


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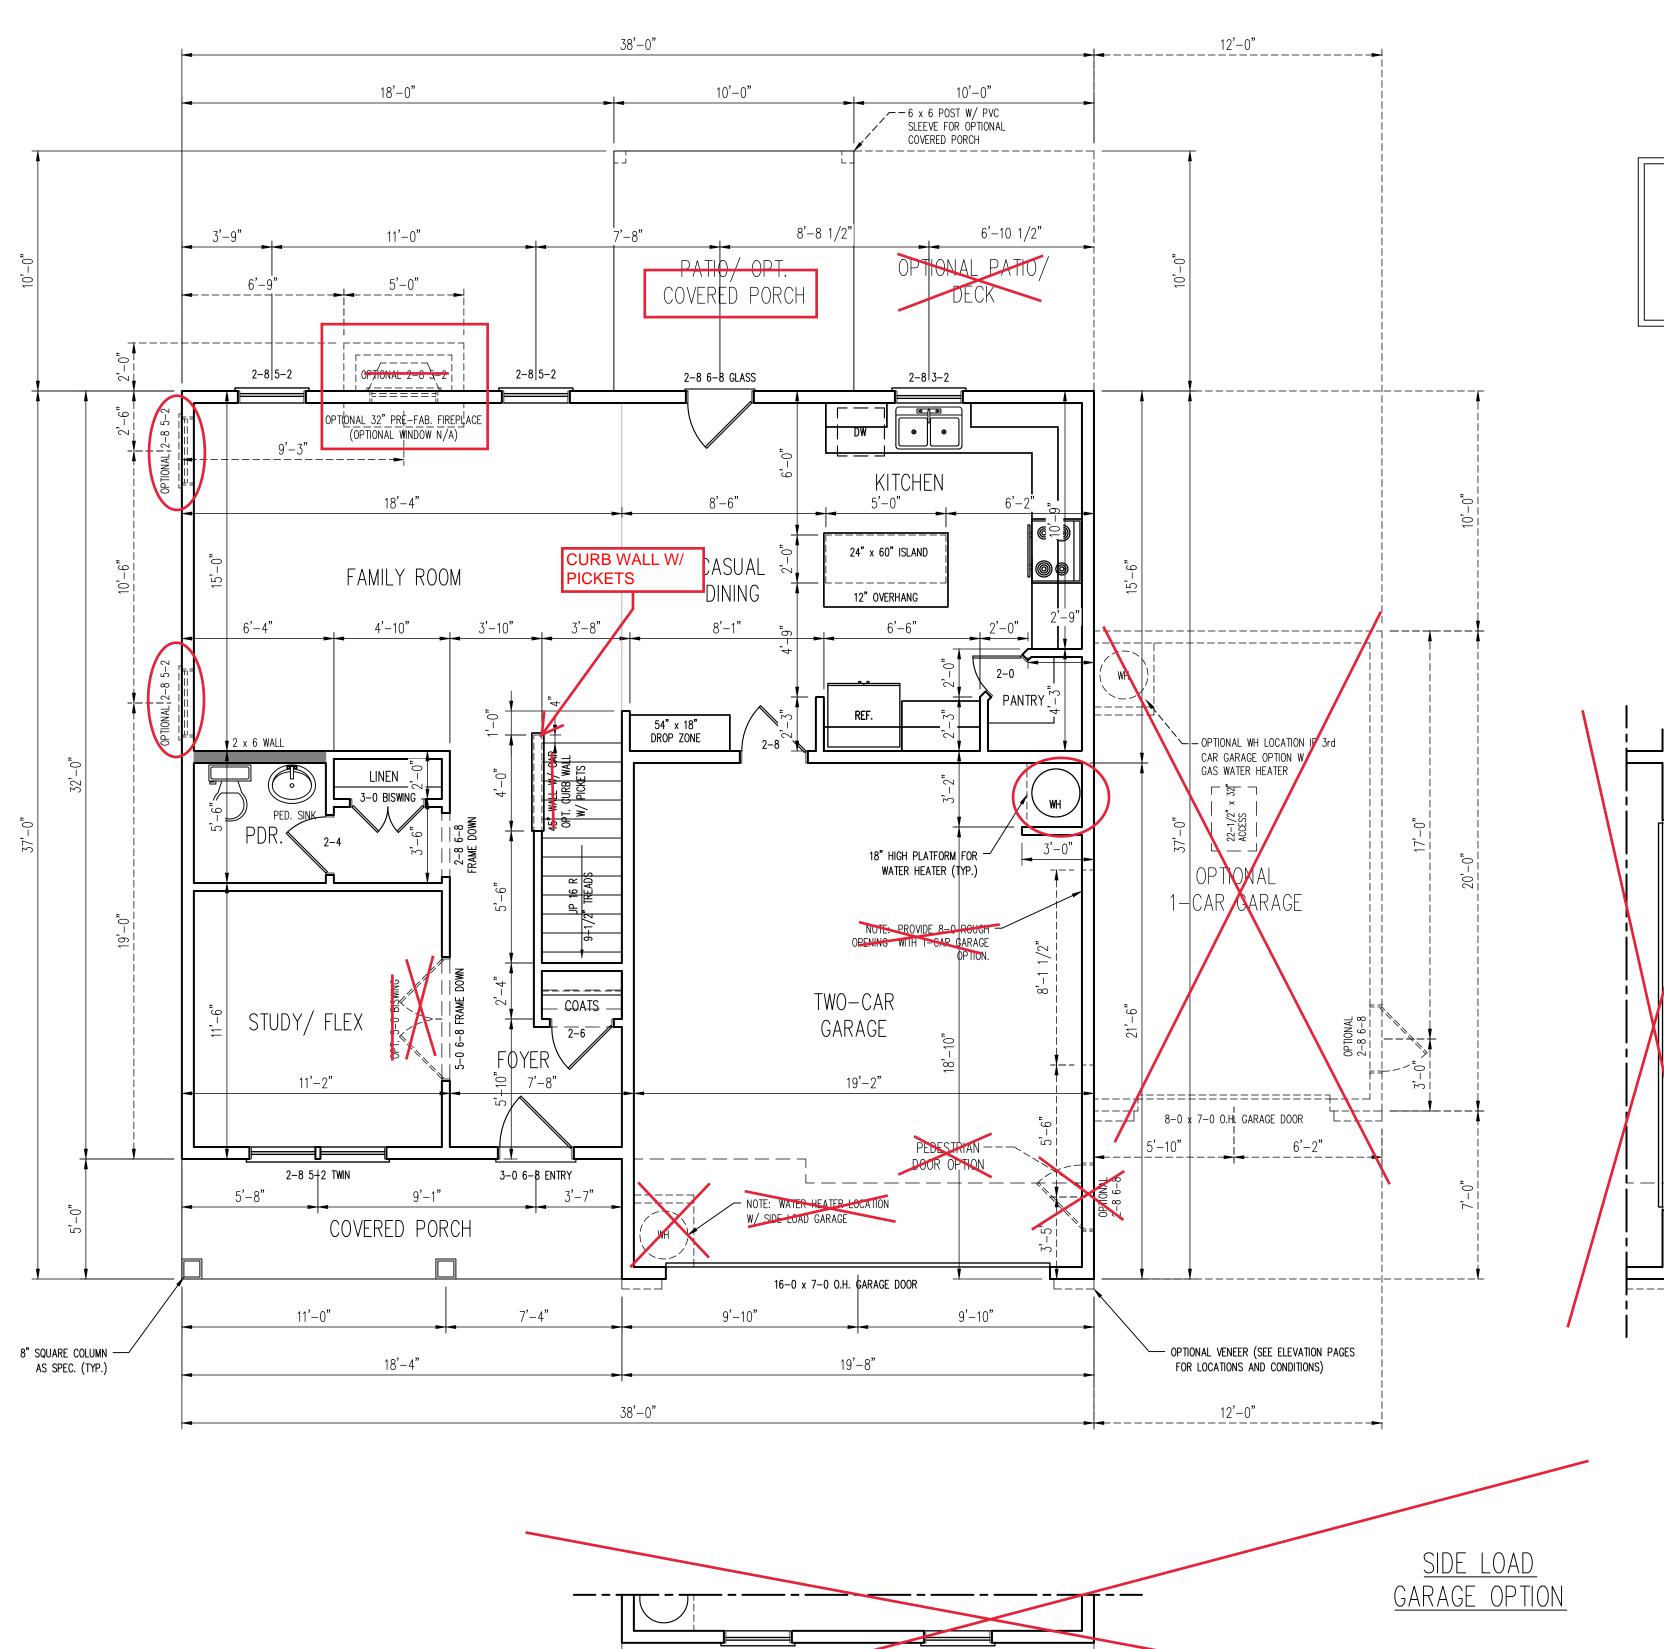


A&G RESIDENTIAL MADISON

DATE: OCTOBER 7, 2022

SCALE: AS NOTED

REVIEWED BY: MGS

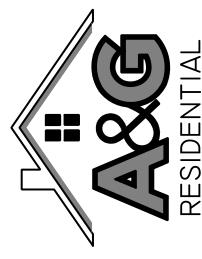

SQUARE FOOTAGE

 1st FLOOR:
 900 SQ. FT.

 2nd FLOOR:
 1228 SQ. FT.

 TOTAL:
 2128 SQ. FT.

 FRONT PORCH:
 92 SQ. FT.

 STD. REAR PATIO:
 100 SQ. FT.

 GARAGE:
 415 SQ. FT.


SQUARE FOOTAGE (OPTIONS)

REAR PORCH:	100 SQ. FT
ODT DATIO / DEGL	100 CO ET
OPT. PATIO/ DECK:	100 30. 11
4 040 040405	240 CO ET
T-CAR GARAGE:	ZTU JQ, 1 1

\*NOTE: ALL EXTERIOR WALLS AND ATTIC WALLS ARE TO BE 2 x 4 @ 16" O.C. MIN. (UNO). 2 x 6 @ 16" O.C. EXTERIOR WALLS MAY BE CONSTRUCTED IN LIEU OF 2 x 4 WALLS. ALL INTERIOR LOAD BEARING WALLS ARE TO BE 2 x 4 @ 16" O.C. (UNO) AND NON-LOAD BEARING INTERIOR WALLS ARE TO BE 2 x 4 @ 24" O.C. (UNO).

## 2x6 WALL

\* SHADED WALLS ARE TO BE 2 x 6 @ 16"
O.C. (LOAD BEARING) OR 2 x 6 @ 24" O.C.
(NON-LOAD BEARING) REGARDLESS OF
EXTERIOR WALL CONDITION

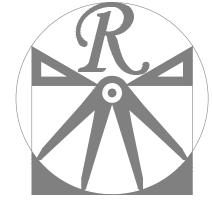

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A&G RESIDENTIAL MADISON

DATE: OCTOBER 7, 2022

SCALE: 1/4

SCALE: 1/4"=1'-0"

DRAWN BY: WG


ENGINEERED BY: WFB

REVIEWED BY: MGS


FIRST FLOOR

PLAN
A-3

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\_\_\_\_\_\_

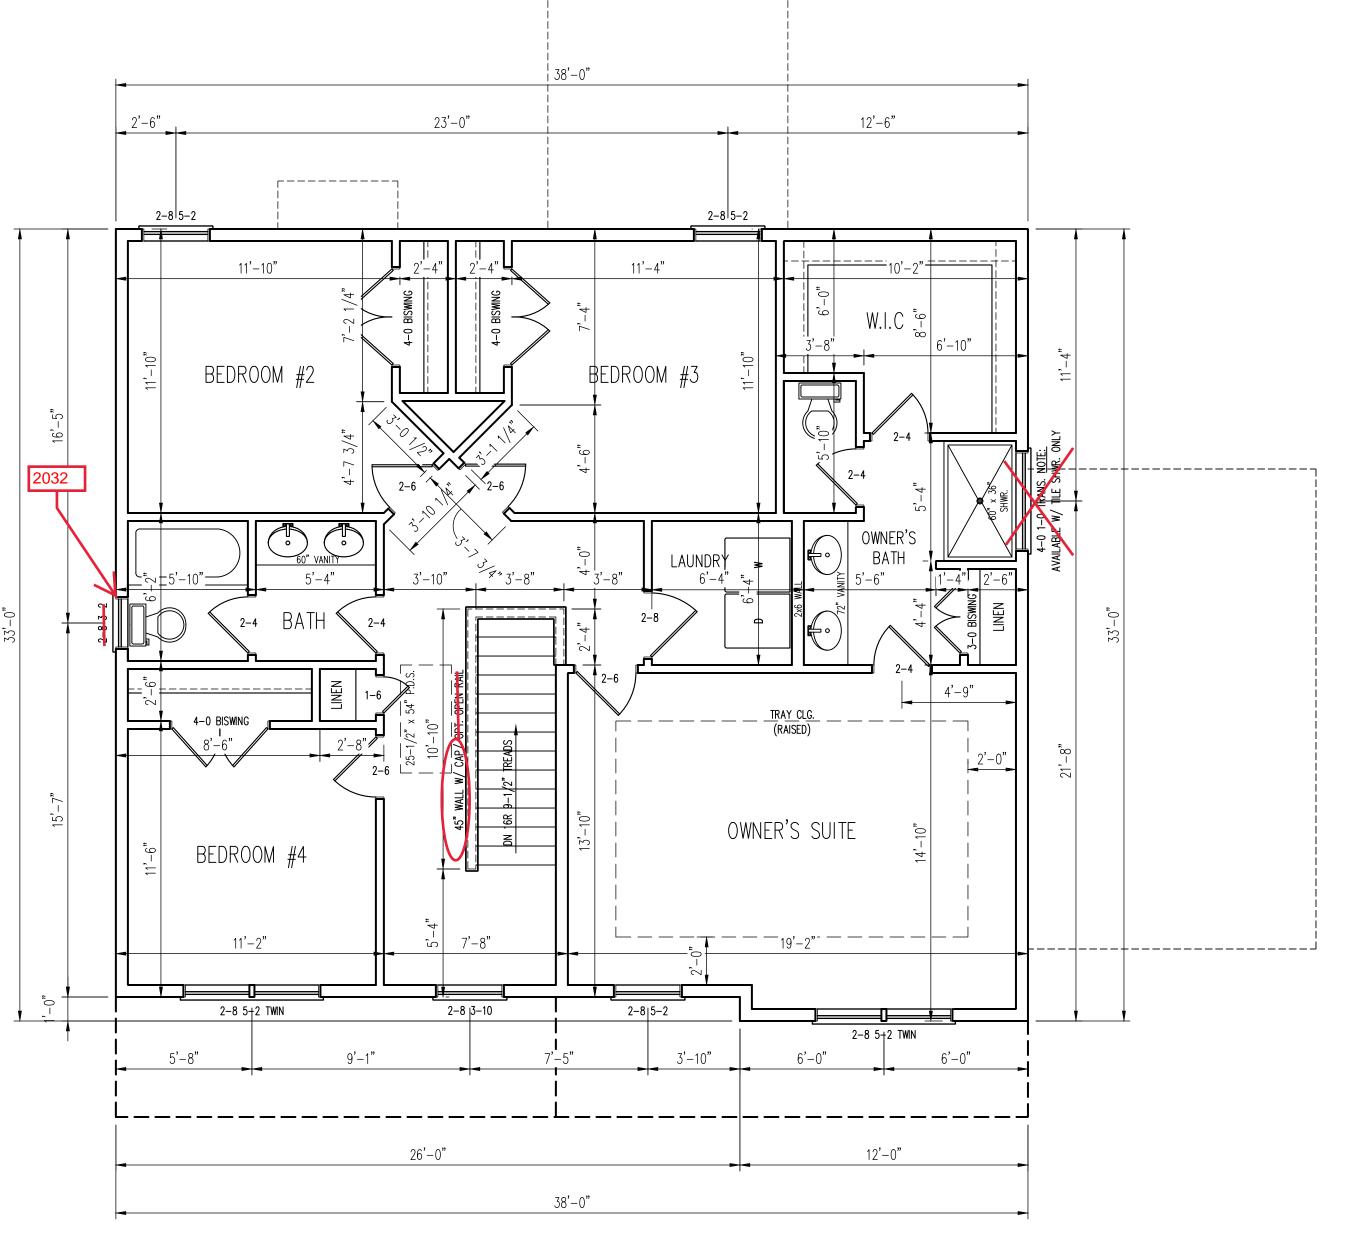

\*NOTE: ALL EXTERIOR WALLS AND ATTIC WALLS ARE TO BE 2 x 4 @ 16" O.C. MIN. (UNO). 2 x 6 @ 16" O.C. EXTERIOR WALLS MAY BE CONSTRUCTED IN LIEU OF 2 x 4 WALLS. ALL INTERIOR LOAD BEARING WALLS ARE TO BE 2 x 4 @ 16" O.C. (UNO) AND NON—LOAD BEARING INTERIOR WALLS ARE TO BE 2 x 4 @ 24" O.C. (UNO).
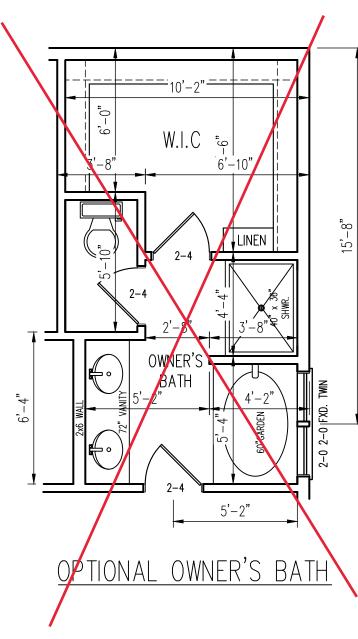
## 2x6 WALL

\* SHADED WALLS ARE TO BE 2 x 6 @ 16"
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DATE: OCTOBER 7, 2022

KEV.:

SCALE: 1/4"=1'-0"


DRAWN BY: WG

ENGINEERED BY: WFB

REVIEWED BY: MGS

SECOND FLOOR

PLAN
A-4

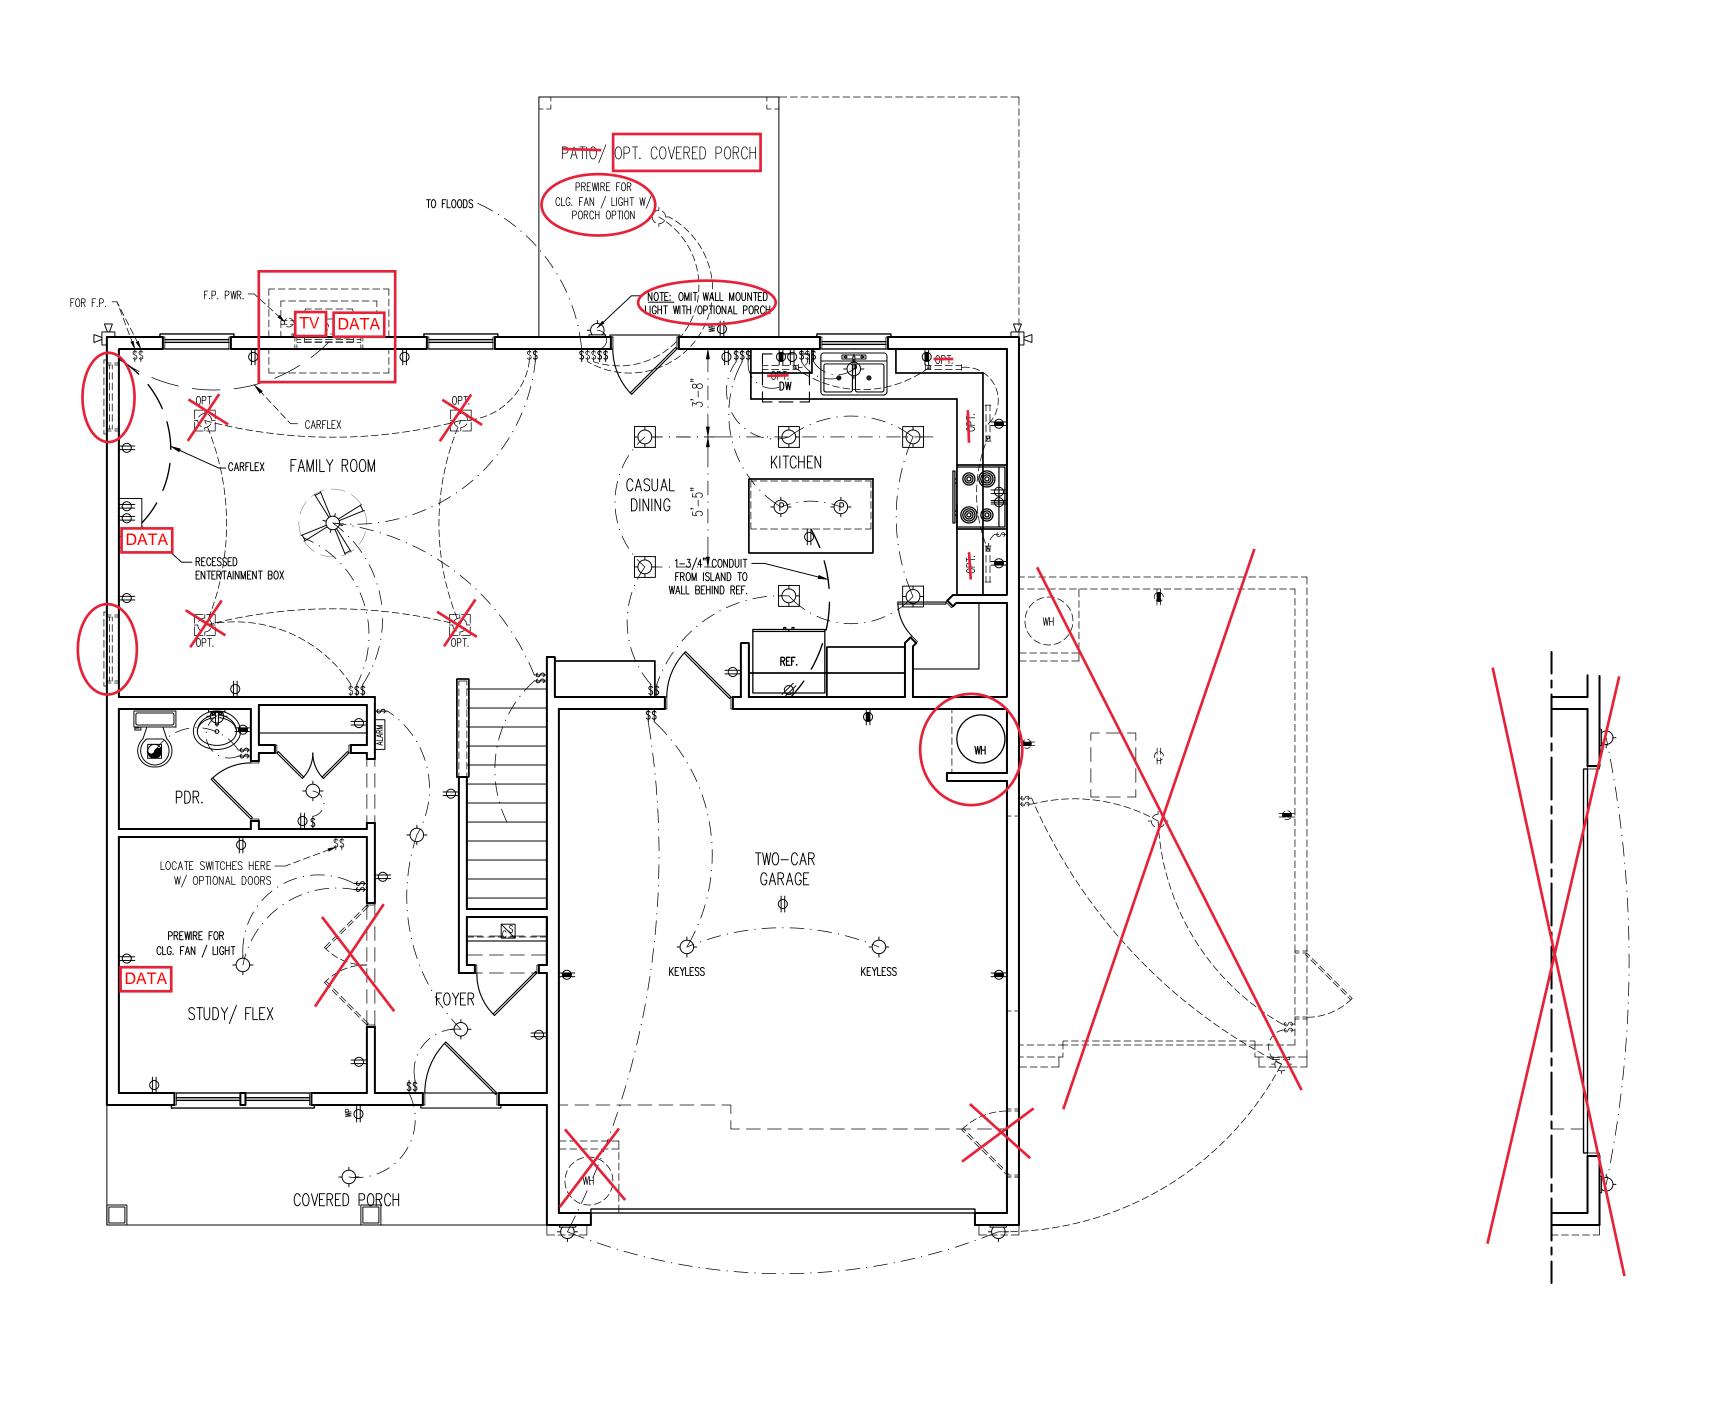

ELECTRICAL LAYOUT NOTES:

 BLOCK AND WIRE FOR ALL CELING FANS PER PLAN.

2.) VANITY LIGHTS TO BE SET @ 90" A.F.F. (TYP.)

3.) ADDITIONAL EXTERIOR OUTLETS REQUIRED BY CODE TO BE

4.) PLACE SWITCHES 8" (MIN.) FROM ROUGH OPENINGS.

LOCATED BY ELECTRICIAN.

## ELECTRICAL LEGEND

- 110 V OUTLET 🗢
- 110 V GFI OUTLET 👄
- 110 V SWITCHED OUTLET 🗢
- 110 V BASEBOARD OUTLET 

  → BB

  4-PLEX
- COUNTER OR FLOOR MOUNTED
- COUNTER OR FLOOR MOUNTED 110V GFI
  - WEATHERPROOF <del>Q</del>
  - 220 V OUTLET 

    ⊕
    .
  - 110 V DEDICATED CIRCUIT 
    220 V DEDICATED CIRCUIT
- SPECIAL PURPOSE (240 V, ETC.)
  - WALL MOUNT LIGHT -
  - CEILING MOUNT LIGHT -
  - PENDANT LIGHT -- (P)-
  - RECESSED CAN LIGHT
  - MINI CAN LIGHT
  - EYEBALL LICHT

    FLUORESCENT LIGHT
  - UNDERCABINET LIGHT
  - FLOOD LIGHT ☐☐☐ SWITCH \$
  - DIMMER SWITCH


TELEPHONE

- DATA 🛆
- TV CONNECTION -TV
- TV/ DATA TO CONDUIT FOR COMPONENT WIRING CD
- SPEAKER &P

  110 V SMOKE/ CM DETECTOR
- 110 V SMOKE DETECTOR SE
- EXHAUST FAN
- LOW VOLTAGE PANEL LVP
- ALARM PANEL ALARM





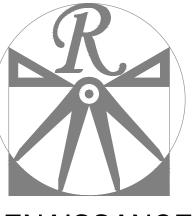

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A&G RESIDENTIAL MADISON

DATE: OCTOBER 7, 2022

REV.:

SCALE: 1/4"=1'-0"

DRAWN BY: WG

ENGINEERED BY: WFB

REVIEWED BY: MGS


FIRST FLOOR ELECTRICAL PLAN

E-1

SIDE LOAD

GARAGE OPTION

 $\label{linear_continuity} C:\Users\xbox\OneDrive\Projects\A\&G\Madison\Madison\_10-7-22.dwg,\ 1/4/2023\ 10:05:28\ AM$ 

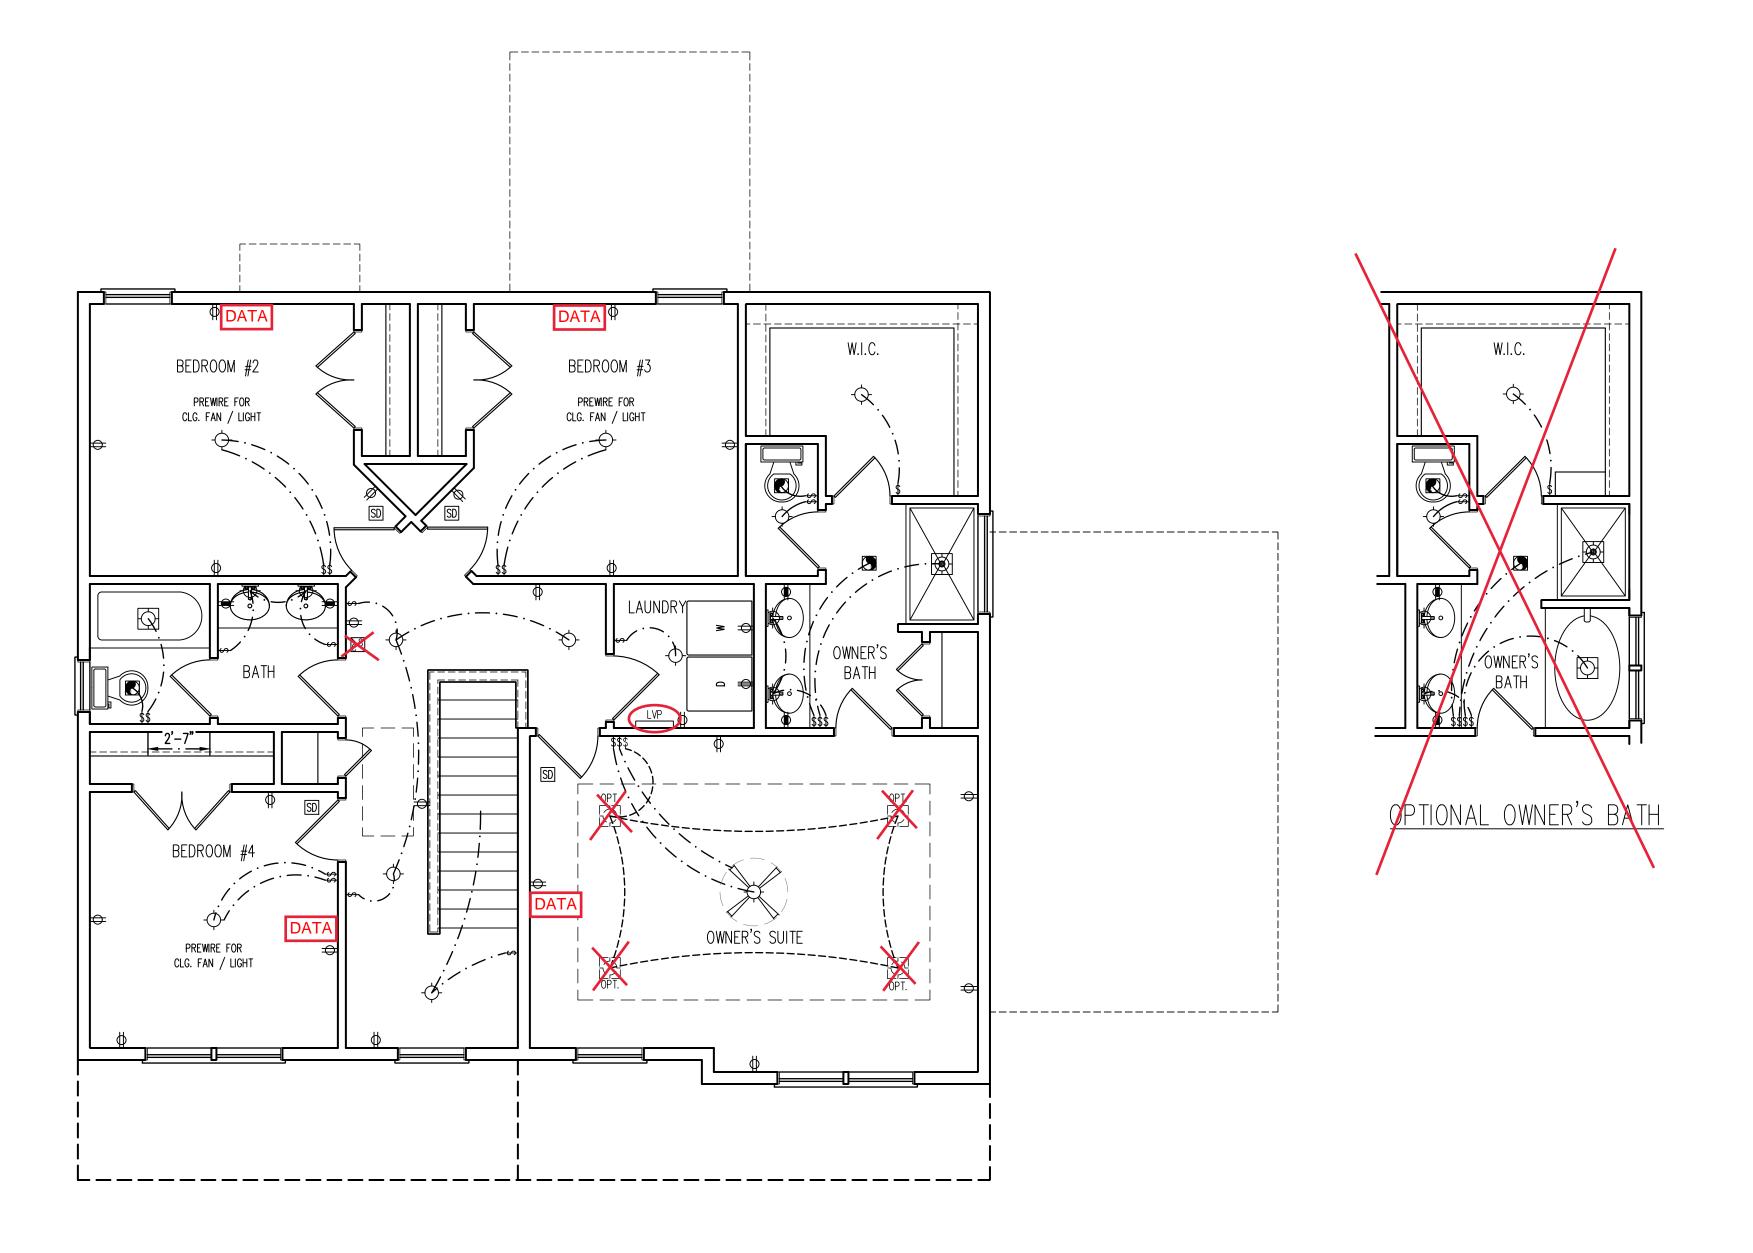

#### ELECTRICAL LAYOUT NOTES:

1.) BLOCK AND WIRE FOR ALL CELING FANS PER PLAN.

2.) VANITY LIGHTS TO BE SET @ 90" A.F.F. (TYP.)

3.) ADDITIONAL EXTERIOR OUTLETS REQUIRED BY CODE TO BE LOCATED BY ELECTRICIAN.

4.) PLACE SWITCHES 8" (MIN.) FROM ROUGH OPENINGS.

## ELECTRICAL LEGEND

110 V OUTLET 110 V GFI OUTLET 👄

4−PLEX #

110 V SWITCHED OUTLET 🗢

110 V BASEBOARD OUTLET 💢 😝 🖽

COUNTER OR FLOOR MOUNTED

COUNTER OR FLOOR MOUNTED 110V GFI WEATHERPROOF 🚓

110 V DEDICATED CIRCUIT 🔌 220 V DEDICATED CIRCUIT

SPECIAL PURPOSE (240 V, ETC.) →

WALL MOUNT LIGHT -CEILING MOUNT LIGHT -

PENDANT LIGHT -(P)-

RECESSED CAN LIGHT MINI CAN LIGHT 🔯

EYEBALL LIGHT FLUORESCENT LIGHT

FLOOD LIGHT

> SWITCH \$ DIMMER SWITCH □\$

> > TELEPHONE

DATA 🛆

TV CONNECTION -TV

TV/ DATA -CONDUIT FOR COMPONENT WIRING -CD


SPEAKER

110 V SMOKE/ CO DETECTOR

110 V SMOKE DETECTOR

EXHAUST FAN LOW VOLTAGE PANEL LVP

ALARM PANEL ALARM

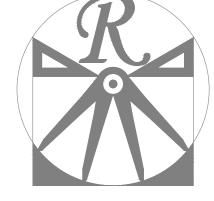

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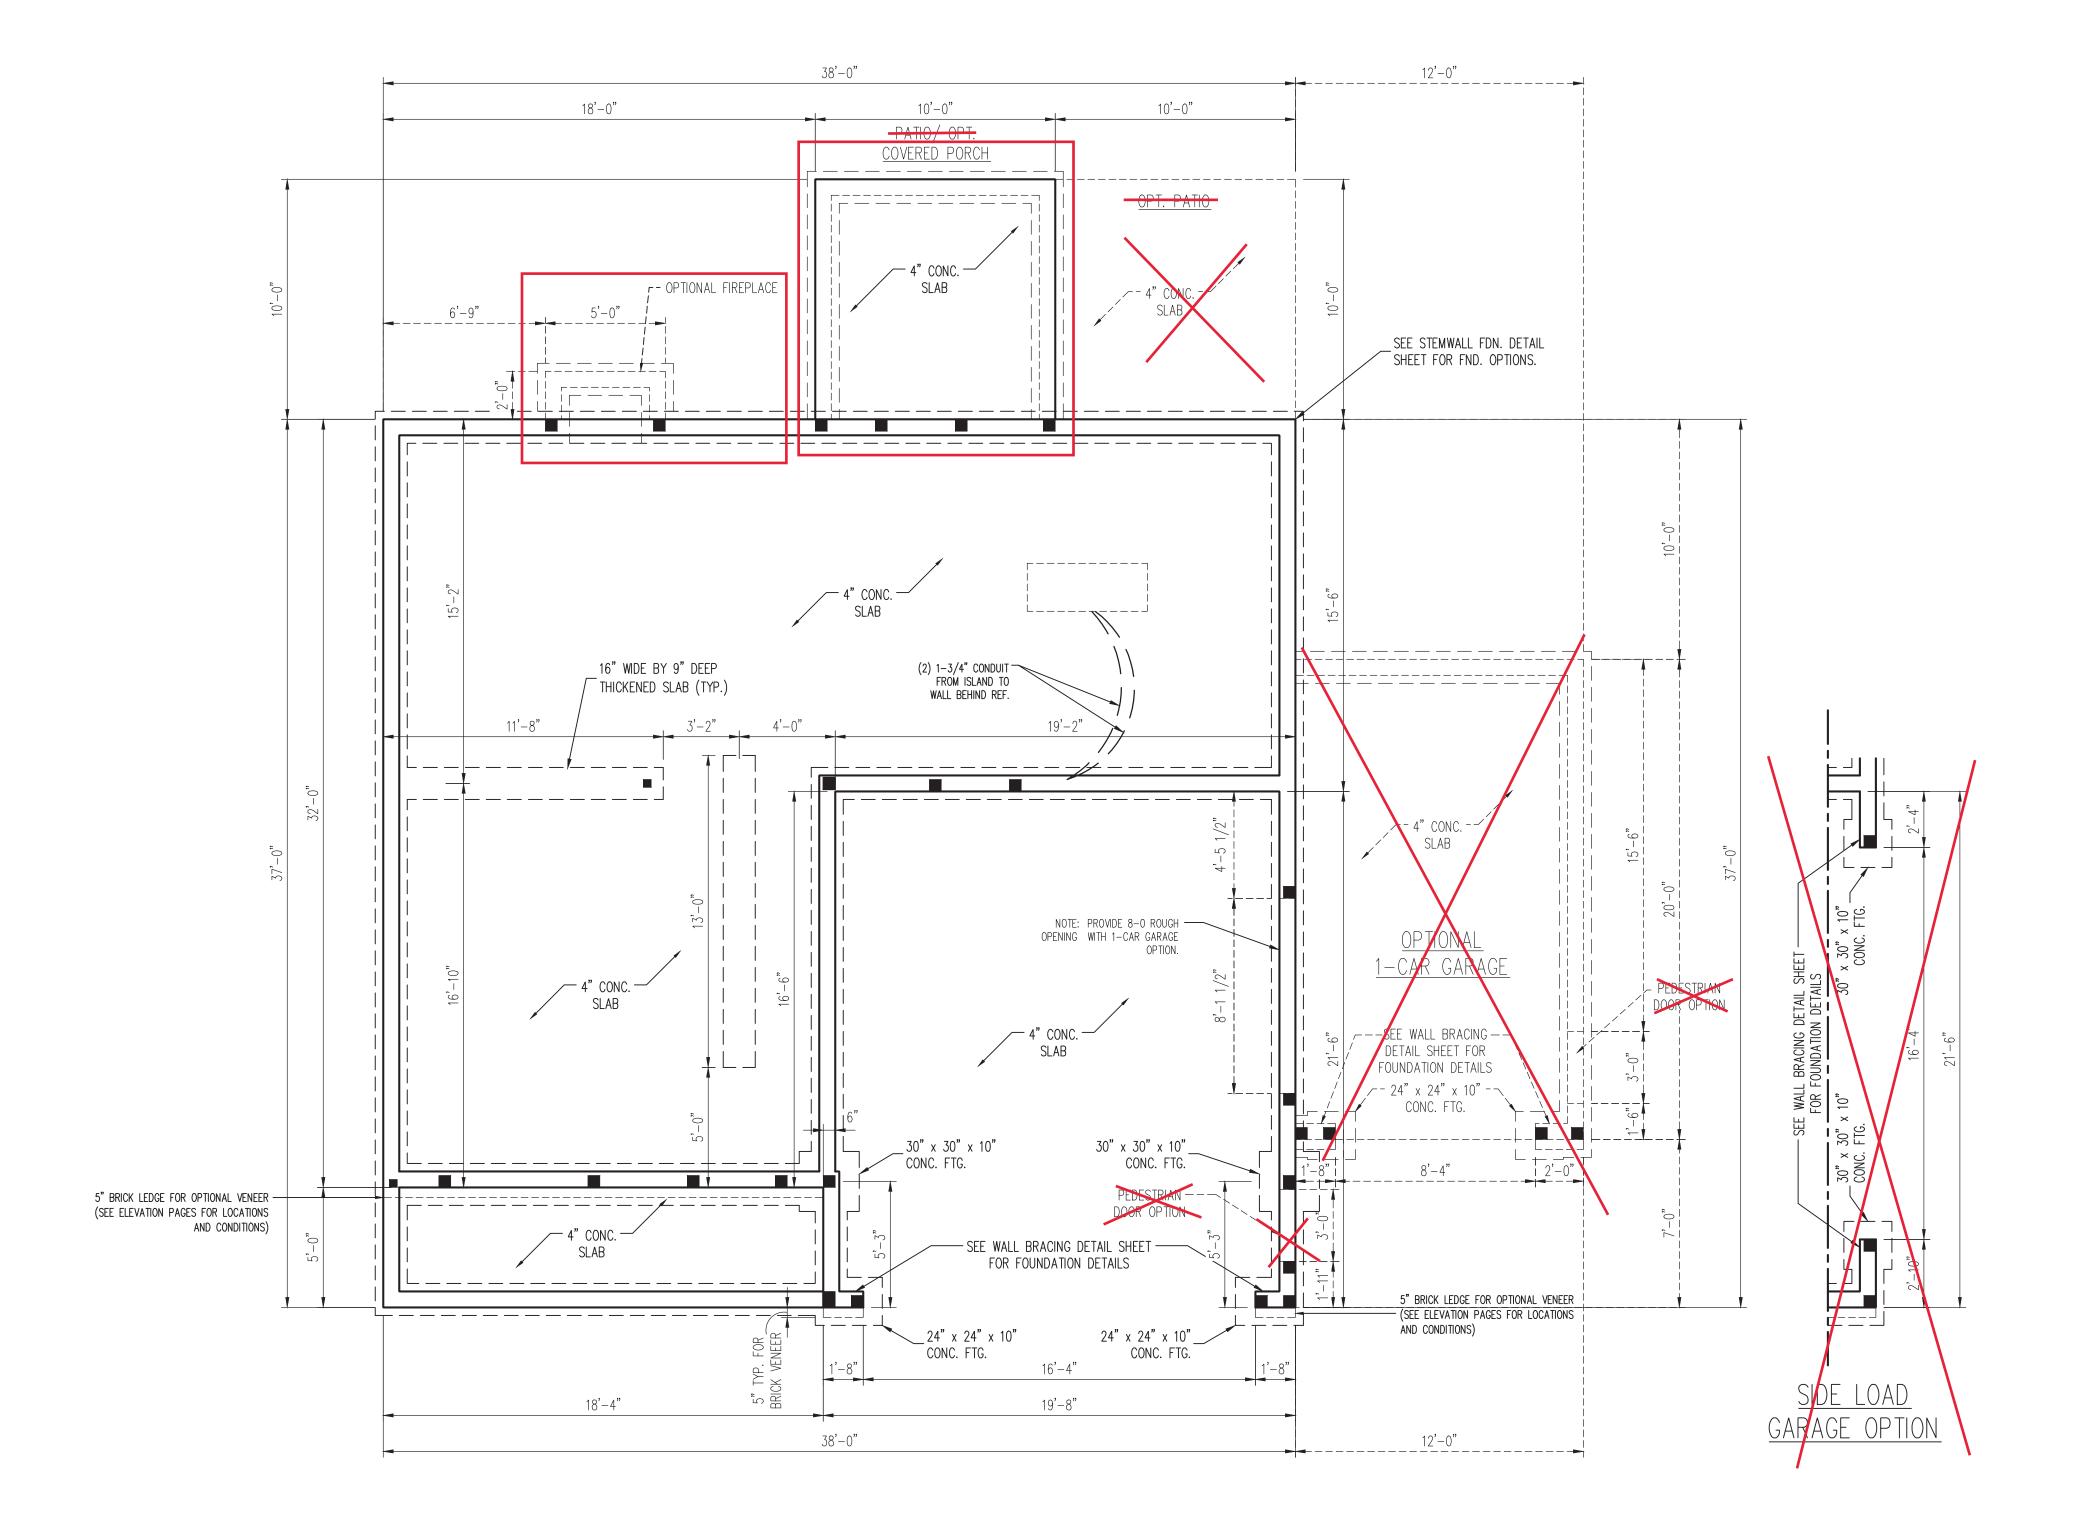
DATE: OCTOBER 7, 2022

SCALE: 1/4"=1'-0"

DRAWN BY: WG ENGINEERED BY: WFB

REVIEWED BY: MGS

SECOND FLOOR ELECTRICAL PLAN



### 120 MPH ULTIMATE DESIGN WIND SPEED NOTES FOR LESS THAN

- DIMENSIONAL ACCURACY OR ARCHITECTURAL LAYOUT INCLUDING ROOF SYSTEM.
- STRUCTURAL DESIGN PER NORTH CAROLINA RESIDENTIAL CODE, 2018 EDITION. INSTALL 1/2" ANCHOR BOLTS 6'-0" O.C. AND
- EXTERIOR WALLS DESIGNED FOR 120 MPH WINDS. 6. WALL CLADDING DESIGNED FOR +15.5 PSF AND -20 PSF (+/- INDICATE POSITIVE / NEGATIVE PRESSURE (TYP).
- PSF FOR ROOF PITCHES 7/12 TO 12/12 AND +10 8. INSTALL 7/16" OSB SHEATHING ON ALL EXTERIOR
- . ENERGY EFFICIENCY COMPLIANCE AND INSULATION VALUES OF THE BUILDING TO BE IN ACCORDANCE WITH CHAPTER 11 OF THE NCRC, 2018 EDITION.

### 130 MPH ULTIMATE DESIGN WIND SPEED NOTES FOR LESS THAN

- WITHIN MIDDLE THIRD OF PLATE WIDTH. . MEAN ROOF HEIGHT IS LESS THAN 30 FEET. 5. EXTERIOR WALLS DESIGNED FOR 130 MPH WINDS. 6. WALL CLADDING DESIGNED FOR +18.2 PSF AND
- ROOF CLADDING DESIGNED FOR +16.7 PSF AND -21 PSF FOR ROOF PITCHES 7/12 TO 12/12 AND +10.5 PSF AND -43 PSF FOR ROOF PITCHED
- WALLS OF ALL STORIES IN ACCORDANCE WITH SECTION R602.10.3 OF THE NCRC, 2018 EDITION. SEE THE WALL BRACING NOTES AND DETAILS
- SHEET FOR MORE INFORMATION. ENERGY EFFICIENCY COMPLIANCE AND INSULATION
- WITH CHAPTER 11 OF THE NCRC, 2018 EDITION. 10. REFER TO NOTES AND DETAIL SHEETS FOR ADDITIONAL STRUCTURAL INFORMATION.



- ENGINEER'S SEAL APPLIES ONLY TO STRUCTURAL COMPONENTS. ENGINEER'S SEAL DOES NOT CERTIFY
- WITHIN 1'-0" FROM END OF EACH CORNER.

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FAX: (919) 789-9921 N.C. LICENSE NO.: C-1733

- ANCHOR BOLTS MUST EXTEND A MINIMUM OF 7" INTO MASONRY OR CONCRETE. LOCATE BOLT WITHIN MIDDLE THIRD OF PLATE WIDTH. . MEAN ROOF HEIGHT IS LESS THAN 30 FEET.
- ROOF CLADDING DESIGNED FOR +14.2 PSF AND -18
- PSF AND -36 PSF FOR ROOF PITCHED 2.25/12 TO WALLS OF ALL STORIES IN ACCORDANCE WITH
- SECTION R602.10.3 OF THE NCRC, 2018 EDITION. SEE THE WALL BRACING NOTES AND DETAILS SHEET FOR MORE INFORMATION.
- 10. REFER TO NOTES AND DETAIL SHEETS FOR
- ADDITIONAL STRUCTURAL INFORMATION.

## 30' MEAN ROOF HEIGHT:

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- RESIDENTIAL CODE, 2018 EDITION. INSTALL 1/2" ANCHOR BOLTS 4'-0" O.C. AND WITHIN 1'-0" FROM END OF EACH CORNER. ANCHOR BOLTS MUST EXTEND A MINIMUM OF 7" INTO MASONRY OR CONCRETE. LOCATE BOLT
- -24 PSF (+/- INDICATE POSITIVE / NEGATIVE
- PRESSURE (TYP). 2.25/12 TO 7/12.
- 8. INSTALL 7/16" OSB SHEATHING ON ALL EXTERIOR
- VALUES OF THE BUILDING TO BE IN ACCORDANCE

-		
		LEGEND
	CONT	CONTINUOUS
	XJ	EXTRA JOIST
	DJ	DOUBLE JOIST
	TJ	TRIPLE JOIST
	EA	EACH
	FDN	FOUNDATION
	FTG	FOOTING
	OC	ON CENTER
	SPF	SPRUCE PINE FIR
	SYP	SOUTHERN YELLOW PINE
	TRTD	PRESSURE TREATED
	TYP	TYPICAL
	UNO	UNLESS NOTED OTHERWISE



DATE: OCTOBER 7, 2022

A&G RESIDENTIAL MADISON

SCALE: 1/4"=1'-0"

REV.:

DRAWN BY: WG

ENGINEERED BY: WFB REVIEWED BY: MGS

STEM WALL FOUNDATION PLAN

## 2X4 WALLS

\*NOTE: ALL EXTERIOR WALLS AND ATTIC WALLS ARE TO BE 2 x 4 @ 16" O.C. MIN. (UNO). 2 x 6 @ 16" O.C. EXTERIOR WALLS MAY BE CONSTRUCTED IN LIEU OF 2 x 4 WALLS. ALL INTERIOR LOAD BEARING WALLS ARE TO BE 2 x 4 @ 16" O.C. (UNO) AND NON-LOAD BEARING INTERIOR WALLS ARE TO BE 2 x 4 @ 24" O.C. (UNO).

监 (3) 2 x 6 JACKS

KING STUDS

(4) 2 x 6

OAD GARAGE OPTION

LEGEND		
CONT	CONTINUOUS	
XJ	EXTRA JOIST	
DJ	DOUBLE JOIST	
TJ	TRIPLE JOIST	
EA	EACH	
( )	NUMBER OF STUDS	
DSP	DOUBLE STUD POCKET	
TSP	TRIPLE STUD POCKET	
OC	ON CENTER	
SPF	SPRUCE PINE FIR	
SYP	SOUTHERN YELLOW PINE	
TRTD	PRESSURE TREATED	
TYP	TYPICAL	
UNO	UNLESS NOTED OTHERWISE	

#### BRACED WALL DESIGN

<u>RECTANGLE A</u> SIDE 1A (FRONT LOAD) METHOD: CS-WSP/PF TOTAL REQUIRED LENGTH: 11.5'

TOTAL PROVIDED LENGTH: 15.04' SIDE 2A METHOD: CS-WSP TOTAL REQUIRED LENGTH: 11.5'

TOTAL PROVIDED LENGTH: 23.92' SIDE 3A METHOD: CS-WSP TOTAL REQUIRED LENGTH: 11.8' TOTAL PROVIDED LENGTH: 30.25'

SIDE 4A (SIDE LOAD) METHOD: CS-WSP/PF TOTAL REQUIRED LENGTH: 11.8' TOTAL PROVIDED LENGTH: 22.2'

BRACED WALL DESIGN NOTES:

O.C. IN THE FIELD.

<u>RECTANGLE B</u> SIDE 1B METHOD: CS-WSP/PF TOTAL REQUIRED LENGTH: 2.85' TOTAL PROVIDED LENGTH: 6.0' SIDE 2B

METHOD: CS-WSP TOTAL REQUIRED LENGTH: 2.85' TOTAL PROVIDED LENGTH: 12.0' SIDE 3B / 4A COMBINED METHOD: CS-WSP TOTAL REQUIRED LENGTH: 13.9'

TOTAL PROVIDED LENGTH: 17' SIDE 4B METHOD: CS-WSP TOTAL REQUIRED LENGTH: 2.1'

MODIFICATIONS TO FLOOR PLANS, DIMENSIONS, MATERIALS, AND SPECIFICATIONS WITHOUT NOTICE TOTAL PROVIDED LENGTH: 15.58' THESE DRAWINGS ARE FOR THE PURPOSE OF CONVEYING AN ARCHITECTURAL CONCEPT ONLY

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TABLE R602.7.5 MINIMUM NUMBER OF FULL HEIGHT KING STUDS

1/4" SCREWS OR 1 5/8" NAILS SPACED 7" O.C. ALONG PANEL EDGES AND IN THE FIELD INCLUDING TOP AND BOTTOM PLATES. BRACED WALL DESIGN APPLIED IN WIND ZONES UP TO 130 MPH. FOR HIGH WIND ZONES, BRACE WALLS ARE TO BE CONSTRUCTED IN ACCORDANCE WITH CHAPTER 45 OF THE NCRC 2018 EDITION. 5. SEE NOTES AND DETAIL SHEETS FOR ADDITIONAL BRACED WALL

BCI 4500s-1.8 JOISTS MAY BE INSTALLED

ALTERNATIVE

IN LIEU OF TJI 110 JOISTS AT THE DEPTH

AND SPACING INDICATED ON THE PLAN SEE SHEET D-1 FOR FLOOR TRUSS

INFORMATION.

STRUCTURAL NOTES:

1. BRACED WALL DESIGN PER SECTION R602.10 OF THE NCRC 2018 EDITION.

PANELS" CONTRACTOR IS TO INSTALL 7/16" OSB ON ALL EXTERIOR WALLS

ATTACHED w/8d NAILS SPACED 6" O.C. ALONG PANEL EDGES AND 12"

. \*GB REFERS TO "GYPSUM BOARD" CONTRACTOR IS TO INSTALL 1/2" (MIN.)

GYPSUM WALL BOARD WHERE NOTED ON THE PLANS. FASTEN GB WITH 1

2. CS-WSP REFERS TO "CONTINUOUS SHEATHING - WOOD STRUCTURAL

ALL FRAMING LUMBER TO BE SPF #2 (UNO). ALL TREATED LUMBER TO BE SYP #2 (UNO.) ALL LOAD BEARING HEADERS TO BE (2) 2 x 6

INSTALL AN EXTRA JOIST UNDER WALLS PARALLEL

TO FLOOR JOISTS WHERE NOTED ON THE PLANS. WINDOW AND DOOR HEADERS TO BE SUPPORTED w/ (1) JACK STUD AND (1) KING STUD EA. END (UNO.). SEE TABLE R602.7.5 FOR ADDITIONAL KING STUD REQUIREMENTS.


SQUARES DENOTE POINT LOADS WHICH REQUIRE SOLID BLOCKING TO GIRDER OR FOUNDATION. ALL SQUARES TO BE (2) STUDS (UNO.)

ALL 4 x 4 POSTS SHALL BE ANCHORED TO SLABS w/ SIMPSON ABU44 POST BASES (OR EQUAL) AND 6 x 6 POSTS w/ ABU66 POST BASES (OR EQUAL) (UNO). ALL 4 x 4 AND 6 x 6 POSTS TO BE INSTALLED WITH 700 LB CAPACITY UPLIFT CONNECTORS AT TOP (UNO.)

FOR FIBERGLASS, ALUMINUM, OR COLUMN ENG. BY OTHERS, SECURE TO SLAB w/ (2) METAL ANGLES USING 2" CONC. SCREWS. FASTEN ANGLES TO COLUMNS w/ 1/4" THROUGH BOLTS w/ NUTS AND WASHERS. LOCATE ANGLES ON OPPOSITE SIDES OF COLUMN. THROUGH BOLTS MUST BE

INSTALLED PRIOR TO SETTING COLUMN. REFER TO NOTES AND DETAIL SHEETS FOR ADDITIONAL STRUCTURAL INFORMATION.

AT EACH END OF	HEADERS IN EXTERIOR WAI
HEADER SPAN (FEET)	MINIMUM NUMBER OF FULL HEIGHT STUDS (KINGS)
UP TO 3'	1
> 3' TO 6'	2
> 6' TO 9'	3
> 9' TO 12'	4
> 12' TO 15'	5

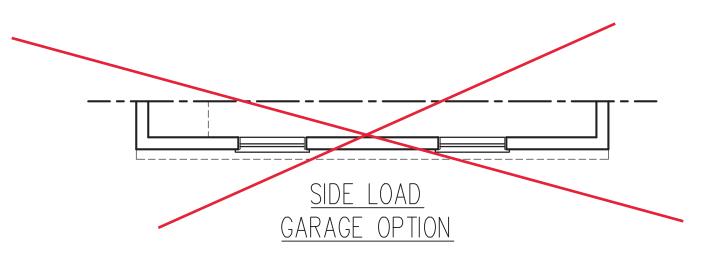

CORNER w/(3) 2 x 6 JACKS EA. BRG. PT.

PF WALL BRACING DETAIL

— GARAGE PORTAL FRAME. SEE METHOD

38'-0" SIDE 2A

w/ OPT. FIREPLACE:

<u>OR</u>: 2 x 6 @ 16" O.C.

OPTIONAL FIREPLACE

w/ OPT. FIREPLACE: <sup>†</sup>

(2) 2 x 10 w/ (2)

4 x 4 TRTD. POST

MIN. (TYP.)

 $(2) 2 \times 10 \text{ w}/(2)^{-1}$ 

JACKS EA. END

(2) 1 3/4" x 14" LVL FLUSH

(2) 2 x 10 (TYP.)

LOCATION OF WATER -

LOAD GARAGE

HEATER WITH SIDE

1'-10"

38'-0" SIDE 1A RECTANGLE A

CONTR. 2'-9"

ROOF TRUSSES ENG. BY OTHERS —

COVERED PORC

5'-10 1/2'

(2) 2 x 10 (TYP.)

 $-(3) 2 \times 4 OR$ 

(3) 2 x 6

∕4 x 4 TRTD. POST

MIN. (TYP. w/ OPT. PORCH)

5'-5 1/2"

<u>12'-0" SIDE 2B</u>

\_\_\_\_\_\_

CAR GARAGE

2 x 12 CONT. FROM CORNEF

CONTR. 3'-3"

METHOD PF WALL BRACING DETAIL

INCORPORATE SECOND FLOOR

12'-0" SIDE 1B RECTANGLE B

TRUSSES ENG. BY OTHERS

-BUMP OUT INTO ROOF

CONTR.  $2^{1/2}9^{1/2}$ 

CONTR. 2'-9"



DATE: OCTOBER 7, 2022

A&G RESIDENTIA MADISON

SCALE: 1/4"=1'-0" DRAWN BY: WG

> ENGINEERED BY: WFB REVIEWED BY: MGS

SECOND FLOOR FRAMING PLAN

S-2

# 2X4 WALLS

\_\_\_\_\_\_ ------NO STRUCTURA CHANGES OPTYONAL OWNER'S BATH (2) 2 x 10 w/ (2) JACKS EA. END

\*NOTE: ALL EXTERIOR WALLS AND ATTIC WALLS ARE TO BE 2 x 4 @ 16" O.C. MIN. (UNO). 2 x 6 @ 16" O.C. EXTERIOR WALLS MAY BE CONSTRUCTED IN LIEU OF 2 x 4 WALLS. ALL INTERIOR LOAD BEARING WALLS ARE TO BE 2 x 4 @ 16" O.C. (UNO) AND NON-LOAD BEARING INTERIOR WALLS ARE TO BE 2 x 4 @ 24" O.C. (UNO).

#### BRACED WALL DESIGN NOTES:

- 1. BRACED WALL DESIGN PER SECTION R602.10 OF THE NCRC 2018 EDITION. 2. CS-WSP REFERS TO "CONTINUOUS SHEATHING - WOOD STRUCTURAL PANELS" CONTRACTOR IS TO INSTALL 7/16" OSB ON ALL EXTERIOR WALLS ATTACHED w/ 8d NAILS SPACED 6" O.C. ALONG PANEL EDGES AND 12" O.C. IN THE FIELD.
- 3. \*GB REFERS TO "GYPSUM BOARD" CONTRACTOR IS TO INSTALL 1/2" (MIN.) GYPSUM WALL BOARD WHERE NOTED ON THE PLANS. FASTEN GB WITH 1 1/4" SCREWS OR 1 5/8" NAILS SPACED 7" O.C. ALONG PANEL EDGES AND IN THE FIELD INCLUDING TOP AND BOTTOM PLATES.
- 4. BRACED WALL DESIGN APPLIED IN WIND ZONES UP TO 130 MPH. FOR HIGH WIND ZONES, BRACE WALLS ARE TO BE CONSTRUCTED IN ACCORDANCE WITH CHAPTER 45 OF THE NCRC 2018 EDITION.
- 5. SEE NOTES AND DETAIL SHEETS FOR ADDITIONAL BRACED WALL INFORMATION.

- 1. PER SECTION R602.10.3.2 OF THE 2018 NCRC, THE AMOUNT OF BRACING ON THE SECOND FLOOR EXCEEDS THE AMOUNT REQUIRED FOR THE FIRST FLOOR AND NO BRACED WALL ANALYSIS IS REQUIRED.
- 2. SHEATH ALL EXTERIOR WALLS WITH 7/16" OSB SHEATHING ATTACHED WITH 8d NAILS AT 6" O.C. ALONG PANEL EDGES AND 12" O.C. IN THE FIELD.

#### STRUCTURAL NOTES:

- ALL FRAMING LUMBER TO BE #2 SPF (UNO). 2. ALL LOAD BEARING HEADERS TO BE (2) 2 x 6
- WINDOW AND DOOR HEADERS TO BE SUPPORTED w/ (1) JACK STUD AND (1) KING STUD EA. END (UNO.). SEE TABLE R602.7.5 FOR ADDITIONAL KING STUD REQUIREMENTS.
- SQUARES DENOTE POINT LOADS WHICH REQUIRE SOLID BLOCKING TO GIRDER OR FOUNDATION. SQUARES TO BE (2) STUDS (UNO.) REFER TO NOTES AND DETAIL SHEETS FOR


ADDITIONAL STRUCTURAL INFORMATION.

TABLE R602.7.5 MINIMUM NUMBER OF FULL HEIGHT KING STUDS AT EACH END OF HEADERS IN EXTERIOR WALLS

HEADER SPAN (FEET)	MINIMUM NUMBER OF FULL HEIGHT STUDS (KINGS)		
UP TO 3'	1		
> 3' TO 6'	2		
> 6' TO 9'	3		
> 9' TO 12'	4		
> 12' TO 15'	5		

LEGEND		
CONT	CONTINUOUS	
XT EXTRA TRUSS		
TS TRUSS SUPPORT  EA EACH		
		( ) NUMBER OF STUDS
DSP DOUBLE STUD POCKET TSP TRIPLE STUD POCKET		
		OC
SPF	SPRUCE PINE FIR	
SYP	SOUTHERN YELLOW PINE	
TRTD	PRESSURE TREATED	
TYP	TYPICAL	
UNO	UNLESS NOTED OTHERWISE	



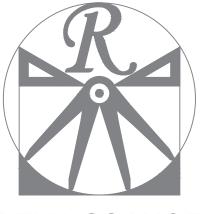

## RENAISSANCE

RESIDENTIAL DESIGN, INC. WILMINGTON NC 28401 (919) 649-4128


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DATE: OCTOBER 7, 2022

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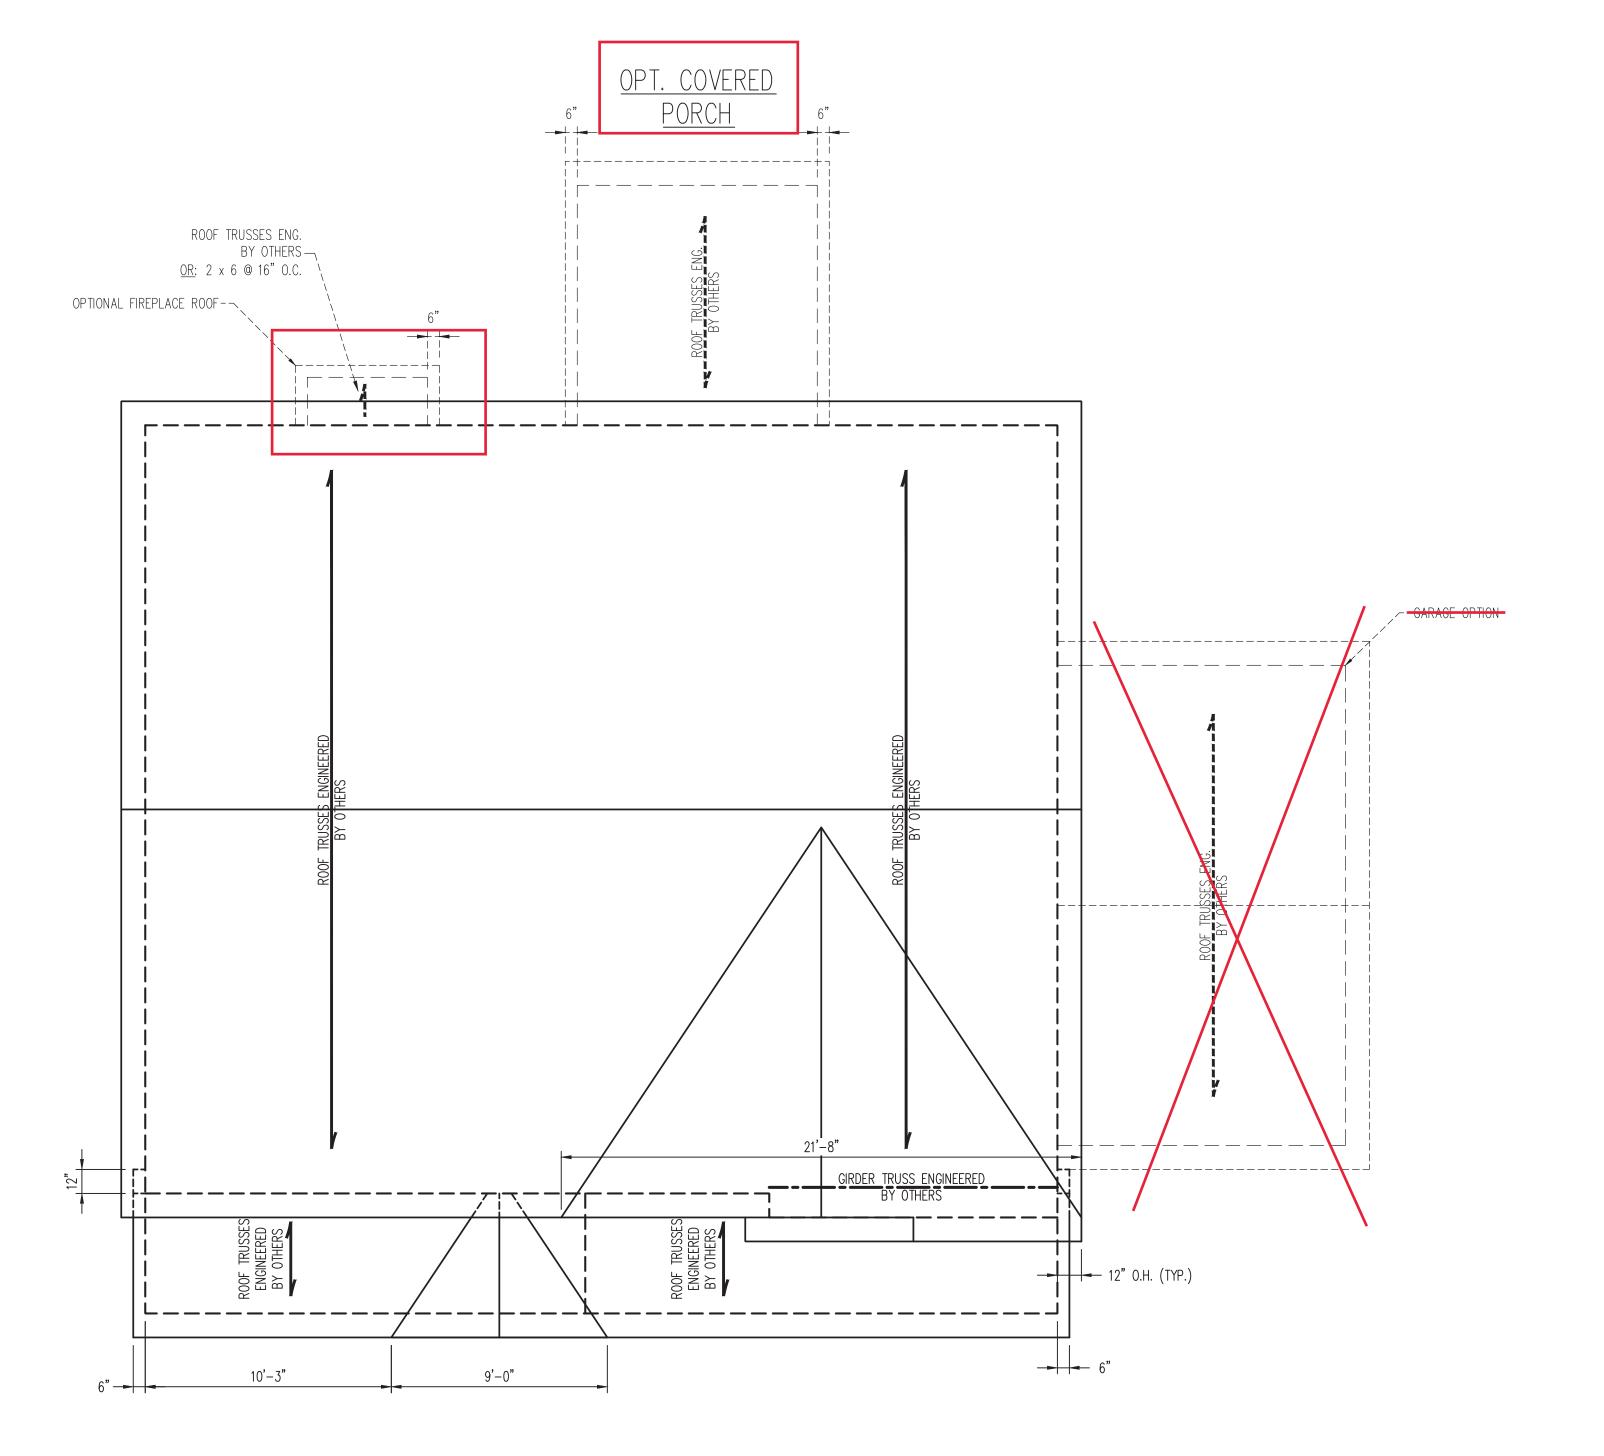
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ENGINEERED BY: WFB REVIEWED BY: MGS

ATTIC FLOOR FRAMING PLAN

S-3

## 2X4 WALLS

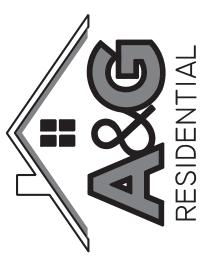

STRUCTURAL NOTES:

- I. ALL FRAMING LUMBER TO BE #2 SPF (UNO).

  2. CIRCLES DENOTE (3) 2 x 4 POSTS FOR ROOF
- FRAME DORMER WALLS ON TOP OF DOUBLE OR
- TRIPLE RAFTERS.

  4. HIP SPLICES ARE TO BE SPACED A MIN. OF 8'-0". FASTEN MEMBERS WITH THREE ROWS OF

12d NAILS @ 16" O.C. (TYP.)

- STICK FRAME OVER-FRAMED ROOF SECTIONS W/2 x 8 RIDGES, 2 x 6 RAFTERS @ 16" O.C. AND FLAT 2 x 10 VALLEYS OR USE VALLEY TRUSSES. FASTEN FLAT VALLEYS TO RAFTERS OR TRUSSES WITH SIMPSON H2.5A HURRICANE TIES @ 32" O.C. MAX. PASS HURRICANE TIES THROUGH NOTCH IN ROOF SHEATHING. EACH RAFTER IS TO BE FASTENED TO THE FLAT VALLEY WITH A MIN. OF (6) 12d TOE NAILS.
- REFER TO SECTION R802.11 OF THE 2018 NCRC FOR REQUIRED UPLIFT RESISTANCE AT RAFTERS AND TRUSSES.
- REFER TO NOTES AND DETAIL SHEETS FOR ADDITIONAL STRUCTURAL INFORMATION.

NOTE: REFER TO ARCHITECTURAL DRAWINGS FOR ROOF PITCHES, PLATE HEIGHTS, DIMENSIONS, OVERHANG WIDTHS, AND ATTIC VENT CALCS.

LEGEND  XT EXTRA TRUSS		
CONT	CONTINUOUS	
EA	EACH	
OC	ON CENTER	
SPF	SPRUCE PINE FIR	
SYP	SOUTHERN YELLOW PINE	
TYP	TYPICAL	
UNO	UNLESS NOTED OTHERWISE	



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10/20/2022

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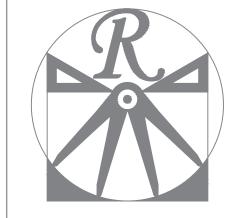
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ENGINEERED BY: WFB
REVIEWED BY: MGS

ROOF PLAN

S-4

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SCALE: 1/4"=1'-0"

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ENGINEERED BY: WFB

REVIEWED BY: MGS


FLOOR TRUSS

ALTERNATIVE


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10/20/2022



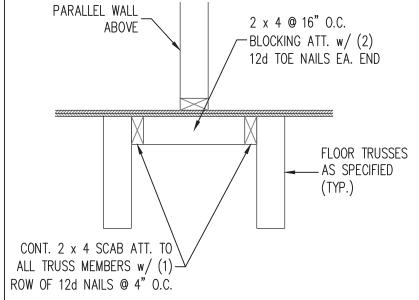

- 1. FLOOR TRUSSES ENGINEERED BY OTHERS AT THE DEPTH INDICATED ON THE PLAN SPACED AT 19.2" O.C. MAY BE USED IN LIEU OF I-JOISTS.
- 2. FIRST FLOOR SYSTEM TRUSSES ARE TO BE DESIGNED TO SUPPORT ADDITIONAL
- LOADING FROM OFFSET LOAD AND ISLAND. 3. AT POINT LOADS WITHIN OFFSET LOADS, INSTALL (2) 2 x 12 BLOCKING BETWEEN TRUSSES w/ FACE MOUNT HANGERS AT EA. END.
- 4. GIRDER TRUSSES ENGINEERED BY OTHERS ARE TO BE INSTALLED IN LIEU OF DOUBLE JOISTS SPECIFIED PER PLAN.
- 5. PROVIDE (1) LSL RIM BOARD MATCHING DEPTH OF FLOOR TRUSSES AT END OF CANT w/ EXTRA TRUSSES AT SIDES.
- 6. INSTALL 2 x 4 @ 16" O.C. BLOCKING BETWEEN ADJACENT TRUSSES UNDER WALLS PARALLEL TO FLOOR TRUSSES WHERE WALL LENGTH EXCEEDS 1/3 OF TRUSS SPAN (SEE DETAIL THIS SHEET). TRUSS DESIGNER TO DESIGN ADJACENT TRUSSES FOR ADDITIONAL LOADING FROM WALLS.

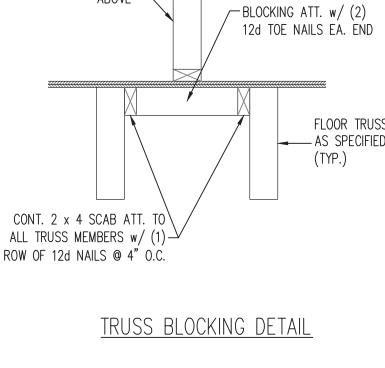

DATE: AUGUST 30, 2022 SCALE: NTS

DRAWN BY: JST

ENGINEERED BY: JST

FOUNDATION DETAILS

MASONRY STEMWALL SPECIFICATIONS MASONRY WALL TYPE WALL HEIGHT 4" BRICK AND 4" BRICK AND (FEET) 8" CMU 12" CMU 2 AND GROUT SOLID UNGROUTED UNGROUTED UNGROUTED BELOW UNGROUTED GROUT SOLID UNGROUTED UNGROUTED GROUT SOLID w/ #4 GROUT SOLID w/ #4 GROUT SOLID GROUT SOLID REBAR @ 64" O.C. REBAR @ 48" O.C. GROUT SOLID w/ #4 GROUT SOLID w/ #4 GROUT SOLID w/ #4 NOT APPLICABLE REBAR @ 36" O.C. REBAR @ 36" O.C. REBAR @ 64" O.C. GROUT SOLID w/ #4 GROUT SOLID w/ #4 GROUT SOLID w/ #4 NOT APPLICABLE 6 REBAR @ 24" O.C. REBAR @ 24" O.C. REBAR @ 64" O.C.

## STRUCTURAL NOTES:

ENGINEERED DESIGN BASED ON SITE CONDITIONS

- 1) WALL HEIGHT MEASURED FROM TOP OF FOOTING TO TOP OF THE WALL.
- 2) TIE MULTIPLE WYTHES TOGETHER WITH LADDER WIRE AT 16" O.C. VERTICALLY.
- 3) CHART APPLICABLE FOR HOUSE FOUNDATION ONLY, CONSULT ENGINEER FOR DESIGN OF GARAGE FOUNDATION NOT COMMON TO HOUSE.
- 4) BACKFILL OF CLEAN #57 / #67 WASHED STONE IS ALLOWABLE.
- 5) BACKFILL OF WELL DRAINED OR SAND GRAVEL MIXTURE SOILS (45 PSF/FT BELOW GRADE) CLASSIFIED AS GROUP I ACCORDING TO UNIFIED SOILS CLASSIFICATION SYSTEM IN ACCORDANCE WITH <u>TABLE R405.1</u> OF THE 2018 NORTH CAROLINA RESIDENTIAL CODE ARE ALLOWABLE.
- 6) PREP SLAB PER <u>R506.2.1</u> AND <u>R506.2.2</u> BASE AND <u>EXCEPTION</u> OF 2018 NORTH CAROLINA RESIDENTIAL CODE.
- 1) MINIMUM 24" LAP SPLICE LENGTH.

7 AND

GREATER

- 8) LOCATE REBAR IN CENTER OF FOUNDATION WALL.
- 9) WHERE REQUIRED, FILL BLOCK SOLID WITH TYPE "S" MORTAR OR 3000 PSI GROUT. USE OF "LOW LIFT GROUTING" METHOD REQUIRED WHEN FILLING WALLS WITH GROUT AT HEIGHTS OF 5' AND GREATER.

PLATE(\$)  A. BOLTS.  ING AND REMENTS  SHEATHING  LADDER WIRE IN TOP TWO COURSES (w/ VENEER ONLY) OPTIONAL BRICK VENEER  FINISHED GRADE  EVERY OTHER COURSE  SITEM WALL AND WALL REINFORCEMENT, SEE CHART FOR SPACING  IG WIDE BY 8" DEEP CONT. CONC. FTG.	2 x 4 STUD FRAMING (UNO) W/ TRTD. BOTTOM PLATE(S)  2 x 4 TRTD. BOTTOM PLATE(S)  3 ECURED BY 1/2" DIA. BOLTS.  3 EE CHART FOR \$PACING AND EMBEDMENT REQUIREMENTS  4" CONCRETE \$LAB W/ FIBER REINFORCING OR WELDED WIRE FABRIC  6 MIL. VAPOR BARRIER  4" WASHED STONE  UNDISTURBED EARTH, COMPACTED FILL OR WASHED STONE  TOP TWO COURSES OF STEM WALL AND ALL CELLS W/ REINFORCEMENT TO BE FILLED SOLID.  BRICK TIES 6  1'-0" VERTICALLY AND 2'-8" HORIZONTALLY 4" BRICK VENEER FLASHING EFEL HORIZONTALLY 5 ECHART FOR SPACING 20" WIDE BY 8" DEEP CONT. CONC. FTG.
STEM WALL FDN. DETAIL 1	STEM WALL FDN. W/ BRICK AND CURB 2
BRICK TIES @ I'-O" VERTICALLY AND 2'-8" HORIZONTALLY  BOLTS. NG AND EMENTS  FLASHING  WEEP HOLES	2 × 4 STUD FRAMING (UNO) W/ TRTD. BOTTOM PLATE(\$)  2 × 4 TRTD. BOTTOM PLATE(\$) SECURED BY 1/2" DIA. BOLTS. SEE CHART FOR SPACING AND EMBEDMENT REQUIREMENTS  4" CONCRETE SLAB W/ FIBER REINFORCING OR WELDED WIRE FABRIC  6 MIL. VAPOR BARRIER

2 x 4 STUD FRAMING (UNO) W/ TRTD. BOTTOM PLATE(9)  2 x 4 TRTD. BOTTOM PLATE(9)  3 x 4 TRTD. BOTTOM PLATE(9)  4 BRICK TIE3 @  1 - Ø' VERTICALLY AND  2 1 - Ø' VERTICALLY  4 I DRICK TIES  5 I DRICK TIES  4 I DRICK TIES  4 I DRICK TIES  4 I DRICK TIES  5 I DRICK TIES  4 I DRICK TIES  5 I DRICK TIES  4 I DRICK TIES  5 I DRICK TIES  5 I DRICK TIES  4 I DRICK TIES  5 I DRICK TIES	2 × 4 TRTD. BOTTOM PLATE(\$)  9ECURED BY 1/2" DIA. BOLTS.  SEE CHART FOR \$PACING AND EMBEDMENT REQUIREMENTS  4" CONCRETE \$LAB  W FIBER REINFORCING OR WELDED WIRE FABRIC  6 MIL. VAPOR  BARRIER  4" WASHED 9TONE  10P TWO COURSES OF STEM WALL AND  ALL CELLS W/ REINFORCEMENT TO BE FILLED \$0LID.  FLASHING  OPTIONAL 4" BRICK  VENEER WATERTABLE  WEEP HOLES  **COMPACTED FILL  OR WASHED 9TONE  TOP TWO COURSES OF STEM WALL AND  ALL CELLS W/ REINFORCEMENT TO BE FILLED \$0LID.  FOR OPTIONAL BRICK WATERTABLE, INCREASE TO 20" WIDE BY 8" DEEP CONT. CONC. FTG.
STEM WALL FDN. W/ BRICK DETAIL 3	STEM WALL FDN. W/ OPTIONAL  BRICK WATERTABLE DETAIL  4

2 x 4 STUD FRAMING (UNO) W/ TRTD. BOTTOM PLATE(S)

2 x 4 TRTD. BOTTOM PLATE(S)—

SECURED BY 1/2" DIA. BOLTS.

SEE CHART FOR SPACING AND EMBEDMENT REQUIREMENTS

THICKENED SLAB

4" CONCRETE SLAB-

6 MIL. VAPOR

UNDISTURBED EARTH,

COMPACTED FILL

OR WASHED STONE

TOP TWO COURSES OF STEM WALL AND

ALL CELLS W/ REINFORCEMENT TO BE

W/ FIBER REINFORCING OR WELDED WIRE FABRIC


4" WASHED STONE


NOT REQUIRED


ANCHOR SPACING AND EMBEDMENT			NOTE:		
WIND ZONE	120 MPH	130 MPH	THREADED ROD WITH EPOXY,		
SPACING	6'-0" O.C. INSTALL MIN. (2) ANCHORS PER PLATE SECTION AND (1) ANCHOR WITHIN 12" OF CORNERS	4'-0" O.C. INSTALL MIN. (2) ANCHORS PER PLATE SECTION AND (1) ANCHOR WITHIN 12" OF CORNERS	SIMPSON TITEN HD, OR APPROVED ANCHORS SPACED AS REQUIRED TO PROVIDE EQUIVALENT ANCHORAGE TO 1/2" DIAMETER ANCHOR BOLTS MAY BE USED IN LIEU OF 1/2" ANCHOR BOLTS.		
EMBEDMENT	7"	15" INTO MASONRY 7" INTO CONCRETE			


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- WALL BRACING DESIGNED IN ACCORDANCE WITH CHAPTER 6 OF THE 2018 NC RESIDENTIAL BUILDING CODE (NCRC). TABLES AND FIGURES REFERENCED ARE FROM THE 2018 NCRC.
- SEE THIS SHEET FOR GENERAL DETAILS. REFER TO THE 2018 NCRC FOR ADDITIONAL INFORMATION AS NEEDED BRACED EXTERIOR WALLS SUPPORTING ROOF TRUSSES AND RAFTERS, INCLUDING STORIES BELOW THE TOP FLOOR, HAVE BEEN DESIGNED PER R602.3.5 (3). WALL SHEATHING AND FASTENERS HAVE BEEN DESIGNED TO RESIST COMBINED UPLIFT AND SHEAR FORCES IN ACCORDANCE WITH ACCEPTED ENGINEERED PRACTICE.
- . SEE STRUCTURAL SHEETS FOR BRACED WALL LOCATIONS, DIMENSIONS, HOLD DOWN TYPE AND LOCATIONS, BRACED WALL LINE KEY WITH WALL DESIGN SUMMARY OF REQUIRED/PROVIDED TOTALS FOR EACH WALL LINE AND ANY SPECIAL NOTES OR REQUIREMENTS 5. ALL EXTERIOR WALLS ARE TO BE SHEATHED WITH CS-WSP IN ACCORDANCE WITH SECTION R602.10.3 UNLESS NOTED OTHERWISE.
- 6. ALL EXTERIOR AND INTERIOR WALLS TO HAVE 1/2" GYPSUM INSTALLED. WHEN NOT USING METHOD "GB", GYPSUM TO BE FASTENED PER TABLE R702.3.5. METHOD GB TO BE FASTENED PER TABLE R602.10.1
- 7. CS-WSP REFERS TO THE "CONTINUOUS SHEATHING WOOD STRUCTURAL PANELS" WALL BRACING METHOD. 7/16" OSB SHEATHING IS TO BE INSTALLED ON ALL EXTERIOR WALLS ATTACHED w/ 6d COMMON NAILS OR 8d (2 1/2" LONG x 0.113" DIAMETER) NAILS SPACED 6" O.C. ALONG PANEL EDGES AND 12" O.C. IN THE FIELD (U.N.O.).
- B. GB REFERS TO THE "GYPSUM BOARD" WALL BRACING METHOD. 1/2" (MIN.) GYPSUM WALL BOARD IS TO BE INSTALLED ON BOTH SIDES OF THE BRACED WALL FASTENED WITH 1 1/4" SCREWS OR 1 5/8" NAILS SPACED 7" O.C. ALONG PANEL EDGES INCLUDING TOP AND BOTTOM PLATES AND INTERMEDIATE SUPPORTS (U.N.O.). VERIFY ALL FASTENER OPTIONS FOR 1/2" AND 5/8" GYPSUM PRIOR TO CONSTRUCTION. FOR INTERIOR FASTENER OPTIONS SEE TABLE R702.3.5. FOR EXTERIOR FASTENER OPTIONS SEE TABLE R602.3(1). EXTERIOR GB TO BE INSTALLED VERTICALLY.
- REQUIRED BRACED WALL LENGTH FOR EACH SIDE OF THE CIRCUMSCRIBED RECTANGLE ARE INTERPOLATED PER TABLE R602. 10.3. METHOD CS-WSP CONTRIBUTES ITS ACTUAL LENGTH, METHOD GB CONTRIBUTES .5 ITS ACTUAL LENGTH, AND METHOD PF CONTRIBUTES 1.5 TIMES ITS ACTUAL LENGTH.



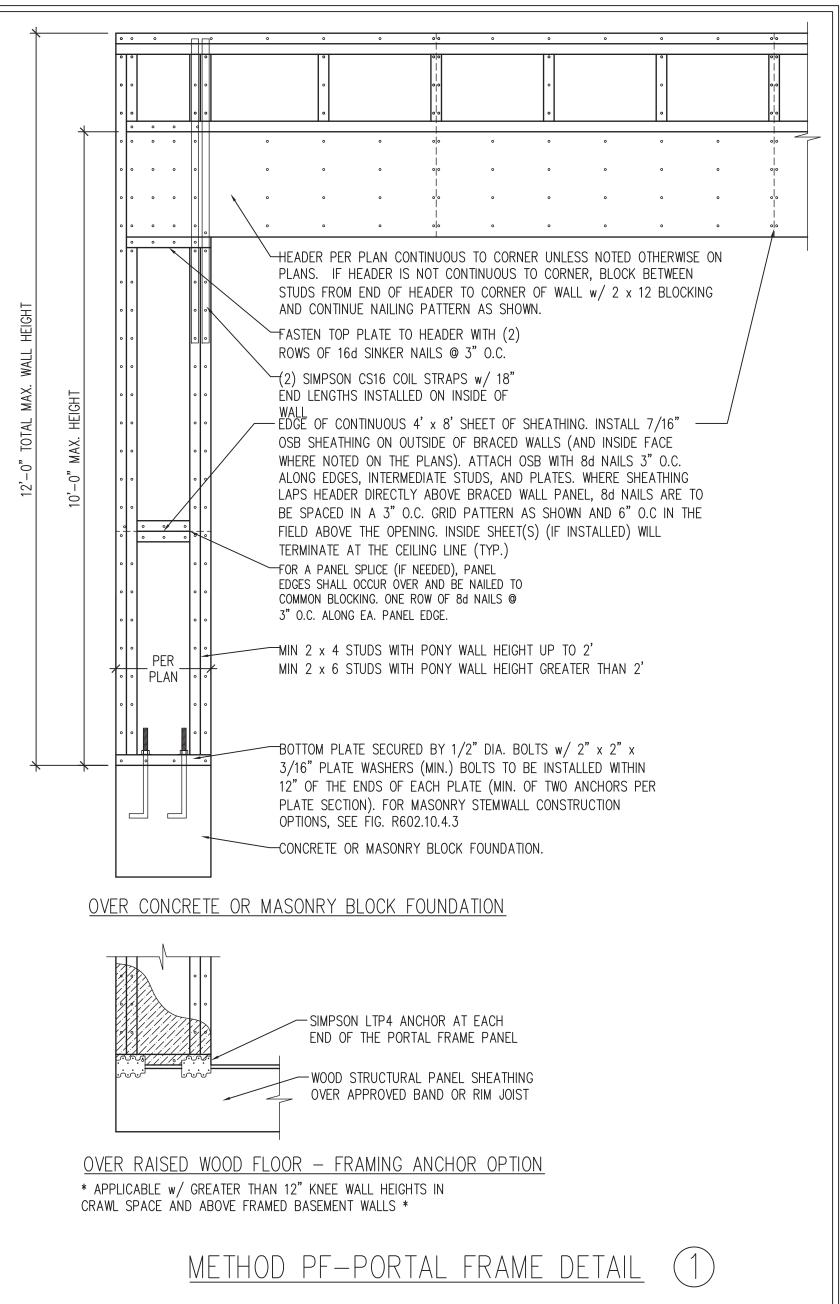


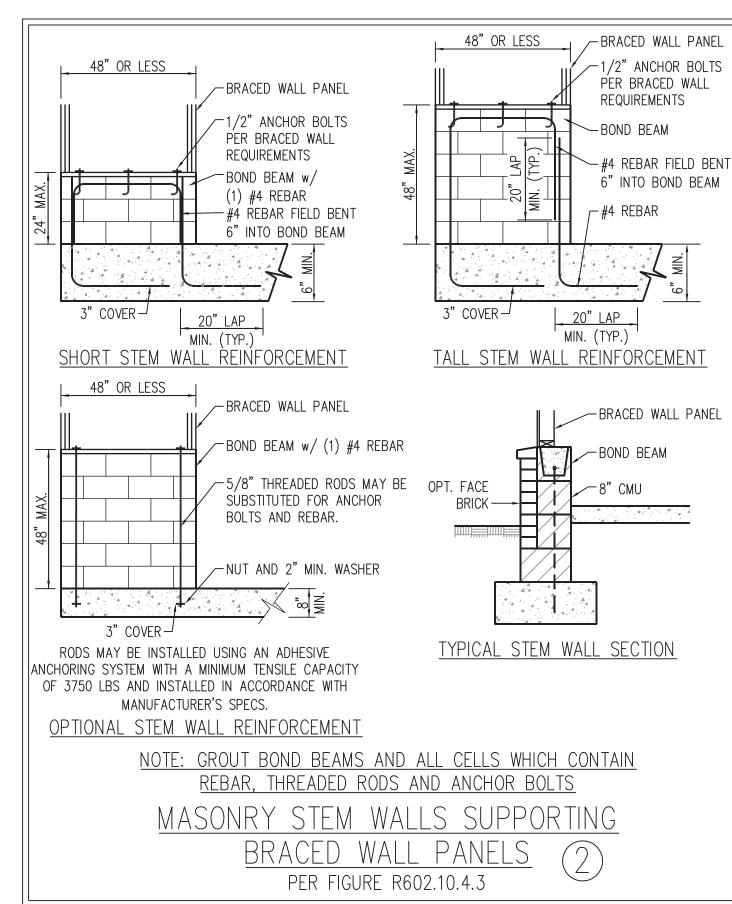

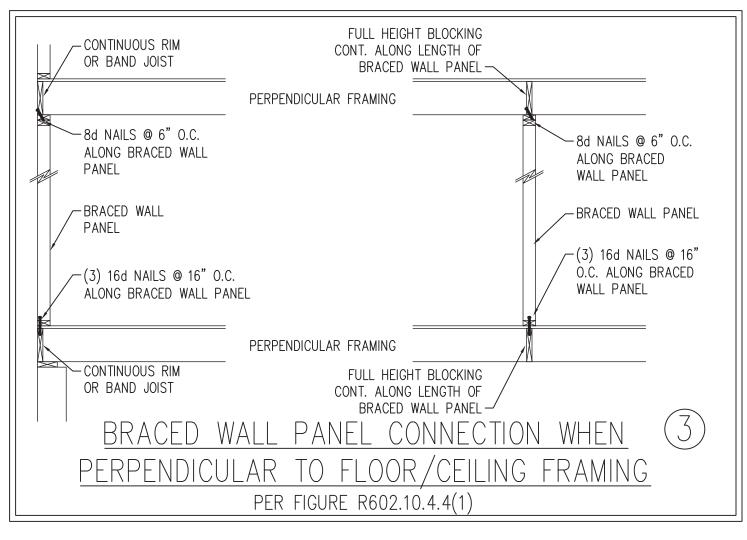


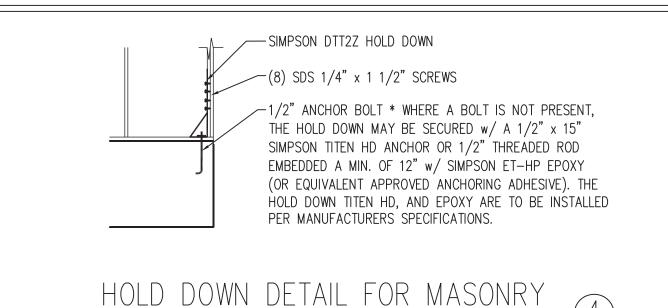
FOUNDATION OR MONOLITHIC SLAB


\* APPLICABLE ONLY WHERE SPECIFIED ON PLAN \*

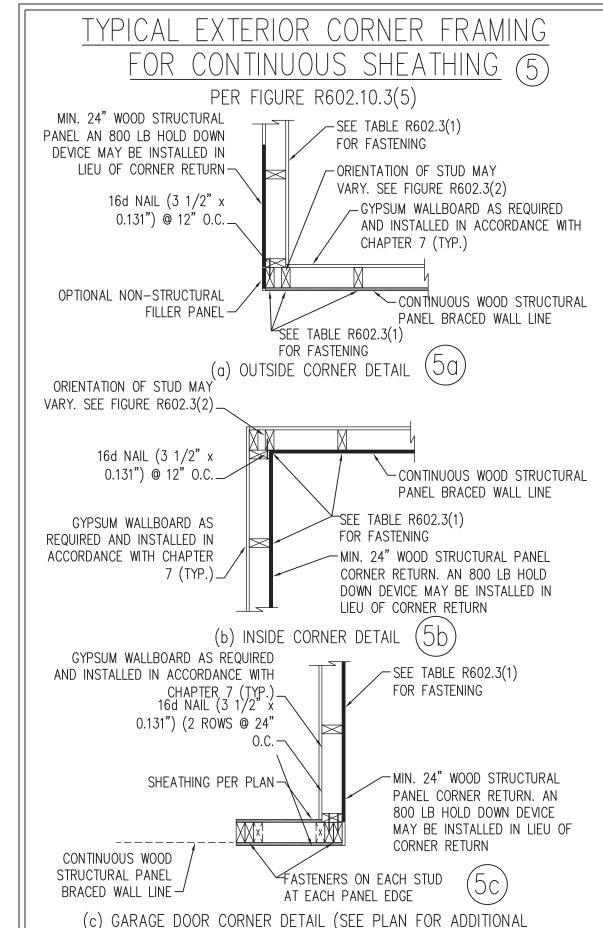


STRUCTURAL INFORMATION OR ALTERNATE CONFIGURATIONS)

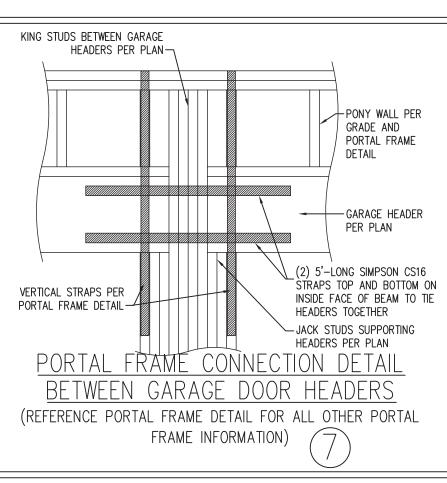

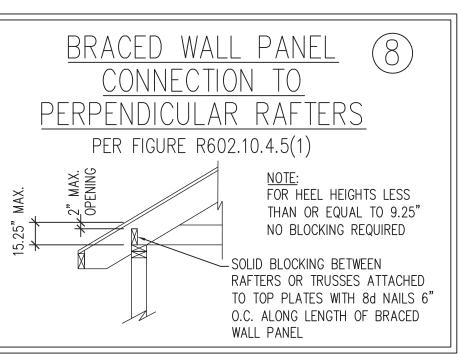

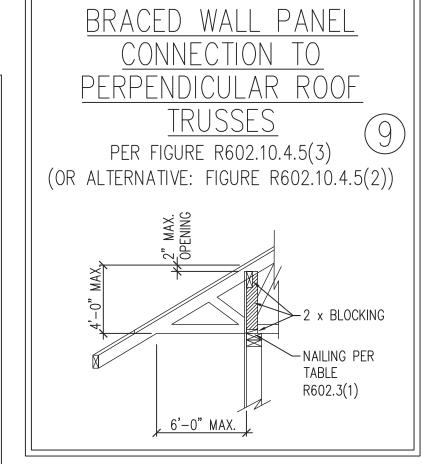

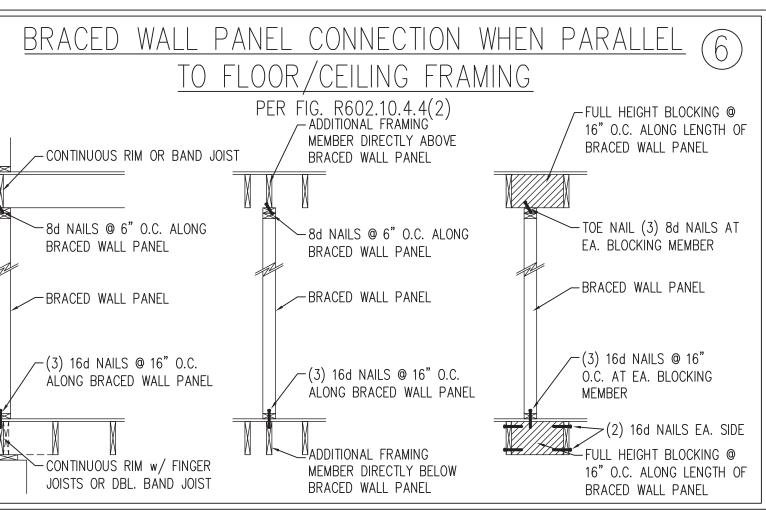

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10/20/2022

ANI BRACING

DATE: AUGUST 30, 2022

SCALE: 1/4" = 1'-0"

BRACED WALL NOTES AND DETAILS AND PF DETAIL

## 1. ALL FRAMING LUMBER SHALL BE #2 SPF MINIMUM (Fb = 875 PSI, Fv = 375 PSI, E = 1600000 PSI) UNLESS NOTED OTHERWISE (UNO). ALL TREATED LUMBER SHALL BE #2 SYP MINIMUM (Fb = 975 PSI, Fv = 175 PSI, E = 1600000 PSI) UNLESS NOTED OTHERWISE (UNO). 2. LAMINATED VENEER LUMBER (LVL) SHALL HAVE THE FOLLOWING MINIMUM PROPERTIES: Fb = 2600 PSI, Fv = 285 PSI, E = 1900000 PSI. LAMINATED

STRAND LUMBER (LSL) SHALL HAVE THE FOLLOWING MINIMUM PROPERTIES: Fb = 2325 PSI, Fv = 310 PSI, E = 1550000 PSI. PARALLEL STRAND LUMBER (PSL) UP TO 7" DEPTH SHALL HAVE THE FOLLOWING MINIMUM PROPERTIES: Fc = 2500 PSI, E =1800000 PSI. PARALLEL STRAND LUMBER (PSL) MORE THAN 7" DEPTH SHALL HAVE THE FOLLOWING MINIMUM PROPERTIES: Fc = 2900 PSI, E = 2000000 PSI. INSTALL ALL CONNECTIONS

4. STEEL BEAMS SHALL BE SUPPORTED AT EACH END WITH A MINIMUM BEARING LENGTH OF 3 1/2" AND FULL FLANGE WIDTH (UNO). PROVIDE SOLID BEARING FROM BEAM SUPPORT TO FOUNDATION. BEAMS SHALL BE ATTACHED AT THE BOTTOM FLANGE TO EACH SUPPORT AS FOLLOWS (UNO):

ASTM A53, GRADE B, TYPE E OR S

FRAMING NOTES

A. WOOD FRAMING (2) 1/2" DIA. x 4" LONG LAG SCREWS (2) 1/2" DIA. x 4" WEDGE ANCHORS B. CONCRETE (2) 1/2" DIA. x 4" LONG SIMPSON TITEN HD ANCHORS C. MASONRY (FULLY GROUTED) (4) 3/4" DIA. A325 BOLTS OR 3/16" FILLET WELD D. STEEL PIPE COLUMN

ASTM A992

ASTM A36

ASTM A36

ASTM A500 GRADE B

PER MANUFACTURER'S SPECIFICATIONS.

W AND WT SHAPES:

PLATES AND BARS:

STEEL PIPE:

CHANNELS AND ANGLES:

HOLLOW STRUCTURAL SECTIONS:

3. STRUCTURAL STEEL SHALL CONFORM TO THE FOLLOWING ASTM SPECIFICATIONS

LATERAL SUPPORT IS CONSIDERED ADEQUATE PROVIDING THE JOISTS ARE TOE NAILED TO THE 2x NAILER ON TOP OF THE STEEL BEAM, AND THE 2x NAILER IS SECURED TO THE TOP OF THE STEEL BEAM w/(2) ROWS OF SELF TAPPING SCREWS @ 16" O.C. OR (2) ROWS OF 1/2" DIAMETER BOLTS @ 16" O.C. IF 1/2" BOLTS ARE USED TO FASTEN THE NAILER, THE STEEL BEAM SHALL BE FABRICATED w/ (2) ROWS OF 9/16" DIAMETER HOLES @ 16" O.C.

- 5. SQUARES DENOTE POINT LOADS WHICH REQUIRE SOLID BLOCKING TO GIRDER OR FOUNDATION. SHADED SQUARES DENOTE POINT LOADS FROM ABOVE WHICH REQUIRE SOLID BLOCKING TO SUPPORTING MEMBER BELOW.
- 6. ALL LOAD BEARING HEADERS TO CONFORM TO TABLE R602.7(1) AND R602.7(2) OF THE NCRC, 2018 EDITION OR BE (2) 2 x 6 WITH (1) JACK AND (1) KING STUD EACH END (UNO), WHICHEVER IS GREATER ALL HEADERS TO BE SECURED TO EACH JACK STUD WITH (4) 8d NAILS. ALL BEAMS TO BE SUPPORTED WITH (2) STUDS AT EACH BEARING POINT (UNO). INSTALL KING STUDS PER SECTION R602.7.5 OF THE NORTH CAROLINA RESIDENTIAL CODE, 2018 EDITION.
- 7. ALL BEAMS, HEADERS, OR GIRDER TRUSSES PARALLEL TO WALL ARE TO BEAR FULLY ON (1) JACK OR (2) STUDS MINIMUM OR THE NUMBER OF JACKS OR STUDS NOTED. ALL BEAMS OR GIRDER TRUSSES PERPENDICULAR TO WALL AND SUPPORTED BY (3) STUDS OR LESS ARE TO HAVE 1 1/2" MINIMUM BEARING (UNO). ALL BEAMS OR GIRDER TRUSSES PERPENDICULAR TO WALL AND SUPPORTED BY MORE THAN (3) STUDS OR OTHER NOTED COLUMN ARE TO BEAR FULLY ON SUPPORT COLUMN FOR ENTIRE WALL DEPTH (UNO). BEAM ENDS THAT BUTT INTO ONE ANOTHER ARE TO EACH BEAR EQUAL LENGTHS (UNO).
- 8. FLITCH BEAMS SHALL BE BOLTED TOGETHER USING 1/2" DIAMETER BOLTS (ASTM A307) WITH WASHERS PLACED AT THREADED END OF BOLT. BOLTS SHALL BE SPACED AT 24" CENTERS (MAXIMUM). AND STAGGERED AT TOP AND BOTTOM OF BEAM (2" EDGE DISTANCE). WITH (2) BOLTS LOCATED AT 6" FROM EACH END (UNO).
- 9. ALL I-JOIST OR TRUSS LAYOUTS ARE TO BE IN COMPLIANCE WITH THE OVERALL DESIGN SPECIFIED ON THE PLANS. ALL DEVIATIONS ARE TO BE BROUGHT TO THE ATTENTION OF THE ENGINEER OF RECORD PRIOR TO INSTALLATION.
- 10. BRACED WALL PANELS SHALL BE CONSTRUCTED ACCORDING TO THE NORTH CAROLINA RESIDENTIAL CODE 2018 EDITION WALL BRACING CRITERIA. THE AMOUNT, LENGTH, AND LOCATION OF BRACING SHALL COMPLY WITH ALL APPLICABLE TABLES IN SECTION R602.10.
- 11. PROVIDE DOUBLE JOIST UNDER ALL WALLS PARALLEL TO FLOOR JOISTS. PROVIDE SUPPORT UNDER ALL WALLS PARALLEL TO FLOOR TRUSSES OR I-JOISTS PER MANUFACTURER'S SPECIFICATIONS. INSTALL BLOCKING BETWEEN JOISTS OR TRUSSES FOR POINT LOAD SUPPORT FOR ALL POINT LOADS ALONG OFFSET LOAD LINES.
- 12. FOR ALL HEADERS SUPPORTING BRICK VENEER THAT ARE LESS THAN 8'-0" IN LENGTH, REST A 6" x 4" x 5/16" STEEL ANGLE WITH 6" MINIMUM EMBEDMENT AT SIDES FOR BRICK SUPPORT (U.N.O). FOR ALL HEADERS 8'-0" AND GREATER IN LENGTH, BOLT A 6" x 4" x 5/16" STEEL ANGLE TO HEADER WITH 1/2" LAG SCREWS AT 12" O.C. STAGGERED FOR BRICK SUPPORT. FOR ALL BRICK SUPPORT AT ROOF LINES, BOLT A 6" x 4" x 5/16" STEEL ANGLE TO (2) 2 x 10 BLOCKING INSTALLED w/ (4) 12d NAILS EA. PLY BETWEEN WALL STUDS WITH (2) ROWS OF 1/2" LAG SCREWS AT 12" O.C. STAGGERED AND IN ACCORDANCE WITH SECTION R703.8.2.1 OF THE NCRC, 2018 EDITION.
- 13. FOR STICK FRAMED ROOFS: CIRCLES DENOTE (3) 2 x 4 POSTS FOR ROOF MEMBER SUPPORT. HIP SPLICES ARE TO BE SPACED A MINIMUM OF 8'-0". FASTEN MEMBERS WITH THREE ROWS OF 12d NAILS AT 16" O.C. FRAME DORMER WALLS ON TOP OF DOUBLE OR TRIPLE RAFTERS AS SHOWN (UNO).
- 14. FOR TRUSSED ROOFS: FRAME DORMER WALLS ON TOP OF 2 x 4 LADDER FRAMING AT 24" O.C. BETWEEN ADJACENT ROOF TRUSSES. STICK FRAME OVER-FRAMED ROOF SECTIONS WITH 2 x 8 RIDGES, 2 x 6 RAFTERS AT 16" O.C. AND FLAT 2 x 10 VALLEYS (UNO).
- 15. ALL 4 x 4 AND 6 x 6 POSTS TO BE INSTALLED WITH 700 LB CAPACITY UPLIFT CONNECTORS TOP AND BOTTOM (UNO.) POSTS MAY BE SECURED USING ONE SIMPSON H6 OR LTS12 UPLIFT CONNECTOR FASTENED TO THE BAND AT THE BOTTOM AND THE BEAM AT THE TOP OF EACH POST. ONE 16" SECTION OF SIMPSON CS16 COIL STRAPPING WITH (8) 8d HDG NAILS AT EACH END MAY BE USED IN LIEU OF EACH TWIST STRAP IF DESIRED. FOR MASONRY OR CONCRETE FOUNDATION USE SIMPSON POST BASE.

### GENERAL NOTES

- 1. ENGINEER'S SEAL APPLIES ONLY TO STRUCTURAL COMPONENTS INCLUDING ROOF RAFTERS, HIPS, VALLEYS, RIDGES, FLOORS, WALLS, BEAMS, HEADERS, COLUMNS, CANTILEVERS, OFFSET LOAD BEARING WALLS, PIERS, GIRDER SYSTEM AND FOOTING. ENGINEER'S SEAL DOES NOT CERTIFY DIMENSIONAL ACCURACY OF ARCHITECTURAL LAYOUT INCLUDING ROOF. ENGINEER'S SEAL DOES NOT APPLY TO I-JOIST OR FLOOR/ROOF TRUSS LAYOUT DESIGN AND ACCURACY.
- 2. ALL CONSTRUCTION SHALL CONFORM TO THE LATEST REQUIREMENTS OF THE NORTH CAROLINA RESIDENTIAL CODE (NCRC), 2018 EDITION, PLUS ALL LOCAL CODES AND REGULATIONS. THE STRUCTURAL ENGINEER IS NOT RESPONSIBLE FOR, AND WILL NOT HAVE CONTROL OF, CONSTRUCTION MEANS, METHODS, TECHNIQUES, SEQUENCES OR PROCEDURES, OR SAFETY PRECAUTIONS AND PROGRAMS IN CONNECTION WITH THE CONSTRUCTION WORK. NOR WILL THE ENGINEER BE RESPONSIBLE FOR THE CONTRACTORS FAILURE TO CARRY OUT THE CONSTRUCTION WORK IN ACCORDANCE WITH THE CONTRACT DOCUMENTS.
- 3. STRUCTURAL DESIGN BASED ON THE PROVISIONS OF THE NCRC, 2018 EDITION (R301.4 R301.7)

DESIGN CRITERIA:	LIVE LOAD (PSF)	DEAD LOAD (PSF)	DEFLECTION (IN)	
ATTIC WITH LIMITED STORAGE	20	10	L/240 (L/360 w/ BRITTLE FINISHES)	
ATTIC WITHOUT STORAGE	10	10	L/360	
DECKS	40	10	L/360	
EXTERIOR BALCONIES	40	10	L/360	
FIRE ESCAPES	40	10	L/360	
HANDRAILS/GUARDRAILS	200	10	L/360	
PASSENGER VEHICLE GARAGE	50	10	L/360	
ROOMS OTHER THAN SLEEPING ROOM	40	10	L/360	
SLEEPING ROOMS	30	10	L/360	
STAIRS	40	10	L/360	
WIND LOAD	(BASED ON TABLE R301.	(BASED ON TABLE R301.2(4) WIND ZONE AND EXPOSURE)		
GROUND SNOW LOAD: Pg	20 (PSF)	,		

- I-JOIST SYSTEMS DESIGNED WITH 12 PSF DEAD LOAD AND DEFLECTION (IN) OF L/480 - FLOOR TRUSS SYSTEMS DESIGNED WITH 15 PSF DEAD LOAD

- 4. FOR 115 AND 120 MPH WIND ZONES, FOUNDATION ANCHORAGE IS TO COMPLY WITH SECTION R403.1.6 OF THE NCRC, 2018 EDITION. FOR 130 MPH, 140 MPH, AND 150 MPH WIND ZONES, FOUNDATION ANCHORAGE IS TO COMPLY WITH SECTION 4504 OF THE NCRC, 2018 EDITION.
- 5. ENERGY EFFICIENCY COMPLIANCE AND INSULATION VALUES OF THE BUILDING TO BE IN ACCORDANCE WITH CHAPTER 11 OF THE NCRC, 2018 EDITION.

## FOOTING AND FOUNDATION NOTES

- 1. FOUNDATION DESIGN BASED ON A MINIMUM ALLOWABLE BEARING CAPACITY OF 2000 PSF. CONTACT GEOTECHNICAL ENGINEER IF BEARING CAPACITY IS NOT ACHIEVED.
- 2. FOR ALL CONCRETE SLABS AND FOOTINGS, THE AREA WITHIN THE PERIMETER OF THE BUILDING ENVELOPE SHALL HAVE ALL VEGETATION, TOP SOIL AND FOREIGN MATERIAL REMOVED. FILL MATERIAL SHALL BE FREE OF VEGETATION AND FOREIGN MATERIAL. THE FILL SHALL BE COMPACTED TO ASSURE UNIFORM SUPPORT OF THE SLAB, AND EXCEPT WHERE APPROVED, THE FILL DEPTHS SHALL NOT EXCEED 24" FOR CLEAN SAND OR GRAVEL. A 4" THICK BASED COURSE CONSISTING OF CLEAN GRADED SAND OR GRAVEL SHALL BE PLACED. A BASE COURSE IS NOT REQUIRED WHERE A CONCRETE SLAB IS INSTALLED ON WELL-DRAINED OR SAND-GRAVEL MIXTURE SOILS CLASSIFIED AS GROUP 1, ACCORDING TO THE UNITED SOIL CLASSIFICATION SYSTEM IN ACCORDANCE WITH TABLE R405.1 OF THE NCRC, 2018 EDITION.
- 3. PROPERLY DEWATER EXCAVATION PRIOR TO POURING CONCRETE WHEN BOTTOM OF CONCRETE SLAB IS AT OR BELOW WATER TABLE. IF APPLICABLE, 3/4" — 1" DEEP CONTROL JOINTS ARE TO BE SAWED WITHIN 4 TO 12 HOURS OF CONCRETE FINISHING AND WALL LOCATIONS HAVE BEEN MARKED. ADJUST WHERE NECESSARY.
- 4. CONCRETE SHALL CONFORM TO SECTION R402.2 OF THE NCRC, 2018 EDITION. CONCRETE REINFORCING STEEL TO BE ASTM A615 GRADE 60. WELDED WIRE FABRIC TO BE ASTM A185. MAINTAIN A MINIMUM CONCRETE COVER AROUND REINFORCING STEFL OF 3" IN FOOTINGS AND 1 1/2" IN SLABS. FOR POURED CONCRETE WALLS, CONCRETE COVER FOR REINFORCING STEEL MEASURED FROM THE INSIDE FACE OF THE WALL SHALL NOT BE LESS THAN 3/4". CONCRETE COVER FOR REINFORCING STEEL MEASURED FROM THE OUTSIDE FACE OF THE WALL SHALL NOT BE LESS THAN 1 1/2" FOR #5 BARS OR SMALLER, AND NOT LESS THAN 2" FOR #6 BARS OR LARGER.
- 5. MASONRY UNITS TO CONFORM TO ACE 530/ASCE 5/TMS 402. MORTAR SHALL CONFORM TO ASTM C270.
- 6. THE UNSUPPORTED HEIGHT OF MASONRY PIERS SHALL NOT EXCEED FOUR TIMES THEIR LEAST DIMENSION FOR UNFILLED HOLLOW CONCRETE MASONRY UNITS AND TEN TIMES THEIR LEAST DIMENSION FOR SOLID OR SOLID FILLED PIERS. PERS MAY BE FILLED SOLID WITH CONCRETE OR TYPE M OR S MORTAR. PIERS AND WALLS SHALL BE CAPPED WITH 8" OF SOLID MASONRY.
- 7. THE CENTER OF EACH OF THE PIERS SHALL BEAR IN THE MIDDLE THIRD OF ITS RESPECTIVE FOOTING. EACH GIRDER SHALL BEAR IN THE MIDDLE THIRD OF THE PIERS.
- 8. ALL CONCRETE AND MASONRY FOUNDATION WALLS ARE TO BE CONSTRUCTED IN ACCORDANCE WITH THE PROVISIONS OF SECTION R404 OF THE NCRC, 2018 EDITION OR IN ACCORDANCE WITH ACI 318, ACI 332, NCMA TR68-A OR ACE 530/ASCE 5/TMS 402. MASONRY FOUNDATION WALLS ARE TO BE REINFORCED PER TABLE R404.1.1(1), R404.1.1(2), R404.1.1(3), OR R404.1.1(4) OF THE NCRC, 2018 EDITION. CONCRETE FOUNDATION WALLS ARE TO BE REINFORCED PER TABLE R404.1.1(5) OF THE NCRC, 2018 EDITION. STEP CONCRETE FOUNDATION WALLS TO 2 x 6 FRAMED WALLS AT 16" O.C. WHERE GRADE PERMITS (UNO).

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**S** AR

ENGINEERED BY: JST

DATE: AUGUST 30, 2022

DRAWN BY: JST