

SHEET COVER

Dream Finders Homes

# OME H DER CKSON RE

ATE: FEBURARY 27 20

EV. DECEMBER 01, 2023

RAWN BY-

GINEERED BY

VIEWED BY-

# **JACKSON REVISION LIST - STRUCTURAL:**


- ADDED FRAMING AND FOUNDATION FOR 3 CAR GARAGE AND 1-CAR WITH SIDE LOAD
- EXTENDED NOOK BEAM, ADDED FRAMING FOR SECOND FLOOR OPTIONS (ADDED EXTRA JOISTS AND SHIFTED BEAMS AT FOYER
- ADDED FRAMING AND FOUNDATION FOR SMALLER MASTER SUITE
- ADDED I-JOIST SERIES/SPACING
- RECONFIGURED CRAWL TO HAVE ALL JOISTS RUNNING FRONT TO BACK
- REMOVED PARTIAL CRAWL FRAMING FROM BASEMENT AND EXTENDED BASEMENT FRAMING BELOW KITCHEN
- CHANGED TO 2 x 6 HEADERS WHERE APPLICABLE (5-18)
- FLOORED OPTION FOR BONUS ROOM AND REVISED HEADER FOR FLOOR LOADS (5-18)
- ADDED HEADERS FOR FIREPLACE OPTIONS (5-18)
- 10. REMOVED BEAM FOR OLD MEDIA ROOM LOCATION (5-18)
- 11. 2 x 6 GARAGE WING WALLS (5-18)
- MODIFIED STRAPPING NOTE FOR DOUBLE GARAGE DOOR (5-18)
- 13. UPDATED STRUCTURAL NOTES (5-18)
- 14. REMOVED ROOF TRUSS BEARING AT REVISED SECOND FLOOR BATH LOCATION (5-18)
- 15. CHANGED FRONT PORCH POSTS TO 6X6 FOR (3) PLY BEAM (2-19)
- ADDED MEDIA OPTION BACK MOVED LVL ON SECOND FLOOR FRAMING, EXTRA JOIST, ATTIC FRAMING PLAN (2-19) 16.
- 17. CODE UPDATE TO 2018 NC IRC (2-19)
- 18. CODE UPDATE TO 2018 SC IRC (1-16)
- CODE UPDATE TO 2021 SC IRC (12-01-22)
- WINDOW LOCATION AND SIZE CHANGE IN OPTIONAL OWNER'S BATH 3 (12-01-22)

# **JACKSON REVISION LIST - ARCHITECTURAL:**

- REMOVED LOGO FROM TITLE BLOCK ON ALL SHEETS (05-01-20)
- REMOVED SHINGLE HATCH FROM ALL ELEVATIONS (05-01-20)
- CHANGED CORNER BOARDS ON ELEVATIONS TO 4" INSTEAD OF 6" (05-01-20)
- CHANGED NOTE FOR GARAGE DOOR ON ALL ELEVATIONS (05-01-20)
- REMOVED GRIDS FROM ALL SIDE AND REAR ELEVATIONS (05-01-20)
- REMOVED GRIDS FROM ALL TRANSOMS AND SIDE LIGHTS AT ALL FRONT DOORS (05-01-20)
- UPDATED HATCH TO REPRESENT STONE ON ALL ELEVATIONS WITH STONE (05-01-20)
- ADDED ELEVATIONS TO SHOW BOTH STONE AND BRICK OPTIONS ON ELEVATIONS (05-01-20)
- DIMENSIONED WATER TABLE ON ALL ELEVATIONS WHERE APPLICABLE (05-01-20)
- DELETED DUPLICATE DIMENSIONS ON ELEVATIONS (05-01-20)
- 11. HATCHED ROWLOCK AROUND WINDOWS WHERE NEEDED (05-01-20)
- 12. ADDED COLUMN DETAIL ON B ELEVATIONS (05-01-20)
- REMOVED HARDWARE FROM SHUTTERS ON ALL C ELEVATIONS (05-01-20) 13
- VERIFIED COACH LIGHT LOCATIONS ON ELEVATIONS ALONG WITH ELECTRICAL SHEETS (05-01-20)
- 15. UPDATED SLAB INTERFACE SHEET (05-01-20)
- ADDED DIAGONAL DIMENSIONS TO SLAB INTERFACE (05-01-20) 16.
- 17. ADDED CONDUIT FROM ISLAND TO BEHIND OPTIONAL REFRIGERATOR (05-01-20)
- RELOCATED OPTIONS TO SEPARATE SHEET (A-4.4) (05-01-20) 18.
- ADDED PARTIAL PLANS TO SHOW SEPARATE FRONT ELEVATION LAYOUTS TO APPLICABLE LAYUOUT (05-01-20) 19.
- 20. VERIFIED ALL ROOM SIZES (05-01-20)
- CHANGED ALL WALLS FROM 2x6 TO 2x4 EXCEPT WHERE SHADED (05-01-20)
- VERIFIED AND UPDATED SQUARE FOOTAGE/ADDED SQUARE FOOTAGE BLOCK FOR FULL BRICK VENEER (05-01-20)
- 23 ADDED OPTIONAL GAS LINE (05-01-20)
- REMOVED ACCESS AND NOTE FOR "OPT WHIRLPOOL TUB" IN OWNER'S BATH AND FLIPPED TUB (05-01-20) 24.
- CHANGED STANDARD OWNER'S BATH TO OWNER'S BATH 1 LAYOUT/ADDED OWNER'S BATH 2 & BATH 3 (05-01-20)
- CHANGED STANDARD COVERED PORCH LAYOUT TO REPRESENT ELEVATION "A" (05-01-20)
- NOTED ALL PLUMBING DROPS (05-01-20)
- VERIFIED VENTILATION AND LIGHT REQUIREMENTS AT OWNER'S BEDROOM MEETS CODE. (05-01-20)
- TRAY CEILING IN OWNER'S BEDROOM SQUARED OFF AND CHANGED TO DROPPED 6" (05-01-20)
- 30. ADDED HOSE BIB LOCATIONS TO OPPOSITE SIDES OF PLAN (05-01-20)
- 31. CHANGED NAME "BONUS ROOM" ON SECOND FLOOR TO "RECREATION ROOM" (05-01-20)
- REMOVED NUMBERS FROM ALL STAIRS (05-01-20)
- REMOVED NUMBER SIGNS FROM ROOM TITLES (05-01-20)
- ADDED NOTE FOR DOOR LEADING TO STORAGE IN SECOND FLOOR (05-01-20)
- ADDED NOTE FOR "PDS ATTIC ACCES" ON SECOND FLOOR (05-01-20)
- REMOVED FIREPLACE OPTION FROM SECOND FLOOR (05-01-20)
- TRAY CEILING IN SECOND OWNER'S BEDROOM SQUARED OFF AND CHANGED TO RAISED 10" (05-01-20)
- ADDED 3x3 CONCRETE PAD TO ALL DOORS NOT LEADING OUT TO PORCH/PATIO (05-01-20)
- UPDATED ELECTRICAL KEY ON ALL ELECTRICAL PLANS (05-01-20)
- CHANGED ALL CEILING FANS TO OPTIONAL ADDED NOTE "STD LIGHT, OPT. FAN/LT PREWIRE" (05-01-20)
- REMOVED ALL WALL OUTLETS, TV OUTLETS, AND PHONE OUTLETS (05-01-20)
- CHANGED PENDANT LIGHTS TO OPTIONAL (05-01-20)
- ADDED STANDARD 2 BULB FLUORESCENT LIGHT TO KITCHEN (05-01-20)
- 44. VERIFIED SMOKE DETECTORS AND ADDED CO2 DETECTORS (05-01-20)
- 45. ADDED AND VERIFIED ROOF VENT CALCULATIONS (05-01-20)
- REMOVED CEILING LIGHT FROM SECONDARY BATHROOM OVER TUB/SHOWER COMBO (05-01-20)
- REMOVED SECOND DOOR AND 2 WINDOWS FROM OPTIONAL BASEMENT (05-01-20)
- CHANGED SERVICE DOOR TO SWING OUT (05-01-20)
- UPDATED DOOR TO BATH 4 W/ OPTIONAL MEDIA ROOM TO 2/4 FROM 2/0

CHANGES DECEMBER 01, 2022

CHANGED WINDOW IN OPTIONAL OWNER'S BATH 3 FROM 2/0 4/0 TO 4/0 1/0 TRANSOM

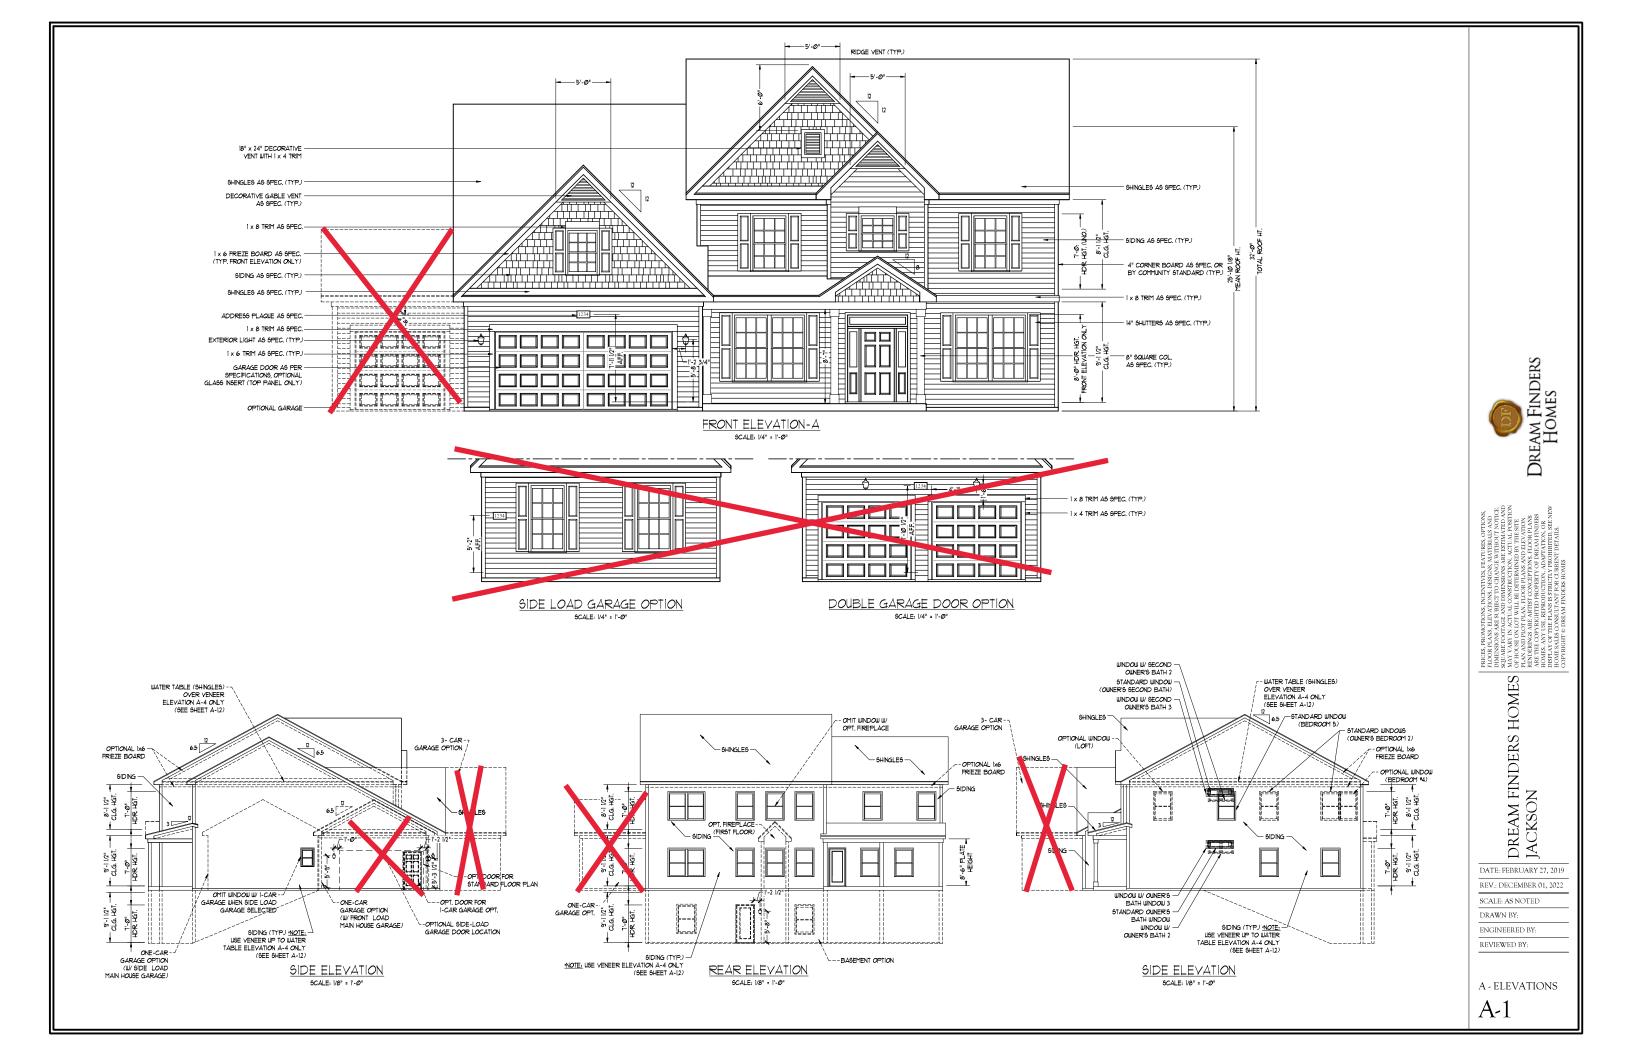





PRICES, PROMO FLOOR PLANS, E DIMENSIONS AND SOUNCE FOOTO MAY VARY IN A MAY VARY IN A MAY VARY IN A PLAN AND PLOT RENDERINGS AF HOMES ARY US DISPLAY OF THI HOMES ARY US DISPLAY OF THI HOME SALES CC COPYRIGHT SO

DREAM FINDERS HOMES JACKSON

DATE: FEBRUARY 27, 2019

REV.: DECEMBER 01, 2022


SCALE: AS NOTED DRAWN BY:


ENGINEERED BY:


REVIEWED BY: ELEVATIONS A-2

& A-3 WITH STONE

A-1.1

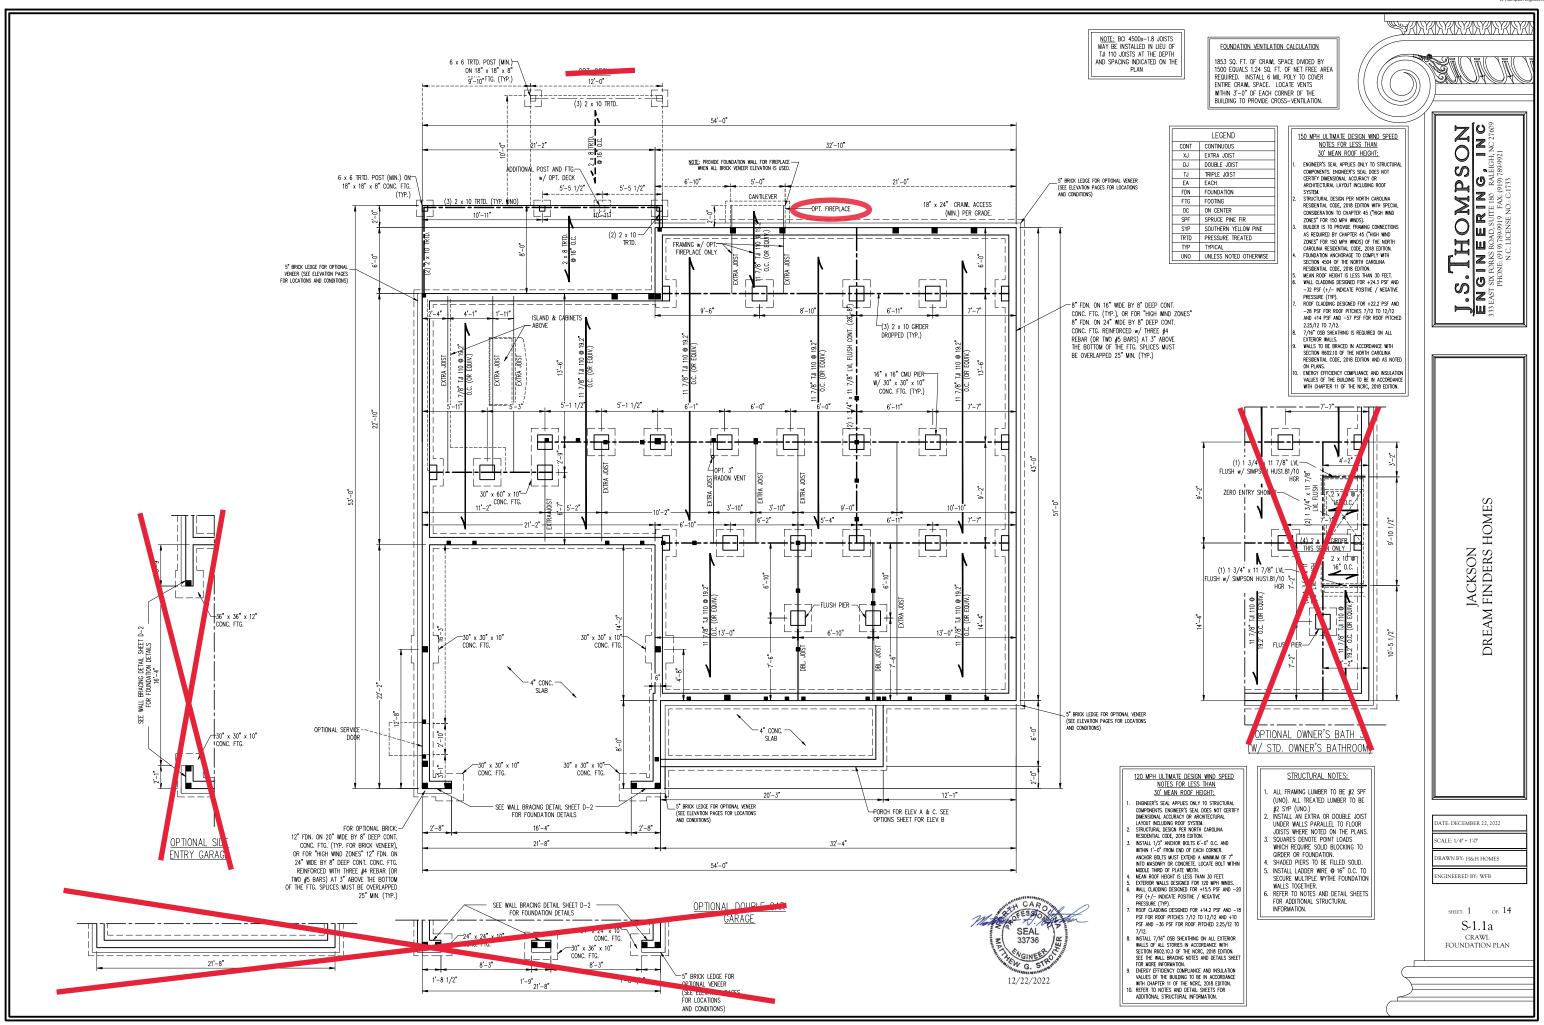

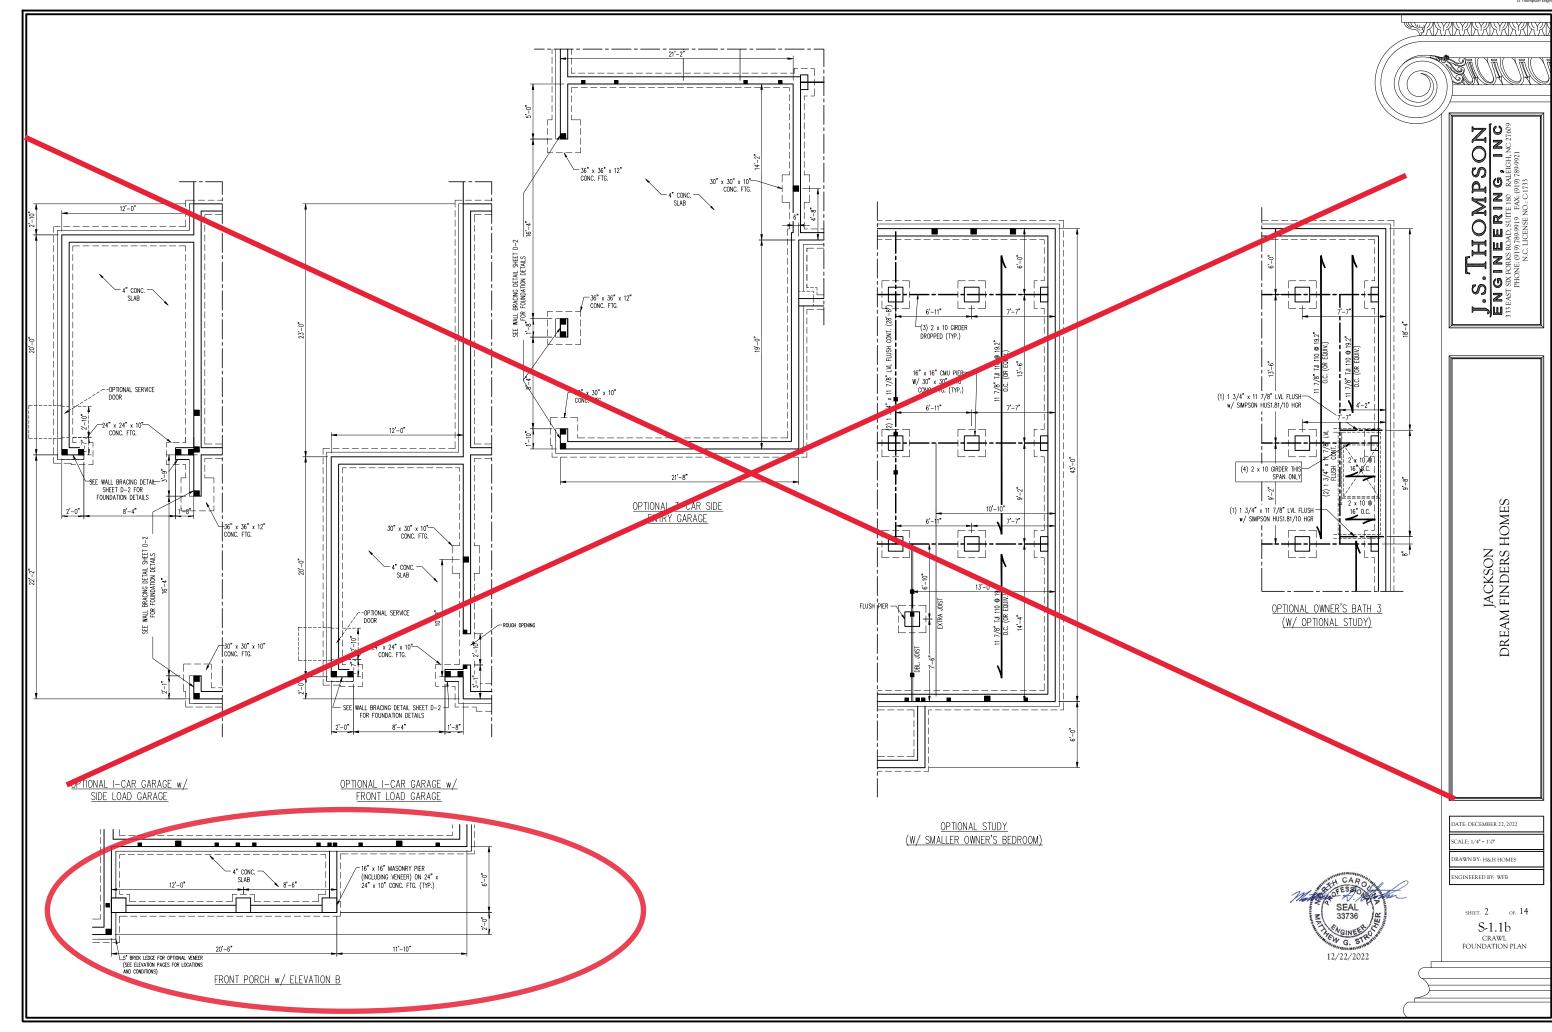

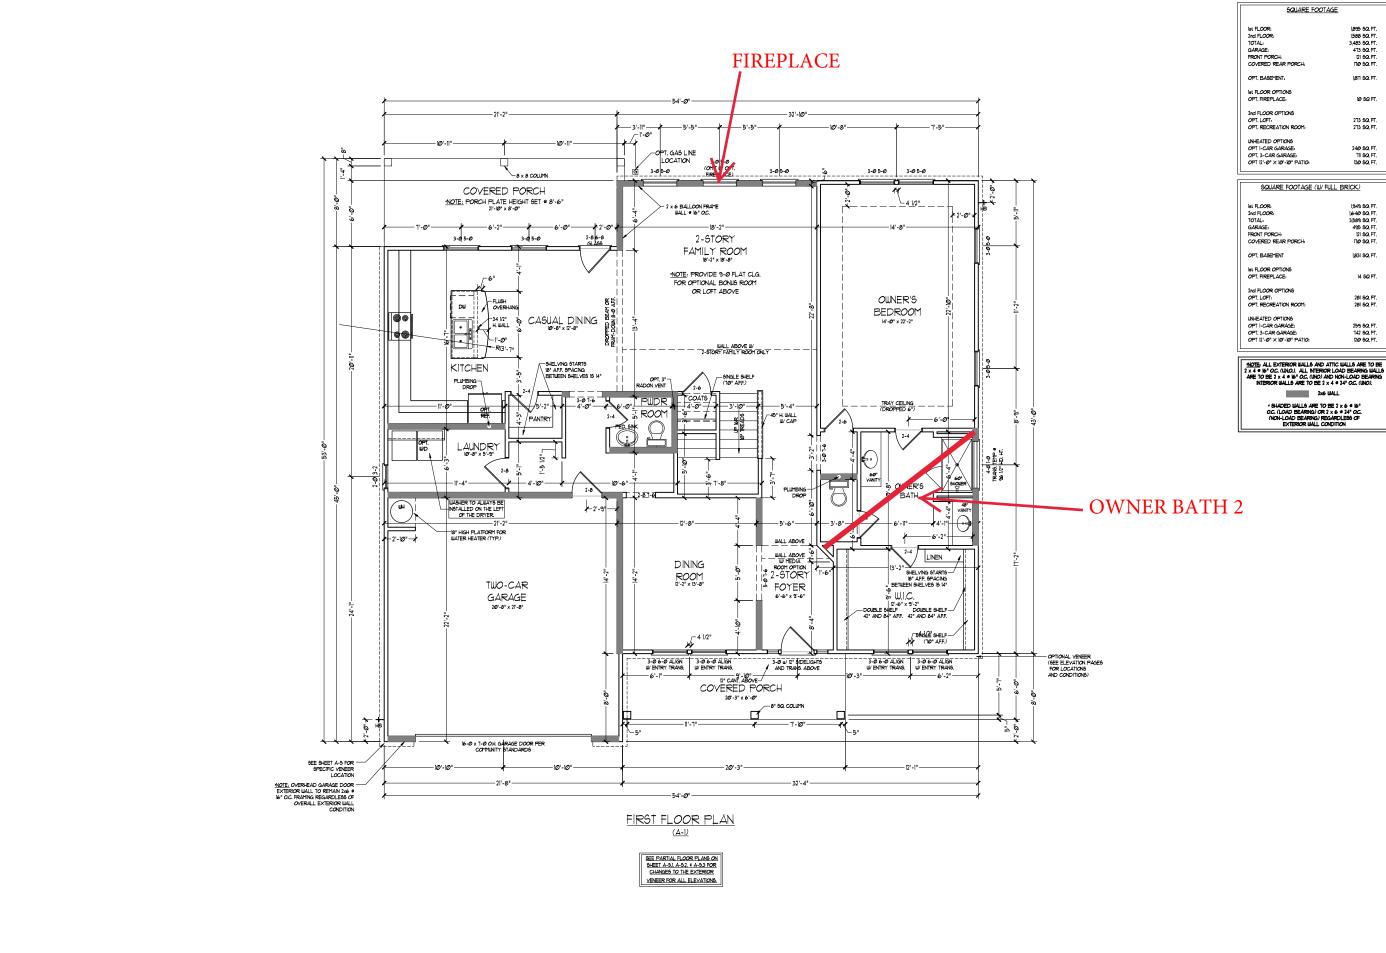

1,895 SQ, FT. 1,588 SQ, FT. 3,483 SQ, FT. 413 SQ, FT. 121 SQ, FT. 110 SQ, FT. 1,817 SQ. FT.

1,949 SQ. FT. 1,640 SQ. FT. 3,569 SQ. FT. 495 SQ. FT. 121 SQ. FT. 110 SQ. FT. 1,831 SQ. FT.

14 5Q FT.

281 SQ. FT. 281 SQ. FT.

259 SQ. FT. 142 SQ. FT. 120 SQ. FT.

2x6 WALL

Dream Finders Homes

PRICES, FLOORI DIMENS SQUARI MAY V. | OF HOI PLAN A RENDE ARE TH HOME DISPL/ HOME

DREAM FINDERS HOMES JACKSON

DATE: FEBRUARY 27, 2019


REV.: DECEMBER 01, 2022

SCALE: 1/4"=1'-0" DRAWN BY:

ENGINEERED BY: REVIEWED BY:


FIRST FLOOR PLAN

A-6

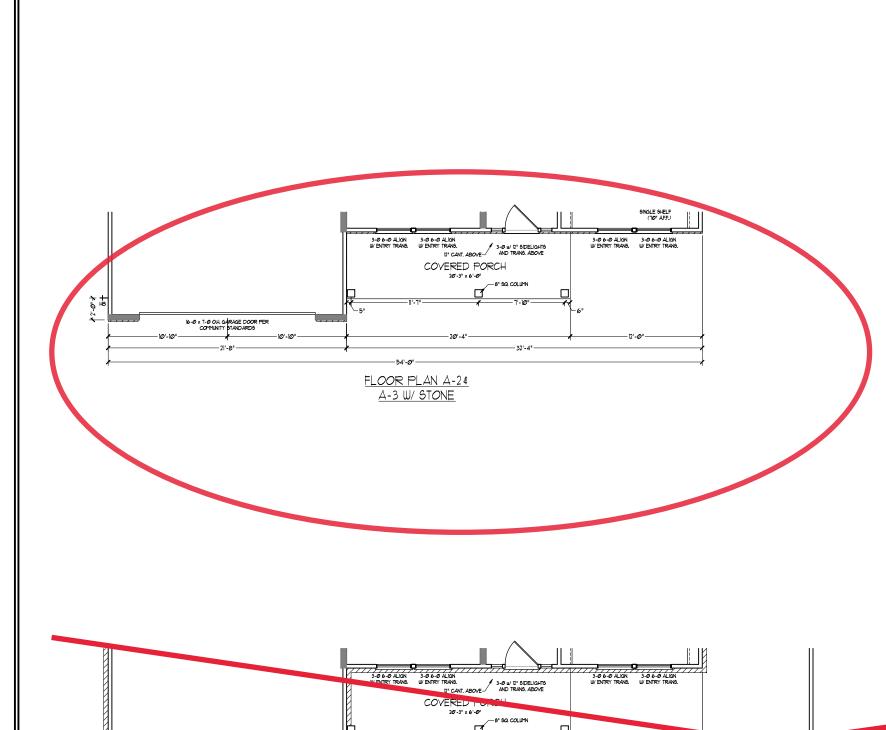

FLOOR PLAN A-4

16-0 x 7-0 O.H. GARAGE DOOR PER COMMUNITY STANDARDS

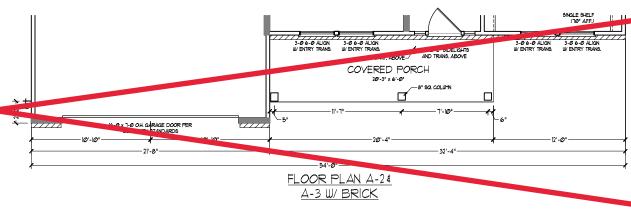



PRICES, PROMOTIONS, INCENTIVIS, FEATURES, OPTIONS, FLOOR PLANS, ELIVATIONS, DISIOSA, MATRIRALIS AND DIMENSIONS ARE SUBECTLY CHANGE WITHOUT NOTICE. SALVAR FOR THE SUBECTLY OF SUBECTLY NOTICE. AND SUBECTLY AND SUBECTLY NOTICE. AND ANY YAR'IN ACTULAL CONSTRUCTION. ACTULAL POSTITION AND YAR'IN ACTULAL CONSTRUCTION. ACTULAL POSTITION OF FOR SUBECTLY OF THE CONFIDENCE OF CHARGE OF THE CONFIDENCE OF THE CONFIDENCE OF CHARGE OF THE CONFIDENCE OF THE

DREAM FINDERS HOMES JACKSON

DATE: FEBRUARY 27, 2019 REV.: DECEMBER 01, 2022


SCALE: 1/4"=1'-0"
DRAWN BY:


ENGINEERED BY:

REVIEWED BY:

FIRST FLOOR
PARTIAL PLANS
"A" ELEVATIONS

A-6.1

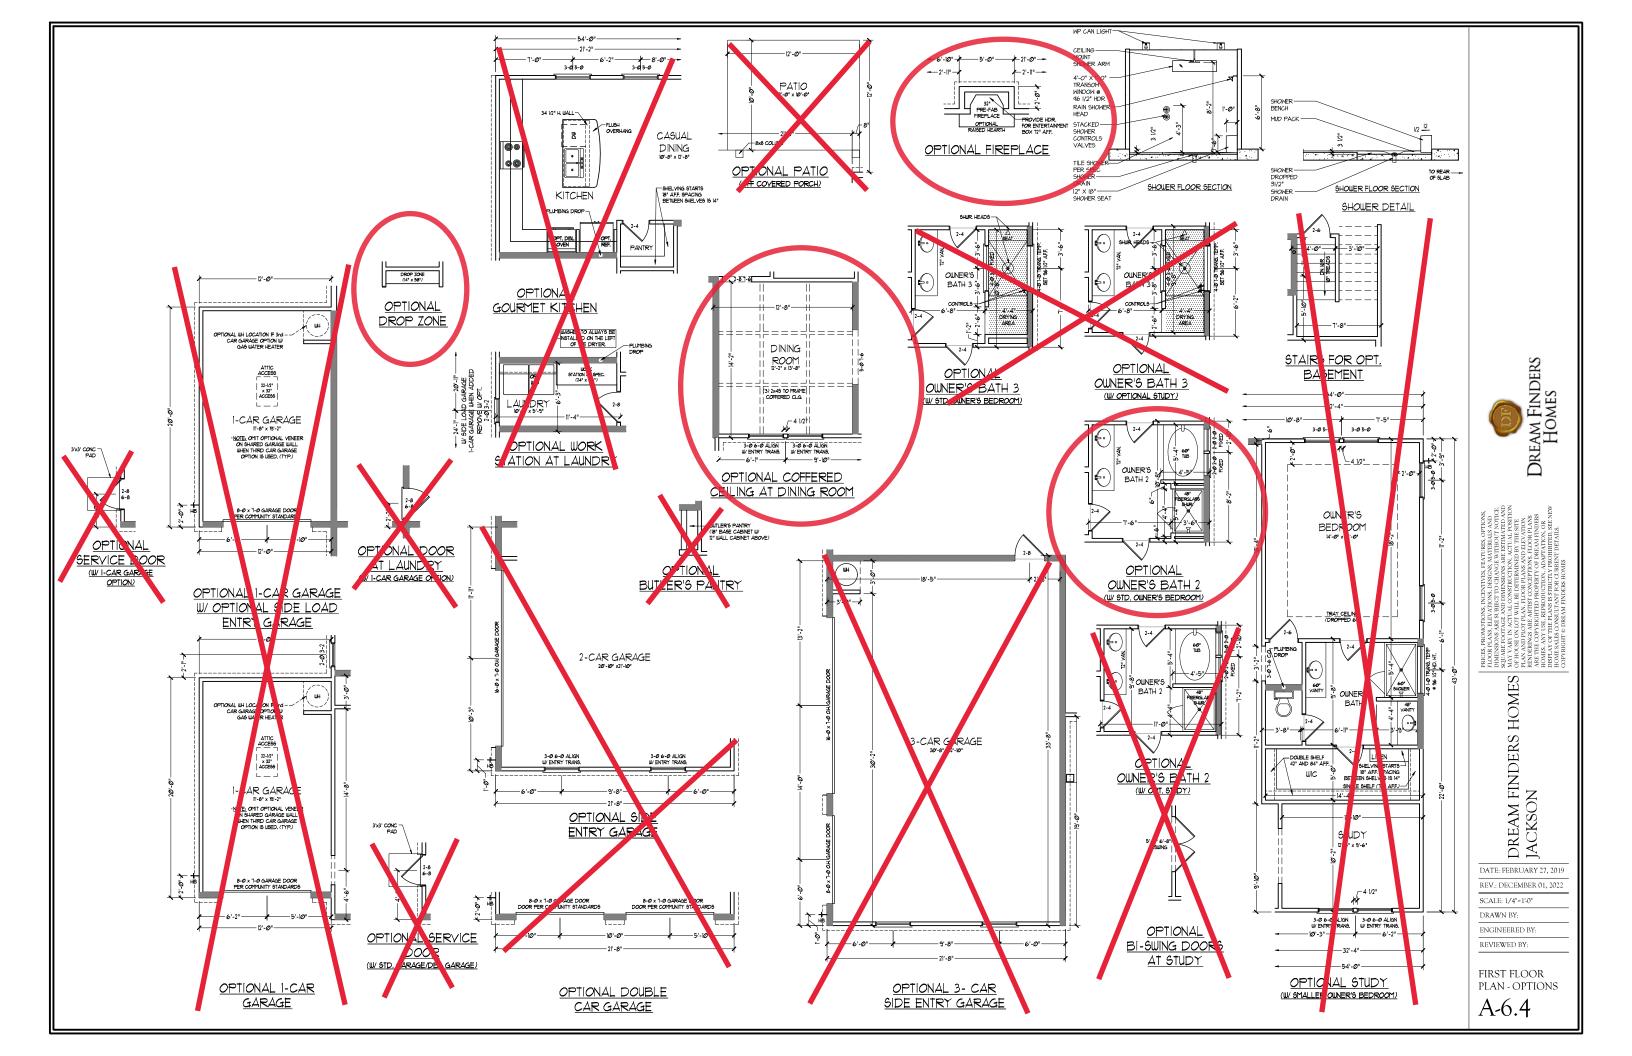

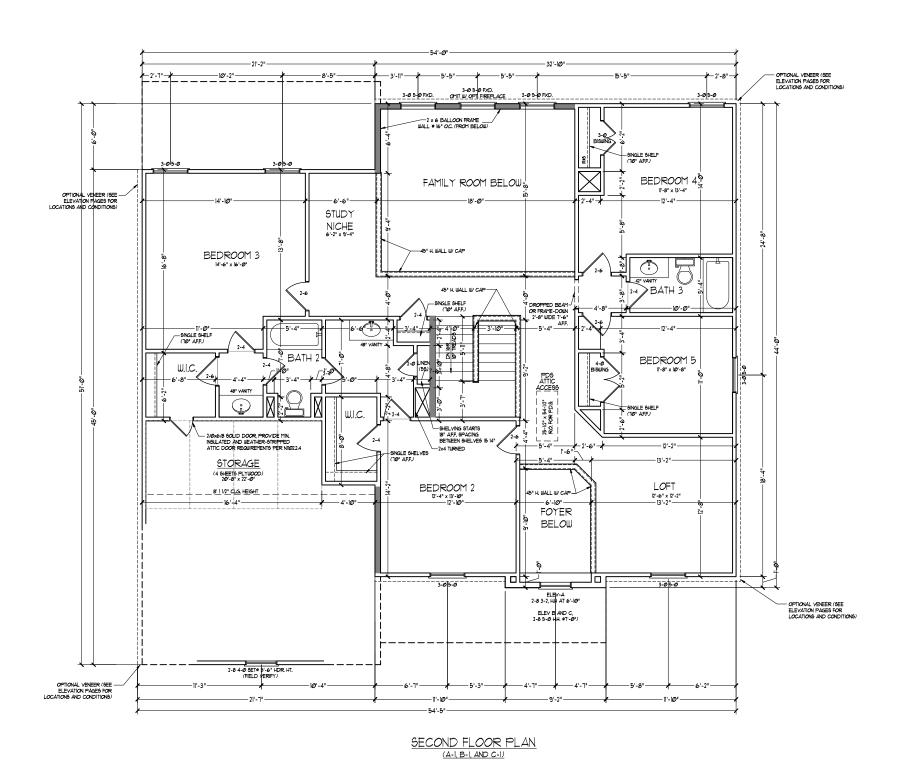

NOTE: ALL EXTERIOR WALLS AND ATTIC WALLS ARE TO BE 2 x 4  $\circ$  b° CC. (WIND). ALL INTERIOR LOAD EBLANNS WALLS ARE TO BE 2 x 4  $\circ$  b° CC. (IND) AND NATI-ADD BEARINS INTERIOR WALLS ARE TO BE 2 x 4  $\circ$  CC. (IND).

X6 WALL

SHADED WALLS ARE TO BE 2 × 6 • 16\* O.C. (LOAD BEARING OR 2 × 6 • 24\* O.C. (NON-LOAD BEARING) REGARDLESS OF EXTERIOR WALL CONDITION

PROVIDE MINIMUM INSULATION IN CEILINGS AND WALLS PER SECTION N 1102.1 DREAM FINDERS Homes

PRICES, PROMOTIONS, INCENTIVES, FEATURES, OPTIONS, FLOOR PLANS, ELEVATIONS, DISTORS, MATRIRALS AND INDIANS, ROSE BLAYING VARIENCE AND INTERNAL SAND. DIMENSIONS ARE SUBJECT TO CHANGE WITHOUT YOTICE. SOLIMBE TO FORCE AND DIMENSIONS ARE ESTIMATION AND ANY YARY IN ACTUAL CONSTRUCTOR, ACTUAL POSTITON OF HOUSE OF LOVE THAN SOLIMBE AND ELEVATION AND ELEVATI

DREAM FINDERS HOMES | SE PER JACKSON | S

DATE: FEBRUARY 27, 2019

REV.: DECEMBER 01, 2022 SCALE: 1/4"=1'.0"


DRAWN BY:

ENGINEERED BY:

REVIEWED BY:

SECOND FLOOR PLAN

A-7

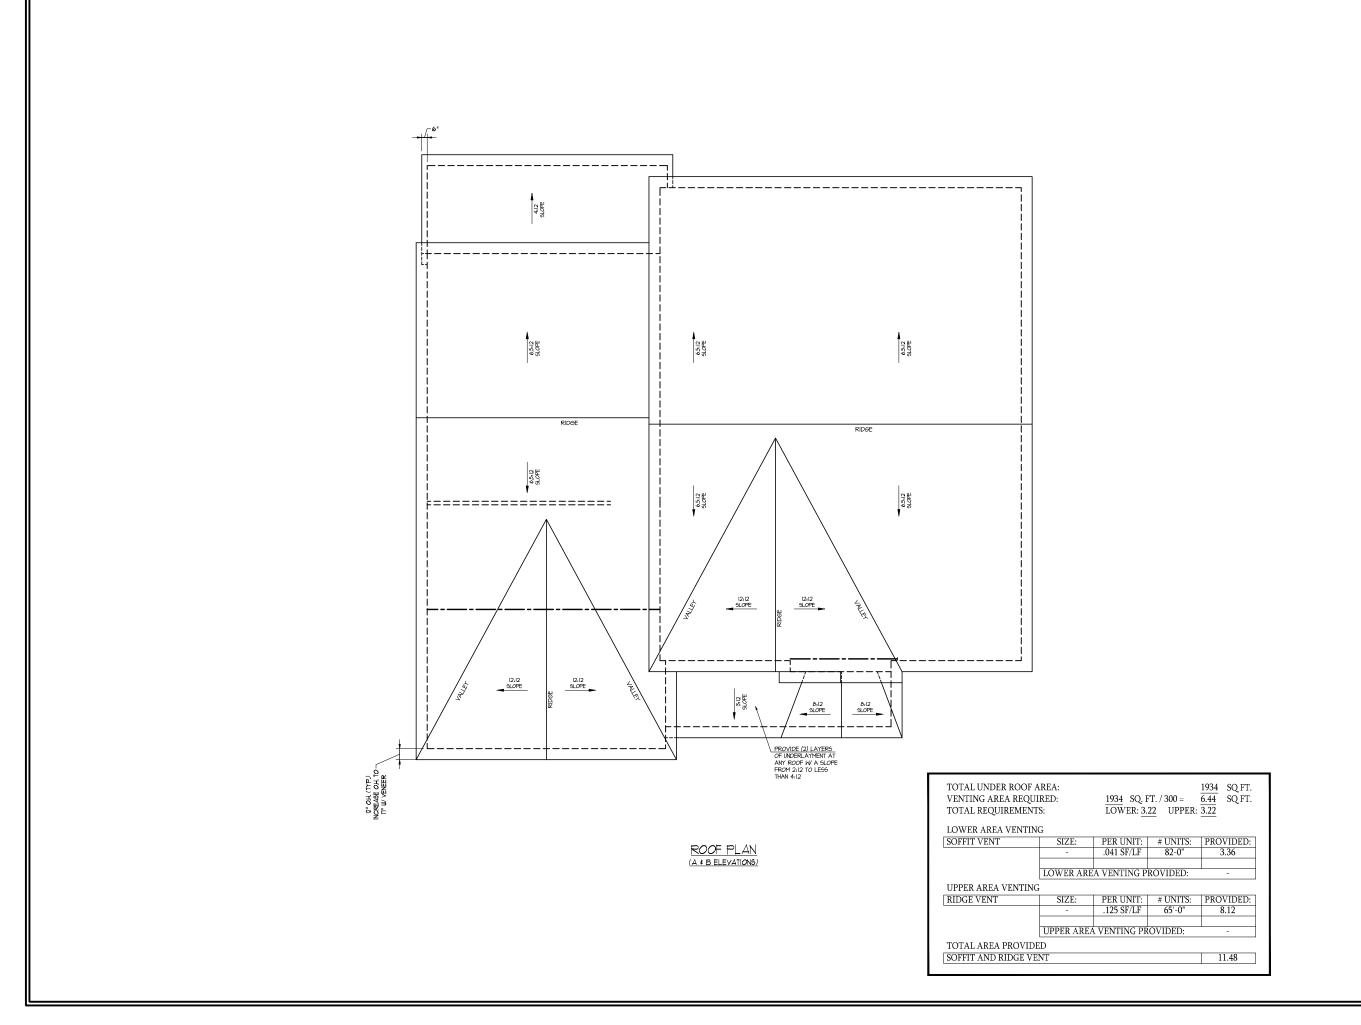




PRICES, PROMOTIONS, INCENTIVES, FEATURES, OPTIONS, ILOOR PLANE ELEVATIONS, BEIGN, MATHERIALS AND IMMESSIONS, RASE SUBJECT, OCHANGE WAS ENTERORY OF CHANGE WITHOUT NOTICE. PROMOTION AND ANY VARY IN ACTUAL CONSTRUCTION. ACTUAL POSTITION AND PLAY NAD PLAY PLAY OF PRICE MAY AND PLAY PLAY SHORD PLAYS AND ELEVATION RECORD PLAYS AND PLAY PROPERTY OF DREAM PINDESS ARE THE COPP RIGHTED REOPERTY OF DREAM PINDESS AND ELEVATION. AS THE THAN AND STRUCTIVE PROHIBITED. SEE EWE OF PRAY AND THE PLAYS IS STRUCTIVE PROHIBITED. SEE EWE COPPRIGHT OR CHREEKT DETAILS.

DREAM FINDERS HOMES REPORTED TO THE PROPERTY OF THE PROPERTY O

DATE: FEBRUARY 27, 2019
REV.: DECEMBER 01, 2022
SCALE: 1/4"=1'0"
DRAWN BY:
ENGINEERED BY:
REVIEWED BY:
ROOF PLAN
ELEVATION - A & B

A-8

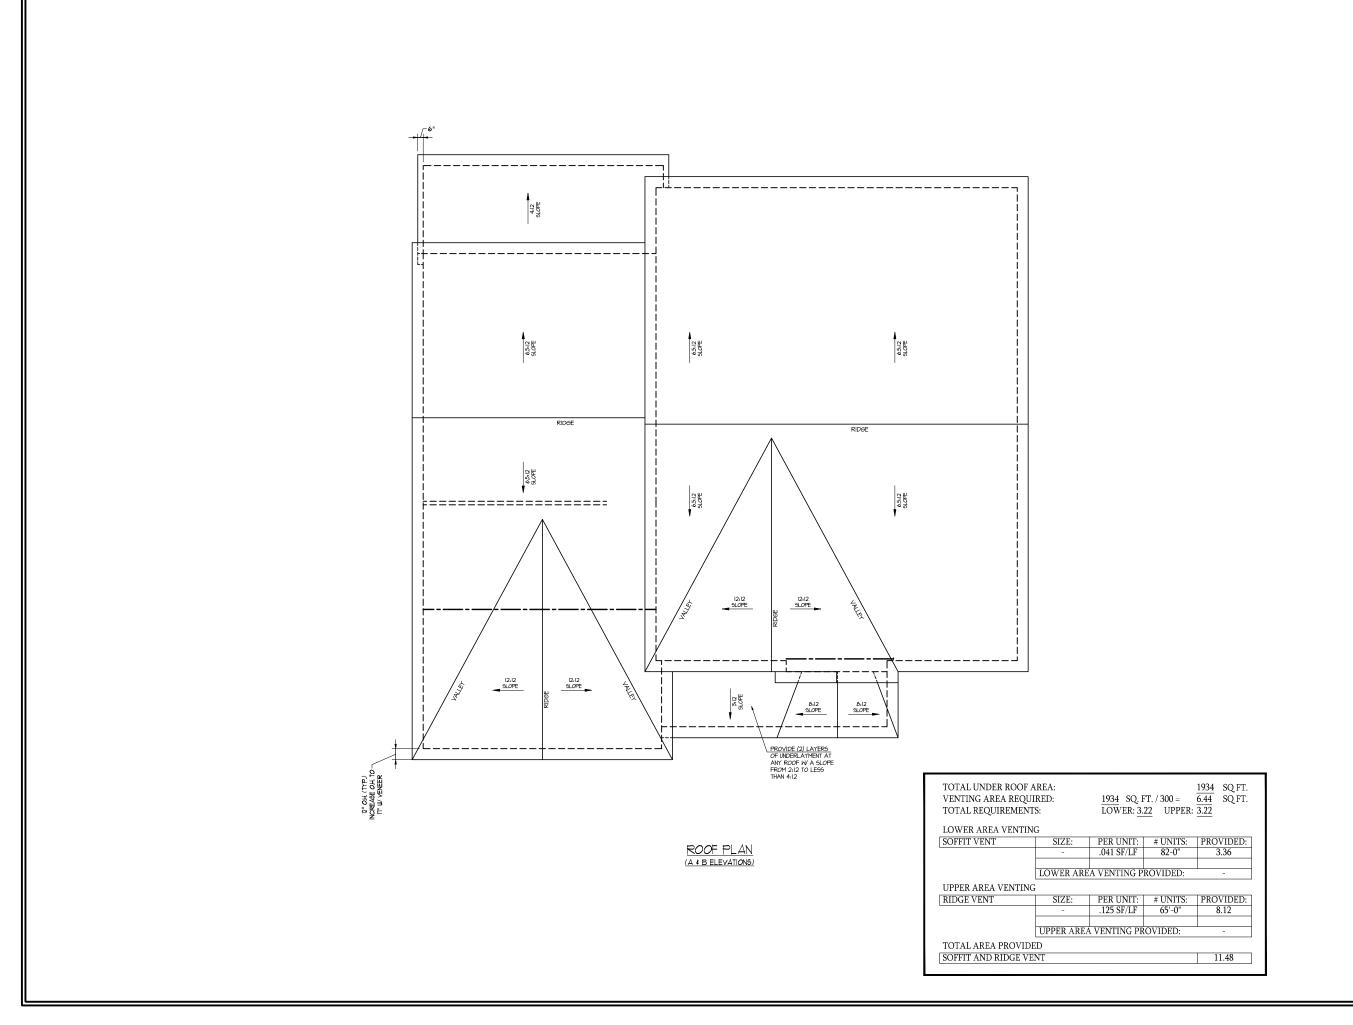



PRICES, PROMOTIONS, INCENTIVES, FEATURES, OPTIONS, INCORP. BILGORP, ANTHREIMAS AND DIMENSIONS ARE BURNATURED INGORAGE WITHRIGHT NOTICE. SOLICIAE AND INMENSIONS ARE SUBSTRICTED AND MAY YARY IN ACTULA, CONSTRUCTION, ACTUAL, POSTITON OFFICIAE, ON THE PLAN AND PLOP PLAN, FLOOR PLANS AND ELEVATION RENDERINGS ARE ARTEST COOKEPTONS, TOOR PLANS AND ELEVATION ARE THE COPYRIGHTED REOPRETY OF DIEAM PINDESS HOMES AND AND PLANS IS STRICTLY PROHIBITED. SEE PART OFFICIAL SONE STRICTLY REQUIRED BY OFFICIAL STRICTLY REQUIRED BY OFFICIAL STRICTLY PROHIBITED SEE PART OFFICIAL STRICTLY PROHIBET DEFAULT.

DREAM FINDERS HOMES | JACKSON


DATE: FEBRUARY 27, 2019
REV.: DECEMBER 01, 2022
SCALE: 1/4"=1'0"

DRAWN BY:


ENGINEERED BY:
REVIEWED BY:


ROOF PLAN ELEVATION - C

A8-.2

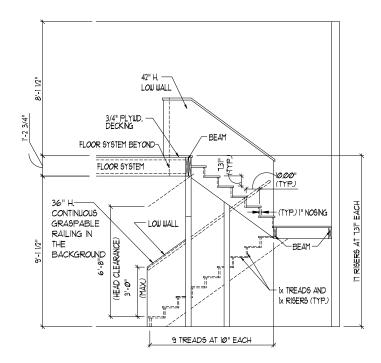


TYPICAL STAIR DETAIL (NTS)

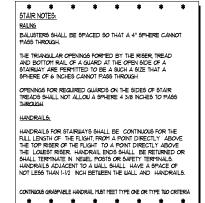

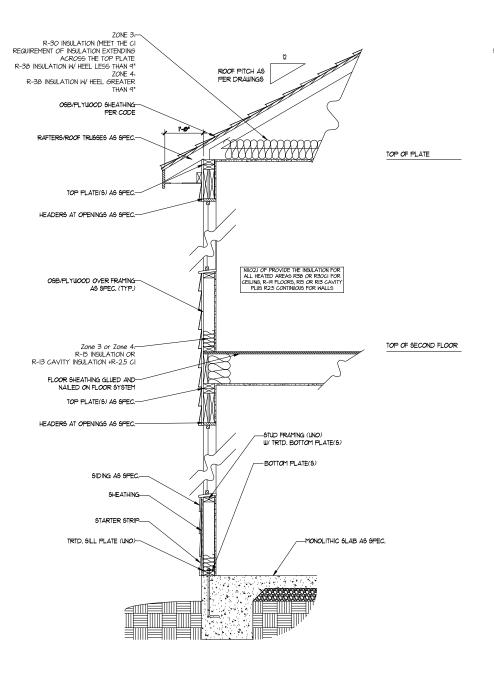

WALL SECTION W/ SLAB W/ STD. SIDING SHOWN (NTS)

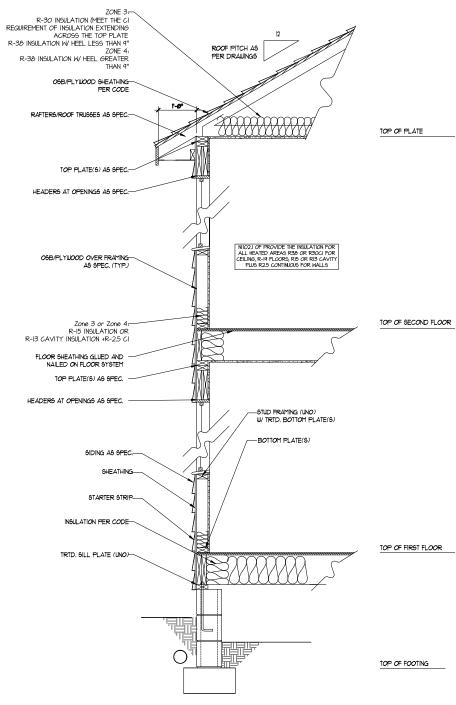

WALL SECTION W/ CRAWL SPACE W/ STD. SIDING SHOWN (NTS)

Dream Finders Homes

DREAM FINDERS HOMES JACKSON

DATE: FEBRUARY 27, 2019
REV.: DECEMBER 01, 2022


REV.: DECEMBER 01, 20 SCALE: 1/4"=1'-0"

DRAWN BY: ENGINEERED BY:

REVIEWED BY:

WALL SECTIONS AND STAIR DETAIL

AD-1

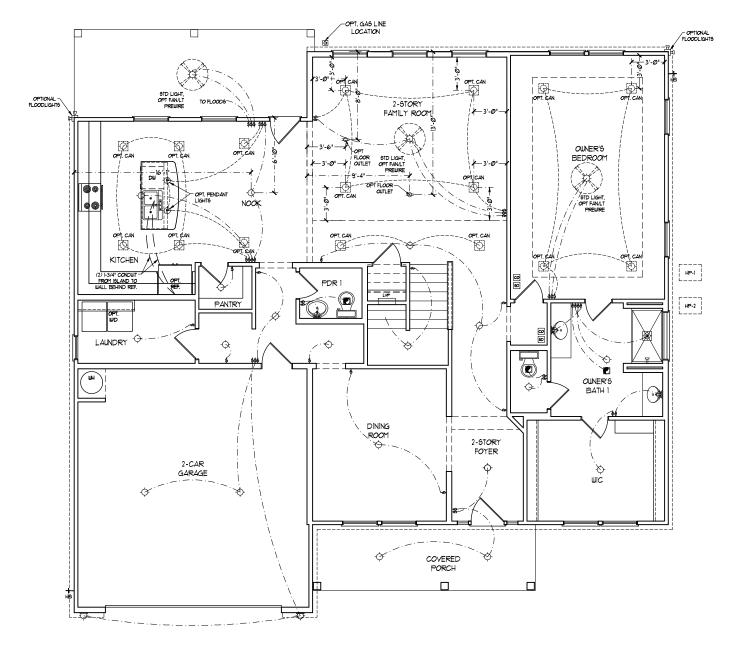

| ELECTRICAL LEGEND |                                 |  |
|-------------------|---------------------------------|--|
| ⇒ Ilø v outilet   |                                 |  |
| ₾                 | WALL MOUNT LIGHT                |  |
| ф                 | CEILING MOUNT LIGHT             |  |
| •                 | PENDANT LIGHT                   |  |
| Ø                 | RECESSED CAN LIGHT              |  |
| Ø                 | MINI CAN LIGHT                  |  |
| <b>(</b>          | EYEBALL LIGHT                   |  |
|                   | FLUORESCENT LIGHT               |  |
|                   | 2 LAMP, 4' FLUORESCENT<br>LIGHT |  |
| 쑈                 | FLOOD LIGHT                     |  |
| ģ                 | SWITCH                          |  |
| ģ                 | 3-WAY SWITCH                    |  |
| \$                | 4-WAY SWITCH                    |  |
| \$                | DIMMER SWITCH                   |  |
| CII-              | CONDUIT FOR COMPONENT<br>WIRING |  |
| 8 <b>P</b>        | SPEAKER                         |  |
| D-                | DOORBELL CHINE                  |  |
| 8D                | 100 V SMOKE DETECTOR            |  |
| 8                 | CO DETECTOR                     |  |
| 3                 | EXHAUST FAN                     |  |
| LVP               | LOW VOLTAGE PANEL               |  |
|                   | CEILING FAN                     |  |
|                   | CEILING FAN W LIGHT             |  |

2.) VANITY LIGHTS TO BE SET 990" AFF. (TYP.)

3.) ADDITIONAL EXTERIOR OUTLETS REQUIRED BY CODE TO BE LOCATED BY ELECTRICIAN. 4.) PLACE SWITCHES 8" (MIN.) FROM ROUGH OPENINGS,

ELECTRICAL LAYOUT NOTES:

| ELECTRICAL LEGEND |                                 |  |  |
|-------------------|---------------------------------|--|--|
| <b></b>           | liø v outlet                    |  |  |
| ₾                 | WALL MOUNT LIGHT                |  |  |
| <b></b>           | CEILING MOUNT LIGHT             |  |  |
| <b>.</b>          | PENDANT LIGHT                   |  |  |
| $\Box$            | RECESSED CAN LIGHT              |  |  |
| Ø                 | MINI CAN LIGHT                  |  |  |
| <b>(</b>          | EYEBALL LIGHT                   |  |  |
|                   | FLUORESCENT LIGHT               |  |  |
|                   | 2 LAMP, 4" FLUORESCENT<br>LIGHT |  |  |
| 쮸                 | FLOOD LIGHT                     |  |  |
| switch            |                                 |  |  |
| ŝ                 | 3-WAY SWITCH                    |  |  |
| ŧ                 | 4-WAY SWITCH                    |  |  |
| 8                 | DIMMER SWITCH                   |  |  |
| CW-               | CONDUIT FOR COMPONENT<br>WIRING |  |  |
| 88                | SPEAKER                         |  |  |
| D-                | DOORBELL CHIME                  |  |  |
| SD                | 100 V SMOKE DETECTOR            |  |  |
| Ø                 | CO DETECTOR                     |  |  |
|                   | EXHAUST FAN                     |  |  |
| LVP               | LOW VOLTAGE PANEL               |  |  |
|                   | CELL BIG FAN                    |  |  |

PRICES, F FLOOR PI DIMENSIS SQUARE: MAY VAN OF HOUS PLAN AN RENDERI ARE THE HOMES. A HOMES. A DREAM FINDERS HOMES JACKSON

Dream Finders Homes

DATE: FEBRUARY 27, 2019

REV.: DECEMBER 01, 2022

SCALE: 1/4"=1'-0" DRAWN BY:


ENGINEERED BY:

REVIEWED BY:

FIRST FLOOR ELECTRICAL PLAN

E-1

FIRST FLOOR PLAN

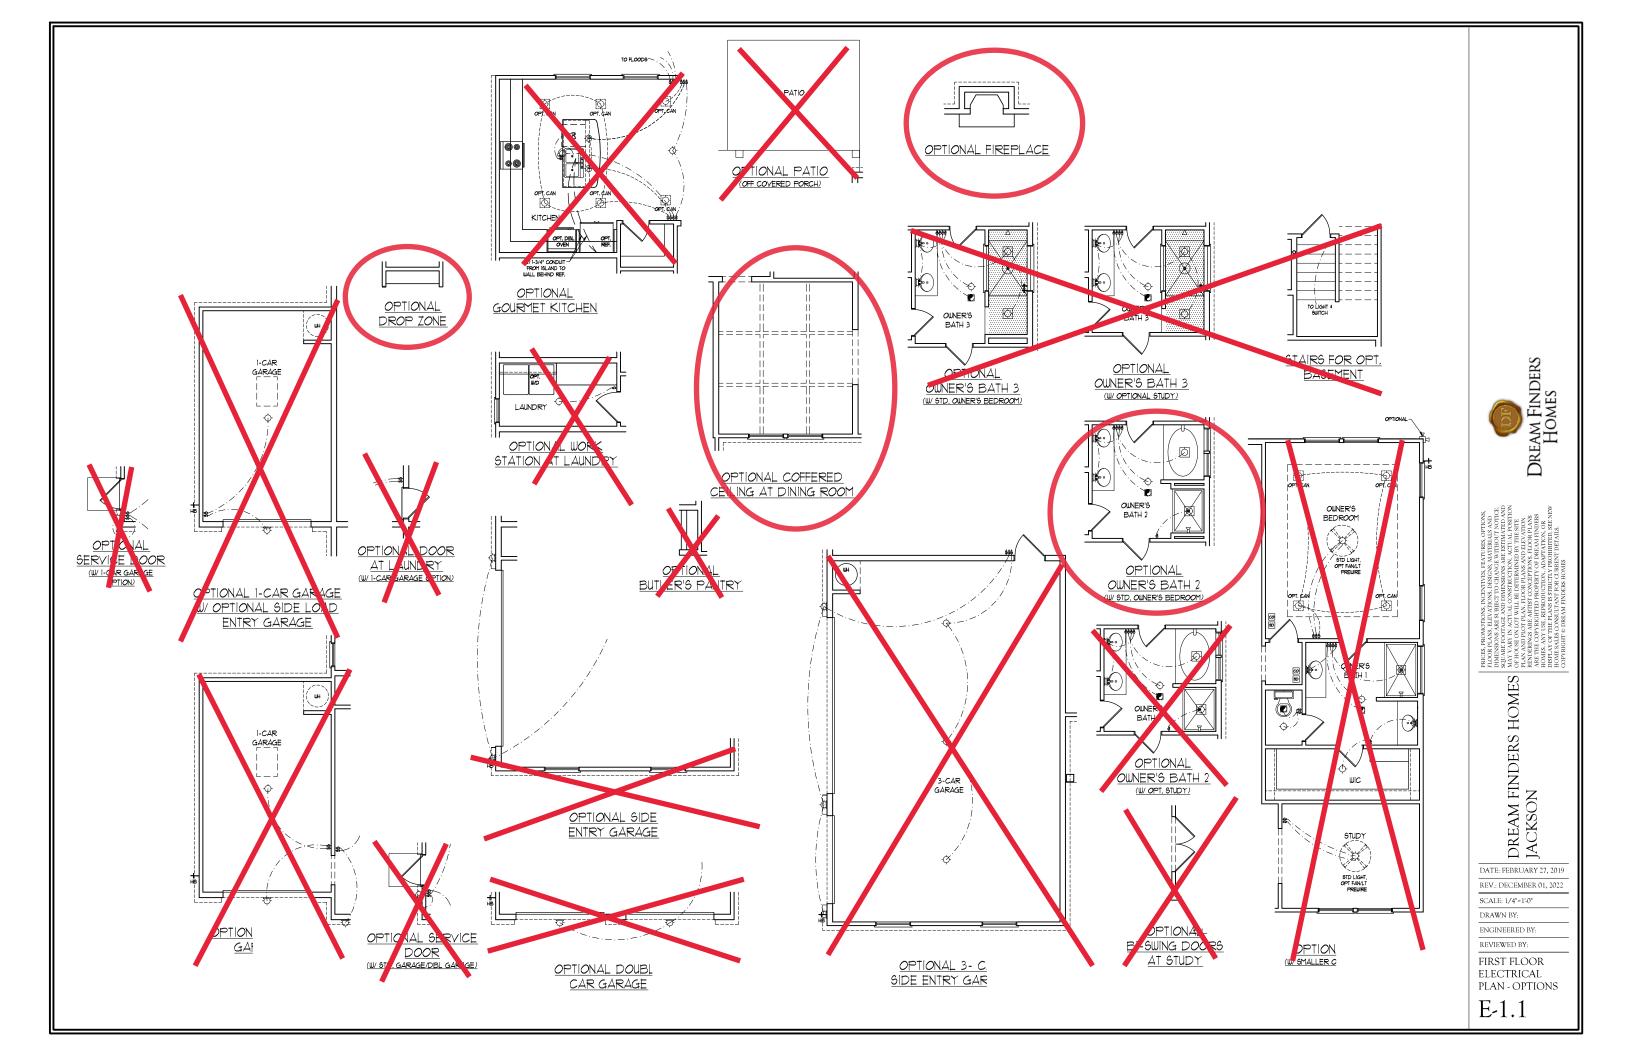

SECOND FLOOR PLAN

ELECTRICAL LAYOUT NOTES:

3.) ADDITIONAL EXTERIOR OUTLETS REQUIRED BY CODE TO BE LOCATED BY ELECTRICIAN.

| ELECTRICAL LEGEND        |                                 |  |
|--------------------------|---------------------------------|--|
| <b>+</b>                 | IIØ V OUTLET                    |  |
| - ☆-                     | WALL MOUNT LIGHT                |  |
| <b>\( \rightarrow \)</b> | CEILING MOUNT LIGHT             |  |
| •                        | PENDANT LIGHT                   |  |
| $\bigcirc$               | RECESSED CAN LIGHT              |  |
| Ø                        | MINI CAN LIGHT                  |  |
| <b>(</b>                 | EYEBALL LIGHT                   |  |
|                          | FLUORESCENT LIGHT               |  |
|                          | 2 LAMP, 4' FLUORESCENT<br>LIGHT |  |
| 华                        | FLOOD LIGHT                     |  |
| \$                       | SWITCH                          |  |
| ŝ                        | 3-WAY SWITCH                    |  |
| ŝ                        | 4-WAY SWITCH                    |  |
| \$                       | DIMMER SWITCH                   |  |
| (W)-                     | CONDUIT FOR COMPONENT<br>WIRING |  |
| SP SP                    | 9PEAKER                         |  |
| D-                       | DOORBELL CHIME                  |  |
| SD                       | IIØ V SMOKE DETECTOR            |  |
| co                       | CO DETECTOR                     |  |
| 5                        | EXHAUST FAN                     |  |
| LVP                      | LOW VOLTAGE PANEL               |  |
|                          | CEILING FAN                     |  |
| ·>                       |                                 |  |

CEILING FAN W/ LIGHT



PRICES, PROMO FLOOR PLANS, E DIMENSIONS AA SQUARE FOOTA MAY VARY IN A MAY VARY IN A PORTON FOR PLAN AND PLOT RENDERINGS AA RETHE COPY HOMES, ANY OF THE HOMES, ANY OF THE HOMES, ANY OF HOME SALLES CC COPYRIGHT © L

DREAM FINDERS HOMES JACKSON

DATE: FEBRUARY 27, 2019

REV.: DECEMBER 01, 2022

SCALE: 1/4"=1'-0" DRAWN BY:

ENGINEERED BY:

REVIEWED BY:

SECOND FLOOR ELECTRICAL PLAN

E-2

| LINTEL SCHEDULE FOR<br>BRICK/NATURAL STONE SUPPORT |                        |  |
|--|------------------------|--|
| LENGTH (FT.) SIZE OF LINTEL                        |                        |  |
| UP TO 4 FT.  | L 3 1/2 x 3 1/2 x 1/4  |  |
| 4-8  | L 5 x 3 1/2 x 5/16 LLV |  |
| 8 AND GREATER                                      | L 6 x 4 x 5/16 LLV     |  |

## BRICK SUPPORT NOTES:

- I. LINTEL SCHEDULE APPLIES TO ALL OPENINGS IN BRICK VENEER (UNO). SEE ARCH DWGS. FOR SIZE AND LOCATION OF OPENINGS.
- 2. (LLV) = LONG LEG VERTICAL
  5. LENGTH = CLEAR OPENING
  6. EMBED ALL ANGLE IRONS MIN. 4" EACH SIDE INTO VENEER TO PROVIDE BEARING.
- FOR ALL HEADERS 8'-0" AND GREATER IN LENGTH, ATTACH STEEL ANGLE TO HEADER W/ LENGIH, ATTAUT SIELE ANGLE 19.

  1/2" LAG SCREWS © 12" OL O. STAGGERED.

  5. FOR ALL BRICK SUPPORT © ROOF LINES, FASTEN

  (2) 2 L 10 BLOCKING BETWEEN STUDS w/ (4)

  120 ANLS PER PLY, FASTEN A 6" x 4" x 5/16"

  STEEL ANGLE TO (2) 2 x 10 BLOCKING w/ (2)
- 1/2" LAG SCREWS @ 12" O.C. STAGGERED. SEE
- FECTION R703.8.2.1 OF THE 2018 NCRC FOR ADDITIONAL BRICK SUPPORT INFORMATION.

  PRECAST REINFORCED CONCRETE LINTELS ENGINEERED BY OTHERS MAY BE USED IN LIEU

|      | LEGEND                 |  |  |
|------|------------------------|--|--|
| CONT | CONTINUOUS             |  |  |
| XJ   | EXTRA JOIST            |  |  |
| DJ   | DOUBLE JOIST           |  |  |
| TJ   | TRIPLE JOIST           |  |  |
| EA   | EACH                   |  |  |
| ()   | NUMBER OF STUDS        |  |  |
| DSP  | DOUBLE STUD POCKET     |  |  |
| TSP  | TRIPLE STUD POCKET     |  |  |
| 00   | ON CENTER              |  |  |
| SPF  | SPRUCE PINE FIR        |  |  |
| SYP  | SOUTHERN YELLOW PINE   |  |  |
| TRTD | PRESSURE TREATED       |  |  |
| TYP  | TYPICAL                |  |  |
| UNO  | UNLESS NOTED OTHERWISE |  |  |

SIDE 4A (62'-0" FOR 3-CAR

14" TJI 360 @ 19.2" O.C.

(4) 2 x 6 OR (6) 2 x 4 EA. END

(3) 1 3/4" x 11 7/8" LVL CONT, FROM CORNER

TO CORNER w/ (2) 2 x 6 EA. BRG. POINT OR FOR BRICK: (3) 1 3/4" x 14" LVL w/


PORTAL FRAME. SEE METHOD PF

WALL BRACING DETAIL ON SHEET D-2


2 x 6


(3) 2 x 12 CONT. FROM CORNER w/ (2) JACKS

STUDS. STRAP HEADERS TOGETHER W/ ( 5' LONG SIMPSON CS16 STRAPS INSTALLED TOP & BOTTOM ON THE INSIDE FACE OF

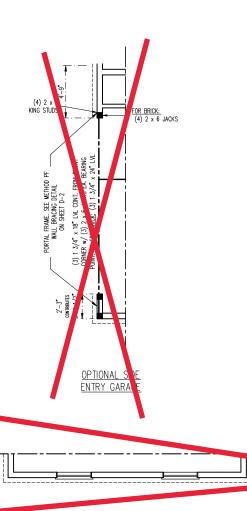



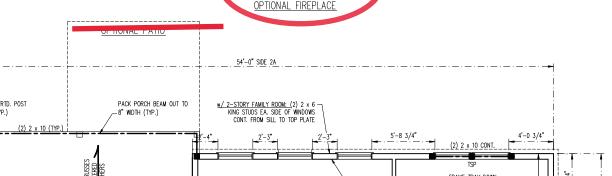

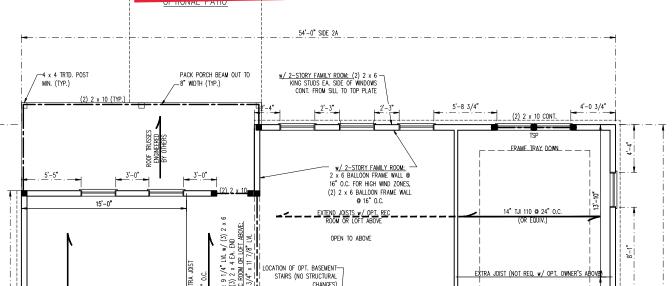

OUBLE JOIST V / 2-STORY FAMILY ROOM OR REC ROOM ABOVE 14"

TIONAL COFFERED

CEILING

54'-0" SIDE 1A RECTANGLE A

14" TJI 110 @ 24" 0.0

(3) 2 x 6

ROOF TRUSSES ENGINEERED BY OTHERS

OPTIONAL DOUBLE CAR

GARAGE

(1) 1 3/4" x 14" LVL

SIMPSON U14

. 14" T.II 110 @ 24" 0.C

(1) 1 3/4" x 14". LVL w/ OPT MEDIA ROOM ABOVE

OPEN TO ABOVE

- SIMPSON

HU416

XTRA JOIST (NOT REQ. w/ OPT. OWNER'S ABOVE

14" TJI 110 @ 24"

EXTRA JOIL W/ STANDARD FLOOR PLAN ABOVE

EXTRA JOIST w/ OPT OWNER'S ABOVE

(2) 2 x 10 CONT.

14" TJI 110 @ 24" O.C.

- PACK PORCH REAM OUT TO

-6 x 6 TRTD POST MIN

16" x 16" MASONRY PIFR INCLUDING VENEER
(TYP. FOR ELEVATION 'C')

(TYP. FOR ELEVATIONS 'A' & 'C'): 6 x 6 TRTD. POST MIN ON

10 1/2" WIDTH (TYP.)

(3) 2 x 6

\_

EXTRA JOIST w/ OPT OWNER'S ABOVE

TABLE R602.7.5 MINIMUM NUMBER OF FULL HEIGHT KING STUDS AT EACH END OF HEADERS IN EXTERIOR WALLS

| HEADER SPAN<br>(FEET) | MINIMUM NUMBER OF FULL<br>HEIGHT STUDS (KINGS) |
|-----------------------|--|
| UP TO 3'              | 1  |
| > 3' TO 6'            | 2  |
| > 6' TO 9'            | 3  |
| > 9' TO 12'           | 4  |
| > 12' TO 15'          | 5  |



SON LEIGH, NC 27609

ERING,

S.TH(
NGINE


EAST SIX FORKS ROAD
PHONE JOYNE

**M**  $\overline{z}$ 

JACKSON DREAM FINDERS HOMES

## STRUCTURAL NOTES:

- ALL FRAMING LUMBER TO BE #2 SPF (UNO). ALL TREATED LUMBER TO BE #2
- ALL LOAD BEARING HEADERS TO BE (2) 2 x 10 (UNO).
  INSTALL AN EXTRA JOIST UNDER WALLS PARALLEL TO FLOOR JOISTS WHERE
  NOTED ON THE PLANS.
- window and door headers to be supported w/ (1) Jack Stud and (1) king stud ea. End (uno.). See Table R602.7.5 FOR Additional king stud REQUIREMENTS.
- SQUARES DENOTE POINT LOADS WHICH REQUIRE SOLID BLOCKING TO GIRDER OR FOUNDATION. ALL SQUARES TO BE (2) STUDS (UNO.)
- FOR HIGH WIND ZONES, ALL EXTERIOR WALLS TO BE SHEATHED WITH 7/16" OSB SHEATHING WITH JOINTS BLOCKED AND SECURED WITH 8d NAILS AT 3" O.C. ALONG EDGES AND 6" O.C. IN THE FIELD.
  FOR HIGH WIND ZONES, SECURE ALL EXTERIOR WALL SHEATHING PANELS TO
- DOUBLE TOP PLATES, BANDS, JOISTS, AND GIRDERS WITH (2) ROWS OF 8d NAILS STAGGERED AT 3" O.C. PANELS SHALL EXTEND 12" BEYOND CONSTRUCTION JOINTS AND SHALL OVERLAP GIRDERS AND DOUBLE SILL PLATES THEIR FULL DEPTH
- ALL 4 x 4 POSTS SHALL BE ANCHORED TO SLABS w/ SIMPSON ABU44 POST BASES (OR EQUAL) AND 6  $\times$  6 POSTS w/ ABU66 POST BASES (OR EQUAL) (UNO). ALL 4  $\times$  4 AND 6  $\times$  6 POSTS TO BE INSTALLED WITH 700 LB CAPACITY UPLIFT CONNECTORS AT TOP (UNO.)
- FOR FIBERGLASS, ALUMINUM, OR COLUMN ENG. BY OTHERS, SECURE TO SLAB w/ (2) METAL ANGLES USING 2" CONC. SCREWS. FASTEN ANGLES TO COLUMNS w/ 1/4" THROUGH BOLTS w/ NUTS AND WASHERS. LOCATE ANGLES ON OPPOSITE SIDES OF COLUMN. THROUGH BOLTS MUST BE
- INSTALLED PRIOR TO SETTING COLUMN. I. REFER TO NOTES AND DETAIL SHEETS FOR ADDITIONAL STRUCTURAL

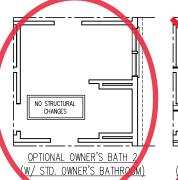



TD. OWNER'S BATHROOM)

- E. BCI 4500s-1.8 JOISTS MAY BE INSTALLED IN LIEU OF TJI 110 JOISTS AT THE DEPTH AND SPACING INDICATED ON THE PLAN BCI 60s-1.8 JOISTS MAY BE INSTALLED IN LIEU
  - OF TJI 360 JOISTS AT THE DEPTH AND SPACING INDICATED ON THE PLAN



\*NOTE: ALL EXTERIOR WALLS AND ATTIC WALLS ARE TO BE 2 x 6 @ 16" O.C. (UNO) 2 x 4 @ 16" O.C. EXTERIOR WALLS MAY BÉ CONSTRUCTED IN LIEU OF 2 x 6 WALLS (UNO). ALL INTERIOR LOAD BEARING WALLS ARE TO BE 2 x 4 @ 16" O.C. (UNO) AND NON-LOAD BEARING INTERIOR WALLS ARE TO BE 2 x 4 @ 24" O.C. (UNO).

# 12/22/2022

- BRACED WALL DESIGN NOTES: BRACED WALL DESIGN PER SECTION R602.10 OF THE NCRC 2018 EDITION.

  CS-WSP REFERS TO "CONTINUOUS SHEATHING - WOOD STRUCTURAL PANELS" CONTRACTOR IS TO INSTALL 7/16" OSB ON ALL EXTERIOR WALLS ATTACHED w/ Bd Nalls spaced 6" O.C. Along Panel edges and 12" O.C. IN THE FIELD.
- O.C. IN THE FIELD.

  \*GB REFERS TO "GYPSUM BOARD" CONTRACTOR IS TO INSTALL 1/2" (MIN.)

  GYPSUM WALL BOARD WHERE NOTED ON THE PLANS. FASTEN GB WITH 1

  1/4" SCREWS OR 1.5/8" NAILS SPACED 7" O.C. ALONG PANEL EDGES AND
- 1/4 SOREWS OR 1-5/8 NAILS SPACED / O.C. ALONG PANEL EDGES AND IN THE FIELD INCLUDING TOP AND BOTTOM PLATES.

  BRACED WALL DESIGN APPLIED IN WIND ZONES UP TO 130 MPH. FOR HIGH WIND ZONES, BRACE WALLS ARE TO BE CONSTRUCTED IN ACCORDANCE WITH CHAPTER 45 OF THE MORCE 2018 EDITION.

  SEE NOTES AND DETAIL SHEETS FOR ADDITIONAL BRACED WALL INFORMATION.

# BRACED WALL DESIGN

RECTANGLE A RECTANGLE B SIDE 1A (FRONT LOAD)
METHOD: CS-WSP/PF SIDE 1B METHOD: PF/CS-WSP TOTAL REQUIRED LENGTH: 4.56' TOTAL REQUIRED LENGTH: 18.95' TOTAL PROVIDED LENGTH: 22' TOTAL PROVIDED LENGTH: 6' SIDE 2A METHOD: CS-WSP TOTAL REQUIRED LENGTH: 18.95' TOTAL PROVIDED LENGTH: 27.6'

SIDE 3A METHOD: CS-WSP TOTAL REQUIRED LENGTH: 19.9' TOTAL PROVIDED LENGTH: 32.3'

SIDE 4A (SIDE LOAD)
METHOD: CS-WSP/PF TOTAL REQUIRED LENGTH: 19.9' TOTAL PROVIDED LENGTH: 22.79

SIDE 2B METHOD: CS-WSP TOTAL REQUIRED LENGTH: 4.56' TOTAL PROVIDED LENGTH: 12' SIDE 3B / SIDE 4A CUMULATIVE METHOD: CS-WSP/GB TOTAL REQUIRED LENGTH: 23.1' TOTAL PROVIDED LENGTH: 26.13 SIDE 4B METHOD: CS-WSP

TOTAL REQUIRED LENGTH: 3.19' TOTAL PROVIDED LENGTH: 15.58' SHEET: 9 OF: 14 S-2a SECOND FLOOR

DATE: DECEMBER 22, 2022

DRAWN BY: H&H HOMES

NGINEERED BY: WFB

SCALE: 1/4" = 1'-0"

FRAMING PLAN

- BRACED WALL DESIGN PER SECTION R602.10 OF THE NCRC 2018 EDITION. CS-WSP REFERS TO "CONTINUOUS SHEATHING — WOOD STRUCTURAL PANELS" CONTRACTOR IS TO INSTALL 7/16" OSB ON ALL EXTERIOR WALLS ATTACHED W/ 8d NAILS SPACED 6" O.C. ALONG PANEL EDGES AND 12"
- O.C. IN THE FIELD.

  S. "4B REFERS TO "GYPSUM BOARD" CONTRACTOR IS TO INSTALL 1/2" (MIN.)

  SYPSUM WALL BOARD WHERE NOTED ON THE PLANS. FASTEN GB WITH 1

  1/4" SCREWS OR 1.5/8" NAILS SPACED 7" O.C. ALONG PANEL EDGES AND

  IN THE FIELD INCLUDING TOP AND BOTTOM PLATES.

  BRACED WALL DESIGN APPLIED IN WIND ZONES UP TO 130 MPH. FOR HIGH

  WIND ZONES, BRACE WALLS ARE TO BE CONSTRUCTED IN ACCORDANCE

  WITH CHAPTER 45 OF THE NORCE 2018 EDITION.

  SEE NOTES AND DETAIL SHEETS FOR ADDITIONAL BRACED WALL

  INFORMATION.

INFORMATION.

NOTE:

w/ 2-STORY FAMILY ROOM: INSTALL (2) = BALLOON FRAMED KING STUDS EA. END OF WINDOW HDRS

BEAR TRUSSES ON WALL -

FLAT GIRDER TRUSS ENGINEERED BY OTHERS

(2) 2 x 6

w/ 2-STORY FAMILY ROOM: -2 x 6 BALLOON FRAME WALL @ 16" O.C. (FROM BELOW) FOR HIGH WIND ZONES, (2) 2 x 6
BALLOON FRAME WALL @ 16" O.C.

OPEN TO BELOW

OPEN TO BELOW

GIRDER TRUSS ENGINEERED BY OTHERS w/ (3) 2 x 4 OR (3) 2 x 6 EA. END

(2) 2 x 6

- PER SECTION R602.10.3.2 OF THE 2018 NCRC, THE AMOUNT OF BRACING ON THE SECOND FLOOR EXCEEDS THE AMOUNT REQUIRED FOR THE FIRST FLOOR AND NO BRACED WALL ANALYSIS IS REQUIRED.
   SHEATH ALL EXTERIOR WALLS WITH 7/16" OSB SHEATHING ATTACHED.
- WITH 8d NAILS AT 6" O.C. ALONG PANEL EDGES AND 12" O.C. IN THE FIELD.

\*NOTE: ALL EXTERIOR WALLS AND ATTIC WALLS ARE TO BE 2 x 6 @ 16" O.C. (UNO). 2 x 4 @ 16" O.C. EXTERIOR WALLS MAY BE CONSTRUCTED IN LIEU OF 2 x 6 WALLS (UNO). ALL INTERIOR LOAD BEARING WALLS ARE TO BE 2 x 4 @ 16" O.C. (UNO) AND NON-LOAD BEARING INTERIOR WALLS ARE TO BE 2 x 4 @ 24" 0.C. (UNO).

|      | LEGEND                 |  |
|------|------------------------|--|
| CONT | CONTINUOUS             |  |
| XJ   | EXTRA JOIST            |  |
| DJ   | DOUBLE JOIST           |  |
| TJ   | TRIPLE JOIST           |  |
| EA   | EACH                   |  |
| ()   | NUMBER OF STUDS        |  |
| DSP  | DOUBLE STUD POCKET     |  |
| TSP  | TRIPLE STUD POCKET     |  |
| 00   | ON CENTER              |  |
| SPF  | SPRUCE PINE FIR        |  |
| SYP  | SOUTHERN YELLOW PINE   |  |
| TRTD | PRESSURE TREATED       |  |
| TYP  | TYPICAL                |  |
| UNO  | UNLESS NOTED OTHERWISE |  |
|      |                        |  |

| LINTEL SCHEDULE FOR<br>BRICK/NATURAL STONE SUPPORT |                        |  |
|--|------------------------|--|
| LENGTH (FT.)                                       | SIZE OF LINTEL         |  |
| UP TO 4 FT.  | L 3 1/2 x 3 1/2 x 1/4  |  |
| 4-8  | L 5 x 3 1/2 x 5/16 LLV |  |
| 8 AND GREATER                                      | L 6 x 4 x 5/16 LLV     |  |
|  |                        |  |

# BRICK SUPPORT NOTES:

- LINTEL SCHEDULE APPLIES TO ALL OPENINGS IN BRICK VENEER (UNO). SEE ARCH DWGS. FOR SIZE
  AND LOCATION OF OPENINGS.
  (LLV) = LONG LEG VERTICAL
  LENGTH = CLEAR OPENING
- EMBED ALL ANGLE IRONS MIN. 4" EACH SIDE INTO VENEER TO PROVIDE BEARING. FOR ALL HEADERS 8'-0" AND GREATER IN
- LENGTH, ATTACH STEEL ANGLE TO HEADER W/ 1/2" LAG SCREWS ® 12" O.C. STAGGERED. FOR ALL BRICK SUPPORT ® ROOF LINES, FASTEN
- (2) 2 x 10 BLOCKING BETWEEN STUDS w/ (4) 12d NAILS PER PLY. FASTEN A 6" x 4" x 5/16" STEEL ANGLE TO (2) 2 x 10 BLOCKING w/ (2) 1/2" LAG SOREWS @ 12" O.C. STAGGERED. SEE SECTION R703.8.2.1 OF THE 2018 NCRC FOR ADDITIONAL BRICK SUPPORT INFORMATION.
- PRECAST REINFORCED CONCRETE LINTELS ENGINEERED BY OTHERS MAY BE USED IN LIEU OF STEEL LINTELS.

# STRUCTURAL NOTES:

- ALL FRAMING LUMBER TO BE SPF #2 (UNO). ALL
- TREATED LUMBER TO BE SYP #2 (UNO.) ALL LOAD BEARING HEADERS TO BE (2) 2 x 10
- (UNO). WINDOW AND DOOR HEADERS TO BE SUPPORTED w/ (1) JACK STUD AND (1) KING STUD EA. END (UNO.). SEE TABLE R602.7.5 FOR ADDITIONAL KING STUD REQUIREMENTS
- SQUARES DENOTE POINT LOADS WHICH REQUIRE SOLID BLOCKING TO GIRDER OR FOUNDATION. ALL
- SQUARES TO BE (2) STUDS (UNO.) FOR HIGH WIND ZONES, ALL EXTERIOR WALLS TO BE SHEATHED WITH 7/16" OSB SHEATHING WITH JOINTS BLOCKED AND SECURED WITH 8d NAILS AT 3" O.C. ALONG EDGES AND 6" O.C. IN THE FIELD.
- FOR HIGH WIND ZONES, SECURE ALL EXTERIOR WALL SHEATHING PANELS TO DOUBLE TOP PLATES. BANDS, JOISTS, AND GIRDERS WITH (2) ROWS OF 8d NAILS STAGGERED AT 3" O.C. PANELS SHALL EXTEND 12" BEYOND CONSTRUCTION JOINTS AND SHALL OVERLAP GIRDERS AND DOUBLE SILL
- PLATES THEIR FULL DEPTH.
  SUPPORT GABLE WALLS NOT BRACED BY CEILING
  JOISTS OR FLOOR SYSTEM WITH 2 x 4 LATERAL BRACING INSTALLED ON TOP OF CEILING JOISTS OR TRUSS BOTTOM CHORDS AT 8'-0" O.C. AND EXTEND INWARD FROM GABLE WALLS 8'-0" MIN.
- REFER TO NOTES AND DETAIL SHEETS FOR ADDITIONAL STRUCTURAL INFORMATION.

TABLE R602.7.5 MINIMUM NUMBER OF FULL HEIGHT KING STUDS

| AT EACH END OF        | HEADERS IN EXTERIOR W                         |
|-----------------------|---|
| HEADER SPAN<br>(FEET) | MINIMUM NUMBER OF FUI<br>HEIGHT STUDS (KINGS) |
| UP TO 3'              | 1   |
| > 3' TO 6'            | 2   |
| > 6' TO 9'            | 3   |
| > 9' TO 12'           | 4   |
| > 12' TO 15'          | 5   |
|                       |   |




JACKSON DREAM FINDERS HOMES

DATE: DECEMBER 22, 2022 SCALE: 1/4" = 1'-0" RAWN BY: H&H HOMES GINEERED BY: WFB SHEET: 11 OF: 14

S-3a CEILING FRAMING PLAN



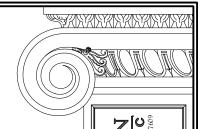

ENGINEERING, INC.
333 EAST SK FORKS ROAD, SUITE 180 FAKE (919) 789-9919 FAKE (919) 789-9921
N.C. LICENSE NO.: C(7733) BRICK SUPPORT NOTE:

- x 3" x 1/4" STEEL PLATE STOPS AT 24" O.C. PER SECTION R703.8.2.1 OF THE NORTH CAROLINA RESIDENTIAL CODE, 2018 EDITION.

# STRUCTURAL NOTES:

- ALL FRAMING LUMBER TO BE #2 SPF

- 1. ALL FRAMING LUMBER TO BE #2 SPF (UNO).
  2. CIRCLES DENOTE (3) 2 x 4 POSTS FOR ROOF SUPPORT.
  3. FRAME DOKMER WALLS ON TOP OF DOUBLE OR TRIPLE RAFTERS.
  4. HIP SPLICES ARE TO BE SPACED A MIN. OF 8'-O'. FASTEN MEMBERS WITH THREE ROWS OF 12d NAILS ⊕ 16' O.C. (TYP.)
  5. STICK FRAME OVER-FRAMED ROOF SECTIONS W/ 2 x 8 RIDGES. 2 x 6 RAFTERS ⊕ 16' O.C. AND FLAT 2 x 10 VALLEYS OR USE VALLEY TRUSSES.
  6. FASTEN FLAT VALLEYS TO RAFTERS OR TRUSSES WITH SIMPSON H2.5A HUBRICANE TIES ⊕ 32' O.C. MAX. PASS HURRICANE TIES 0 THROUGH NOTICH IN ROOF SHEATHING. EACH RAFTER IS TO BE FASTENED TO THE FLAT VALLEY WITH A MIN. OF (6) 12d TOC NAILS.
  7. REFER TO SECTION R802.11 OF THE 2018 NORG FOR REQUIRED UPUFT RESISTANCE AT RAFTERS AND TRUSSES.
  8. REFER TO NOTES AND DETAIL SHEETS FOR ADDITIONAL STRUCTURAL INFORMATION.

|      | LEGEND                 |
|------|------------------------|
| XT   | EXTRA TRUSS            |
| TS   | TRUSS SUPPORT          |
| XR   | EXTRA RAFTER           |
| RS   | RAFTER SUPPORT         |
| CONT | CONTINUOUS             |
| EA   | EACH                   |
| OC   | ON CENTER              |
| SPF  | SPRUCE PINE FIR        |
| SYP  | SOUTHERN YELLOW PINE   |
| TYP  | TYPICAL                |
| UNO  | UNLESS NOTED OTHERWISE |

DATE: DECEMBER 22, 2022


SCALE: 1/4" = 1'-0"

DRAWN BY: H&H HOMES


JACKSON DREAM FINDERS HOMES

ENGINEERED BY: WFB


SHEET: 13 OF: 14 S-4a ROOF FRAMING PLAN

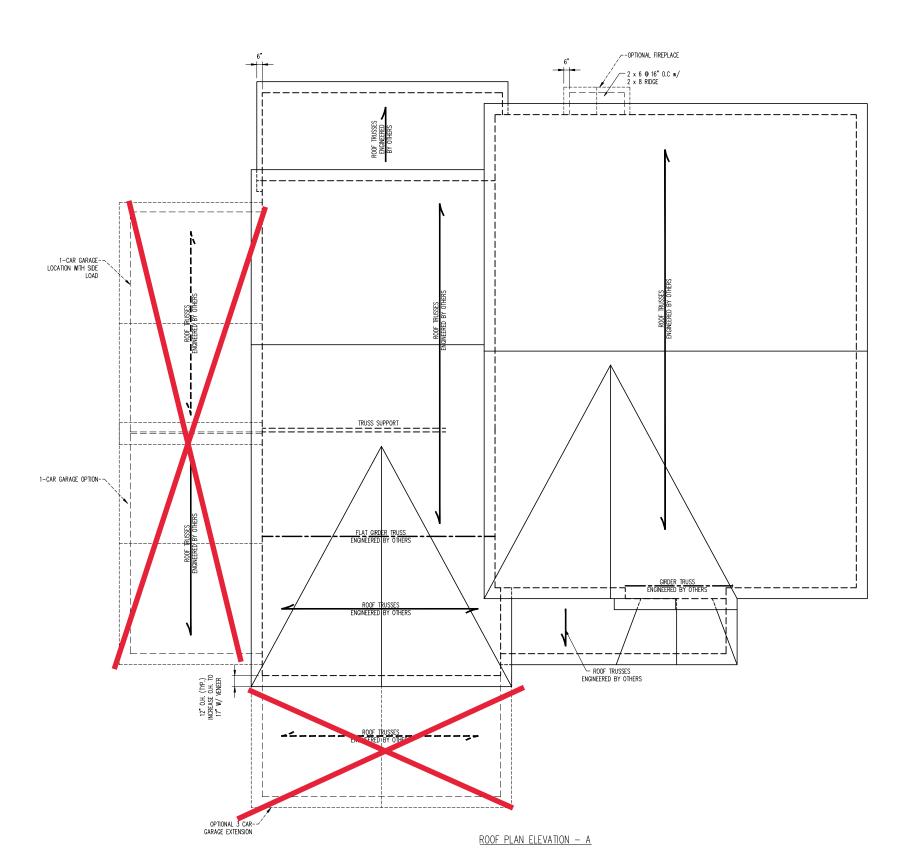




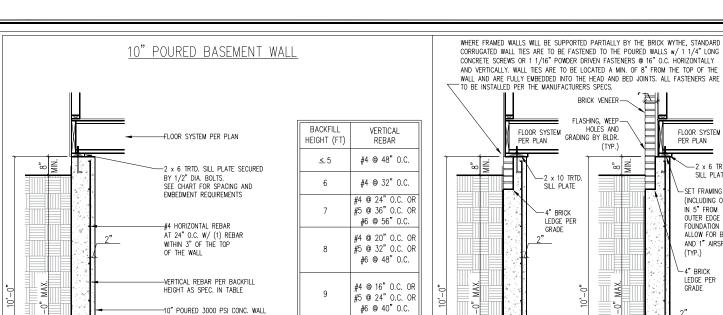

BASEMENT WALL REINFORCEMENT TABLE

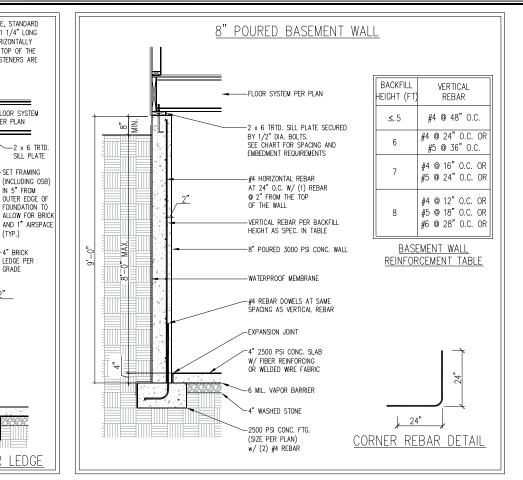

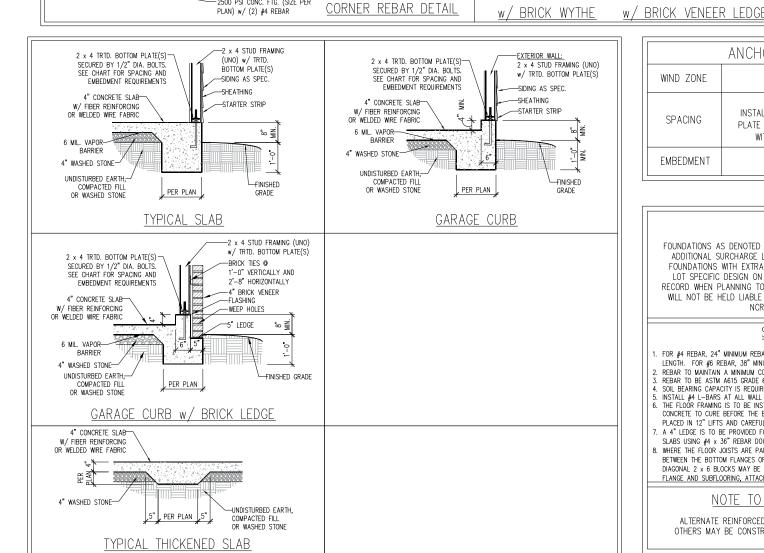

-WATERPROOF MEMBRANE

EXPANSION JOINT 4" 2500 PSI CONC. SLAB

W/ FIBER REINFORCING OR WELDED WIRE FABRIC

6 MII VAPOR BARRIFR

-2500 PSI CONC. FTG. (SIZE PER

4" WASHED STONE

#4 REBAR DOWELS AT SAME

| ANCHOR SPACING AND EMBEDMENT |   | NOTE:  |   |
|------------------------------|---|--|---|
| WIND ZONE                    | 120 MPH   | 130 MPH  | THREADED ROD WITH EPOXY,  |
| SPACING                      | 6'-0" O.C.<br>INSTALL MIN. (2) ANCHORS PER<br>PLATE SECTION AND (1) ANCHOR<br>WITHIN 12" OF CORNERS | 4'-0" O.C. INSTALL MIN. (2) ANCHORS PER PLATE SECTION AND (1) ANCHOR WITHIN 12" OF CORNERS | SIMPSON TITEN HD, OR APPROVED<br>ANCHORS SPACED AS REQUIRED TO<br>PROVIDE EQUIVALENT ANCHORAGE<br>TO 1/2" DIAMETER ANCHOR BOLTS |
| EMBEDMENT                    | 7"  | 15" INTO MASONRY<br>7" INTO CONCRETE   | MAY BE USED IN LIEU OF 1/2"<br>ANCHOR BOLTS.  |
|                              |   |  |   |

# IMPORTANT NOTE:

FOUNDATIONS AS DENOTED IN THESE DETAILS ARE <u>NOT</u> SUITABLE FOR SUPPORT OF ADDITIONAL SURCHARGE LOADING FROM ADJACENT STRUCTURES OR DRIVEWAYS. FOUNDATIONS WITH EXTRA LATERAL LOADING IN THESE SCENARIOS WILL REQUIRE LOT SPECIFIC DESIGN ON A CASE BY CASE BASIS. CONSULT THE ENGINEER OF RECORD WHEN PLANNING TO BUILD IN CLOSE PROXIMITY TO THE FOUNDATION AS WE WILL NOT BE HELD LIABLE FOR FOUNDATION FAILURE. SEE R403.1.9 OF THE 2018 NCRC FOR ADDITIONAL INFORMATION.

# STRUCTURAL NOTES:

- FOR #4 REBAR, 24" MINIMUM REBAR LAP SPLICE LENGTH. FOR #5 REBAR, 32" MINIMUM REBAR LAP SPLICE LENGTH. FOR #6 REBAR, 38" MINIMUM REBAR LAP SPLICE LENGTH.
- REBAR TO MAINTAIN A MINIMUM CONCRETE COVER OF 3" (UNO). REBAR TO BE ASTM A615 CRADE 60
- . NICLANIA TO BE ANNIA OF THE REQUIRED TO BE 2000 PSF MIN.
  . INSTALL #4 L-BARS AT ALL WALL CORNERS AT SAME SPACING AS HORIZ. STEEL. SEE DETAIL. THE FLOOR FRAMING IS TO BE INSTALLED AND A MIN. OF SEVEN DAYS IS REQUIRED TO ALLOW THE CONCRETE TO CURE BEFORE THE BACKFILL CAN BE INSTALLED. THE BACKFILL IS RECOMMENDED TO BE PLACED IN 12" LIFTS AND CARFFULLY TAMPED.
- A 4" LEDGE IS TO BE PROVIDED FOR THE PORCH SLAB. THE WALLS ARE REQUIRED TO BE BONDED TO THE SLABS USING  $\#4 \times 36$ " REBAR DOWELS 32" O.C. EMBEDDED 4" INTO THE CONC. USING EPOXY.
- WHERE THE FLOOR JOISTS ARE PARALLEL TO THE WALLS, 2 x 4 BLOCKING IS TO BE INSTALLED 24" O.C. BETWEEN THE BOTTOM FLANGES OF THE I-JOISTS FOR A MIN. OF 6'-0" AWAY FROM THE WALL OR DIAGONAL  $2 \times 6$  BLOCKS MAY BE INSTALLED  $24^{\prime\prime}$  O.C. FROM THE EDGE OF THE SILL PLATE TO THE TOP FLANGE AND SUBFLOORING, ATTACHED W/ (3) 12d NAILS EACH END.

# NOTE TO FOUNDATION CONTRACTOR:

ALTERNATE REINFORCED CONCRETE POURED WALL DESIGNS ENGINEERED BY OTHERS MAY BE CONSTRUCTED. NO CONTINUOUS FOOTINGS OR LUG FOOTINGS MAY BE REDUCED IN SIZE.



This sealed page is to be used in conjunction with a full plan set engineered by J.S. Thompson Engineering, Inc. only. Use of this individual sealed page within rchitectural pages or shop drawing by others is a punishable offense under N.C. Statute § 89C-23

ഗ COMPS, SAD, SUITE 180 RALE RALE (919) 789,9919 FAX. (919) 78 S. THO

ЫШ≋

130 MPH ULTIMATE DESIGN WIND SPEED WALL BASEMENT FOUNDATION DETAILS DREAM FINDERS HOMES 120 MPH.
POURED

ATE: NOVEMBER 29, 2022 CALE: NTS

NOINEERED BY: JST

FOUNDATION DETAILS

D-3

KANYANNYANNYANNYANNY

RAWN BY: JST NGINEERED BY: JST

D-1 FOUNDATION DETAILS




DETAIL 1

DETAIL 2 —BRICK TIES ®
1'-0" VERTICALLY AND
2'-8" HORIZONTALLY TRID. BOTTOM PLATE SECURED BY-\_\_\_4" BRICK VENEER —FLASHING 4" CONCRETE SLAB-W/ FIBER REINFORCING OR WELDED WIRE FABRIC -WEEP HOLES .w. w. 4" COMPACTED— WELL-DRAINING SOIL OR WASHED STONE -LADDER WIRE EVERY OTHER COURSE -12" CMU BLOCK TOP TWO COLIRSES OF STEM--20" WIDE BY 8" DEEP CONT. CONC. FTG. WALL AND ALL CELLS w/ REINF. TO BE GROUTED SOLID.

TYPICAL STEM WALL FND. W/ BRICK DETAIL

DETAIL 3 WALL FRAMING AND TRTD. SILL—
PLATE PER PLAN
TRTD. BOTTOM PLATE SECURED BY— -SIDING AS SPEC. -SHEATHING 1/2" DIA. BOLTS. SEE CHART FOR SPACING AND EMBEDMENT REQ. 4" CONCRETE SLAB W/ FIBER REINFORCING OR WELDED WIRE FABRIC 6 MIL. VAPOR— BARRIER 4" COMPACTED WELL-DRAINING SOIL OR WASHED STONE UNDISTURBED EARTH,— COMPACTED FILL OR WASHED STONE -LADDER WIRE EVERY OTHER COURSE -8" CMU BLOCK TOP TWO COURSES OF STEM-TYPICAL STEM WALL FND. DETAIL

w/ CURB @ GARAGE

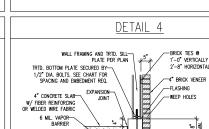

AND CURB @ GARAGE

| DETAIL 8   |   |  |
|--|---|--|
| INSIDE EDGE OF<br>MASONRY STEMWALL                   | 1/2" ANCHOR ROD<br>SPACED PER TABLE           |  |
| LADDER WIRE PER DETAIL  BRICK MASONRY                | 000 000                                       |  |
| OUTSIDE EDGE OF BRICK AND<br>STICK FRAMED WALL ABOVE | NOTCH BRICK ® THREADED ROD<br>AND GROUT SOLID |  |
| THREADED ROD THE                                     | ROUGH BRICK MASONRY                           |  |

# MONOLITHIC SLAB DETAILS DETAIL 2 WALL FRAMING AND TRTD. SILL— PLATE PER PLAN WALL FRAMING AND TRTD. SILL— PLATE PER PLAN BRICK TIES ® 1'-0" VERTICALLY AND 2'-8" HORIZONTALLY -SIDING AS SPEC. -SHEATHING TRTD. BOTTOM PLATE SECURED BY— 1/2" DIA. BOLTS. SEE CHART FOR SPACING AND EMBEDMENT REQ. -4" BRICK VENEER STARTER STRIP -WEEP HOLES 4" CONCRETE SLAB-–5" LEDGE / FINISHED GRADE 4" COMPACTED WELL-DRAINING-

1'-4"

BRICK TIES ® 1'-0" VERTICALLY AND 2'-8" HORIZONTALLY

-4" BRICK VENEER
-FLASHING
-WEEP HOLES
-5" LEDGE

DETAIL 4

WALL FRAMING AND TRTD. SILL— PLATE PER PLAN

UNDISTURBED EARTH, COMPACTED— FILL OR WASHED STONE

TYPICAL SLAB DETAIL BRICK VENEER DETAIL

WALL FRAMING AND TRTD. SILL— PLATE PER PLAN 4" CONCRETE SLAB 4" CONCRETE SLAB W/ FIBER REINFORCING OR WELDED WIRE FABRIC W/ FIBER REINFORCING R WELDED WIRE FABRIC 6 MIL. VAPOR BARRIER 6 MIL. VAPOR BARRIER COMPACTED WELL-DRAINING-SOIL OR WASHED STONE UNDISTURBED EARTH, COMPACTED— FILL OR WASHED STONE UNDISTURBED EARTH, COMPACTED—
FILL OR WASHED STONE

GARAGE CURB DETAIL

DETAIL 5

DETAIL 3

DETAIL 1


TRTD. BOTTOM PLATE SECURED BY-1/2" DIA. BOLTS. SEE CHART FOR SPACING AND EMBEDMENT REQ.

4" CONCRETE SLAB-

4" COMPACTED WELL-DRAINING-SOIL OR WASHED STONE

UNDISTURBED EARTH, COMPACTED— FILL OR WASHED STONE


4" CONCRETE SLAB-W/ FIBER REINFORCING OR WELDED WIRE FABRIC

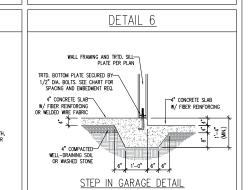

GARAGE CURB BRICK LEDGE DETAIL


THICKENED SLAB DETAIL

5" PER PLAN 5"

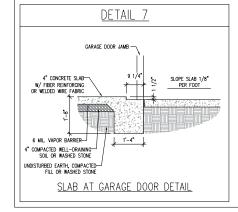

| <u>DETAIL 1</u>  | OPTIONAL DETAIL 1  |
|--|--|
| WALL FRAMING AND TRITD. SILL— PLATE FER PLAN  TRID. BOTTOM PLATE SECURED BY  1/2" DIA. BOTTS, SEE CHART FOR SPACING AND ENGEDMENT REQ.  4" CONCRETE ES ARB 4" LEDGE  4" COMPACTED THE RENTORCING  WILLOED WER FARRIC  6 MIL VAPORE BARRIER  4" COMPACTED THE ARBIC  6 MIL VAPORE WASHED STONE  UNDISTURBED EARTH- COMPACTED THE OF THE OFFICE ARBIC  100 PT TWO COURSES OF STEM  WALL AND ALL CELLS W  REINF. 10 BE GROUTED SOLID.  105 WOE BY 8" DEEP  CONC. FTG.  106 WOE BY 8" DEEP  CONC. FTG. | WALL FRAMING AND TRID. SILL PLATE FER PLAN  TRID. BOTTOM PLATE SECURED BY- 1/2" DIA. BOLTS. SEE CHART FOR SPEANON AND DIRECUPANT FICE.  SEE THERAGE PROCES  A* LEDGE  A* LEDGE  A* LEDGE  A* CONCRETE SLIB  A* LEDGE  W/ FIBER RENF GROWG  OR NELICIES WHE FARRIC  6 MLL VAPOR  BARGER  A* COMPACTED  LIMISTURBED FARRIC  LIMISTURBED FARRIC  OFFICE COSTS. CEST WINT SLIB  LIMISTURBED FARRIC  OFFICE COSTS. CEST WINT SLIB  TOP TWO COURSES OF STEM  WALL AND ALL CELLS. W/ REINF. TO BE GROUTED SOULD.  TOP TWO COURSES OF STEM  WALL AND ALL CELLS. W/ REINF. TO BE GROUTED SOULD.  TOP TWO COURSES OF STEM  WALL AND ALL CELLS. W/ REINF. TO BE GROUTED SOULD.  TOP TWO COURSES OF STEM  WALL AND ALL CELLS. W/ REINF. TO BE GROUTED SOULD.  TOP TWO COURSES OF STEM  WALL AND ALL CELLS. W/ REINF. TO BE GROUTED SOULD.  TOP TWO COURSES OF STEM  WALL AND ALL CELLS. W/ REINF. TO BE GROUTED SOULD.  TOP TWO COURSES OF STEM  WALL AND ALL CELLS. W/ REINF. TO BE GROUTED SOULD.  COURSE COURSE OF STEM  COURSE COURSE COURSE OF STEM  TOP TWO COURSES OF STEM  WALL AND ALL CELLS. W/ REINF. TO BE GROUTED SOULD.  COURSE COURSE COURSE  COURSE COURSE COURSE  RECAST WITH SALE SALE SALE SALE SALE SALE SALE SALE |
| TYPICAL STEM WALL DETAIL (w/ OPTIONAL WATERTABLE)  | OPTIONAL STEM WALL DETAIL  |

OPTIONAL DETAIL 3

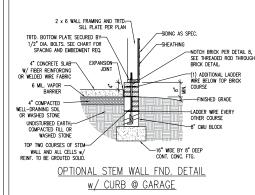

1'-0" VERTICALLY AND 2'-8" HORIZONTALLY 4" COMPACTED— WELL-DRAINING SOIL OR WASHED STONE UNDISTURBED EARTH, COMPACTED FILL OR WASHED STONE TOP TWO COURSES OF STEM WALL AND ALL CELLS w/ REINF. TO BE GROUTED SOLID. TYPICAL STEM WALL FND. DETAIL W/ BRICK

UNGROUTED GROUT SOLID UNGROUTED UNGROUTED GROUT SOLID w/ #4 GROUT SOLID w/ #4 4 GROUT SOLID GROUT SOLID REBAR @ 48" 0.0 REBAR @ 64" O.C. GROUT SOLID w/ #4 GROUT SOLID w/ #4 GROUT SOLID w/ #4 NOT APPLICABLE REBAR @ 36" 0.0 REBAR @ 36" 0.0 REBAR @ 64" 0 C GROUT SOLID w/ #4 GROUT SOLID w/ #4 GROUT SOLID w/ #4 REBAR @ 24" O.C. REBAR @ 64" O.C. NOT APPLICABLE REBAR @ 24" O.C. 7 AND GREATER ENGINEERED DESIGN BASED ON SITE CONDITIONS STRUCTURAL NOTES: WALL HEIGHT MEASURED FROM TOP OF FOOTING TO TOP OF THE WALL.
THE MULTIPLE WYTHES TOGETHER WITH LADDER WIRE AT 16" O.C. VERTICALLY.
CHART APPLICABLE FOR HOUSE FOUNDATION ONLY, CONSULT ENGINEER FOR DESIGN OF GARAGE FOUNDATION NOT COMMON TO HOUSE

MASONRY STEMWALL SPECIFICATIONS

4" BRICK AND

4" CMII

MASONRY WALL TYPE

4" BRICK AND

8" CMII

12" CMU

UNGROUTED

- BACKFILL OF CLEAN #57 / #67 WASHED STONE IS ALLOWABLE.

8" CMU

UNGROUTED

2 AND BELOW

- 5. BACKFILL OF WELL DRAINED OR SAND GRAVEL MIXTURE SOILS (45 PSF/FT BELOW GRADE) CLASSIFIED AS GROUP I ACCORDING TO UNIFIED SOILS CLASSIFICATION SYSTEM IN ACCORDANCE WITH TABLE R405.1
- OF THE 2018 INTERNATIONAL RESIDENTIAL CODE ARE ALLOWABLE.

  PREP SLAB PER R506.2.1 AND R506.2.2 BASE OF THE 2018 INTERNATIONAL RESIDENTIAL CODE.
- . MINIMUM 24" LAP SPLICE LENGTH 8. LOCATE REBAR IN CENTER OF FOUNDATION WALL.
- WHERE REQUIRED, FILL BLOCK SOLID WITH TYPE "S" MORTAR OR 3000 PSI GROUT. USE OF "LOW LIFT GROUTING" METHOD REQUIRED WHEN FILLING WALLS WITH GROUT AT HEIGHTS OF 5' AND GREATER.

| - |           |           |   |   |
|---|-----------|-----------|---|---|
|   |           |           | ANCHOR SPACING AND  | EMBEDMENT   |
|   | WIND ZONE | 120 MPH   | 130 MPH   |   |
| _ |           | SPACING   | 6'-0" O.C.<br>INSTALL MIN. (2) ANCHORS PER<br>PLATE SECTION AND (1) ANCHOR<br>WITHIN 12" OF CORNERS | 4'-0" O.C.<br>INSTALL MIN. (2) ANCHORS PER<br>PLATE SECTION AND (1) ANCHOR<br>WITHIN 12" OF CORNERS |
|   |           | EMBEDMENT | 7"  | 15" INTO MASONRY<br>7" INTO CONCRETE  |
|   |           |           |   |   |

THREADED ROD WITH EPOXY, SIMPSON TITEN HD. OR APPROVED ANCHORS SPACED AS REQUIRED TO PROVIDE EQUIVALENT ANCHORAGE TO 1/2" DIAMETER ANCHOR BOLTS MAY BE USED IN LIEU OF 1/2" ANCHOR BOLTS.



This sealed page is to be used in

oniunction with a full plan set

engineered by J.S. Thompson Engineering, Inc. only. Use of this individual sealed page within

rchitectural pages or shop draw

mder N.C. Statute § 89C-23

DATE: NOVEMBER 28, 2022

SCALE: 1/4" = 1'40" DRAWN BY: IST

NGINEERED BY: JST

D-2 BRACED WALL NOTES AND DETAILS AND PF DETAIL

GENERAL WALL BRACING NOTES:

I. WALL BRACING DESIGNED IN ACCORDANCE WITH CHAPTER 6 OF THE 2018 NC RESIDENTIAL BUILDING CODE (NCRC). TABLES AND FIGURES REFERENCED ARE FROM THE 2018 NCRC.
SEE THIS SHEET FOR GENERAL DETAILS. REFER TO THE 2018 NCRC FOR ADDITIONAL INFORMATION AS NEEDED.

BRACED EXTERIOR WALLS SUPPORTING ROOF TRUSSES AND RAFTERS, INCLUDING STORES BELOW THE TOP FLOOR, HAVE BEEN DESIGNED PER R602.3.5 (3). WALL SHEATHING AND FASTENERS HAVE BEEN DESIGNED TO RESIST COMBINED UPLIFT AND SHEAR FORCES IN ACCORDANCE WITH ACCEPTED ENGINEERED PRACTICE.

FORCES IN ACCURANCE WITH ACCEPTED ENGINEERED PRACTICE.

SET STRUCTURAL SHEETS FOR BRACED WALL LOCATIONS, DIMENSIONS, HOLD DOWN TYPE AND LOCATIONS, BRACED WALL LINE KEY
WITH WALL DESIGN SUMMARY OF REQUIRED/PROVIDED TOTALS FOR EACH WALL LINE AND ANY SPECIAL NOTES OR REQUIREMENTS.

ALL EXTERIOR WALLS ARE TO BE SHEATHED WITH CS-WSP IN ACCORDANCE WITH SECTION R602.10.3 UNLESS NOTED OTHERWISE.


6. ALL EXTERIOR AND INTERIOR WALLS TO HAVE 1/2" GYPSUM INSTALLED, WHEN NOT USING METHOD "GB", GYPSUM TO BE FASTENED PER TABLE R702.3.5. METHOD GB TO BE FASTENED PER TABLE R602.10.1
7. CS-WSP REFERS TO THE "CONTINUOUS SHEATHING - WOOD STRUCTURAL PANELS" WALL BRACING METHOD. 7/16" OSB


7. CS-MSF REFERS TO THE CONTINUOUS SHEATING — MOUD STRUCTURAL PARKETS WALL BRACHING METHOUS. 7/10 OSB SHEATINGS TO BE INSTALLED ON ALL EXTERIOR WALLS ATTACHED W/ 6d COMMON NALLS OR 8d (2 1/2" LONG x 0.113" DIAMETER) NAILS SPACED 6" O.C. ALONG PANEL EDGES AND 12" O.C. IN THE FIELD (U.N.O.).


8. GB REFERS TO THE "CYPSUM BOARD" WALL BRACHING METHOD. 1/2" MIN.) CYPSUM WALL BOARD IS TO BE INSTALLED ON BOTH SIDES OF THE BRACED WALL FASTENED WITH 1 1/4" SCREWS OR 1 5/8" NAILS SPACED 7" O.C. ALONG PANEL EDGES INCLUDING TOP AND BOTTOM PLATES AND INTERMEDIATE SUPPORTS (LLN.O.) VERIFY ALL EASTENER OPTIONS FOR 1/2" AND 5/8" GYPSIM PRIOR TO CONSTRUCTION. FOR INTERIOR FASTENER OPTIONS SEE TABLE R702.3.5. FOR EXTERIOR FASTENER OPTIONS SEE TABLE


R602.3(1). EXTERIOR GB TO BE INSTALLED VERTICALLY.

9. REQUIRED BRACED WALL LENGTH FOR EACH SIDE OF THE CIRCUMSCRIBED RECTANGLE ARE INTERPOLATED PER TABLE R602. 10.3. METHOD CS-WSP CONTRIBUTES ITS ACTUAL LENGTH, METHOD GB CONTRIBUTES .5 ITS ACTUAL LENGTH, AND METHOD PF

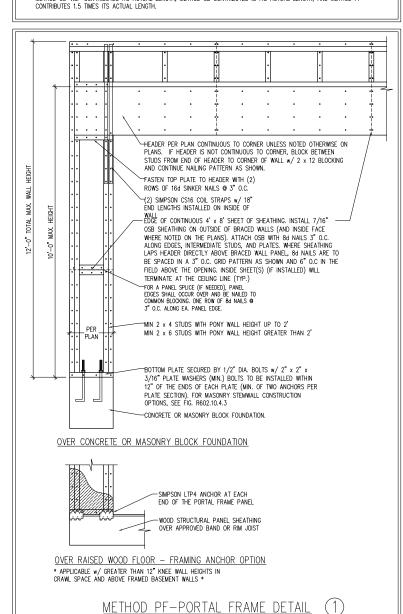


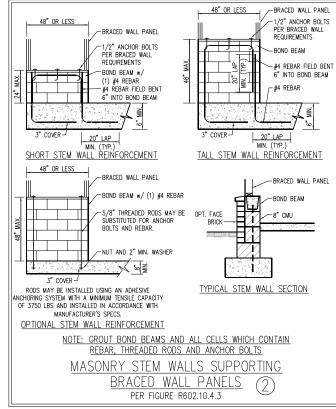

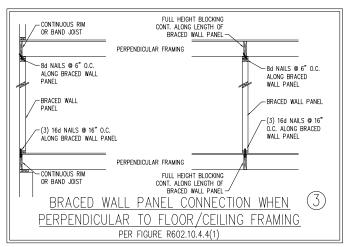

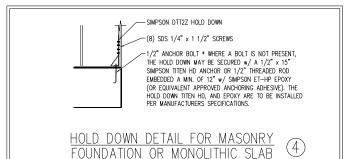



\* APPLICABLE ONLY WHERE SPECIFIED ON PLAN \*

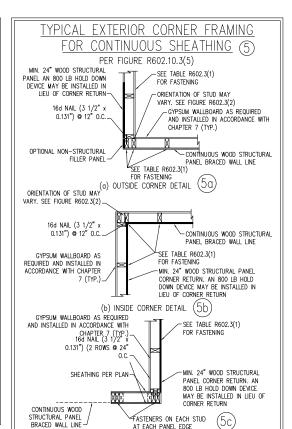

(c) GARAGE DOOR CORNER DETAIL (SEE PLAN FOR ADDITIONAL

STRUCTURAL INFORMATION OR ALTERNATE CONFIGURATIONS)

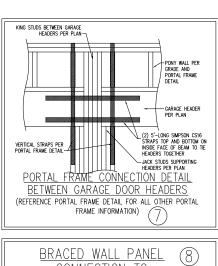

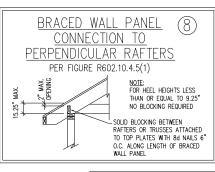

BRACED WALL PANEL


CONNECTION TO


TRUSSES

— 2 x BLOCKING

NAILING PER

R602.3(1)

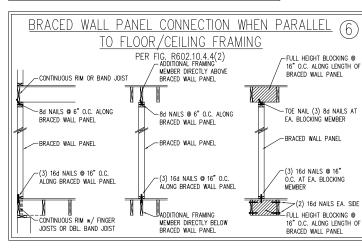

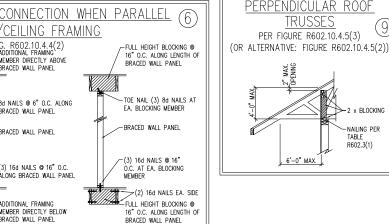

Thompson Engineering, Inc. only. Use of this individual sealed page within itectural pages or shop drawings by others is a punishable offense under N.C Statute § 89C-23

2538 SEAL 33736

ഗ

OMI

H

: **5** 

လ်ြို့

# GENERAL NOTES

- 1. ENGINEER'S SEAL APPLIES ONLY TO STRUCTURAL COMPONENTS INCLUDING ROOF RAFTERS, HIPS, VALLEYS, RIDGES, FLOORS, WALLS, BEAMS, HEADERS, COLUMNS, CANTILEVERS, OFFSET LOAD BEARING WALLS, PIERS, GIRDER SYSTEM AND FOOTING. ENGINEER'S SEAL DOES NOT CERTIFY DIMENSIONAL ACCURACY OF ARCHITECTURAL LAYOUT INCLUDING ROOF. ENGINEER'S SEAL DOES NOT APPLY TO I-JOIST OR FLOOR/ROOF TRUSS LAYOUT DESIGN AND
- ALL CONSTRUCTION SHALL CONFORM TO THE LATEST REQUIREMENTS OF THE NORTH CAROLINA RESIDENTIAL CODE (NCRC), 2018 EDITION, PLUS ALL LOCAL
  CODES AND REQULATIONS. THE STRUCTURAL ENGINEER IS NOT RESPONSIBLE FOR, AND WILL NOT HAVE CONTROL OF, CONSTRUCTION MEANS, METHODS, TECHNIQUES SEQUENCES OR PROCEDURES OR SAFETY PRECAUTIONS AND PROGRAMS IN CONNECTION WITH THE CONSTRUCTION WORK. NOR WILL THE ENGINEER BE RESPONSIBLE FOR THE CONTRACTORS FAILURE TO CARRY OUT THE CONSTRUCTION WORK IN ACCORDANCE WITH THE CONTRACT DOCUMENTS.
- 3. STRUCTURAL DESIGN BASED ON THE PROVISIONS OF THE NCRC, 2018 EDITION (R301.4 R301.7)

| DESIGN CRITERIA:               | LIVE LOAD (PSF)                                   | DEAD LOAD (PSF) | DEFLECTION (IN)                   |
|--------------------------------|---|-----------------|-----------------------------------|
| ATTIC WITH LIMITED STORAGE     | 20  | 10              | L/240 (L/360 w/ BRITTLE FINISHES) |
| ATTIC WITHOUT STORAGE          | 10  | 10              | L/360                             |
| DECKS                          | 40  | 10              | L/360                             |
| EXTERIOR BALCONIES             | 40  | 10              | L/360                             |
| FIRE ESCAPES                   | 40  | 10              | L/360                             |
| HANDRAILS/GUARDRAILS           | 200   | 10              | L/360                             |
| PASSENGER VEHICLE GARAGE       | 50  | 10              | L/360                             |
| ROOMS OTHER THAN SLEEPING ROOM | 40  | 10              | L/360                             |
| SLEEPING ROOMS                 | 30  | 10              | L/360                             |
| STAIRS                         | 40  | 10              | L/360                             |
| WIND LOAD                      | (BASED ON TABLE R301.2(4) WIND ZONE AND EXPOSURE) |                 |                                   |
| GROUND SNOW LOAD: Pg           | 20 (PSF)  | ,               |                                   |

- I-JOIST SYSTEMS DESIGNED WITH 12 PSF DEAD LOAD AND DEFLECTION (IN) OF L/480
- FLOOR TRUSS SYSTEMS DESIGNED WITH 15 PSF DEAD LOAD
- 4. FOR 115 AND 120 MPH WIND ZONES, FOUNDATION ANCHORAGE IS TO COMPLY WITH SECTION R403.1.6 OF THE NCRC, 2018 EDITION. FOR 130 MPH, 140 MPH, AND 150 MPH WIND ZONES, FOUNDATION ANCHORAGE IS TO COMPLY WITH SECTION 4504 OF THE NCRC, 2018 EDITION,
- 5. ENERGY EFFICIENCY COMPLIANCE AND INSULATION VALUES OF THE BUILDING TO BE IN ACCORDANCE WITH CHAPTER 11 OF THE NCRC, 2018 EDITION.

# FOOTING AND FOUNDATION NOTES

- FOUNDATION DESIGN BASED ON A MINIMUM ALLOWABLE BEARING CAPACITY OF 2000 PSF. CONTACT GEOTECHNICAL ENGINEER IF BEARING CAPACITY IS NOT ACHIEVED.
- 2, FOR ALL CONCRETE SLABS AND FOOTINGS, THE AREA WITHIN THE PERIMETER OF THE BUILDING ENVELOPE SHALL HAVE ALL VEGETATION, TOP SOIL AND FOREIGN MATERIAL REMOVED. FILL MATERIAL SHALL BE FIRE OF VEGETATION AND FOREIGN MATERIAL. THE FILL SHALL BE COMPACTED TO ASSURE UNIFORM SUPPORT OF THE SLAB, AND EXCEPT WHERE APPROVED, THE FILL DEPTHS SHALL NOT EXCEED 24" FOR CLEAN SAND OR GRAVEL. A 4" HICK BASED COURSE CONSISTING OF CLEAN GRADED SAND OR GRAVEL SHALL BE PLACED. A BASE COURS IS NOT REQUIRED WHERE A CONCRETE SLAB IS INSTALLED ON WELL-DRAINED OR SAND—GRAVEL MIXTURE SOILS CLASSIFIED AS GROUP 1, ACCORDING TO THE UNITIED SOIL CLASSIFICATION SYSTEM IN ACCORDANCE WITH TABLE R405.1 OF THE NCRC. 2018 EDITION.
- 3. PROPERLY DEWATER EXCAVATION PRIOR TO POURING CONCRETE WHEN BOTTOM OF CONCRETE SLAB IS AT OR BELOW WATER TABLE. IF APPLICABLE,  $3/4^*-1^*$  DEEP CONTROL JOINTS ARE TO BE SAWED WITHIN 4 TO 12 HOURS OF CONCRETE FINISHING AND WALL LOCATIONS HAVE BEEN MARKED. ADJUST WHERE NECESSARY
- 4. CONCRETE SHALL CONFORM TO SECTION R402.2 OF THE NCRC, 2018 EDITION. CONCRETE REINFORCING STEEL TO BE ASTM A615 GRADE 60. WELDED WIRE FABRIC TO BE ASTM A615. MAINTAIN A MINIMUM CONCRETE COVER AROUND REINFORCING STEEL OF 3" IN FOOTINGS AND 1 1/2" IN SLABS. FOR POURED CONCRETE WALLS, CONCRETE COVER FOR REINFORCING STEEL MEASURED FROM THE INSIDE FACE OF THE WALL SHALL NOT BE LESS THAN 3/4". CONCRETE COVER FOR REINFORCING STEEL MEASURED FROM THE OUTSIDE FACE OF THE WALL. SHALL NOT BE LESS THAN 1 1/2" FOR #5 BARS OR SMALLER, AND NOT LESS THAN 2" FOR #6 BARS OR LARGER.

This sealed page is to be used in conjunction with a

full plan set engineered by L.S. Thompson Engineerin

Inc. only. Use of this individual sealed page within

architectural pages or shop drawings by others is a

nunishable offense under N.C. Statute \$ 89C-23

- 5. MASONRY UNITS TO CONFORM TO ACE 530/ASCE 5/TMS 402. MORTAR SHALL CONFORM TO ASTM C270.
- 6. THE UNSUPPORTED HEIGHT OF MASONRY PIERS SHALL NOT EXCEED FOUR TIMES THEIR LEAST DIMENSION FOR UNFILLED HOLLOW CONCRETE MASONRY UNITS AND TEN TIMES THEIR LEAST DIMENSION FOR SOLID OR SOLID FILLED PIERS. PERS MAY BE FILLED SOLID WITH CONCRETE OR TYPE M OR S MORTAR. PIERS AND WALLS SHALL BE CAPPED WITH 8" OF SOLID MASONRY
- 7. THE CENTER OF EACH OF THE PIERS SHALL BEAR IN THE MIDDLE THIRD OF ITS RESPECTIVE FOOTING. EACH GIRDER SHALL BEAR IN THE MIDDLE THIRD OF THE PIERS.
- 8. ALL CONCRETE AND MASONRY FOUNDATION WALLS ARE TO BE CONSTRUCTED IN ACCORDANCE WITH THE PROVISIONS OF SECTION R404 OF THE NCRC, 2018 EDITION OR IN ACCORDANCE WITH ACI 318, ACI 332, NCMA TR68-A OR ACE 530/ASCE 5/TMS 402. MASONRY FOUNDATION WALLS ARE TO BE REINFORCED PER TABLE R404.1.1(1), R404.1.1(2), R404.1.1(3), OR R404.1.1(4) OF THE NCRC, 2018 EDITION. CONCRETE FOUNDATION WALLS ARE TO BE REINFORCED PER TABLE R404.1.1(5) OF THE NCRC. 2018 EDITION. STEP CONCRETE FOUNDATION WALLS TO 2 x 6 FRAMED WALLS AT 16" O.C. WHERE GRADE PERMITS (UNO).

- 2. LAMINATED VENEER LUMBER (LVL) SHALL HAVE THE FOLLOWING MINIMUM PROPERTIES: Fb = 2600 PSI, Fv = 285 PSI, E = 1900000 PSI, LAMINATED STRAND LUMBER (LSL) SHALL HAVE THE FOLLOWING MINIMUM PROPERTIES: Fb = 2325 PSI, Fv = 310 PSI, E = 1550000 PSI. PARALLEL STRAND (PSL) MORE THAN 7" DEPTH SHALL HAVE THE FOLLOWING MINIMUM PROPERTIES: Fc = 2900 PSI, E = 2000000 PSI. INSTALL ALL CONNECTIONS PER MANUFACTURER'S SPECIFICATIONS.
- 3. STRUCTURAL STEEL SHALL CONFORM TO THE FOLLOWING ASTM SPECIFICATIONS

| A. | M AND MI SHAPES:            | ASIM A992                      |
|----|-----------------------------|--------------------------------|
| B. | CHANNELS AND ANGLES:        | ASTM A36                       |
| C. | PLATES AND BARS:            | ASTM A36                       |
| D. | HOLLOW STRUCTURAL SECTIONS: | ASTM A500 GRADE B              |
| E. | STEEL PIPE:                 | ASTM A53, GRADE B, TYPE E OR S |
|    |                             |                                |

4. STEEL BEAMS SHALL BE SUPPORTED AT EACH END WITH A MINIMUM BEARING LENGTH OF 3 1/2" AND FULL FLANGE WIDTH (UNO). PROVIDE SOLID BEARING FROM BEAM SUPPORT TO FOUNDATION. BEAMS SHALL BE ATTACHED AT THE BOTTOM FLANGE TO EACH SUPPORT AS FOLLOWS (UNO):

| A. WOOD FRAMING            | (2) 1/2" DIA. x 4" LONG LAG SCREWS               |
|----------------------------|--|
| B. CONCRETE                | (2) 1/2" DIA. x 4" WEDGE ANCHORS                 |
| C. MASONRY (FULLY GROUTED) | (2) 1/2" DIA. x 4" LONG SIMPSON TITEN HD ANCHORS |
| D. STEEL PIPE COLUMN       | (4) 3/4" DIA. A325 BOLTS OR 3/16" FILLET WELD    |

LATERAL SUPPORT IS CONSIDERED ADEQUATE PROVIDING THE JOISTS ARE TOE NAMED TO THE 2x NAMER ON TOP OF THE STEEL REAM AND THE 2x NAILER IS SECURED TO THE TOP OF THE STEEL BEAM w/ (2) ROWS OF SELF TAPPING SCREWS @ 16" O.C. OR (2) ROWS OF 1/2" DIAMETER BOLTS 16 O.C. IF 1/2 BOLTS ARE USED TO FASTEN THE NAILER, THE STEEL BEAM SHALL BE FABRICATED W/ (2) ROWS OF 9/16 DIAMETER HOLES 10

- WHICH REQUIRE SOLID BLOCKING TO SUPPORTING MEMBER BELOW.
- 6. ALL LOAD BEARING HEADERS TO CONFORM TO TABLE R602.7(1) AND R602.7(2) OF THE NCRC, 2018 EDITION OR BE (2) 2 x 6 WITH (1) JACK AND (1) KING STUD EACH END (UNO), WHICHEVER IS GREATER ALL HEADERS TO BE SECURED TO EACH JACK STUD WITH (4) 8d NAILS. ALL BEAMS TO BE SUPPORTED WITH (2) STUDS AT EACH BEARING POINT (UNO). INSTALL KING STUDS PER SECTION R602.7.5 OF THE NORTH CAROLINA
- 7. ALL BEAMS, HEADERS, OR GIRDER TRUSSES PARALLEL TO WALL ARE TO BEAR FULLY ON (1) JACK OR (2) STUDS MINIMUM OR THE NUMBER OF JACKS OR STUDS NOTED. ALL BEAMS OR GIRDER TRUSSES PERPENDICULAR TO WALL AND SUPPORTED BY (3) STUDS OR LESS ARE TO HAVE 1 1/2" MINIMUM BEARING (UNO). ALL BEAMS OR GIRDER TRUSSES PERPENDICULAR TO WALL AND SUPPORTED BY MORE THAN (3) STUDS OR OTHER NOTED COLUMN ARE TO BEAR FULLY ON SUPPORT COLUMN FOR ENTIRE WALL DEPTH (UNO). BEAM ENDS THAT BUTT INTO ONE ANOTHER ARE TO
- 8. FLITCH BEAMS SHALL BE BOLTED TOGETHER USING 1/2" DIAMETER BOLTS (ASTM A307) WITH WASHERS PLACED AT THREADED END OF BOLT. BOLTS SHALL BE SPACED AT 24" CENTERS (MAXIMUM), AND STAGGERED AT TOP AND BOTTOM OF BEAM (2" EDGE DISTANCE), WITH (2) BOLTS LOCATED AT 6" FROM FACH END (UNO)
- BROUGHT TO THE ATTENTION OF THE ENGINEER OF RECORD PRIOR TO INSTALLATION
- 10. BRACED WALL PANELS SHALL BE CONSTRUCTED ACCORDING TO THE NORTH CAROLINA RESIDENTIAL CODE 2018 EDITION WALL BRACING CRITERIA. THE AMOUNT, LENGTH, AND LOCATION OF BRACING SHALL COMPLY WITH ALL APPLICABLE TABLES IN SECTION R602.10.
- I-JOISTS PER MANUFACTURER'S SPECIFICATIONS. INSTALL BLOCKING BETWEEN JOISTS OR TRUSSES FOR POINT LOAD SUPPORT FOR ALL POINT LOADS ALONG OFFSET LOAD LINES.
- 12. FOR ALL HEADERS SUPPORTING BRICK VENEER THAT ARE LESS THAN 8'-0" IN LENGTH. REST A 6" x 4" x 5/16" STEEL ANGLE WITH 6" MINIMUM EMBEDMENT AT SIDES FOR BRICK SUPPORT (U.N.O). FOR ALL HEADERS 8'-0" AND GREATER IN LENGTH, BOLT A 6" x 4" x 5/16" STEEL ANGLE TO HEADER WITH 1/2" LAG SCREWS AT 12" O.C. STAGGERED FOR BRICK SUPPORT. FOR ALL BRICK SUPPORT AT ROOF LINES, BOLT A 6" x 4" x 5/16" STEEL ANGLE TO (2) 2 x 10 BLOCKING INSTALLED w/ (4) 12d NAILS EA. PLY BETWEEN WALL STUDS WITH (2) ROWS OF 1/2" LAG SCREWS AT 12" O.C. STAGGERED AND IN ACCORDANCE WITH SECTION R703.8.2.1 OF THE NCRC, 2018 EDITION.
- 13. FOR STICK FRAMED ROOFS: CIRCLES DENOTE (3) 2 x 4 POSTS FOR ROOF MEMBER SUPPORT. HIP SPLICES ARE TO BE SPACED A MINIMUM OF 8'-0". FASTEN MEMBERS WITH THREE ROWS OF 12d NAILS AT 16" O.C. FRAME DORMER WALLS ON TOP OF DOUBLE OR TRIPLE RAFTERS AS SHOWN
- 14. FOR TRUSSED ROOFS: FRAME DORMER WALLS ON TOP OF 2 x 4 LADDER FRAMING AT 24" O.C. BETWEEN ADJACENT ROOF TRUSSES. STICK FRAME OVER-FRAMED ROOF SECTIONS WITH 2 x 8 RIDGES, 2 x 6 RAFTERS AT 16" O.C. AND FLAT 2 x 10 VALLEYS (UNO).
- 15. ALL 4 x 4 AND 6 x 6 POSTS TO BE INSTALLED WITH 700 LB CAPACITY LIPLIET CONNECTORS TOP AND ROTTOM (LING.). POSTS MAY BE SECURED. 16" SECTION OF SIMPSON CS16 COIL STRAPPING WITH (8) 8d HDG NAILS AT EACH END MAY BE USED IN LIEU OF EACH TWIST STRAP IF DESIRED. FOR MASONRY OR CONCRETE FOUNDATION USE SIMPSON POST BASE.

# FRAMING NOTES

1. ALL FRAMING LUMBER SHALL BE #2 SPF MINIMUM (Fb = 875 PSI, Fv = 375 PSI, E = 1600000 PSI) UNLESS NOTED OTHERWISE (UNO). ALL TREATED LUMBER SHALL BE #2 SYP MINIMUM (Fb = 975 PSI, Fv =175 PSI, E = 1600000 PSI) UNLESS NOTED OTHERWISE (UNO).

LUMBER (PSL) UP TO 7" DEPTH SHALL HAVE THE FOLLOWING MINIMUM PROPERTIES: Fc = 2500 PSI, E =1800000 PSI. PARALLEL STRAND LUMBER

5. SQUARES DENOTE POINT LOADS WHICH REQUIRE SOLID BLOCKING TO GIRDER OR FOUNDATION, SHADED SQUARES DENOTE POINT LOADS FROM ABOVE

- EACH BEAR EQUAL LENGTHS (UNO).
- 9. ALL I-JOIST OR TRUSS LAYOUTS ARE TO BE IN COMPLIANCE WITH THE OVERALL DESIGN SPECIFIED ON THE PLANS. ALL DEVIATIONS ARE TO BE
- 11. PROVIDE DOUBLE JOIST UNDER ALL WALLS PARALLEL TO FLOOR JOISTS. PROVIDE SUPPORT UNDER ALL WALLS PARALLEL TO FLOOR TRUSSES OR

- USING ONE SIMPSON H6 OR LTS12 UPLIFT CONNECTOR FASTENED TO THE BAND AT THE BOTTOM AND THE BEAM AT THE TOP OF EACH POST. ONE

SPEED - 130 MPH ULTIMATE DESIGN WIND STANDARD STRUCTURAL NOTES DREAM FINDERS HOMES MPH 20

DATE: IUNE 17, 2022

SCALE: NTS DRAWN BY: IST

NOINEERED BY: JST

S-0 STRUCTURAL NOTES