REVISION: DO 1 DATE: 6/20/2022 1. ADD SIDE LOAD GARAGE. REVISION: DO 2 DATE: 7/05/2022 1. ADD OPT. EXTENDED CAFE W/ COVERED PATIO/DECK. REVISION: DO 3 DATE: 7/22/2022

1. ADD STEM WALL SLAB FOUNDATION SHEETS

Lot 105 Duncan's Creek - 304 Beacon Hill Road Lillington, NC 27546

NC.



DESIGN CRITERIA:

THIS PLAN IS TO BE BUILT IN CONFORMANCE WITH THE 2018 NORTH CAROLINA STATE BUILDING CODE: RESIDENTIAL CODE

 ${\bf DIMENSIONS~SHALL~GOVERN~OVER~SCALE,~AND~CODE~SHALL~GOVERN~OVER~DIMENSIONS.}\\$

2010 Smithfield - LH

'LOW COUNTRY' ELEVATION

neet No.	Sheet Description
0.0	Cover Sheet
1.1	Foundation (Slab)
1.1.1	Foundation Options (Slab)
1.1.2	Foundation Options (Slab)
1.2	Foundation (Crawl) Foundation Options (Crawl)
1.2.1	Foundation Options (Crawl)
1.2.2	Foundation (Stem Wall Slab))
	Foundation (Stern Wall Slab)
1.3.1	
1.3.2	Foundation Options (Stem Wall Slab)
2.1	First Floor Plan
2.1.1	First Floor Plan Options
2.2	Second Floor Plan
2.2.1	Second Floor Plan Options
2.3	Opt. Third Floor
2.4	Covered Patio Plans & Elevations (Slab)
2.4.1	Covered Deck Plans & Elevations (Crawl)
2.5	Extended Cafe Elevations & Roof Plan (Slab)
2.5.1	Extended Cafe Elevations & Roof Plan (Crawl)
2.6	Extended Cafe w/ Covered Patio Elevations & Roof Plan (Slab)
2.6.1	Extended Cafe w/ Covered Deck Elevations & Roof Plan (Crawl)
2.7	2-Car Sideload Garage Plans
2.7.1	2-Car Sideload Garage Elevations
3.1	Front & Rear Elevations (Slab)
3.1.1	Front & Rear Elevations (Crawl)
3.1.2	Front & Rear Elevations (Slab) Attic Option
3.1.3	Front & Rear Elevations (Crawl) Attic Option
3.2	Side Elevations (Slab)
3.2.1	Side Elevations (Crawl)
3.2.2	Side Elevations (Slab) Attic Option
3.2.3	Side Elevations (Crawl) Attic Option
3.3	Roof Plan
5.1	First Floor Electrical
5.2	Second Floor Electrical
5.2.1	Second Floor Options Electrical
5.3	Opt. Third Floor Electrical
	1 1

SQUARE	F	00	T/	AGE
		DUNTRY		
	UNHEATED			HEATED
FIRST FLOOR		0		846
SECOND FLOOR		0		1159
FRONT PORCH		56		0
2 CAR GARAGE		414		0
PATIO		144		0
	_			
SUBTOTALS	L	614		2005
	L			
TOTAL UNDER ROOF			26	19
TOTAL UNDER ROOF			26	19
	<u>-</u>	ONS	26	19
	_	ONS HEATED S		HEATED S.F.
	_			
OF	_	HEATED S		HEATED S.F.
OF UNFIN. THIRD FLOOR	_	HEATED S		HEATED S.F.
OF UNFIN. THIRD FLOOR FINISHED THIRD FLOOR	_	HEATED S +554 0		HEATED S.F. 0 +554
UNFIN. THIRD FLOOR FINISHED THIRD FLOOR EXTENDED CAFE	_	+554 0 -144		HEATED S.F. 0 +554 +120
UNFIN. THIRD FLOOR FINISHED THIRD FLOOR EXTENDED CAFE PATIO W/ EXT CAFE	UN	+554 0 -144 +150		HEATED S.F. 0 +554 +120 0
UNFIN. THIRD FLOOR FINISHED THIRD FLOOR EXTENDED CAFE PATIO W/ EXT CAFE EXTENDED FAMILY	UN	+554 0 -144 +150		HEATED S.F. 0 +554 +120 0 +29



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2010 - SMITHFIELD - LH
---Cover Sheet 'Low Country'


DRAWN BY:
South Designs

ISSUE DATE:
10/29/2021

CURRENT REVISION DATE:
--SCALE:
1/8" = 1'-0"

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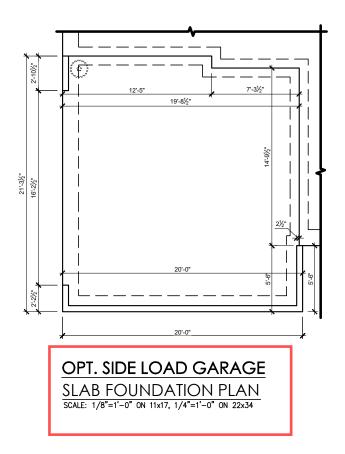
---- SMITHFIELD - LH
---Slab Foundation 'Low Country'

DRAWN BY: South Designs

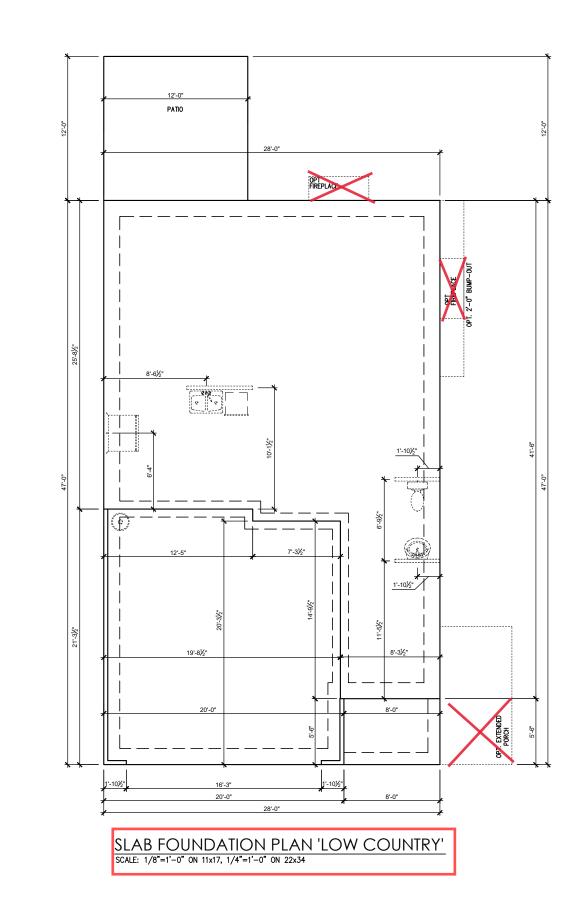ISSUE DATE: 10/29/2021

CURRENT REVISION DATE:
---SCALE:
1/8" = 1'-0"

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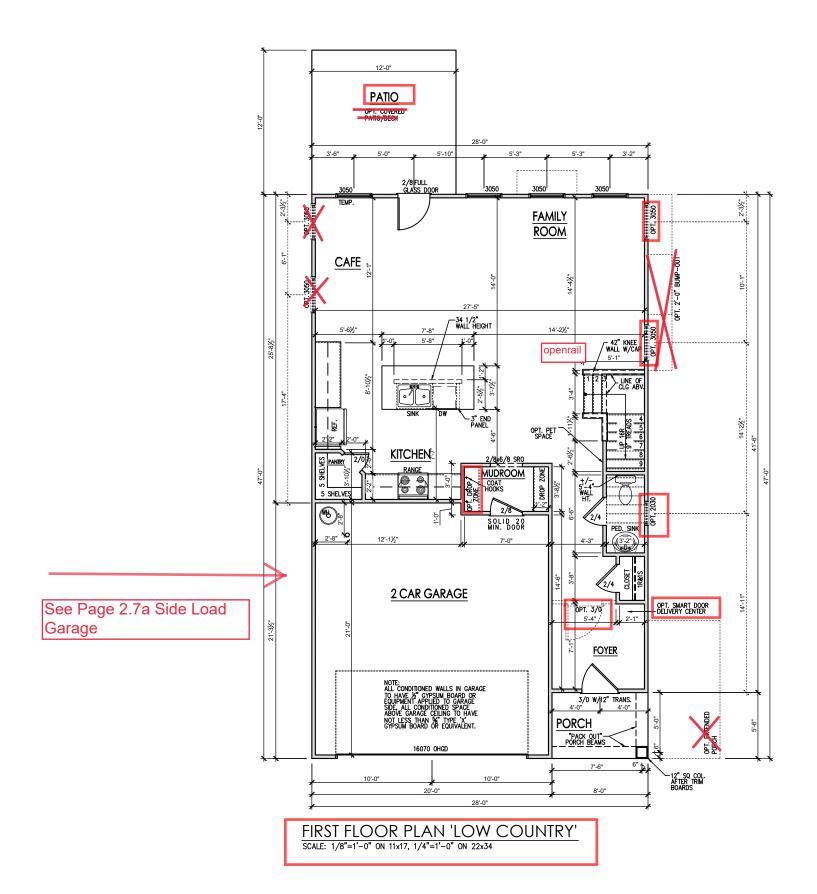
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Stab Foundation Options Low Country	7	1	
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General Floor Plan Notes

General Floor Plan Notes shall apply unless noted otherwise on plan.

- Wall Heights: Typically 9'-1 1/2" at first floor, 8'-1 1/2" at second floor, and 8'-1 1/2" at attics U.N.O. All walls are constructed using a double top plate. Splices at Double Top Plate do not need to occur at Vertical Studs but must be at least 24" apart from Joint in other Top Plate layer. Special wall heights are noted on plans where they occur.
- Wall Thickness is typically 3 1/2". 2x6 frame shall be used at walls that back up to plumbing fixtures.
 Walls greater than 10' high shall be framed with 2x6 framing or greater and will be noted as a special condition where it occurs on plan.
- 3. Typical header height shall be 6'-11" AFF at First Floor, and 6'-11" AFF at Second Floor U.N.O.
- Jacks: Openings up to 3"-4" wide shall have (1) 2x4 jack stud SPF on each side. Openings greater than 3"-4" wide shall have (2) 2x4 jack studs SPF on each side.
- 5. Soffits, Coffered Ceilings, Trey Ceilings and other significant ceiling plan elements are shown on the floor plans and are denoted as single dashed lines. Unless specifically call out as included, Kitchens do not include soffits over wall cabinetry.
- Door & Window Frames, where occurring near corners, shall be a minimum of 4 1/2" from corner. Except for walk-in closets with doors near a corner, doors at closets shall be centered on closet.
- Windows: Shall have at least (1) window in each sleeping room, that meets egress. Shall be provided with tempered glass at hazardous glazing areas. False windows shall be installed with obscure glazing.
- Closets for clothing or coat storage shall be equipped with 1 rod/shelf. Closets for linen shall have 4 open equal shelves. Closets for pontries shall have 4 equal wood shelves, painted.
- Stair treads shall be a min of 9" deep, risers shall be a maximum of 8 1/4", unless noted otherwise, per the current North Carolina Residential Code
- 10. Handrails and Guards at stairs shall be 34" above the finished surface of the ramp surface of the stair. Handrails at landings and overlooks of multilevel spaces shall be 36" above finished floor. Guards (pickets or balusters) shall be spaced with no more than 4" between guards.
- 11. Affic Access shall be provided at all affic area with a height greater than 30". Minimum clear affic access shall be 20" x 30". Pull down stairs and access doors in knee walls meeting minimum criteria are also acceptable.
- 12. Garage Door to Living Space shall be 2'-8" x 6'-8" minimum size and shall be 20 minute fire rated and weather sealed.
- 13. Garage Walls, as a minimum, shall be separated from living space by installing 1/2" gypsum board on the garage side of the wall. With habitable space above, the inside of all garage walls require 1/2" GWB supporting 5/8" Youe X GWB on ceiling





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-- SMITHFIELD

First Floor Plan 'Low Country'

DRAWN BY: South Designs

ISSUE DATE: 10/29/2021


CURRENT REVISION DATE:
---SCALE:
1/8" = 1'-0"

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General Floor Plan Notes

General Floor Plan Notes shall apply unless noted otherwise on plan.

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- 11. Attic Access shall be provided at all attic area with a height greater than 30". Minimum clear attic access shall be 20" x 30". Pull down stalis and access doors in knee walls meeting minimum criteria are also acceptable.
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Second Floor Plan 'Low

SMITHFIELD
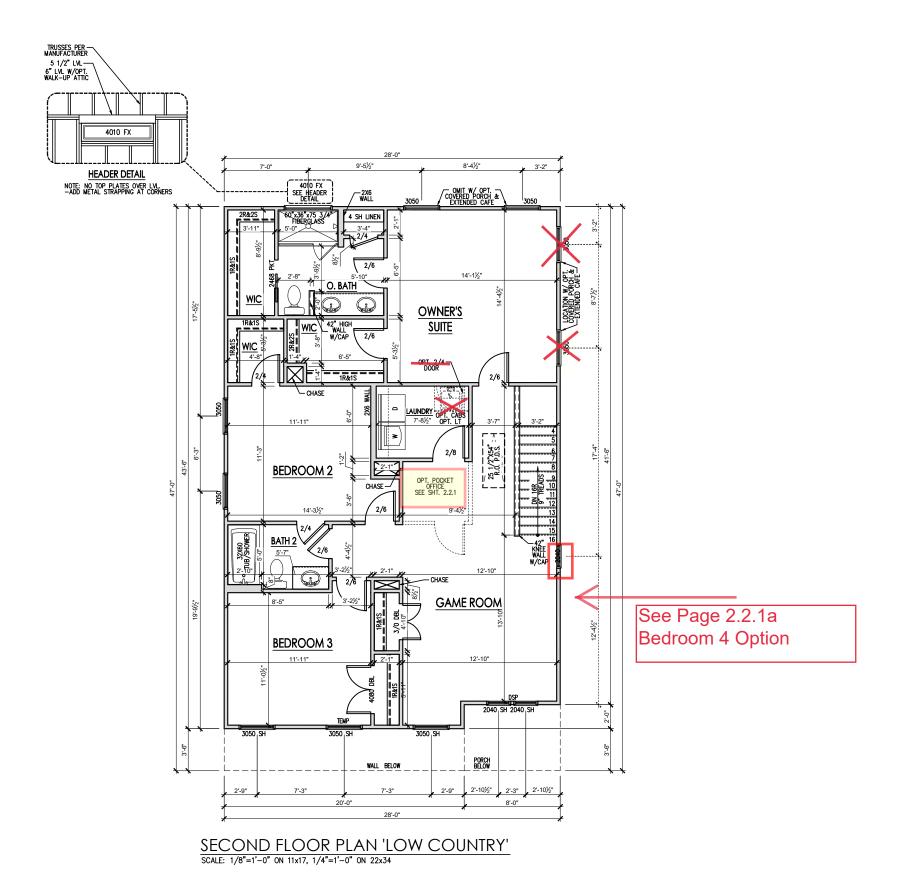
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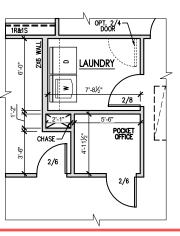
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South Designs
ISSUE DATE:
10/29/2021
SURRENT REVISION DATE:
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SCALE:
1/8" = 1'-0"


General Floor Plan Notes

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- 9. Stair treads shall be a min of 9" deep, risers shall be a maximum of 8 1/4", unless noted otherwise, per the current North Carolina Residential Code
- 10. Handralls and Guards at stairs shall be 34" above the finished surface of the ramp surface of the stair. Handralls at landings and overlooks of multilevel spaces shall be 36" above finished floor. Guards (pickets or balusters) shall be spaced with no more than 4" between guards.
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LAUNDRY W/OPT. POCKET OFFICE SCALE: 1/8"=1'-0" ON 11x17, 1/4"=1'-0" ON 22x34



OPT. BEDROOM 4 I.L.O. GAMEROOM SCALE: 1/8"=1'-0" ON 11x17, 1/4"=1'-0" ON 22x34

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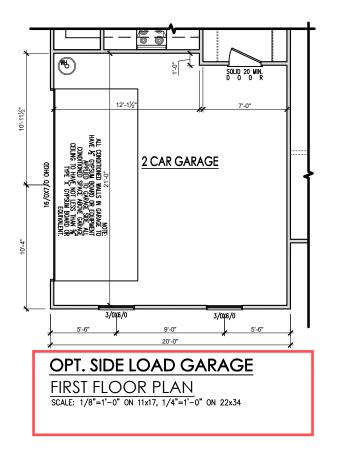
Second Floor Plan Options 'Low Country' SMITHFIELD

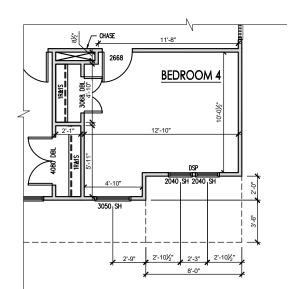
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South Designs

ISSUE DATE: 10/29/2021 CURRENT REVISION DATE:

SCALE: 1/8" = 1'-0"



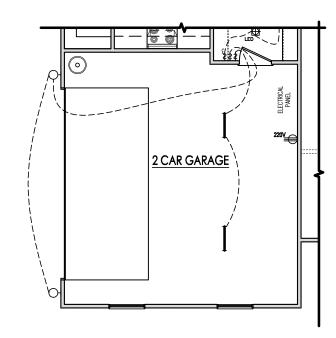

OPT. SIDE LOAD GARAGE
FIRST FLOOR ELECTRICAL PLAN
SCALE: 1/8"=1'-0" ON 11x17, 1/4"=1'-0" ON 22x34

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--- - SMITHFIELD - LH


2-Car Sideload Garage 'Low Country'

DRAWN BY: South Designs

ISSUE DATE: 10/29/2021

CURRENT REVISION DATE:
---SCALE:
1/8" = 1'-0"

2.7a

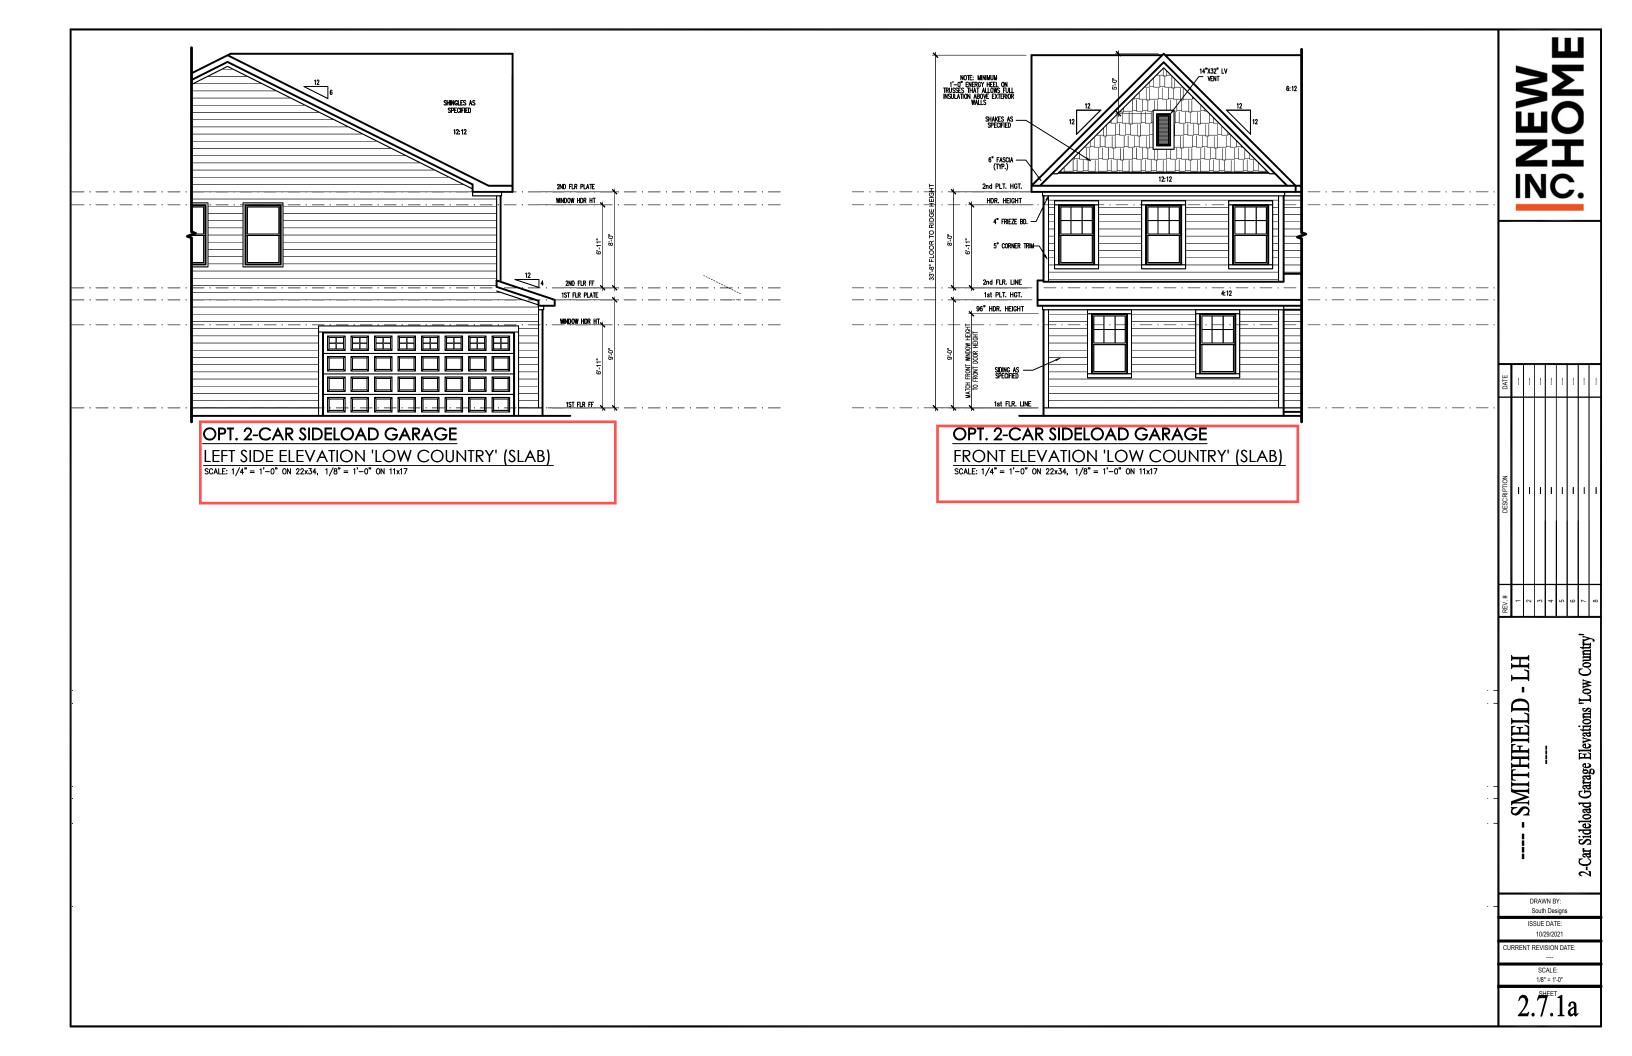

General Elevation Notes


General Elevation Notes shall apply unless noted otherwise on plan.


- Roof shall be finished with architectural composition shingles with slopes as noted on plan.
- Ridge Vent shall be provided and installed on all ridges greater than 6' in length per manufacturer's specifications.
- 3. Soffit Vent shall be continuous soffit vent
- House Wrap, "tyvek" or approved equal shall be installed over entire exterior wall per manufacturer's specifications and recommendations.
- Flashing shall be provided above all door and window openings, above finish wall material changes and at wall surfaces where lower roof areas abut vertical wall surfaces.
- Porch Railings shall be provided at all porch walking surfaces greater than 30" above adjacent finished grade. It shall be 36" high with guards spaced no more than 4" apart. Consult community specifications for material.
- Finish Wall Material shall be as noted on elevation drawings.
- 8. Brick Veneer, if included on elevation shall be tied to wall surface with galvanized corrugated metal ties at a rate of 24" oc horizontally and 16" oc vertically so that no more than 2.67sf of brick is supported by (1) tie. Space between face of wall and back face of brick shall be limited to a maximum of 1". Flashing shall be provided behind brick above all wall openings and at base of brick wall. Rashing shall be a minimum of 6-mil poly or other corrosion resistant material and shall be installed so that it laps under the house wrap material a minimum of 2". Weepholes shall be provided at a rate of 48" oc and shall not be less than 3/16" in diameter and shall be located immediately above flashing.
- Brick Veneer Support Lintels shall be provided if brick veneer is included on elevation. Lintels shall be provided as listed in the following schedule and shall have a minimum bearing length of 6". Masonry Lintels shall be provided so that deflection is limited to L/600.

Masonry Opening Lintel Schedule

oening Size	Angl

up to	4'-0"		3-1/2" x 3-1/2" x 5/16"
4'-1"	to	5'-6"	4" x 3-1/2" x 5/16" LLV
5'-7"	to	6'-6"	5" x 3-1/2" x 5/16" LLV
6'-7"	to	8'-4"	6" x 3-1/2" x 5/16" LLV
8'-5"	to	16'-4"	7" x 4" x 3/8" LLV

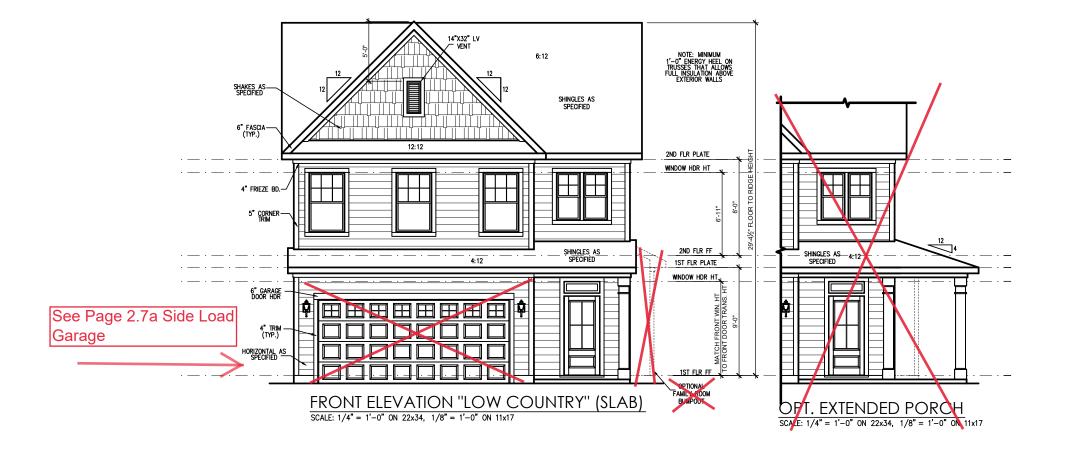

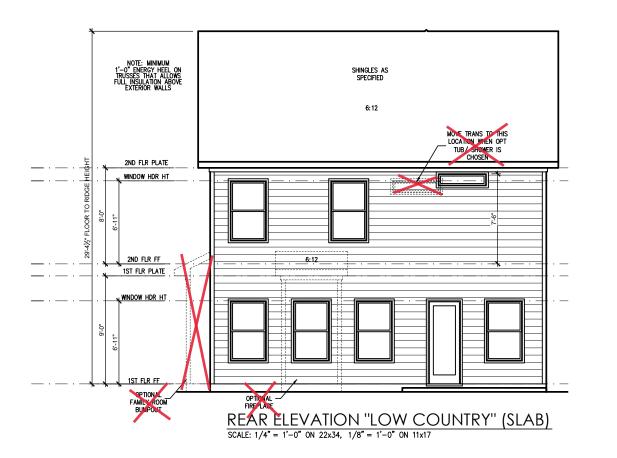



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---- SMITHFIELD - LH
---Front & Rear Elevations (Slab) 'Low
Country'

DRAWN BY: South Designs ISSUE DATE:

10/29/2021 CURRENT REVISION DATE:

> SCALE: 1/8" = 1'-0" 3.1a

General Elevation Notes


General Elevation Notes shall apply unless noted otherwise on plan.


- Roof shall be finished with architectural composition shingles with slopes as noted on plan.
- Ridge Vent shall be provided and installed on all ridges greater than 6' in length per manufacturer's specifications.
- 3. Soffit Vent shall be continuous soffit vent
- House Wrap, "tyvek" or approved equal shall be installed over entire exterior wall per manufacturer's specifications and recommendations.
- Flashing shall be provided above all door and window openings, above finish wall material changes and at wall surfaces where lower roof areas abut vertical wall surfaces.
- Porch Railings shall be provided at all porch walking surfaces greater than 30" above adjacent finished grade. It shall be 36" high with guards spaced no more than 4" apart. Consult community
- Finish Wall Material shall be as noted on elevation drawings.
- 8. Brick Veneer, if included on elevation shall be fled to wall surface with galvanized corrugated metal fles at a rate of 24" oc horizontally and 16" oc vertically so that no more than 2.67st of brick is supported by (1) fle. Space between face of wall and back face of brick shall be limited to a maximum of 1". Flashing shall be provided behind brick above all wall openings and at base of brick wall. Flashing shall be a minimum of 6-mil poly or other corosion resistant material and shall be installed so that it laps under the house wrap material a minimum of 2". Weepholes shall be provided at a rate of 48" oc and shall not be less than 316" in diameter and shall be located immediately above flashing.
- 9. Brick Veneer Support Lintels shall be provided if brick veneer is included on elevation. Lintels shall be provided as listed in the following schedule and shall have a minimum bearing length of 6". Masonry Lintels shall be provided so that deflection is limited to L/600.

Masonry Opening Lintel Schedule


Opening Size An

up to 4'-0" 3-1/2" x 3-1/2" x 5/16" 4'-1" to 5'-6" 4" x 3-1/2" x 5/16" LLV 5'-7" to 6'-6" 5" x 3-1/2" x 5/16" LLV 6'-7" to 8'-5" to 16'-4" 7" x 4" x 3/8" LLV

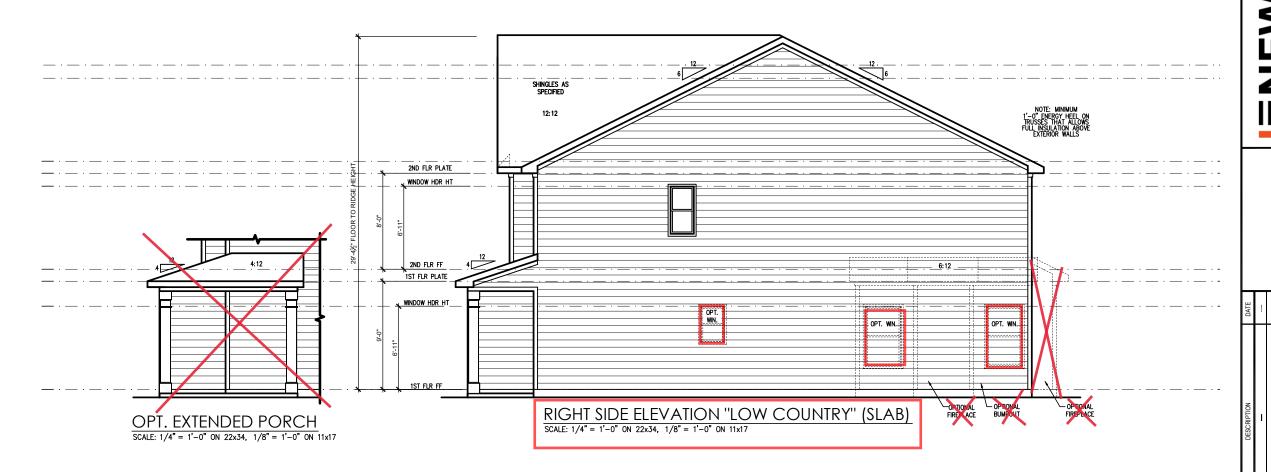

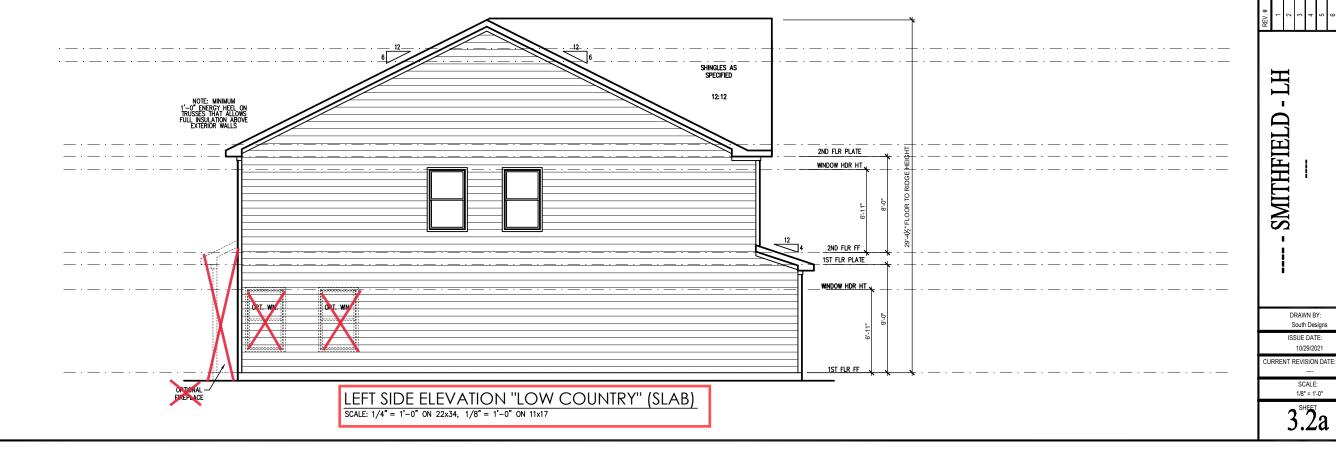

Side Elevations (Slab) 'Low Country'

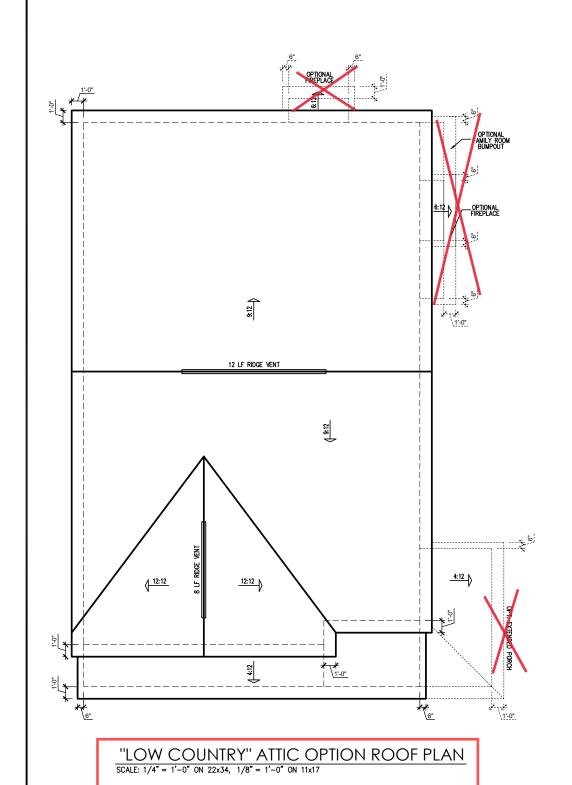

	ATTIC VENT SCHEDULE										
"LOW COUNTRY" ELEVATION											
MAIN HOUSE SQ F				1202	AT / NEAR RIDGE			AT / NEAR EAVE			
VENT TYPE	SQ. REQU	. FT.	SQ. FT.	PERCENT OF TOTAL SUPPLIED	POT LARGE (SQ. FT. EACH)	POT SMALL (SQ. FT. EACH)	RIDGE VENT (SQ. FT. PER LF)	EAVE VENT (SQ. IN. EACH)	CONT. VENT		
VEINTTILE	RAN		SUPPLIED		0.4236	0.2778	0.125	0.1944	0.0625		
RIDGE VENT	1.60	2.00	2.50	52.63	0	0	20.00				
SOFFIT VENTS	2.40	2.00	2.25	47.37				0	36.00		
TOTAL (MIN)	4.01	4.01	4.75	100.00	POT VENTS MAY BE REQUIRED IF THERE IS INSUFFICIENT RIDGE AVAILABLE						

^{*} SCHEDULE HAS BEEN CALCULATED ASSUMING EAVE VENTILATION AT 50-60% OF TOTAL AND RIDGE AT 40-50% OF TOTAL REQUIRED VENTILATION

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---- SMITHFIELD - LH
---Roof Plan 'Low Country'

DRAWN BY: South Designs

ISSUE DATE: 10/29/2021

10/29/2021 CURRENT REVISION DATE:

> SCALE: 1/8" = 1'-0"

3.3a

ELECTRICAL SYMBOL KEY LIGHT FIXTURES CEILING SURFACE MOUNT LIGHT RECESSED CAN LIGHT WP RECESSED CAN LIGHT WATERPROOF RECESSED CAN - EYEBALL ● PENDANT LIGHTING ₩ALL SCONCE ₩ WALL MOUNT LIGHT FLOOD LIGHT OUTLETS DUPLEX OUTLET € GFI OUTLET GFI-NP WATERPROOF GFI OUTLET SWITCHED 1/2 HOT DUPLEX OUTLET 220V OUTLET TELEPHONE OUTLET -E CATY (TELEVISION) OUTLET = UNDER-COUNTER OR CONCEALED OUTLETS Ø CEILING MOUNTED DUP. OUTLET ØFLOOR FLOOR MOUNTED DUP. OUTLET **SWITCHES** \$ SINGLE POLE SMITCH \$3 THREE-WAY SWITCH \$4 FOUR-WAY SWITCH DISJ ELECTRICAL DISCONNECT MISC FIXTURES EXHAUST FAN UNCTION BOX DUNCTION BOX 220V CARBON MONOXIDE DETECTOR OR SMOKE DETECTOR CARBON MONOXIDE DETECTOR AND SMOKE DETECTOR ELECTRIC METER ELECTRICAL PANEL DOOR BELL CHIME DOOR BELL PUSH BUTTON CEILING FAN PREWIRE FLUORESCENT LIGHT


General Power and Lighting:

General Power and Lighting Notes shall apply unless noted otherwise on plans.


All work shall be installed per the current NC Residential Building Code, and the National Electric Code. Alarm devices shall meet NFPA 72.

- Smoke Alarms Shall be provided as a minimum of (1) per floor, including basements (if applicable), (1) in each sleep room, and (1) outside each sleeping area, within the immediate vicinity of sleeping rooms. When more than one alarm is required, the alarm devices shall be interconnected in such a manner that the activation of one alarm will activate all of the alarms. Smoke alarms shall be hard wired to permanent power and shall have batter back-ups.
- 2. Switches For lighting, fans, etc. shall be installed at heights illustrated on this page and shall be located a minimum of 4 1/2" from door openings to allow for the proper installation of door casings. Switches, thermostats, security pads, and other similar devices shall be grouped together and installed thoughtfully for convenience of use and to avoid placement within centers of wall areas.

Note:
This plan is a diagram showing approximate locations of convenience outlets based on requirements found in the NC Residential Code and N.E.C. Actual positions may vary from what is shown on plan.

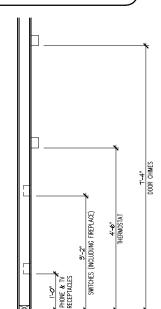

ELECTRICAL BOX HEIGHTS

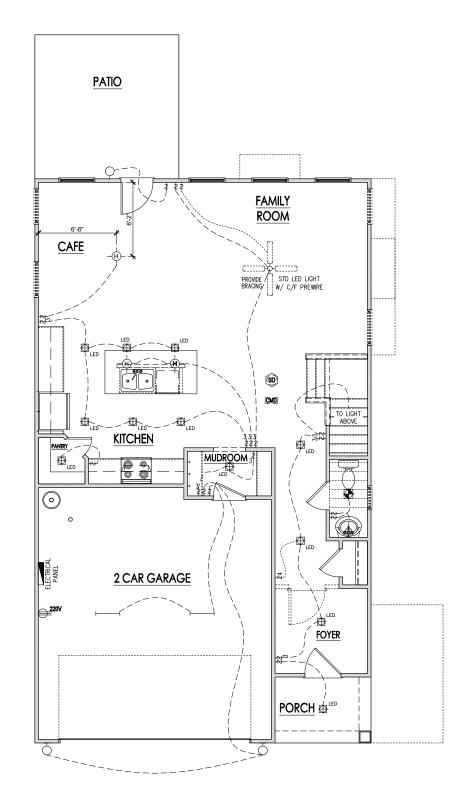

FIRST FLOOR ELECTRICAL PLAN 'LOW COUNTRY' SCALE: 1/8"=1'-0" ON 11x17, 1/4"=1'-0" ON 22x34

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	SMITHFIELD - LH First Floor Electrical 'Low Country'								
		5	South	VN B	signs				
CU	RRE		10/2	29/20)21	TE:			
			1/8"	ALE ' = 1'	-0"				
	5.1a								

ELECTRICAL SYMBOL KEY LIGHT FIXTURES CEILING SURFACE MOUNT LIGHT LED LED PUCK LIGHT RECESSED CAN LIGHT WATERPROOF RECESSED CAN - EYEBALL PENDANT LIGHTING ₩ALL SCONCE WALL MOUNT LIGHT FLOOD LIGHT OUTLETS DUPLEX OUTLET € GFI OUTLET WATERPROOF GFI OUTLET SWITCHED 1/2 HOT DUPLEX OUTLET 220V OUTLET TELEPHONE OUTLET CATV (TELEVISION) OUTLET SHOP OF CONTER OR CONCEALED OUTLETS Ø CEILING MOUNTED DUP. OUTLET ALOOR HOUNTED DUP. OUTLET SWITCHES \$ SINGLE POLE SWITCH \$3 THREE-WAY SWITCH \$4 FOUR-WAY SWITCH PIS ELECTRICAL DISCONNECT MISC FIXTURES EXHAUST FAN JUNCTION BOX \$\Phi_{220V}\$ JUNCTION BOX 220V CARBON MONOXIDE DETECTOR OR SMOKE DETECTOR CARBON MONOXIDE DETECTOR AND SMOKE ELECTRIC METER ELECTRICAL PANEL DOOR BELL CHIME DOOR BELL PUSH BUTTON CEILING FAN PREMIRE FLUORESCENT LIGHT

General Power and Lighting:


General Power and Lighting Notes shall apply unless noted otherwise on plans.

All work shall be installed per the current NC Residential Building Code, and the National Electric Code. Alarm devices shall meet NFPA 72.


- Smoke Alarms Shall be provided as a minimum of (1) per floor, including basements (if applicable), (1) in each sleep room, and (1) outside each sleeping area, within the immediate vicinity of sleeping rooms. When more than one alarm is required, the alarm devices shall be interconnected in such a manner that the activation of one alarm will activate all of the alarms. Smoke alarms shall be hard wired to permanent power and shall have batter back-ups.
- Switches For lighting, fans, etc. shall be installed at heights illustrated on this page and shall be located a minimum of 4 1/2" from door openings to allow for the proper installation of door casings. Switches, thermostals, security pads, and other similar devices shall be grouped together and installed thoughtfully for convenience of use and to avoid placement within centers of wall areas.

Note

This plan is a diagram showing approximate locations of convenience outlets based on requirements found in the NC Residential Code and N.E.C. Actual positions may vary from

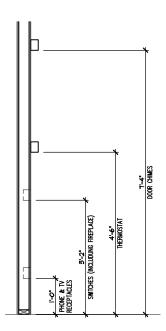

ELECTRICAL BOX HEIGHTS

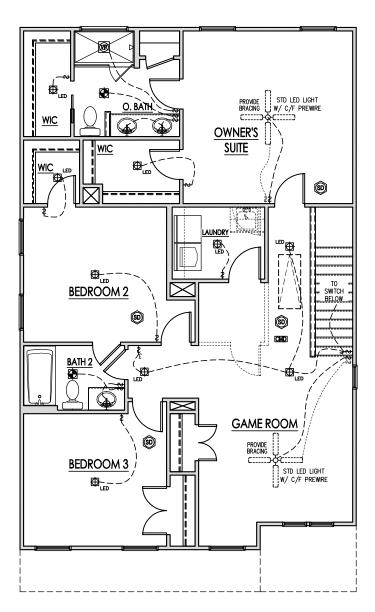

SECOND FLOOR ELECTRICAL PLAN 'LOW COUNTRY'
SCALE: 1/8"=1'-0" ON 11x17, 1/4"=1'-0" ON 22x34

Ш
≥Σ
МO
H
INC.
IIVC.

DATE									
DESCRIPTION	ı	1	-	-	-	-	-	-	
4EV.#	-	2	3	4	2	9	7	8	

---Second Floor Electrical 'Low Country'

SMITHFIELD

DRAWN BY: South Designs


ISSUE DATE: 10/29/2021

CURRENT REVISION DATE:


1/8" = 1'-0"

5.2a

SCALE:

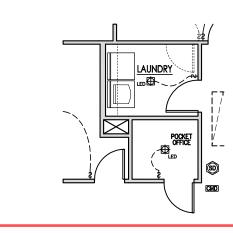

LAUNDRY W/OPT. POCKET OFFICE SCALE: 1/8"=1'-0" ON 11x17, 1/4"=1'-0" ON 22x34

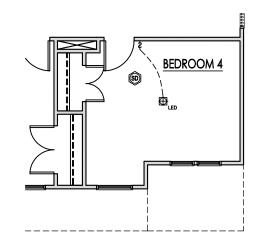

OPT. BEDROOM 4 I.L.O. GAMEROOM
SCALE: 1/8"=1'-0" ON 11x17, 1/4"=1'-0" ON 22x34



DATE									
DESCRIPTION	ı	1	-	-	-	-	1	-	
3EV.#	-	2	3	4	2	9	7	8	

---- SMITHFIELD - LH
---- Second Floor Options Electrical 'Low
Country'

DRAWN BY: South Design

ISSUE DATE: 10/29/2021 CURRENT REVISION DATE:

> SCALE: 1/8" = 1'-0"

5.2.1a

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12" WIDE — TURN-DOWN FTG. / WITH COVERED PORCH PATI0 903 SD 12'-63" IO4A SD I8" WIDE × IO" DEEP CONC. FTG. IOOA SD IB" WIDE TURN-DOWN FTG. 12-5"
4" CONC. SLAB (TABLE R402.2)
WITH FIBERMESH OR WIREMESH
ON 6 MIL VAPOR RETARDER
(AS REQT) ON BASE COURSE
(R506.2.2), SEE R506.2.1 FOR
FILL REQUIREMENTS. 18 IOIA SD I8" WIDE TURN-DOWN FTG. 1'-10½" IS" WIDE : 10" DEEPP CONC. FTG. 36"x36"x12" CONC. FTG. 36"x36"x12" CONC. FTG. 8'-0" /-12" WIDE TURN-DOWN FTG. 20'-0"

SLAB FOUNDATION PLAN 'LOW COUNTRY'
SCALE: 1/8"=1'-0" ON 11x17, 1/4"=1'-0" ON 22x34

See Page S-1.1.2 Side Load Garage

S-1.1

OPT. SIDE LOAD GARAGE SLAB FOUNDATION PLAN
SCALE: 1/8"=1'-0" ON 11x17, 1/4"=1'-0" ON 22x34

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TRUSS SYSTEM REQUIREMENTS NC (2018 NCRC): Wind: 115-120 mph

- TRUSS SYSTEM LAYOUTS (PLACEMENT PLANS) SHALL BE DESIGNED IN ACCORDANCE WITH SEALED STRUCTURAL PLANS. ANY NEED TO CHANGE TRUSSES SHALL BE COORDINATED WITH SOUTHERN ENGINEERS.
- TRUSS SCHEMATICS (PROFILES) SHALL BE PREPARED AND SEALED BY TRUSS MANUFACTURER.
- ALL TRUSSES SHALL BE DESIGNED FOR BEARING ON SPF #2 OR #3 PLATES OR LEDGERS (UNO).
- ALL REQUIRED ANCHORS FOR TRUSSES DUE TO UPLIFT OR BEARING SHALL MEET THE REQUIREMENTS AS SPECIFIED ON THE TRUSS SCHEMATICS.

HEADER/BEAM & COLUMN NOTES

- ALL EXTERIOR AND LOAD BEARING HEADERS SHALL BE MIN. (2)2x6 (4" WALL) OR (3)2x6 (6" WALL) WITH (I) SUPPORT STUD, UNLESS NOTED OTHERWISE.
- 2. THE NUMBER SHOWN AT BEAM AND HEADER SUPPORTS INDICATES THE NUMBER OF SUPPORT STUDS REQUIRED IN STUD POCKET OR COLUMN, THE NUMBER OF KING STUDS AT EACH END OF HEADERS IN EXTERIOR WALLS SHALL BE ACCORDING TO ITEM "d" IN TABLE R602.3(5) OR AS BELOW PER NCDOI COMMENTARY "KING STUDS AT WALL OPENINGS" REVISED 1-9-2020: UP TO 3' SPAN: (I) KING STUD

- OVER 3' UP TO 6' SPAN: (2) KING STUDS OVER 6' UP TO 9' SPAN: (3) KING STUDS
- OVER 9' UP TO 12' SPAN: (4) KING STUDS
- OVER 12' UP TO 15' SPAN: (5) KING STUDS

FRAMING NOTES

NC (2018 NCRC): Wind: 115-120 mph

- BRACING METHOD AND TYPE: CONTINUOUSLY SHEATHED WSP: CS-MSP. NOTE THAT THE WALL BRACING AMOUNT PROVIDED ON THE PLANS (DETAILS AND SPECIFICATIONS) IS GREATER THAN THE AMOUNT OF WALL BRACING REQUIRED BY SECTION R602 IO OF THE CODE. SEE NOTES BELOW FOR DETAILS AND SPECIFICATIONS FOR WALL BRACING AND WALL FRAMING.
- . EXTERIOR WALL SHEATHING; WALLS SHALL BE BRACED BY SHEATHING WALLS ON ALL STORIES WITH WOOD STRICTURAL PANEL SHEATHING (WSP) (EXPOSURE B: 1/16°, EXPOSURE C. 15/32°). SHEATHING SHALL BE ATTACHED WITH 8d NAILS AT A 6'1/2° NAILING PATTERN (6" OC AT PANEL EDGES AND 12" OC AT INTERMEDIATE SUPPORTS). INSTALL BLOCKING AT ALL PANEL
- 3. WSP SHEATHING SHALL EXTEND TO THE UPPERMOST DOUBLE BEARING PLATE. BLOCK AT ROOF PER SECTION R602.IO.4.5 AND ATTACH BRACED WALLS PER CODE. WSP SHEATHING BETWEEN FLOORS SHALL BE SPLICED ALONG CONTINUOUS BAND OR THE MSP SHEATHING MAY BE SPLICED ACROSS STUDS (CONTINUOUS ACROSS FLOOR SYSTEM) WITH BLOCKING AT PANEL EDGES. (MINIMUM 12" BEYOND FLOOR BREAK) OR OTHER APPROVED
- 4. "HD" = HOLDOWN: HOLD-DOWN DEVICE (NOTED AS "HD" ON PLANS)
 SHALL BE AN 800 POUND CAPACITY ASSEMBLY AS NOTED ON
 PLANS. SEE DETAILS FOR HD ASSEMBLY.
- **GROUND/FIRST FLOOR: USE "HD HOLD-DOWN DETAIL" ON SD SHEET (OR EQUIV.)
- **UPPER FLOORS: ATTACH BASE OF KING STUD WITH A SIMPSON C522 STRAP DOWN ACROSS THE BAND AND DOWN TO A STUD BELOW OR HEADER BELOW. EXTEND STRAP 7" MIN ALONG EACH STUD (OR HEADER) AND ATTACH EACH END W (7) 8d NAILS.
- 5. INTERIOR BRACED WALL: (NOTED AS "IBW" ON PLANS) ATTACH I/2" GYPSUM BOARD (GB) ON EACH SIDE OF WALL WITH A MIN. OF 5d COOLER NAILS OR #6 SCREWS @ 7° O.C. ALONG THE EDGES AND AT INTERMEDIATE SUPPORTS
- 6. INTERIOR BRACED WALL-WOOD STRUCTURAL PANEL: (NOTED AS "I<u>BM-WSP</u>" ON PLANS). ATTACH ONE SIDE MITH 76" MSP SHEATHING MITH 8d NAILS AT A 6"/12" NAILING PATTERN (6" OC AT PANEL EDGES AND 12" OC AT INTERMEDIATE SUPPORTS). INSTALL BLOCKING AT ALL PANEL EDGES, ATTACH GB OVER WSP AS REQUIRED. ATTACH OPPOSITE SIDE WITH 1/2" GB WITH A MIN. OF 5d COOLER NAILS OR #6 SCREWS @ 7" OC ALONG THE EDGES AND AT INTERMEDIATE SUPPORTS.

MOOD I-JOISTS

(SHALL BE ONE OF THE FOLLOWING OR EQUAL):

- LPI 20 PLUS BY LP

HEAVY WOOD I-JOISTS

- (SHALL BE ONE OF THE FOLLOWING OR EQUAL):
- TJI 360 BY TRUS JOIST
- BCI 60s 2.0 BY BC
- ALL WOOD I-JOISTS SHALL BE INSTALLED ACCORDING TO MANUFACTURER'S SPECIFICATIONS.
- INSTALL SQUASH BLOCKS, WEB STIFFENERS, ETC. AS REQUIRED BY AND ACCORDING TO THE 1-JOIST MANUFACTURER'S SPECIFICATIONS AND INSTRUCTIONS
- HANGERS FOR I-JOISTS ARE THE RESPONSIBILITY OF
- FLOOR TRUSSES BY MANUFACTURER MAY BE SUBSTITUTED FOR ANY I-JOISTS.

PORCH POST NOTES:

- 4"x4" (6"x6") TRT'D POST (OR EQUAL).
- ATTACH TRUSSES (RAFTERS) AT PORCH WITH HURRICANE CONNECTORS.
- CUNNECTORS.

 1. POST CAP: SIMPSON AC4-MAX (AC6-MAX)

 2. POST CAP AT CORNER: (2) SIMPSON LCE4 (MITER HEADER AT CORNER). HIGH WIND; ADD (1) SIMPSON H6.

 3. POST BASE: SIMPSON ABU44 (ABU66).
- MONO: %" ANCHOR (EMBED 7")
- CMU: 5/6" ANCHOR (EXTEND TO FOOTING HIGH WIND ONLY)
- 4. POST BASE: WOOD FOUNDATION: (2) SIMPSON CSI6 STRAPS AT POSTS. EXTEND 12" ONTO EACH POST (UPPER AND LOWER) OR TO GIRDER.
- NOTE: EQUIVALENT POST CAP AND BASE ACCEPTABLE.


WITH PDS ATTIC: (2) 2x12 WITH (2) JACK STUDS AT EACH END WITH WALK-UP ATTIC: (3) 2xIO WITH

CI

WITH PDS ATTIC: 3.5"x5.25" PSL/LVL COLUMN WITH WALK-UP ATTIC: 3.5"x7" PSL/LVL COLUMN EACH SIDE OF COLUMN AND ATTACH WITH (2)

(2) 2x6 JACK STUDS AT EACH END



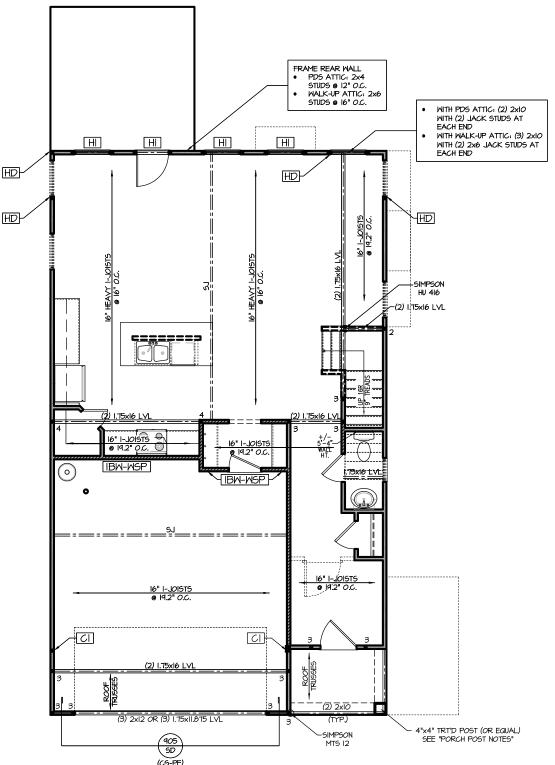

FIRST FLOOR PLAN 'LOW COUNTRY'

SCALE: 1/8"=1'-0" ON 11x17, 1/4"=1'-0" ON 22x34

PROJECT # 21-3366-LH

ns. : are to be brought to the ers. Failure to do so will

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TRUSS SYSTEM REQUIREMENTS NC (2018 NCRC): Wind: 115-120 mph

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HEADER/BEAM & COLUMN NOTES

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- UP TO 3' SPAN: (I) KING STUD
- OVER 3' UP TO 6' SPAN: (2) KING STUDS OVER 6' UP TO 9' SPAN: (3) KING STUDS
- OVER 9' UP TO 12' SPAN: (4) KING STUDS OVER 12' UP TO 15' SPAN: (5) KING STUDS

FRAMING NOTES

NC (2018 NCRC): Wind: 115-120 mph

- BRACING METHOD AND TYPE: CONTINUOUSLY SHEATHED WSP: CS-WSP. NOTE THAT THE WALL BRACING AMOUNT PROVIDED ON THE PLANS (DETAILS AND SPECIFICATIONS) IS GREATER THAN THE AMOUNT OF WALL BRACING REQUIRED BY SECTION R602.10 OF THE CODE. SEE NOTES BELOW FOR DETAILS AND SPECIFICATIONS FOR WALL BRACING AND WALL FRAMING.
- . EXTERIOR WALL SHEATHING; WALLS SHALL BE BRACED BY SHEATHING WALLS ON ALL STORIES WITH WOOD STRICTURAL PANEL SHEATHING (WSP) (EXPOSURE B: 1/1/6', EXPOSURE C: 15/32''). SHEATHING SHALL BE ATTACHED WITH 8d NAILS AT A 6'/12' NAILING PATTERN (6" OC AT PANEL EDGES AND 12" OC AT INTERMEDIATE SUPPORTS). INSTALL BLOCKING AT ALL PANEL
- WSP SHEATHING SHALL EXTEND TO THE UPPERMOST DOUBLE BEARING PLATE. BLOCK AT ROOF PER SECTION R602.10.4.5 AND ATTACH BRACED WALLS PER CODE. WSP SHEATHING BETWEEN FLOORS SHALL BE SPLICED ALONG CONTINUOUS BAND OR THE WSP SHEATHING MAY BE SPLICED ACROSS STUDS (CONTINUOUS ACROSS FLOOR SYSTEM) WITH BLOCKING AT PANEL EDGES. (MINIMUM 12" BEYOND FLOOR BREAK) OR OTHER APPROVED
- 4. "HD" = HOLDOWN: HOLD-DOWN DEVICE (NOTED AS "HD" ON PLANS) SHALL BE AN 800 POUND CAPACITY ASSEMBLY AS NOTED ON PLANS. SEE DETAILS FOR HD ASSEMBLY.
- **GROUND/FIRST FLOOR: USE "HD HOLD-DOWN DETAIL" ON SD SHEET (OR EQUIV.)
- SHEET (OR EQUIV.)

 **UPPER FLOORS: ATTACH BASE OF KING STUD WITH A SIMPSON
 C522 STRAP DOWN ACROSS THE BAND AND DOWN TO A STUD
 BELOW OR HEADER BELOW. EXTEND STRAP 1" MIN ALONG EACH STUD (OR HEADER) AND ATTACH EACH END W (7) 8d NAILS.
- 5. INTERIOR BRACED WALL: (NOTED AS "IBM" ON PLANS) ATTACH I/2" GYPSUM BOARD (GB) ON EACH SIDE OF WALL WITH A MIN. OF 5d COOLER NAILS OR #6 SCREWS @ 7" O.C. ALONG THE EDGES AND AT INTERMEDIATE SUPPORTS.
- 6. INTERIOR BRACED WALL-WOOD STRUCTURAL PANEL: (NOTED AS "IBW-MSP" ON PLANS). ATTACH ONE SIDE WITH 1/6" WSP SHEATHING WITH 8d NAILS AT A 6"/12" NAILING PATTERN (6" OC AT PANEL EDGES AND 12" OC AT INTERMEDIATE SUPPORTS). INSTALL BLOCKING AT ALL PANEL EDGES, ATTACH GB OVER WSP AS REQUIRED. ATTACH OPPOSITE SIDE WITH 1/2" GB WITH A MIN. OF 5d COOLER NAILS OR #6 SCREWS @ 7" OC ALONG THE EDGES AND AT INTERMEDIATE SUPPORTS.

WITH PDS ATTIC: (6) 2x4 COLUMN. ATTACH EACH STUD WITH (2) I2d NAILS @ 6" O.C.

WITH WALK-UP ATTIC: 3.5"x7" PSL/LVL COLUMN

INSTALL A 2x4 STUD ON EACH SIDE OF COLUMN AND ATTACH WITH (2) ROWS OF 12d NAILS @ 6" O.C.



CUT OUT TOP PLATES AND ATTACH ENDS OF HEADER TO PLATES WITH A 12" LONG (MIN.) SIMPSON CSI6 STRAP HORIZONTALLY AND VERTICALLY TO THE STUDS WITH THE SAME TYPE OF STRAP. WITH WALK-UP ATTIC: (2) 1.75x6 LVL HEADER SET DIRECTLY UNDER A SINGLE TOP PLATE. WITH PDS ATTIC: (2) 2xIO WITH WALK-UP ATTIC: (2) 1.75x9.25 LVL (USE SMALLER X ____ See Page S- 2.2.1 Pocket Office See Page S-2.2.1 Bedroom 4 -[6] CI(2) 1.75x9.25 LVL ROOF TRUSSES

SECOND FLOOR PLAN 'LOW COUNTRY' SCALE: 1/8"=1'-0" ON 11x17, 1/4"=1'-0" ON 22x34

WITH PDS ATTIC: (2) 1.75x5.5 LVL HEADER -

Roof Truss Version

S-2.2

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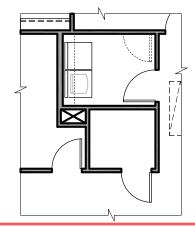
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> HOME, NEW


SMITHFIELD

NO STRUCTURAL CHANGES FROM BASE



LAUNDRY W/OPT. POCKET OFFICE SCALE: 1/8"=1'-0" ON 11x17, 1/4"=1'-0" ON 22x34

NO STRUCTURAL CHANGES FROM BASE

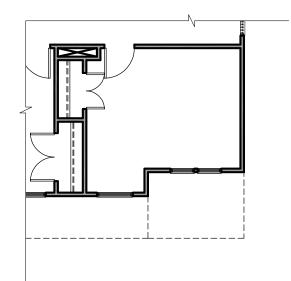

OPT. BEDROOM 4 I.L.O. GAMEROOM
SCALE: 1/8"=1'-0" ON 11x17, 1/4"=1'-0" ON 22x34


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OPT. SIDE LOAD GARAGE

FIRST FLOOR PLAN
SCALE: 1/8"=1'-0" ON 11x17, 1/4"=1'-0" ON 22x34

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S-2.7

TRUSS SYSTEM REQUIREMENTS

NC (2018 NCRC): Wind: 115-120 mph

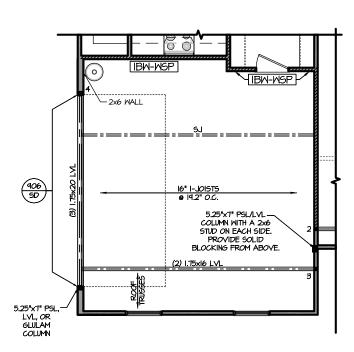- TRUSS SYSTEM LAYOUTS (PLACEMENT PLANS) SHALL BE DESIGNED IN ACCORDANCE WITH SEALED STRUCTURAL PLANS. ANY NEED TO CHANGE TRUSSES SHALL BE COORDINATED WITH SOUTHERN ENGINEERS.
- 2. TRUSS SCHEMATICS (PROFILES) SHALL BE PREPARED AND SEALED BY TRUSS MANUFACTURER.
- ALL TRUSSES SHALL BE DESIGNED FOR BEARING ON SPF #2 OR #3 PLATES OR LEDGERS (UNO).
- 4. ALL REQUIRED ANCHORS FOR TRUSSES DUE TO UPLIFT OR BEARING SHALL MEET THE REQUIREMENTS AS SPECIFIED ON THE TRUSS SCHEMATICS.

ROOF FRAMING NOTES:

NC (2018 NCRC): Wind: 115-120 mph

- 1. 2x8 RAFTERS @ 16" O.C. WITH 2x10 RIDGE, UNO.
- (2) 2xIO OR I.75xII.675 LVL HIP. (2) 2xIO HIPS MAY BE SPLICED WITH A MIN. 6'-O" OVERLAP AT CENTER
- (2) 2x10 OR 1.75x9.25 LVL VALLEY. DO NOT SPLICE VALLEYS
- 4) 1.75x11.875 LVL OR (2)1.75x9.25 LVL VALLEY
- 5) FALSE FRAME VALLEY ON 2xIO FLAT PLATE
- 6 2x6 RAFTERS @ 16" O.C. W 2x8 RIDGE, UNO.
- 7) 2xIO RAFTERS @ I6" O.C. W 2xI2 RIDGE, UNO.
- (8) EXTEND RIDGE 12" BEYOND INTERSECTION

- "SR" = SINGLE RAFTER
 "DR" = DOUBLE RAFTER
 "TR" = TRIPLE RAFTER
 "RS" = ROOF SUPPORT
 "B" = (3) STUD OR 4x4 POST FOR ROOF SUPPORT (USE
 2X6 STUDS OR 6X6 POST FOR SUPPORT OVER IO'-O' IN
- HEIGHT)
 ATTACH VAULTED RAFTERS WITH HURRICANE CLIPS:
 SIMPSON "H-2.5A" OR EQUIVALENT. TIES TO BE INSTALLED
 ON THE OUTSIDE FACE OF FRAMING.
 INSTALL RAFTER TIES AND COLLAR TIES PER SECTION
 R802.3.1 OF THE 2018 NC RESIDENTIAL CODE.

	ATTIC VENT SCHEDULE										
"LOW COUNTRY" ELEVATION											
MAIN HOUSE			SQ FTG	1202	AT / NEAR RIDGE			AT / NEAR EAVE			
VENT TYPE	SQ. FT.		SQ. FT. PERCENT OF TOTAL		POT LARGE (SQ. FT. EACH)	POT SMALL (SQ. FT. EACH)	RIDGE VENT (SQ. FT. PER LF)	EAVE VENT (SQ. IN. EACH)	CONT. VENT (SQ. IN. PER LF)		
	RAN	IGE	SUPPLIED	SUPPLIED	0.4236	0.2778	0.125	0.1944	0.0625		
RIDGE VENT	1.60	2.00	2.50	52.63	0	0	20.00				
SOFFIT VENTS	2.40	2.00	2.25	47.37				0	36.00		
TOTAL (MIN)	4.01	4.01	4.75	100.00	POT VENTS MAY B	POT VENTS MAY BE REQUIRED IF THERE IS INSUFFICIENT RIDGE AVAILABLE					

^{*} SCHEDULE HAS BEEN CALCULATED ASSUMING EAVE VENTILATION AT 50-60% OF TOTAL AND RIDGE AT 40-50% OF TOTAL REQUIRED VENTILATION



- OPTIONAL FIREPLACE ROOF TRUSSES IY MANUFACTURER ROOF TRUSSES BY MANUFACTURE 6:12 10 LF RIDGE VENT 12:12 12:12 ROOF BY MANU * * 1 \1'-0" - ROOF TRUSSES -BY MANUFACTURER

> "LOW COUNTRY" ROOF PLAN SCALE: 1/4" = 1'-0" ON 22x34, 1/8" = 1'-0" ON 11x17

21-3366-LH

PROJECT #

P.A. 27609


Southern Engineers, P 3716 Benson Drive, Raleigh, NC 2' Phone: (919) 878-1617


NEW HOME,

SMITHFIELD


S-3.1



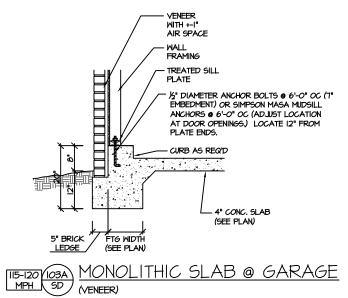


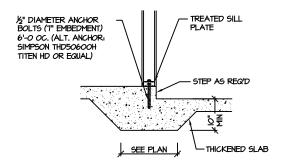

THICKENED SLAB @ GARAGE MPH SD (INTERIOR GARAGE WALL)

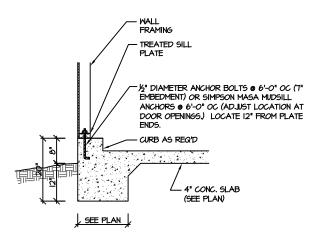

MONOLITHIC SLAB @ GARAGE (SIDING OR EQUAL)

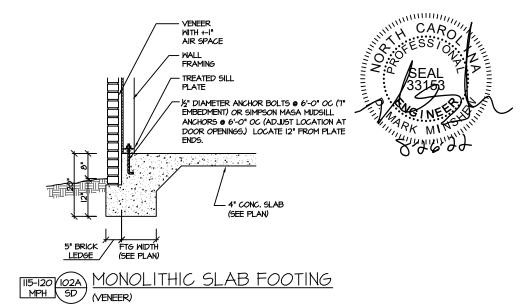


E" DIAMETER ANCHOR
BOLTS (T' EMBEDMENT)
6'-O OC. (ALT. ANCHOR:
SIMPSON THD50600H
TITTEN HD OR EQUAL)

-THICKENED SLAB

THICKENED SLAB (INTERIOR BEARING WALL)

≠-SEE PLAN-+

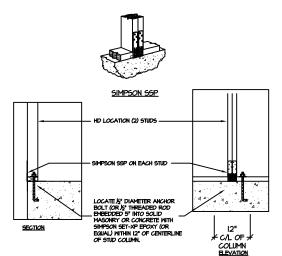

BRACED WALL END CONDITION "HD"

HOLD-DOWN DETAIL

NOTE: SIMPSON DTT-IZ IS ACCEPTABLE ALTERNATE
NOTE: ALTERNATE HD HOLD-DOWN DEVICES OR SYSTEMS MAY
BE USED TO MEET THE CODE REQUIRED 800 LB CAPACITY IN
LIEU OF THE ABOVE DETAIL.

SLAB FOUNDATION

PROJECT # 21-3366

eal does not include construction means, methods, techn squences, procedures or safety precautions. Any deviations or discrepanties on plans are to be brough mredate attention of Southern Engineers, Falure to do oid Southern Engineers's liability.

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SMITHFIELD PLAN

SD