REVISION LOG

REVISION:001

ADJUST OPTION SQUARE FOOTAGES TO ACCURATELY SHOW THE DIFFERENCES FROM THE BASE PLAN SQUARE FOOTAGE TOTALS.

- ADJUST OPTION SQUARE FOOTAGES TO ACCURATELY SHOW THE DIFFERENCES FROM THE BASE PLAN ADJUST OPTION SQUARE FOOTAGES TO ACCURATELY SHOW THE DIFFERENCES FROM THE SOUARE FOOTAGE TOTALS.

 EXTENDED TRIM AT GARAGE DOOR DOWN TO BASE AND CUT STONE BACK ADJUSTED KITCHEN ISLAND RESIZED THE FIREPLACE OPTION RELOCATED THE WINDOW IN THE MESSY KITCHEN TO BEHIND THE OPT. SINK CHANGED MESSY KITCHEN WINDOW TO OPTIONAL

- 6. CHANGED MESSY KITCHEN WINDOW TO OPTIONAL
 7. ADDED CHASE TO OWNER'S WC
 8. ADDED DIMS TO 0. BATH VANITY FOR CLARIFICATION
 9. REMOVED OPT. DOOR TO LOFT
 10. ADDED CHASE TO LOFT MC
 11. RELOCATED LINEN IN THE 0. BATH OPTIONS
 12. REMOVED THE OPT. SUPER SHOWER (ZERO ENTRY)
 13. FLIPPED SMART DOOR DELIVERY DOOR HANDING
 14. CHANGED ALL LINEN CLOSETS TO HAVE ONLY 4 SHELVES
 15. CHANGED SIZE OF BASE SHOWER TO 60X36
 16. UPDATED OPTIONAL SQ. FTG. CHART
 17. REMOVED HALF WALLS AT KITCHEN ISLAND AND UPDATED PER CABINET PROVIDER
 18. EXTEND PORCH SLAB 4" AT FRONT AND EXTEND AROUND CORNER 20" TO SUPPORT STONE VENEER
 19. EXTEND PORCH SLAB 4" AROUND THE PERMIETER AT THE "CRAFTSMAN" ELEVATION

DATE: 3/30/2022

- EXTEND PORCH SLAB 4" AROUND THE PERIMETER AT THE 'CRAFTSMAN' ELEVATION ADDED A COLUMN DETAIL FOR CLARITY ON THE 'CRAFTSMAN' ELEVATION ADDED A SEPARATE OPTION FOR THE POCKET OFFICE WITH THE SMART DELIVERY DOOR ADDED A SEPARATE OPTION FOR THE POCKET OFFICE WITH THE SMART DELIVERY DOOR DATE: 6/20/2022

REVISION:004

1. ADD SIDE LOAD GARAGE.

REVISION:005

DATE: 7/22/2022

- ADD STEM WALL SLAB FOUNDATION SHEETS
 CORRECT OPTIONAL SWART DELIVERY DOOR LOCATION ON FOUNDATION PLANS TO MATCH FLOOR PLAN.

Lot 104 Duncan's Creek - 334 Beacon Hill Road Lillington, NC 27546

PLAN 2 The Holly - RH 'CRAFTSMAN' ELEVATION

NC.



DESIGN CRITERIA:

THIS PLAN IS TO BE BUILT IN CONFORMANCE WITH THE 2018 NORTH CAROLINA STATE BUILDING CODE: RESIDENTIAL CODE

DIMENSIONS SHALL GOVERN OVER SCALE, AND CODE SHALL GOVERN OVER DIMENSIONS.

Sheet No.	Sheet Description
0.0	Cover Sheet
1.1	Foundation (Slab)
1.1.1	Foundation Options (Slab)
1.1.2	Foundation Options (Slab)
1.2	Foundation (Crawl)
1.2.1	Foundation Options (Crawl)
1.2.2	Foundation Options (Crawl)
1.3	Foundation (Stem Wall Slab)
1.3.1	Foundation Options (Stem Wall Slab)
1.3.2	Foundation Options (Stem Wall Slab)
2.1	First Floor Plan
2.1.1	First Floor Plan Options
2.2	Second Floor Plan
2.2.1	Second Floor Plan Options
2.4	Covered Porch Plans & Elevations (Slab)
2.4.1	Covered Porch Plans & Elevations (Crawl/Stem Wall)
2.5	Covered Porch w/ Extended Cafe Plans & Elevations (Slab)
2.5.1	Covered Porch w/ Extended Cafe Plans & Elevations (Crawl/ Stem Wa
2.6	Extended Cafe Plans & Elevations (Slab)
2.6.1	Extended Cafe Plans & Elevations (Crawl/ Stem Wall)
2.7	2-Car Sideload Garage Plans
2.7.1	2-Car Sideload Garage Elevations
3.1	Front & Rear Elevations (Slab)
3.1.1	Front & Rear Elevations (Crawl/ Stem Wall)
3.2	Side Elevations (Slab)
3.2.1	Side Elevations (Crawl/ Stem Wall)
3.3	Roof Plan
5.1	First Floor Electrical
5.1.1	First Floor Options Electrical
5.2	Second Floor Electrical
5.2.1	Second Floor Options Electrical

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		С	RAFT	SM/	٨N	
	ι	NHEATEL)		HEATED	
FIRST FLOOR		0		П	872	П
SECOND FLOOR		0			1345	
FRONT PORCH		125			0	
2 CAR GARAGE		437			0	
PATIO		160			0	
SUBTOTALS		722			2217	
TOTAL UNDER ROOF			29	39		
OI	PTIC	ONS				
	UNH	IEATED	S.F.	HE	ATED S	.F.
EXTENDED PATIO		+148	_		0	
COVERED PATIO	_	160			0	
EXTENDED CAFE		0			+152	
REAR POCKET OFFICE		0			+60	
FRONT POCKET OFFICE		0			+39	
FRONT PORCH W/ FRONT POCKET OFFICE		128			0	
FRONT POCKET OFFICE W/SMART DOOR		0			+61	
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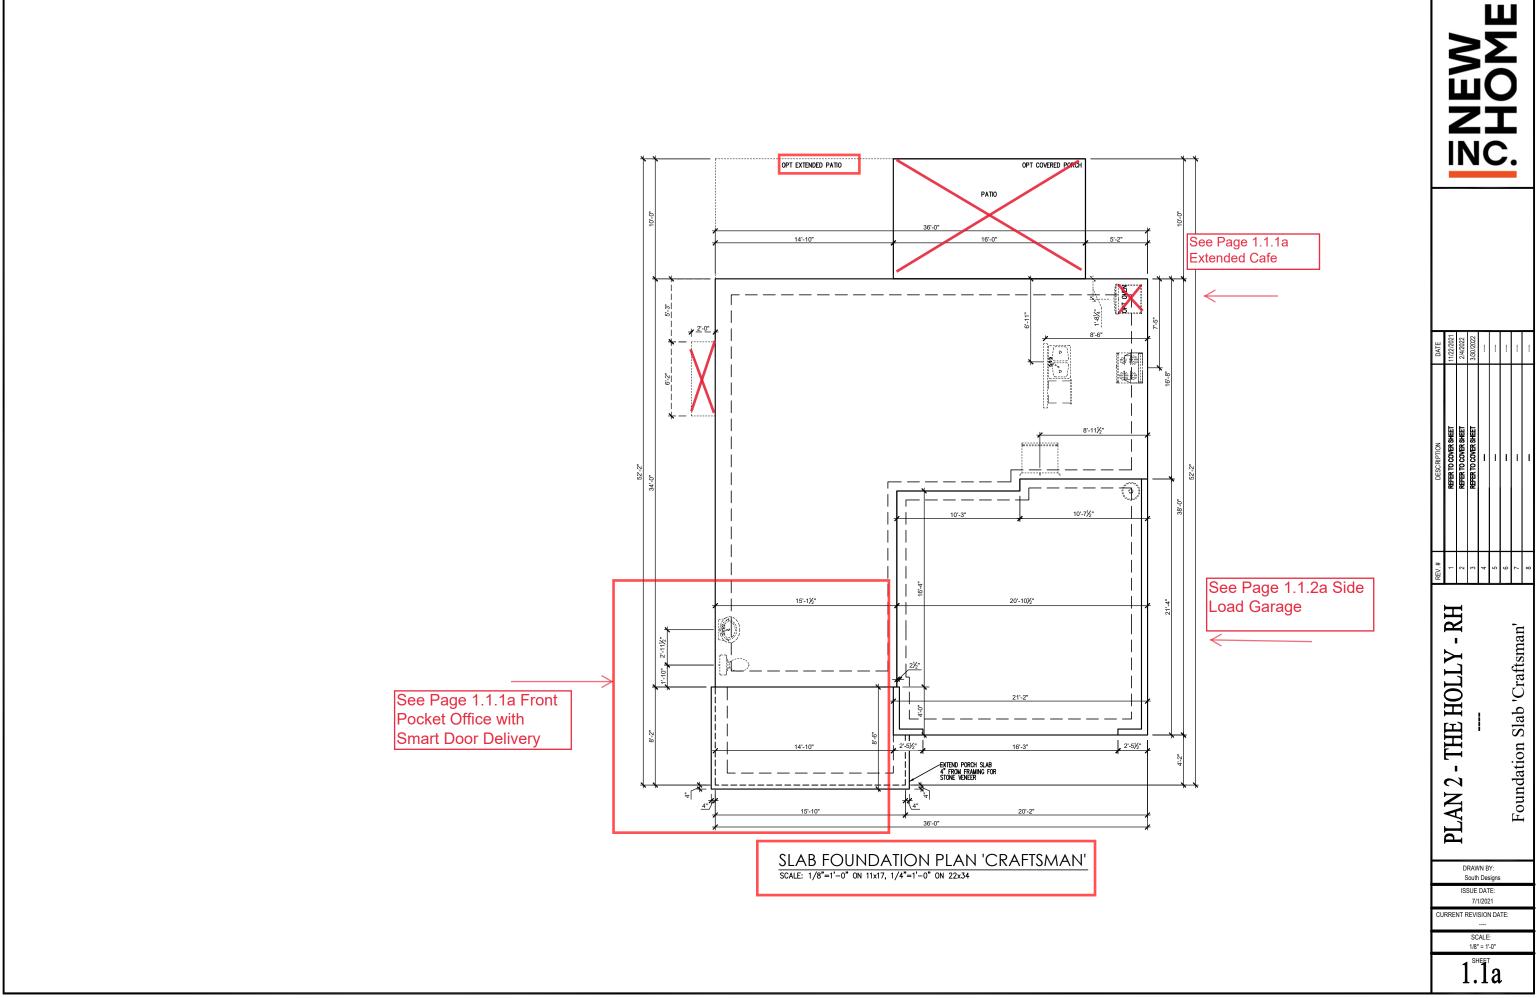
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Sheet 'Craftsman' - THE HOLLY PLAN 2.


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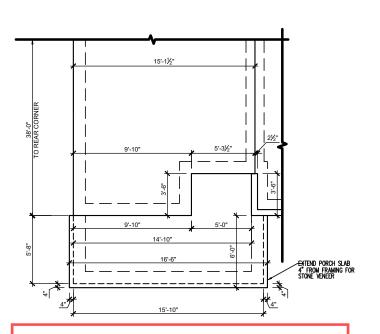
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1/8" = 1'-0"



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SLAB FND. W/OPT. SMART DOOR
SCALE: 1/8"=1'-0" ON 11x17, 1/4"=1'-0" ON 22x34
*ONLY AVAILABLE W/ POCKET OFFICE OPTION

With From

Pocket Office

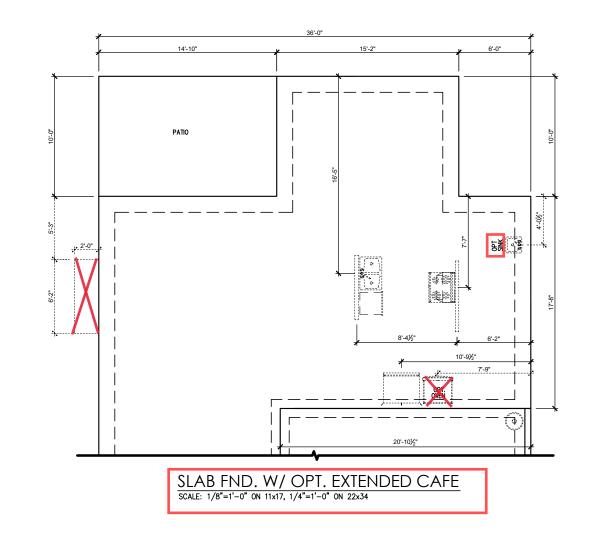
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DRAWN BY: South Designs

ISSUE DATE: 7/1/2021 CURRENT REVISION DATE:

SCALE: 1/8" = 1'-0"



OPT. SIDE LOAD GARAGE SLAB FOUNDATION PLAN SCALE: 1/8"=1'-0" ON 11x17, 1/4"=1'-0" ON 22x34
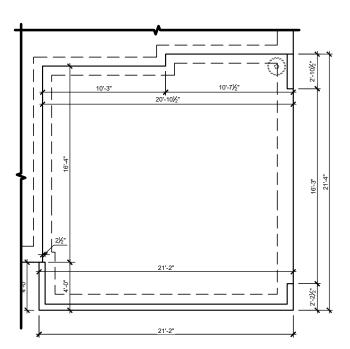
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DRAWN BY: South Designs


ISSUE DATE: 7/1/2021

CURRENT REVISION DATE:

SCALE: 1/8" = 1'-0"

General Floor Plan Notes shall apply unless noted otherwise on plan.

- Wall Heights: Typically 9'-1 1/2" at first floor and 8'-1 1/2" at second floor and attics U.N.O. All walls are constructed using a double top plate. Splices at Double Top Plate do not need to occur at Vertical Studs but must be at least 24" apart from Joint in other Top Plate layer. Special wall heights are noted on plans where they occur.
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- Door & Window Frames, where occurring near corners, shall be a minimum of 4 1/2" from corner. Except for walk-in closets with doors near a corner, doors at closets shall be centered on closet.
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- 10. Handrails and Guards at stairs shall be 34" above the finished surface of the ramp surface of the stair. Handrails at landings and overlooks of multilevel spaces shall be 36" above finished floor. Guards (pickets or balusters) shall be spaced with no more than 4" between guards.
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- 12.Garage Door to Living Space shall be 2'-8" x 6'-8" minimum size and shall be 20 minute fire rated and weather sealed.
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RH

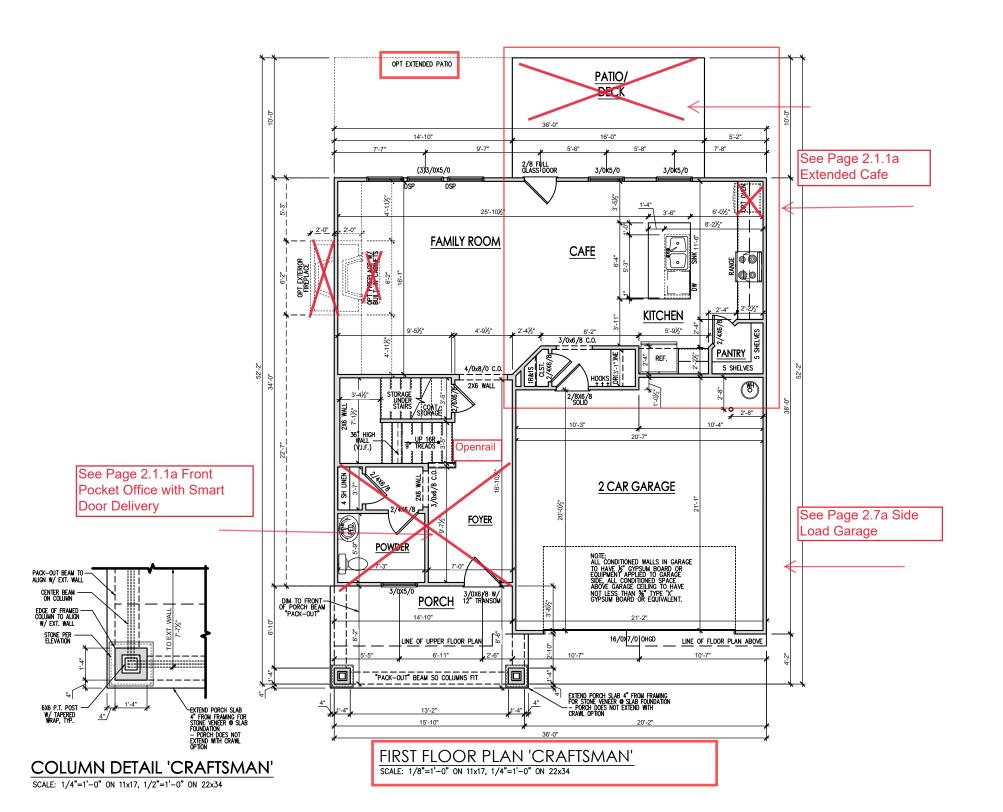THE HOLLY

PLAN 2

'Craftsman'

Plan

Floor]

First

DRAWN BY: South Designs


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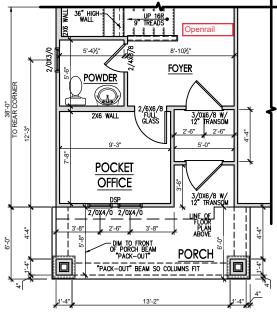
> SCALE: 1/8" = 1'-0"

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OPT. POCKET OFFICE W/SMART DOOR DELIVERY CENTER SCALE: 1/8"=1'-0" ON 11x17, 1/4"=1'-0" ON 22x34

First Floor Plan Options 'Craftsman' - 1 THE HOLLY ~ PLAN :

RH


South Designs

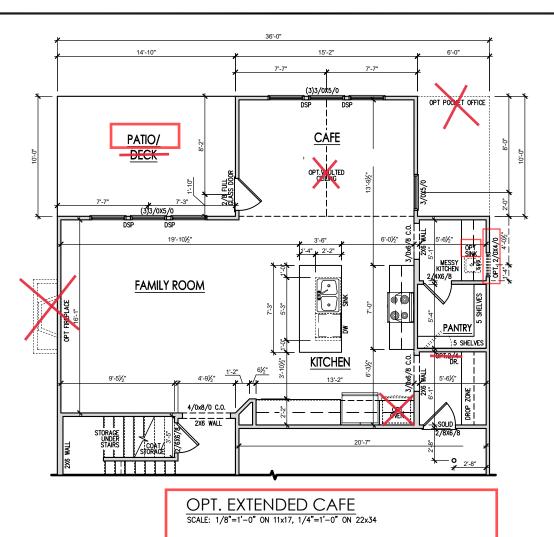ISSUE DATE: 7/1/2021

CURRENT REVISION DATE: SCALE: 1/8" = 1'-0"

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PLAN 2 - THE HOLLY - RH

Second Floor Plan 'Craftsman'

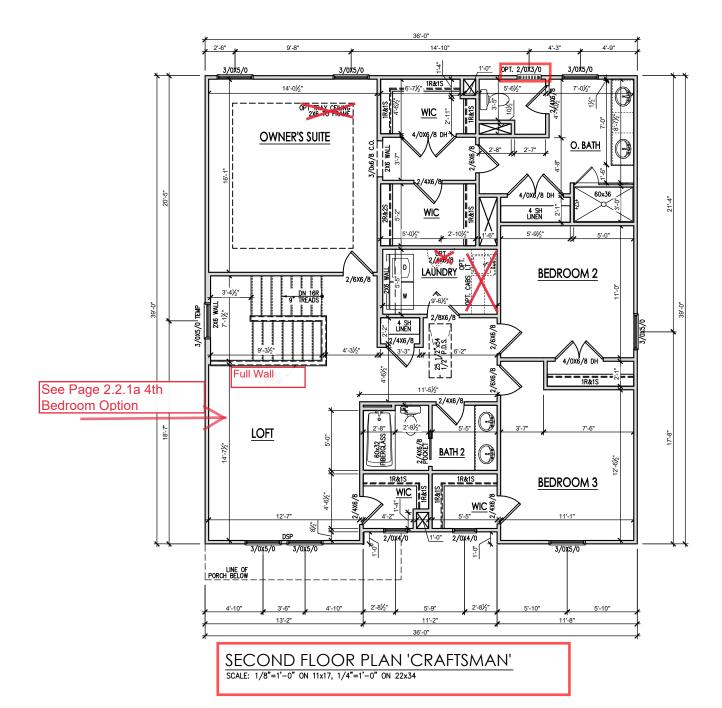DRAWN BY: South Designs

ISSUE DATE: 7/1/2021


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1/8" = 1'-0"

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OPT. BEDROOM 4 ILO LOFT SCALE: 1/8"=1'-0" ON 11x17, 1/4"=1'-0" ON 22x34



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PLAN 2 - THE HOLLY - RH


Second Floor Plan Options 'Craftsman'

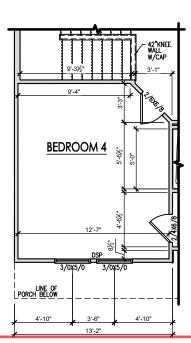DRAWN BY: South Designs

ISSUE DATE: 7/1/2021

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---SCALE:
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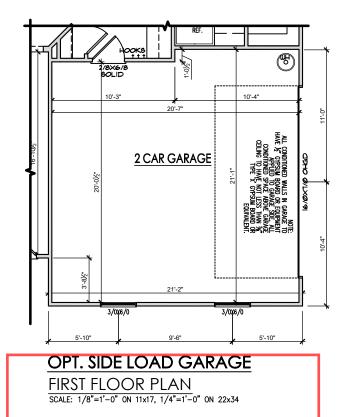
Extended Cafe Plans & Elevations 'Craftsman' Slab


South Designs

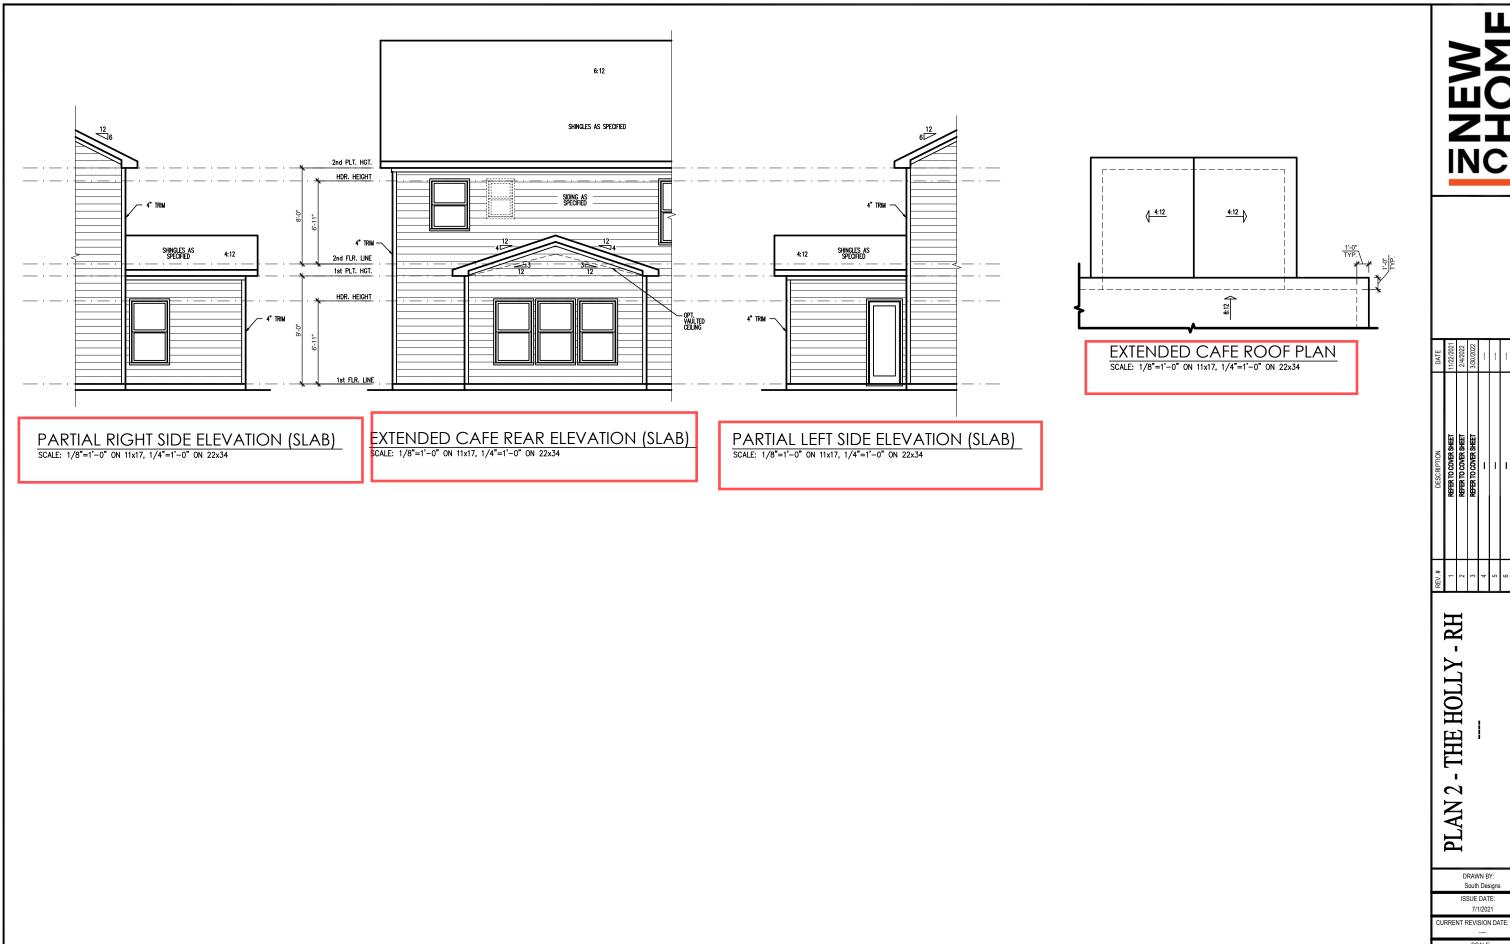ISSUE DATE: 7/1/2021

SCALE: 1/8" = 1'-0"

2.6a



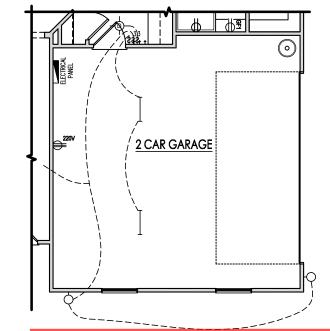

OPT. SIDE LOAD GARAGE
FIRST FLOOR ELECTRICAL PLAN
SCALE: 1/8"=1'-0" ON 11x17, 1/4"=1'-0" ON 22x34

PLAN 2 - THE HOLLY - RH


2-Car Sideload Garage Plans 'Craftsman'

DRAWN BY: South Designs

ISSUE DATE: 7/1/2021 CURRENT REVISION DATE:

> SCALE: 1/8" = 1'-0"

2.7a

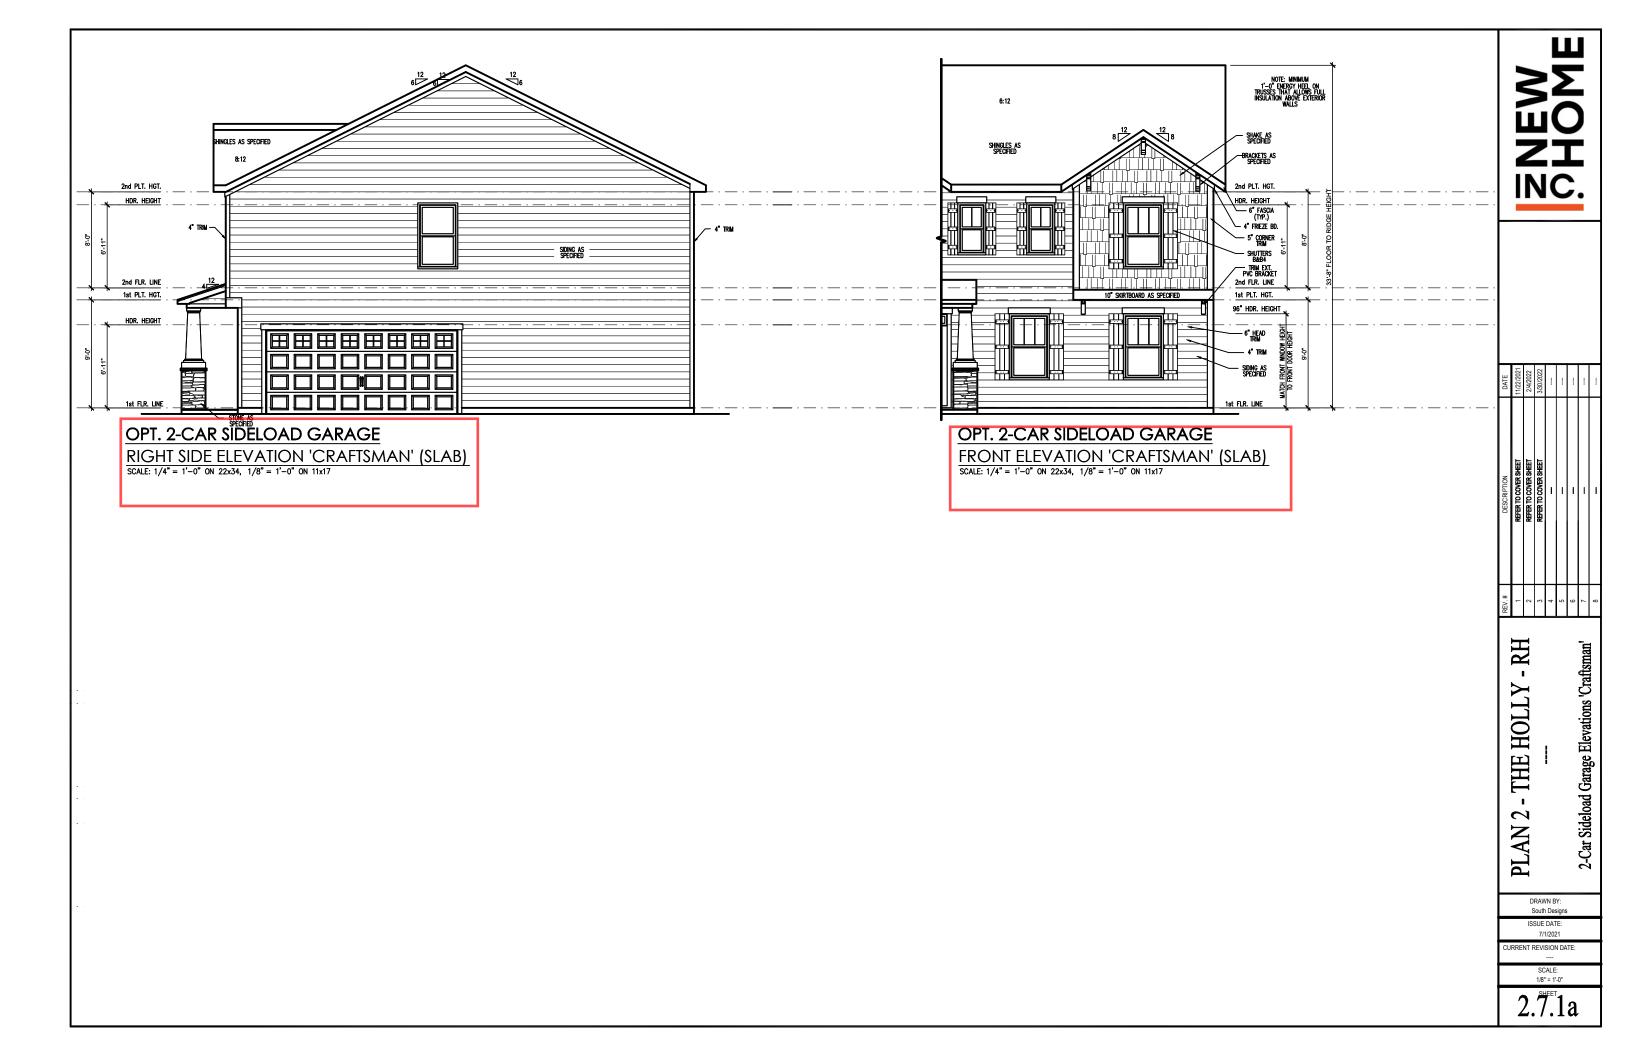

General Elevation Notes

General Elevation Notes shall apply unless noted otherwise on plan.

- Roof shall be finished with architectural composition shingles with slopes as noted on plan.
- Ridge Vent shall be provided and installed on all ridges greater than 6' in length per manufacturer's specifications.
- 3. Soffit Vent shall be continuous soffit vent
- House Wrap, "tyvek" or approved equal shall be installed over entire exterior wall per manufacturer's specifications and recommendations.
- Flashing shall be provided above all door and window openings, above finish wall material changes and at wall surfaces where lower roof areas abut vertical wall surfaces.
- Porch Railings shall be provided at all porch walking surfaces greater than 30" above adjacent finished grade. It shall be 36" high with guards spaced no more than 4" apart. Consult community specifications for material.
- Finish Wall Material shall be as noted on elevation drawings.
- 8. Brick Veneer, if included on elevation shall be fled to wall surface with galvanized corrugated metal fles at a rate of 24" oc horizontally and 16" oc vertically so that no more than 2.67sf of brick is supported by (1) fle. Space between face of wall and back face of brick shall be limited to a maximum of 1". Flashing shall be provided behind brick above all wall openings and at base of brick wall. Rashing shall be a minimum of 6-mil poly or other corrosion resistant material and shall be installed so that it laps under the house wrap material a minimum of 2".

 Weepholes shall be provided at a rate of 48" oc and shall not be less than 3/16" in diameter and shall be located immediately above flashing.
- Brick Veneer Support Lintels shall be provided if brick veneer is included on elevation. Lintels shall be provided as listed in the following schedule and shall have a minimum bearing length of 6". Masonry Lintels shall be provided so that deflection is limited to L/600.

onry Opening Lintel Schedule

Opening Size Angle

 up to 4'-0"
 3-1/2" x 3-1/2" x 5/16"

 4'-1" to 5'-6"
 4" x 3-1/2" x 5/16" LLV

 5'-7" to 6'-6"
 5" x 3-1/2" x 5/16" LLV

 6'-7" to 8'-4"
 6" x 3-1/2" x 5/16" LLV

 8'-5" to 16'-4"
 7" x 4" x 3/8" LLV



NOTE MANAM OF THE PLANT AND ASSISTED TO THE

See Page 2.6 a Rear Elevation with Extended Cafe



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,	9	_	
Slab	7	-	
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PLAN 2 - THE HOLLY

Front & Rear Elevations 'Craftsman'

DRAWN BY: South Designs

ISSUE DATE: 7/1/2021 URRENT REVISION DATE:

> SCALE: 1/8" = 1'-0"

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General Elevation Notes


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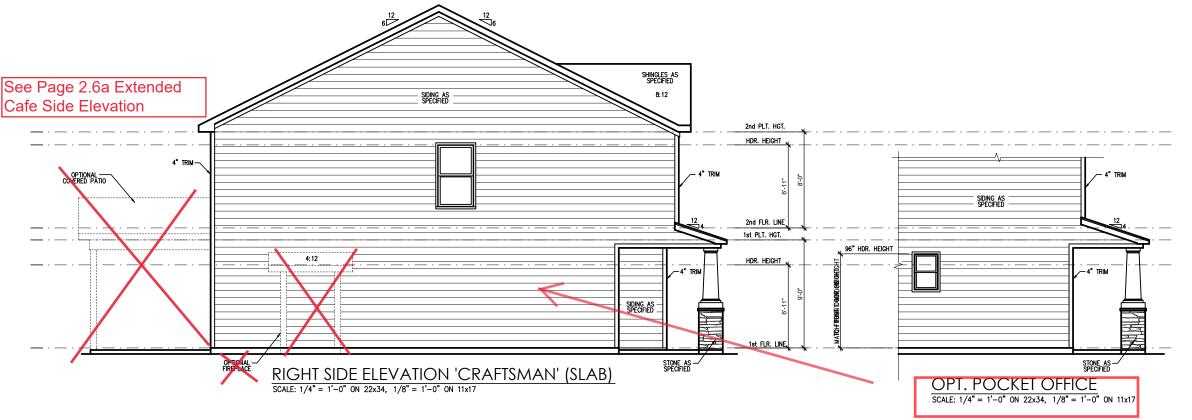
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- 3. Soffit Vent shall be continuous soffit vent
- House Wrap, "tyvek" or approved equal shall be installed over entire exterior wall per manufacturer's specifications and recommendations.
- Flashing shall be provided above all door and window openings, above finish wall material changes and at wall surfaces where lower roof areas abut vertical wall surfaces.
- Porch Railings shall be provided at all porch walking surfaces greater than 30" above adjacent finished grade. It shall be 36" high with guards spaced no more than 4" apart. Consult community specifications for material.
- Finish Wall Material shall be as noted on elevation drawings.
- 8. Brick Veneer, if included on elevation shall be tied to wall surface with galvanized corrugated metal ties at a rate of 24" oc horizontally and 16" oc vertically so that no more than 2.67st of brick is supported by (1) tie. Space between face of wall and back face of brick shall be limited to a maximum of 1". Flashing shall be provided behind brick above all wall openings and at base of brick wall. Flashing shall be a minimum of 6-mil poly or other corrosion resistant material and shall be installed so that it laps under the house wrap material a minimum of 2". Weepholes shall be provided at a rate of 48" oc and shall not be less than 316" in diameter and shall be located immediately above flashing.
- P. Brick Veneer Support Lintels shall be provided if brick veneer is included on elevation. Lintels shall be provided as listed in the following schedule and shall have a minimum bearing length of 6". Masonry Lintels shall be provided so that deflection is limited to L/600.

Masonry Opening Lintel Schedule

Opening Size An

up to 4'-0" 3-1/2" x 3-1/2" x 5/16" 4'-1" to 5'-6" 4" x 3-1/2" x 5/16" LLV 5'-7" to 6'-6" 5" x 3-1/2" x 5/16" LLV 6'-7" to 8'-5" to 16'-4" 7" x 4" x 3/8" LLV



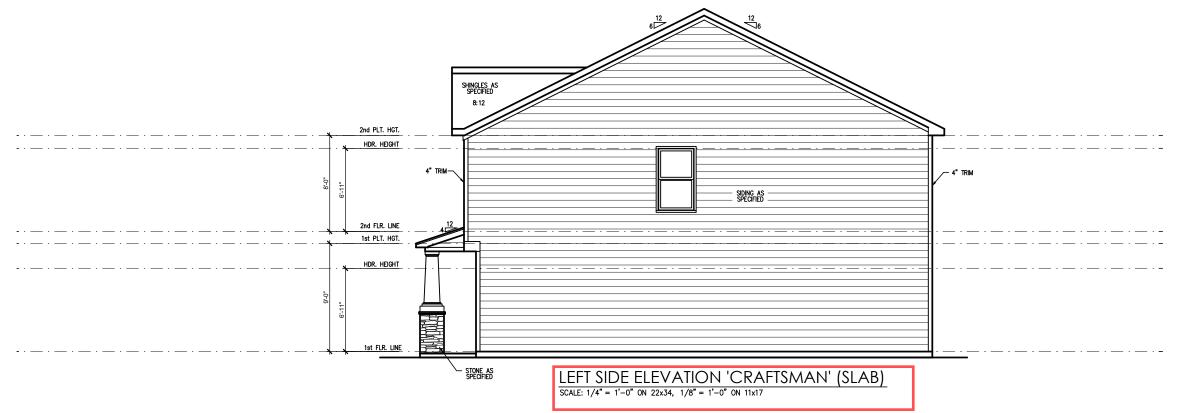



	REV.#	DESCRIPTION	DATE
BH -	1	REFER TO COVER SHEET	11/22/2021
171	2	REFER TO COVER SHEET	2/4/2022
	3	REFER TO COVER SHEET	3/30/2022
	4	-	
	2	-	
	9	_	
Slab	7	-	
-	8	_	

PLAN 2 - THE HOLLY

Side Elevations 'Craftsman' Slab


DRAWN BY: South Designs ISSUE DATE: 7/1/2021

7/1/2021

CURRENT REVISION DATE:

SCALE:
1/8" = 1'-0"

3.28

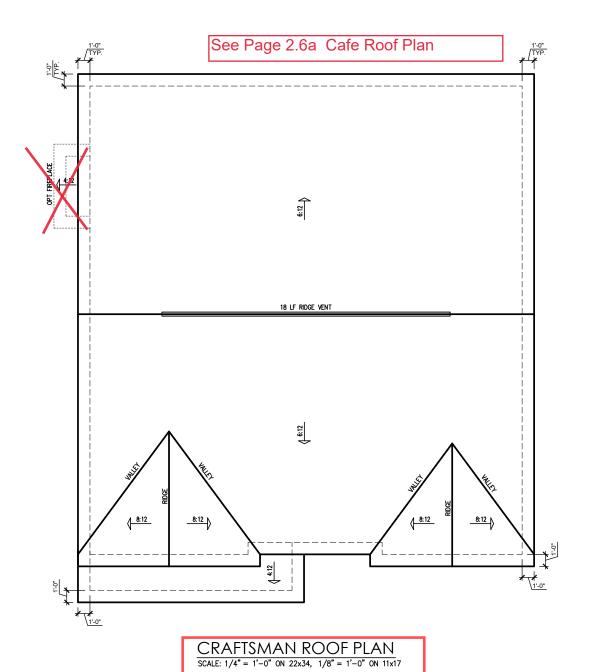

	ATTIC VENT SCHEDULE											
	CRAFTSMAN											
MAIN	MAIN HOUSE			1393	AT / NEAR RIDGE			AT / NEAR EAVE				
VENT TYPE	SQ. REQU	. FT. JIRFD	SQ. FT. SUPPLIED	PERCENT OF TOTAL SUPPLIED	POT LARGE (SQ. FT. EACH)	POT SMALL (SQ. FT. EACH)	RIDGE VENT (SQ. FT. PER LF)	EAVE VENT (SQ. IN. EACH)	CONT. VENT (SQ. IN. PERLE)			
721111112	RAN				0.4236	0.2778	0.125	0.1944	0.0625			
RIDGE VENT	1.86	2.32	3.00	44.44	0	0	24.00					
SOFFIT VENTS	2.79	2.32	3.75	55.56				0	60.00			
TOTAL (MIN)	4.64	4.64	6.75	100.00	POT VENTS MAY BE REQUIRED IF THERE IS INSUFFICIENT RIDGE AVAILABLE							

* SCHEDULE HAS BEEN CALCULATED ASSUMING EAVE VENTILATION AT 50-60% OF TOTAL AND RIDGE AT 40-50% OF TOTAL REQUIRED VENTILATION

NEW SHOME

DATE	11/22/2021	2/4/2022	3/30/2022					
DESCRIPTION	REFER TO COVER SHEET	REFER TO COVER SHEET	REFER TO COVER SHEET	-	-	-	-	-
REV.#	1	2	3	4	5	9	7	8

PLAN 2 - THE HOLLY - RH
--Roof Plan 'Craftsman'

DRAWN BY: South Designs

ISSUE DATE:
7/1/2021
CURRENT REVISION DATE:

SCALE: 1/8" = 1'-0"

3.3a

PROJECT # 21-2816-RH

2816-F

Successions appraised in the construction means, methods, technique quences, procedures or safety precautions.

In deviations or discrepancies on plans are to be brought to mediate attention of Southern Engineers. Failure to do so will Southern Engineer's Hability.


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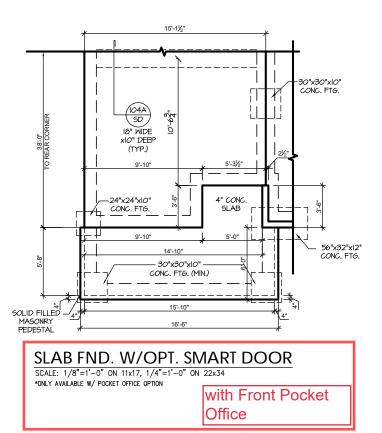
SOUTH DESIGNS

2 - The Holly - RH
NEW HOME, INC.

S-1.1

Plan



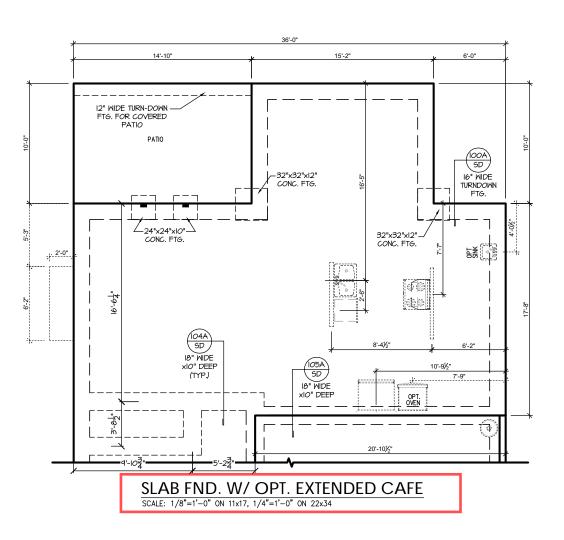

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SOUTH DESIGNS

RH The Holly NEW HOME, INC. 2

24"x24"x10" —/ CONC. FTG. -30"x30"x10" CONC. FTG. 4" CONC. SLAB (TABLE R402.2)
MITH FIBERMESH OR WIREMESH
ON 6 MIL VAPOR RETARDER
(AS REQ'ID) ON BASE COURSE
(R506.2.2). SEE R506.2.1 FOR
FILL REQUIREMENTS. IOIA SD I6" WIDE TURNDOWN FTG. - 24"x24"x10"— CONC. FTG. —30"x30"x10" CONC. FTG.

ADJUST GARAGE SLAB ELEVATION AS NECESSARY TO PROVIDE HEAD CLEARANCE AT BEAM.

CRAFTSMAN OPT. SIDE LOAD GARAGE SLAB FOUNDATION PLAN SCALE: 1/8"=1'-0" ON 11x17, 1/4"=1'-0" ON 22x34

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SOUTH DESIGNS

RH The Holly NEW HOME, INC.

2 Plan

TRUSS SYSTEM REQUIREMENTS NC (2018 NCRC): Wind: 115-120 mph

- TRUSS SYSTEM LAYOUTS (PLACEMENT PLANS) SHALL BE DESIGNED IN ACCORDANCE WITH SEALED STRUCTURAL PLANS ANY NEED TO CHANGE TRUSSES SHALL BE COORDINATED WITH SOUTHERN
- TRUSS SCHEMATICS (PROFILES) SHALL BE PREPARED AND SEALED BY TRUSS MANUFACTURER.
- ALL TRUSSES SHALL BE DESIGNED FOR BEARING ON SPF #2 OR #3 PLATES OR LEDGERS (UNO).
- ALL REQUIRED ANCHORS FOR TRUSSES DUE TO UPLIFT OR BEARING SHALL MEET THE REQUIREMENTS AS SPECIFIED ON THE TRUSS

HEADER/BEAM & COLUMN NOTES

- ALL EXTERIOR AND LOAD BEARING HEADERS SHALL BE MIN. (2)2x6 (4" WALL) OR (3)2x6 (6" WALL) WITH (I) SUPPORT STUD, UNLESS NOTED
- 2. THE NUMBER SHOWN AT BEAM AND HEADER SUPPORTS INDICATES THE NUMBER OF SUPPORT STUDS REQUIRED IN STUD POCKET OR COLUMN HEADERS IN EXTERIOR WALLS SHALL BE ACCORDING TO ITEM "d" IN TABLE R602.3(5)
 OR AS BELOW PER NCDO! COMMENTARY "KING STUDS AT WALL OPENINGS" REVISED I-9-2020: UP TO 3' SPAN: (I) KING STUD
- OVER 3' UP TO 6' SPAN: (2) KING STUDS OVER 6' UP TO 9' SPAN: (3) KING STUDS
- OVER 9' UP TO 12' SPAN: (4) KING STUDS
- OVER 12' UP TO 15' SPAN: (5) KING STUDS

WOOD "I" JOISTS

- (SHALL BE ONE OF THE FOLLOWING):

 TJI 210 BY TRUS JOIST
- I PI 20 PI IS BY I P
- ALL WOOD "I"JOISTS SHALL BE INSTALLED ACCORDING TO MANUFACTURER'S SPECIFICATIONS.
- INSTALL SQUASH BLOCKS, WEB STIFFENERS ETC. AS REQUIRED BY AND ACCORDING TO THE I-JOIST MANUFACTURER'S SPECIFICATIONS AND INSTRUCTIONS
- HANGERS FOR I-JOISTS ARE THE RESPONSIBILITY OF THE I-JOIST SUPPLIER.
- FLOOR TRUSSES BY MANUFACTURER MAY BE

- PORCH POST NOTES:

 4X4 (6x6) TRT'D POST (OR EQUAL).
- ATTACH TRUSSES (RAFTERS) AT PORCH WITH HURRIGANE CONNECTORS.
- POST CAP: SIMPSON AC4-MAX (AC6-MAX) POST CAP AT CORNER: (2) SIMPSON LCE4 MITER HEADER AT CORNER). HIGH WIND; ADD (1) SIMPSON H6.
- POST BASE: SIMPSON ABU44 (ABU66).
- MONO: 56" ANCHOR (EMBED 7")
 CMU: 56" ANCHOR (EXTEND TO FOOTING
- HIGH WIND ONLY)
- POST BASE: WOOD FOUNDATION: (2) SIMPSON CSI6 STRAPS AT POSTS. EXTEND 12" ONTO EACH POST (UPPER AND LOWER) OR TO GIRDER.

and Smart Door

Delivery

NOTE: EQUIVALENT POST CAP AND BASE ACCEPTABLE.

FRAMING NOTES


NC (2018 NCRC): Wind: 115-120 mph

- BRACING METHOD AND TYPE: CONTINUOUSLY SHEATHED WSP. CS-WSP. NOTE THAT THE WALL BRACING AMOUNT PROVIDED ON THE PLANS (DETAILS AND SPECIFICATIONS) IS GREATER THAN THE AMOUNT OF WALL BRACING REQUIRED BY SECTION R602.10 OF THE CODE. SEE NOTES BELOW FOR DETAILS AND SPECIFICATIONS FOR WALL BRACING AND WALL FRAMING.
- 2. EXTERIOR WALL SHEATHING: WALLS SHALL BE BRACED BY SHEATHING WALLS ON ALL STORIES WITH WOOD STRUCTURAL PANEL SHEATHING (WSP) (EXPOSURE B: T/16", EXPOSURE C: 15/32"), SHEATHING SHALL BE ATTACHED WITH 8d NAILS AT A 6"/12" NAILING PATTERN (6" OC AT PANEL EDGES AND 12" OC AT INTERMEDIATE SUPPORTS). INSTALL BLOCKING AT ALL PANEL EDGES.
- 3. WSP SHEATHING SHALL EXTEND TO THE UPPERMOST DOUBLE BEARING PLATE. BLOCK AT ROOF PER SECTION R602.IO.4.5 AND ATTACH BRACED WALLS PER CODE, WSP SHEATHING BETWEEN FLOORS SHALL BE SPLICED ALONG CONTINUOUS BAND OR THE MSP SHEATHING MAY BE SPLICED ACROSS STUDS (CONTINUOUS ACROSS FLOOR SYSTEM) WITH BLOCKING AT PANEL EDGES. (MINIMUM 12" BEYOND FLOOR BREAK) OR OTHER APPROVED METHOD.
- 4. "HD" = HOLDOWN: HOLD-DOWN DEVICE (NOTED AS "HD" ON PLANS)
 SHALL BE AN 800 POUND CAPACITY ASSEMBLY AS NOTED ON PLANS,
 SEE DETAILS FOR HD ASSEMBLY.
- **GROUND/FIRST FLOOR: USE "HD HOLD-DOWN DETAIL" ON SD SHEET
- (OR EGUIV.)

 **UPPER FLOORS: ATTACH BASE OF KING STUD WITH A SIMPSON CS22

 STRAP DOWN ACROSS THE BAND AND DOWN TO A STUD BELOW OR

 HEADER BELOW. EXTEND STRAP 7" MIN ALONG EACH STUD (OR HEADER) AND ATTACH EACH END W/ (7) 8d NAILS.
- 5. INTERIOR BRACED WALL: (NOTED AS "IBW" ON PLANS) ATTACH I/2" GYPSUM BOARD (GB) ON EACH SIDE OF WALL MITH A MIN. OF 5d COOLER NAILS OR #6 SCREMS @ 7" O.C. ALONG THE EDGES AND AT INTERMEDIATE SUPPORTS.
- 6. INTERIOR BRACED WALL-WOOD STRUCTURAL PANEL: (NOTED AS "IBM-MSP" ON PLANS). ATTACH ONE SIDE WITH 1/6" MSP SHEATHING WITH 8d NAILS AT A 6"/12" NAILING PATTERN (6" OC AT PANEL EDGES AND 12" OC AT INTERMEDIATE SUPPORTS). INSTALL BLOCKING AT ALL PANEL EDGES, ATTACH GB OVER WSP AS REQUIRED, ATTACH OPPOSITE SIDE WITH 1/2" GB WITH A MIN. OF 5d COOLER NAILS OR #6 SCREMS @ 7" OC ALONG THE EDGES AND AT INTERMEDIATE

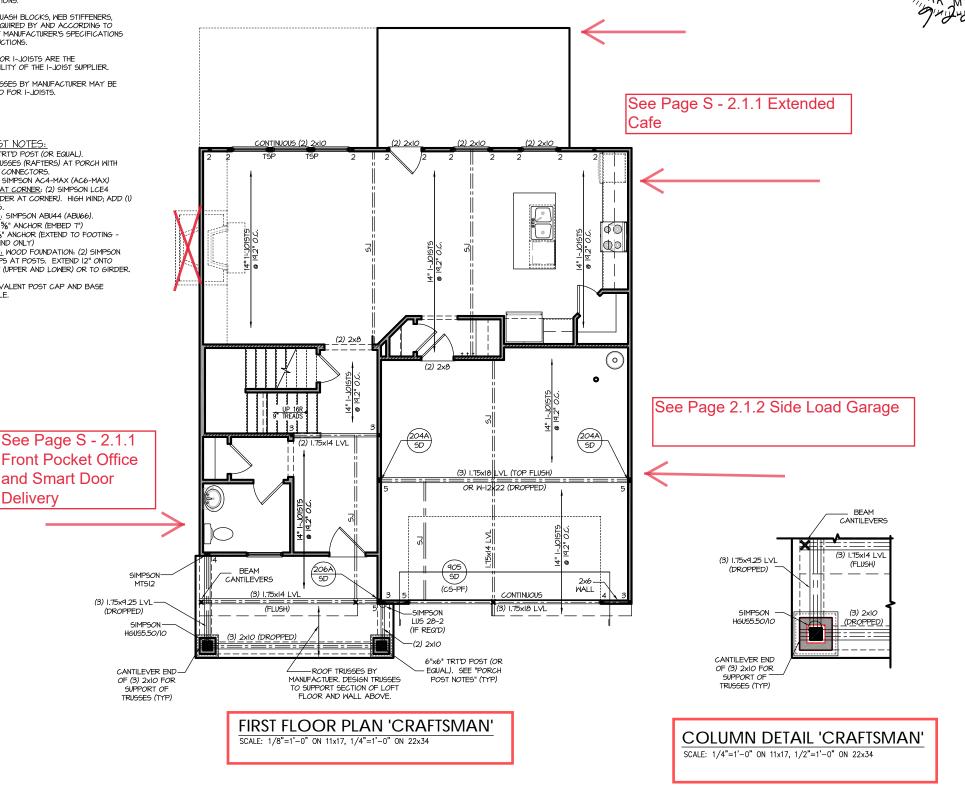

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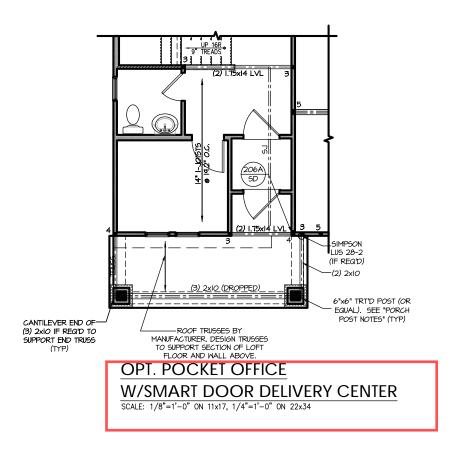
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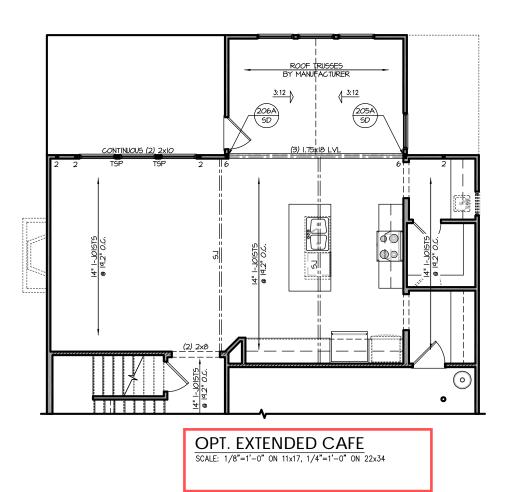
P.A. 27609

Engineers, Drive, Raleigh, NC Southern Engi 3716 Benson Drive, Ra Phone: (919) 8

SOUTH DESIGNS

KH Holly HOME, The





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SOUTH DESIGNS

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S-2.1

Plan

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SOUTH DESIGNS

- RH NEW HOME, INC.

The Holly

TRUSS SYSTEM REQUIREMENTS NC (2018 NCRC): Wind: 115-120 mph

- TRUSS SYSTEM LAYOUTS (PLACEMENT PLANS) SHALL BE DESIGNED IN ACCORDANCE WITH SEALED STRUCTURAL PLANS ANY NEED TO CHANGE TRUSSES SHALL BE COORDINATED WITH SOUTHERN
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- ALL TRUSSES SHALL BE DESIGNED FOR BEARING ON SPF #2 OR #3 PLATES OR LEDGERS (UNO).
- ALL REQUIRED ANCHORS FOR TRUSSES DUE TO UPLIFT OR BEARING SHALL MEET THE REQUIREMENTS AS SPECIFIED ON THE TRUSS

HEADER/BEAM & COLUMN NOTES

- ALL EXTERIOR AND LOAD BEARING HEADERS SHALL BE MIN. (2)2x6 (4" WALL) OR (3)2x6 (6" WALL) WITH (I) SUPPORT STUD, UNLESS NOTED
- 2. THE NUMBER SHOWN AT BEAM AND HEADER SUPPORTS INDICATES THE NUMBER OF SUPPORT STUDS REQUIRED IN STUD POCKET OR COLUMN. THE NUMBER OF KING STUDS AT EACH END OF HEADERS IN EXTERIOR WALLS SHALL BE ACCORDING TO ITEM "d" IN TABLE R602.3(5)
 OR AS BELOW PER NCDOI COMMENTARY "KING STUDS AT WALL OPENINGS" REVISED I-9-2020: UP TO 3' SPAN: (I) KING STUD
- OVER 3' UP TO 6' SPAN: (2) KING STUDS OVER 6' UP TO 9' SPAN: (3) KING STUDS
- OVER 9' UP TO 12' SPAN: (4) KING STUDS
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FRAMING NOTES

NC (2018 NCRC): Wind: 115-120 mph

- BRACING METHOD AND TYPE: CONTINUOUSLY SHEATHED WGP; CS-WGP. NOTE THAT THE WALL BRACING AMOUNT PROVIDED ON THE PLANS (DETAILS AND SPECIFICATIONS) IS GREATER THAN THE AMOUNT OF WALL BRACING REQUIRED BY SECTION R602.10 OF THE CODE. SEE NOTES BELOW FOR DETAILS AND SPECIFICATIONS FOR WALL BRACING AND WALL FRAMING.
- 2. EXTERIOR WALL SHEATHING: WALLS SHALL BE BRACED BY SHEATHING WALLS ON ALL STORIES HITH WOOD STRUCTURAL PANEL SHEATHING (WSP) (EXPOSURE B: 7/16". EXPOSURE C: 15/32"). SHEATHING SHALL BE ATTACHED WITH 8d NAILS AT A 6"/12" NAILING PATTERN (6" OC AT PANEL EDGES AND 12" OC AT INTERMEDIATE SUPPORTS). INSTALL BLOCKING AT ALL PANEL EDGES.
- 3. WSP SHEATHING SHALL EXTEND TO THE UPPERMOST DOUBLE BEARING PLATE. BLOCK AT ROOF PER SECTION R602.IO.4.5 AND ATTACH BRACED WALLS PER CODE, WSP SHEATHING BETWEEN FLOORS SHALL BE SPLICED ALONG CONTINUOUS BAND OR THE MSP SHEATHING MAY BE SPLICED ACROSS STUDS (CONTINUOUS ACROSS FLOOR SYSTEM) WITH BLOCKING AT PANEL EDGES. (MINIMUM 12" BEYOND FLOOR BREAK) OR OTHER APPROVED METHOD.
- 4. "HD" = HOLDOWN: HOLD-DOWN DEVICE (NOTED AS "HD" ON PLANS)
 SHALL BE AN 800 POUND CAPACITY ASSEMBLY AS NOTED ON PLANS.
 SEE DETAILS FOR HD ASSEMBLY.
- **GROUND/FIRST FLOOR: USE "HD HOLD-DOWN DETAIL" ON SD SHEET
- ***UPPER FLOORS: ATTACH BASE OF KING STUD MITH A SIMPSON C522
 STRAP DOWN ACROSS THE BAND AND DOWN TO A STUD BELOW OR
 HEADER BELOW. EXTEND STRAP 7" MIN ALONG EACH STUD (OR HEADER) AND ATTACH EACH END W/ (7) 8d NAILS.
- 5. INTERIOR BRACED WALL: (NOTED AS "IBW" ON PLANS) ATTACH I/2" GYPSUM BOARD (GB) ON EACH SIDE OF WALL MITH A MIN. OF 5d COOLER NAILS OR #6 SCREMS @ 7" O.C. ALONG THE EDGES AND AT INTERMEDIATE SUPPORTS.
- 6. INTERIOR BRACED WALL-WOOD STRUCTURAL PANEL: (NOTED AS "IBM-MSP" ON PLANS). ATTACH ONE SIDE WITH 1/6" MSP SHEATHING WITH 8d NAILS AT A 6"/12" NAILING PATTERN (6" OC AT PANEL EDGES AND 12" OC AT INTERMEDIATE SUPPORTS). INSTALL BLOCKING AT ALL PANEL EDGES, ATTACH GB OVER WSP AS REQUIRED, ATTACH OPPOSITE SIDE WITH 1/2" GB WITH A MIN. OF 5d COOLER NAILS OR #6 SCREMS @ 7" OC ALONG THE EDGES AND AT INTERMEDIATE

SIMPSON C520 OR C5HP20 STRAP DOWN ACROSS THE BAND AND DOWN TO A STUD BELOW OR HEADER BELOW. EXTEND STRAP 9" MIN ALONG EACH STUD (OR HEADER) AND ATTACH EACH END W (8) 8d COMMON NAILS (OR EQ). <u>WIC</u> WIC ROOF TRUSSES MANUFACTURE ROOF TRUSSES ____

SECOND FLOOR PLAN 'CRAFTSMAN'

SCALE: 1/8"=1'-0" ON 11x17, 1/4"=1'-0" ON 22x34

ATTACH BASE OF STUD WITH A

See Page S - 2.2.1 4th

Bedroom

CARO"

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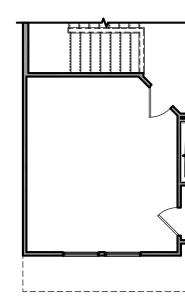
SOUTH DESIGNS

HOME,

Holly The



NO STRUCTURAL CHANGES FROM BASE PLAN



OPT. BEDROOM 4 ILO LOFT SCALE: 1/8"=1'-0" ON 11x17, 1/4"=1'-0" ON 22x34

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SOUTH DESIGNS

The Holly - RH NEW HOME, INC.

7 Plan

S-2.2.

TRUSS SYSTEM REQUIREMENTS NC (2018 NCRC): Wind: 115-120 mph

- I. TRUSS SYSTEM LAYOUTS (PLACEMENT PLANS)
 SHALL BE DESIGNED IN ACCORDANCE WITH SEALED
 STRUCTURAL PLANS, ANY NEED TO CHANGE
 TRUSSES SHALL BE COORDINATED WITH SOUTHERN
 ENGINEERS,
- TRUSS SCHEMATICS (PROFILES) SHALL BE
 PREPARED AND SEALED BY TRUSS MANUFACTURER.
- 3. ALL TRUSSES SHALL BE DESIGNED FOR BEARING ON SPF #2 OR #3 PLATES OR LEDGERS (UNO).
- 4. ALL REQUIRED ANCHORS FOR TRUSSES DUE TO UPLIFT OR BEARING SHALL MEET THE REQUIREMENTS AS SPECIFIED ON THE TRUSS SCHEMATICS.


 6. HEMATICS.

ATTIC VENT SCHEDULE											
CRAFTSMAN											
MAIN	MAIN HOUSE			1393	AT	/ NEAR RID	AT / NEAR EAVE				
VENT TYPE	SQ REQL	. FT. JIRFD	SQ. FT.	PERCENT OF TOTAL SUPPLIED	POT LARGE (SQ. FT. EACH)	POT SMALL (SQ. FT. EACH)	RIDGE VENT (SQ. FT. PER LF)	EAVE VENT (SQ. IN. EACH)	CONT. VENT (SQ. IN. PER LF)		
	RAN		SUPPLIED		0.4236	0.2778	0.125	0.1944	0.0625		
RIDGE VENT	1.86	2.32	3.00	44.44	0	0	24.00				
SOFFIT VENTS	2.79	2.32	3.75	55.56				0	60.00		
TOTAL (MIN)	4.64	4.64	6.75	100.00	POT VENTS MAY BE REQUIRED IF THERE IS INSUFFICIENT RIDGE AVAILABLE						

* SCHEDULE HAS BEEN CALCULATED ASSUMING EAVE VENTILATION AT 50-60% OF TOTAL AND RIDGE AT 40-50% OF TOTAL REQUIRED VENTILATION



See S- 6.1 Extended Cafe Roof Plan

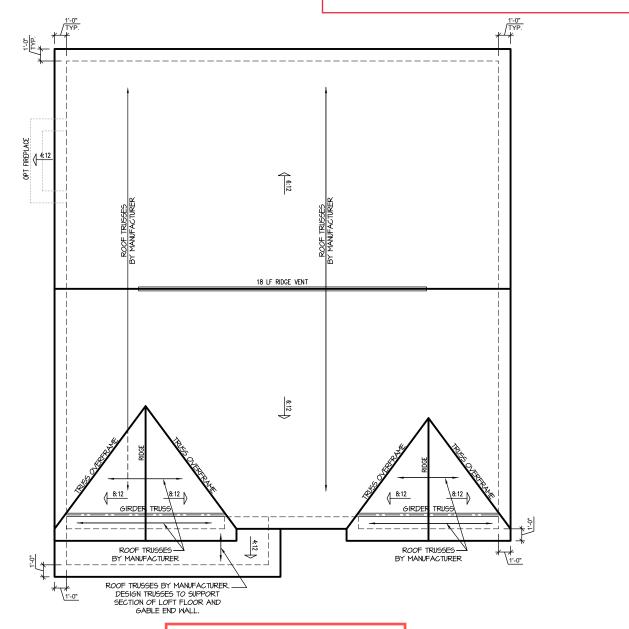

CRAFTSMAN ROOF PLAN
SCALE: 1/4" = 1'-0" ON 22x34, 1/8" = 1'-0" ON 11x17

PROJECT # 21-2816-RH

lans are to be brought to the lineers. Failure to do so will lineers. Provent from date of seal.

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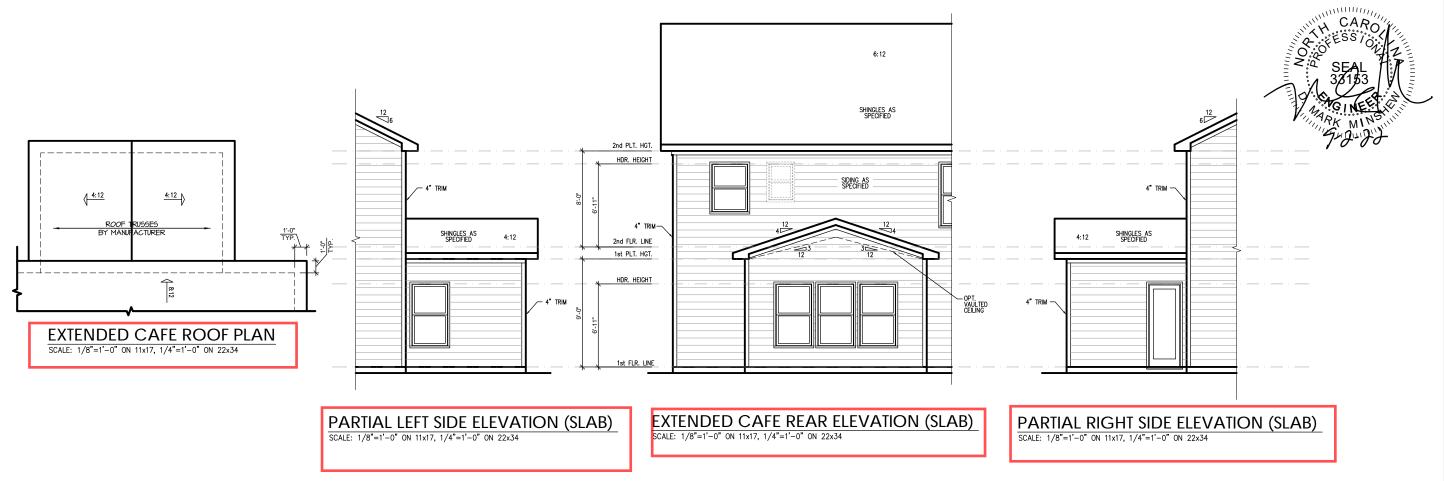
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SOUTH DESIGNS

- The Holly - RI EW HOME, INC.

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