

The Windson Creek

GENERAL NOTES:

- 1. ALL KITCHEN AND UTILITY COUNTERTOPS ARE SHOWN AS 2'-0" WIDE UNLESS STATED OTHERWISE.
- 2. ALL BATHROOM LAVATORY COUNTERTOPS SHOWN AS 1'-10" WIDE.
- 3. ATTIC SPACES MUST PROVIDE I SQ. FT. VENTILATION PER 150 SQ. FT. OF AREA UNLESS CONDITIONED SPACE. (ATTICS R.906)
- 4. ALL INTERIOR DIMENSIONS ARE FROM STUD FACE TO STUD FACE.
- 5. ALL INTERIOR WALL THICKNESS SHOWN AS 4" UNLESS NOTED OTHERWISE.
- 6. THE CONTRACTOR SHALL VERIFY ALL DIMENSIONS BEFORE COMMENCING WORK.
- 7. GUARDS AND RAILINGS SHALL COMPLY WITH IRC 2018, R312.1.1 AND R312.1.2, INSECT SCREENING SHALL NOT BE CONSIDERED AS A GUARD.
- 8. PURCHASER OF THIS PLAN ASSUMES LIABILITY FOR ANY MODIFICATIONS MADE TO THE LAYOUT OF THIS PLAN.
- 9. ALL WOOD FRAMING SHALL BE NO. 2 GRADE -SOUTHERN PINE LUMBER. ALL CEILING JOISTS SPANS ARE BASED ON TABLE R802.5.1 (2) OF THE I.R.C. 2018 AND ARE DESIGNED FOR ATTICS WITH LIMITED STORAGE. (REFER TO FOUNDATION SHEET FOR
- 10. RE: SEC. 308 GLAZING IN HAZARDOUS LOCATIONS & TEMPERED GLASS FOR WINDOWS THAT ARE WITHIN 24" OF THE DOOR IN THE CLOSED POSITION, PROVIDING THE WINDOW IS LESS THAN 60" ABOVE THE FLOOR. (R308 I.R.C. 2018)
- 11. MASONRY VENEER SHALL BE ANCHORED TO THE SUPPORTING WALL WITH CORROSION-RESISTANT METAL TIES SPACED NOT MORE THAN 32" ON CENTER HORIZONTALLY AND 24" ON CENTER VERTICALLY AND SHALL SUPPORT NOT MORE THAN 2.67 SQ. FEET
- OF WALL PER SECTION RTØ3.8.4.1 12. YENT HOOD IN KITCHEN MUST YENT TO THE OUTSIDE, MICROWAYE HOODS MUST VENT TO THE
- OUTSIDE WHERE APPLICABLE. 13. DRYER VENT MUST HAVE MAX LENGTH 25'
- 14. ALL RETURN AIR GRILLS ARE TO BE LOCATED TO COMPLY WITH SECTION MI602 OF THE IRC

WIND ZONE NOTES

PRESSURES.

- I. VERIFY WINDOW CODE REQUIREMENTS AT EACH BUILDING LOCATION, AND INSTALL WINDOWS AS PER CODE. REQUIREMENTS WILL VARY FROM DOUBLE INSULATED VINYL TO IMPACT RESISTANT DOUBLE INSULATED VINYL WINDOWS. 2. ALL WINDOWS SHALL COMPLY WITH THE GOVERNING IRC/IBC, WINDOWS SHALL BE SELECTED BASED UPON THE COMPONENT AND CLADDING DESIGN
- 3. CONTRACTOR RESPONSIBLE FOR ANCHORAGE OF BOTTOM PLATE AND WALL STUDS TO FOUNDATION IN COMPLIANCE WITH THE GOVERNING EDITION OF IRC/IBC 1609. SEE TABLE R301.2.1.2 OF IRC 2018.

HEADER SPANS FOR LOAD

BEARING WALLS: SINGLE STORY:

- 2 PLY 2'X6" • 2 PLY 2'X8" 5'-4" MAX
- 2 PLY 2'XIO" 7'-6" MAX
- 2 STORY: 3'X7" MAX 2 PLY 2'X6"
- 2 PLY 2'X8" 4'X6" MAX • 2 PLY 2'XIØ" 6'X2" MAX

NO BOXED HEADERS

- 2 PLY 2X6 HEADERS FOR ALL NON-LOAD BEARING WALLS OSB BETWEEN ALL HEADER PLIES OWNER.
- REFER TO IRC R502.5 (1) AND (2) FOR ADDITIONAL HEADER AND GIRDER

ROOF OVERHANG ON NEW CONSTRUCTION TYPICAL 12" FROM FACE OF STUD UNLESS OTHERWISE NOTED.

GENERAL CONTRACTOR TO PROVIDE ADEQUATE ROOF VENTILATION BUILDING SYSTEMS PER IRC CODE (SECTION R806). SYSTEMS TO BE USED TO MEET ROOF VENTALATION REQUIREMENTS ARE AS FOLLOWS: CONTINUOUS RIDGE VENTS, POWER VENTS, BOX VENTS, AND GABLE/DORMER VENTS WHEN APPROVED BY

SOFFIT VENTS TO BE USED ONLY IN ACCORDANCE W/ IRC CODE (SECTION R3Ø2 AND TABLE R3Ø2.1) TO ACCOMMODATE APPROPRIATE FIRE SEPARATION DISTANCES.

GENERAL MATERIALS:

1. EXTERIOR WALLS: -REINFORCED CEMENTITIOUS SIDING

- "TYVEK" BUILDING WRAP -1/2" O.S.B. SHEATHING

-2×4 STUDS @ 1'-4" O.C. (UNLESS NOTED) -R-13 BATT INSULATION -1/2" GYPSUM BOARD INTERIOR 2. INTERIOR WALLS: -1/2" GYPSUM BOARD ON BOTH SIDES

-2×4 STUDS @ 1'-4" O.C. 3. CEILING: -2× JOISTS @ 1'-4" O.C. -R38 INSULATION

-1/2" GYPSUM BOARD

4. ROOF SYSTEM: -30 YEAR FIBERGLASS SHINGLES -#I5FELT -5/8" O.S.B. OR CDX PLYWOOD

-2×6 RAFTERS @ 2'0" O.C. (CONFIRM W/ LOCAL CODE)

NOTE: ALL ROOFING PRODUCTS, MATERIALS AND INSTALLATION, SHALL COMPLY WITH THE REQUIREMENTS UNLESS CHANGED BY GENERAL CONTRACTOR AT OWN DISCRETION.

PROTECTION AGAINST TERMITES:

- I. SUBTERRANEAN TERMITE CONTROL. IN AREAS FAVORABLE TO TERMITE DAMAGE METHODS OF PROTECTION SHALL BE BY CHEMICAL SOIL TREATMENT, PRESSURE-TREATED WOOD, NATURALLY TERMITE RESISTANT WOOD OR PHYSICAL BARRIERS (SUCH AS METAL OR PLASTIC TERMITE SHIELDS), OR ANY COMBINATION OF THESE
- 2. CHEMICAL SOIL TREATMENT. THE CONCENTRATION, RATE OF APPLICATION AND TREATMENT METHOD OF THE TERMITICIDE LABEL.
- 3. PRESSURE-TREATED AND NATURALLY RESISTANT WOOD. HEARTWOOD OF REDWOOD AND EASTERN RED CEDAR SHALL BE CONSIDERED TERMITE RESISTANT. PRESSURE-TREATED WOOD AND NATURALLY TERMITE RESISTANT WOOD SHALL NOT BE USED AS A PHYSICAL BARRIER UNLESS A BARRIER CAN BE INSPECTED FOR ANY TERMITE SHELTER TUBES AROUND THE INSIDE AND OUTSIDE EDGES AND JOINTS OF A BARRIER.
- 4. FIELD TREATMENT. FIELD CUT ENDS, NOTCHES, AND DRILLED HOLES OF PRESSURE-TREATED WOOD SHALL BE RETREATED IN THE FIELD ACCORDING TO AWPA M4 AS PER IRC 2018, R318.1.2

WINDOW EGRESS NOTES

- R311.1 MEANS OF EGRESS. DWELLINGS SHALL BE PROVIDED WITH A MEANS OF EGRESS IN ACCORDANCE WITH THIS SECTION. THE MEANS OF EGRESS SHALL PROVIDE A CONTINUOUS AND UNOBSTRUCTED PATH OF VERTICAL AND HORIZONTAL EGRESS TRAVEL FROM ALL PORTIONS OF THE DWELLING TO THE REQUIRED EGRESS DOOR WITHOUT REQUIRING TRAVEL THROUGH A GARAGE. THE REQUIRED EGRESS DOOR SHALL OPEN DIRECTLY INTO A PUBLIC WAY OR TO A YARD OR COURT THAT OPENS TO A PUBLIC WAY.
- . R310.2.1 MINIMUM OPENING AREA. EMERGENCY AND ESCAPE RESCUE OPENINGS SHALL HAVE A NET CLEAR OPENING OF NOT LESS THAN 5.7 SQUARE FEET (0.530 M2). THE NET CLEAR OPENING DIMENSIONS REQUIRED BY THIS SECTION SHALL BE OBTAINED BY THE NORMAL OPERATION OF THE EMERGENCY ESCAPE AND RESCUE OPENING FROM THE INSIDE. THE NET CLEAR HEIGHT OPENING SHALL BE NOT LESS THAN 24 INCHES (610 MM) AND THE NET CLEAR WIDTH SHALL BE NOT LESS THAN 20 INCHES (508 MM), EXCEPTION: GRADE FLOOR OR BELOW GRADE OPENINGS SHALL HAVE A NET CLEAR OPENING OF NOT LESS THAN 5 SQUARE FEET (0.465 M2).
- . R310.2.2 WINDOW SILL HEIGHT, WHERE A WINDOW IS PROVIDED AS THE EMERGENCY ESCAPE AND RESCUE OPENING, IT SHALL HAVE A SILL HEIGHT OF NOT MORE THAN 44 INCHES (1118 MM) ABOVE THE FLOOR, WHERE THE SILL HEIGHT IS BELOW GRADE, IT SHALL BE PROVIDED WITH A WINDOW WELL IN ACCORDANCE WITH SECTION R310.2.3.
- 4. R310.2.3 WINDOW WELLS. THE HORIZONTAL AREA OF THE WINDOW WELL SHALL BE NOT LESS THAN 9 SQUARE FEET (0.9 M2), WITH A HORIZONTAL PROJECTION AND WIDTH OF NOT LESS THAN 36 INCHES (914 MM). THE AREA OF THE WINDOW WELL SHALL ALLOW THE EMERGENCY ESCAPE AND RESCUE OPENING TO BE FULLY OPENED. EXCEPTION: THE LADDER OR STEPS REQUIRED BY SECTION R310.2.3.1 -SHALL BE PERMITTED TO ENCROACH NOT MORE THAN 6 INCHES (152 MM) INTO THE REQUIRED DIMENSIONS OF THE WINDOW WELL.


- 5. R310.2.3.1 LADDER AND STEPS. WINDOW WELLS WITH A VERTICAL DEPTH GREATER THAN 44 INCHES (1118 MM) SHALL BE EQUIPPED WITH A PERMANENTLY AFFIXED LADDER OR STEPS USABLE WITH THE WINDOW IN THE FULLY OPEN POSITION. LADDERS OR STEPS REQUIRED BY THIS SECTION SHALL NOT BE REQUIRED TO COMPLY WITH SECTIONS R311.7 AND R311.8. LADDERS OR RUNGS SHALL HAVE AN INSIDE WIDTH OF NOT LESS THAN 12 INCHES (305 MM), SHALL PROJECT NOT LESS THAN 3 INCHES (76 MM) FROM THE WALL AND SHALL BE SPACED NOT MORE THAN 18 INCHES (457 MM) ON CENTER VERTICALLY FOR THE FULL HEIGHT OF THE
- 6. R312.2 WINDOW FALL PROTECTION. WINDOW FALL PROTECTION SHALL BE PROVIDED IN ACCORDANCE WITH SECTIONS R312.2.1 AND R312.2.2.

WINDOW WELL.

- R312.2.1 WINDOW SILLS. IN DWELLING UNITS, WHERE THE TOP OF THE SILL OF AN OPERABLE WINDOW OPENING IS LOCATED LESS THAN 24 INCHES (610 MM) ABOVE THE FINISHED FLOOR AND GREATER THAN 72 INCHES (1829 MM) ABOVE THE FINISHED GRADE OR OTHER SURFACE BELOW ON THE EXTERIOR OF THE BUILDING, THE OPERABLE WINDOW SHALL COMPLY WITH ONE OF THE FOLLOWING:
 - 1. OPERABLE WINDOWS WITH OPENINGS THAT WILL NOT ALLOW A 4-INCH-DIAMETER (102 MM) SPHERE TO PASS THROUGH THE OPENING WHERE THE OPENING IS IN ITS LARGEST OPENED
 - 2. OPERABLE WINDOWS THAT ARE PROVIDED WITH WINDOW FALL PREVENTION DEVICES THAT COMPLY WITH ASTM F 2090.
 - 3. OPERABLE WINDOWS THAT ARE PROVIDED WITH WINDOW OPENING CONTROL DEVICES THAT COMPLY WITH SECTION R312.2.2.
- 8. R312.2.2 WINDOW OPENING CONTROL DEVICES. WINDOW OPENING CONTROL DEVICES SHALL COMPLY WITH ASTM F 2090. THE WINDOW OPENING CONTROL DEVICE, AFTER OPERATION TO RELEASE THE CONTROL DEVICE ALLOWING THE WINDOW TO FULLY OPEN. SHALL NOT REDUCE THE NET CLEAR OPENING AREA OF THE WINDOW UNIT TO LESS THAN THE AREA REQUIRED BY SECTION R310.2.1

CODE DISCLAIMER:

- THESE PLANS WERE DESIGNED TO MEET IRC 2018 AT THE TIME OF THEIR CREATION AND MORE SPECIFICALLY THE MINIMAL LOCAL CODES OF THE SOUTH LOUISIANA AREA. IT IS HIGHLY RECOMMENDED THAT THESE PLANS BE REVIEWED BY A LOCAL STRUCTURAL ENGINEER PRIOR TO CONSTRUCTION.
- BEAMS AND FLOOR JOISTS ARE NOT SIZED DUE TO THE MANY GEOGRAPHIC LOCATIONS THESE PLANS ARE SOLD. THESE ITEMS SHALL BE SIZED BY A LOCAL ENGINEER OR MANUFACTURER.
- 3. ALL CEILING & FLOOR JOISTS (IF CONVENTIONAL FRAMING) SHOULD BE SIZED USING THE LATEST VERSION OF THE IRC OR APPLICABLE CODES AT SITE TO MEET THE LOCAL REQUIREMENTS SUCH AS SNOW LOADS AND OTHER FACTORS. THE CEILING JOIST SIZES LABELED (IF PRESENT) WERE SIZED USING THE 2018 IRC AT THE TIME OF THEIR CREATION. THEY MUST BE VERIFIED AND MODIFIED AS REQUIRED TO MEET THE LATEST EDITION OF THE (IRC) INTERNATIONAL RESIDENTIAL CODE.
- 4. ALL FOUNDATION AND FOOTING DETAILS SHALL BE REVIEWED AND APPROVED BY A LOCAL ENGINEER.
- 5. CONTRACTOR SHALL PROVIDE ALL HIGH WIND STRAPPING AND ANCHOR BOLTS AS REQUIRED BY THE LOCAL CODE REQUIREMENTS AND THE LATEST VERSION OF THE IRC.

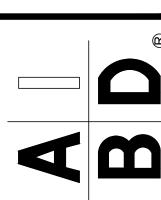

Project No.: Windsor Creek

JULY 6, 2022 Steven Madden DRAWN BY:

DESIGNED BY: Steven Madden

COPYRIGHT NOTE: 0 These Plans Are Subject To Federal Copyright Laws And Are To Be Used For The Lot

Number And Subdivision Indicated in This Title Block Only. Use On Any Other Site is Prohibited.

O COPYRICHT 2022

Sheet Title **COVER**

SHEET

□ Preliminary Dwo

☐ Bidding Doc.

☐ Construction Do



Q M

Project No.: Windsor Creek

JULY 6, 2022 Steven Madden

DESIGNED BY: Steven Madden


COPYRIGHT NOTE: 0 These Plans Are Subject To Federal Copyright Laws And Are To Be Used For The Lot Number And Subdivision Indicated In This Title Block Only. Use On Any Other Site is Prohibited.


OCOPYRICHT 2022


Sheet Title

FRONT & REAR **ELEVATIONS**

□ Preliminary Dwg.

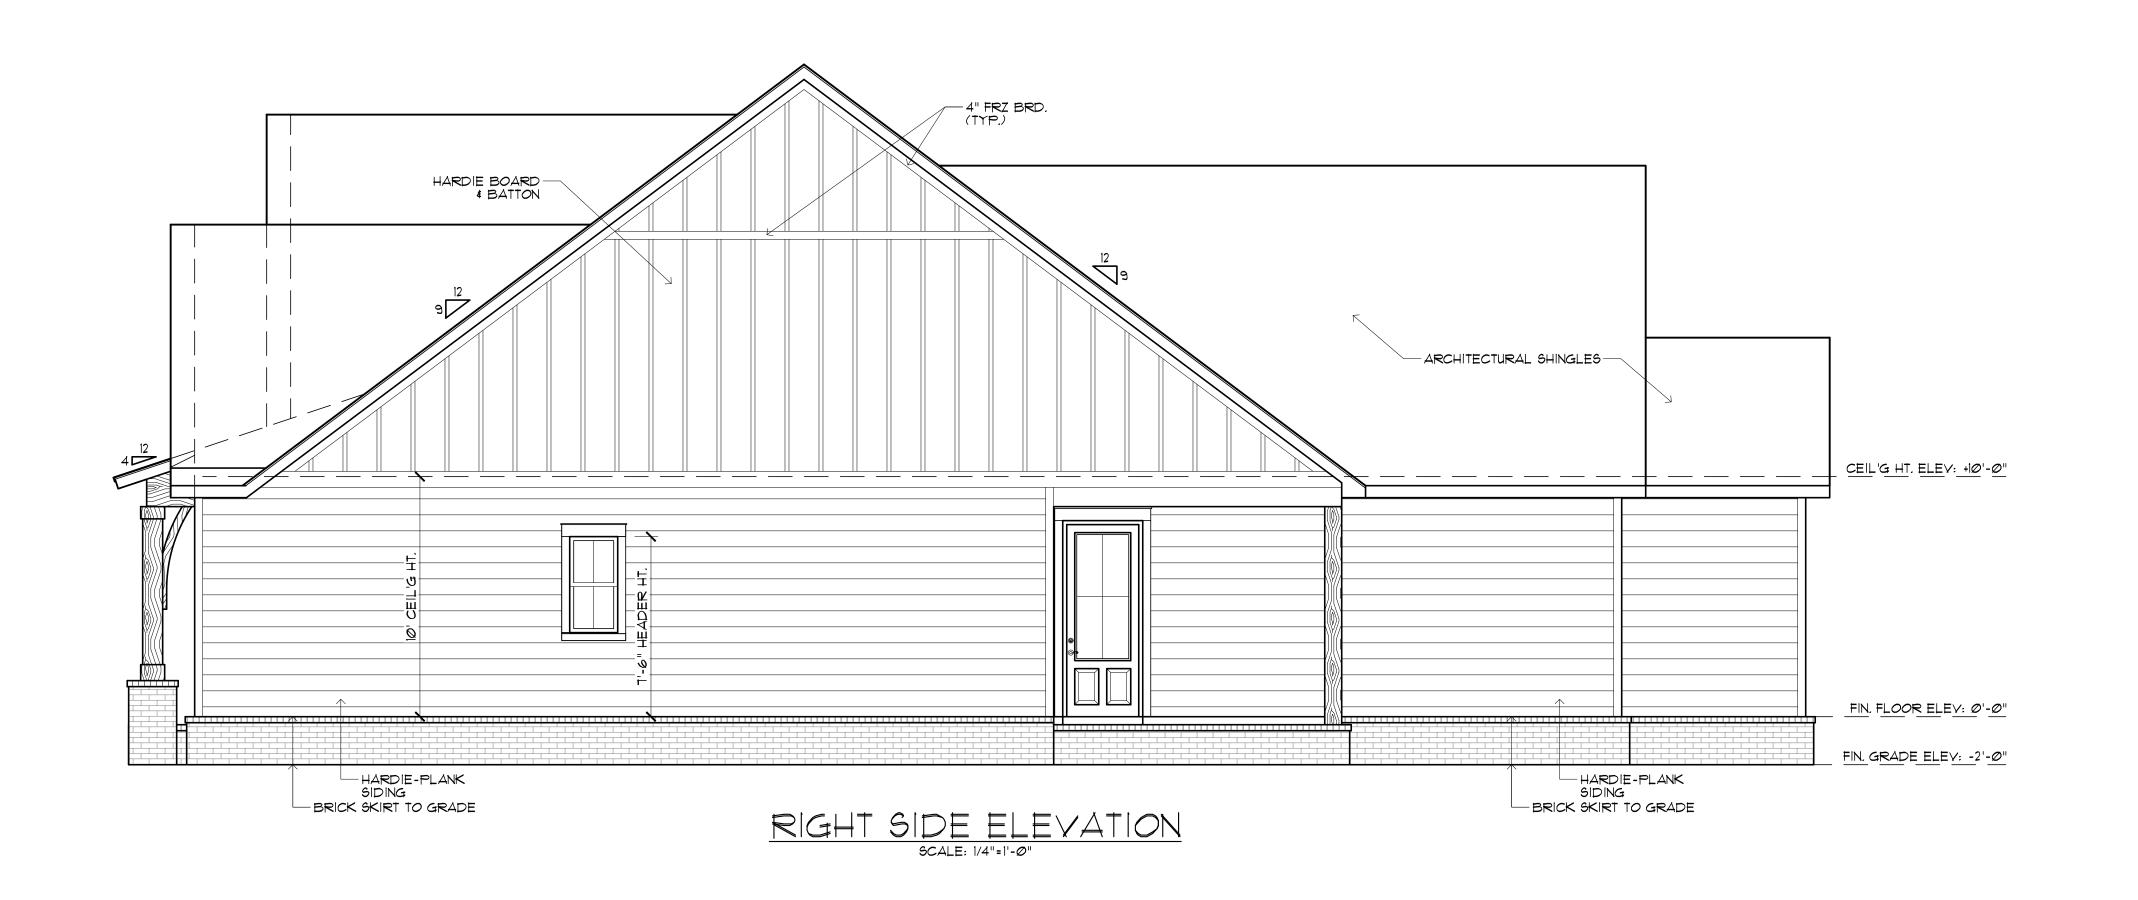

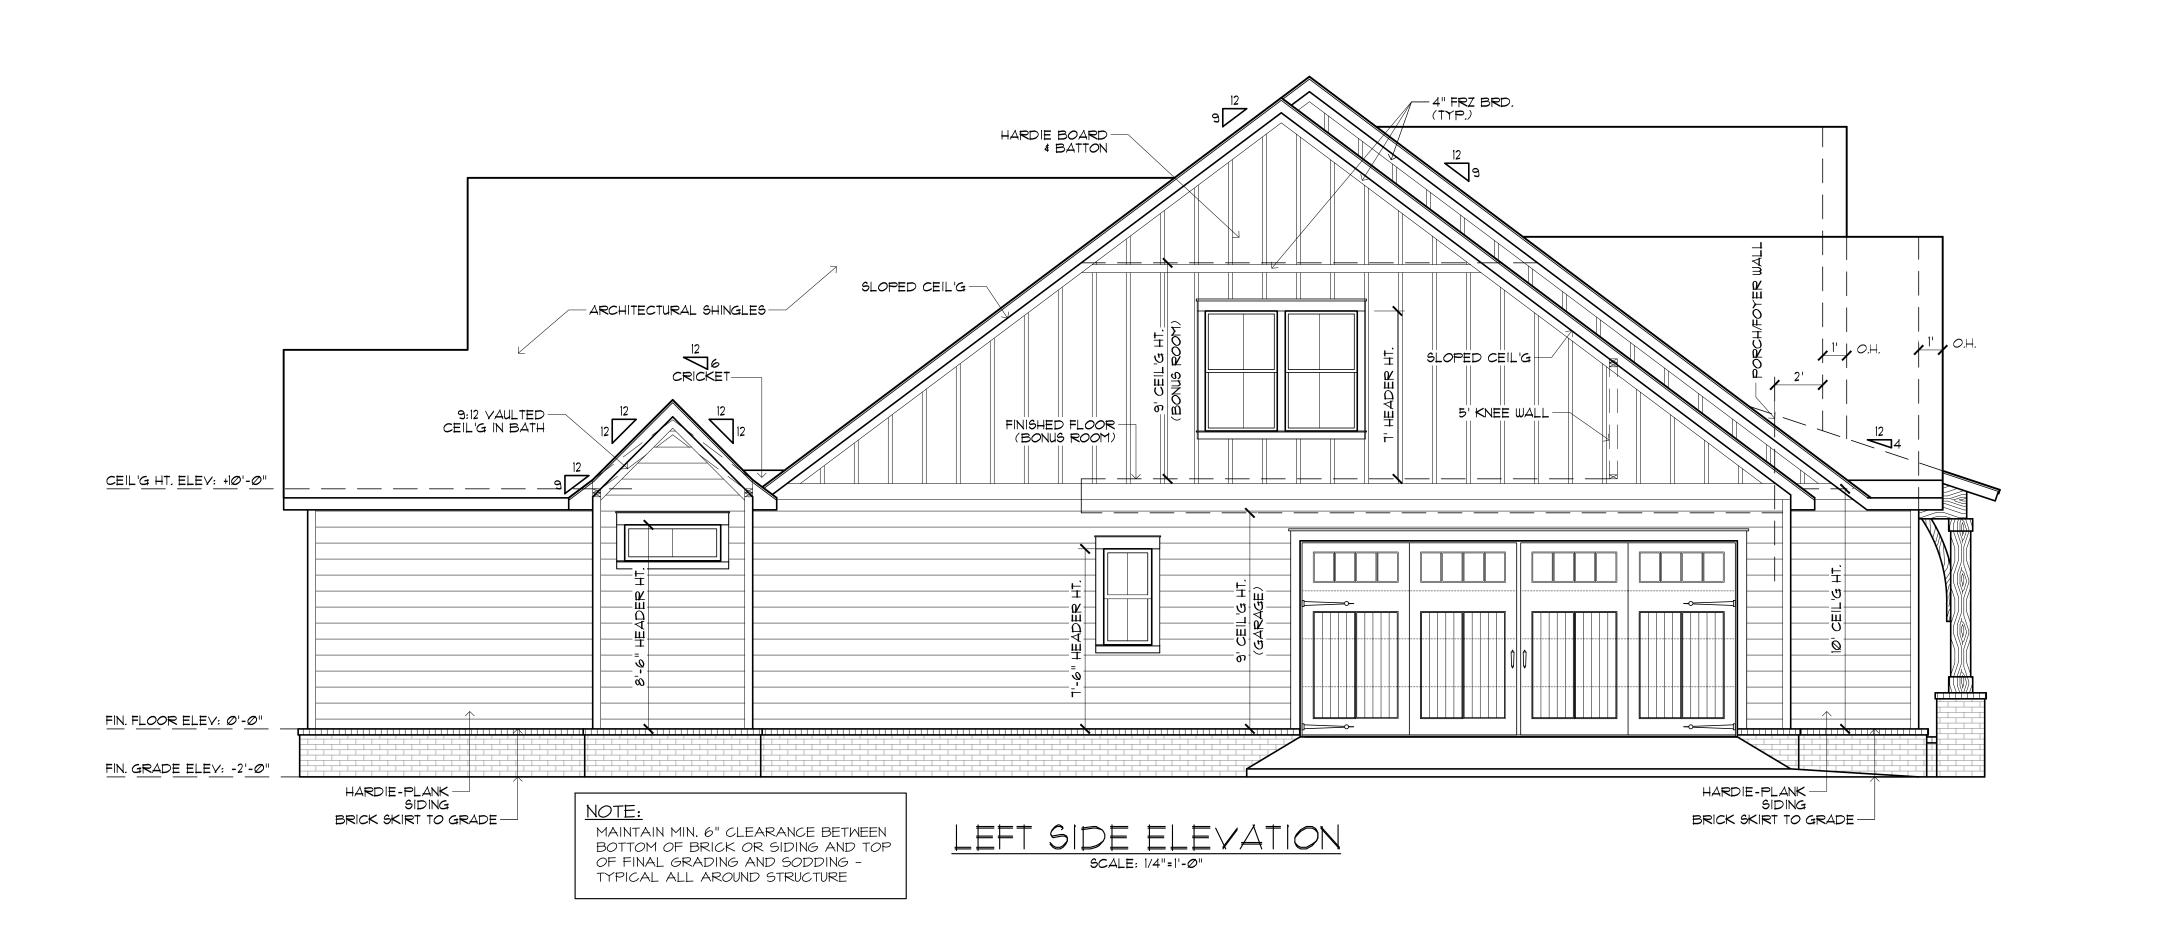

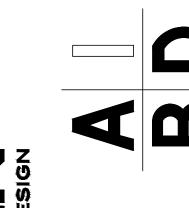

Project No.: Windsor Creek

JULY 6, 2022 Steven Madden

DESIGNED BY: Steven Madden

COPYRIGHT NOTE: © These Plans Are Subject To Federal Copyright Laws And Are To Be Used For The Lot Number And Subdivision Indicated In This Title Block Only. Use On Any Other Site is Prohibited.


© COPYRICHT 2022


Sheet Title

SIDE **ELEVATIONS**

 \square Preliminary Dwg.

☐ Bidding Doc. ☐ Construction Do

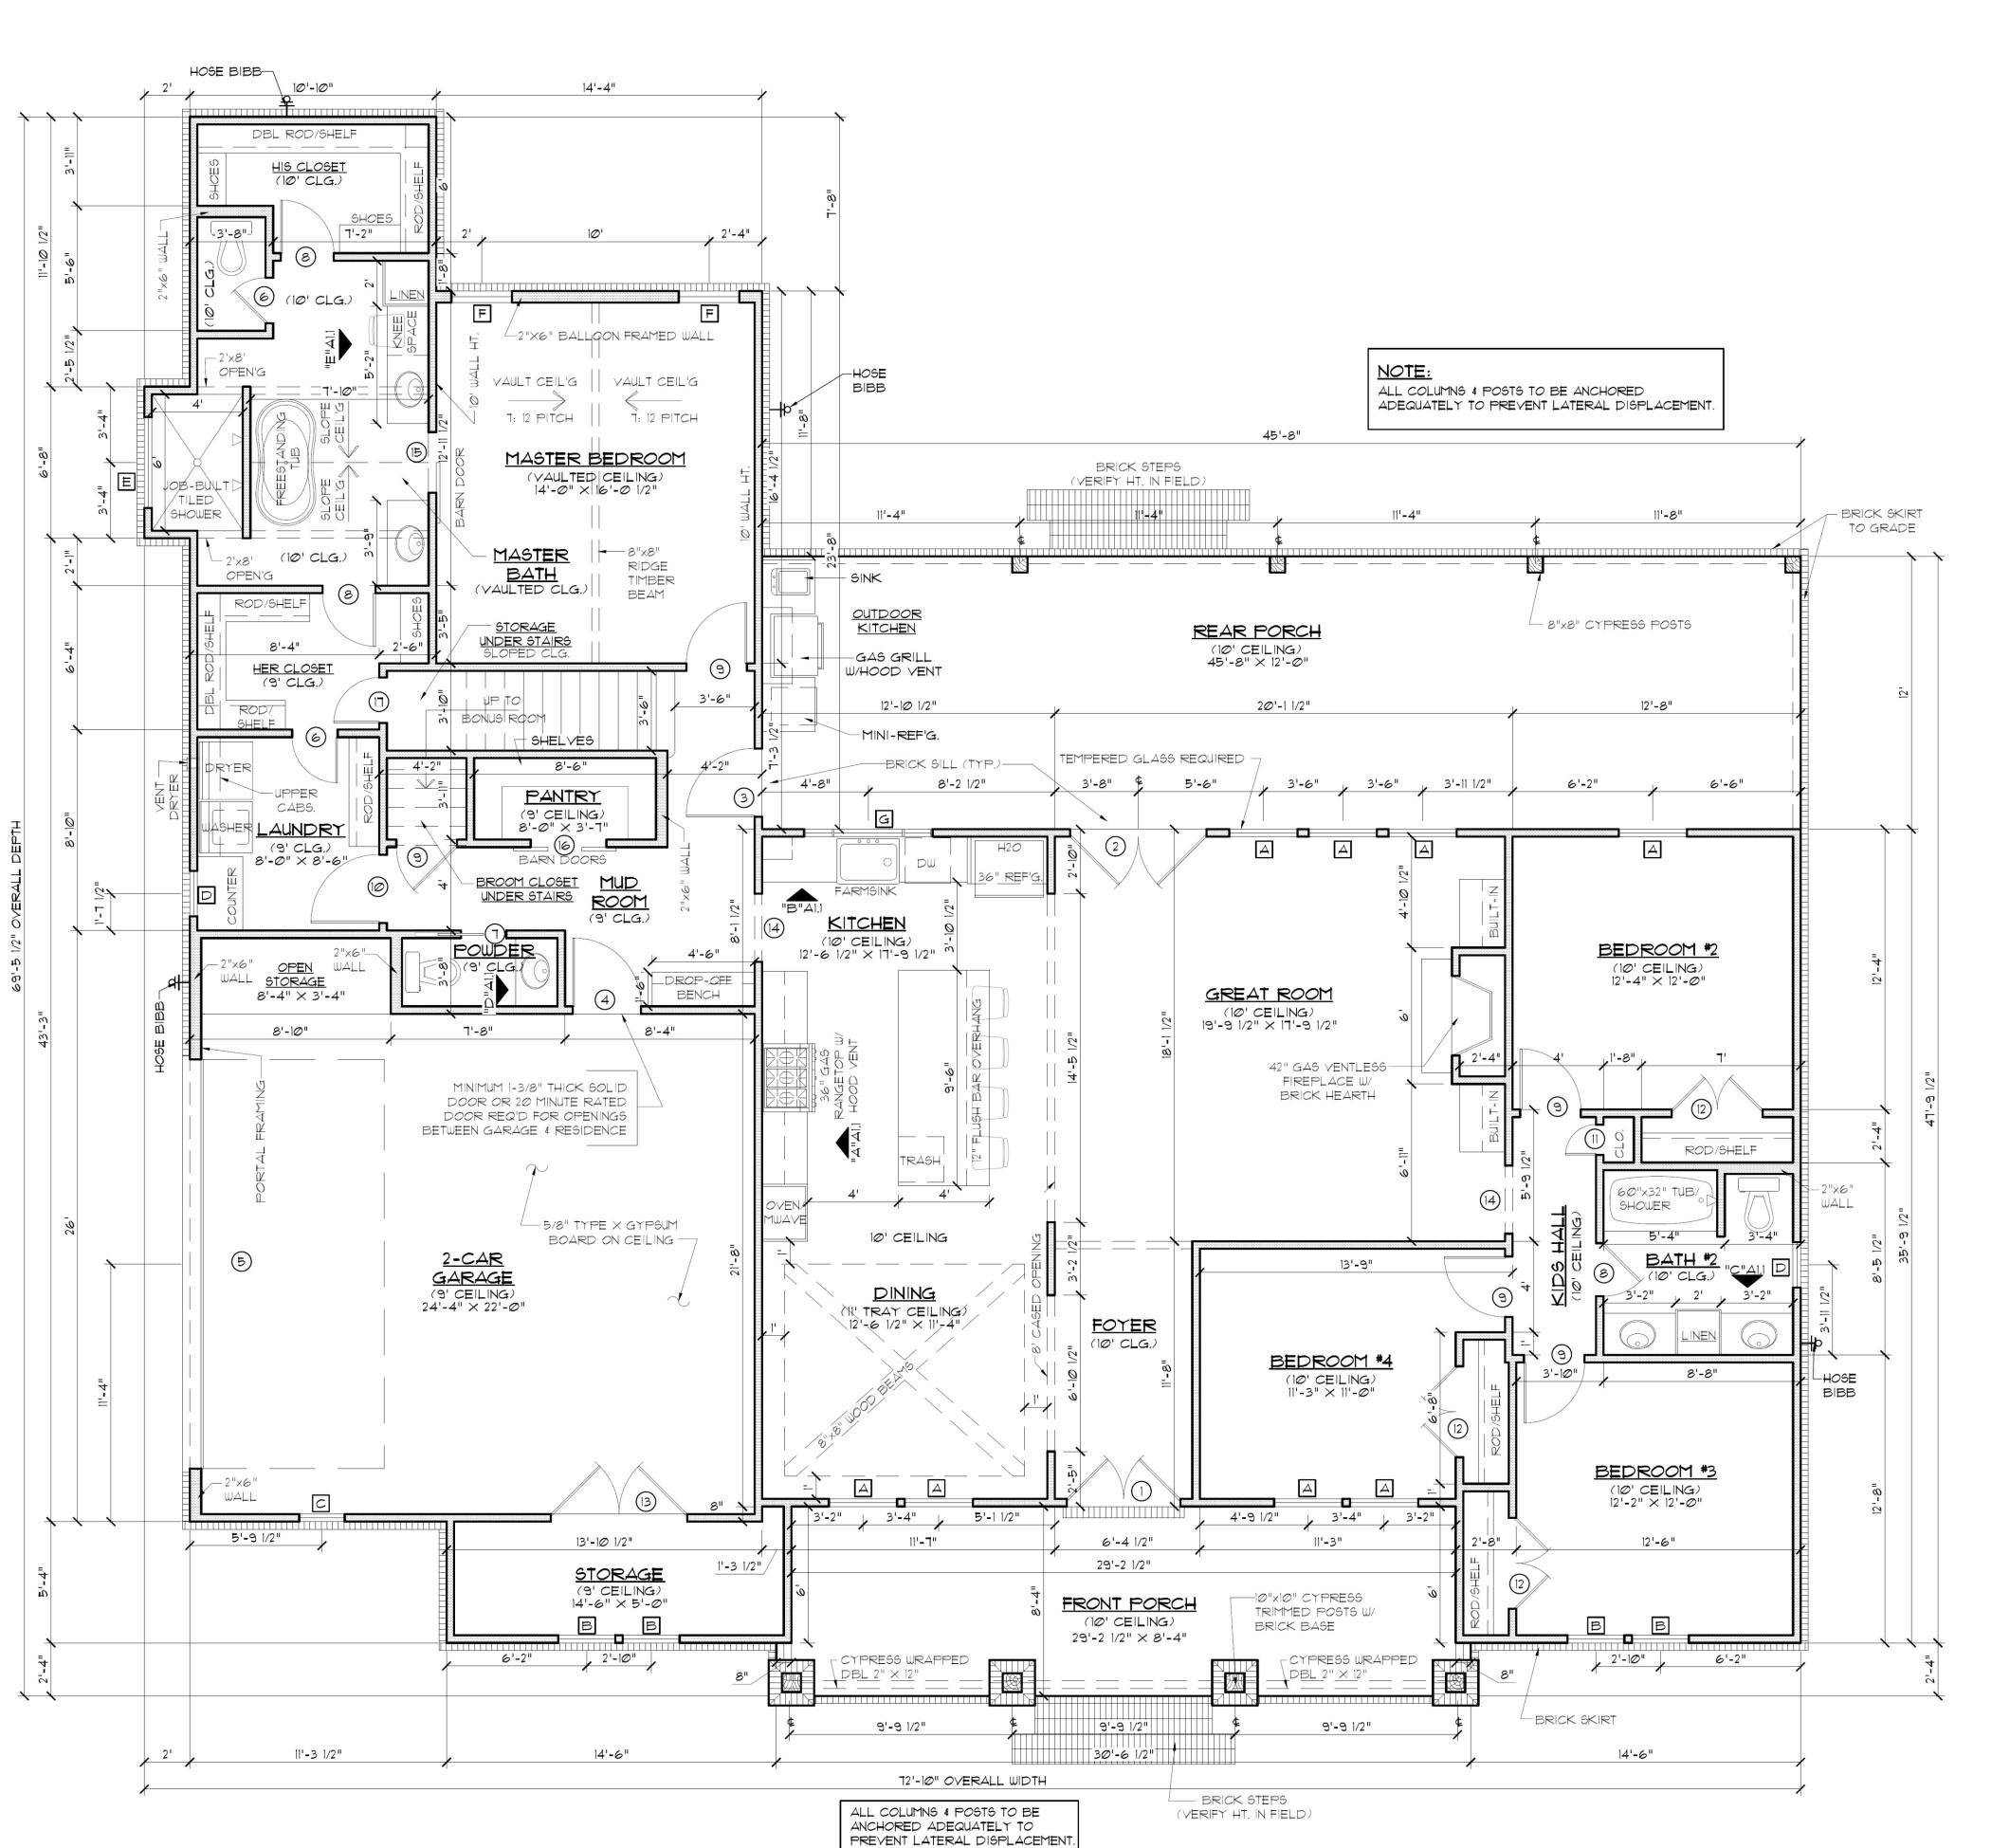

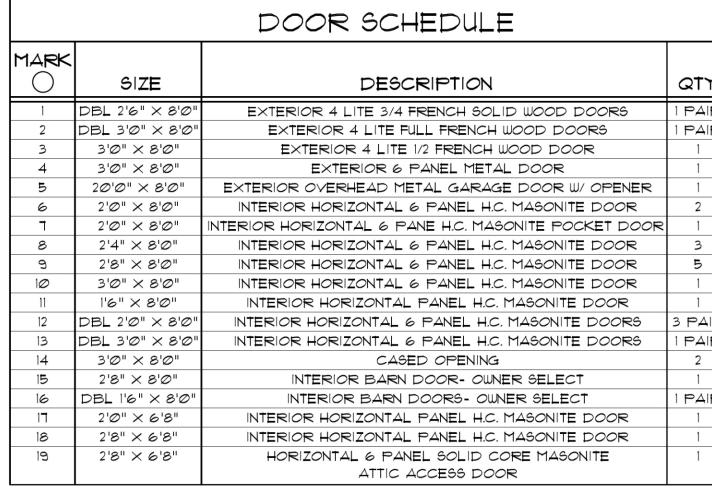

WINDOW SCHEDULE			
MARK	opening size	DESCRIPTION	QTY.
Д	3'Ø" × 7'Ø"	2/2 LITE VINYL SINGLE HUNG WINDOW INSULATED	8
В	2'6" × 6'0"	2/2 LITE VINYL SINGLE HUNG WINDOW INSULATED	4
С	2'Ø" × 3'Ø"	4 LITE VINYL FIXED WINDOW INSULATED	1
D	2'Ø" × 4'Ø"	2/2 LITE VINYL SINGLE HUNG WINDOW INSULATED	2
E	4'Ø" × 1'6"	2 LITE VINYL FIXED TRANSOM WINDOW INSULATED	1
F	2'8" × 6'Ø"	2/2 LITE VINYL SINGLE HUNG WINDOW INSULATED	2
G	5'6" × 4'0"	(1) 3'0" 2/2 S.H. INSULATED WINDOW W/ 1'2" SIDELITES	1
H	2'Ø" × 2'Ø"	4 LITE VINYL FIXED WINDOW INSULATED (SEE SHEET A2.0)	2
J	2'Ø" × 4'Ø"	4 LITE VINYL FIXED WINDOW INSULATED (SEE SHEET A2.0)	2
K	2'8" × 5'Ø"	2/2 LITE VINYL SINGLE HUNG WINDOW INSULATED	2

IMPORTANT NOTE:

ALL EGRESS OR RESCUE WINDOWS FROM SLEEPING ROOMS MUST HAVE A MINIMUM NET CLEAR OPENING OF 5.7 SQUARE FEET. GRADE FLOOR WINDOWS MAY HAVE A MINIMUM NET CLEAR OPENING OF 5 SQUARE FEET. THE MINIMUM NET CLEAR OPENING HEIGHT SHALL BE 24". THE MINIMUM NET CLEAR OPENING WIDTH SHALL BE 20". MAXIMUM SILL HEIGHT - 44" A.F.F.


SQUARE FOOTAGE
MAIN LIVING — — — — — — 2326 FRONT PORCH — — — — — — 246 REAR PORCH — — — — — — 548 GARAGE/OPEN STORAGE — — — 584 STORAGE — — — — — — 82
TOTAL SQ. FT.——————— 378

FLOOR PLAN SCALE: 1/4" = 1'-0"

CONTRACTOR TO LOCATE WATER HEATER & A/C UNITS ON SITE

ALCHITECTURAL DESIGN LINE AND LABER IN A SOUTH SECTION OLD BEING A SOU

RON TUTOR IWOOD BLDRS L

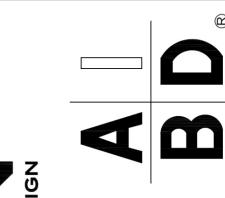

5 Rushing Road ham Springs, Louisian 26

Project No.: Windsor Creek

DATE: JULY 6, 2022

DRAWN BY: Steven Madden

DESIGNED BY: Steven Madden

COPTRIGHT NOTE: ©
These Plans Are Subject To
Federal Copyright Laws And
Are To Be Used For The Lot
Number And Subdivision
Indicated In This Title Block

Only. Use On Any Other Site is

Prohibited.


© COPYRICHT 2022


Sheet Title

FLOOR
PLAN
PO#23320RT

☐ Preliminary Dwg.

☐ Bidding Doc.☐ Construction Doc.

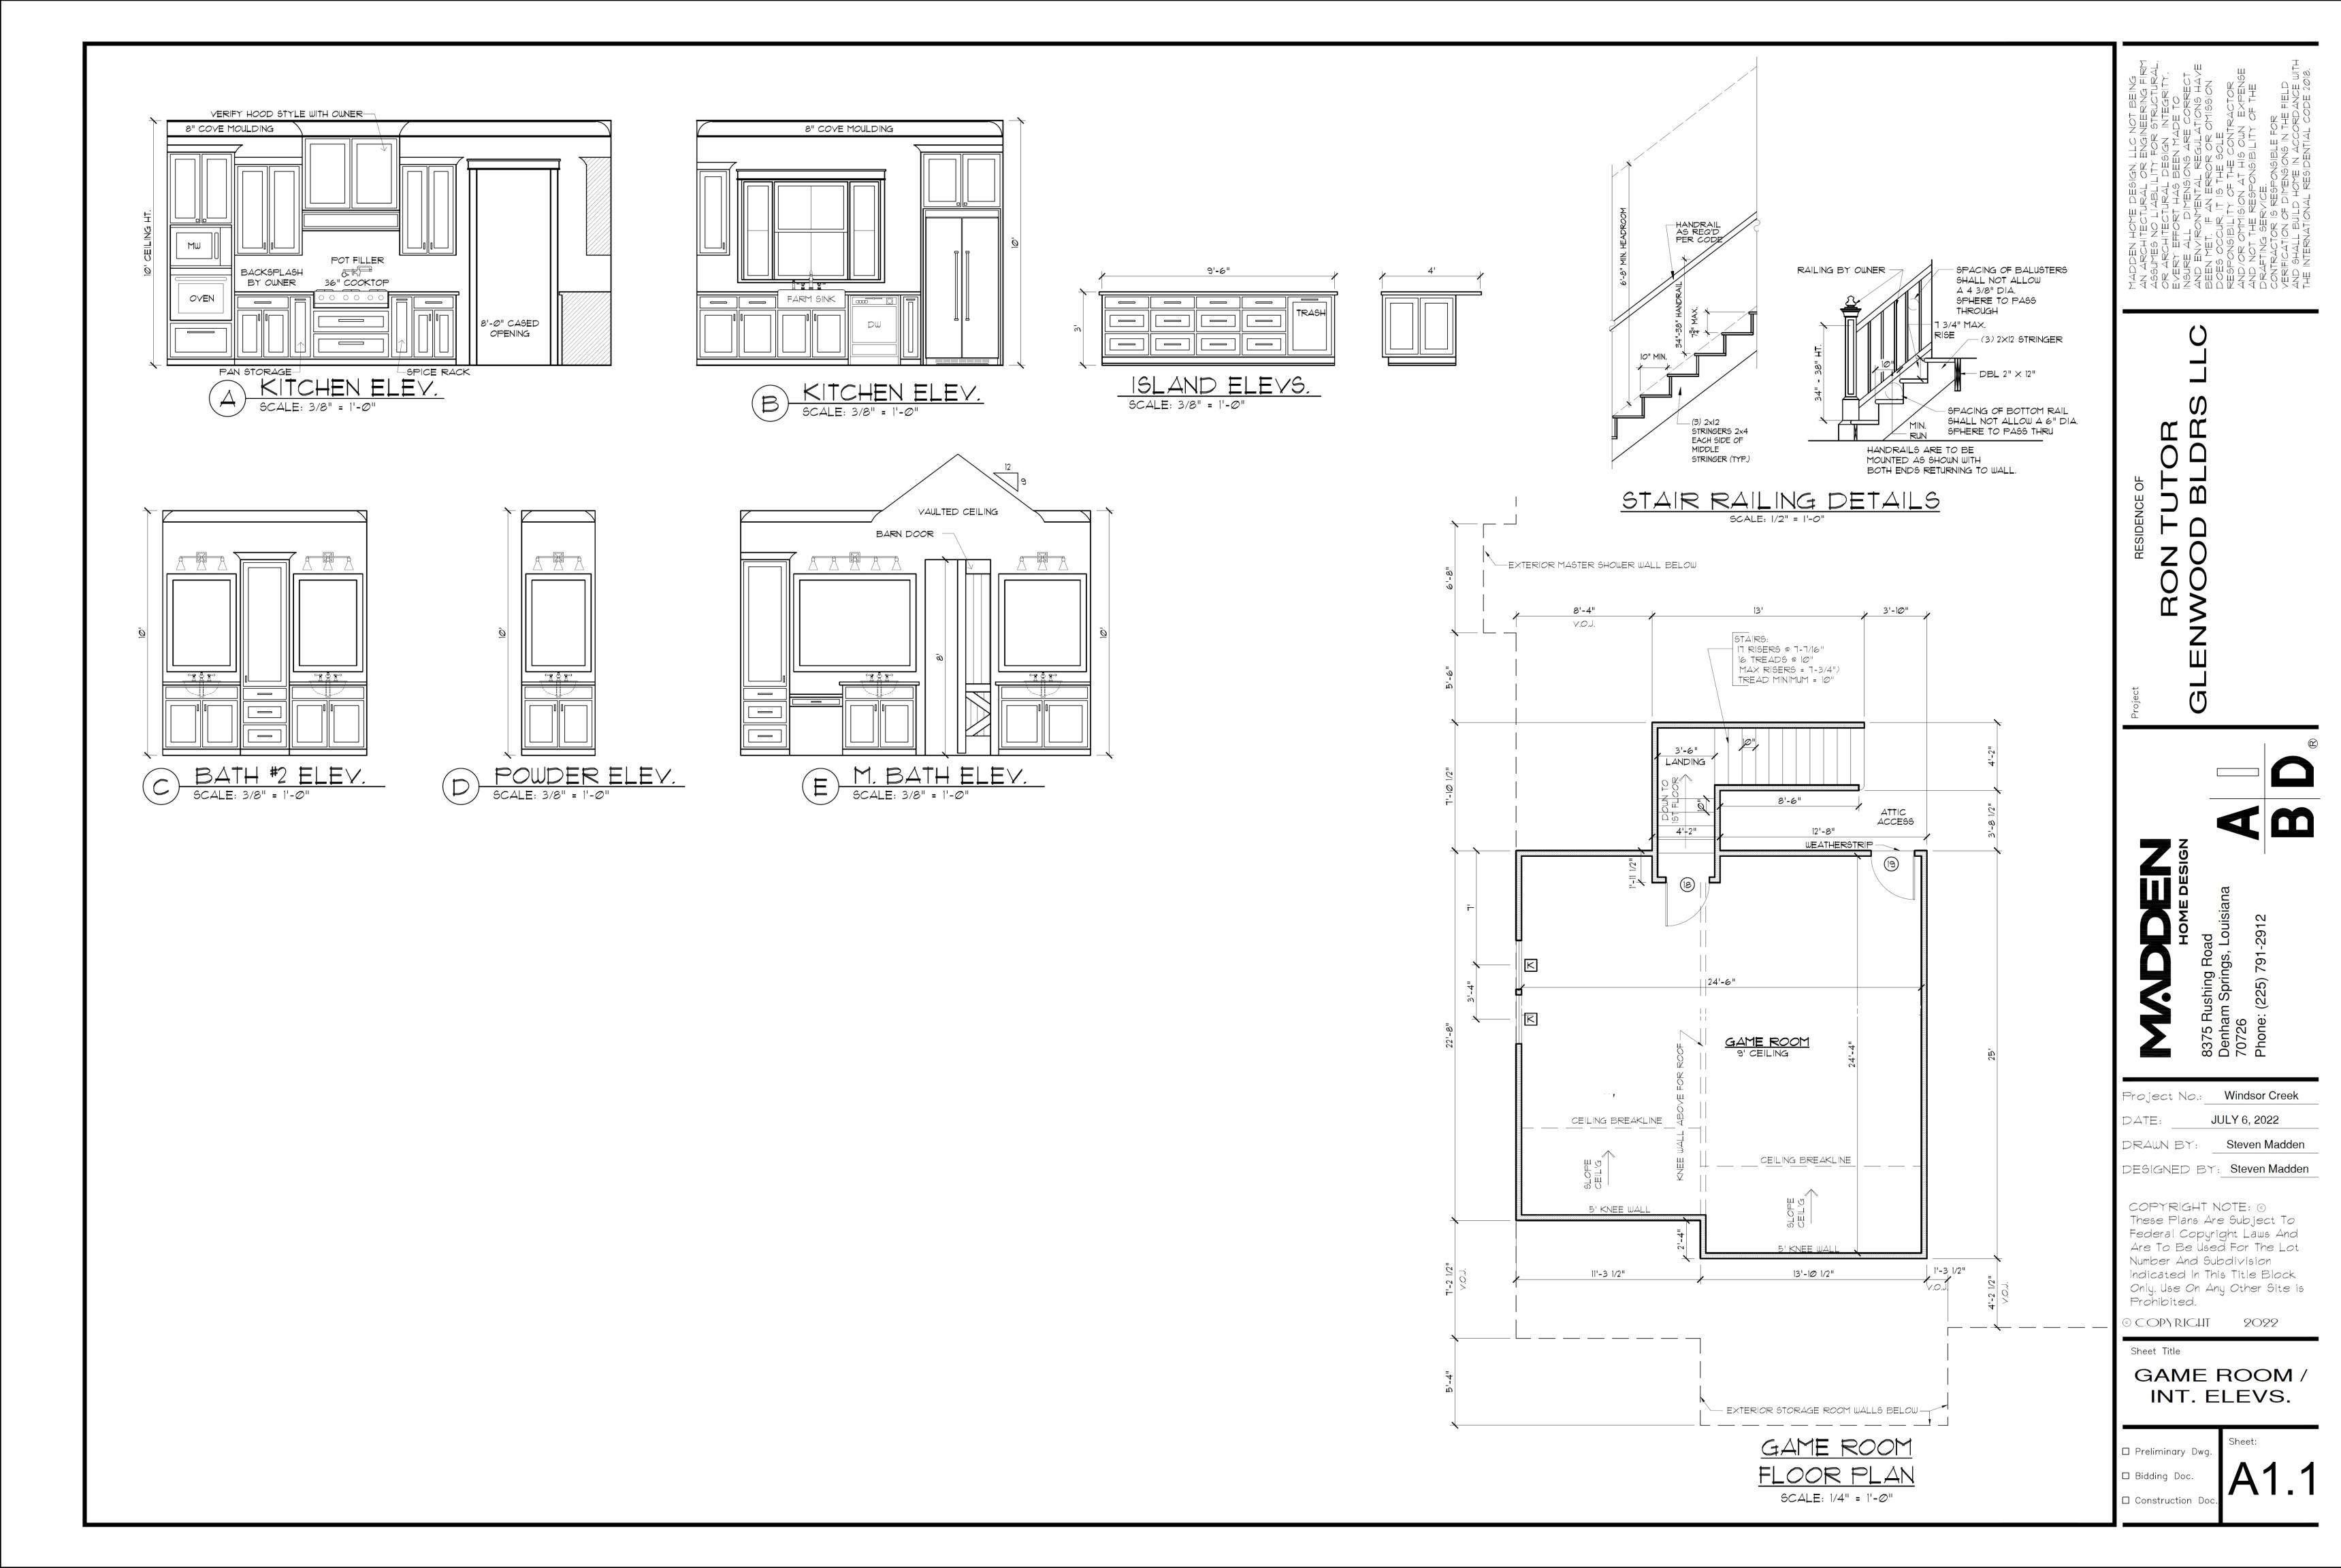

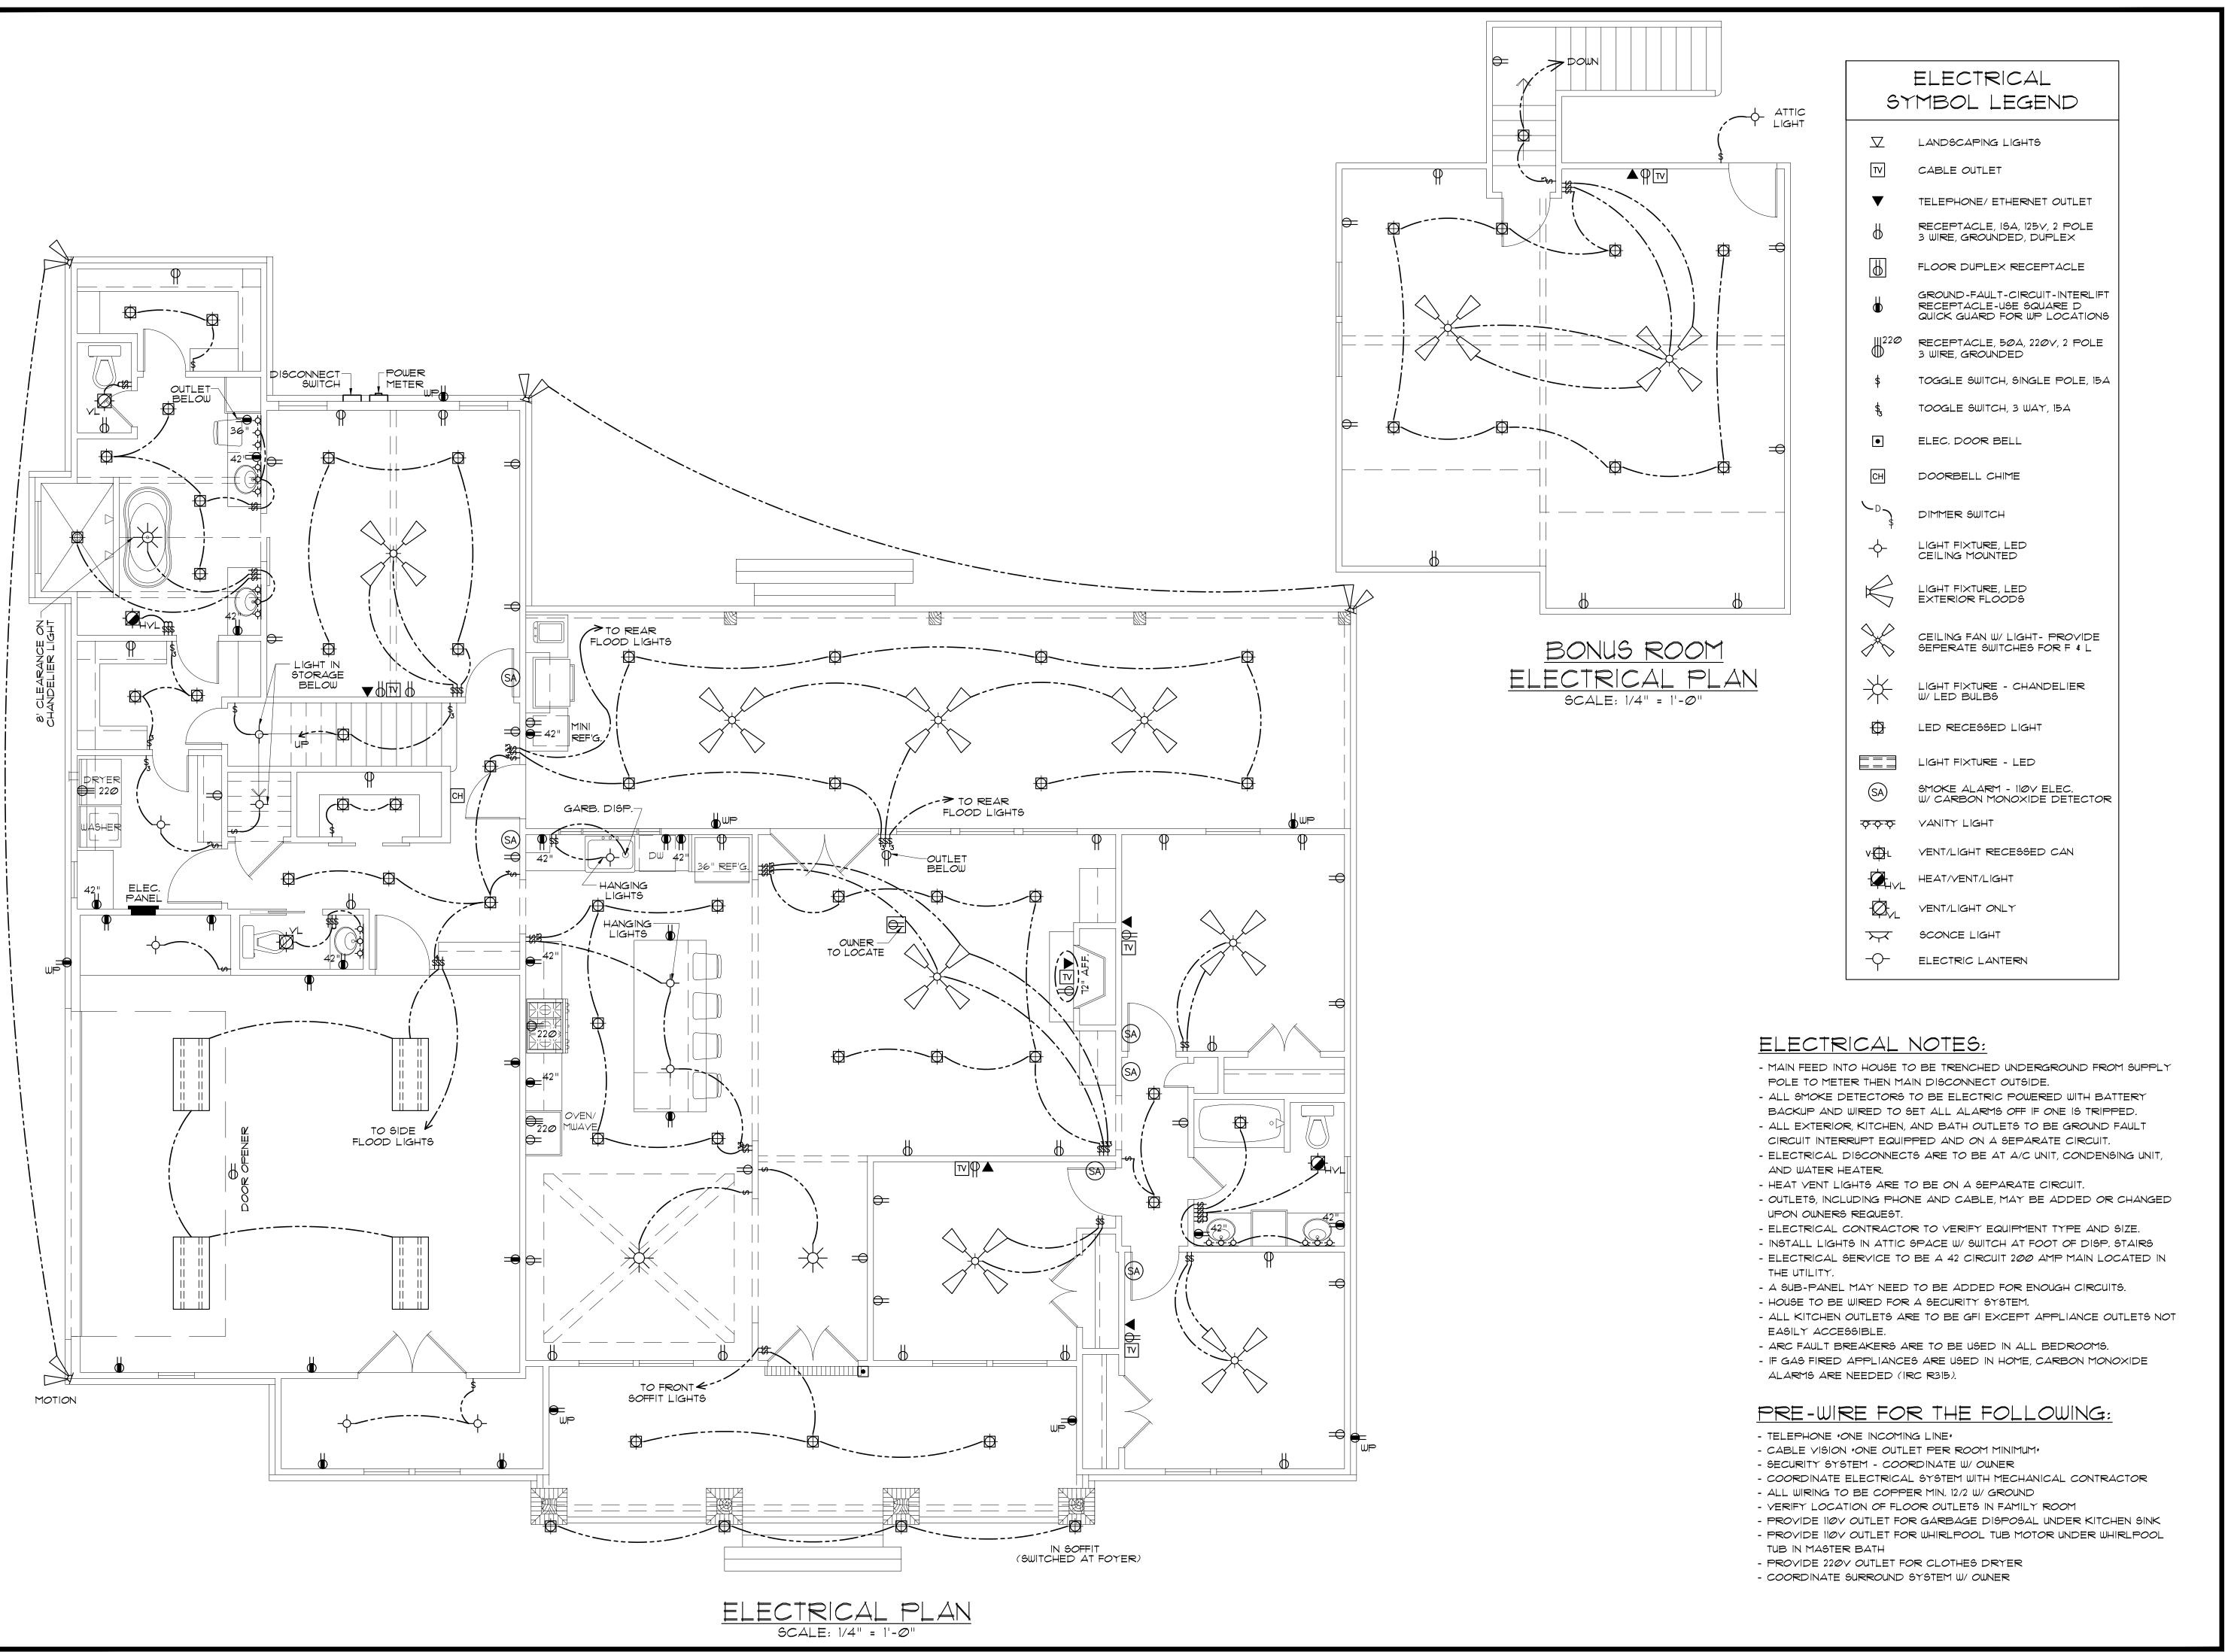

Project No.: Windsor Creek

Steven Madden

JULY 6, 2022

DESIGNED BY: Steven Madden

COPYRIGHT NOTE: © These Plans Are Subject To Federal Copyright Laws And Are To Be Used For The Lot Number And Subdivision Indicated In This Title Block Only. Use On Any Other Site is

Prohibited. OCOPYRICHT 2022


Sheet Title


ELECTRICAL PLAN

☐ Preliminary Dwg.

☐ Bidding Doc.

☐ Construction Do

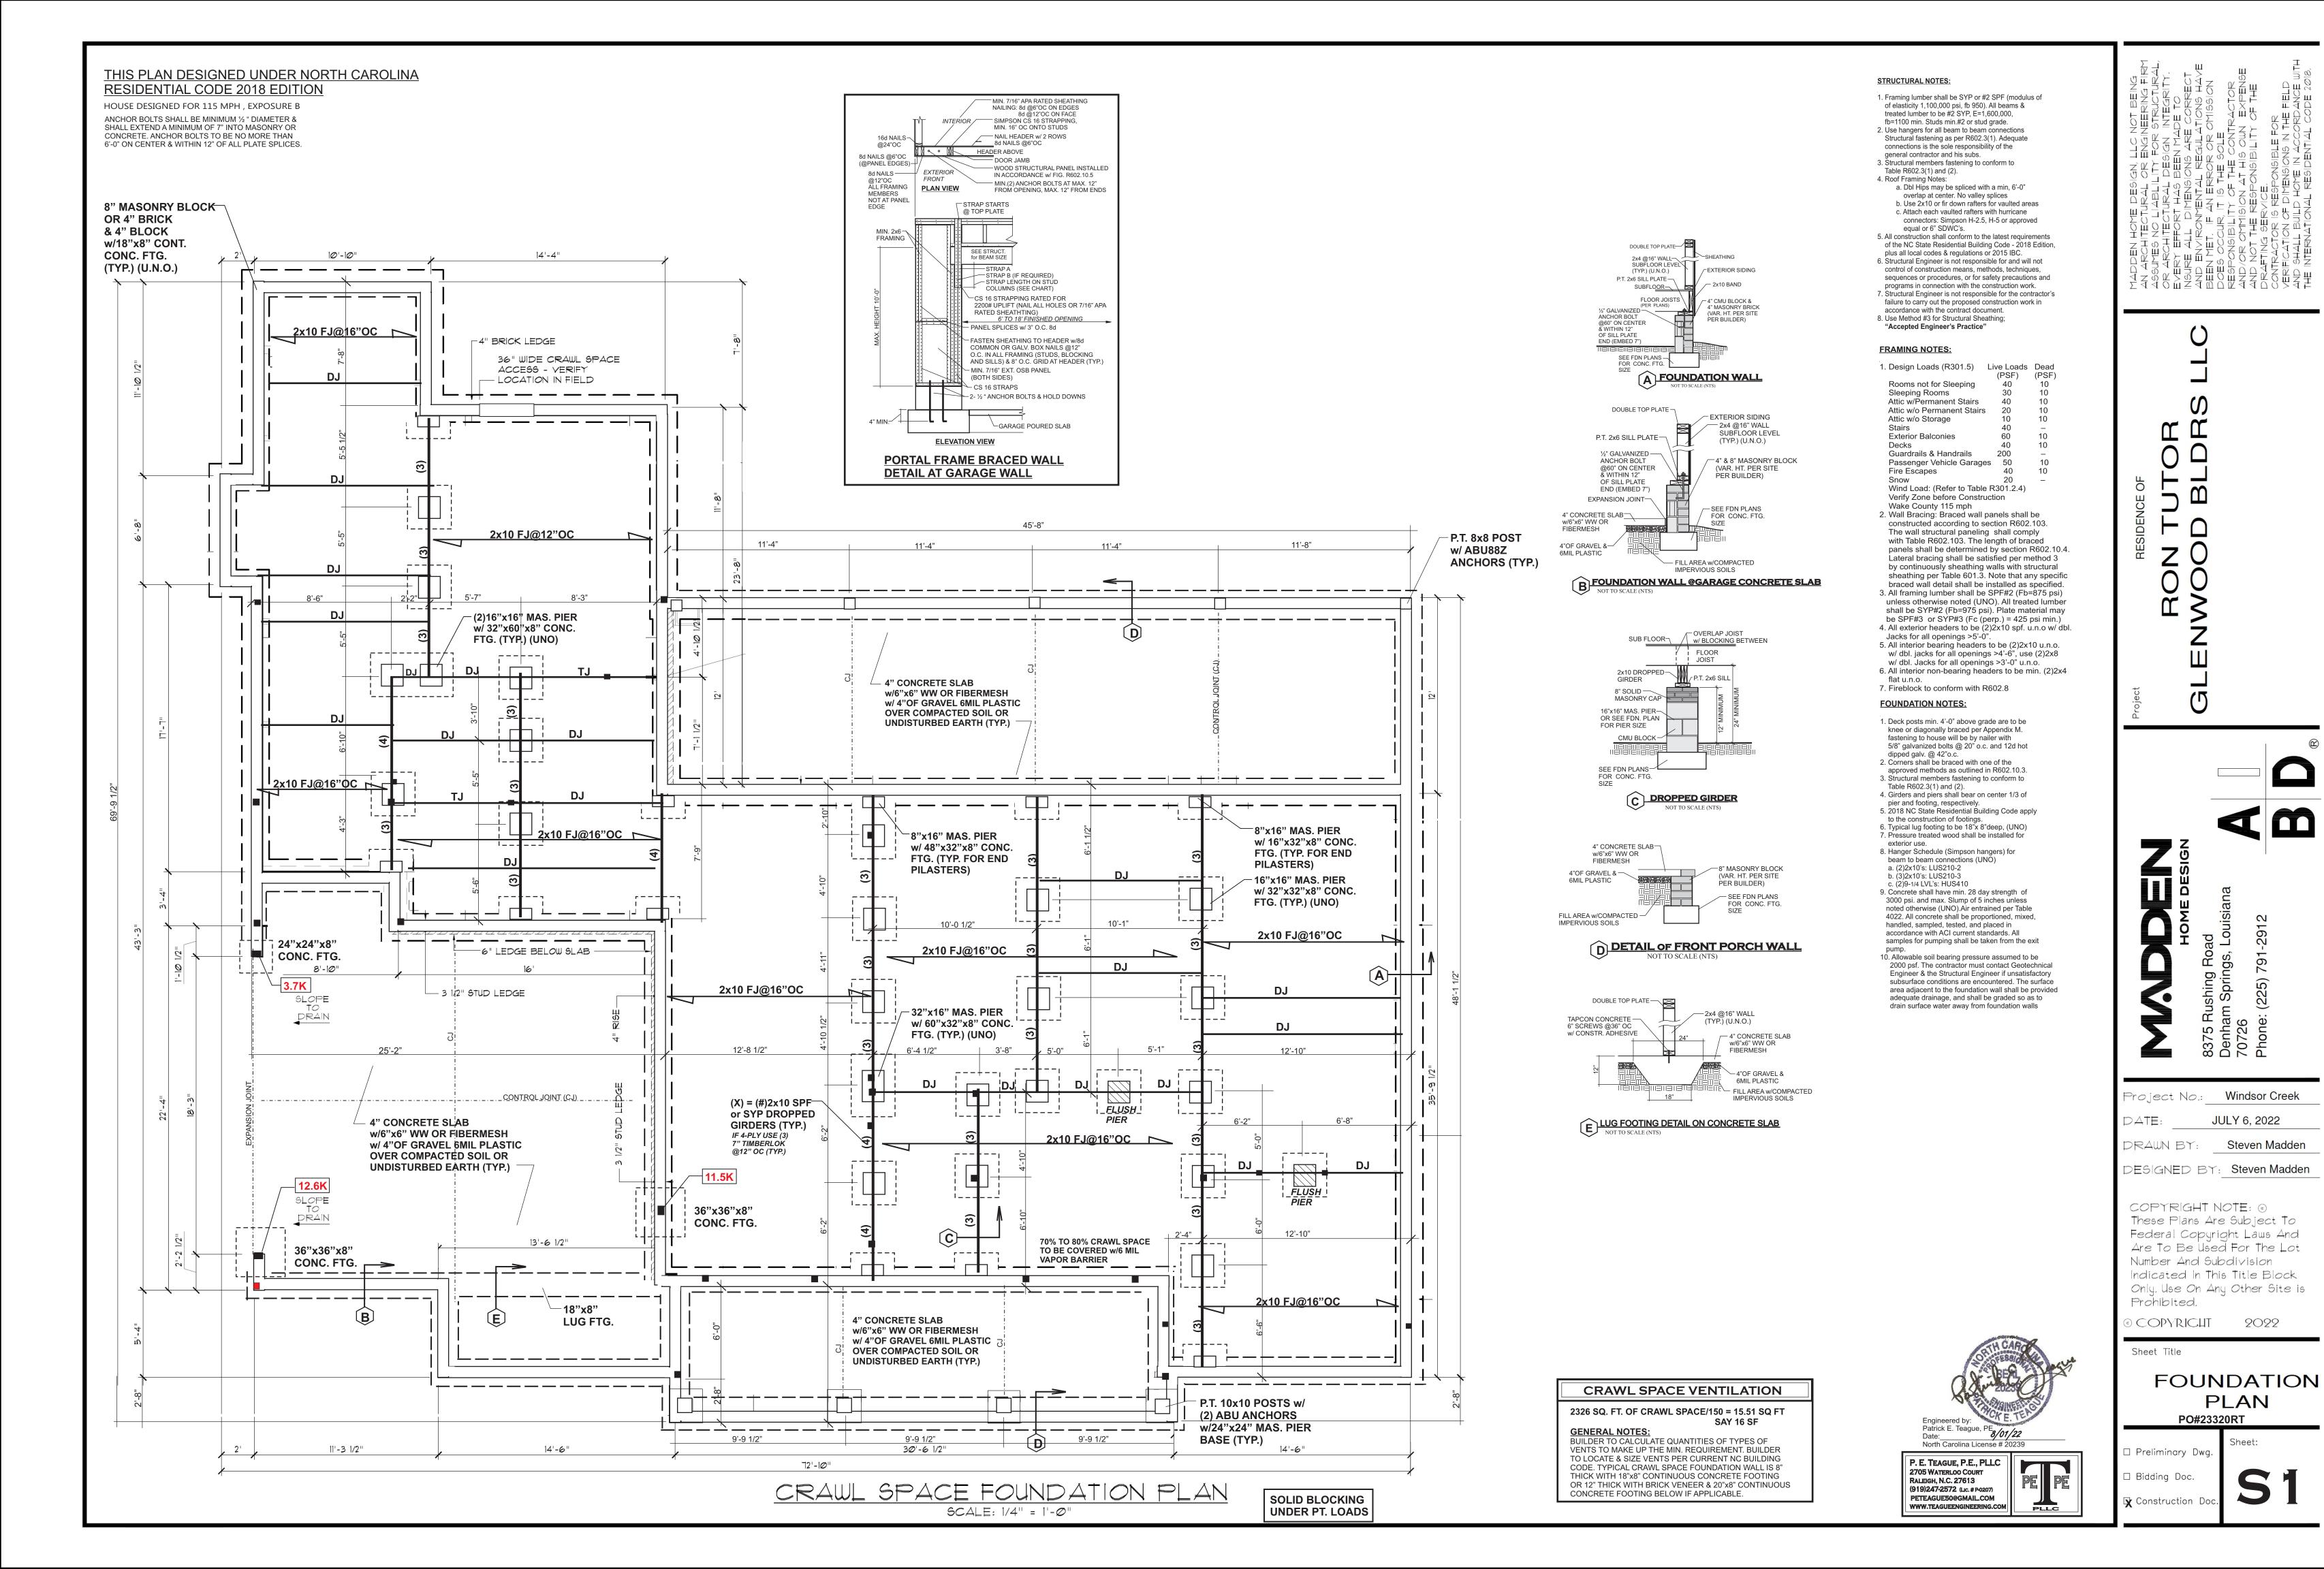

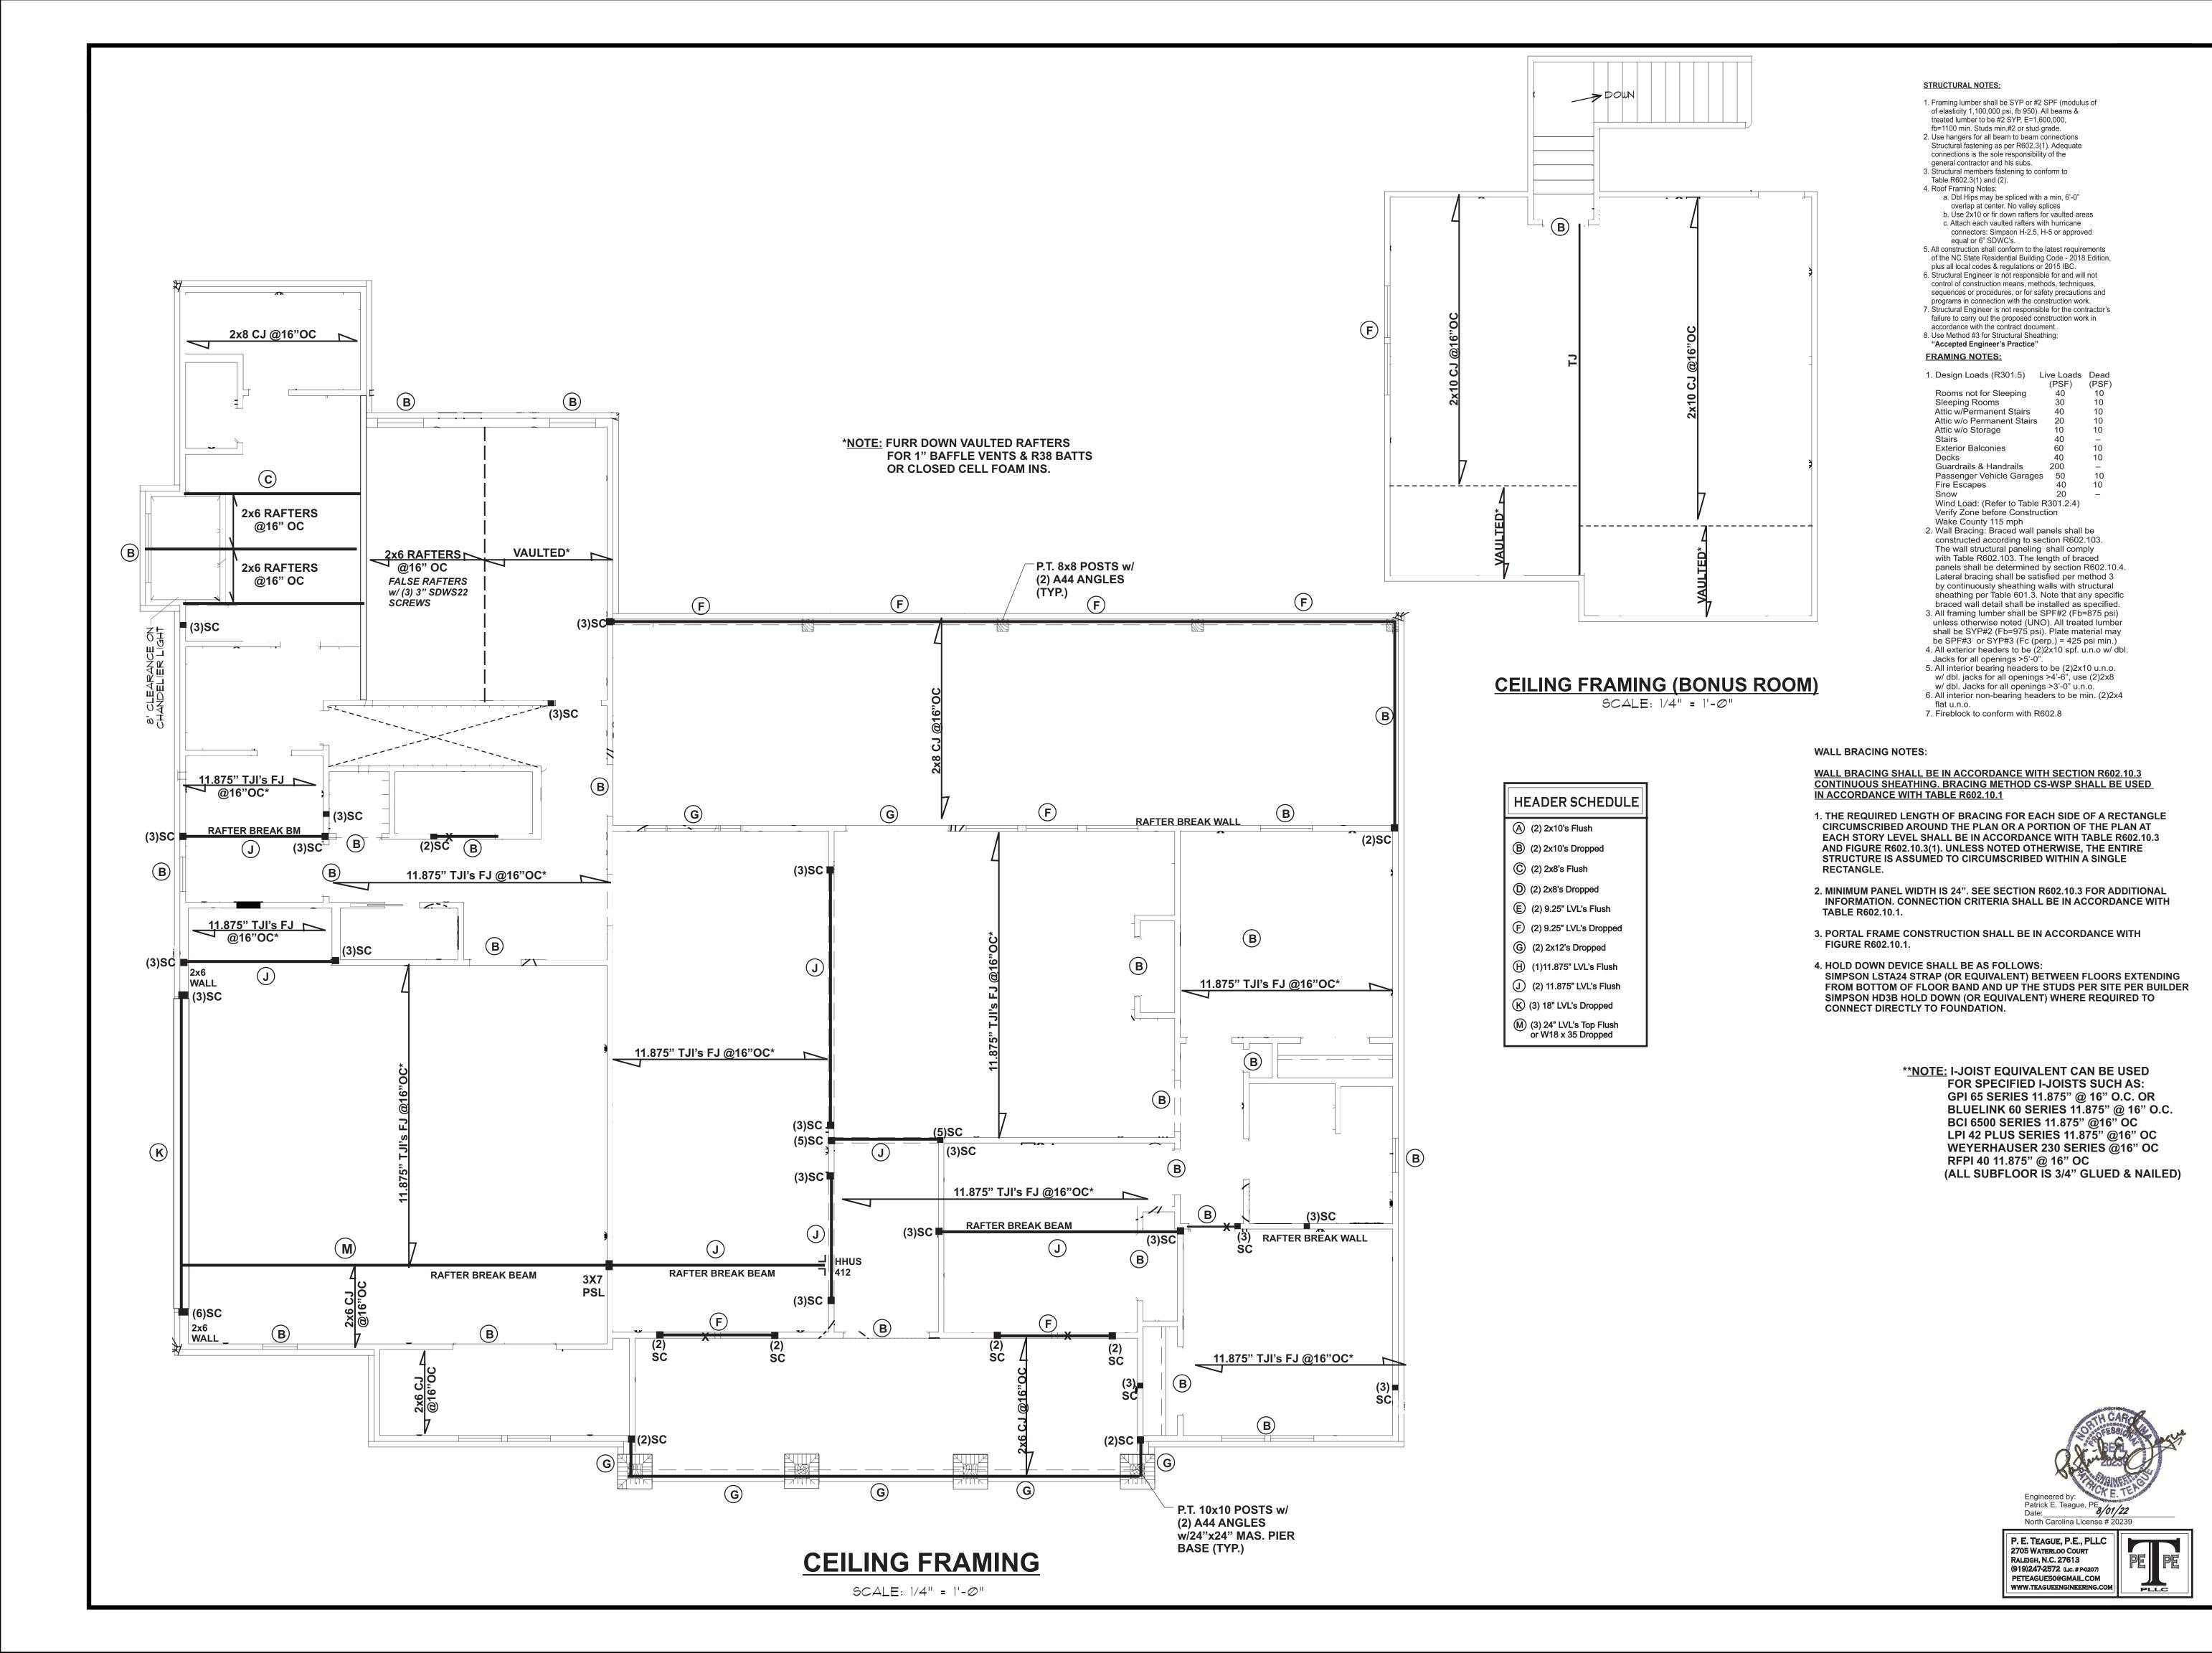

RON TUTOR NWOOD BLDRS LLC

Denham Springs, 70726 Phone: (225) 791

Project No.: Windsor Creek

JULY 6, 2022 Steven Madden

DESIGNED BY: Steven Madden

COPYRIGHT NOTE: ©
These Plans Are Subject To
Federal Copyright Laws And
Are To Be Used For The Lot
Number And Subdivision
Indicated In This Title Block
Only. Use On Any Other Site is
Prohibited.

Sheet Title

DATE:

COPYRIGHT 2022


CEILING FRAMING

PO#23320RT

□ Preliminary Dwg.

Construction D

Sheet:

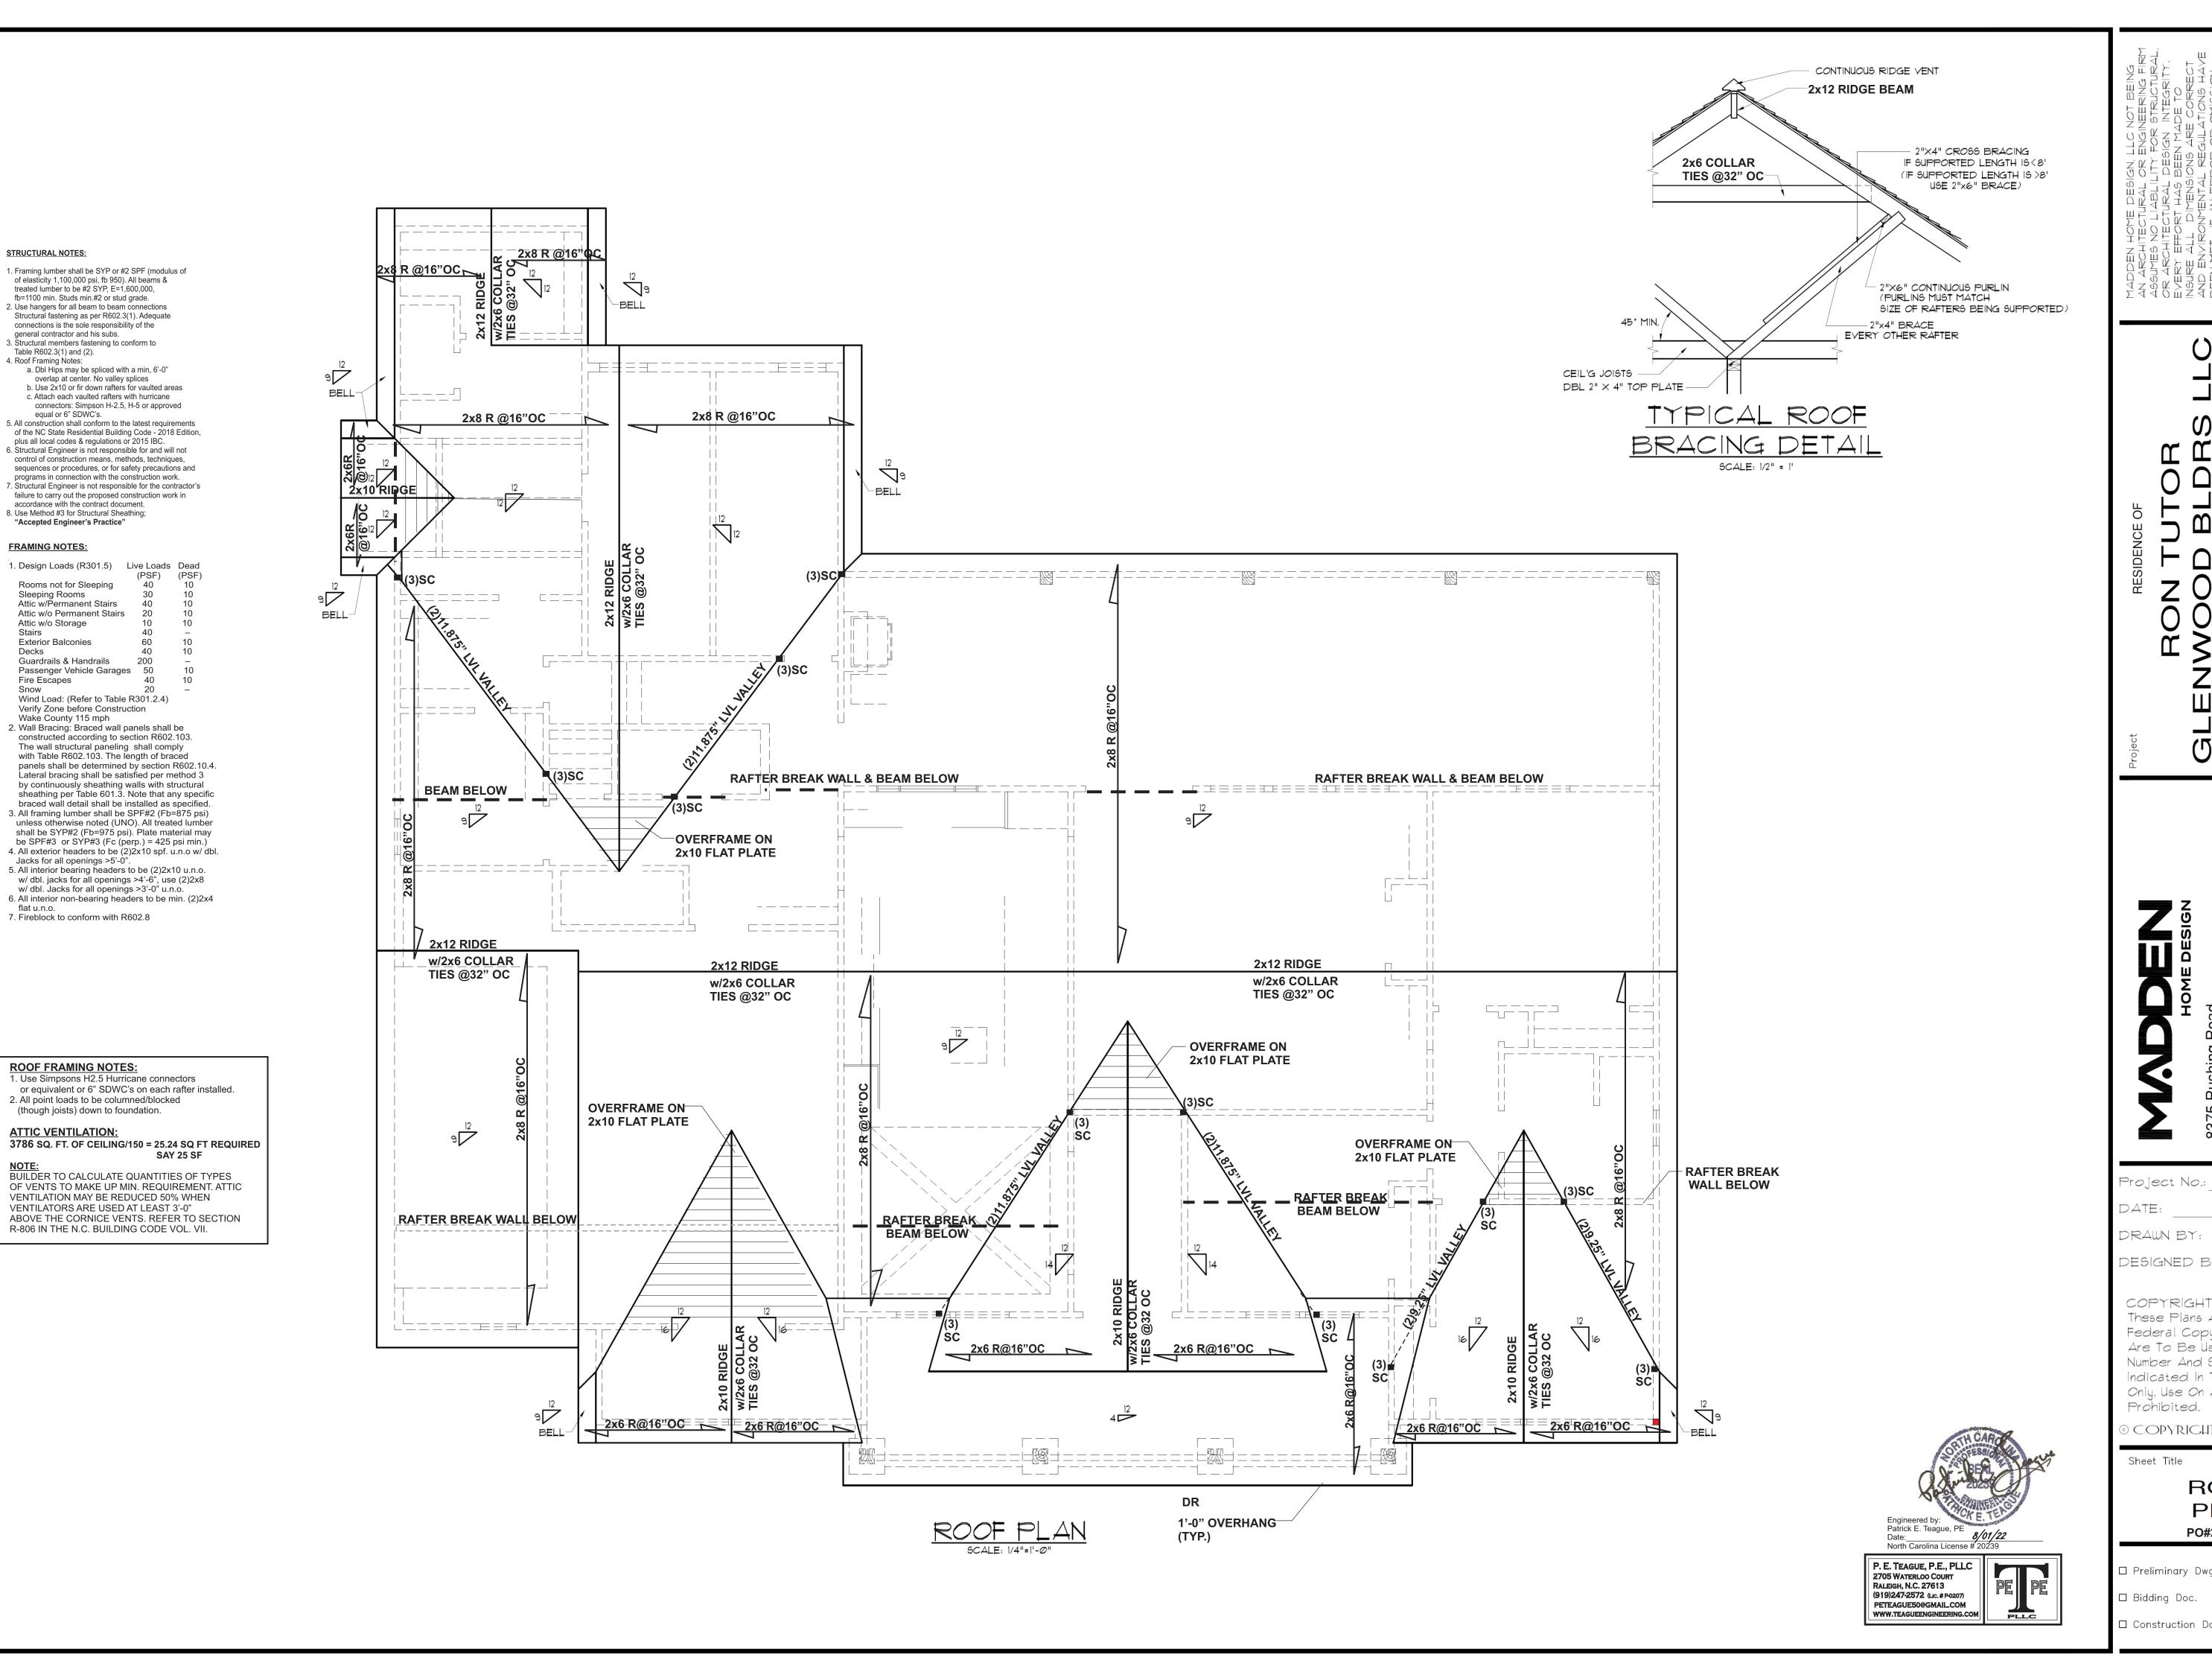

STRUCTURAL NOTES:

1. Framing lumber shall be SYP or #2 SPF (modulus of of elasticity 1,100,000 psi, fb 950). All beams &

treated lumber to be #2 SYP, E=1,600,000,

Structural fastening as per R602.3(1). Adequate

a. Dbl Hips may be spliced with a min, 6'-0"

overlap at center. No valley splices

plus all local codes & regulations or 2015 IBC. 6. Structural Engineer is not responsible for and will not control of construction means, methods, techniques,

accordance with the contract document. 8. Use Method #3 for Structural Sheathing; "Accepted Engineer's Practice"

FRAMING NOTES:

Attic w/o Storage Exterior Balconies

Fire Escapes

Rooms not for Sleeping Sleeping Rooms Attic w/Permanent Stairs Attic w/o Permanent Stairs

Guardrails & Handrails

Jacks for all openings >5'-0".

7. Fireblock to conform with R602.8

ROOF FRAMING NOTES:

ATTIC VENTILATION:

2. All point loads to be columned/blocked

VENTILATORS ARE USED AT LEAST 3'-0"

(though joists) down to foundation.

5. All interior bearing headers to be (2)2x10 ι

w/ dbl. Jacks for all openings >3'-0" u.n.o.

Passenger Vehicle Garages 50

Wind Load: (Refer to Table R301.2.4) Verify Zone before Construction Wake County 115 mph

 Wall Bracing: Braced wall panels shall be constructed according to section R602.103. The wall structural paneling shall comply with Table R602.103. The length of braced

programs in connection with the construction work.

failure to carry out the proposed construction work in

b. Use 2x10 or fir down rafters for vaulted areas

c. Attach each vaulted rafters with hurricane connectors: Simpson H-2.5, H-5 or approved

connections is the sole responsibility of the

general contractor and his subs. 3. Structural members fastening to conform to

equal or 6" SDWC's.

Table R602.3(1) and (2). 4. Roof Framing Notes:

fb=1100 min. Studs min.#2 or stud grade. 2. Use hangers for all beam to beam connections

Project No.: Windsor Creek JULY 6, 2022

Steven Madden DESIGNED BY: Steven Madden

COPYRIGHT NOTE: 0 These Plans Are Subject To Federal Copyright Laws And Are To Be Used For The Lot Number And Subdivision Indicated In This Title Block Only. Use On Any Other Site is Prohibited.

O COPYRICHT 2022

Sheet Title

ROOF PLAN PO#23320RT

☐ Preliminary Dwg. ☐ Bidding Doc.