

Items drawn on any drawings and not written in the contract selctions WILL NOT be included in the site specific drawings.

. XXX

2. XXX

3. XXX

4. XXX

Reason For Modification:

. XXX

2. XXX

3. XXX

4. XXX

Architecture Plan Review:

Customer Request:

. XXX

2. XXX

3. XXX

4. XXX

■ No Comments

☐ See Comments


Design Solution:

. XXX

2. XXX

3. XXX

4. XXX

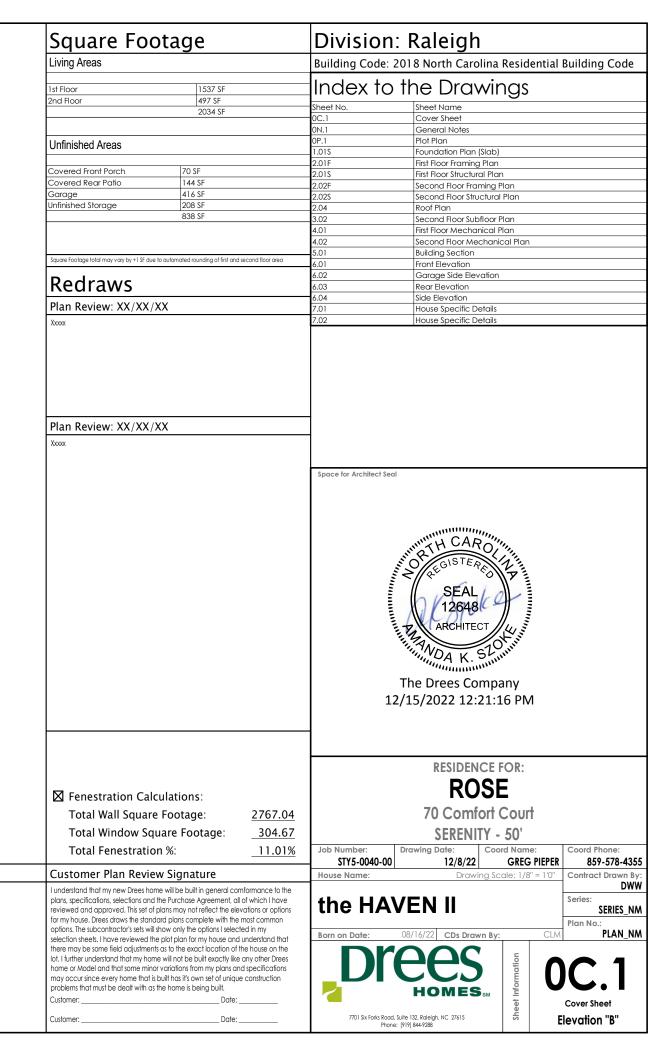

#### **GENERAL NOTES - RALEIGH** FOUNDATION NOTES CRAWL SPACES: **BASEMENTS:** SLOPE CONCRETE SLAB 4" MINIMUM TOWARDS GARAGE DOOR - SLOPE CONCRETE SLAB 4" MINIMUM TOWARDS GARAGE DOOR - EXTERIOR FLATWORK/GARAGES SHALL HAVE A MINIMUM CONCRETE SRENGTH OF 4,500 PSI - EXTERIOR FLATWORK/GARAGES SHALL HAVE A MINIMUM CONCRETE SRENGTH OF 4,500 PSI FOOTINGS TO A MINIMUM CONCRETE STRENGTH OF 2500 PSI, UNLESS OTHERWISE NOTED - FOOTINGS TO A MINIMUM CONCRETE STRENGTH OF 2500 PSI, UNLESS OTHERWISE NOTED- ALL FOUNDATION WALLS TO BE CAST IN PLACE CONCRETE 3000 PSI MIN, UNLESS OTHERWISE ASSUMED ALLOWABLE SOIL BEARING PRESSURE: 2 000 p s f WATERPROOF FOUNDATION WITH BITUMINOUS SPRAY. - BASEMENT WINDOW LOCATIONS MAY VARY FROM DRAWING DUE TO LOT CONDITIONS. WALL TIES EMBEDDED IN THE HORIZONTAL MORTAR JOINT SHALL BE 16" ON CENTER, TIES IN ALTERNATE COURSES SHALL BE STAGGERED. - BACKFILL ADJACENT TO FOUNDATION WALLS SHALL NOT BE PLACED UNTIL THE WALL HAS SUFFICIENT STRENGTH AND HAS BEEN ANCHORED TO THE FLOOR OR HAS BEEN SUFFICIENTLY THE MAXIMUM VERTICAL DISTANCE BETWEEN TIES SHALL NOT EXCEED 16" AND THE MAXIMUM HORIZONTAL DISTANCE SHALL NOT EXCEED BRACED TO PREVENT DAMAGE BY THE BACKFILL. - ASSUMED ALLOWABLE SOIL BEARING PRESSURE: 2,000 p.s.f. 16" ADDITIONAL TIES SHALL BE PROVIDED AT ALL OPENINGS, AND WITHIN 12" OF THE OPENING CORE FILL ENTIRE BLOCK WALL WHEN THE WALL IS 4'-0" TALL OR HIGHER. INSTALL #4 REBAR IN EACH HOLLOW AREA OF EACH BLOCK - WATERPROOF FOUNDATION WITH BITUMINOUS SPRAY. FROM FOOTING TO TOP OF WALL, ON THE ENTIRE WALL PRIOR TO CORE FILLING IT. - VERTICAL CONTROL JOINTS IN BASEMENT FOUNDATION WALLS - STANDARD LOCATION GUIDELINES: TOP COURSE OF BLOCK ON ALL WALLS WILL BE FILLED SOLID WITH MORTAR PLACING THE FOUNDATION STRAPS OR BOLTS IN THE MORTAR 1) PLACE A CONTROL JOINT IN ALL UNBRACED WALLS OVER 30' IN LENGTH. (NOTE: "T" WALLS AND CORNERS COUNT AS A BRACE). 2) WINDOWS THAT ARE LARGER THAN THE STANDARD BASEMENT WINDOW REQUIRE A CONTROL JOINT. 6'-0" ON CENTER, AND 12" FROM EACH CORNER 12"x16" PIERS: HOLLOW MASONRY UP TO 48" HIGH, SOLID MASONRY UP TO 9'0" HIGH 3) CONTROL JOINTS ARE NOT REQUIRED AT EVERY WINDOW THAT IS STANDARD SIZE 16"x16" PIERS: HOLLOW MASONRY UP TO 64" HIGH, SOLID MASONRY UP TO 12'0" HIGH 4) IF THERE IS A STANDARD WINDOW LOCATED IN A WALL SEGMENT THAT REQUIRES A CONTROL JOINT, THEN THE CONTROL JOINT SHOULD BE PLACED ON THE SIDE OF THE WINDOW - BLOCK PIERS SHOULD BE PLACED DIRECTLY ON CONCRETE FOOTINGS PER PLAN. THEY SHOULD BE PLUMBED AND SQUARE WITHIN 1/4". that is adjacent to the long side of the wall. If there is more than one window in a wall then only one window should have a control joint. - SILL PLATES TO BE A MINIMUM OF 2x4 NOMINAL LUMBER. 5) DOORS DO NOT GET CONTROL JOINTS. 6) CONTROL JOINTS SHOULD NOT BE LOCATED WITHIN 3' OF A BEAM POCKET.

DESIGN LOADS: FLOORS: 40 psf LIVE LOAD + 10 psf DEAD LOAD = 50 psf GARAGE FLOOR: 50 psf LIVE LOAD SEISMIC: "A" & "B" ROOF: 18 psf LIVE LOAD + 17psf DEAD LOAD = 35 psf WIND SPEED: 120 MPH DESIGN DEFLECTION LIMITS (BASED ON LIVE LOAD, EXCEPT MASONRY): RAFTERS GREATER THAN 3:12 L/180 **CEILINGS** L/240

MASONRY VENEER L/600

NOMINAL LUMBER FLOORS: L/360

MANUFACTURED WOOD FLOORS: DESIGNED TO MINIMUM PRO RATING OF 35 (OR EQUIVALENT). NO MORE THAN 8 POINT DIFFERENCE BETWEEN ADJACENT SPANS.

L/480 FOR SPANS UP TO 16'-0" AND NO GREATER THAN 1/2" DEFLECTION L/600 FOR SPANS OVER 16'-0" IF SIMPLE SPAN AND NO GREATER THAN 1/2" DEFLECTION L/840 FOR SPANS OVER 16'-0" IF CONTINUOUS SPAN. AND NO GREATER THAN 1/2" DEFLECTION

19.2" o.c. MAXIMUM SPACING JOIST SPACING:

FRAMING NOTES

DOUBLE EVERY OTHER FLOOR JOIST UNDER KITCHEN ISLANDS

INSTALL UNCOUPLING MEMBRANE IN TILE FLOOR AREAS IF 19.2" o.c. FLOOR JOIST SPACING

GLUE AND MECHANICALLY FASTEN [SCREWS] WOOD FLOOR IF 19.2" o.c. FLOOR JOIST SPACING MANUFACTURED WOOD PRODUCTS (INCLUDING, BUT NOT LIMITED TO, STRUCTURAL WOOD BEAMS AND I-JOISTS) SHALL BE FABRICATED.

HANDLED, AND INSTALLED IN ACCORDANCE WITH THE MANUFACTURER'S INSTRUCTIONS. -JOISTS ARE NOT TO BE PLACED DIRECTLY OVER INTERIOR PARALLEL WALLS. (TO PREVENT UNEVEN FLOOR DEFLECTION FROM OCCURRING)

ALL WOOD BEAMS/HEADERS: 2x6's TO BE SPF STUD GRADE OR BETTER/ 2x8 OR LARGER TO BE SYP #2 | PER NDS 2012 | OR BETTER, U.O.N.

ALL HEADERS SHALL BE SUPPORTED BY (1) 2x JACK STUD AND (1) 2x KING STUD MINIMUM. THE NUMBER OF STUDS SPECIFIED AT A SUPPORT INDICATES THE NUMBER OF JACKS REQUIRED, U.N.O. AT FLUSH OR DROPPED BEAMS, THE NUMBER OF STUDS SPECIFIED INDICATES THE TOTAL NUMBER OF STUDS REQUIRED TO SUPPORT THE BEAM

EXTERIOR WALLS TO BE 2x4 SPF STUD GRADE AT 16" O.C. UNLESS OTHERWISE NOTED (10'4-1/2" MAXIMUM WALL HEIGHT)

ALL INTERIOR BEARING WALLS AND WALLS AT BASEMENT & FIRST FLOOR STAIRWELLS, KITCHEN, BATH, & GARAGE TO BE 2x4 SPF STUD GRADE @ 16" o.c.; ALL OTHER NON-BEARING INTERIOR WALLS TO BE 2x4 SPF STUD GRADE @ 24" o.c. U.O.N.

ALL WALLS TO BE 3 1/2" UNLESS OTHERWISE NOTED.

PROVIDE SOLID BEARING TO FOUNDATION OR BEAM BELOW FOR ALL BEAMS, HEADERS & GIRDER TRUSSES. PROVIDE BLOCKING BETWEEN JOISTS AS REQUIRED.

SEE SELECTION SHEET FOR SIZE AND STYLE OF FIREPLACE. SEE FIREPLACE ELEVATION DETAIL FOR ADDITIONAL FRAMING REQUIREMENTS, IF ANY. CHECK SELECTION SHEETS FOR FLOOR COVERING AT TOP AND BOTTOM OF STAIR RISERS AND ADJUST RISERS AS REQ'D.

PROVIDE BLOCKING AT ALL HANDRAIL TERMINATION AND BRACKET LOCATIONS.

20-MINUTE FIRE RATED DOOR BETWEEN GARAGE AND LIVING AREA.

EXTERIOR WALL TO BE 2x4 SPF STUD G AT 16" o.c., UNLESS OTHERWISE NOTED (10'-0" MAXIMUM UNBRACED WALL HEIGHT).

ALL EXTERIOR WALLS AND INTERIOR BEARING WALLS, FRAMED HIGHER THAN THE STANDARD PLATE HEIGHT. SHALL BE FRAMED WITH CONTINUIOUS FULL HEIGHT STUDS TO THE HIGHEST CEILING (I.E. NO INTERMEDIATE BREAKS) TO PREVENT LATERAL HINGE CONDITIONS.

IN THE GARAGE, PROVIDE 1/2" GYP. BOARD AT ALL WALLS COMMON TO LIVING SPACE AND ALL STRUCTURAL MEMBERS SUPPORTING FLOOR/CEILING ASSEMBLY. GARAGE CEILING TO BE 1/2" SAG RESISTANT GYP. BOARD WHEN THERE ARE NO HABITABLE SPACES ABOVE, OR 5/8" TYPE X GYP. BOARD WHEN HABITABLE SPACES ARE ABOVE.

ALL EMERGENCY ESCAPE & RESCUE OPENINGS TO BE A MAXIMUM OF 44" OFF OF FINISHED FLOOR AND HAVE MINIMUM OPENING DIMENSIONS OF 24" IN HEIGHT, 20" IN WIDTH, & HAVE A MINIMUM OPENING AREA OF 5.7 S.F.

ALL DOORS TO BE 6'-8" TALL UNLESS OTHERWISE NOTED.

ALL GLASS IN INTERIOR AND EXTERIOR DOORS TO BE TEMPERED (INCLUDING SIDELITES AND TRANSOMS)

ALL LUMBER CONTACTING CONCRETE TO BE PRESSURE TREATED.

ALL FASTENERS, HANGERS, AND OTHER CONNECTORS TO BE USED WITH PRESSURE TREATED WOOD ARE TO HAVE ZMAX COATING (OR EQUIVALENT) HOT-DIPPED GALVANIZED OR STAINLESS STEEL.

AT STAIR HANDRAIL, ON ONE SIDE ONLY, SHALL BE CONTINUOUS FOR THE ENTIRE LENGTH OF THE STAIRWAY, AND ENDS SHALL BE RETURNED TO A WALL OR POST. THE HANDRAIL MAY BE INTERRUPTED AT A NEWEL POST AT A TURN.

ALL HANDRAIL GRIP PORTIONS SHALL NOT EXCEED 2-1/4" IN CROSS SECTIONAL DIMENSION.

HANDRAILS SHALL BE INSTALLED ON ALL STAIRS WITH 2 OR MORE RISERS, HANDRAIL HEIGHTS SHALL BE A MINIMUM OF 34" AND A MAXIMUM OF 38". ALL STAIRS TO BE CONSTRUCTED SO AS NOT TO ALLOW A 4" SPHERE TO PASS THROUGH THE RISER.

GUARDRAILS MUST BE A MINIMUM OF 36" HIGH. GUARDRAILS AT THE OPEN SIDES OF STAIRS MUST BE A MINIMUM OF 34" HIGH MEASURED VERTICALLY

FROM THE NOSING AT THE TREADS. THE HORIZONTAL SPACING OF THE VERTICAL BALUSTERS SHALL BE 4" O.C.

- GUARDRAIL DESIGN TO RESIST A MINIMUM OF 200 LBS LATERAL FORCE

7) CONTROL JOINTS ARE REQUIRED AT THE FIRST AND LAST STEP DOWN AT STEPPED BASEMENT FOUNDATION WALLS.

- INTERIOR FLATWORK SHALL HAVE A MINIMUM CONCRETE STRENGTH OF 3,000 PSI.

- ALL VERTICAL STEEL AND ALL STEEL IN STRUCTURAL SLABS TO BE GRADE 60. ALL HORIZONTAL STEEL IN FOUNDATION WALLS AND FOOTERS TO BE GRADE 40 STEEL

#### MECHANICAL/ELECTRICAL NOTES

- ANY GAS APPLIANCES MUST BE INSTALLED PER MANUFACTURER'S SPECIFICATIONS. - HOLD THE CENTERLINE OF ALL EXTERIOR LIGHT FIXTURES AT 5'-8" OFF BOTTOM OF DOOR OPENING.

- ALL KITCHEN CABINET DIMENSIONS ARE CABINET TO CABINET

- CABINET STYLES MAY VARY FROM INTERIOR ELEVATIONS DEPENDING ON STYLE, MANUFACTURER, ETC. FOR CABINET

DETAILS SEE SHOP DRAWINGS.

- CABINET SIZES MAY VARY WITH FULL-OVERLAY CABINETS.

- GROUND FAULT INTERRUPTER (GFCI) OUTLETS TO BE INSTALLED PER NEC 2017, SECT. 210.8

- PROVIDE HOSE BIBS PER DIVISION SPEC. SHEET. EXACT LOCATION TO BE FIELD DETERMINED UNLESS OTHERWISE NOTED

R-38 BLOWN

ON THE PLANS.

- MIN. 50 C.F.M. FOR ALL EXHAUST FANS IN BATHROOMS

#### INSULATION DETAILS

EXTERIOR STUD WALL CAVITY: R-15 FLOOR JOIST CAVITY AT STANDARD PERIMETER: R-19 FLOOR JOIST CAVITY AT CANTILEVER: R-19

(OVER HORIZONTAL SPACE) OVER GARAGE: (SLOPED AND VERTICAL SPACE) R-38 BATT

#### FI EVATION NOTES

WINDOW STYLE AND MULLIONS MAY VARY FROM ELEVATION DEPENDING UPON MANUFACTURER. STYLE, PATTERN, TYPE,

- USE SECONDARY HEAT BARRIER ON ALL DIRECT VENT FIREPLACES 7' OR LESS ABOVE A WALKWAY. - GRADE AWAY FROM FOUNDATION WALLS SHALL FALL A MINIMUM OF 6" WITHIN THE FIRST 10'.

- PROVIDE TYVEK OR EQUIVALENT HOUSE WRAP BEHIND BRICK AND STONE VENEER OVER WOOD SHEATHING.

PROVIDE BRICK WEEP HOLES AT 24" O.C. WITH BRICK VENEER AND MORTER NET BEHIND AND THROUGH WEEP HOLES.

- PROVIDE FLASHING AND WEEP HOLES ABOVE ALL BRICK ANGLE IRONS, BELOW ALL BRICK SILLS AND ABOVE SILL PLATE

- EXTERIOR STEPS TO HAVE A MAXIMUM 8" RISER. WHEN VERTICAL RISE EXCEEDS 30" OR FOUR OR MORE CONTINUOUS RISERS, A HANDRAIL IS REQUIRED

#### **ROOF PLAN NOTES**

- ALL OVERHANGS TO HAVE (2) SOFFIT VENTS PER EACH 8' SOFFIT SECTION.

- PROVIDE BAFFLES AT EXTERIOR TRUSS BEARING FOR VENTILATION.

PROVIDE 15# FELT PAPER LINDER SHINGLES

Space for Architect Seal



12/15/2022 12:21:16 PM

**RESIDENCE FOR:** 

**ROSE** 

70 Comfort Court SERENITY - 50

Job Number Drawina Date STY5-0040-00 12/8/22

7701 Six Forks Road, Suite 132, Raleigh, NC 27615 Phone: [919] 844-9288

**GREG PIEPER** House Name:

the HAVEN II

CDs Drawn Bv

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Elevation "B"

Series

Plan No


859-578-4355


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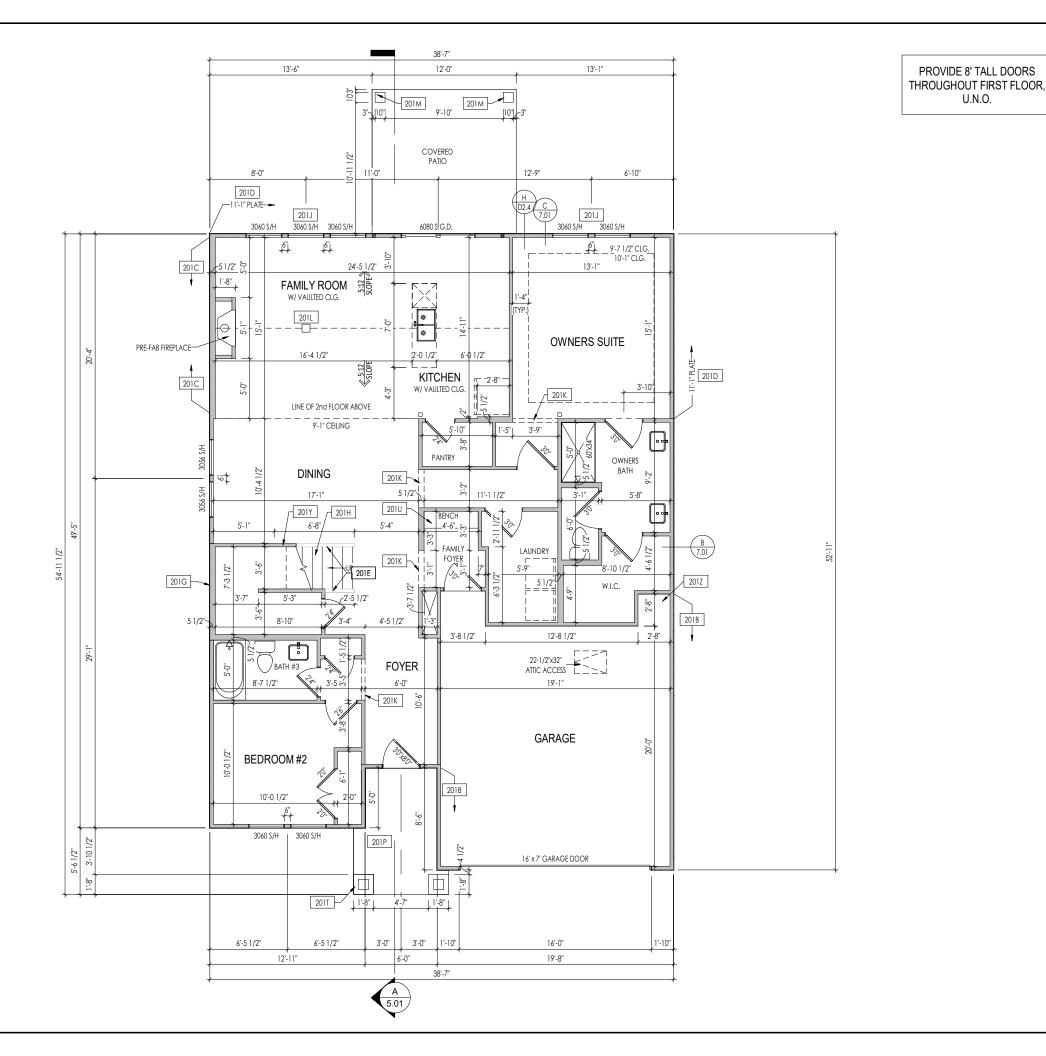
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PLAN NM

Contract Drawn B





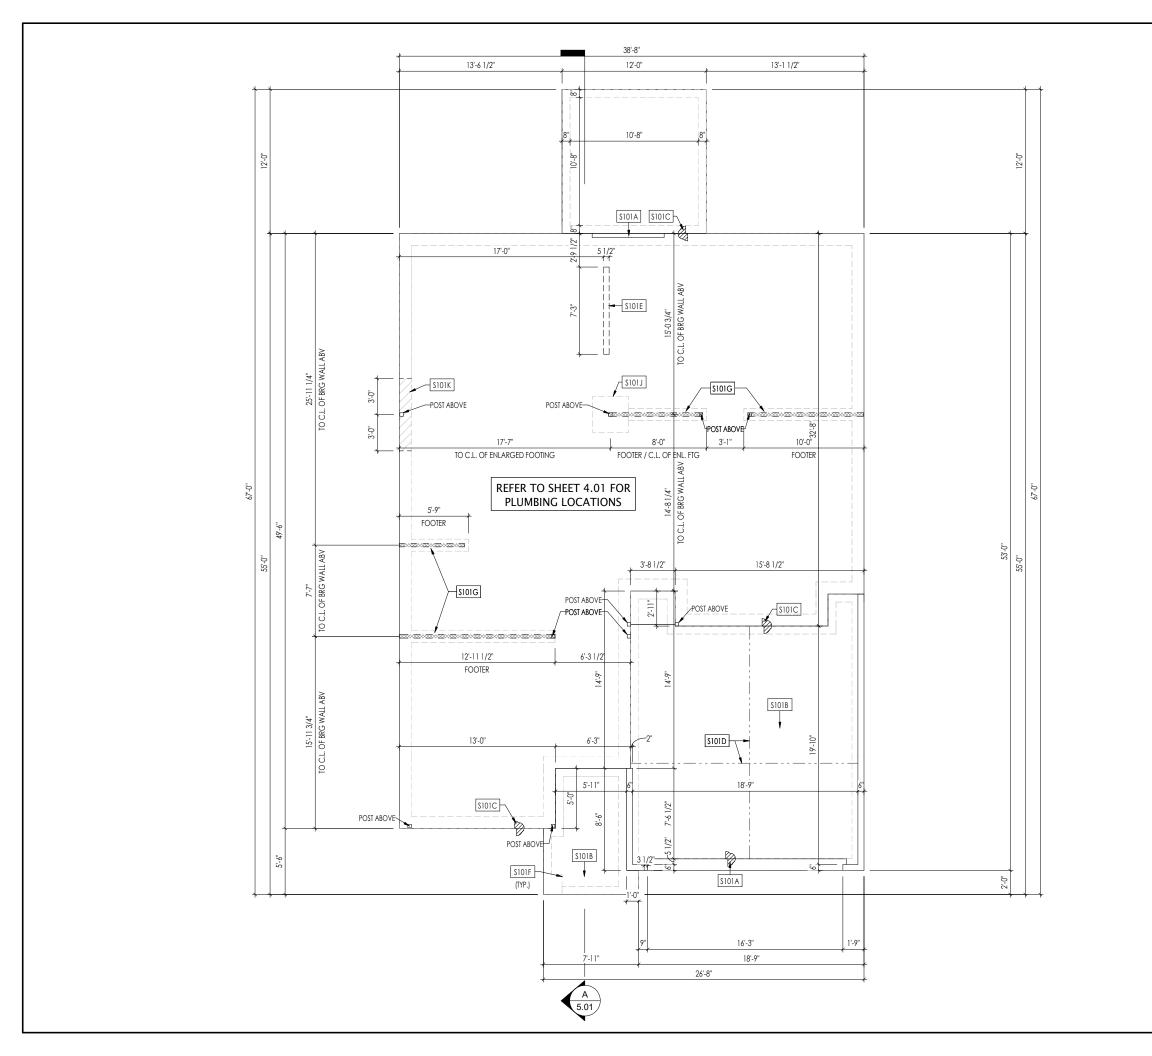

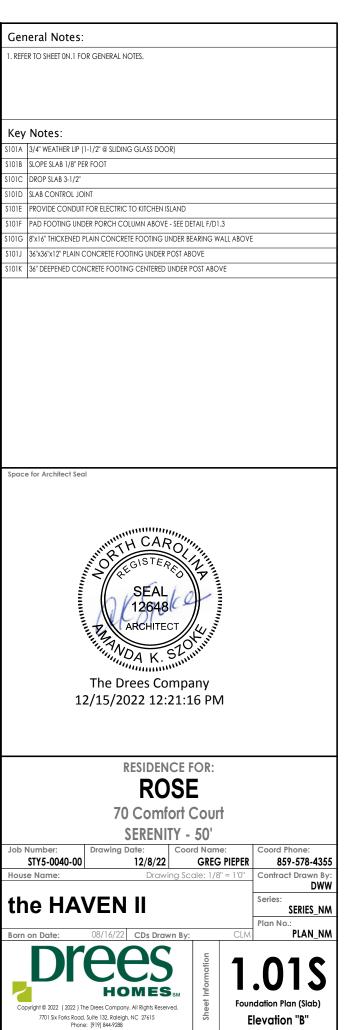- . REFER TO SHEET ON.1 FOR GENERAL NOTES.
- 2. ALL FIRST FLOOR CEILINGS TO BE 10"-1" ABOVE SUBFLOOR UNLESS OTHERWISE NOTED.

  3. FRAME TOP OF ALL WINDOWS AT 1"-10" BELOW TOP OF PLATE UNLESS OTHERWISE NOTED.
- . ALL DROPPED, INTERIOR HEADERS (FALSE AND BEARING) ARE DROPPED 1'-3" FROM CEILING.
- S. REFER TO SELECTION SHEETS FOR FLOORING MATERIAL PRIOR TO CONSTRUCTING STAIRS TO DETERMINE
- 6. REFER TO SHEET 2.01S FOR STRUCTURAL INFORMATION.
- 7. ALL FIRST FLOOR EXTERIOR WALLS AND INTERIOR BEARING WALLS TO BE FRAMED AT 10'-1" HIGH WITH 2x4

#### Key Notes:

U.N.O.

- 201B FRAME GARAGE WALLS AT 10'-1" HIGH FROM TOP OF FOUNDATION WALL
- 201C 2x6 BALLOON FRAMED WALL TO UNDERSIDE OF SCISSOR TRUSS SEE SHEET 2.01S FOR MORE INFO
- 201D FRAME 11'-1" HIGH WALLS W/ (2)2x4 STUDS @ 16" O.C.
- 201E 36" HIGH WALL SLOPED WITH STAIR STRINGER
- 101G 2x6 BALLOON FRAMED WALL AT STAIRS SEE SHEET 2.01S FOR MORE INFO
- 201H SEE DETAIL F/7.01 FOR STAIR FRAMING DETAILS
- 201J FRAME TOP OF WINDOW AT TO 2'-10" BELOW TOP PLATE
- 201K FRAME TOP OF OPENING AT HEIGHT SPECIFIED IN GENERAL NOTES ON THIS SHEET
- FRAME 7-1/4"W x 8"L DROPPED CLG. AT PEAK OF VAULT FOR ELECT. FIXTURE
- 01M 10"x10" BOX COLUMN SEE DETAIL K/7.01
- CARPENTER TO DROP ELECTRICAL WIRE THROUGH PORCH CEILING FOR LIGHTS
- SEE DETAIL G/7.01 FOR PORCH COLUMN FRAMING INFO
- BENCH SEE DETAIL F/D2.2
- APPROX. LOCATION OF 36" HIGH WALL UNDER STAIRS (FIELD VERIFY)
- 201Z 18" HIGH WATER HEATER PLATFORM

Space for Architect Seal



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**RESIDENCE FOR:** 

# **ROSE**

70 Comfort Court SERENITY - 50'

Job Number: STY5-0040-00 12/8/22 **GREG PIEPER** 859-578-4355


### the HAVEN II

SERIES\_NM PLAN NM

**HOMES**<sub>SM</sub>

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Elevation "B"

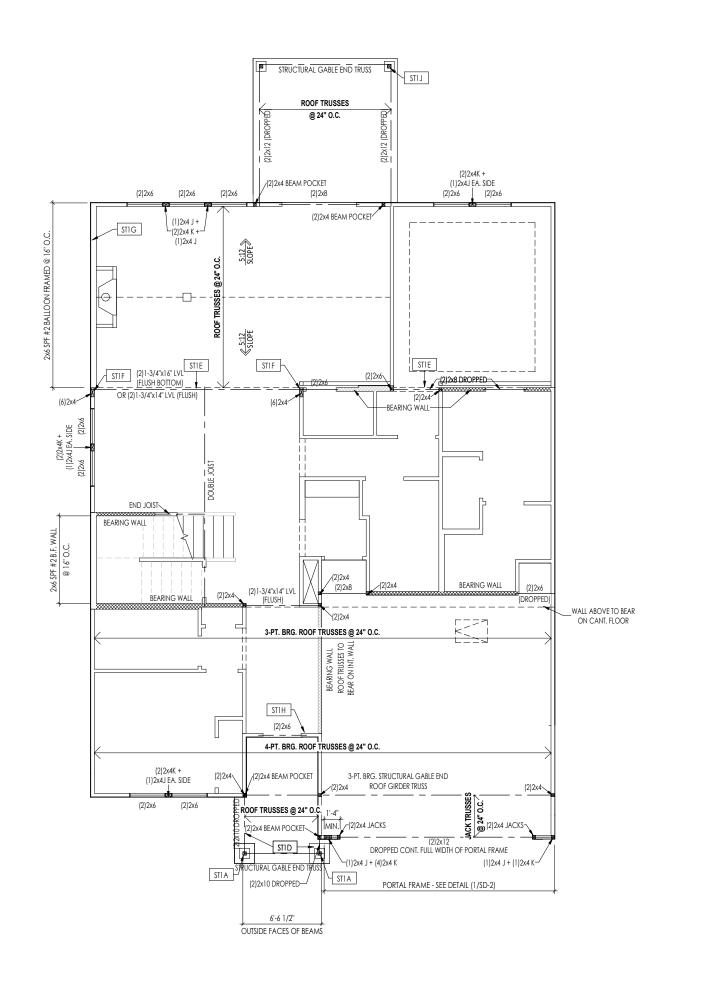

1. REFER TO SHEET ON.1 FOR GENERAL NOTES.

#### Key Notes:

STIA 4x4 P.T. WOOD POST WITH SIMPSON ABW44Z POST BASE AND SIMPSON BCS2-2/4 CAP (TYP.)

STID FRAME TOP OF BEAM AT 10'-1" ABOVE FIRST FLOOR SUBFLOOR/SLAB

STIE OUTLINE OF SECOND FLOOR ABOVE

STIF BEAM TO BEAR DIRECTLY ON POSTS

STIG GABLE END TRUSS PROFILE TO MATCH VAULTED CEILING PROFILE, BALLOON FRAME TO UNDERSIDE OF

SCISSOR TRUSS

STIH TRUSSES TO BEAR ON EXTERIOR WALL

STIJ 4x4 P.T. POST w/ SIMPSON BCS2-2/4 CAP AND BASE (TYP. 2)

Space for Architect Seal



The Drees Company 12/15/2022 12:21:17 PM

RESIDENCE FOR:

# ROSE

70 Comfort Court SERENITY - 50'

### the HAVEN II


08/16/22 CDs Drawn By:

Series:
SERIES\_NM
Plan No.:
PLAN NM

**Drees** 

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Phone: [1919 84-9288

2.01 Sirst Floor Structural Place Elevation "B"

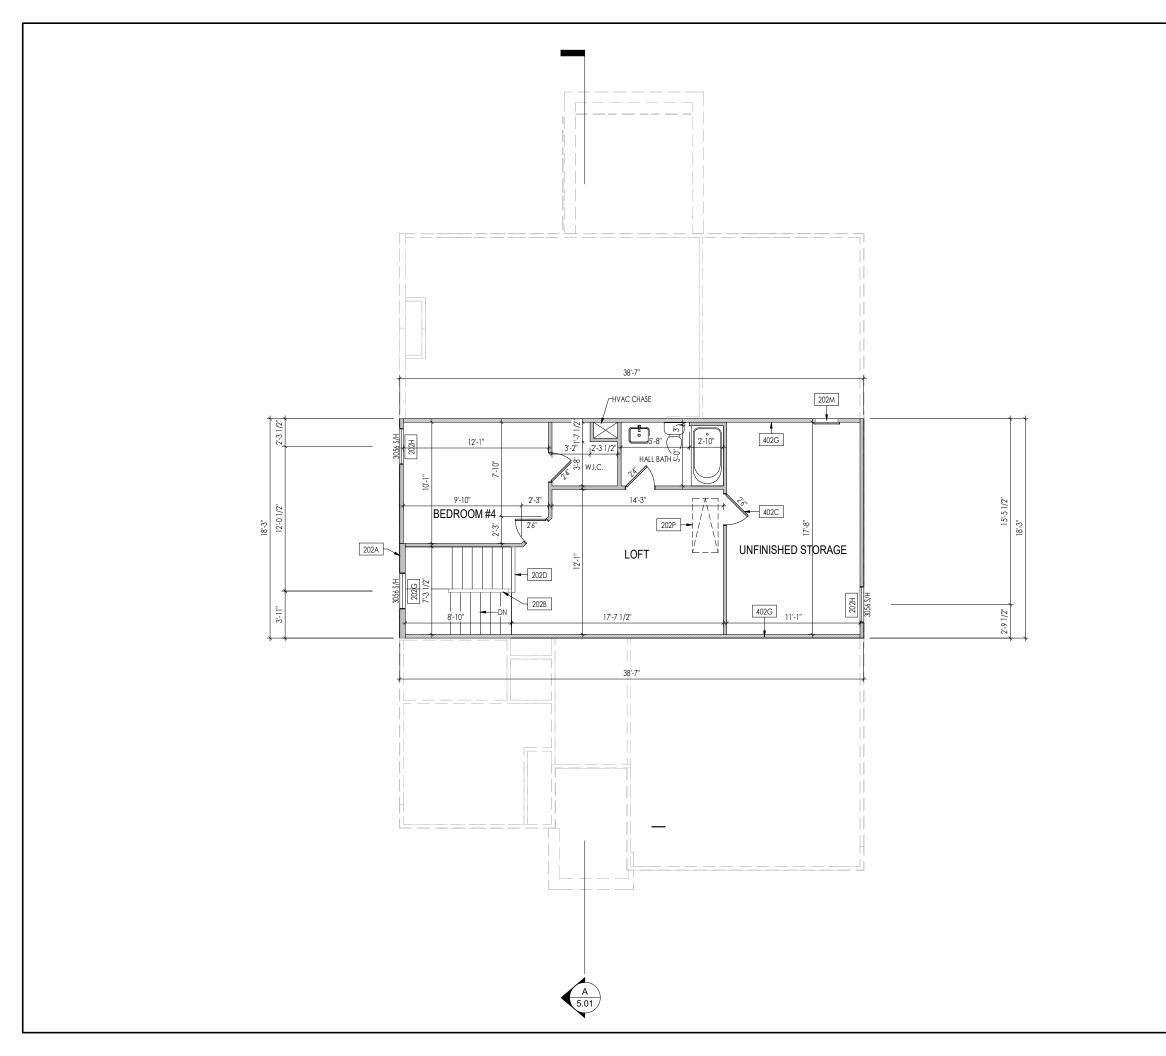

- . REFER TO SHEET ON.1 FOR GENERAL NOTES.
- 1. ACE AND SHEED WITH TO A GENERAL MOTES.
  2. ALL SECOND FLOOR CEILINGS TO BE 9'-1" ABOVE SUBFLOOR UNLESS OTHERWISE NOTED.
  3. FRAME TOP OF ALL WINDOWS AT 1'-0 1/4" BELOW TOP OF PLATE UNLESS OTHERWISE NOTED.
  4. ALL DROPPED, INTERIOR HEADERS (FALSE AND BEARING) ARE DROPPED 1'-0" FROM CEILING.
- 5. REFER TO SELECTION SHEETS FOR FLOORING MATERIAL PRIOR TO CONSTRUCTING STAIRS TO DETERMINE
- RISER HEIGHTS.

  6. REFER TO SHEET 2.02S FOR STRUCTURAL INFORMATION.

#### Key Notes:

- 202A 2x6 BALLOON FRAMED WALL AT STAIRS SEE SHEET 2.02S FOR MORE INFO
- 202B 36" HIGH WALL SLOPED WITH STAIR STRINGER
- 202D 36" HIGH WALL
- 202G FRAME TOP OF WINDOW AT TO 3'-0 1/4" BELOW TOP PLATE
- 202H FRAME TOP OF WINDOWS AT 0'6-1/2" BELOW TOP OF PLATE
- 202M SEE DETAIL N/D2.1 FOR WALL ATTIC ACCESS DETAILS
- 202P PULL DOWN ATTIC ACCESS STAIRS (25-1/2" x 54") WITH LIGHT AND OUTLET

Space for Architect Seal



The Drees Company 12/15/2022 12:21:17 PM

RESIDENCE FOR:

### **ROSE**

70 Comfort Court SERENITY - 50'

Coord Name: Job Number: 12/8/22 STY5-0040-00

House Name:

**GREG PIEPER** 


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Elevation "B"

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1. REFER TO SHEET ON.1 FOR GENERAL NOTES.

#### Key Notes:

ST2F PROVIDE CONTINUOUS FULL HEIGHT SHEATHING DOWN TO SECOND FLOOR SOLE PLATE

# CONNECTION SPECIFICATIONS (TYP. U.N.O.) NOTE: 10d NAIL = 3"x 0.131" GUN NAIL

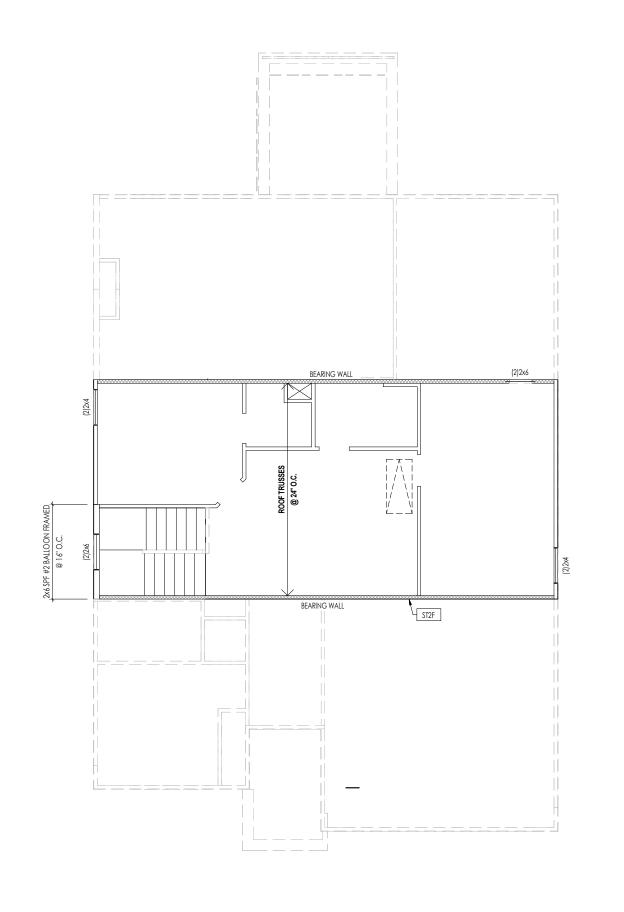(3) 10d TOENAILS OLE PLATE TO JOIST/BLK'G. 10d NAILS @ 6" o.c. TUD TO SOLE PLATE (3) 10d TOENAILS OP OR SOLE PLATE TO STUD M TO TOP PLATE 10d TOENAILS @ 6" o.c. LK'G. BTWN. JOISTS TO TOP PL (3) 10d TOENAILS (3)10d TOENAILS + (1) SIMPSON H2.5A AFTER/TRUSS TO TOP PLATE GAB. END TRUSS TO DBL. TOP PL 10d TOENAILS @ 8" o.c. 2x10 BLK EVERY 3RD BAY FASTENED TO DBL. TOP PLATE w/ 10d TOENAILS @ 6" O.C. R.T. w/ HEEL HT. 9 1/4" TO 12" 2x12 BLK EVERY 3RD BAY FASTENED TO DBL. TOP PLATE w/ 10d TOENAILS @ 6" O.C. .T. w/ HEEL HT. 12" TO 16" LAP WALL SHTG. w/ DBL. TOP PL. & INSTALL ON TRUSS VERT. FASTEN w/ 8d NAILS @ 6" O.C. R.T. w/ HEEL HT. UP TO 24" LAP WALL SHTG. W/ DBL. TOP PL. & INSTALL ON TRUSS VERT. -FASTEN W/ 8d NAILS @ 6" O.C. PROVIDE 2x BLK @ EA. BAY AT TOP OF HEEL R.T. w/ HEEL HT. 24" TO 48" 10d NAILS @ 24" o.c. OUBLE STUD OUBLE TOP PLATE 10d NAILS @ 24" o.c. OUBLE TOP PLATE LAP SPLICE (10)10d NAILS IN LAPPED AREA TOP PLATE LAP @ CORNERS & INTERSECTING WALLS (2)10d NAILS WALL SHTG. LAP w/ SILL PL. & FASTENED PER SHEAR WALL FASTENING SPEC. WALL TO FOUNDATION

Space for Architect Seal



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RESIDENCE FOR:

# **ROSE**

70 Comfort Court SERENITY - 50'

Job Number:	Drawing Date:	Coord Name:	Coord Phone:
STY5-0040-00	12/8/22	GREG PIEPER	859-578-4355
House Name:	Drawi	ng Scale: 1/8" = 1'0"	Contract Drawn By
			DUM

### the HAVEN II

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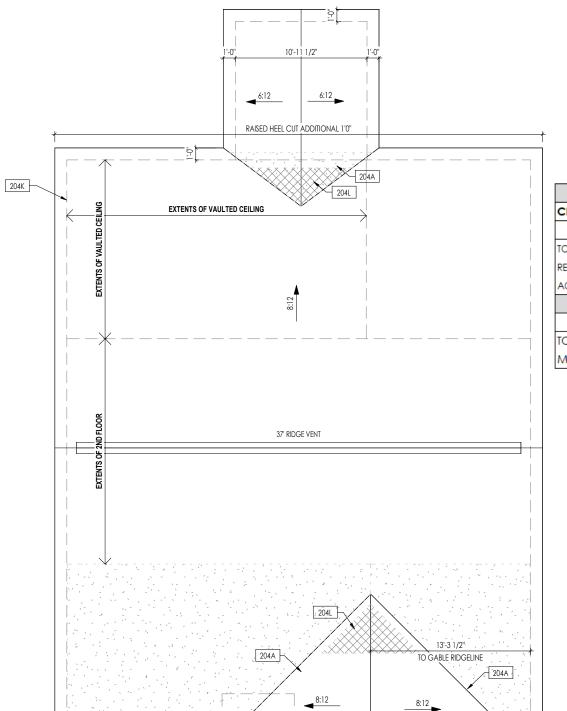
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Plan No.:
PLAN NM

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1'-7 3/4"


AŤ PORĆH

1'-7 3/4"

AT PORCH

	HEEL CUT STANDARDS						
		OVERH	HANG				
		1'-0"	2'-0"				
	4:12	3-3/4"	7-3/4"				
	5:12	4-3/4"	9-3/4"				
	6:12	5-3/4"	11-3/4"				
F	7:12	6-3/4"	13-3/4"				
ROOF PITCH	8:12	7-3/4"	N/A				
8	9:12	8-3/4"	N/A				
œ	10:12	9-3/4"	N/A				
	12:12	11-3/4"	N/A				
	14:12	13-3/4"	N/A				

ROOF VENTILATION	
CITY/SERIES:	RALEIGH
	MAIN HOUSE
TOTAL ATTIC AREA:	2,352
REQUIRED NET FREE VENTILATION (ATTIC AREA/300):	7.84
ACTUAL NET FREE VENTILATION (UPPER + LOWER):	7.88
DOWNSPOUT CALCULATION	
	MAIN HOUSE
TOTAL DRAINABLE ROOF AREA:	3057.6
MINIMUM # OF DOWNSPOUTS:	6

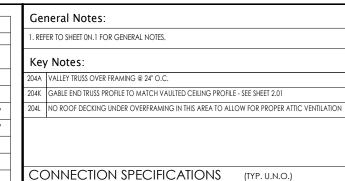

	,
NOTE	: 10d NAIL = 3" x 0.131" GUN NAIL
JOIST TO SOLE PLATE	(3)10d TOENAILS
SOLE PLATE TO JOIST/BLK'G.	10d NAILS @ 6" o.c.
STUD TO SOLE PLATE	(3) 10d TOENAILS
TOP OR SOLE PLATE TO STUD	(3) 10d NAILS
RIM TO TOP PLATE	10d TOENAILS @ 6" o.c.
BLK'G. BTWN. JOISTS TO TOP PL.	(3)10d TOENAILS
RAFTER/TRUSS TO TOP PLATE	(3)10d TOENAILS + (1) SIMPSON H2.5A
GAB. END TRUSS TO DBL. TOP PL.	10d TOENAILS @ 8" o.c.
R.T. w/ HEEL HT. 9 1/4" TO 12"	2x10 BLK EVERY 3RD BAY FASTENED TO DBL. TOP PLATE W/ 10d TOENAILS @ 6" O.C.
R.T. w/ HEEL HT. 12" TO 16"	2x12 BLK EVERY 3RD BAY FASTENED TO DBL, TOP PLATE W/ 10d TOENAILS @ 6" O.C.
R.T. w/ HEEL HT. UP TO 24"	LAP WALL SHTG. W/ DBL. TOP PL. & INSTALL ON TRUSS VERT FASTEN W/ 8d NAILS @ 6" O.C.
R.T. w/ HEEL HT. 24" TO 48"	LAP WALL SHTG. W/ DBL. TOP PL. & INSTALL ON TRUSS VERT FASTEN W/ 8d NAILS @ 6" O.C. PROVIDE 2x BLK @ EA. BAY AT TOP OF HEEL
DOUBLE STUD	10d NAILS @ 24" o.c.
DOUBLE TOP PLATE	10d NAILS @ 24" o.c.
DOUBLE TOP PLATE LAP SPLICE	(10)10d NAILS IN LAPPED AREA
TOP PLATE LAP @ CORNERS & INTERSECTING WALLS	(2)10d NAILS
WALL TO FOUNDATION	WALL SHTG. LAP w/ SILL PL. & FASTENED PER SHEAR WALL FASTENING SPEC.

Space for Architect Seal



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RESIDENCE FOR:

# **ROSE**

70 Comfort Court SERENITY - 50'

Coord Name: Job Number: Drawing Date: 12/8/22 GREG PIEPER 859-578-4355 STY5-0040-00 House Name:

the HAVEN II


SERIES\_NM

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Elevation "B"

PLAN\_NM

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- 1. REFER TO SHEET ON.1 FOR GENERAL NOTES.
- 2. FLOOR JOISTS TO BE 14" TJI 210 SERIES I-JOISTS, OR EQUAL, @ 19.2" O.C., UNLESS OTHERWISE NOTED.
- 3. JOISTS ARE NOT TO BE PLACE DIRECTLY OVER INTERIOR PARALLEL WALL.
- (TO PREVENT UNEVEN FLOOR DEFLECTION FROM OCCURRING)

  4. ADD'L JOISTS MAY BE LOCATED UP TO 2" AWAY FROM THE PARTITION WALL ABOVE IN CASES WHERE MECHANICAL PENETRATIONS
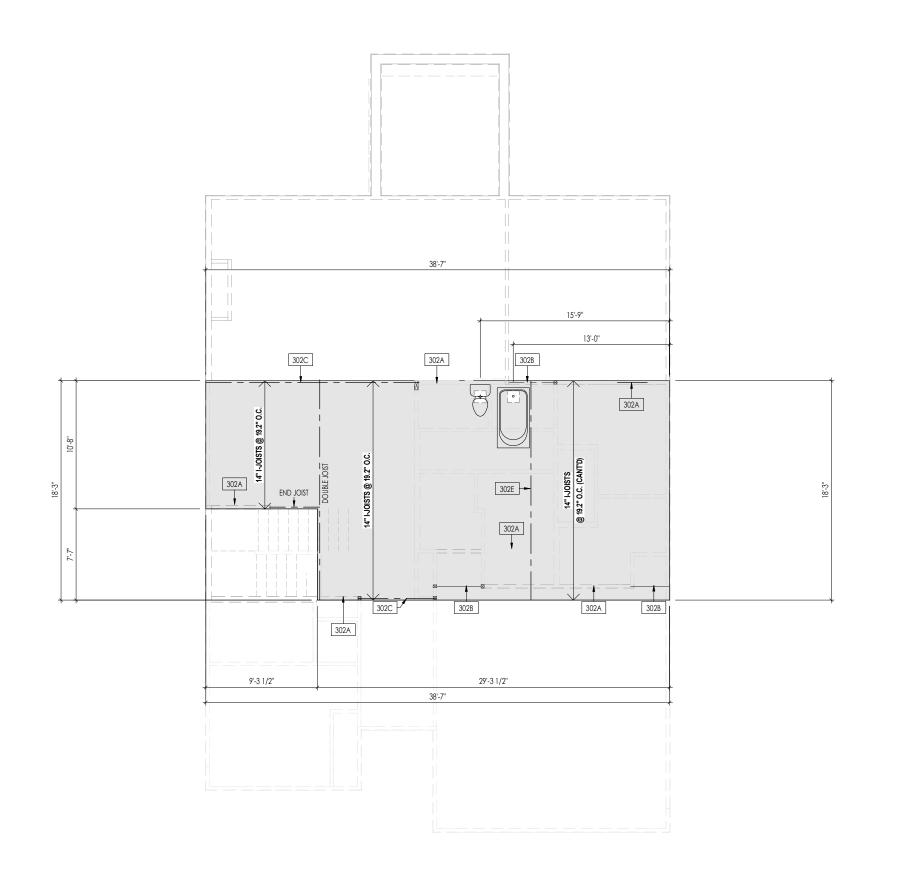
#### Key Notes:

302A BEARING WALL BELOW

302B BEAM BELOW - SEE SHEET 2.01S FOR MORE INFO

302C FLUSH BEAM - SEE SHEET 2.01S FOR MORE INFO

302E ADDITIONAL JOIST UNDER PARTITION ABOVE

Space for Architect Seal



The Drees Company 12/15/2022 12:21:17 PM

RESIDENCE FOR:

# **ROSE**

70 Comfort Court

SERENITY - 50'

Drawing Date: Coord Name:

 STY5-0040-00
 12/8/22
 GREG PIEPER

 House Name:
 Drawing Scale: 1/8" = 1'0"

the HAVEN II

Series: SERIES\_NM

859-578-4355

Plan No.:


ate: 08/16/22 CDs Drawn By: CLM PLAN\_NM



Job Number:

Second Floor

Second Floor Subfloor Pla Elevation "B"

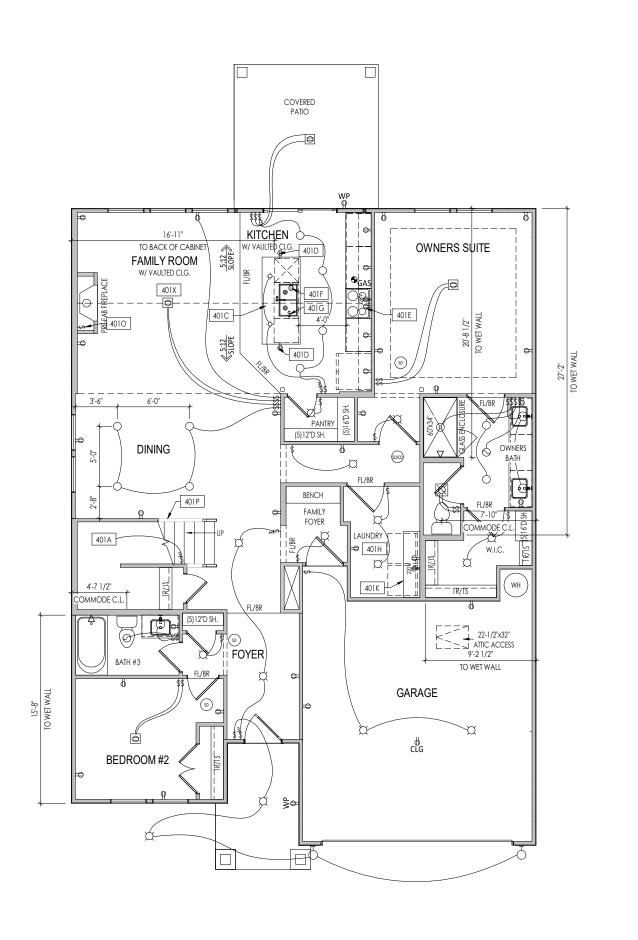

PROVIDE 8' TALL DOORS THROUGHOUT FIRST FLOOR, U.N.O.

### General Notes: . REFER TO SHEET ON.1 FOR GENERAL NOTES. Key Notes: 401A TO SWITCH OR LIGHT ABOVE 401C SEE DETAIL A/7.01 FOR KITCHEN ISLAND COUNTERTOP DIMENSIONS 401D HOLD OUTLET HIGH ON ISLAND 401E OUTLET FOR RANGE HOOD/MICROWAVE HELD HIGH, VENT TO EXTERIOR OUTLET FOR DISHWASHER LOCATED IN SINK CABINET PUSH BUTTON FOR GARBAGE DISPOSAL OR SWITCH LOCATED IN SINK CABINET - REFER TO SELECTIONS LOCATE WASHER TO LEFT OF DRYER 16" DEEP x 5'-6" LONG SHELF HELD AT 5'-7" A.F.F. 401P 36"H. WALL W/ WOOD CAP 401X BOX FOR ELECTRICAL FIXTURE - SEE SHEET 2.01F FOR FRAMING INFORMATION MECHANICAL LEGEND ■ PHONE JACK ⇒ WALL OUTLET CLG. MOUNTED LIGHT FIXT. STAIR LIGHT + HOSE BIB ₩EATHERPROOF GFCI OUTLET SHOWER HEAD № 220 VOLT OUTLET → WALL MOUNTED LIGHT FIXT. GAS GAS HOOK UP - DOUBLE SPOTLIGHT FIXT. ⊕ FLOOR DRAIN 8 ← GFCI OUTLET FLOOR OUTLET DIRECTIONAL CAN LIGHT SD SMOKE DETECTOR (TV) CABLE TELEVISION JACK ( PIN LIGHT © CO DETECTOR SMOKE DETECTOR/ CO DETECTOR COMBINATION ← SINGLE POLE SWITCH ₩ WALL SCONCE @ 5'-6" A.F.F. ⇔ 3-WAY SWITCH FLUORESCENT LIGHT UNDER CABINET LIGHTING EXHAUST FAN AND LIGHT COMBINATION BLOCK, MOUNT, & SWITCH FOR FUTURE FAN/LIGHT COMBINATION (CENTER, UNLESS OTHERWISE NOTED) O CLG. MTD. EXHAUST FAN Space for Architect Seal The Drees Company 12/15/2022 12:21:17 PM **RESIDENCE FOR: ROSE** 70 Comfort Court SERENITY - 50' Coord Name Job Number: Drawing Date: 859-578-4355 STY5-0040-00 12/8/22 **GREG PIEPER** House Name: DWW

SERIES\_NM o.: PLAN NM


Elevation "B"

the HAVEN II

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08/16/22 CDs Drawn By

**HOMES**<sub>SM</sub>



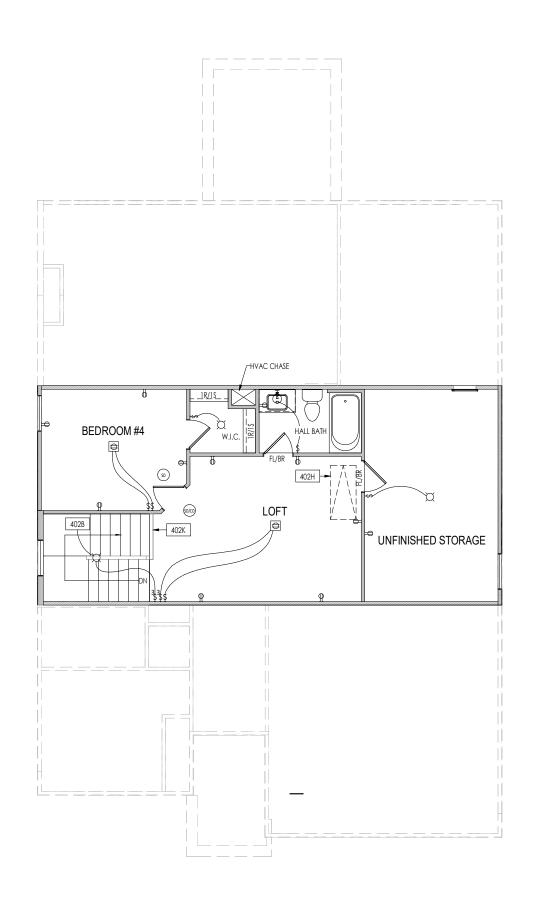



12/15/2022 12:21:17 PM

RESIDENCE FOR:

# **ROSE**

70 Comfort Court SERENITY - 50'

Coord Name: Job Number: Drawing Date: **GREG PIEPER** 859-578-4355 STY5-0040-00 12/8/22 House Name: DWW

### the HAVEN II

08/16/22 **CDs Drawn By:** 

SERIES\_NM PLAN NM

**HOMES**<sub>SM</sub>


Elevation "B"

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BUILDING SECTION THRU FOYER

1/8" = 1'-0"



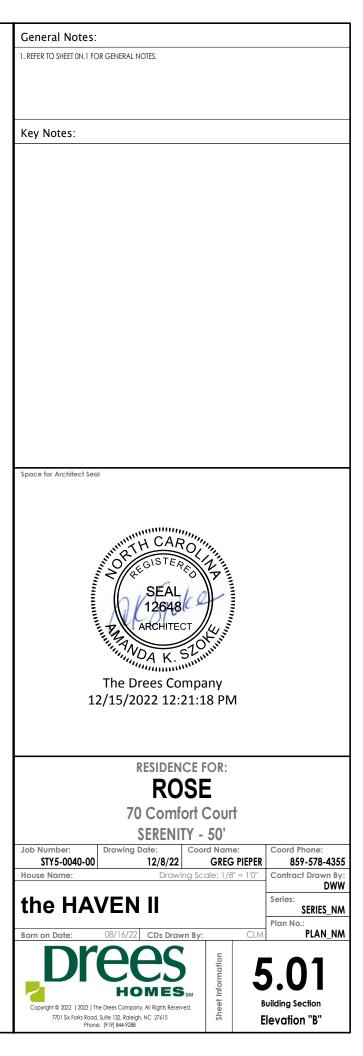

**ELEVATION'B'** 

### TYPICAL TRIM:

### 6" FASCIA (ALL SIDES)

8" FRIEZE (FRONT ONLY, UNLESS OTHERWISE NOTED)

#### General Notes:

- . REFER TO SHEET ON.1 FOR GENERAL NOTES.
- 2. ROOFING MATERIAL PER SELECTIONS.
  3. CONTACT M&K ENGINEERING FOR HEADER SIZE/BRICK SUPPORT IF GRADE DROPS AND THE AMOUNT OF BRICK OVER GARAGE DOOR SHOWN ON CURRENT ELEVATION IS NO LONGER ACCURATE

Key Notes:

#### BRICK and STONE LINTEL SCHEDULE WINDOW 36" HIGH LINTEL SIZE ABOVE Up to 6'-0" L3 1/2 x 3 1/2 x 1/4 Up to 8'-3" ----L5 x 3 1/2 x 5/16 Up to 9'-3" L6 x 4 x 3/16 L7 x 4 x 3/8 Up to 16'-3" \*\*per Design L7 x 4 x 3/8 L8 x 4 x 1/2 L8 x 4 x 1/2 Up to 6'-0" ----L4 x 3 1/2 x 1/4 Up to 8'-3" ----L5 x 3 1/2 x 5/14 Up to 9'-3" \*\*per Design L6 x 4 x 3/8 L7 x 4 x 3/8 Up to 16'-3" \*\*per Design \*\*per Design L8 x 4 x 1/2

All Lintels: 4" Minimum bearing required each end

\* Brick is based on 40psf and Stone is based on 60psf

\*\* Any lintels not described by the above parameters shall be specifically designed.

Space for Architect Seal



The Drees Company 12/15/2022 12:21:18 PM

RESIDENCE FOR:

### **ROSE**

70 Comfort Court SERENITY - 50'

Job Number: Drawing Date **GREG PIEPER** 859-578-4355 STY5-0040-00 12/8/22 House Name: DWW

### the HAVEN II

SERIES\_NM Plan No. PLAN NM

CDs Drawn Bv



Elevation "B"

	TYPICAL TRIM:
	6" FASCIA (ALL SIDES)
	8" FRIEZE (FRONT ONLY, UNLESS OTHERWISE NO
4" TRIM————————————————————————————————————	
12 8	
	٦
-4" CORNER TRIM	
2'-0" HORIZONTAL SIDING	1

NOTED)

- REFER TO SHEET ON.1 FOR GENERAL NOTES.
   ROOFING MATERIAL PER SELECTIONS.
   REFER TO LINTEL SCHEDULE AS NEEDED ON SHEET 6.01.

Key Notes:

Space for Architect Seal



The Drees Company 12/15/2022 12:21:18 PM

RESIDENCE FOR:

# **ROSE**

70 Comfort Court

SERENITY - 50' Coord Name: Drawing Date:

Job Number: 12/8/22 GREG PIEPER STY5-0040-00 House Name: Drawing Scale: 1/8" = 1'0" Contract Drawn By:

the HAVEN II

SERIES\_NM

Plan No.: PLAN\_NM 08/16/22 **CDs Drawn By:** 

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**Garage Side Elevation** Elevation "B"

859-578-4355

DWW

4" TRIM		4" CORNER TRIM
	8" TRIM KICKPLATE	

### TYPICAL TRIM:

## 6" FASCIA (ALL SIDES)

**8" FRIEZE** (FRONT ONLY, UNLESS OTHERWISE NOTED)

### General Notes:

- 1. REFER TO SHEET ON.1 FOR GENERAL NOTES. 2. ROOFING MATERIAL PER SELECTIONS. 3. REFER TO LINTEL SCHEDULE AS NEEDED ON SHEET 6.01.

### Key Notes:

Space for Architect Seal



The Drees Company 12/15/2022 12:21:18 PM

RESIDENCE FOR:

# **ROSE**

70 Comfort Court SERENITY - 50'

Coord Name: Job Number: Drawing Date: STY5-0040-00

GREG PIEPER 12/8/22 Drawing Scale: 1/8" = 1'0" Contract Drawn By: House Name:

the HAVEN II

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Plan No.: PLAN\_NM

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Elevation "B"



Space for Architect Seal



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RESIDENCE FOR:

# **ROSE**

70 Comfort Court SERENITY - 50'

Coord Name: Drawing Date:

12/8/22 GREG PIEPER STY5-0040-00


the HAVEN II


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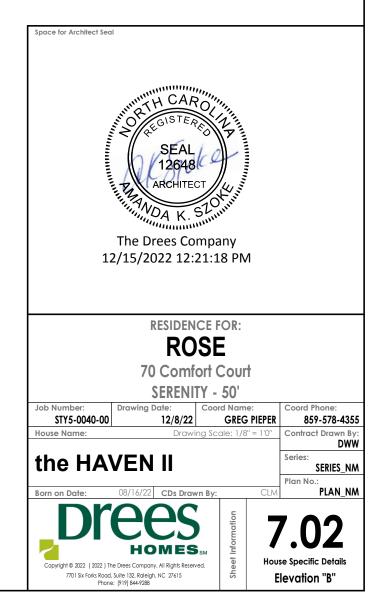
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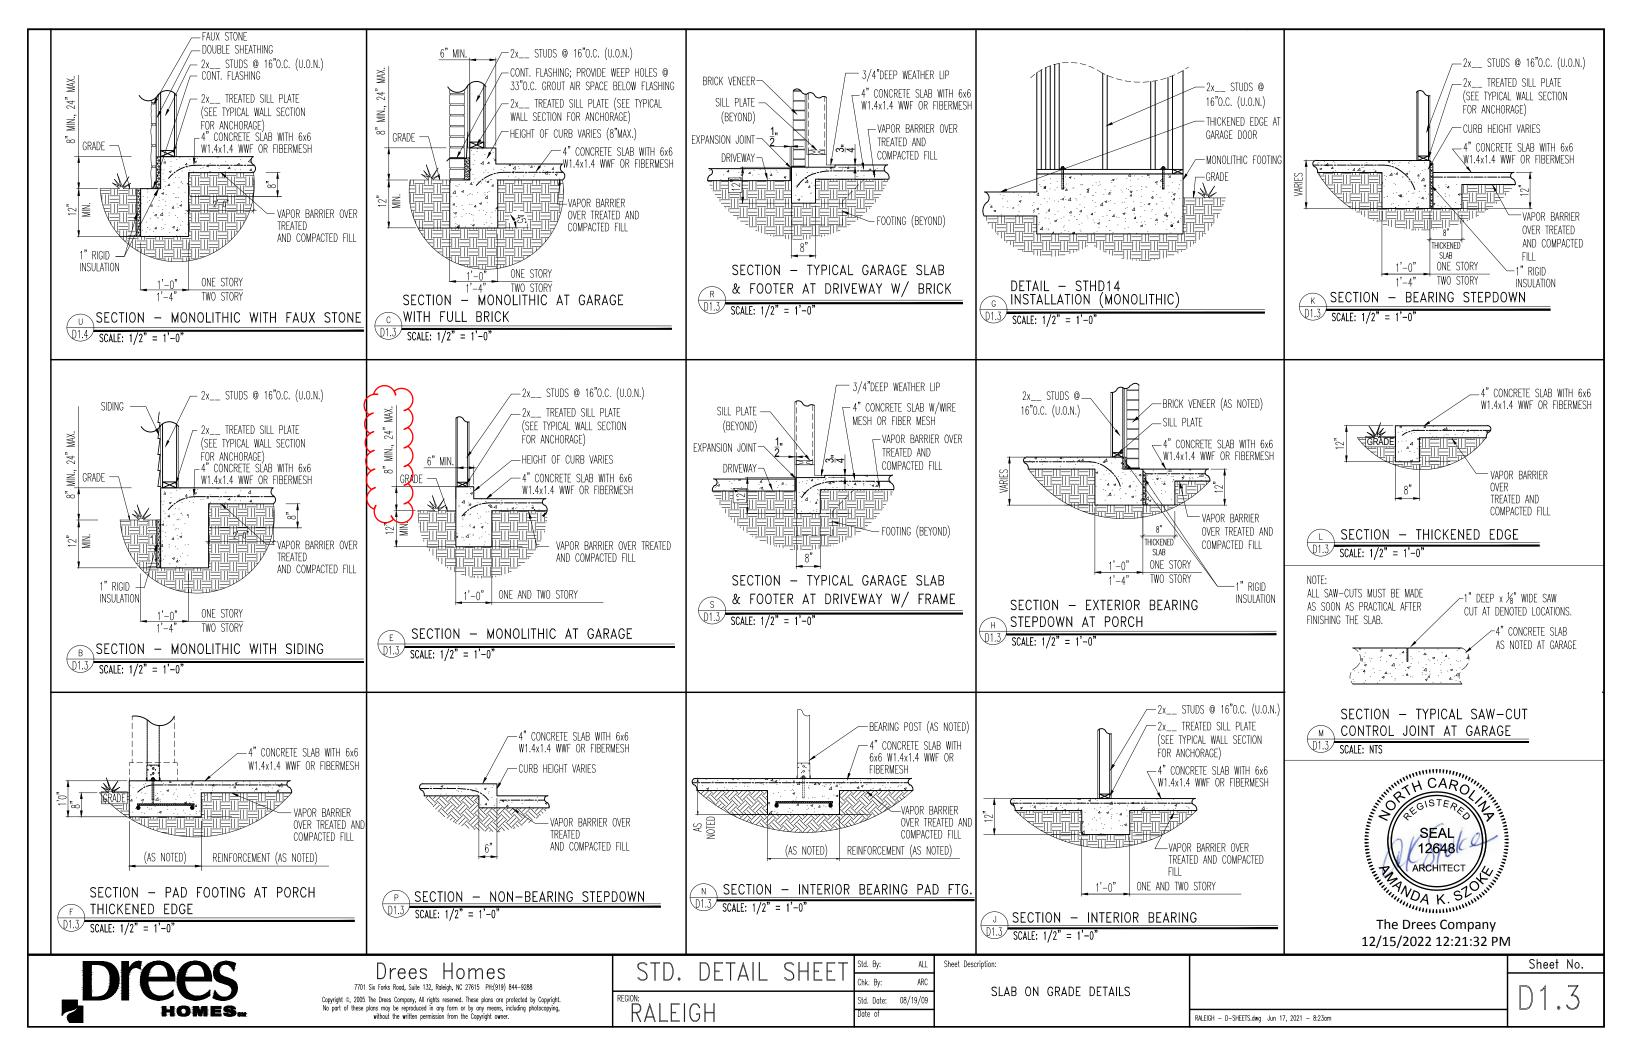
Elevation "B"


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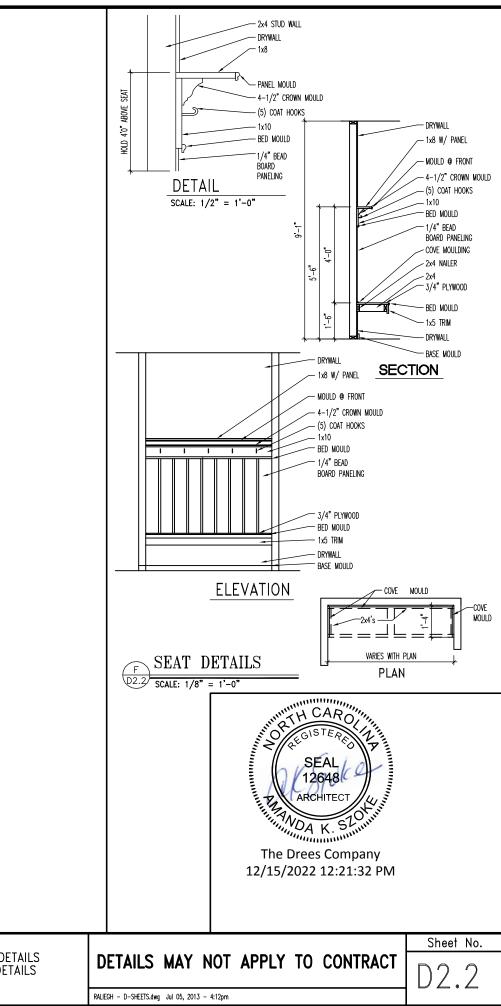






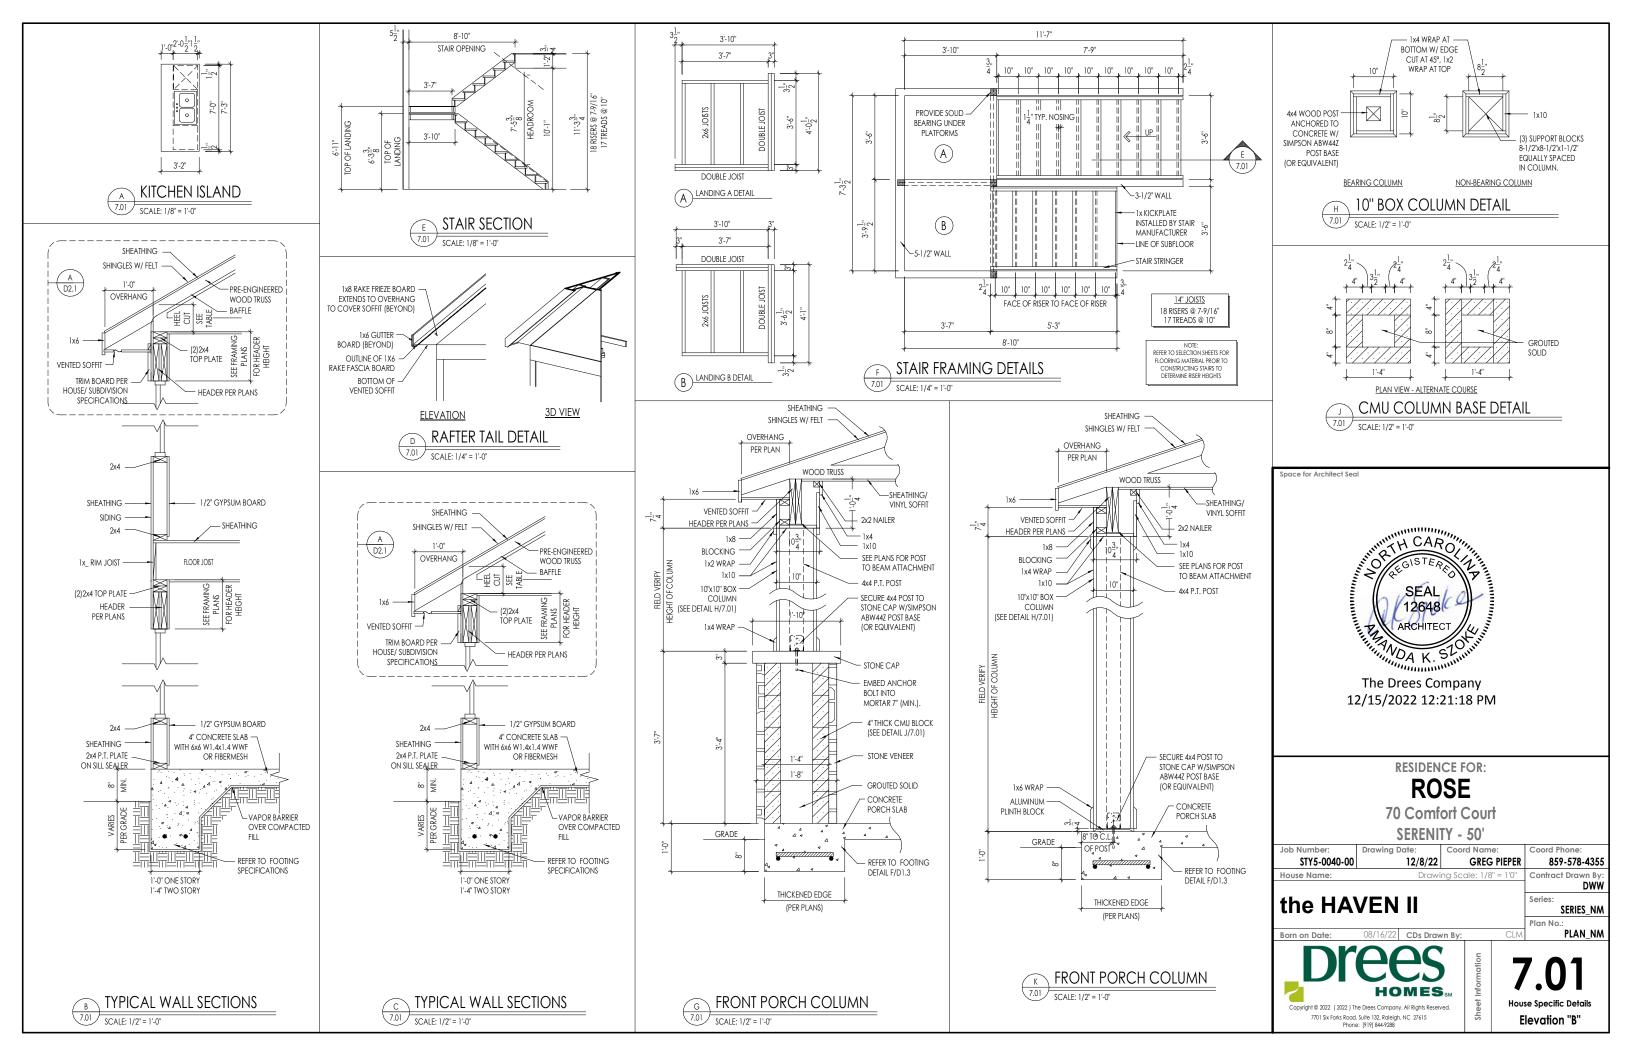

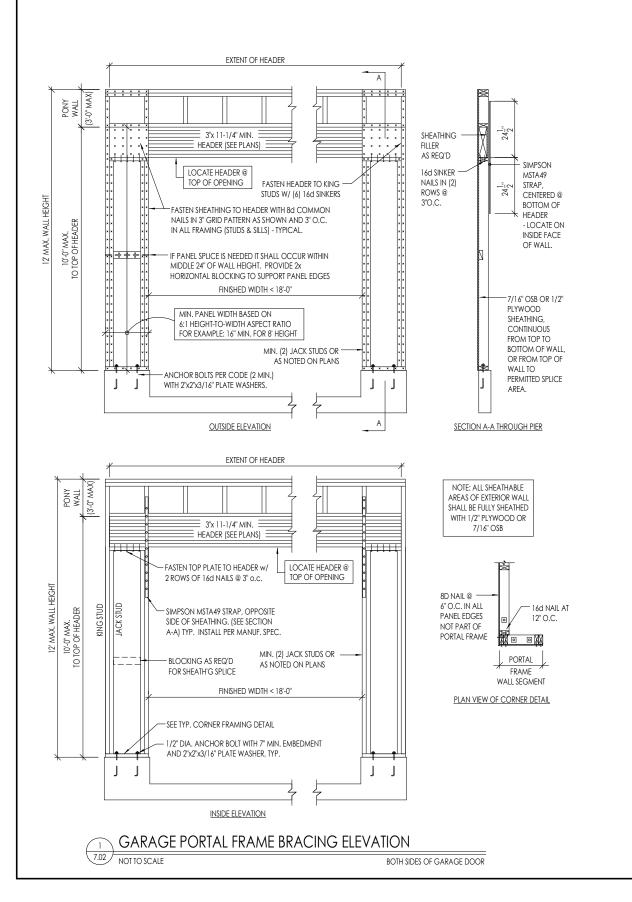

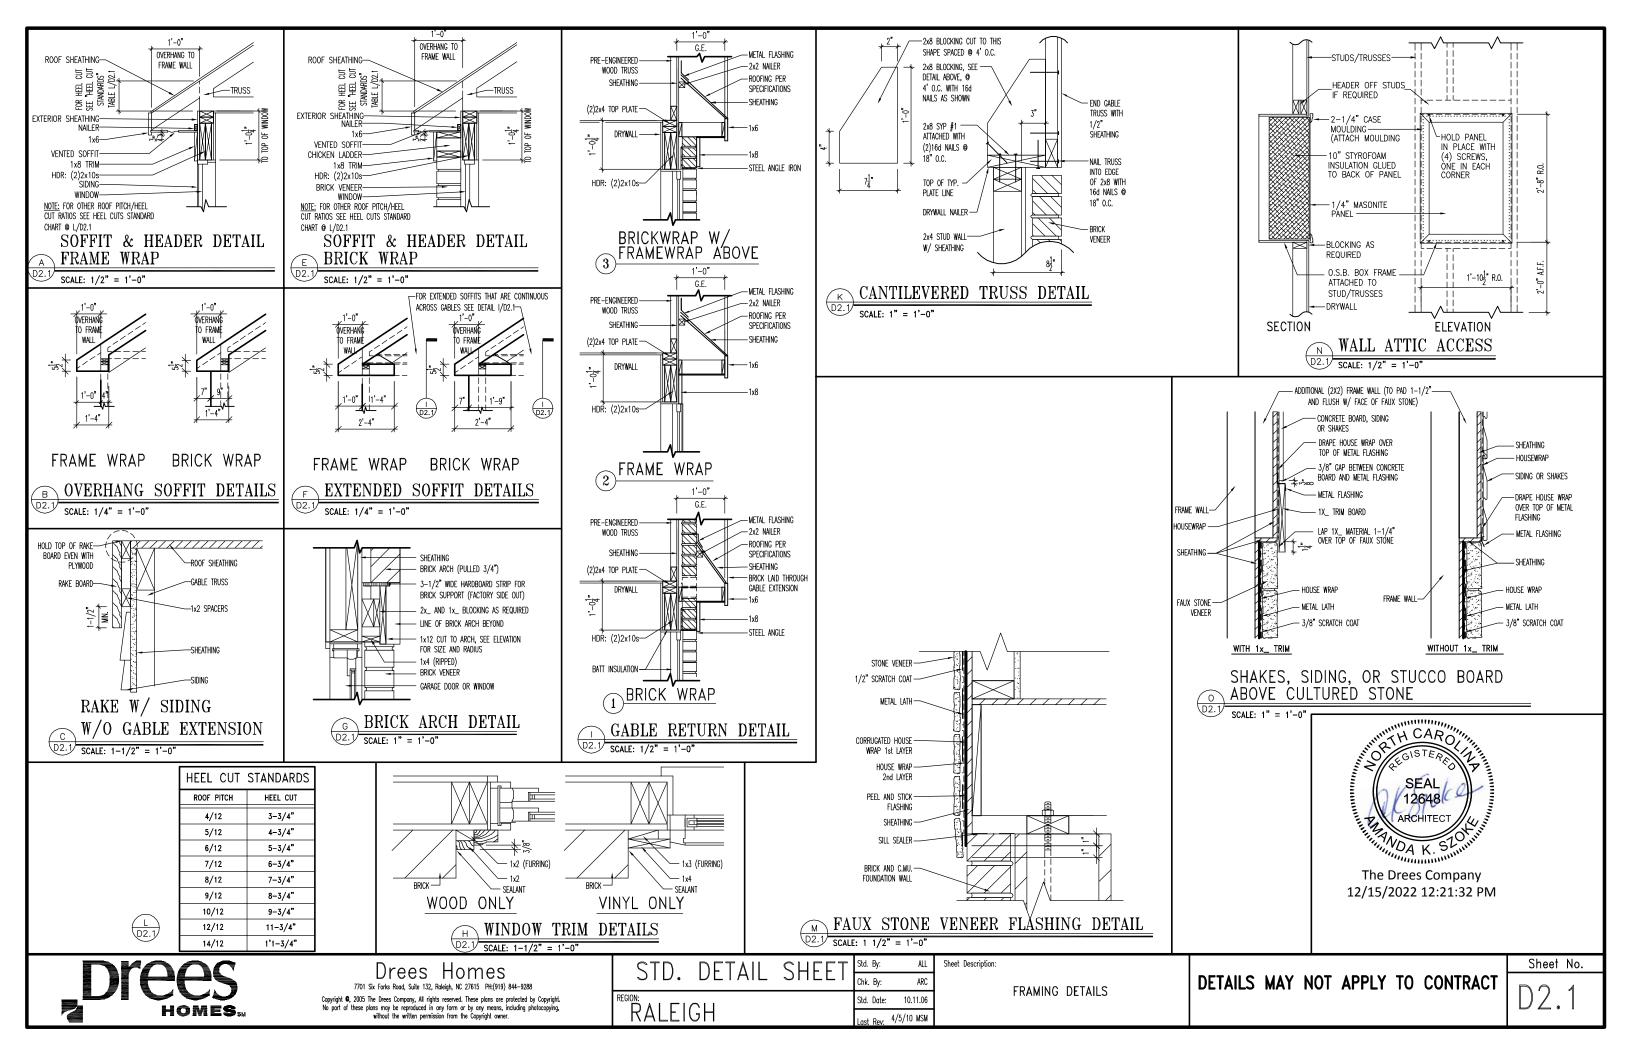



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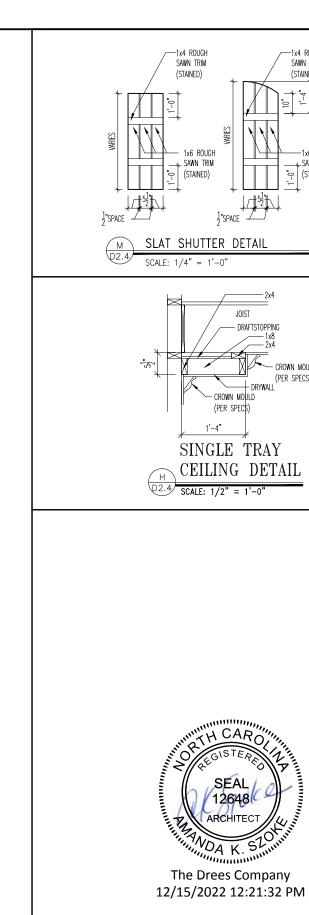
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CTD	DETAIL		Std. By:
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GION:			Std. Date:
RALEI(	ĴΗ		Date of

ARC 10.11.06

Date of Last Rev: 02/25/09 DAB

FRONT BAY WINDOW DETAILS REAR BAY WINDOW DETAILS



HOMES...

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STD	DETAIL	SHEET	Std. By:	ALL
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REGION:		_	Std. Date:	10.11.06
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COLUMN DETAILS SUNROOM DETAILS

DETAILS MAY NOT APPLY TO CONTRACT

Sheet No.


-1x6 ROUGH SAWN TRIM (STAINED)

(PER SPECS)

— CROWN MOULD (PER SPEC\$) 1'-4"

12648

RALEIGH - D-SHEETS.dwg Mar 24, 2015 - 12:15pm

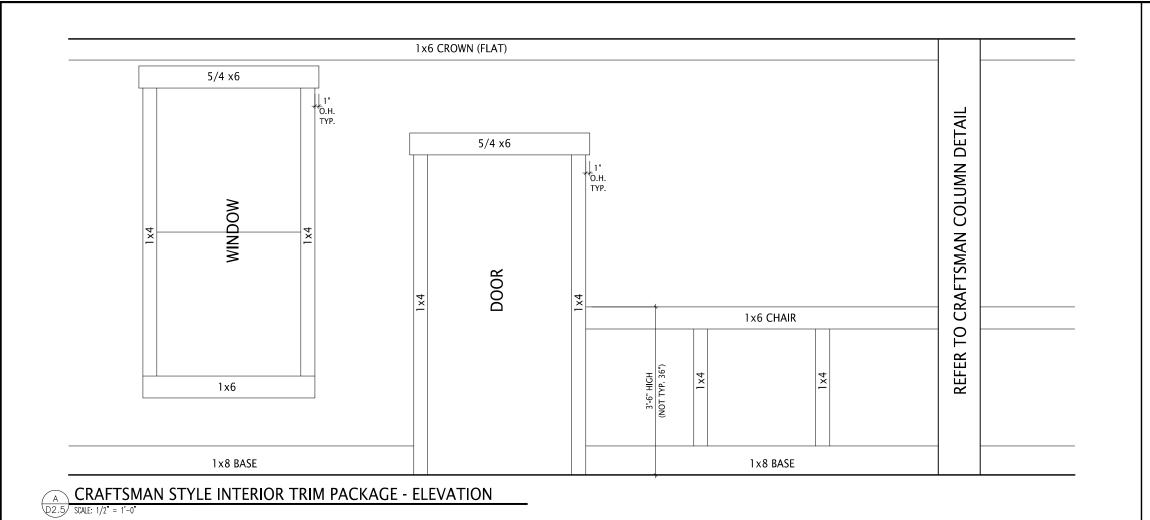

SEAL 12648

ARCHITECT A STOCKHILL ARCHITECT ARCHITECT A STOCKHILL ARCHITECT A STOCKHILL ARCHITECT A STOCKHILL



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CTD	DETAIL	CHEET	Std. By:	DWW
טוט.	DLIAIL	JIILLI	Chk. By:	ARC
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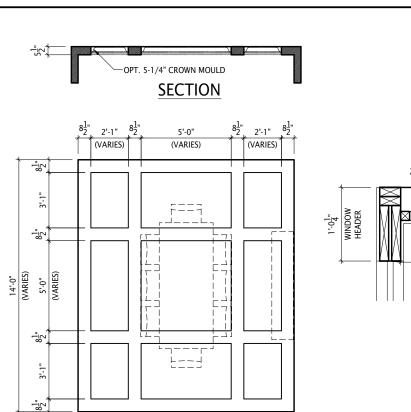
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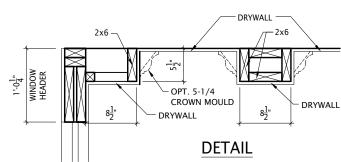
INTERIOR TRIM DETAILS DETAILS MAY NOT APPLY TO CONTRACT

D2.5

Sheet No.

RALEIGH - D-SHEETS.dwg Dec 10, 2014 - 1:50pm





Note: Ceiling treatment details will tray down into space on enclosed rooms located on the 1st floor. On enclosed rooms on the 2nd floor, the ceiling treatment will tray up into the roof truss system. On 2-story spaces, the ceiling treatment will tray down into the space and require an appropriate sized header to capture the ceiling detail return.

(VARIES) TYPICAL PLAN

14'-0" (VARIES)



roof truss system. On 2-story spaces, the ceiling treatment will tray down into the space and require an appropriate sized header to capture the ceiling detail return.

DATE OF DETAIL:


# 5-1/4" CROWN MOULD 5/8"x3/4" BASE MOULD

### **SECTION**

12'-0"

(VARIES)

TYPICAL PLAN

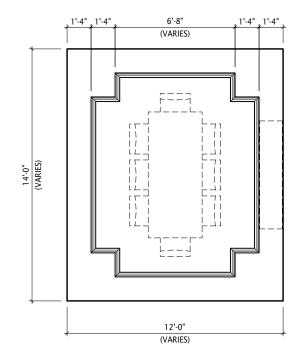

TYPICAL PLAN



1st floor. On enclosed rooms on the 2nd floor, the ceiling treatment will tray up into the roof truss system. On 2-story spaces, the ceiling treatment will tray down into the space and require an appropriate sized header to capture the ceiling detail return.

-5-1/4" CROWN MOULD 4-1/4" CROWN MOULD-**SECTION** 1'-4" 2'-2" 2'-0" [1'-0" 2'-0"

12'-0"

∕−12x6 BOX BEAM

-8x8 BOX BEAM

**SECTION** 


7'-4"

(VARIES)

8", 1'-8"

(VARIES) TYPICAL PLAN

12'-0"

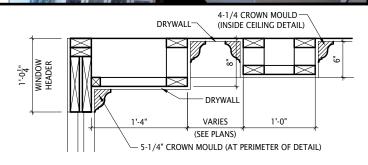

### **DETAIL**




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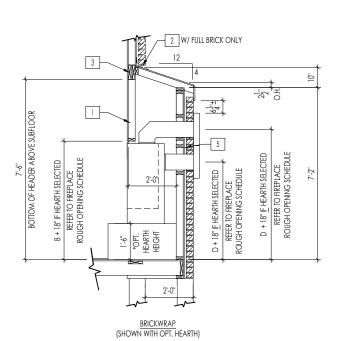
Note: Ceiling treatment details will tray down into space on enclosed rooms located on the 1st floor. On enclosed rooms on the 2nd floor, the ceiling treatment will tray up into the roof truss system. On 2-story spaces, the ceiling treatment will tray down into the space and require an appropriate sized header to capture the ceiling detail return.



CEILING TREATMENTS


SCALE: AS NOTED



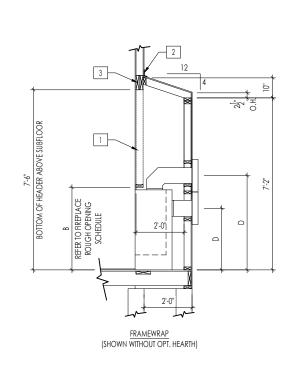


FIREPLACE DOGHOUSE SECTIONS

SCALE: 1/4" = 1'-0"

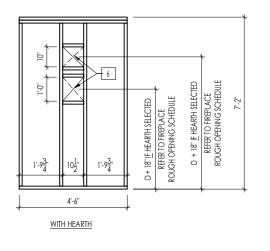

DIRECT VENT REAR WALL FRAMING

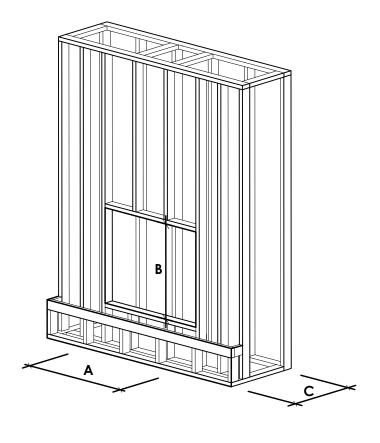

NOTE: PROVIDE OSB SHEATHING WHEN STONE VENEER SELECTED


FIREPLACE ROUGH OPENING SCHEDULE						
FIDEDI A CE LA NILIE A CTUDED	MODEL	A	A B		D	
FIREPLACE MANUFACTURER		(FIREBOX REQUIRED WIDTH)	(FIREBOX REQUIRED HEIGHT) *ADD 18" W/ OPT. HEARTH	(FIREBOX REQUIRED DEPTH - INTERIOR REAR WALL TO FRONT EXTERIOR WALL)	PTH - (VENT CENTERLINE HEIGHT)	
	SLIMLINE SL-7	42"	38-1/4"	16-1/4"		
HEAT & GLO	COSMO 42	49"	32-3/4"	17-3/4"	17-3/4" TOP ONLY 47-1/16"	
	COURTYARD 36	43-3/8"	44-1/8"	18-3/8"	SEE MANUFACTURER'S SPEC	
HEARTH & HOME	COURTYARD 42	49-1/4"	44-1/8"	18-1/8"	SEE MANUFACTURER'S SPEC	
PLANTI & HOME	LANAI *(NOT IN CINCY/NKY)	57-3/4"	39-1/2"	17-5/8"	SEE MANUFACTURER'S SPEC	
	RAVE	50"	40-1/4"	18-1/4"	TOP ONLY 46-1/2"	
			all dimensions	are in inches		

#### General Notes

REFER TO SHEET ON.1 FOR GENERAL NOTES.
 VERIFY FIREPLACE MODEL AND HEARTH SELECTION WITH CUSTOMER'S SELECTIONS.

#### Key Notes

- 1 FUTURE FRAMING FOR F.P. OPENING AFTER INSULATION HAS BEEN INSTALLED IN EXT. WALLS
- 2 FLASHING
- 3 HEADER PER PLAN
- 4
- 5 1" AIRSPACE
- 6 BOX OUT FOR FLUE (REFER TO SELECTIONS FOR FIREPLACE AND OPENING HEIGHT)

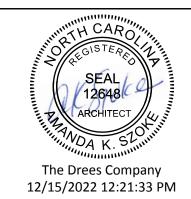



The Drees Company 211 Grandview Drive Fort Mitchell, Kentucky 41017 PH:(859) 578-4200

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Std. Drawn By:	MRPH	Sheet Description:	SCALE: VARIES
		FIREPLACE DETAIL	
Std. Date:	02.29.20		
Date of Last Rev:	7.21.2021	g:\architecture\cincinnati\cinti standard drawings\fireplace\fireplace detail sheets.dwg	

Sheet No.

F-1

# **RALEIGH WINDOW SCHEDULE**

\* MEETS EMERGENCY ESCAPE & RESCUE OPENING REQUIREMENTS

Drees General	Window Type	MI Windows and Doors Capitol Series			Drees General				
Callout	Willdow Type	Call No. Rough Opening	Call No.	Rough Opening	Callout	Call No.	Rough Opening	Call No.	Rough Opening
1660	SINGLE/DOUBLE HUNG	CW3500 1/8 x 6/0 20" x 60-1/4"							
1670 1860	SINGLE/DOUBLE HUNG SINGLE/DOUBLE HUNG	CW3500 1/8 x 7/0 20" x 84" CW3500 1/8 x 6/0 20" x 60-1/4"							
2030	SINGLE/DOUBLE HUNG	L CW3500 2/0 x 3/0 L 24" x 36"		<del> </del>					
2040	SINGLE/DOUBLE HUNG	CW3500 2/0 x 4/0   24" x 48"							
2050	SINGLE/DOUBLE HUNG SINGLE/DOUBLE HUNG	CW3500 2/0 x 5/0 24" x 60-1/4" CW3500 2/0 x 6/0 24" x 72"							
2060 2070	SINGLE/DOUBLE HUNG	CW3500 2/0 x 6/0   24 x 72							
2430	SINGLE/DOUBLE HUNG SINGLE/DOUBLE HUNG	CW3500 2/0 x 7/0 24" x 84" CW3500 2/4 x 3/0 28" x 36"							
2440	SINGLE/DOUBLE HUNG	CW3500 2/4 x 4/0   28" x 48"							
2450 2460	SINGLE/DOUBLE HUNG SINGLE/DOUBLE HUNG	CW3500 2/4 x 5/0 28" x 60-1/4" CW3500 2/4 x 6/0 28" x 72"							
2830	SINGLE/DOUBLE HUNG	CW3500 2/8 x 3/0   32" x 36"							
2840	SINGLE/DOUBLE HUNG	CW3500 2/8 x 4/0   32" x 48" CW3500 2/8 x 5/0   32" x 60-1/4"							
2850 2860	SINGLE/DOUBLE HUNG	CW3500 2/8 x 5/0   32" x 60-1/4"   CW3500 2/8 x 6/0   32" x 72"							
3030	SINGLE/DOUBLE HUNG SINGLE/DOUBLE HUNG	CW3500 2/8 x 6/0   32 x 72 CW3500 3/0 x 3/0   36-1/4" x 36"		+					
3040	SINGLE/DOUBLE HUNG	CW3500 3/0 x 4/0   36-1/4" x 48"							
3050	SINGLE/DOUBLE HUNG	CW3500 3/0 x 5/0 36-1/4" x 60-1/4"							
3060 3070	SINGLE/DOUBLE HUNG SINGLE/DOUBLE HUNG	CW3500 3/0 x 6/0 36-1/4" x 72" CW3500 3/0 x 7/0 36-1/4" x 84"		-					
3470	SINGLE/DOUBLE HUNG	CW3500 3/0 x 7/0   30-1/4 x 84"		<del> </del>					
1050 FIXED		910T 5/0 x 1/0   59-5/8" x 11-1/2"							
1640 FIXED		910T 4/0 x 1/8 47-1/4" x 19-1/2"							
2020 FIXED 2030 FIXED		CW3500 2/0 x 2/0 24" x 24" CW3500SL 2/0 x 3/0 24" x 36"							
2040 FIXED		CW3500SL 2/0 x 3/0 24 x 30 CW3500SL 2/0 x 4/0 24" x 48"							
2050 FIXED		CW3500SL 2/0 x 5/0 24" x 60-1/4"							
2816 FIXED		910TSL 2/6 x 1/8 29-1/4" x 19-1/2" CW3500 3/0 x 6/0 36" x 72"							
2860 FIXED 3016 FIXED		910TSL 3/0 x 1/8   35-1/4" x 19-1/2"		+					
3020 FIXED		910TSL 3/0 x 2/0   35-1/4" x 23-1/2"							
3030 FIXED		CW3500P 3/0 x 3/0   36-1/4" x 36"							
3040 FIXED 3050 FIXED		CW3500P 3/0 x 4/0   36-1/4" x 48" CW3500P 3/0 x 5/0   36-1/4" x 60-1/4"		-					
3060 FIXED		CW3500P 3/0 x 5/0   36-1/4 x 60-1/4 CW3500P 3/0 x 6/0   36-1/4" x 72"							
3070 FIXED		CW3500P 3/0 x 7/0   36-1/4" x 84"							
4010 FIXED		910T 4/0 x 1/0 47-1/4" x 11-1/2"							
4020 FIXED 4030 FIXED		910T 4/0 x 2/0 47-1/4" x 23-1/2" CW3500P 4/0 x 3/0 48" x 36"							
4040 FIXED		CW3500F 4/0 x 4/0   48" x 48"							
4044 FIXED		CW3500P 4/0 x 4/4   48" x 52"							
4050 FIXED		CW3500P 4/0 x 5/0 48" x 60-1/4"							
4060 FIXED 4070 FIXED		CW3500P 4/0 x 6/0 48" x 72" CW3500P 4/0 x 7/0 48" x 84"		+					
5030 FIXED		CW3500P 5/0 x 3/0   60" x 36"							
5040 FIXED		CW3500P 5/0 x 4/0   60" x 48"							
5060 FIXED 5070 FIXED		CW3500P 5/0 x 6/0 60" x 72" CW3500P 5/0 x 7/0 60" x 84"							
6020 FIXED		910T 6/0 x 2/0 71-5/8" x 23-1/2"		<del> </del>					
6050 FIXED		CW3500P 6/0 x 5/0 72" x 60-1/4"							
6060 FIXED		CW3500P 6/0 x 6/0 72" x 72"							
3'-0" HALF ROUND 4'-0" HALF ROUND		CW3500 3/0 HC 36-1/4" CW3500 3/0 HC 48"		+					
5'-0" HALF ROUND		CW3500 3/0 HC 60"							
2020 OCTAGON	UND	CW3500 2/0 OCT 24"							
2'-4" QUARTER RO 3'-0" QUARTER RO		CW3500 2/4 QC 28" CW3500 3/0 QC 36-1/4"							
3-U QUAKTEK KU	עוויט	CW3300 3/0 QC   30-1/4							



Drees Homes

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Sheet Description:

WINDOW SCHEDULE

Sheet No.

# MOULDED MILLWORK SCHEDULE

LAST REVISED 11/22/1
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Droos Coporal Callout	Number	Fypon
Drees General Callout	Nuwood	* *
ARCHED HEADER D1	H8xxEFR	N/A
ARCHED HEADER D1K	H8xxEFKR	N/A
ARCHED HEADER D2	H8xxEFTR	N/A
ARCHED HEADER D2K	H8xxEFTKR	N/A
ARCHED HEADER D3	AH10xx	WCHSEGxxX10
ARCHED HEADER D3K	N/A	WCHSEGxxX10K
ARCHED HEADER D4	AR5xx	ARxxX6M
ARCHED HEADER D4K	AR5xxK	ARxxX6MK
ARCHED HEADER D5	AR10xxEC	ARXXX6METAR6C
ARCHED HEADER D5K	AR10xxECK	ARXXX6METAR6CK
ARCHED HEADER D6	AR10xxC	ARxxX10MC
ARCHED HEADER D6K	AR10xxCK	ARxxX10MCK
ARCHED HEADER D7K	H7xxEF-4K	N/A
ARCHED HEADER D8	AR14xxC	ARXXX14MC
ARCHED HEADER D8K	AR14xxCK	ARxxX14MCK
ARCHED HEADER D9	H9xxE	WCHARSxx13
CROSSHEAD A1	H9xx	WCHxxX9N
CROSSHEAD A1K	H9xxK	WCHxxX9NK
CROSSHEAD B1	H14xxBT	WCHxxX14BT
CROSSHEAD B1K	H14xxBTK	WCHxxX14BTK
CROSSHEAD B2	H12xx	WCHxxX12
CROSSHEAD B2K	H12xxK	WCHxxX12K
CROSSHEAD C1	H18xxBT	WCHxxX14BT
CROSSHEAD C1K	H18xxBTK	WCHxxX14BTK
CROSSHEAD C2	H18xxBT-PA	LDCHxxX18
CROSSHEAD C2K	H18xxBTK-PA	LDCHxxX18K
CROSSHEAD Z-E1-HDR	Z-E1-HDR	Z-E1-HDR
CROSSHEAD Z-E2-HDR	Z-E2-HDR	Z-E2-HDR
Crosshead z-e3-hdr	Z-E3-HDR	Z-E3-HDR
CROSSHEAD Z-E3-ARCHHDR	Z-E3-ARCHHDR	Z-E3-ARCHHDR
CROSSHEAD Z-E3-CLHDR	Z-E3-CLHDR	Z-E3-CLHDR
CROSSHEAD Z-E5-HDR	Z-E5-HDR	Z-E5-HDR
WINDOW HEADER A1	H6xx	WCHxxX6
WINDOW HEADER A1K	H6xxK	WCHxxX6K
WINDOW HEADER B1	H9xx-2	WCHxxX9N
WINDOW HEADER B1K	H9xx-2K	WCHxxX9NK
WINDOW HEADER B2	H9xxBT	WCHxxX10NBT
WINDOW HEADER B2K	H9xxBTK	WCHxxX10NBTK
WINDOW HEADER C1	H9xx	CCAxxX10
WINDOW HEADER C1K	H9xxK	CCAxxX10K
WINDOW HEADER C2	H9xxT	WCHxxX9T
WINDOW HEADER C2K	H9xxTK	WCHxxX9TK
WINDOW HEADER C3	H12xxBT	WCHxxX10BT
WINDOW HEADER C3K	H12xxBTK	WCHxxX10BTK
WINDOW HEADER C4	H14xxBT	WCHxxX14BT
WINDOW HEADER D1	H7xxF-4	N/A
WINDOW HEADER D1K	H7xxF-4K	N/A
WINDOW HEADER D2K	H9xxK-1	N/A
WINDOW HEADER Z-W1	Z-W1	Z-W1
WINDOW HEADER Z-W3	Z-W3	Z-W3
WINDOW HEADER Z-W3K	Z-W3K	Z-W3K
WINDOW HEADER Z-W3D	Z-W3D	Z-W3D
WINDOW HEADER Z-W4	Z-W4	Z-W4
window header z-w4k	Z-W4K	Z-W4K

PILASTERS				
Drees General Callout	Nuwood	Fypon		
FLUTED PILASTER A1	PL7xxF	PIL7Xxx		
FLUTED PILASTER B1	PL9xxF	PIL9Xxx		
FLUTED PILASTER C1	PL11xxFM	PIL11Xxx		
PANEL PILASTER A2	PL7xxP	PIL7XxxDP		
PANEL PILASTER B2	PL9xxP	PIL9XxxDP		
PANEL PILASTER C2	PL11xxPM	PIL11XxxDP		
PILASTER D1	M311-9	PIL10XxxA		
PILASTER D2	M323-9	N/A		
PILASTER Z-E1-PIL	Z-E1-PIL	Z-E1-P <b>I</b> L		
PILASTER Z-E2-PIL	Z-E2-PIL	Z-E2-PIL		
PILASTER Z-E3-PIL	Z-E3-PIL	Z-E3-PIL		
PILASTER Z-PIL-EXT	Z-PIL-EXT	Z-PIL-EXT		
PLAIN PILASTER A3	PL7xxS	PIL7XxxP		
PLAIN PILASTER B3	PL9xxS	PIL9XxxP		
PLAIN PILASTER C3	PL11xxS	PIL11XxxP		
PLINTH D1	PF10	ADD "P" TO END OF PILASTER		
PLINTH D2	P14.5	N/A		
LOUVERS				

Drees General Callout	Nuwood	Fypon	Mid-America
CATHEDRAL LOUVER D1	CLV1224	CLV12X24	
CATHEDRAL LOUVER D1T	CLV1224TRIM4	CLV12X24X4F	
CATHEDRAL LOUVER D2	CLV1432	CLV14X32	
CATHEDRAL LOUVER D2T	CLV1432TRIM4	CLV14X32X4F	00 44 1422
CATHEDRAL LOUVER D3	CLV2232	CLV22X32	
CATHEDRAL LOUVER D3T	CLV2232TRIM4	CLV22X32X4F	
HALF CIRCLE LOUVER D1	HRLV32	HRLV32X16	
HALF CIRCLE LOUVER D1T	HRLV32TRIM4	HRLV32X4F	
HALF CIRCLE LOUVER D2	HRLV36	HRLV36X18	

HALF CIRCLE LOUVER DT	HRLV32	HRLV32X16	
HALF CIRCLE LOUVER D1T	HRLV32TRIM4	HRLV32X4F	
HALF CIRCLE LOUVER D2	HRLV36	HRLV36X18	
HALF CIRCLE LOUVER D2T	HRLV36TRIM4	HRLV36X4F	00 43 2234
OCTAGONAL LOUVER D1	OLV24	OLV24	
OCTAGONAL LOUVER D12	OLV24TRIM4	OLV24X4F	
OVAL LOUVER D1	OLV2537	OLV37X25	
OVAL LOUVER D1T	OLV2537TRIM4	OLV37X25X4F	
RECTANGUAR LOUVER D1	LV1224V	LV12X24	00 45 1218
RECTANGUAR LOUVER D1T	LV1224VTRIM4	LV12X24-4F	00 45 1218
RECTANGUAR LOUVER D2	LV1636V	LV16X36	
RECTANGUAR LOUVER D2T	LV1636VTRIM4	LV16X36-4F	
RECTANGUAR LOUVER D3	LV2436V	LV24X36	
RECTANGUAR LOUVER D3T	LV2436VTRIM4	LV24X36-4F	
RECTANGUAR LOUVER D4	LV2424V	LV24X24	
RECTANGUAR LOUVER D4T	LV2424VTRIM4	LV24X24-4F	
ROUND LOUVER D1	RLV18	RLV18	
ROUND LOUVER DIT	RLV18TRIM4	RLV18X4F	
ROUND LOUVER D2	RLV22	RLV22	
ROUND LOUVER D2T	RLV22TRIM4	RLV22X4F	
TRIANGULAR LOUVER D1		TRLVxxX36	00 47 0x0x
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### BRACKETS

Drees General Callout	Nuwood	Fypon
EXTERIOR BRACKET D1	BR437	N/A
EXTERIOR BRACKET D2	DB102	DTLB6X4X6
EXTERIOR BRACKET D3	BR304 (7" WIDE)	BKT24X24X7
EXTERIOR BRACKET D4	BR455	N/A
EXTERIOR BRACKET D5	BR300-1	BKT12X12X6
EXTERIOR BRACKET D6	BR300	BKT12X12
EXTERIOR BRACKET D7	BR409	BKT16X18X3
EXTERIOR BRACKET D8	BR413	DTLB5X5X3
EXTERIOR BRACKET D9	TBD	BKT11X20
EXTERIOR BRACKET D10	TBD	BKT12X24X3
EXTERIOR BRACKET D11	BR435	BKT25X27
EXTERIOR BRACKET D12	BR404	BKT16X30X4
EXTERIOR BRACKET D13	BR23.13x10.13x5.5	N/A
GABLE BRACKET D1	TBD	DTLB6X4X6R(OR L)PITCH
GABLE BRACKET D2	BR423-x:12	BKT5X20
GABLE BRACKET D3	BR424-x:12	BKT5X20 (CUT 2" PROJECTION)

MOULDINGS				
Drees General Callout	Nuwood	Fypon		
BAND MOULD D1	M210-16	MLD612-12		
BAND MOULD D2	M301-16	MLD220-16		
BARGE MOULD D1	WM210	WM210		
CASE MOULD D1	M320-16	MLD226-16		
CASE MOULD D2	N/A	MLD244-12		
CROWN MOULD D1	M404-16	MLD572-16		
DENTIL MOULD D1	M105-16	MLD310-16		
DENTIL MOULD D2	M108-8	MLD353-8		
HALF ROUND MOULD D1	N/A	MLD605-12		
PANEL MOULD D1	M310-8 OR 16	MLD612-12		

### PEDIMENTS / COMBO HEADERS

Drees General Callout	Nuwood	Fypon
BROW COMBO D1	BCxx	CSAPxx
PEAK PEDIMENT D1	Pxx-4 (6:12)	PCPxx
PEAK PEDIMENT Z-E1-PED	Z-E1-PED	Z-E1-PED
PEAKED COMBO D1	PCxx-4	CPCPxx
RAMS HEAD PEDIMENT D1	Rxx	RHPxx00
ROUND PEDIMENT D1	Bxx-4	PSPxx
SUNRISE COMBO D1	SCxx-4	CSPxx
VICTORIAN PEDIMENT D1	VPxx	DVPxx w/ SWDHxxXxx

### WINDOW DECORATION

Drees General Callout	Nuwood	Fypon
HALF CIRCLE SUNBURST D1	SPxxxx	SWDHxxXxx
PALLADIAN WINDOW D1	H9AR10-xx xx" FL/FR	ARxxX10MFLxxx
PALLADIAN WINDOW D1K	H9AR10-xxK xx" FL/FR	ARxxX10MFLxxx with K10TM
PALLADIAN WINDOW D2	H9AR10SPxxxx	ARxxX10MFLxxx with
		SWDHxxXxx
PALLADIAN WINDOW D2K	H9AR10SPxxxxK	ARxxX10MFLxxx with
		SWDHxxXxx and K10TM
PEAKED CAP HEADER D1	N/A	CHPCxxX15
PLAIN SEGMENT D1	SPxxxxP	PSPxx
SEGMENT SUNBURST D1	SPxxxx	SWDHxxXxx

### **ACCESSORIES**

Drees General Callout	Nuwood	Fypon
GABLE D1	PGDx12	GPA (width X height)
KEYSTONE D1	KY14F-3	KY14
KEYSTONE D2	KYHM9F	К9М
WREATH D1	N/A	WAB34



Sheet Description:

MOULDED MILLWORK SCHEDULE

Sheet No.