

# See notes on first floor plan



Reason For Modification:

1. XXX

2. XXX

3. XXX

4. XXX

1. XXX

2. XXX

3. XXX

4. XXX

Design Solution:

1. XXX

2. XXX

3. XXX

4. XXX

Architecture Plan Review:

Customer Request:

1. XXX

2. XXX

3. XXX

4. XXX

Square Footage		Division: R				
			Building Code: 2018 North Carolina Residential Building Code			
					<del>-</del>	
1st Floor         1146 SF           2nd Floor         1326 SF		Index to t	ne Drawir	ngs		
2nd Floor	2472 SF			Sheet Name		
			0C.1 0N.1	Cover Sheet General Notes		
Unfinished Areas			OP.1	Plot Plan		
Ullillistieu Aleas			1.01S	Foundation Plan (Slab)		
Covered Front Porch	150 SF		2.01F 2.01S	First Floor Framing Plan First Floor Structural Plan	n	
Garage	445 SF		2.02F	Second Floor Framing P		
Outdoor Living	77 SF 672 SF		2.02\$	Second Floor Structural	Plan	
	0/ Z 3F		2.04 3.02	Roof Plan Second Floor Subfloor P	Plan	
			4.01	First Floor Mechanical P		
			4.02	Second Floor Mechanic	cal Plan	
Square Footage total may vary by +1 SF due	e to automated rounding of first and seco	nd floor area	5.01 6.01	Building Section Front Elevation		
D 1			6.02	Garage Side Elevation		
Redraws			6.03	Rear Elevation		
Plan Review: 10/13	122		6.04	Side Elevation		
	1 44		7.01 7.02	House Specific Details SD-2 House Specific De	etails	
- Changed to Meadow II_			7.03	House Specific Details (		
Plan Review: 10/24 Changed garage to side entry - Removed fire rating on garage side.	FOR STRUC		Space for Architect Seal			
The state of the s	SEAL STATES					
				RESIDENCE F	FOR:	
				MARK	FT	
Fenestration Ca	ılculations:				<del></del>	
Total Wall Squa	re Footage:	3319.89		52 COMFORT	COURT	
Total Window Square Footage: 463.33				SERENIT	Υ	
Total Fenestration	-	13.96%	Job Number: Dr		rd Name: Coord Phone:	
101di Feriesii dii011 %. <u>13.76%</u>			STY5-0037-00	10/13/22	GREG PIEPER 859-578-435	
Customer Plan Rev	Customer Plan Review Signature			Drawing Sc	cale: 1/8" = 1'0" Contract Drawn By	
I understand that my new Drees ho					DWV	
plans, specifications, selections and the Purchase Agreement, all of which I have reviewed and approved. This set of plans may not reflect the elevations or options for my house. Drees draws the standard plans complete with the most common action. The whole the plant of the pla			the MEA	DOW II	Series:	
					Plan No.:	
options. The subcontractor's sets will show only the options I selected in my selection sheets. I have reviewed the plot plan for my house and understand that			Born on Date: 06/2	29/2021 <b>CDs Drawn By:</b>	SSP PLAN_NA	
there may be some field adjustmen	nts as to the exact location of the h	nouse on the			<u> </u>	
lot. I further understand that my hor home or Model and that some min	or variations from my plans and sp	ecifications			oc.1	
may occur since every home that i problems that must be dealt with a	is built has it's own set of unique co					
Customer:	s the nome is being built Date:			HOMES	Cover Sheet	
Customer	Date:		7701 Six Forks Road, Suite	132, Raleigh, NC 27615	Cover Sheet  Elevation "B"	
Customer: Date:			Phone: [91		cievation b	

## **GENERAL NOTES - RALEIGH**

#### **FOUNDATION NOTES**

#### CRAWL SPACES:

SLOPE CONCRETE SLAB 4" MINIMUM TOWARDS GARAGE DOOR

- EXTERIOR FLATWORK/GARAGES SHALL HAVE A MINIMUM CONCRETE SRENGTH OF 4,500 PSI

FOOTINGS TO A MINIMUM CONCRETE STRENGTH OF 2500 PSI, UNLESS OTHERWISE NOTED

ASSUMED ALLOWABLE SOIL BEARING PRESSURE: 2 000 p s f

WATERPROOF FOUNDATION WITH BITUMINOUS SPRAY.

WALL TIES EMBEDDED IN THE HORIZONTAL MORTAR JOINT SHALL BE 16" ON CENTER, TIES IN ALTERNATE COURSES SHALL BE STAGGERED. THE MAXIMUM VERTICAL DISTANCE BETWEEN TIES SHALL NOT EXCEED 16" AND THE MAXIMUM HORIZONTAL DISTANCE SHALL NOT EXCEED

16" ADDITIONAL TIES SHALL BE PROVIDED AT ALL OPENINGS, AND WITHIN 12" OF THE OPENING

- CORE FILL ENTIRE BLOCK WALL WHEN THE WALL IS 4'-0" TALL OR HIGHER. INSTALL #4 REBAR IN EACH HOLLOW AREA OF EACH BLOCK

FROM FOOTING TO TOP OF WALL, ON THE ENTIRE WALL PRIOR TO CORE FILLING IT.

TOP COURSE OF BLOCK ON ALL WALLS WILL BE FILLED SOLID WITH MORTAR PLACING THE FOUNDATION STRAPS OR BOLTS IN THE MORTAR

6'-0" ON CENTER, AND 12" FROM EACH CORNER

12"x16" PIERS: HOLLOW MASONRY UP TO 48" HIGH, SOLID MASONRY UP TO 9'0" HIGH

16"x16" PIERS: HOLLOW MASONRY UP TO 64" HIGH, SOLID MASONRY UP TO 12'0" HIGH

- BLOCK PIERS SHOULD BE PLACED DIRECTLY ON CONCRETE FOOTINGS PER PLAN. THEY SHOULD BE PLUMBED AND SQUARE WITHIN 1/4".

- SILL PLATES TO BE A MINIMUM OF 2x4 NOMINAL LUMBER.

#### **BASEMENTS:**

- SLOPE CONCRETE SLAB 4" MINIMUM TOWARDS GARAGE DOOR

- EXTERIOR FLATWORK/GARAGES SHALL HAVE A MINIMUM CONCRETE SRENGTH OF 4,500 PSI

- FOOTINGS TO A MINIMUM CONCRETE STRENGTH OF 2500 PSI, UNLESS OTHERWISE NOTED- ALL FOUNDATION WALLS TO BE CAST IN PLACE CONCRETE 3000 PSI MIN, UNLESS OTHERWISE

- BASEMENT WINDOW LOCATIONS MAY VARY FROM DRAWING DUE TO LOT CONDITIONS.

- BACKFILL ADJACENT TO FOUNDATION WALLS SHALL NOT BE PLACED UNTIL THE WALL HAS SUFFICIENT STRENGTH AND HAS BEEN ANCHORED TO THE FLOOR OR HAS BEEN SUFFICIENTLY BRACED TO PREVENT DAMAGE BY THE BACKFILL.

- ASSUMED ALLOWABLE SOIL BEARING PRESSURE: 2,000 p.s.f.

- WATERPROOF FOUNDATION WITH BITUMINOUS SPRAY.

MECHANICAL/ELECTRICAL NOTES

- ALL KITCHEN CABINET DIMENSIONS ARE CABINET TO CABINET

- CABINET SIZES MAY VARY WITH FULL-OVERLAY CABINETS.

- MIN. 50 C.F.M. FOR ALL EXHAUST FANS IN BATHROOMS

(OVER HORIZONTAL SPACE)

R-38 BATT

FLOOR JOIST CAVITY AT STANDARD PERIMETER:

- VERTICAL CONTROL JOINTS IN BASEMENT FOUNDATION WALLS - STANDARD LOCATION GUIDELINES:

1) PLACE A CONTROL JOINT IN ALL UNBRACED WALLS OVER 30' IN LENGTH. (NOTE: "T" WALLS AND CORNERS COUNT AS A BRACE).

2) WINDOWS THAT ARE LARGER THAN THE STANDARD BASEMENT WINDOW REQUIRE A CONTROL JOINT.

3) CONTROL JOINTS ARE NOT REQUIRED AT EVERY WINDOW THAT IS STANDARD SIZE

4) IF THERE IS A STANDARD WINDOW LOCATED IN A WALL SEGMENT THAT REQUIRES A CONTROL JOINT, THEN THE CONTROL JOINT SHOULD BE PLACED ON THE SIDE OF THE WINDOW THAT IS ADJACENT TO THE LONG SIDE OF THE WALL. IF THERE IS MORE THAN ONE WINDOW IN A WALL THEN ONLY ONE WINDOW SHOULD HAVE A CONTROL JOINT.

5) DOORS DO NOT GET CONTROL JOINTS.

DETAILS SEE SHOP DRAWINGS.

EXTERIOR STUD WALL CAVITY:

FLOOR JOIST CAVITY AT CANTILEVER:

(SLOPED AND VERTICAL SPACE)

ON THE PLANS.

INSULATION DETAILS

OVER GARAGE:

6) CONTROL JOINTS SHOULD NOT BE LOCATED WITHIN 3' OF A BEAM POCKET.

7) CONTROL JOINTS ARE REQUIRED AT THE FIRST AND LAST STEP DOWN AT STEPPED BASEMENT FOUNDATION WALLS.

- CABINET STYLES MAY VARY FROM INTERIOR ELEVATIONS DEPENDING ON STYLE, MANUFACTURER, ETC. FOR CABINET

- PROVIDE HOSE BIBS PER DIVISION SPEC, SHEET, EXACT LOCATION TO BE FIELD DETERMINED UNLESS OTHERWISE NOTED

R-19

R-19

R-38 BLOWN

- INTERIOR FLATWORK SHALL HAVE A MINIMUM CONCRETE STRENGTH OF 3,000 PSI.

- ANY GAS APPLIANCES MUST BE INSTALLED PER MANUFACTURER'S SPECIFICATIONS

- HOLD THE CENTERLINE OF ALL EXTERIOR LIGHT FIXTURES AT 5'-8" OFF BOTTOM OF DOOR OPENING.

- GROUND FAULT INTERRUPTER (GFCI) OUTLETS TO BE INSTALLED PER NEC 2017, SECT. 210.8

- ALL VERTICAL STEEL AND ALL STEEL IN STRUCTURAL SLABS TO BE GRADE 60. ALL HORIZONTAL STEEL IN FOUNDATION WALLS AND FOOTERS TO BE GRADE 40 STEEL

R-15

#### FRAMING NOTES

DESIGN LOADS:

FLOORS: 40 psf LIVE LOAD + 10 psf DEAD LOAD = 50 psf ROOF:

18 psf LIVE LOAD + 17psf DEAD LOAD = 35 psf

GARAGE FLOOR: 50 psf LIVE LOAD

L/240

SEISMIC: "A" & "B"

WIND SPEED: 120 MPH

DESIGN DEFLECTION LIMITS (BASED ON LIVE LOAD, EXCEPT MASONRY): RAFTERS GREATER THAN 3:12 L/180 **CEILINGS** 

MASONRY VENEER L/600

NOMINAL LUMBER FLOORS: L/360

MANUFACTURED WOOD FLOORS: DESIGNED TO MINIMUM PRO RATING OF 35 (OR EQUIVALENT). NO MORE THAN 8 POINT DIFFERENCE BETWEEN ADJACENT SPANS.

L/480 FOR SPANS UP TO 16'-0" AND NO GREATER THAN 1/2" DEFLECTION

L/600 FOR SPANS OVER 16'-0" IF SIMPLE SPAN AND NO GREATER THAN 1/2" DEFLECTION

L/840 FOR SPANS OVER 16'-0" IF CONTINUOUS SPAN. AND NO GREATER THAN 1/2" DEFLECTION 19.2" o.c. MAXIMUM SPACING JOIST SPACING:

DOUBLE EVERY OTHER FLOOR JOIST UNDER KITCHEN ISLANDS

INSTALL UNCOUPLING MEMBRANE IN TILE FLOOR AREAS IF 19.2" o.c. FLOOR JOIST SPACING

GLUE AND MECHANICALLY FASTEN [SCREWS] WOOD FLOOR IF 19.2" o.c. FLOOR JOIST SPACING

MANUFACTURED WOOD PRODUCTS (INCLUDING, BUT NOT LIMITED TO, STRUCTURAL WOOD BEAMS AND I-JOISTS) SHALL BE FABRICATED. HANDLED, AND INSTALLED IN ACCORDANCE WITH THE MANUFACTURER'S INSTRUCTIONS.

-JOISTS ARE NOT TO BE PLACED DIRECTLY OVER INTERIOR PARALLEL WALLS. (TO PREVENT UNEVEN FLOOR DEFLECTION FROM OCCURRING)

ALL WOOD BEAMS/HEADERS: 2x6's TO BE SPF STUD GRADE OR BETTER/ 2x8 OR LARGER TO BE SYP #2 | PER NDS 2012 | OR BETTER, U.O.N.

ALL HEADERS SHALL BE SUPPORTED BY (1) 2x JACK STUD AND (1) 2x KING STUD MINIMUM. THE NUMBER OF STUDS SPECIFIED AT A SUPPORT INDICATES THE NUMBER OF JACKS REQUIRED, U.N.O. AT FLUSH OR DROPPED BEAMS, THE NUMBER OF STUDS SPECIFIED INDICATES THE TOTAL NUMBER OF STUDS REQUIRED TO SUPPORT THE BEAM.

EXTERIOR WALLS TO BE 2x4 SPF STUD GRADE AT 16" O.C. UNLESS OTHERWISE NOTED (10'4-1/2" MAXIMUM WALL HEIGHT)

ALL INTERIOR BEARING WALLS AND WALLS AT BASEMENT & FIRST FLOOR STAIRWELLS, KITCHEN, BATH, & GARAGE TO BE 2x4 SPF STUD GRADE @ 16" o.c.; ALL OTHER NON-BEARING INTERIOR WALLS TO BE 2x4 SPF STUD GRADE @ 24" o.c. U.O.N.

ALL WALLS TO BE 3 1/2" UNLESS OTHERWISE NOTED.

PROVIDE SOLID BEARING TO FOUNDATION OR BEAM BELOW FOR ALL BEAMS, HEADERS & GIRDER TRUSSES. PROVIDE BLOCKING BETWEEN JOISTS AS REQUIRED.

SEE SELECTION SHEET FOR SIZE AND STYLE OF FIREPLACE. SEE FIREPLACE ELEVATION DETAIL FOR ADDITIONAL FRAMING REQUIREMENTS, IF ANY. CHECK SELECTION SHEETS FOR FLOOR COVERING AT TOP AND BOTTOM OF STAIR RISERS AND ADJUST RISERS AS REQ'D.

PROVIDE BLOCKING AT ALL HANDRAIL TERMINATION AND BRACKET LOCATIONS.

20-MINUTE FIRE RATED DOOR BETWEEN GARAGE AND LIVING AREA.

EXTERIOR WALL TO BE 2x4 SPF STUD G AT 16" o.c., UNLESS OTHERWISE NOTED (10'-0" MAXIMUM UNBRACED WALL HEIGHT).

ALL EXTERIOR WALLS AND INTERIOR BEARING WALLS, FRAMED HIGHER THAN THE STANDARD PLATE HEIGHT. SHALL BE FRAMED WITH CONTINUIOUS FULL HEIGHT STUDS TO THE HIGHEST CEILING (I.E. NO INTERMEDIATE BREAKS) TO PREVENT LATERAL HINGE CONDITIONS.

IN THE GARAGE, PROVIDE 1/2" GYP. BOARD AT ALL WALLS COMMON TO LIVING SPACE AND ALL STRUCTURAL MEMBERS SUPPORTING FLOOR/CEILING ASSEMBLY. GARAGE CEILING TO BE 1/2" SAG RESISTANT GYP. BOARD WHEN THERE ARE NO HABITABLE SPACES ABOVE, OR 5/8" TYPE X GYP. BOARD WHEN HABITABLE SPACES ARE ABOVE.

ALL EMERGENCY ESCAPE & RESCUE OPENINGS TO BE A MAXIMUM OF 44" OFF OF FINISHED FLOOR AND HAVE MINIMUM OPENING DIMENSIONS OF 24" IN HEIGHT, 20" IN WIDTH, & HAVE A MINIMUM OPENING AREA OF 5.7 S.F.

ALL DOORS TO BE 6'-8" TALL UNLESS OTHERWISE NOTED.

ALL GLASS IN INTERIOR AND EXTERIOR DOORS TO BE TEMPERED (INCLUDING SIDELITES AND TRANSOMS)

ALL LUMBER CONTACTING CONCRETE TO BE PRESSURE TREATED.

ALL FASTENERS, HANGERS, AND OTHER CONNECTORS TO BE USED WITH PRESSURE TREATED WOOD ARE TO HAVE ZMAX COATING (OR EQUIVALENT) HOT-DIPPED GALVANIZED OR STAINLESS STEEL.

AT STAIR HANDRAIL, ON ONE SIDE ONLY, SHALL BE CONTINUOUS FOR THE ENTIRE LENGTH OF THE STAIRWAY, AND ENDS SHALL BE RETURNED TO A WALL OR POST. THE HANDRAIL MAY BE INTERRUPTED AT A NEWEL POST AT A TURN.

ALL HANDRAIL GRIP PORTIONS SHALL NOT EXCEED 2-1/4" IN CROSS SECTIONAL DIMENSION.

HANDRAILS SHALL BE INSTALLED ON ALL STAIRS WITH 2 OR MORE RISERS, HANDRAIL HEIGHTS SHALL BE A MINIMUM OF 34" AND A MAXIMUM OF 38".

ALL STAIRS TO BE CONSTRUCTED SO AS NOT TO ALLOW A 4" SPHERE TO PASS THROUGH THE RISER.

GUARDRAILS MUST BE A MINIMUM OF 36" HIGH. GUARDRAILS AT THE OPEN SIDES OF STAIRS MUST BE A MINIMUM OF 34" HIGH MEASURED VERTICALLY FROM THE NOSING AT THE TREADS. THE HORIZONTAL SPACING OF THE VERTICAL BALUSTERS SHALL BE 4" O.C.

- GUARDRAIL DESIGN TO RESIST A MINIMUM OF 200 LBS LATERAL FORCE

## FI EVATION NOTES

WINDOW STYLE AND MULLIONS MAY VARY FROM ELEVATION DEPENDING UPON MANUFACTURER. STYLE, PATTERN, TYPE,

- USE SECONDARY HEAT BARRIER ON ALL DIRECT VENT FIREPLACES 7' OR LESS ABOVE A WALKWAY.

- GRADE AWAY FROM FOUNDATION WALLS SHALL FALL A MINIMUM OF 6" WITHIN THE FIRST 10'.

- PROVIDE TYVEK OR EQUIVALENT HOUSE WRAP BEHIND BRICK AND STONE VENEER OVER WOOD SHEATHING.

PROVIDE BRICK WEEP HOLES AT 24" O.C. WITH BRICK VENEER AND MORTER NET BEHIND AND THROUGH WEEP HOLES.

- PROVIDE FLASHING AND WEEP HOLES ABOVE ALL BRICK ANGLE IRONS, BELOW ALL BRICK SILLS AND ABOVE SILL PLATE

- EXTERIOR STEPS TO HAVE A MAXIMUM 8" RISER. WHEN VERTICAL RISE EXCEEDS 30" OR FOUR OR MORE CONTINUOUS RISERS, A HANDRAIL IS REQUIRED


#### **ROOF PLAN NOTES**

- ALL OVERHANGS TO HAVE (2) SOFFIT VENTS PER EACH 8' SOFFIT SECTION.

- PROVIDE BAFFLES AT EXTERIOR TRUSS BEARING FOR VENTILATION.

PROVIDE 15# FELT PAPER LINDER SHINGLES

# FOR STRUCTURE

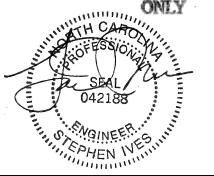

Space for Architect Seal

**RESIDENCE FOR:** 

# **MARKET**

**52 COMFORT COURT SERENITY** 

Drawing Scale: 1/8" = 1'0" House Name:

Job Number

Born on Date:

STY5-0037-00

Coord Name

**GREG PIEPER** 

the MEADOW II

10/13/22

Drawina Date

CDs Drawn By

**HOMES**<sub>sn</sub> Copyright © 2021 (2021) The Drees Company. All Rights Reserved 7701 Six Forks Road, Suite 132, Raleigh, NC 27615 Phone: [919] 844-9288

Elevation "B"

Coord Phone

Series

Plan No


859-578-4355


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CLASSIC

PLAN NM

Contract Drawn B



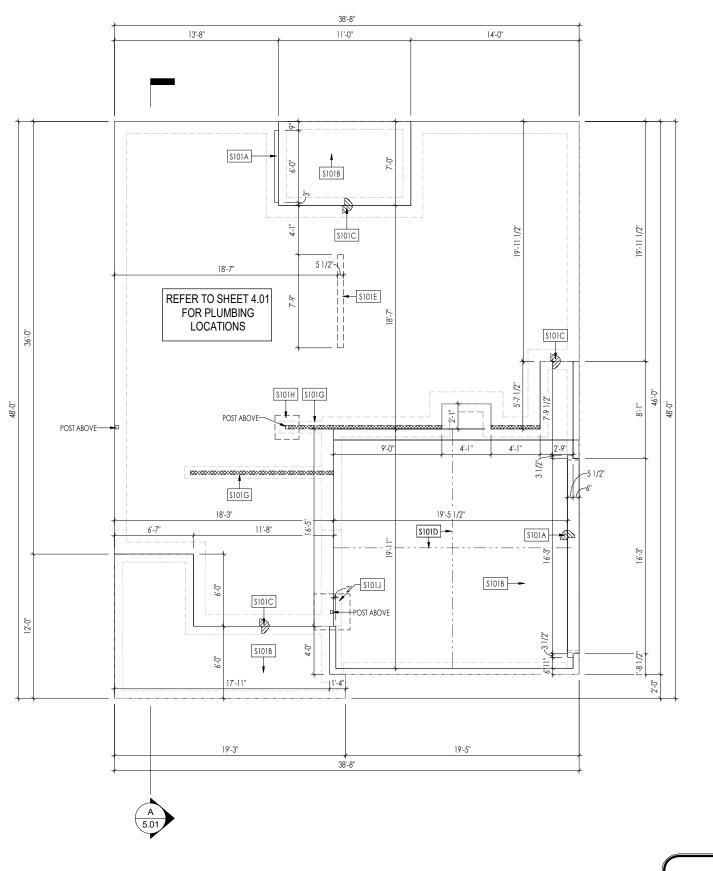

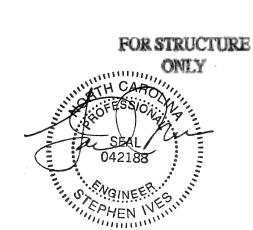Ceneral Notes:

1. REFER TO SHEET ON.1 FOR GENERAL NOTES.

Key Notes:

S101A 3/4" WEATHER LIP (1-1/2" @ SLIDING GLASS DOOR)

S101B SLOPE SLAB 1/8" PER FOOT

S101C DROP SLAB 3-1/2"

S101D SLAB CONTROL JOINT

S101E PROVIDE CONDUIT FOR ELECTRIC TO KITCHEN ISLAND

S101B 8%16" THICKENED PLAIN CONCRETE FOOTING UNDER BEARING WALL ABOVE

S101H 24"x24"x8" ENLARGED CONCRETE FOOTING UNDER POST ABOVE

S101J 36"x36"x12" PLAIN CONCRETE FOOTING UNDER POST ABOVE

Space for Architect Seal

RESIDENCE FOR:

# **MARKET**

52 COMFORT COURT

SERENITY

| Job Number: | Drawing Date: | Coord Name: | Coord Name:

the MEADOW II

06/29/2021 CDs Drawn By:

mation 1

859-578-4355

Plan No.:


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Phone: [191] 844-9288

Flower: [191] 944-9288



General Notes:

1. REFER TO SHEET ON.1 FOR GENERAL NOTES.

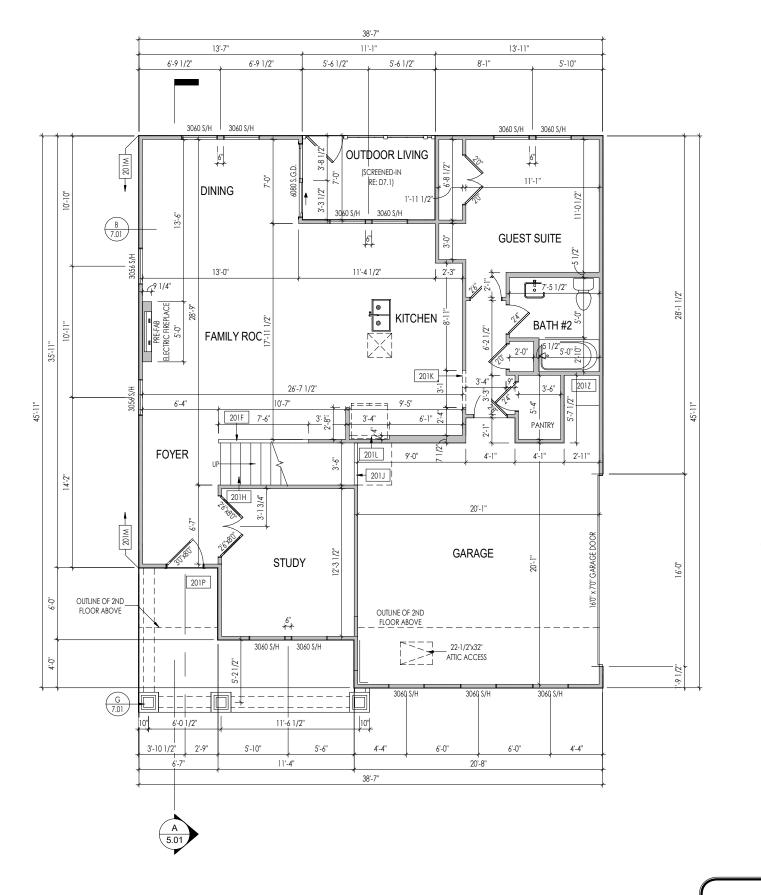2. ALL FIRST FLOOR CEILINGS TO BE 10"-1" ABOVE SUBFLOOR UNLESS OTHERWISE NOTED.

3. FRAME TOP OF ALL WINDOWS AT 1"-10" BELOW TOP OF PLATE UNLESS OTHERWISE NOTED.

3. FRAME TOP OF ALL WINDOWS AT 1'-10" BELOW TOP OF PLATE UNLESS OTHERWISE NOTED.

 4. ALL DROPPED, INTERIOR HEADERS (FALSE AND BEARING) ARE DROPPED 1'-3" FROM CEILING.

NEED HOLD TO SELECTION SHEETS FOR FLOORING MATERIAL PRIOR TO CONSTRUCTING STAIRS TO DETERMINE

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RISER HEIGHTS.
6. REFER TO SHEET 2.01S FOR STRUCTURAL INFORMATION.

#### Key Notes:

201F SLOPE WALL EVEN WITH TOP OF STAIR STRINGER, RAILING ABOVE

201H SEE DETAIL F/7.01 FOR STAIR FRAMING DETAILS

01J +/-7'-1 1/2" HIGH WALL UNDER STAIRS ABOVE

201K FRAME TOP OF OPENING AT HEIGHT SPECIFIED IN GENERAL NOTES ON THIS SHEET

201L REFRIG. HEADER HELD TO 6'-6" A.F.F.

201M PROVIDE 1/2" FIRE RATED PLYWOOD ON SIDE ELEVATIONS

201P CARPENTER TO DROP ELECTRICAL WIRE THROUGH PORCH CEILING FOR LIGHTS

201Z 18" HIGH WATER HEATER PLATFORM

Space for Architect Seal

FOR STRUCTURE

RESIDENCE FOR:

# **MARKET**

52 COMFORT COURT

SERENITY

Drawing Date: Coord

\$TY5-0037-00 10/13/22 GREG PIEPER

the MEADOW II

Job Number:

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CLASSIC
Plan No.:

859-578-4355

SSP PLAN\_NM

DICES
HOMES SM
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First Floor Framing PI
Elevation "B"

# LATERAL/WALL BRACING & WALL SHEATHING SPECIFICATIONS

THIS MODEL HAS BEEN DESIGNED TO RESIST LATERAL FORCES RESULTING FROM:

## 120 MPH WIND IN 2018 NCSBC MAP

(120 MPH WIND SPEED IN ASCE 7-10 WIND MAP, PER IRC R301.2.1.1) EXP. B & SEISMIC CAT. A/B.

#### EXT. WALL SHEATHING SPECIFICATION

- 7/16" OSB OR 15/32" PLYWOOD: FASTEN SHEATHING w/ 2-3/8"x 0.113 NAILS @ 6" O.C. AT EDGES & @ 12" O.C. IN THE PANEL FIELD. (TYP,
- ALL SHEATHING PANELS SHALL BE ORIENTED AND INSTALLED FULL HEIGHT OF SHEAR WALL OR 2x
  HORIZONTAL BLOCKING SHALL BE PROVIDED TO SUPPORT ALL UNSUPPORTED PANEL EDGES & EDGE
- ALL EXT. WALLS SHALL BE CONTINUOUSLY SHEATHED AND ARE CONSIDERED SHEAR WALLS.
- ALT. STAPLE CONNECTION SPEC: 1 3/4" 16 GA STAPLES
- (7/6" CROWN) @ 3" O.C. AT EDGES & @ 6" O.C IN FIELD.

#### 3" O.C. EDGE NAILING

• AT DESIGNATED AREAS - FASTEN PANEL EDGES OF WOOD STRUCTURAL WALL SHEATHING TO FRAMING W/ 2-3/8"x 0.113 NAILS @ 3" O.C. NO STAPLE ALTERNATIVE AVAILABLE AT THIS SPEC . ALL SHEATHING PANELS SHALL BE ORIENTED AND INSTALLED FULL HEIGHT OF SHEAR WALL OR 2x HORIZONTAL BLOCKING SHALL BE PROVIDED TO SUPPORT UNSUPPORTED PANEL EDGES AND 3" O.C. EDGE FASTENING.


- SEE CONNECTION SPECIFICATIONS CHART FOR STANDARD SHEAR TRANSFER DETAILING. IF ADDITIONAL CAPACITY IS REQUIRED BY DESIGN, IT WILL BE SPECIFICALLY NOTED ON PLAN.
- DESIGN ASSUMES 16" O.C MAX. STUD SPACING, U.N.O. ALL STRUCTURAL PANELS ARE TO BE DIRECTLY APPLIED TO STUD FRAMING.
- PRE-MANUFACTURED PANELIZED WALLS: FASTEN TOGETHER END STUDS OF WALL PANELS SHEATHED w/ OSB OR PLYWOOD w/ 10d NAILS @ 4" O.C. (THRU ONE SIDE ONLY)

INDICATES EXTENT OF INT. OSB SHEARWALL. AND/OR 3" O.C. EDGE NAILING

► INDICATES HOLDOWN

\* INDICATES POST ABOVE (P.A.) PROVIDE SOLID BLOCKING UNDER POST OR JAMB ABOVE.

> Rated windows. See last page

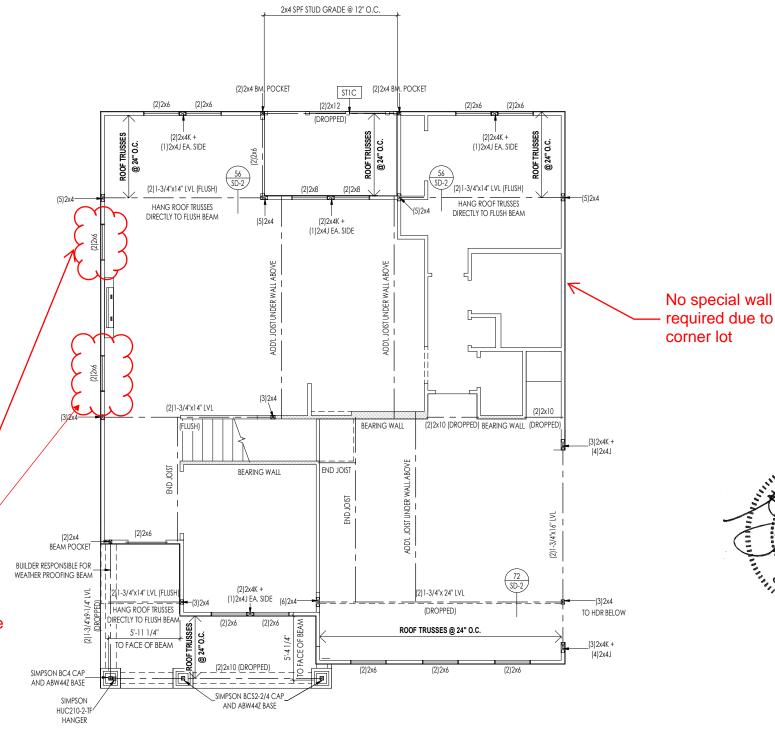

General Notes:

. REFER TO SHEET ON.1 FOR GENERAL NOTES.

Key Notes:

TIC FRAME TOP OF BEAM AT 9'-1" ABOVE FIRST FLOOR SUBFLOOR/SLAB

CONNECTION SPECIFICATIONS (TYP. U.N.O.) NOTE: 10d NAIL = 3" x 0.131" GUN NAIL (3)10d TOENAILS OLE PLATE TO JOIST/BLK'G. 10d NAILS @ 6" o.c. UD TO SOLE PLATE (3) 10d TOENAILS OP OR SOLE PLATE TO STUD M TO TOP PLATE 10d TOENAILS @ 6" o.c K'G. BTWN. JOISTS TO TOP PL (3)10d TOENAILS (3)10d TOENAILS + (1) SIMPSON H2.5A AFTER/TRUSS TO TOP PLATE AB. END TRUSS TO DBL. TOP PL 10d TOENAILS @ 8" o.c. 2x10 BLK EVERY 3RD BAY FASTENED TO DBL. TOP PLATE T. w/ HEEL HT. 9 1/4" TO 12" 2x12 BLK EVERY 3RD BAY FASTENED TO DBL. TOP PLATE T. w/ HEEL HT. 12" TO 16" w/ 10d TOENAILS @ 6" O.C LAP WALL SHTG. w/ DBL. TOP PL. & INSTALL ON TRUSS VERT. FASTEN w/ 8d NAILS @ 6" O.C. T. w/ HEEL HT. UP TO 24" LAP WALL SHTG. w/ DBL. TOP PL. & INSTALL ON TRUSS VERT. T. w/ HEEL HT. 24" TO 48" FASTEN w/ 8d NAILS @ 6" O.C. PROVIDE 2x BLK @ EA. BAY AT OUBLE STUD 10d NAILS @ 24" o.c. 10d NAILS @ 24" o.c. OUBLE TOP PLATE (10)10d NAILS IN LAPPED AREA OUBLE TOP PLATE LAP SPLICE OP PLATE LAP @ CORNERS & NTERSECTING WALLS (2)10d NAILS WALL SHTG. LAP w/ SILL PL. & FASTENED PER SHEAR WALL FASTENING SPEC. VALL TO FOUNDATION

Space for Architect Seal

FOR STRUCTURE

# **MARKET**

10/13/22 STY5-0037-00 **GREG PIEPER** 859-578-4355

the MEADOW II

Job Number:

Plan No.

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Elevation "B"

DWW

CLASSIC

PLAN NM

**REISSUED:** 10/24/2022


WALLE OF THE STATE OF THE STATE

# **RESIDENCE FOR:**

**52 COMFORT COURT** 

Drawina Date

7701 Six Forks Road, Suite 132, Raleigh, NC 27615 Phone: [919] 844-9288

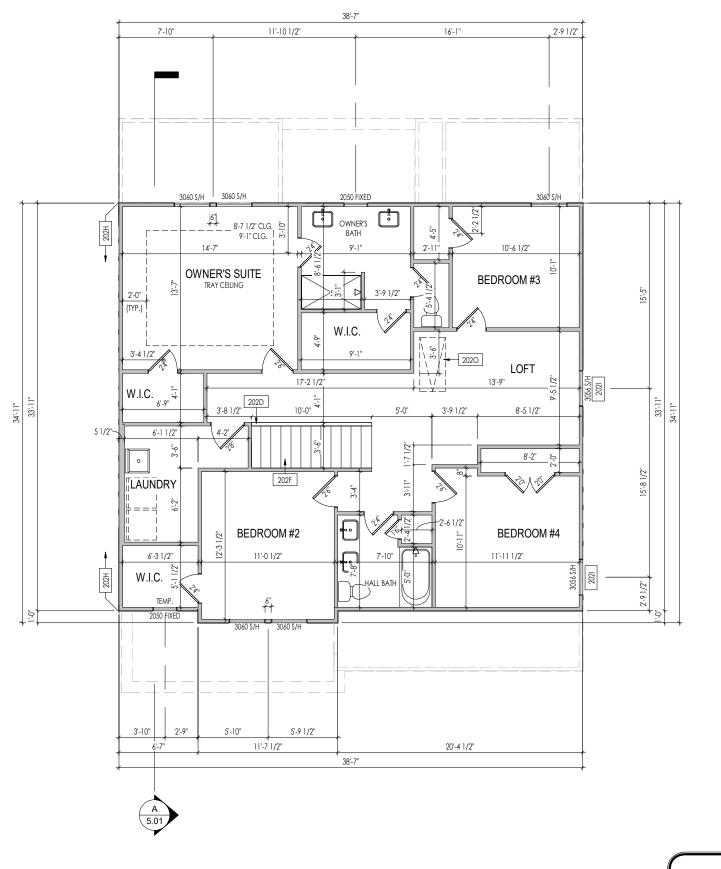

General Notes:

. REFER TO SHEET ON.1 FOR GENERAL NOTES.

2. ALL SECOND FLOOR CEILINGS TO BE 5-1" ABOVE SUBFLOOR UNLESS OTHERWISE NOTED.

3. FRAME TOP OF ALL WINDOWS AT 1'-0 1/4" BELOW TOP OF PLATE UNLESS OTHERWISE NOTED.

4. ALL DROPPED, INTERIOR HEADERS (FALSE AND BEARING) ARE DROPPED 1'-0" FROM CEILING. 5. REFER TO SELECTION SHEETS FOR FLOORING MATERIAL PRIOR TO CONSTRUCTING STAIRS TO DETERMINE

RISER HEIGHTS.

6. REFER TO SHEET 2.02S FOR STRUCTURAL INFORMATION.

Key Notes:

202D 36" HIGH WALL

202F SEE DETAIL F/7.01 FOR STAIR FRAMING DETAILS

202H PROVIDE 1/2" FIRE RATED PLYWOOD ON SIDE ELEVATIONS

2021 FRAME TOP OF WINDOWS AT 0'6-1/2" BELOW TOP OF PLATE

1020 PULL DOWN ATTIC ACCESS STAIRS (25-1/2" x 54") WITH LIGHT AND OUTLET

Space for Architect Seal

FOR STRUCTURE

RESIDENCE FOR:

# **MARKET**

**52 COMFORT COURT** 

**SERENITY** 

Job Number: Coord Name: Drawing Date: 10/13/22 **GREG PIEPER** STY5-0037-00

the MEADOW II

CLASSIC Plan No.: PLAN NM

859-578-4355

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Elevation "B"

## LATERAL/WALL BRACING & WALL SHEATHING SPECIFICATIONS

THIS MODEL HAS BEEN DESIGNED TO RESIST LATERAL FORCES RESULTING FROM:

## 120 MPH WIND IN 2018 NCSBC MAP

(120 MPH WIND SPEED IN ASCE 7-10 WIND MAP, PER IRC R301.2.1.1) EXP. B & SEISMIC CAT. A/B.

#### EXT. WALL SHEATHING SPECIFICATION

7/16" OSB OR 15/32" PLYWOOD: • FASTEN SHEATHING w/ 2-3/8"x 0.113 NAILS @ 6" O.C. AT EDGES & @ 12" O.C. IN THE PANEL FIELD. (TYP,

ALL SHEATHING PANELS SHALL BE ORIENTED AND
INSTALLED FULL HEIGHT OF SHEAR WALL OR 2X
HORIZONTAL BLOCKING SHALL BE PROVIDED TO SUPPORT ALL UNSUPPORTED PANEL EDGES & EDGE

ALL EXT. WALLS SHALL BE CONTINUOUSLY SHEATHED AND ARE CONSIDERED SHEAR WALLS.

" 16 GA STAPLES 33 ALT. STAPLE CONNECTION SPEC: 1 "CROWN) @ 3" O.C. AT EDGES & @ 6" O.C IN FIELD.12\(\)\(\)

#### 3" O.C. EDGE NAILING

AT DESIGNATED AREAS - FASTEN PANEL EDGES OF . WOOD STRUCTURAL WALL SHEATHING TO FRAMING W/ NO STAPLE ALTERNATIVE NAILS @ 3" O.C. 2-3/8"x 0.113 ALL SHEATHING PANELS SHALL AVAILABLE AT THIS SPEC BE ORIENTED AND INSTALLED FULL HEIGHT OF SHEAR WALL OR 2x HORIZONTAL BLOCKING SHALL BE PROVIDED TO SUPPORT UNSUPPORTED PANEL EDGES AND 3" O.C. EDGE FASTENING.

SEE CONNECTION SPECIFICATIONS CHART FOR • STANDARD SHEAR TRANSFER DETAILING. IF ADDITIONAL CAPACITY IS REQUIRED BY DESIGN, IT WILL BE SPECIFICALLY NOTED ON PLAN.

DESIGN ASSUMES 16" O.C MAX. STUD SPACING, U.N.O. • ALL STRUCTURAL PANELS ARE TO BE DIRECTLY APPLIED . TO STUD FRAMING.


PRE-MANUFACTURED PANELIZED WALLS: FASTEN TOGETHER END STUDS OF WALL PANELS SHEATHED w/ OSB OR PLYWOOD w/ 10d NAILS @ 4" O.C. (THRU ONE SIDE ONLY)


INDICATES EXTENT OF INT. OSB SHEARWALL, AND/OR 3" O.C. EDGE NAILING

INDICATES HOLDOWN

ABOVE.

INDICATES POST ABOVE (P.A.) PROVIDE \* SOLID BLOCKING UNDER POST OR JAMB

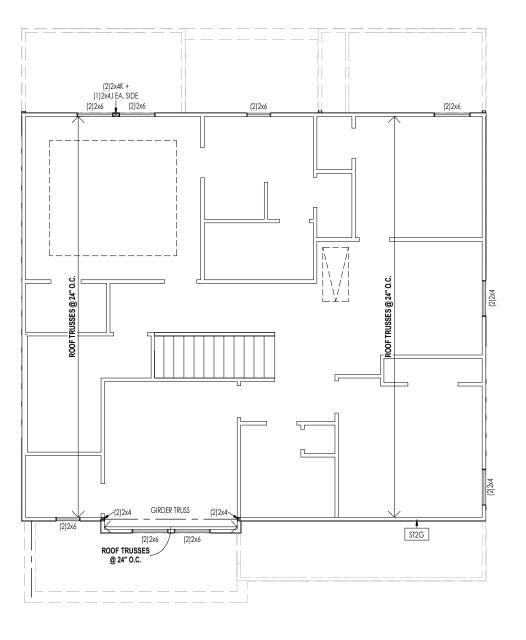

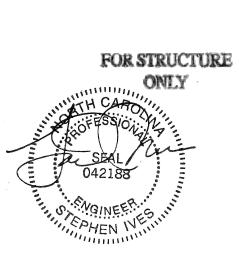

General Notes:

. REFER TO SHEET ON.1 FOR GENERAL NOTES.

Key Notes:

TZG PROVIDE CONT. SHTG, BEHIND LOW ROOF TRUSSES DOWN TO SECOND FLOOR SOLE PLATE (TYP.)

CONNECTION SPECIFICATIONS (TYP. U.N.O.) NOTE: 10d NAIL = 3" x 0.131" GUN NAIL (3)10d TOENAILS OLE PLATE TO JOIST/BLK'G. 10d NAILS @ 6" o.c UD TO SOLE PLATE (3) 10d TOENAILS OP OR SOLE PLATE TO STUD M TO TOP PLATE 10d TOENAILS @ 6" o.c. LK'G. BTWN. JOISTS TO TOP PL (3)10d TOENAILS (3)10d TOENAILS + (1) SIMPSON H2.5A AFTER/TRUSS TO TOP PLATE SAB, END TRUSS TO DBL, TOP PL 10d TOENAILS @ 8" o.c. 2x10 BLK EVERY 3RD BAY FASTENED TO DBL. TOP PLATE T. w/ HEEL HT. 9 1/4" TO 12" 2x12 BLK EVERY 3RD BAY FASTENED TO DBL. TOP PLATE T. w/ HEEL HT. 12" TO 16" w/ 10d TOENAILS @ 6" O.C LAP WALL SHTG. w/ DBL. TOP PL. & INSTALL ON TRUSS VERT. FASTEN w/ 8d NAILS @ 6" O.C. T. w/ HEEL HT. UP TO 24" LAP WALL SHTG. w/ DBL. TOP PL. & INSTALL ON TRUSS VERT. T. w/ HEEL HT. 24" TO 48" FASTEN w/ 8d NAILS @ 6" O.C. PROVIDE 2x BLK @ EA. BAY AT TOP OF HEEL OUBLE STUD 10d NAILS @ 24" o.c. 10d NAILS @ 24" o.c. OUBLE TOP PLATE (10)10d NAILS IN LAPPED AREA OUBLE TOP PLATE LAP SPLICE TOP PLATE LAP @ CORNERS & NTERSECTING WALLS (2)10d NAILS WALL SHTG. LAP w/ SILL PL. & FASTENED PER SHEAR WALL FASTENING SPEC. VALL TO FOUNDATION

Space for Architect Seal

**RESIDENCE FOR:** 

**52 COMFORT COURT** 

Job Number Drawina Date: Coord Name: STY5-0037-00 10/13/22 **GREG PIEPER** 859-578-4355 Drawing Scale: 1/8" = 1'0" DWW

> CLASSIC Plan No. PLAN NM

Elevation "B"

**REISSUED:** 10/24/2022

**MARKET** 


the MEADOW II

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	5.1	POT VENT (TYP.)
204F }		8:12
		1'-0"
	11:0"	204L 8:12 8:12 8:12 8:12 8:12 8:12 8:12 1:0'

	HEEL CUT STANDARDS						
		OVER	HANG				
		1'-0"	2'-0"				
	4:12	3-3/4"	7-3/4"				
	5:12	4-3/4"	9-3/4"				
	6:12	5-3/4"	11-3/4"				
F	7:12	6-3/4"	13-3/4"				
PITCH	8:12	7-3/4"	N/A				
ROOF	9:12	8-3/4"	N/A				
2	10:12	9-3/4"	N/A				
	12:12	11-3/4"	N/A				
	14:12	13-3/4"	N/A				



**REISSUED:** 10/24/2022

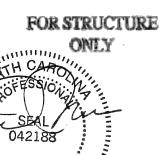ROOF VENTILATION			
CITY/SERIES:	RALEIGH		
	MAIN HOUSE	LOWER	GARAGE
OTAL ATTIC AREA:	1,471	312	128
REQUIRED NET FREE VENTILATION (ATTIC AREA/300):	4.90	1.04	0.43
ACTUAL NET FREE VENTILATION (UPPER + LOWER):	5.71	2.90	0.54
DOWNSPOUT CALCULATION			
	MAIN HOUSE	LOWER	GARAGE
OTAL DRAINABLE ROOF AREA:	1912.3	405.6	166.4
MINIMUM # OF DOWNSPOUTS:	4	1	1
	4	1	100

		G
N	IDARDS	
ŀ	HANG	1. R
	2'-0"	Κe
	7-3/4"	204/
	9-3/4"	204F
	11-3/4"	2041
	13-3/4"	
	N/A	
	N/A	
	N/A	С

$\neg$		Ge	neral Notes:			
1. REFER TO SHEET ON.1 FOR GENERAL NOTES.						
		Ke	y Notes:			
		204A	VALLEY TRUSS OVER FRAMING @ 24" O.C.			
		204F	4-0"(MIN.) OF FIRE RETARDENT TREATED ROOF SHEATHING. NO PENETRATION ALLOWED WITHEN 4" OF EXTERIOR WALL - SEE DETAIL A/7.03 FOR FIRE BLOCKING AT SOFFIT			
4		204L	NO ROOF DECKING UNDER OVERFRAMING IN THIS AREA TO ALLOW FOR PROPER ATTIC VENTILATION			
4						

CONNECTION SPE	CIFICATIONS (TYP. U.N.O.)			
NOTE	E: 10d NAIL = 3" x 0.131" GUN NAIL			
JOIST TO SOLE PLATE	(3)10d TOENAILS			
SOLE PLATE TO JOIST/BLK'G.	10d NAILS @ 6" o.c.			
STUD TO SOLE PLATE	(3)10d TOENAILS			
TOP OR SOLE PLATE TO STUD	(3)10d NAILS			
RIM TO TOP PLATE	10d TOENAILS @ 6" o.c.			
BLK'G. BTWN. JOISTS TO TOP PL.	(3)10d TOENAILS			
RAFTER/TRUSS TO TOP PLATE	(3)10d TOENAILS + (1) SIMPSON H2.5A			
GAB. END TRUSS TO DBL. TOP PL.	10d TOENAILS @ 8" o.c.			
R.T. w/ HEEL HT. 9 1/4" TO 12"	2x10 BLK EVERY 3RD BAY FASTENED TO DBL. TOP PLATE w/ 10d TOENAILS @ 6" O.C.			
R.T. w/ HEEL HT. 12" TO 16"	2x12 BLK EVERY 3RD BAY FASTENED TO DBL. TOP PLATE w/ 10d TOENAILS @ 6" O.C.			
R.T. w/ HEEL HT. UP TO 24"	LAP WALL SHTG. w/ DBL. TOP PL. & INSTALL ON TRUSS VERT FASTEN w/ 8d NAILS @ 6" O.C.			
R.T. w/ HEEL HT. 24" TO 48"	LAP WALL SHTG. w/ DBL. TOP PL. & INSTALL ON TRUSS VERT FASTEN w/ 8d NAILS @ 6" O.C. PROVIDE 2x BLK @ EA. BAY AT TOP OF HEEL			
DOUBLE STUD	10d NAILS @ 24" o.c.			
DOUBLE TOP PLATE	10d NAILS @ 24" o.c.			
DOUBLE TOP PLATE LAP SPLICE	(10)10d NAILS IN LAPPED AREA			
TOP PLATE LAP @ CORNERS & INTERSECTING WALLS	(2)10d NAILS			
WALL TO FOUNDATION	WALL SHTG, LAP w/ SILL PL. & FASTENED PER SHEAR WALL FASTENING SPEC.			

Space for Architect Seal

RESIDENCE FOR:

# **MARKET**

**52 COMFORT COURT** 


SERENITY

Job Number:	Drawing Da	ite:	Coord Name	9:	Coord Phone:
STY5-0037-00	1	0/13/22	GREG	PIEPER	859-578-4355
House Name:	Contract Drawn By:				
					DWW
the ME	Series: CLASSIC				
					Plan No.:
Born on Date:	06/29/2021	CDs Drawn	Bv:	SSP	PLAN NM

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- . REFER TO SHEET ON.1 FOR GENERAL NOTES.
- 2. FLOOR JOISTS TO BE 14" TJI 5000 SERIES, OR EQUAL, @ 19.2 O.C. UNLESS OTHERWISE NOTED.
- 3. JOISTS ARE NOT TO BE PLACE DIRECTLY OVER INTERIOR PARALLEL WALL.
- (TO PREVENT UNEVEN FLOOR DEFLECTION FROM OCCURRING)
  4. ADD'L JOISTS MAY BE LOCATED UP TO 2" AWAY FROM THE PARTITION WALL ABOVE IN CASES WHERE MECHANICAL PENETRATIONS

## Key Notes:

302A BEARING WALL BELOW

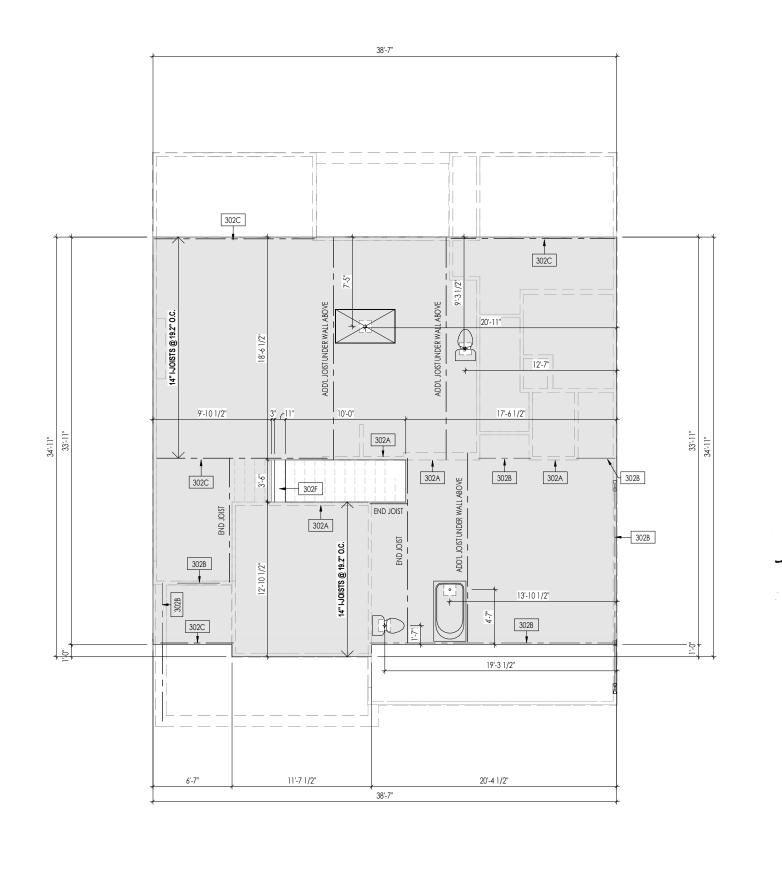302B BEAM BELOW - SEE SHEET 2.01S FOR MORE INFO

302C FLUSH BEAM - SEE SHEET 2.01S FOR MORE INFO

302F (2)2x8 (TOP FLUSH) NEXT TO 2x12 FLAT FRAME FOR STAIR HEADROOM - SEE DETAIL E/7.01

FOR STRUCTURE

Space for Architect Seal

RESIDENCE FOR:

# **MARKET**

**52 COMFORT COURT** 

**SERENITY** 

Job Number: Coord Name: Drawing Date: **GREG PIEPER** STY5-0037-00 10/13/22 859-578-4355

# the MEADOW II


CLASSIC Plan No.: PLAN NM

DWW

**HOMES**<sub>SM</sub>

Elevation "B"

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Ş ⇒ 220 VOLT OUTLET → WALL MOUNTED LIGHT FIXT. GAS GAS HOOK UP - DOUBLE SPOTLIGHT FIXT. ⊕ FLOOR DRAIN B⊕ GFCI OUTLET FLOOR OUTLET DIRECTIONAL CAN LIGHT SD SMOKE DETECTOR
CO CO DETECTOR (TV) CABLE TELEVISION JACK (•) PIN LIGHT SMOKE DETECTOR/ CO DETECTOR COMBINATION ← SINGLE POLE SWITCH ₩ALL SCONCE @ 5'-6" A.F.F. ⇔ 3-WAY SWITCH FLUORESCENT LIGHT UNDER CABINET LIGHTING EXHAUST FAN AND LIGHT COMBINATION BLOCK, MOUNT, & SWITCH FOR FUTURE FAN/LIGHT COMBINATION (CENTER, UNLESS OTHERWISE NOTED) O CLG. MTD. EXHAUST FAN Space for Architect Seal RESIDENCE FOR: **MARKET 52 COMFORT COURT SERENITY** Job Number: Coord Name: Drawing Date: **GREG PIEPER** STY5-0037-00 10/13/22 859-578-4355 House Name: Drawing Scale: 1/8" = 1'0" DWW the MEADOW II CLASSIC Plan No.: PLAN NM **HOMES**<sub>SM</sub> Copyright © 2021 (2021) The Drees Company. All Rights Reserved. 7701 Six Forks Road, Suite 132, Raleigh, NC 27615 Phone: [919] 844-9288 Elevation "B"

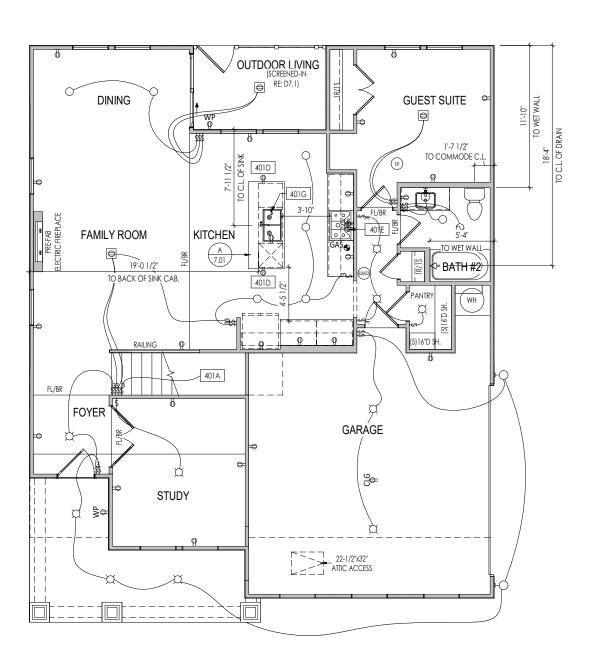General Notes:

Key Notes:
401A TO SWITCH OR LIGHT ABOVE
401D HOLD OUTLET HIGH ON ISLAND

■ PHONE JACK
⇒ WALL OUTLET

₩EATHERPROOF GFCI OUTLET

. REFER TO SHEET ON.1 FOR GENERAL NOTES.

401E OUTLET FOR RANGE HOOD/MICROWAVE HELD HIGH

MECHANICAL LEGEND


401G PUSH BUTTON FOR GARBAGE DISPOSAL OR SWITCH LOCATED IN SINK CABINET - REFER TO SELECTIONS

CLG. MOUNTED LIGHT FIXT.

SURFACE MOUNT DISC LIGHT OR RECESSED CEILING LIGHT, PER SPECS. STAIR LIGHT


SHOWER HEAD

+ HOSE BIB

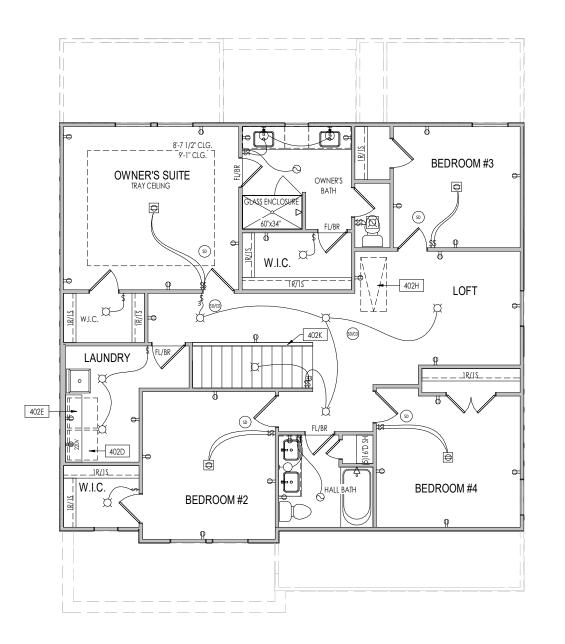

General Notes: . REFER TO SHEET ON.1 FOR GENERAL NOTES. Key Notes: 402D LOCATE WASHER TO LEFT OF DRYER 402E 16" DEEP x 5'-6" LONG SHELF HELD AT 5'-7" A.F.F. 402H PULL DOWN ATTIC ACCESS STAIRS W/ LIGHT AND OUTLET 402K HALF WALL WITH WOOD CAP MECHANICAL LEGEND ■ PHONE JACK
⇒ WALL OUTLET CLG. MOUNTED LIGHT FIXT. ■ STAIR LIGHT SURFACE MOUNT DISC LIGHT OR RECESSED CEILING LIGHT, PER SPECS. + HOSE BIB ₩EATHERPROOF GFCI OUTLET SHOWER HEAD Ş ⇒ 220 VOLT OUTLET → WALL MOUNTED LIGHT FIXT. GAS GAS HOOK UP - DOUBLE SPOTLIGHT FIXT. ⊕ FLOOR DRAIN B⊕ GFCI OUTLET FLOOR OUTLET DIRECTIONAL CAN LIGHT SD SMOKE DETECTOR
CO CO DETECTOR (TV) CABLE TELEVISION JACK (•) PIN LIGHT SMOKE DETECTOR/ CO DETECTOR COMBINATION ← SINGLE POLE SWITCH ₩ALL SCONCE @ 5'-6" A.F.F. ⇔ 3-WAY SWITCH FLUORESCENT LIGHT UNDER CABINET LIGHTING EXHAUST FAN AND LIGHT COMBINATION BLOCK, MOUNT, & SWITCH FOR FUTURE FAN/LIGHT COMBINATION (CENTER, UNLESS OTHERWISE NOTED) O CLG. MTD. EXHAUST FAN Space for Architect Seal RESIDENCE FOR: **MARKET 52 COMFORT COURT SERENITY** Job Number: Coord Name: Drawing Date: 10/13/22 **GREG PIEPER** 859-578-4355 STY5-0037-00 DWW the MEADOW II CLASSIC Plan No.: PLAN NM **HOMES**<sub>SM</sub> Copyright © 2021 (2021) The Drees Company. All Rights Reserved. 7701 Six Forks Road, Suite 132, Raleigh, NC 27615 Phone: [919] 844-9288 Elevation "B"



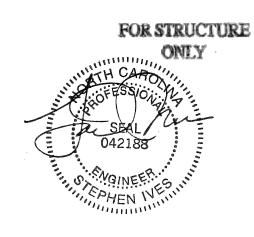

BUILDING SECTION THRU STAIRS

1/8" = 1'-0"

**REISSUED:** 10/24/2022

	General Notes:	
	1. REFER TO SHEET ON.1 FOR GENERAL NOTES.	
	1. KE EK TO STILLE GIV. I FOR OLIVENVE NOTES.	
	Key Notes:	
	Space for Architect Seal	
	RESIDENCE FOR:	
	MARKET	
	52 COMFORT COURT	
	SERENITY	
	Job Number: Drawing Date: Coord Name:	Coord Phone:
	STY5-0037-00   10/13/22   GREG PIEPER	859-578-4355
	House Name: Drawing Scale: 1/8" = 1'0"	Contract Drawn By:
	the MEADOW II	Series:
		CLASSIC Plan No.:
	Born on Date:         06/29/2021         CDs Drawn By:         SSP	PLAN_NM
		5.01
	HOMES	.UI
		uilding Section
- 1		

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Elevation "B"

# RECTANGULAR LOUVER D1T -6" CORNER TRIM RECTANGULAR LOUVER D1T 6" CORNER TRIM-

**ELEVATION 'B'** 

TYPICAL TRIM:

6" FASCIA (ALL SIDES)

8" FRIEZE (FRONT ONLY, UNLESS OTHERWISE NOTED)

General Notes:

. REFER TO SHEET ON.1 FOR GENERAL NOTES.

2. ROOFING MATERIAL PER SELECTIONS.
3. CONTACT M&K ENGINEERING FOR HEADER SIZE/BRICK SUPPORT IF GRADE DROPS AND THE AMOUNT OF BRICK OVER GARAGE DOOR SHOWN ON CURRENT ELEVATION IS NO LONGER ACCURATE

Key Notes:

#### BRICK VENEER LINTEL SCHEDULE HEIGHT OF VENEER ABOVE LINTEL STEEL ANGLE SIZE L3-1/2 x3-1/2 x1/4 20 FT. MAX Up to 3'-6" L5x 3-1/2x 5/16 (LLV) Up to 6'-0" 20 FT. MAX L6x 3- 1/2x 3/8 (LLV) 20 FT. MAX Up to 8'-0" L7x 4x 3/8 (LLV) 9'-0" 12 FT. MAX \*16'-0" L7x 4x 3/8 (LLV) 3 FT. MAX L8x 4x 1/2 (LLV) \*16'-0" 4-1/2 FT. MAX


ALL LINTELS <=6' SHALL HAVE 4" MINIMUM BEARING AT EACH END.

ALL LINTELS >=6' SHALL HAVE 8" MINIMUM BEARING AT EACH END.

\* FASTENED TO HDR @ 1/3 SPAN POINTS THRU 1-1/2 "LONG VERTICALLY SLOTTED HOLES IN LINTEL W/ 1/2" DIA. x 3-1/2 " LONG LAG SCREWS. LOCATE LAG SCREWS @ MIDDLE OF SLOTTED HOLE & TIGHTEN SCREWS ENOUGH TO ALLOW MOVEMENT OF LINTEL.

\*\*ANY LINTEL CONDITION NOT SPECIFIED ABOVE SHALL BE DESIGNED

Space for Architect Seal

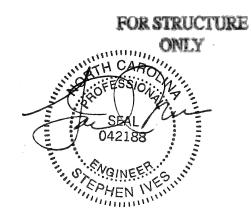

RESIDENCE FOR:

# **MARKET**

**52 COMFORT COURT** 

**SERENITY** 

Job Number: Drawing Date: **GREG PIEPER** STY5-0037-00 10/13/22 859-578-4355 House Name: DWW

# the MEADOW II


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Elevation "B"

Plan No.:

CLASSIC

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4*CORRECT RINA  6*TRINA	TYPICAL TRIM:  6" FASCIA (ALI 3DES)  8" FRIEZE (FRONT ONLY, UNIESS OTHERWISE NOTED)  FOR STRUCTURE ONLY  SEAL  042188
	REISSUED: 10/24/2022

# ASCIA L SIDES)
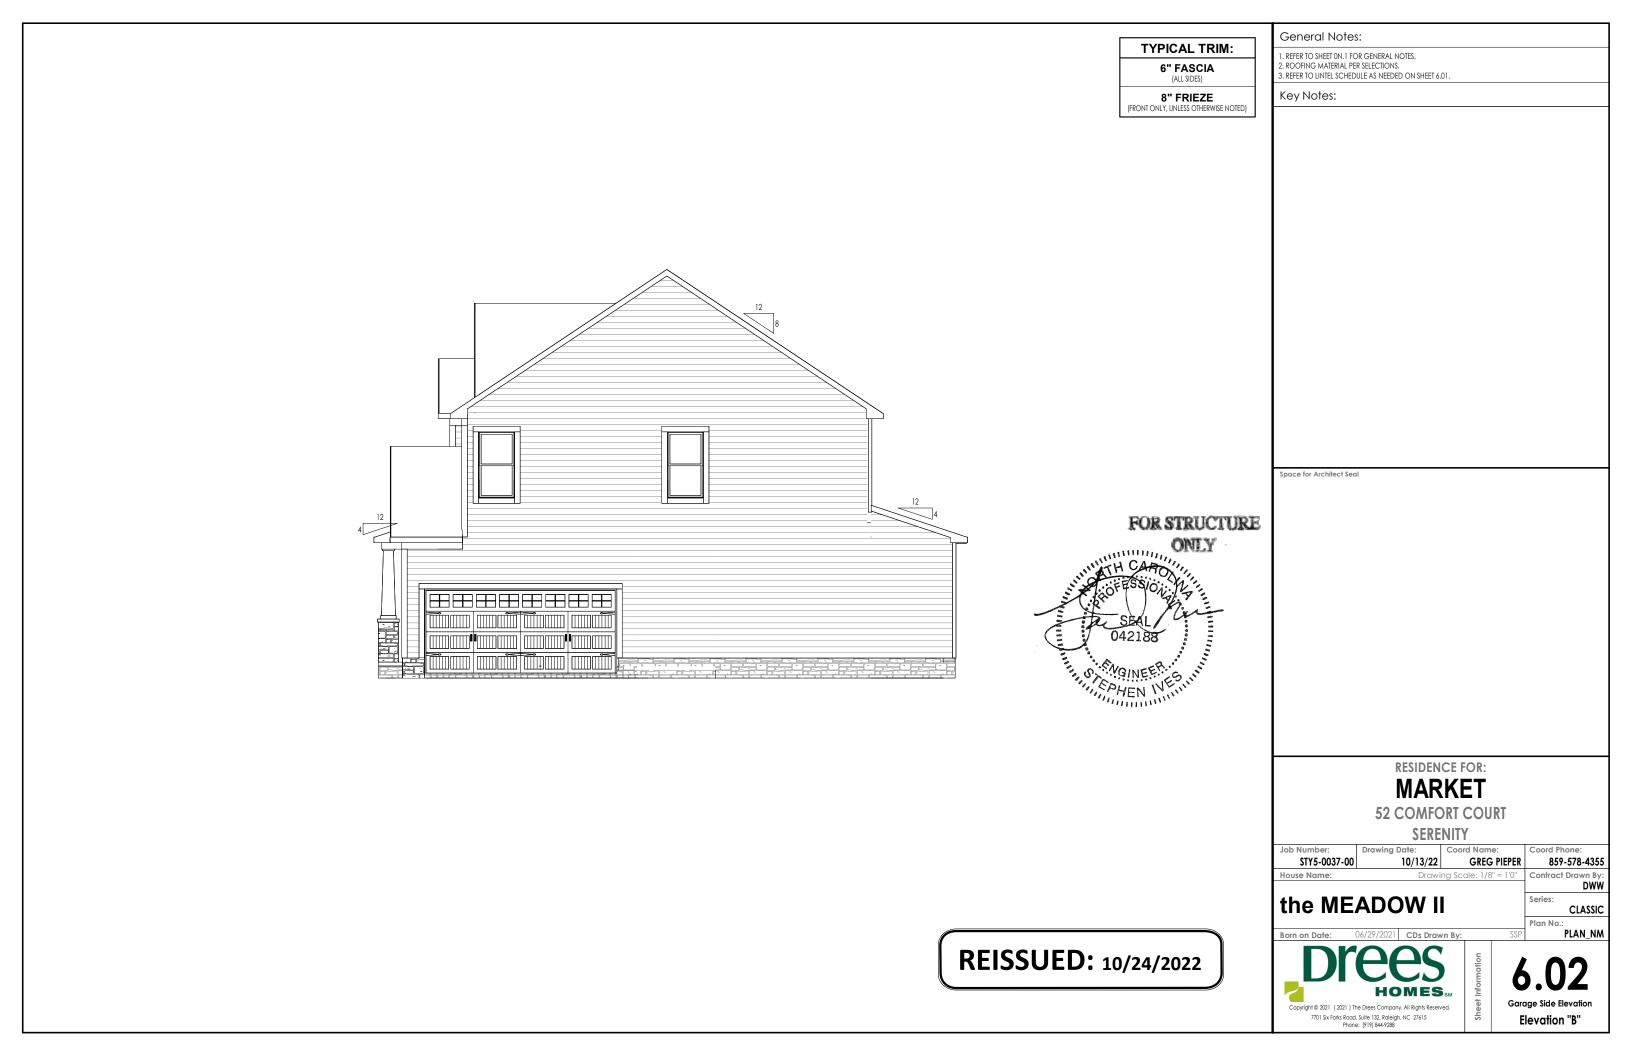
## AL TRIM:

- General Notes:
- 1. REFER TO SHEET ON.1 FOR GENERAL NOTES. 2. ROOFING MATERIAL PER SELECTIONS. 3. REFER TO LINTEL SCHEDULE AS NEEDED ON SHEET 6.01.

Key Notes:

Space for Architect Seal

RESIDENCE FOR:

# **MARKET**

**52 COMFORT COURT** 

**SERENITY** 

Drawing Date: Coord Name: Job Number: 10/13/22 GREG PIEPER STY5-0037-00 Drawing Scale: 1/8" = 1'0" Contract Drawn By:

# the MEADOW II

CLASSIC Plan No.: PLAN\_NM


859-578-4355


DWW


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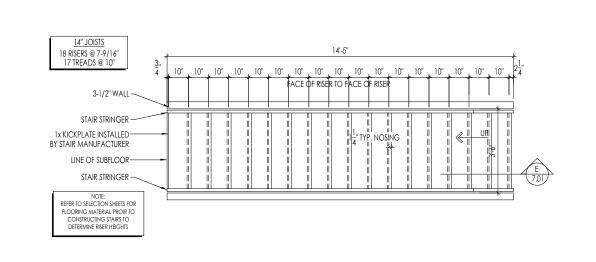
Elevation "B"






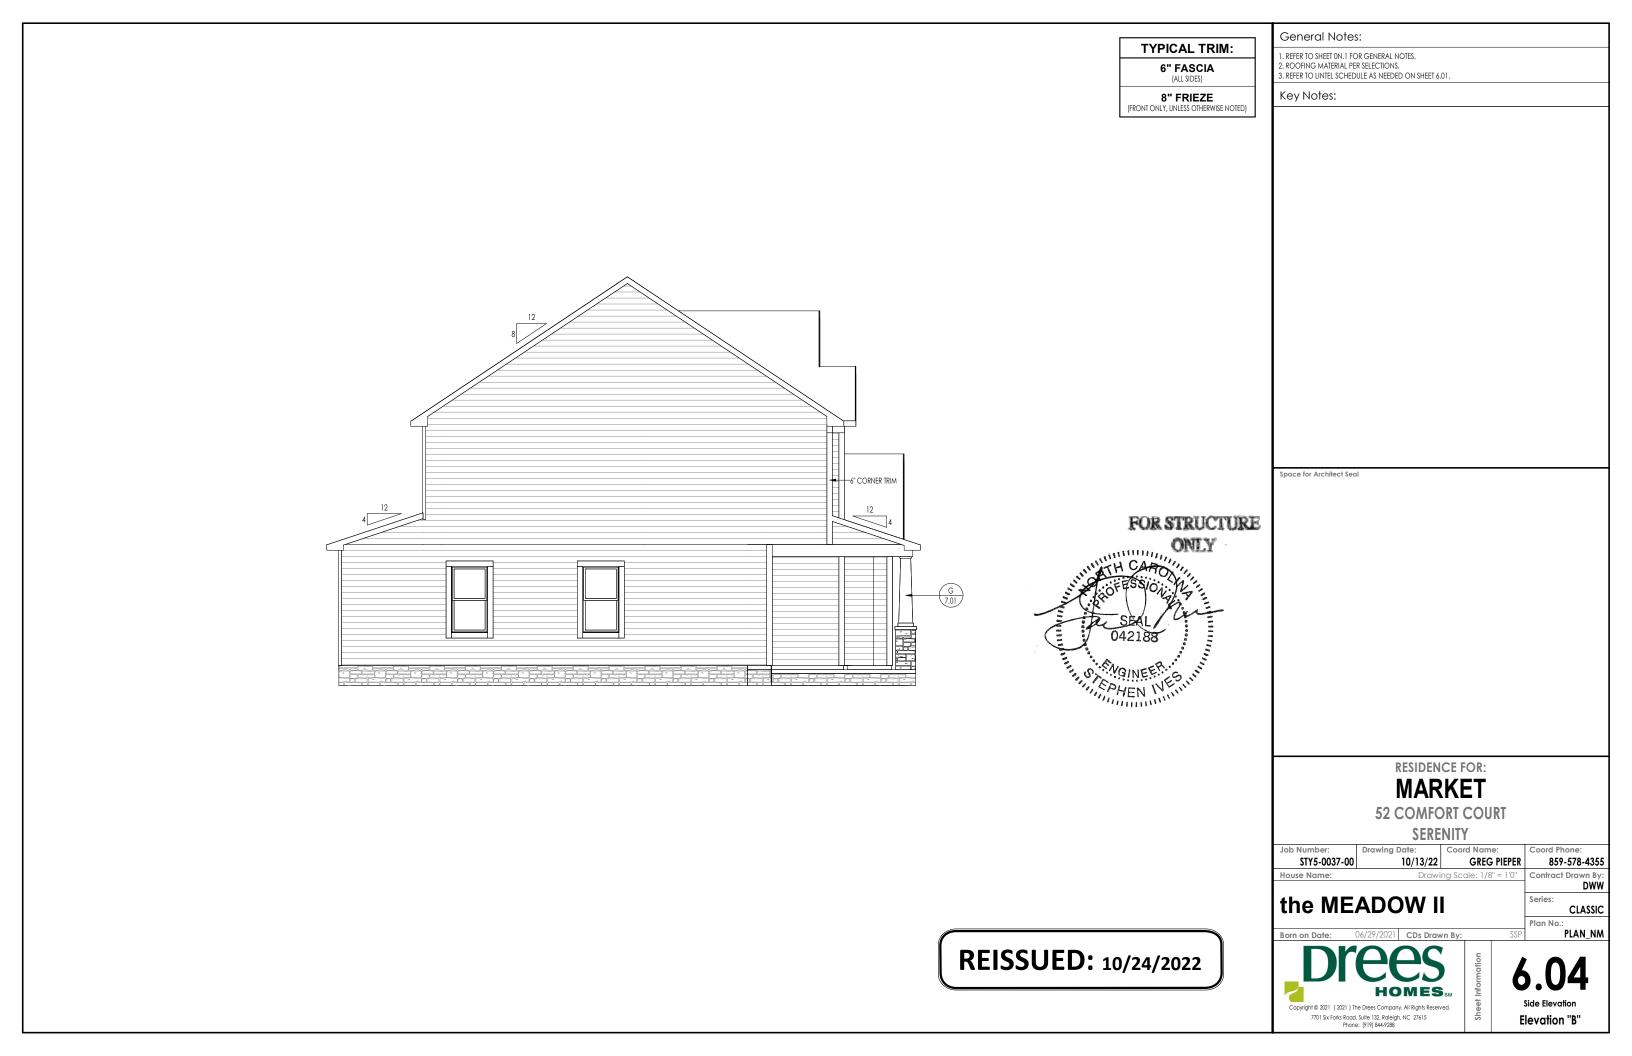

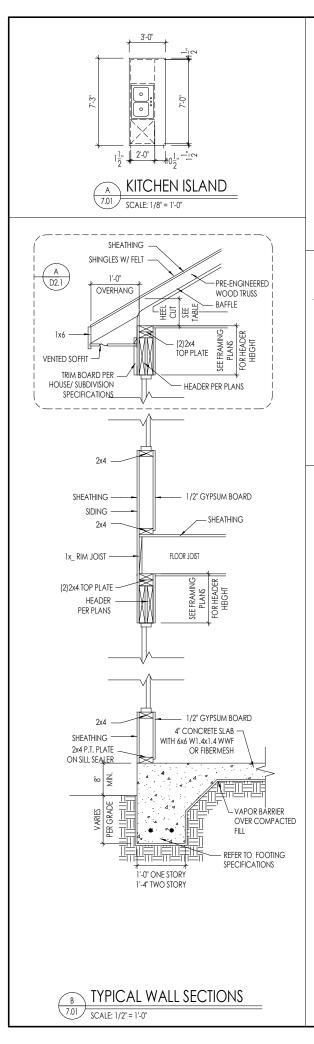SCALE: 1/4" = 1'-0"

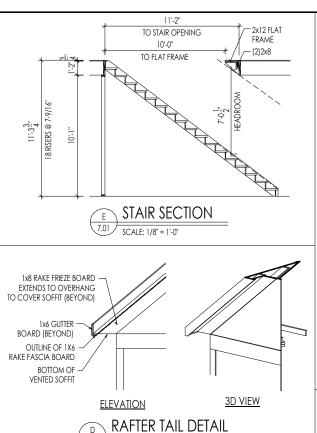

# STAIR FRAMING DETAILS

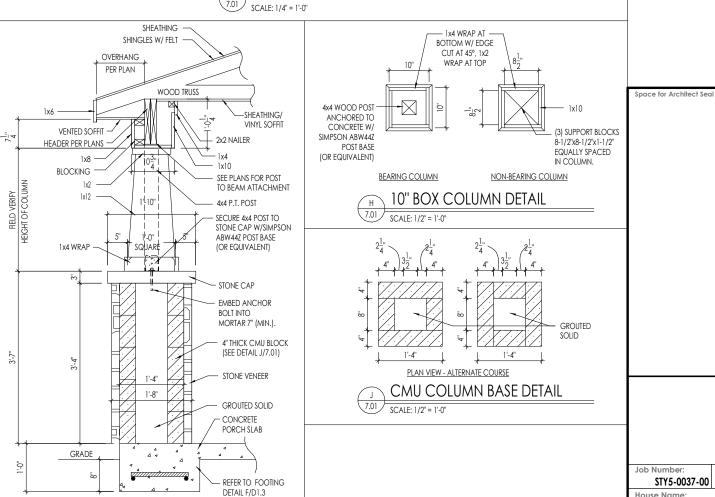


THICKENED EDGE

(PER PLANS)

FRONT PORCH COLUMN

SCALE: 1/2" = 1'-0"

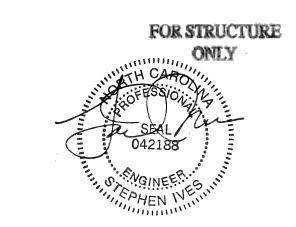

# **RESIDENCE FOR: MARKET**


**52 COMFORT COURT** 

**SERENITY** 


**GREG PIEPER** 859-578-4355 STY5-0037-00 10/13/22 DWW the MEADOW II CLASSIC Plan No. PLAN NM


**HOMES**<sub>SM</sub> Copyright © 2021 (2021) The Drees Company. All Rights Reserved.

7701 Six Forks Road, Suite 132, Raleigh, NC 27615 Phone: [919] 844-9288 Elevation "B"

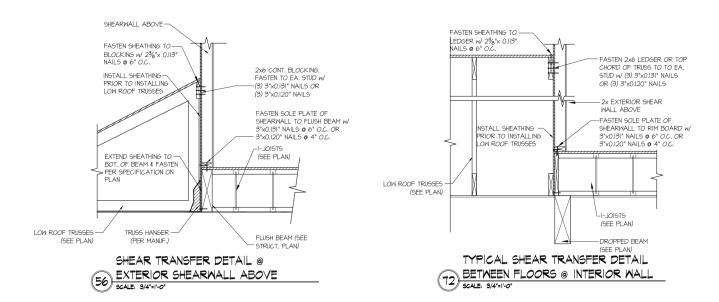




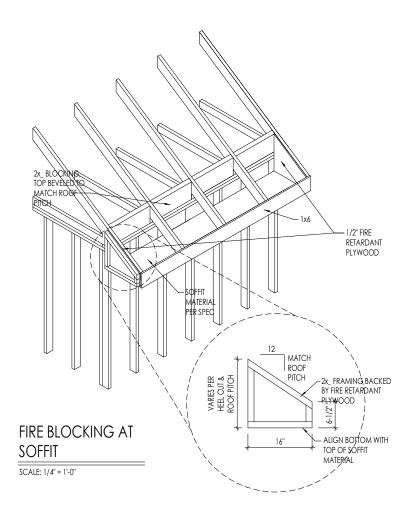


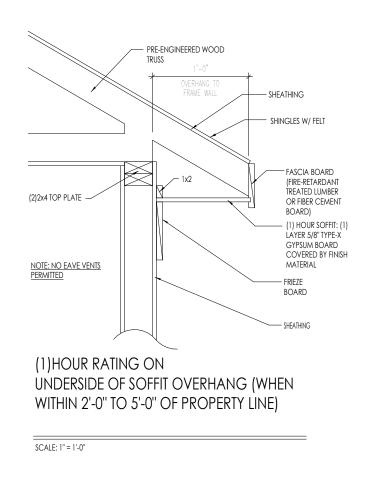



A SOFFIT FIRE BLOCKING DETAILS


7.02 SCALE: 1/4" = 1'-0"

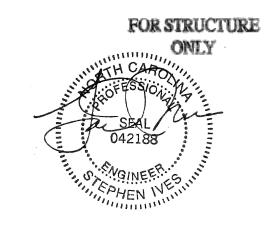

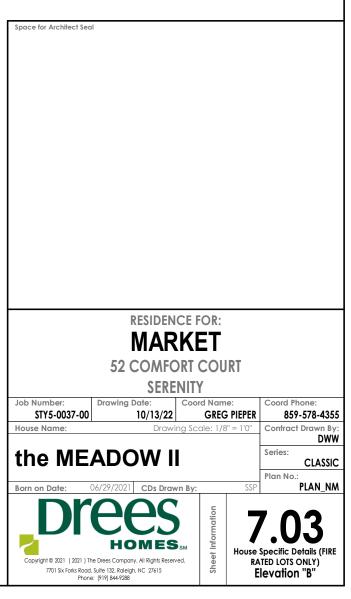

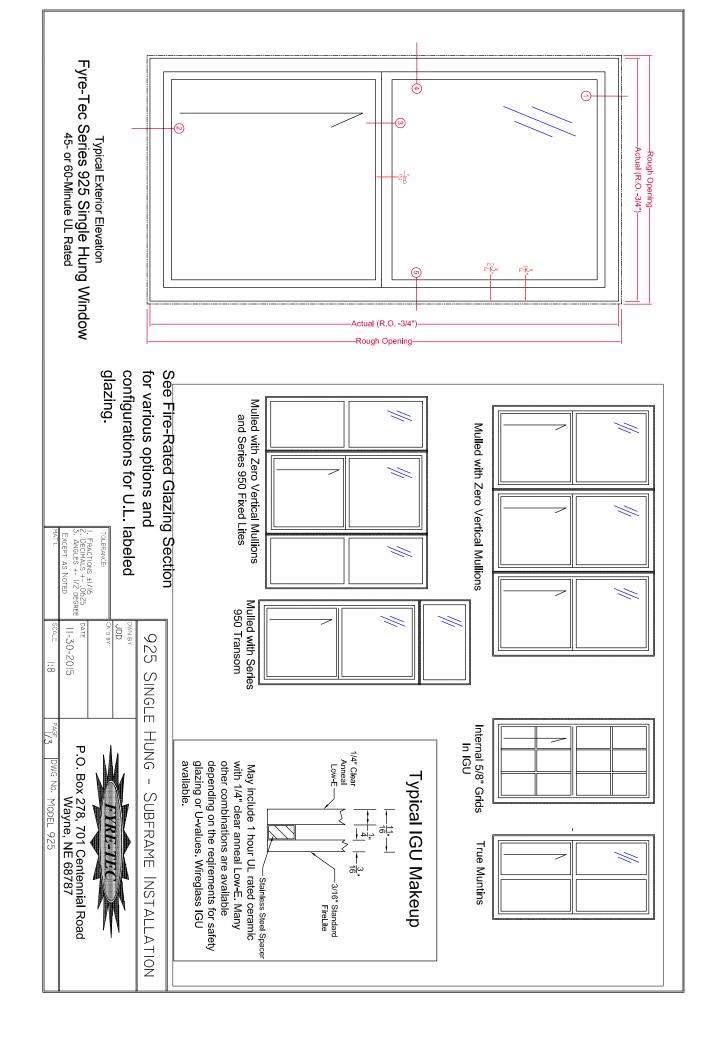

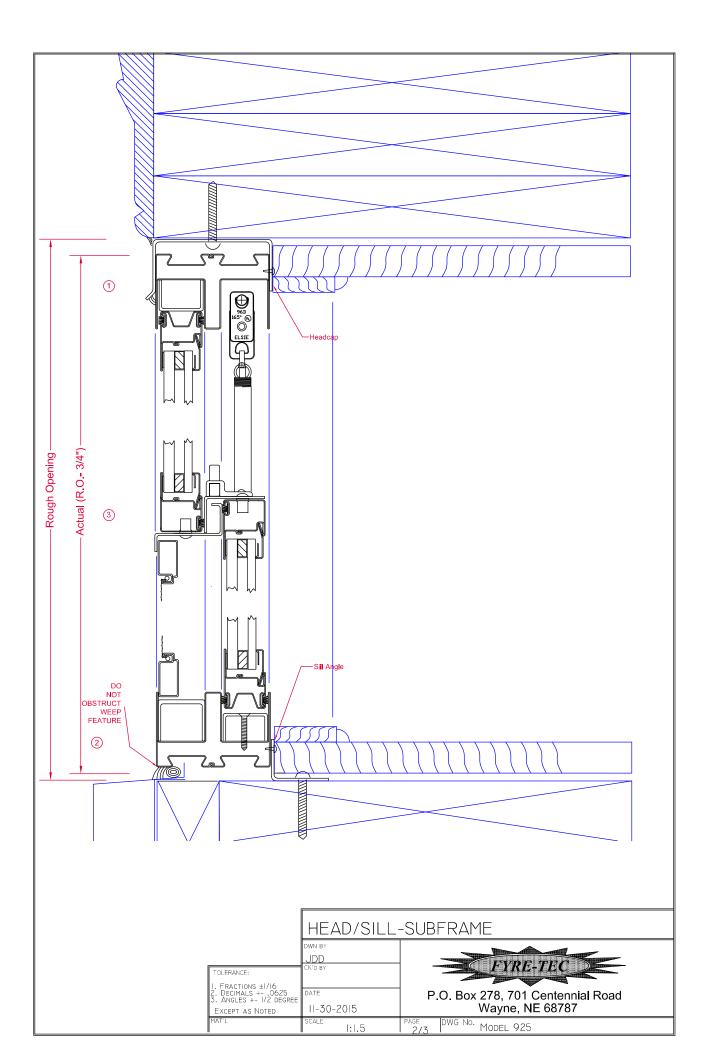

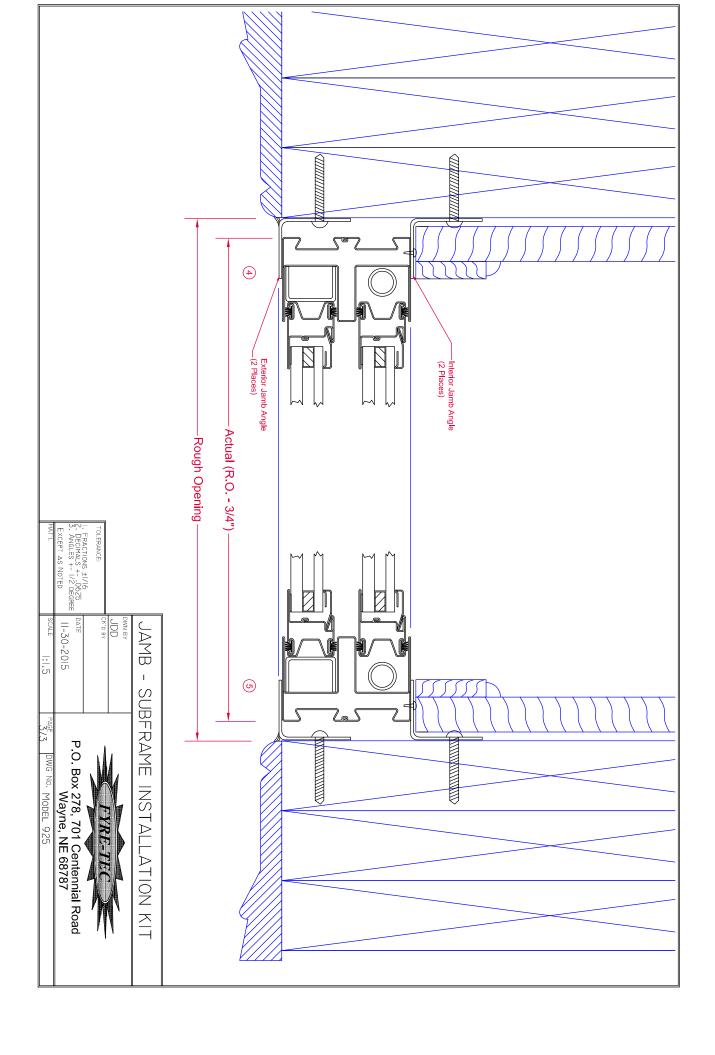

# Fin Mounting System Installation Procedure

The window and installation components should be inspected for any shipping damage. All local codes must be followed and supersede any of the following instructions. All finished surfaces of the window must be protected from damage to frame, paint, and glazing surfaces throughout the complete installation and wall finalization. This is to include stucco, drywall, brickwash or any other cleaning technique other than that recommended by Fyre-Tec. Failure to protect the window will VOID any applicable warranties. Protective coverings are recommended.

## Opening Requirements


The opening should be built square and plumb and large enough to accept the window(s) provided. Windows are provided ¾" less in both width and height from the rough or nominal opening size. This allows for a 3/8" gap around the entire perimeter of the window to be properly squared and shimmed in the opening. It is recommended that the sill of the window be shimmed no less than ¼" above the construction sill to accommodate the weep feature of the window.


## **Opening Preparation**


The window opening is to be prepared in conformance with local code and approved construction drawings. On openings other than masonry it is recommended that the perimeter be prepped with an air-barrier type window wrap and flashing system. Sill panning is recommended for optimal protection against water penetration. Panning and air barriers are not provided by Fyre-tec.


## **Fin Mounting to Window**

The mounting fins are supplied loose and are to be mounted to the window with the self-tapping screws supplied. Window frame depth in relationship to the finished wall may be adjusted in four increments by selecting the mounting position on the perimeter of the frame as shown in the following layout.

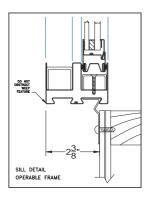

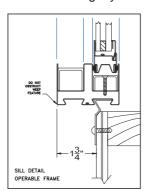

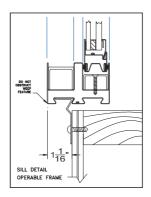

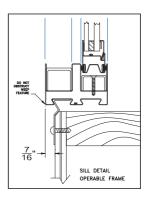

## **Attachment Procedure**

- 1. \*Pre-drill holes using a 3/16" bit in the fin to be mounted to the window (short leg). The screws are to be positioned 1" from each end of the individual fins and then placed 24" on center thereafter. The hole should be centered on the leg. \*Pre-drill holes using a bit large enough to accept fasteners being used in fin for mounting to wall (Long Leg). Hole locations should be no more than 3" from each end of the individual fins and then placed 16" on center thereafter. The holes should be place in a known location as to allow fastener to penetrate a structural member of the wall.
- 2. Caulk bedding is to be applied around the perimeter of the frame in the frame recess that the fin is intended to be mounted. As shown (A). Any other holes or voids in the perimeter of the frame must be sealed as well to prevent water penetration into the wall cavity.
- Screw the fin to the window as shown in (B) & (C)









<u>Note</u>: The sill of **operable windows** have additional factory applied butyl tape to further assist in preventing water leaking into wall cavity.

## **Window Installation in Opening**

Installation will require a minimum of two people.

One individual should remain on the exterior to hold the window in place and the other on the interior to center the window in the opening using a flat pry-bar or shim. All sides on the interior should have approximately 3/8" gap from wall opening to window edge. Shim using an approved material. Check window for level in the opening and complete shim application. Once the window is shimmed properly, attach the fin on the exterior to a structural member per an approved method as laid out by an architect or authority having jurisdiction. Special attention should be made with the weep feature of the window in the exterior sill. A minimum 1/4" gap should be maintained between the sill of the window and the construction sill of the wall to allow for proper weeping and drainage from the window.





## **INTERIOR**



## **EXTERIOR**



When attaching the Fin to the wall section keep the corners loose to apply the Fin corner pieces. Caulk corner of wall where Fin will be placed as seen in picture to (left). Pull fin away from wall slightly and slide fin underneath as shown in picture (lower left). Once all Fin corners are installed caulk all exposed seams using an approved sealant shown (lower right). The window is now ready to be flashed.






## Flashing the Installation

Flashing the exterior gives added protection against water penetration. The recommended procedure for flashing the opening is to use a flexible adhesive backed window wrap. Each application of the window wrap should be cut extra long as to allow over lapping in each of the corners, at least the width of the wrap itself. The wrap should contact the window frame and be applied per manufacture specification.

If stucco is the desired finished wall exterior a J-channel trim must be used to keep the stucco from contacting the perimeter of the window frame. Protection against stucco from getting on the window and glazing surfaces is important.

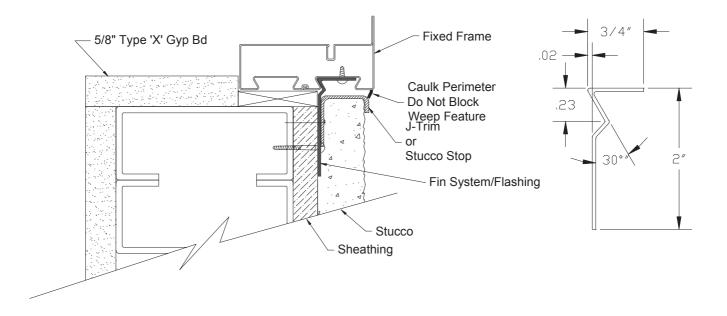

## Finalizing the Installation & Weep Feature

Once the wall construction is complete and stucco, siding, masonry or other application is complete, a perimeter beading of approved sealant is needed. Use caution when sealing around the weep feature.

The weep feature is a very important part in the longevity of the window's life span. On exterior applications special attention should be made to the exterior sill and the windows weep feature. The weep located 2" in from both corners of the sill and should be inspected or verified that the weep is open to a gap of 1/8" by approximately 7/8" long. Verification ensures that the weep has not been pinched down or crimped shut during shipping, handling, and installation. Failure to inspect the weep feature prior to finalizing the project can lead to water leakage as well as premature rusting with the window. If the slot needs additional adjustment carefully use a flat screwdriver or small pry-bar to make the gap more. Do not use excessive force, which can cause the frame to tear or crack the protective paint.



## **Tools Recommended:**

-Safety glasses -Pencil -Power tool with drilling and screwing capabilities -Measuring tape -Hammer -Saw or power saw with metal cutting capabilities

-Caulking Gun -Level -Pry-bar for shimming and squaring

## **Supplies Needed:**

\*Notice\* All supplies must be approved and meet local code requirements. Contact your local inspector for a list of their approved products.

-Sealant -Fasteners -Shims

## Parts Shipped

Contained within each individual crate supplied are:

1-Window

\*1-Trim kit containing:

Instructions


1-Head Fin

1-Sill Fin

2-Jamb Fins

4-Fin Corners

\*\*Touchup paint

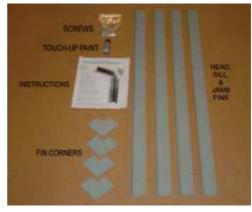

\*\*Screws for applying fin (Not shown) Mullions if applicable Notes:


The window and parts should be inspected for shipping damage prior to installation
\*If trim kit exceeds the length of the window it will be provided in separate box.

\*\*Note: Depending upon the quantity of windows, touchup paint and screws may be provided in larger bags with enough quantity to cover the whole order. These bags will be attached to only one or several trim kits depending on order quantity. Location of these items will be identified on the shipped crate being marked as "SCREWS"


			CURVE	TABLE		
CURVE	DELTA	RADIUS	ARC	CHORD	TANGENT	CHORD BRG
C1	84°21'36"	25.00'	36.81'	33.57'	22.65'	N 54°41'45" W
C2	6°07'58"	255.00'	27.29'	27.28'	13.66'	N 15°34'55" W

LINE TABLE				
LINE	BEARING	DISTANCE		
L1	S 83'07'27" W	104.67		
L2	S 06°52'33" E	68.80'		

PROPOSED IMPERVIOUS SURFACES:
TOTAL LOT AREA=7,621 S.F.
HOUSE/PORCHES=1,816 S.F.
DRIVEWAYS/ETC.=429 S.F.
TOTAL IMPERVIOUS AREA=2,245 S.F.
MAX. IMPERVIOUS AREA=2,600 S.F.

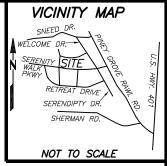

REFERENCES: D.B. 4165, PG. 419 PIN 0655-23-1910.000 PID 08065501 0032 07 RESTRICTIVE COVENANTS: 2. D.B. 4109, PG. 612

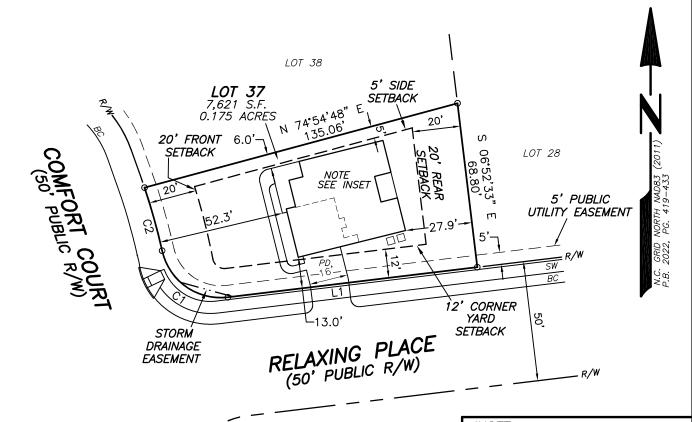


SETBACKS LOT WIDTHS FRONT YARD—20 SIDE YARD—5' REAR YARD—20' CORNER SIDE-12'

## **LEGEND**

(BC)-BACK OF CURB (SW)-SIDEWALK (PD)-PROPOSED DRIVEWAY

## NOTES:

1. ALL EASEMENTS, RIGHTS OF WAY AND BOUNDARY INFORMATION TAKEN FROM P.B. 2022, PG 419-433 UNLESS OTHERWISE NOTED.
2. PROPERTY IS SUBJECT TO ALL EASEMENTS AND RESTRICTIONS OF RECORD. NO TITLE EXAMINATION HAS BEEN DONE BY ROBINSON & PLANTE, P.C.

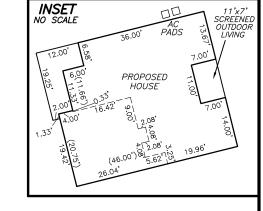

PRELIMINARY PLAT- NOT FOR RECORDATION, CONVEYANCE, OR SALE

LOT 37 SERENITY SUBDIVISION PHASE 1 52 COMFORT COURT HARNETT COUNTY FUQUAY-VARINA, N.C. 27526

# SURVEY FOR DREES HOMES

40' 80' 120' GRAPHIC SCALE

419-433 REFERENCE: PLAT BOOK 2022 PAGE

I CERTIFY THAT THIS MAP WAS DRAWN
UNDER MY SUPERVISION FROM AN ACTUAL
SURVEY MADE UNDER MY SUPERVISION
DESCRIPTION RECORDED IN REFERENCES AS SHOWN;
THAT THE BOUNDARIES NOT SURVEYED ARE
INDICATED AS DRAWN FROM INFORMATION
IN\_\_\_\_; THAT THE RATIO
OF PRECISION IS 1:10,000; AND THAT
THIS MAP MEET THE REQUIREMENTS OF
THE STANDARDS OF PRACTICE FOR LAND
SURVEYING IN NORTH CAROLINA
(21 NCAC 56.16000).
THIS\_\_\_\_\_ DAY OF \_\_\_\_\_\_, 2022.

PROFESSIONAL LAND SURVEYOR L-4433

MEADOW II ELEV B SLAB ON GRADE SCREENED IN OUTDOOR LIVING GARAGE RIGHT SIDE

# ROBINSON & PLANTE PC

LAND SURVEYING C - 2687970 TRINITY ROAD RALEIGH, N.C. 27607 PHONE (919) 859-6030 FAX (919) 859-6032

DATE: 10-26-22

SCALE: 1"=40

FILE: STYLOT37PPR2