

AN ARCHITECTURAL OR ENGINEERING FIRM ASSUMES NO LIABLILITY FOR STRUCTURAL, OR ARCHITECTURAL DESIGN INTEGRITY.

EVERY EFFORT HAS BEEN MADE TO INSURE ALL DIMENSIONS ARE CORRECT AND ENVIRONMENTAL REGULATIONS HAVE BEEN MET. IF AN ERROR OR OMISSION DOES OCCUR, IT IS THE SOLE RESPONSIBILITY OF THE CONTRACTOR AND NOT THE RESPONSIBILITY OF THE DRAFTING SERVICE.

CONTRACTOR IS RESPONSIBLE FOR VERFICATION OF DIMENSIONS IN THE FIELD AND SHALL BUILD HOME IN ACCORDANCE WITH INFORMATION OF DIMENSIONS IN THE FIELD AND SHALL BUILD HOME IN ACCORDANCE WITH THE INTEGRAL OF SOLE

JAMIE FISHER

Project



8375 Rushing Road Denham Springs, Lo 70726 Phone: (225) 791-29

Project No.: HONEYSUCKLE

DATE: MARCH 14, 2022

DRAWN BY: Steven Madden

DESIGNED BY: Steven Madden

COPYRIGHT NOTE: ©
These Plans Are Subject To
Federal Copyright Laws And
Are To Be Used For The Lot
Number And Subdivision
Indicated In This Title Block
Only. Use On Any Other Site is
Prohibited.

© COPYRICHT 2022

Sheet Title

COVER SHEET

☐ Preliminary Dwg.

☐ Bidding Doc.

☐ Construction Doc

DOOR SCHEDULE					
MARK					
	SIZE	DESCRIPTION	QTY.		
1	DBL 2'6" × 8'Ø"	EXTERIOR 4 LITE 3/4 FRENCH SOLID WOOD DOORS	1 PAIR		
2	3'Ø" × 8'Ø"	EXTERIOR 4 LITE FULL FRENCH WOOD DOOR	1		
3	18'Ø" × 8'Ø"	EXT. O.H. METAL INGUL. GARAGE DOOR W/ DOOR OPENER	1		
4	3'Ø" × 8'Ø"	EXTERIOR 6 PANEL METAL DOOR	1		
5	3'Ø" × 8'Ø"	CASED OPENING	2		
6	1'6" × 8'Ø"	INTERIOR HORIZONTAL PANEL H.C. MASONITE DOOR	2		
٦	2'Ø" × 8'Ø"	INTERIOR HORIZONTAL 6 PANEL H.C. MASONITE DOOR	3		
8	2'4" × 8'Ø"	INTERIOR HORIZONTAL 6 PANEL H.C. MASONITE DOOR	4		
9	2'8" × 8'Ø"	INTERIOR HORIZONTAL 6 PANEL H.C. MASONITE DOOR	4		
100	3'Ø" × 8'Ø"	INTERIOR HORIZONTAL 6 PANEL H.C. MASONITE DOOR	1		
11	2'Ø" × 8'Ø"	INT. HORIZONTAL 3 PANEL H.C. MASONITE POCKET DOOR	3		
12	2'Ø" × 6'Ø"	TEMPERED FRAMELESS GLASS SHOWER DOOR	1		

	WINDOW SCHEDULE					
MARK	OPENING SIZE	DESCRIPTION	QTY.			
Д	2'8" × 7'Ø"	2/2 LITE VINYL SINGLE HUNG WINDOW INSULATED	6			
В	4'Ø" × 4'Ø"	DBL 2 LITE VINYL CASEMENT WINDOW INSULATED	1			
С	3'6" × 4'0"	DBL 2 LITE VINYL CASEMENT WINDOW INSULATED	1			
Ω	3'Ø" × 7'Ø"	2/2 LITE VINYL SINGLE HUNG WINDOW INSULATED	1			
E	3'6" × 7'Ø"	2/2 LITE VINYL SINGLE HUNG WINDOW INSULATED	1			
F	2'Ø" × 3'6"	4 LITE VINYL FIXED WINDOW INSULATED (SEE SHEET A2.0)	1			

PROTECTION AGAINST TERMITES:

. SUBTERRANEAN TERMITE CONTROL. IN AREAS FAVORABLE TO TERMITE DAMAGE METHODS OF PROTECTION SHALL BE BY CHEMICAL SOIL TREATMENT, PRESSURE-TREATED WOOD, NATURALLY TERMITE RESISTANT WOOD OR PHYSICAL BARRIERS (SUCH AS METAL OR PLASTIC TERMITE SHIELDS), OR ANY COMBINATION OF THESE

METHODS. 2. CHEMICAL SOIL TREATMENT. THE CONCENTRATION, RATE OF APPLICATION AND

TREATMENT METHOD OF THE TERMITICIDE LABEL. 3. PRESSURE-TREATED AND NATURALLY RESISTANT WOOD. HEARTWOOD OF REDWOOD AND EASTERN RED CEDAR SHALL BE CONSIDERED TERMITE RESISTANT. PRESSURE-TREATED WOOD AND NATURALLY TERMITE RESISTANT WOOD SHALL NOT BE USED AS A PHYSICAL BARRIER UNLESS A BARRIER CAN BE INSPECTED FOR ANY TERMITE SHELTER TUBES AROUND THE INSIDE AND OUTSIDE EDGES AND JOINTS OF A BARRIER.

4. FIELD TREATMENT, FIELD CUT ENDS, NOTCHES, AND DRILLED HOLES OF PRESSURE-TREATED WOOD SHALL BE RETREATED IN THE FIELD ACCORDING TO

WIND ZONE NOTES

MPORTANT NOTE:

YERIFY WINDOW CODE REQUIREMENTS AT EACH BUILDING LOCATION, AND INSTALL WINDOWS AS PER CODE. REQUIREMENTS WILL VARY FROM DOUBLE INSULATED VINYL TO IMPACT RESISTANT DOUBLE INSULATED YINYL WINDOWS.

2. ALL WINDOWS SHALL COMPLY WITH THE GOVERNING IRC/IBC. WINDOWS SHALL BE SELECTED BASED UPON THE COMPONENT AND

CLADDING DESIGN PRESSURES. 3. CONTRACTOR RESPONSIBLE FOR ANCHORAGE OF BOTTOM PLATE AND WALL STUDS TO FOUNDATION IN COMPLIANCE WITH THE GOVERNING EDITION OF IRC/IBC 1609.

GENERAL NOTES:

OF THIS PLAN.

SPANS)

- ALL KITCHEN AND UTILITY COUNTERTOPS ARE SHOWN AS 2'-0" WIDE UNLESS STATED OTHERWISE.
- 2. ALL BATHROOM LAVATORY COUNTERTOPS SHOWN AS 1'-10" WIDE.
- 3. ALL EXTERIOR OVERALL DIMENSIONS ARE FROM EDGE OF FOUNDATION.
- 4. ALL INTERIOR DIMENSIONS ARE FROM STUD
- FACE TO STUD FACE. ALL INTERIOR WALL THICKNESS SHOWN AS 4"
- UNLESS NOTED OTHERWISE. 6. THE CONTRACTOR SHALL VERIFY ALL DIMENSIONS
- BEFORE COMMENCING WORK.
- 1. DRYER VENT MUST HAVE MAX LENGTH 25'
- 8. PURCHASER OF THIS PLAN ASSUMES LIABILITY FOR ANY MODIFICATIONS MADE TO THE LAYOUT
- 9. ALL WOOD FRAMING SHALL BE NO. 2 GRADE -SOUTHERN PINE LUMBER. ALL CEILING JOISTS SPANS ARE BASED ON TABLE R802.5.1 (2) OF THE I.R.C. 2018 AND ARE DESIGNED FOR ATTICS WITH LIMITED STORAGE. (REFER TO FOUNDATION SHEET FOR
- 10. RE: SEC. 308 GLAZING IN HAZARDOUS LOCATIONS & TEMPERED GLASS FOR WINDOWS THAT ARE WITHIN 24" OF THE DOOR IN THE CLOSED POSITION, PROVIDING THE WINDOW IS LESS THAN 60" ABOVE THE FLOOR. (R3Ø8 I.R.C. 2Ø15)
- II. ATTIC SPACES MUST PROVIDE I SQ. FT. VENTILATION PER 150 SQ. FT. OF AREA UNLESS CONDITIONED SPACE. (ATTICS R.906)
- 12. YENT HOOD IN KITCHEN MUST YENT TO THE OUTSIDE. MICROWAYE HOODS MUST VENT TO THE OUTSIDE WHERE APPLICABLE.

NOTE: HEADER SPANS FOR LOAD BEARING WALLS: NOTED.

SINGLE STORY: 2 PLY 2'X6" 2 PLY 2'X8" 5'-4" MAX 2 PLY 2'XIØ" 7'-6" MAX

2 STORY: 2 PLY 2'×6" 3'X7" MAX 2 PLY 2'X8" 4'X6" MAX 2 PLY 2'XIØ"
 6'X2" MAX

 2 PLY 2X6 HEADERS FOR ALL NON-LOAD BEARING WALLS OSB BETWEEN ALL HEADER PLIES OWNER.

REFER TO IRC R502.5 (1) AND (2) FOR ADDITIONAL HEADER AND GIRDER SPANS

ROOF OVERHANG ON NEW CONSTRUCTION TYPICAL 12" FROM FACE OF STUD UNLESS OTHERWISE

GENERAL CONTRACTOR TO PROVIDE ADEQUATE ROOF VENTILATION BUILDING SYSTEMS PER IRC CODE (SECTION R806). SYSTEMS TO BE USED TO MEET ROOF VENTALATION REQUIREMENTS ARE AS FOLLOWS: CONTINUOUS RIDGE VENTS, POWER VENTS, BOX VENTS, AND GABLE/DORMER VENTS WHEN APPROVED BY

SOFFIT VENTS TO BE USED ONLY IN ACCORDANCE W/ IRC CODE (SECTION R302 AND TABLE R302.1) TO ACCOMMODATE APPROPRIATE FIRE SEPARATION DISTANCES.

GENERAL MATERIALS:

1. EXTERIOR WALLS:

NO BOXED HEADERS

-HARDIE SIDING AS SPECIFIED - "TYVEK" BUILDING WRAP -1/2" O.S.B. SHEATHING

-R-13 BATT INSULATION 2. INTERIOR WALLS: -2×4 STUDS @ 1'-4" O.C.

3. CEILING: -2× JOISTS @ 1'-4" O.C. -R38 INSULATION 4. ROOF SYSTEM:

-2×4 STUDS @ 1'-4" O.C. -1/2" GYPSUM BOARD INTERIOR

-1/2" GYPSUM BOARD ON BOTH SIDES -1/2" GYPSUM BOARD

-30 YEAR FIBERGLASS SHINGLES -5/8" O.S.B. OR CDX PLYWOOD -2×6 RAFTERS @ 2'0" O.C.

NOTE: ALL ROOFING PRODUCTS, MATERIALS AND INSTALLATION, SHALL COMPLY WITH THE REQUIREMENTS UNLESS CHANGED BY GENERAL CONTRACTOR AT OWN DISCRETION.

CODE DISCLAIMER

THESE PLANS WERE DESIGNED TO MEET IRC 2015 AT THE TIME OF THEIR CREATION AND MORE SPECIFICALLY THE MINIMAL LOCAL CODES OF THE SOUTH LOUISIANA AREA. IT IS HIGHLY RECOMMENDED THAT THESE PLANS BE REVIEWED BY A LOCAL STRUCTURAL ENGINEER PRIOR TO CONSTRUCTION.

BEAMS AND FLOOR JOISTS ARE NOT SIZED DUE TO THE MANY GEOGRAPHIC LOCATIONS THESE PLANS ARE SOLD. THESE ITEMS SHALL BE SIZED BY A LOCAL ENGINEER OR MANUFACTURER.


- B. ALL CEILING & FLOOR JOISTS (IF CONVENTIONAL FRAMING) SHOULD BE SIZED USING THE LATEST VERSION OF THE IRC OR APPLICABLE CODES AT SITE TO MEET THE LOCAL REQUIREMENTS SUCH AS SNOW LOADS AND OTHER FACTORS. THE CEILING JOIST SIZES LABELED (IF PRESENT) WERE SIZED USING THE 2015 IRC AT THE TIME OF THEIR CREATION. THEY MUST BE VERIFIED AND MODIFIED AS REQUIRED TO MEET THE LATEST EDITION OF THE (IRC) INTERNATIONAL RESIDENTIAL CODE.
- 4. ALL FOUNDATION AND FOOTING DETAILS SHALL BE REVIEWED AND APPROVED BY A LOCAL ENGINEER.
- 5. CONTRACTOR SHALL PROVIDE ALL HIGH WIND STRAPPING AND ANCHOR BOLTS AS REQUIRED BY THE LOCAL CODE REQUIREMENTS AND THE LATEST VERSION OF THE IRC.

SQUARE FOOTAGE

LIVING 1924
FRONT PORCH271
REAR PORCH ———————— 410
GARAGE 574
TOTAL SQ. FT.— — — — — 3179

CONTRACTOR TO LOCATE WATER HEATER & A/C UNITS ON SITE

Σ V S

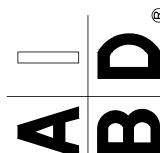

Project No.: HONEYSUCKLE MARCH 14, 2022

Steven Madden

DESIGNED BY: Steven Madden

COPYRIGHT NOTE: 0 These Plans Are Subject To Federal Copyright Laws And Are to Be Used For the Lot Number And Subdivision Indicated In This Title Block Only. Use On Any Other Site is Prohibited.

OCOPYRICHT 2022


Sheet Title


FLOOR PLAN


□ Preliminary Dwg


☐ Bidding Doc.

☐ Construction Do

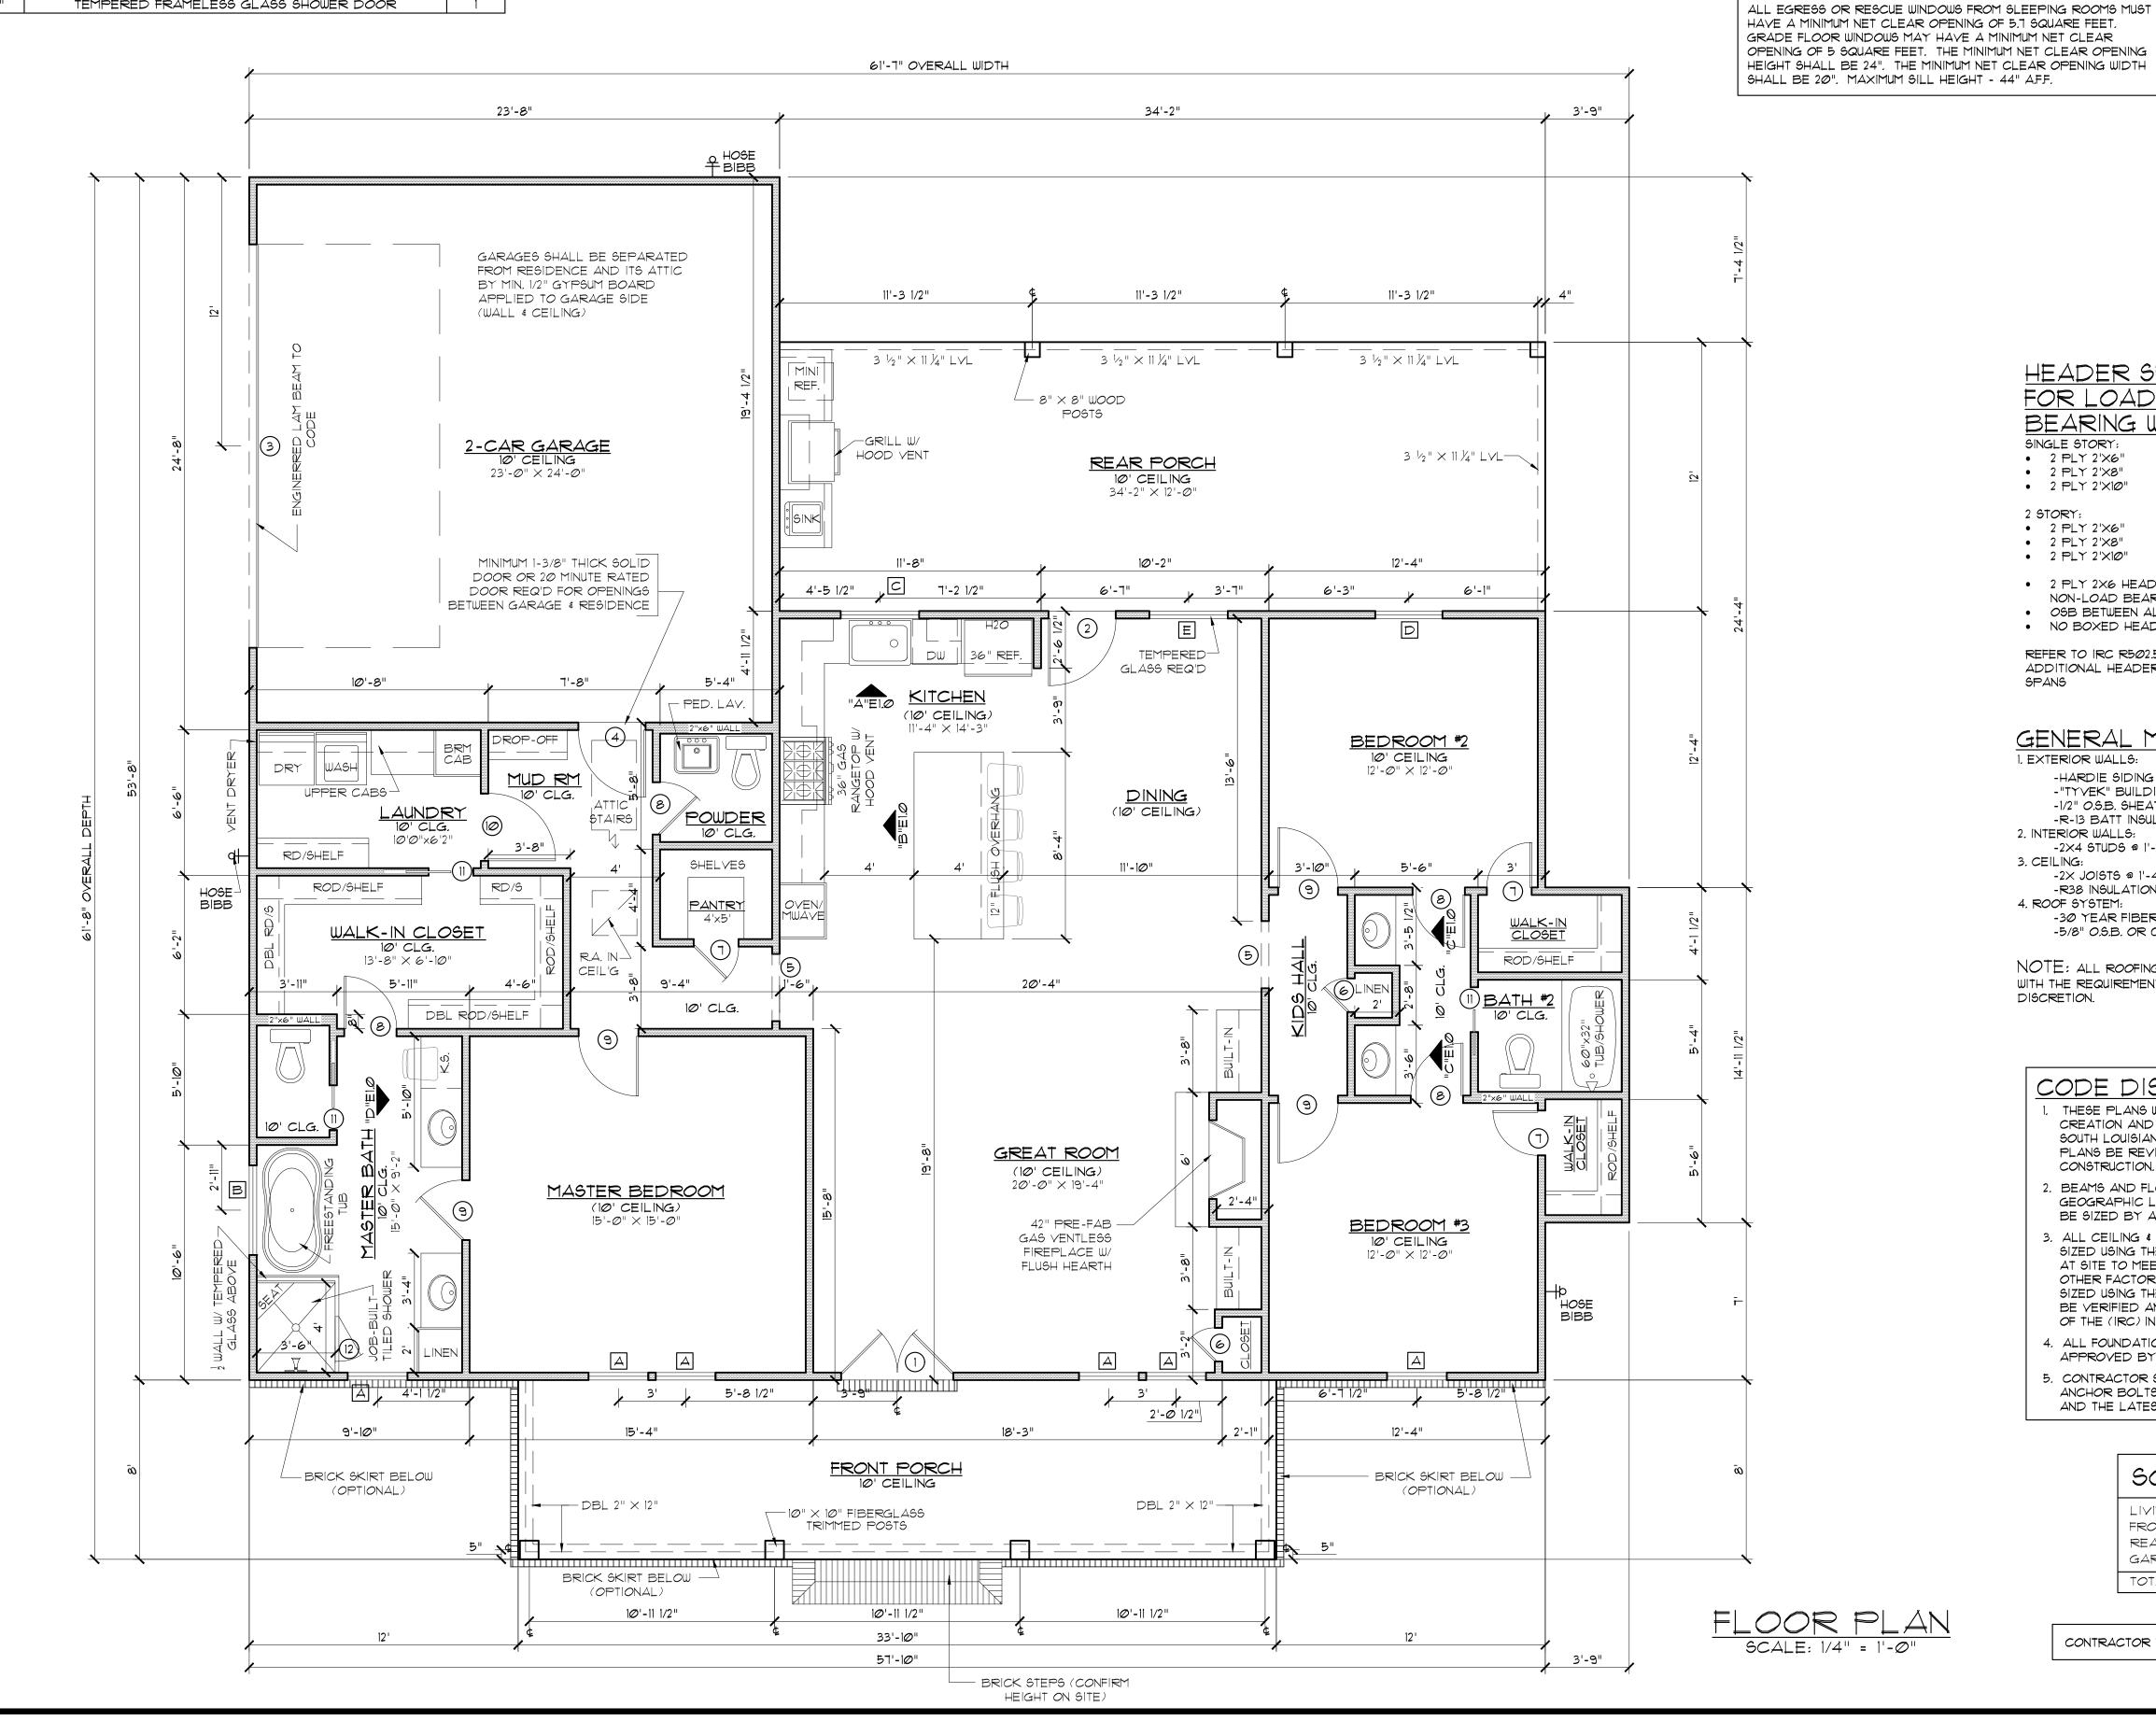

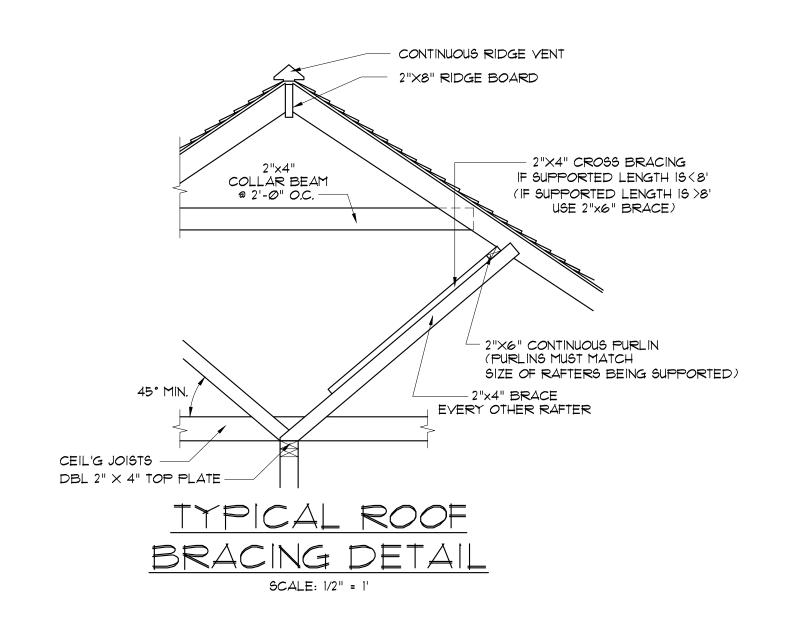

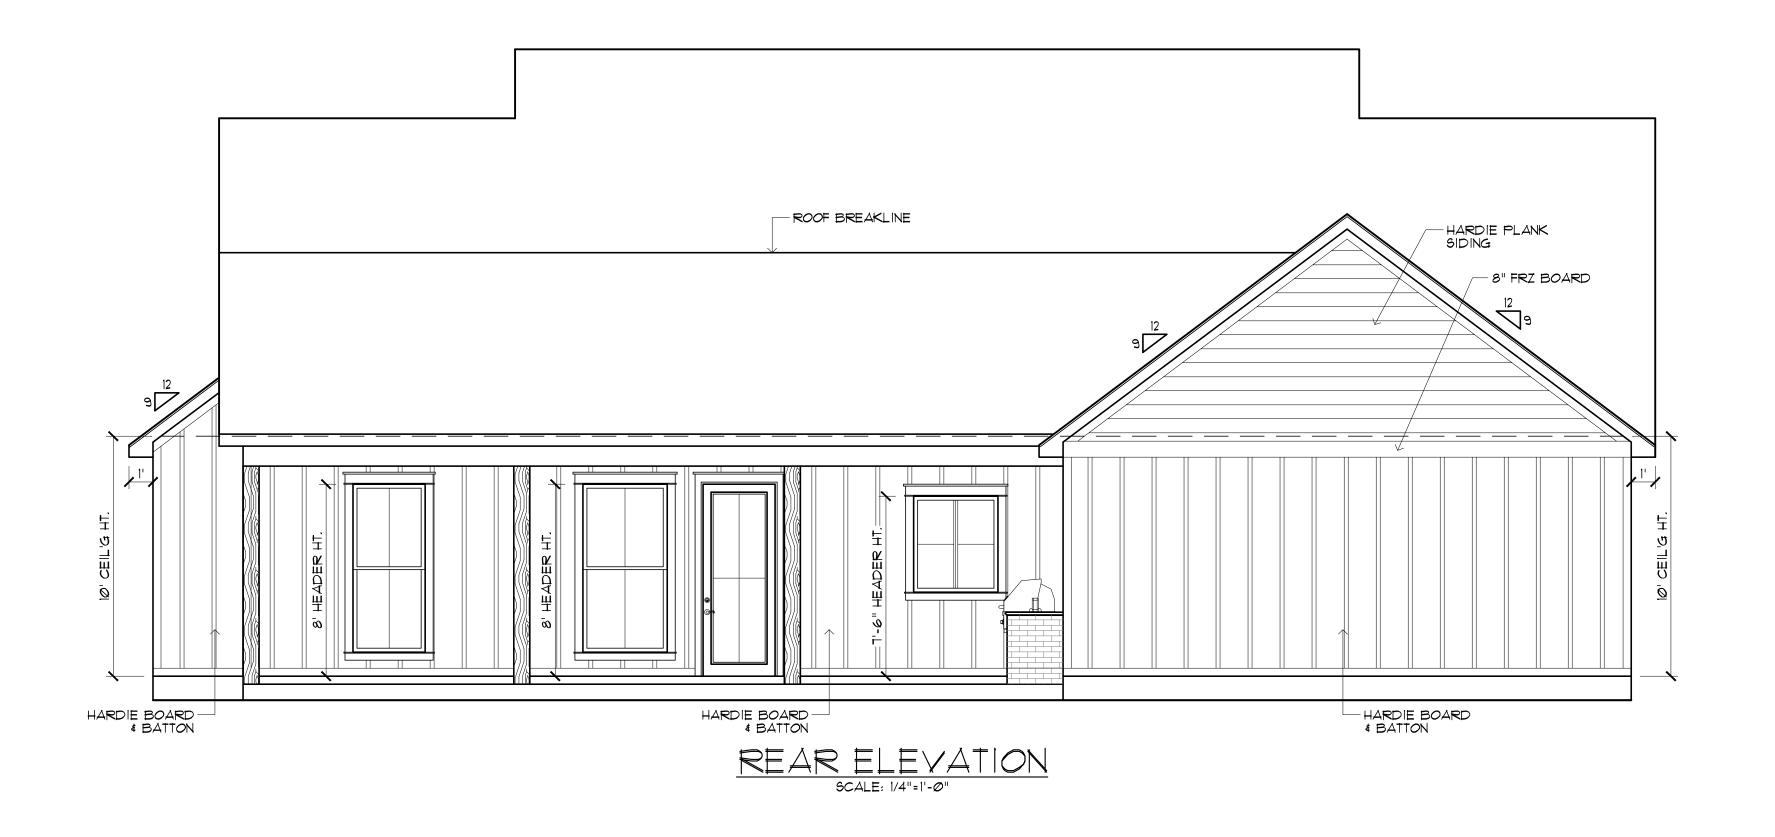

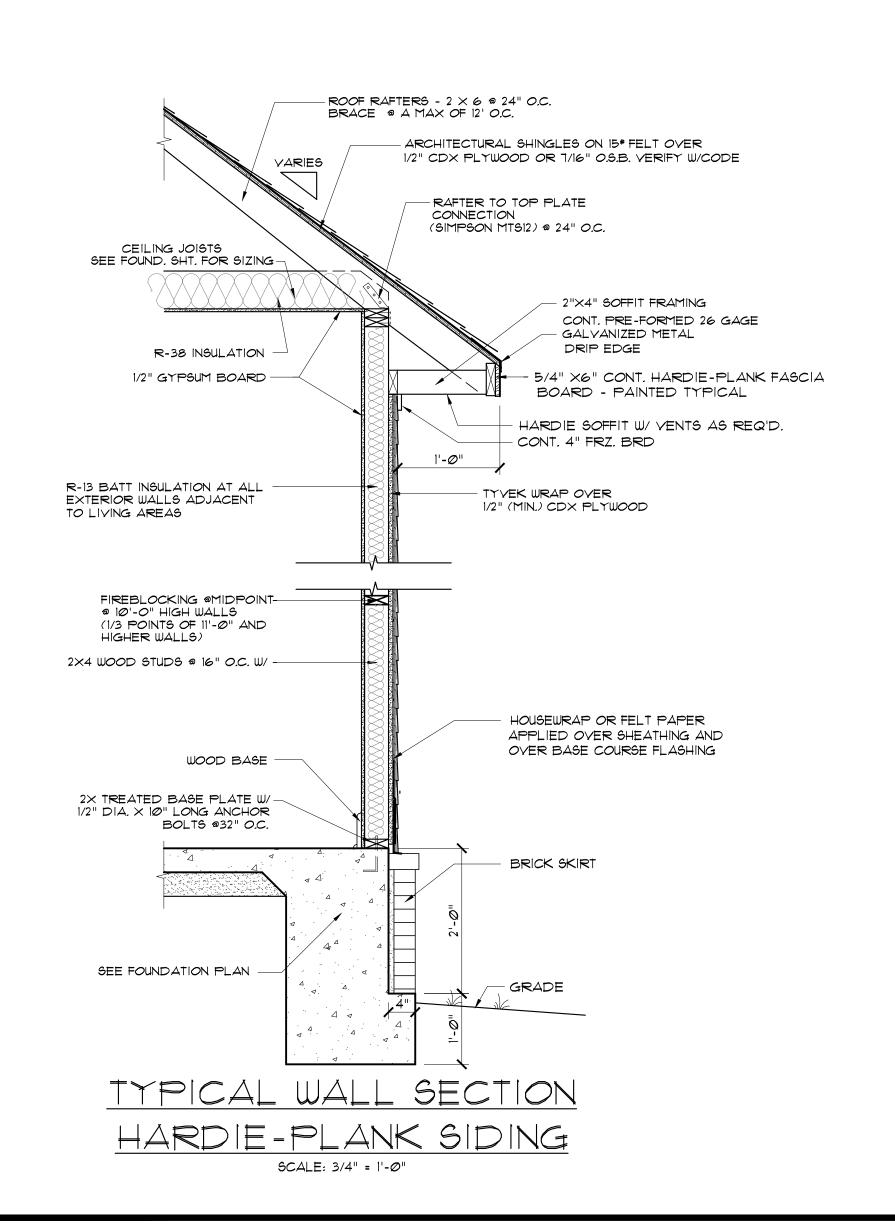



Q M

Project No.: HONEYSUCKLE

MARCH 14, 2022 Steven Madden

DESIGNED BY: Steven Madden

COPYRIGHT NOTE: © These Plans Are Subject To Federal Copyright Laws And Are To Be Used For The Lot Number And Subdivision Indicated In This Title Block Only. Use On Any Other Site is Prohibited.


© COPYRICHT 2022


Sheet Title


FRONT & REAR **ELEVATIONS**


☐ Preliminary Dwg. ☐ Bidding Doc.

☐ Construction Do

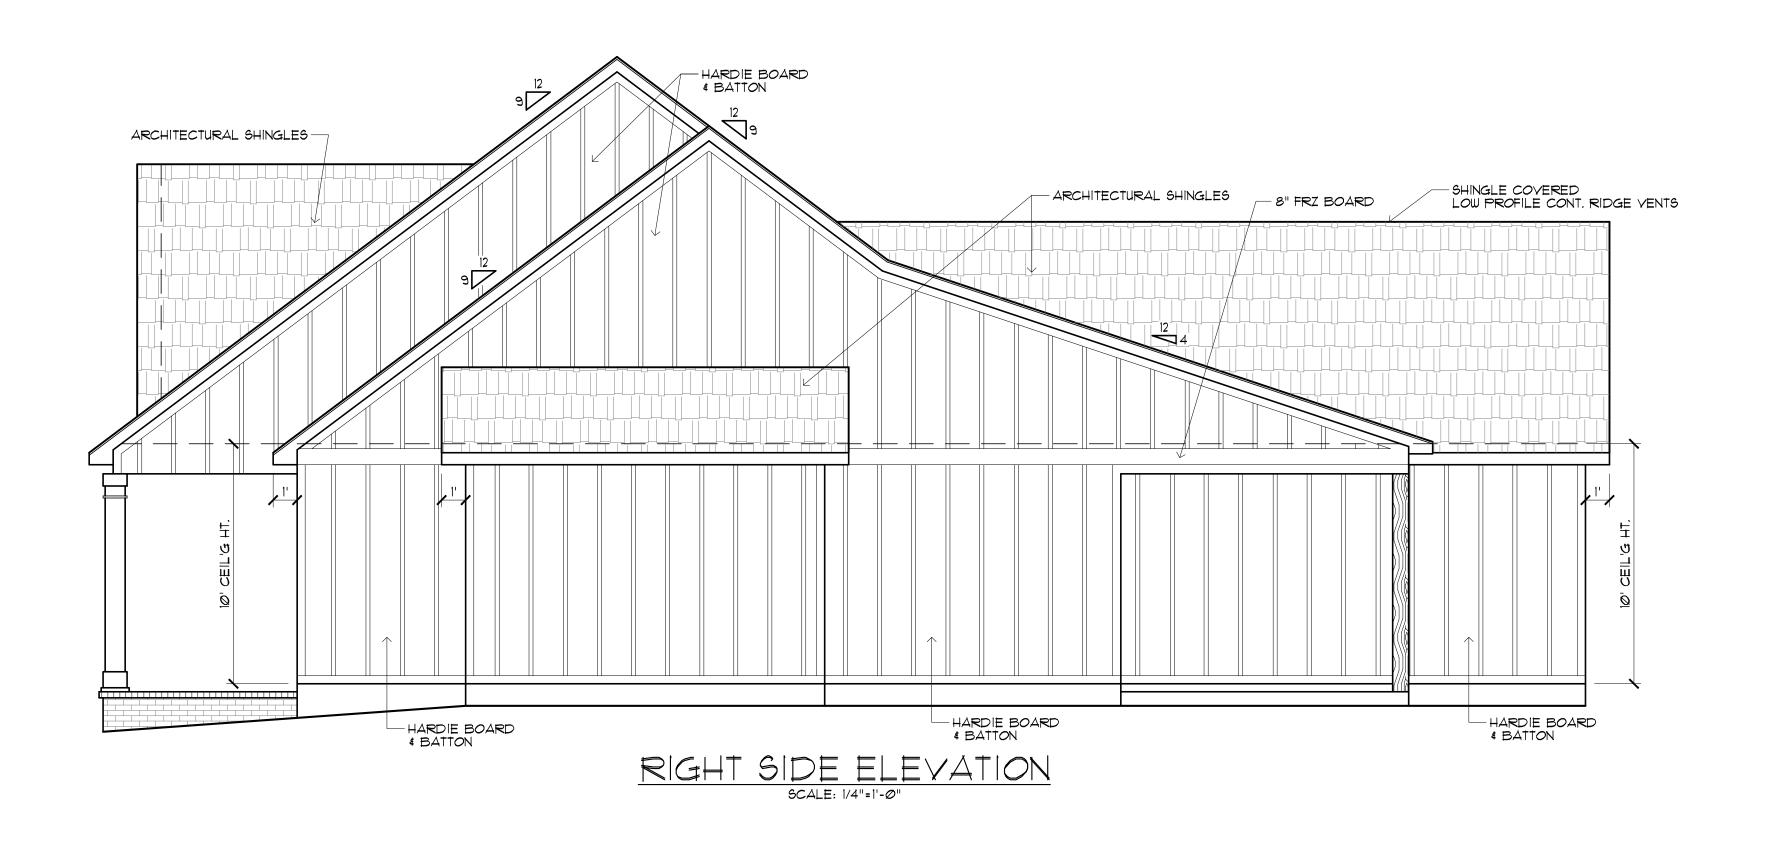

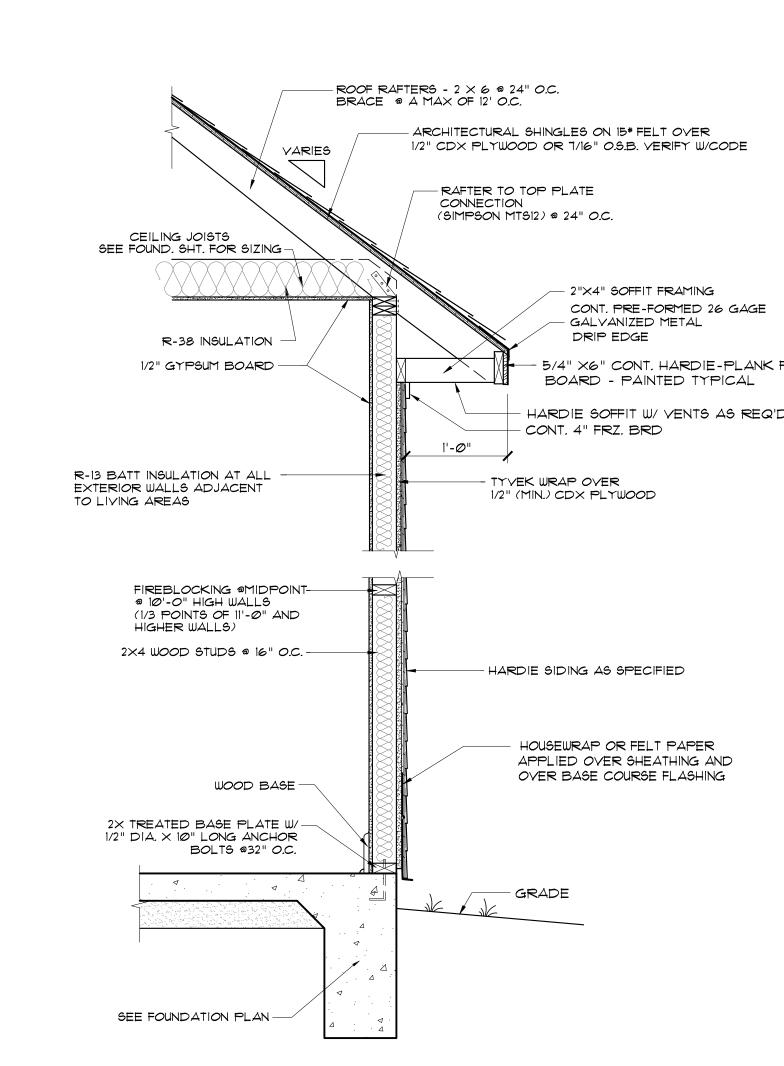

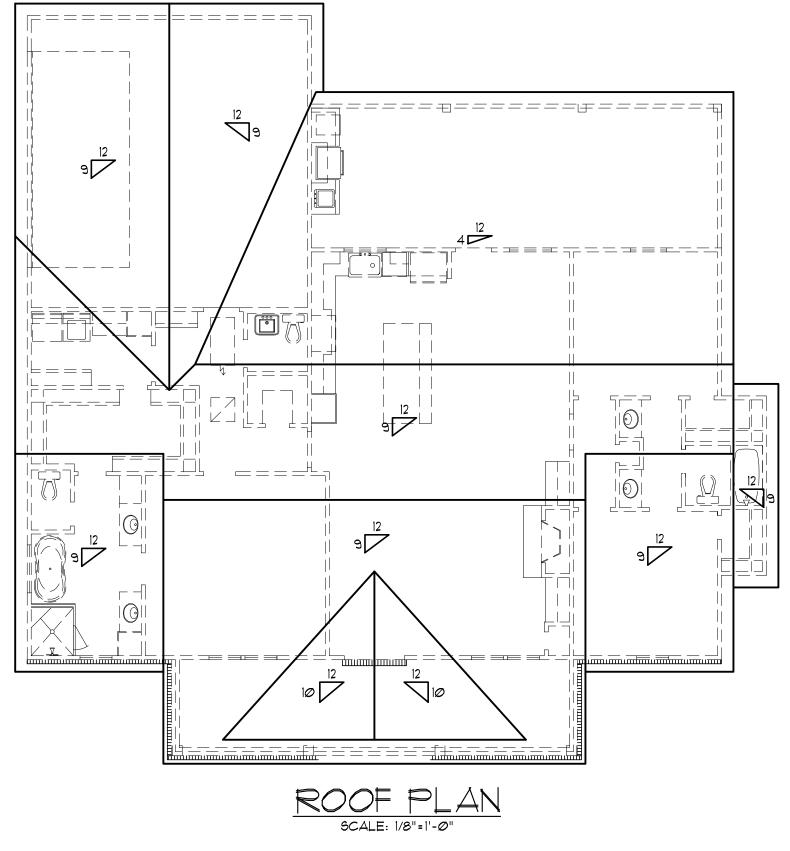

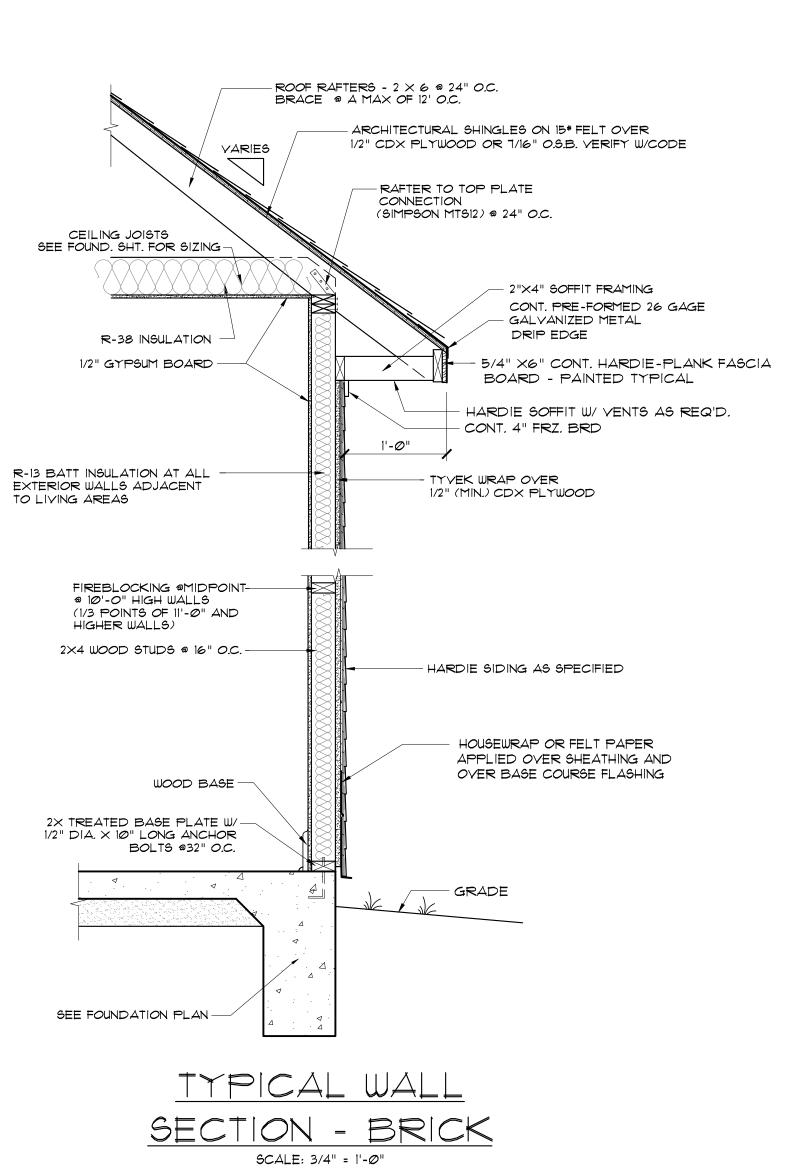

Project No.: HONEYSUCKLE

MARCH 14, 2022 Steven Madden

DESIGNED BY: Steven Madden

COPYRIGHT NOTE: © These Plans Are Subject To Federal Copyright Laws And Are To Be Used For The Lot Number And Subdivision Indicated In This Title Block Only. Use On Any Other Site is

© COPYRICHT 2022

Sheet Title


Prohibited.

ELEVATIONS & ROOF PLAN

☐ Preliminary Dwg. ☐ Bidding Doc.

☐ Construction Do



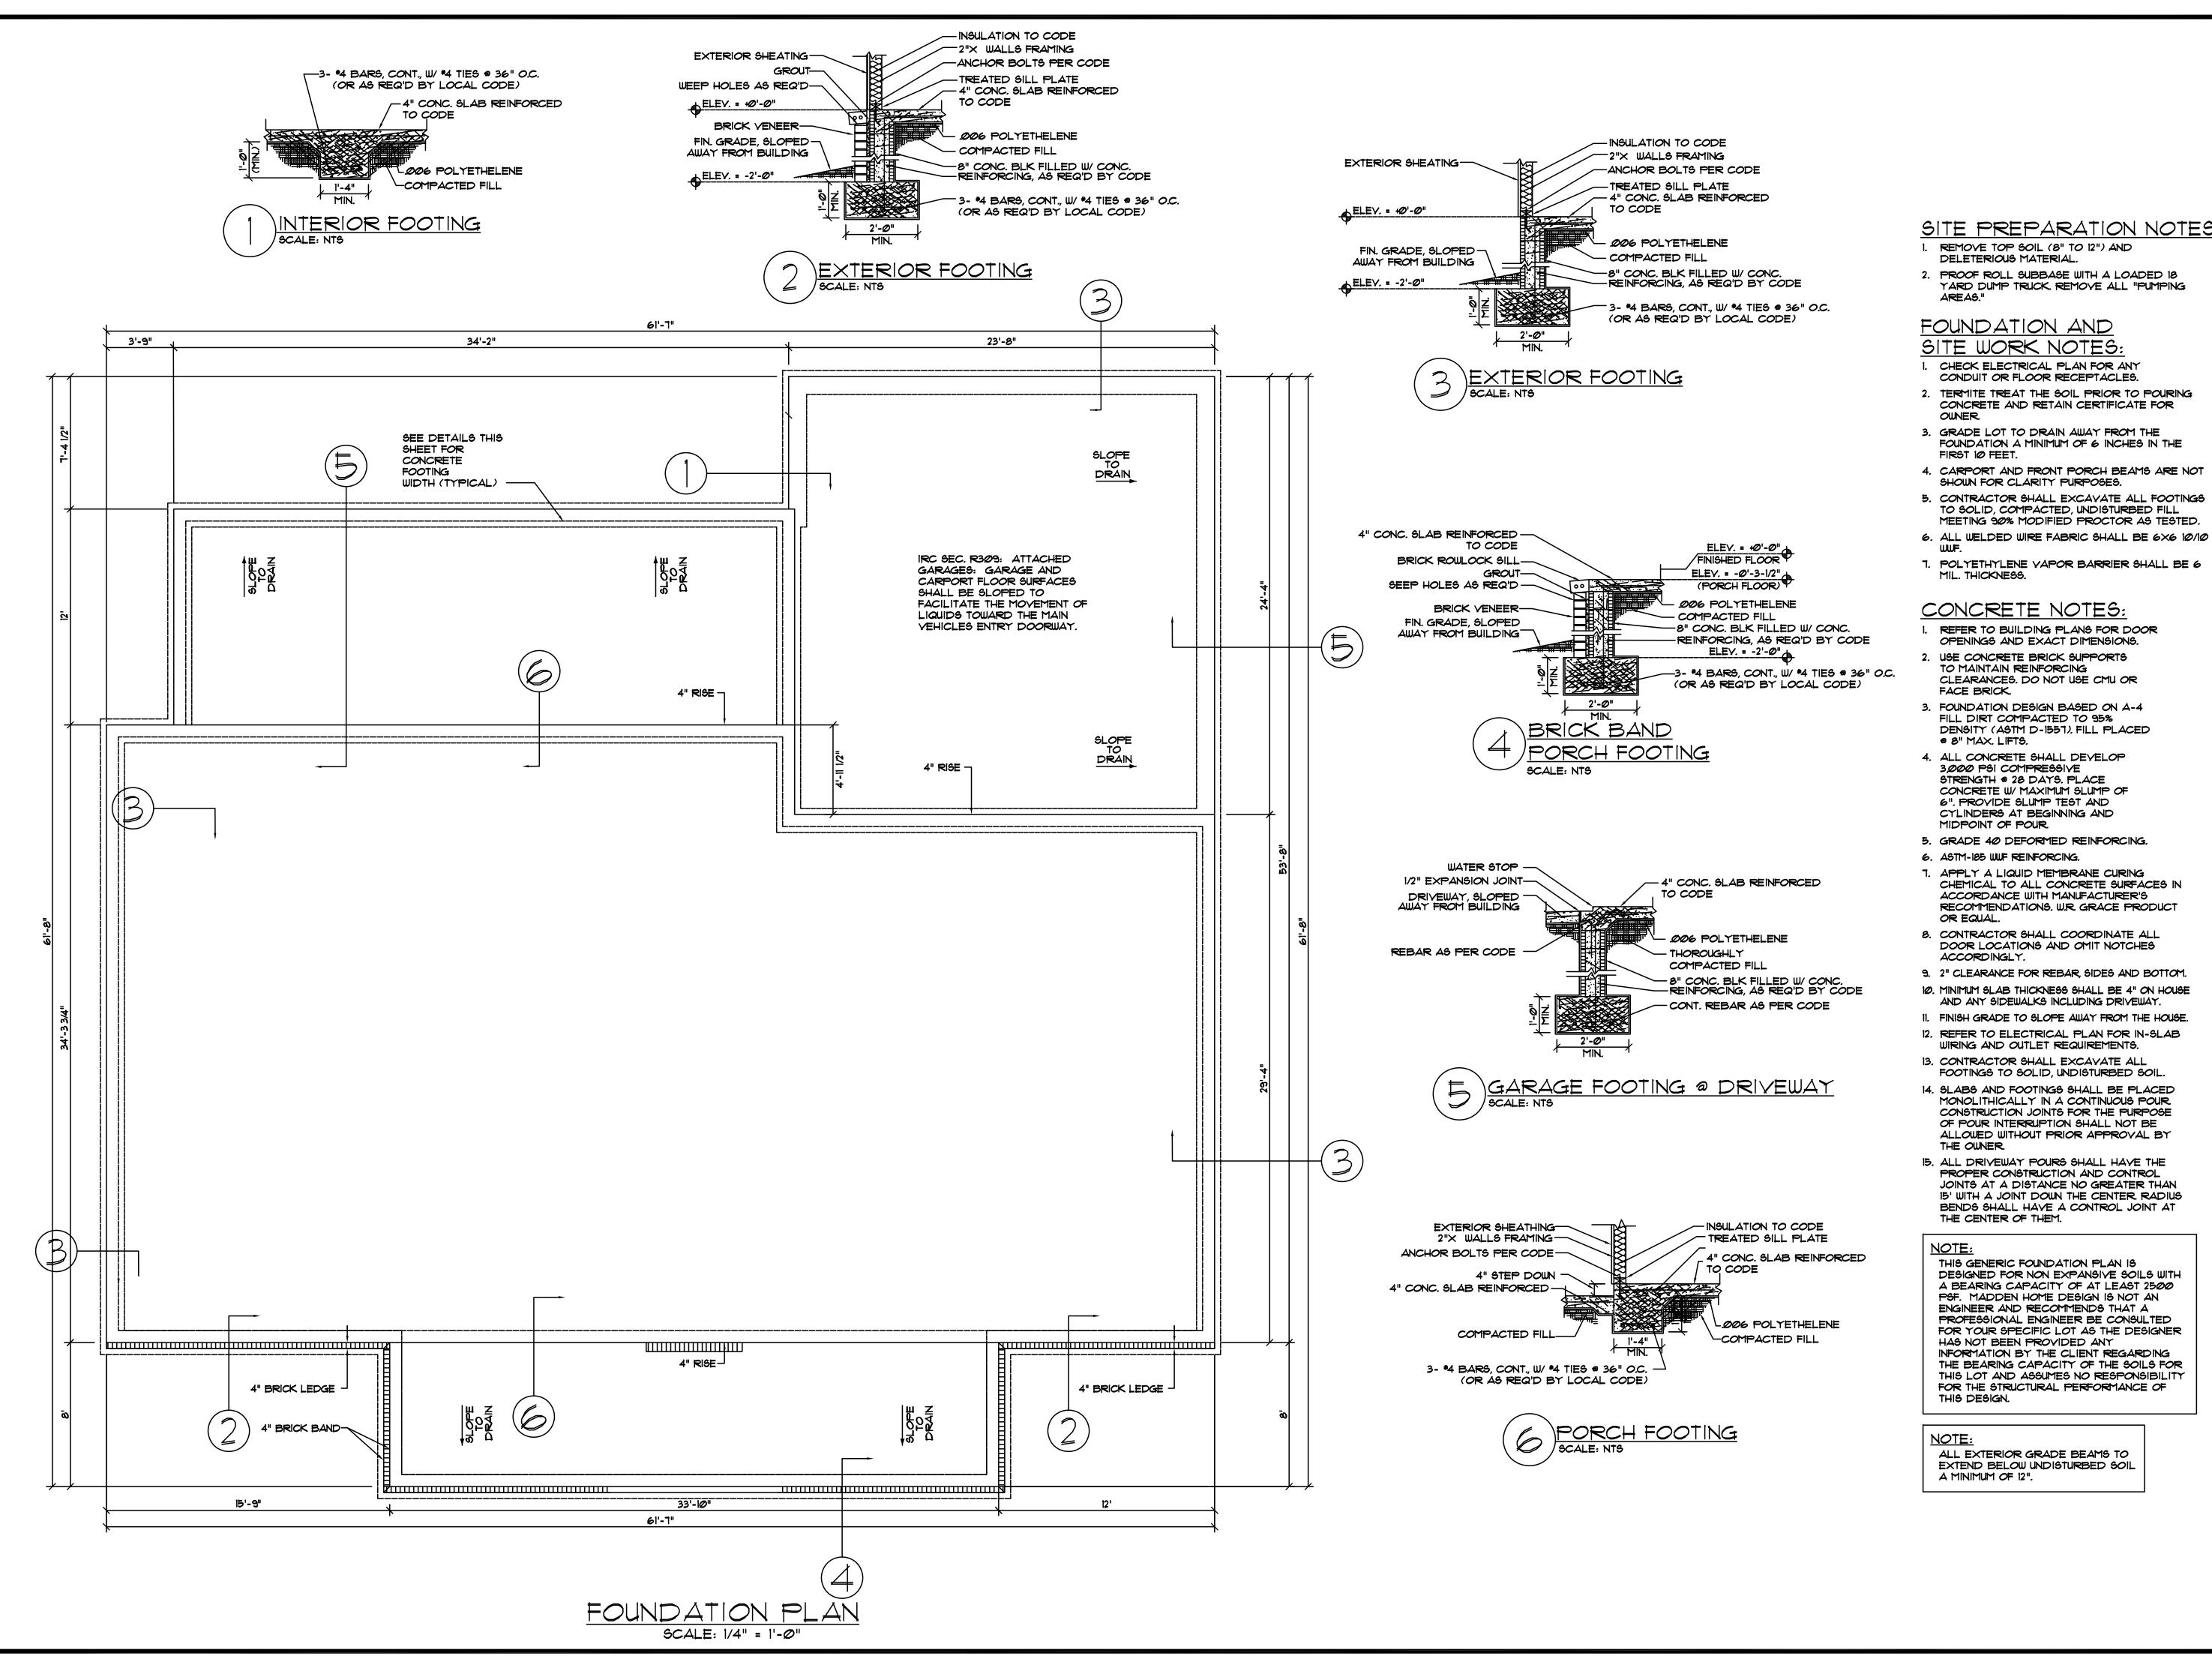

SITE PREPARATION NOTES:

REMOVE TOP SOIL (8" TO 12") AND

YARD DUMP TRUCK. REMOVE ALL "PUMPING

- 2. TERMITE TREAT THE SOIL PRIOR TO POURING CONCRETE AND RETAIN CERTIFICATE FOR
- 3. GRADE LOT TO DRAIN AWAY FROM THE FOUNDATION A MINIMUM OF 6 INCHES IN THE
- 5. CONTRACTOR SHALL EXCAYATE ALL FOOTINGS TO SOLID, COMPACTED, UNDISTURBED FILL MEETING 90% MODIFIED PROCTOR AS TESTED.
- 7. POLYETHYLENE VAPOR BARRIER SHALL BE 6

- OPENINGS AND EXACT DIMENSIONS.
- 2. USE CONCRETE BRICK SUPPORTS CLEARANCES. DO NOT USE CMU OR
- FILL DIRT COMPACTED TO 95% DENSITY (ASTM D-1551). FILL PLACED

- 10. MINIMUM SLAB THICKNESS SHALL BE 4" ON HOUSE AND ANY SIDEWALKS INCLUDING DRIVEWAY.
- 14. SLABS AND FOOTINGS SHALL BE PLACED MONOLITHICALLY IN A CONTINUOUS POUR. CONSTRUCTION JOINTS FOR THE PURPOSE OF POUR INTERRUPTION SHALL NOT BE
- PROPER CONSTRUCTION AND CONTROL JOINTS AT A DISTANCE NO GREATER THAN 15' WITH A JOINT DOWN THE CENTER RADIUS BENDS SHALL HAVE A CONTROL JOINT AT

THIS GENERIC FOUNDATION PLAN IS PSF. MADDEN HOME DESIGN IS NOT AN ENGINEER AND RECOMMENDS THAT A PROFESSIONAL ENGINEER BE CONSULTED HAS NOT BEEN PROVIDED ANY INFORMATION BY THE CLIENT REGARDING FOR THE STRUCTURAL PERFORMANCE OF

ALL EXTERIOR GRADE BEAMS TO EXTEND BELOW UNDISTURBED SOIL

2. PROOF ROLL SUBBASE WITH A LOADED 18

FOUNDATION AND SITE WORK NOTES

- CONDUIT OR FLOOR RECEPTACLES.

- 4. CARPORT AND FRONT PORCH BEAMS ARE NOT SHOWN FOR CLARITY PURPOSES.

- REFER TO BUILDING PLANS FOR DOOR
- STRENGTH # 28 DAYS. PLACE CONCRETE W/ MAXIMUM SLUMP OF 6". PROVIDE SLUMP TEST AND CYLINDERS AT BEGINNING AND
- 5. GRADE 40 DEFORMED REINFORCING.
- T. APPLY A LIQUID MEMBRANE CURING CHEMICAL TO ALL CONCRETE SURFACES IN ACCORDANCE WITH MANUFACTURER'S RECOMMENDATIONS. W.R. GRACE PRODUCT
- 8. CONTRACTOR SHALL COORDINATE ALL DOOR LOCATIONS AND OMIT NOTCHES
- 9. 2" CLEARANCE FOR REBAR, SIDES AND BOTTOM.
- 11. FINISH GRADE TO SLOPE AWAY FROM THE HOUSE
- 12. REFER TO ELECTRICAL PLAN FOR IN-SLAB WIRING AND OUTLET REQUIREMENTS.
- 13. CONTRACTOR SHALL EXCAYATE ALL FOOTINGS TO SOLID, UNDISTURBED SOIL.
- ALLOWED WITHOUT PRIOR APPROVAL BY
- 15. ALL DRIVEWAY POURS SHALL HAVE THE

DESIGNED FOR NON EXPANSIVE SOILS WITH A BEARING CAPACITY OF AT LEAST 2500 FOR YOUR SPECIFIC LOT AS THE DESIGNER THE BEARING CAPACITY OF THE SOILS FOR THIS LOT AND ASSUMES NO RESPONSIBILITY

Project No.: HONEYSUCKLE MARCH 14, 2022

DRAWN BY: Steven Madden DESIGNED BY: Steven Madden

COPYRIGHT NOTE: 0 These Plans Are Subject To Federal Copyright Laws And Are To Be Used For The Lot Number And Subdivision Indicated In This Title Block

Only. Use On Any Other Site is

Prohibited. © COPYRIGHT 2022

Sheet Title **FOUNDATION**

PLAN

□ Preliminary Dwg.

☐ Bidding Doc.

CEILING JOIST SPANS CEILING JOIST SPANS FOR SOUTHERN PINE SPECIES (UNINHABITABLE ATTIC WITHOUT STORAGE, LIVE LOAD = 20PSF, LA= 240) DEAD LOAD = 10 PSF **IF HABITABLE ATTIC SPACE OR STORAGE IS DESIRED, REFER TO INTERNATIONAL RESIDENTIAL CODE SPAN TABLES SPACING VISUALLY GRADED #2 SOUTHERN PINE SIZE (MAXIMUM CEILING JOIST SPAN) (FT.-IN.) (INCHES) 12.0 9-3 16.0 8-0 2"×4" 19.2 7-4 24*.*Ø 6-7 12.0 13-11 16.0 12-0 2"x6" 19.2 11-0 24*.*Ø 9-10 12.0 17 - 7 16.0 15-3 2"x8" 19.2 13-11 24*.*Ø 12-6 12.0 20-11 16.0 18-1 2"xlØ" 19.2 16-6

(LIVE L	_OAD = 20 PS	3F, L∆= 240) DEAD LOAD = 10 P9
SIZE	SPACING (INCHES)	SPANS (MAXIMUM RAFTER SPAN BETWEEN BRACING) (FTIN.)
	12.0	12 - 11
21146 11	16.0	11-2
2"x6"	19.2	10-2
	24.0	9-2
	12.00	16-4
2"x8"	16.0	14-2
2 0	19.2	12 – 11
	24.0	11-7
	12.00	19-5
2"x1Ø"	16.0	16-10
2"XIO"	19.2	15-4
	24.0	13-9
	12.00	22-100
2"x12"	16.0	19-10
2"XI2"	19.2	18-1
	24.0	16-2

RAFTER SPANS

24.0 14-9 NOTE: THE ABOVE TABLE IS BASED ON THE IRC 2018 NOTE: THE ABOVE TABLE IS BASED ON THE IRC 2018 TABLE R802.5.1 (2) TABLE R802.4.1 (3) 2 × 6 JOISTS 2×6 JOISTS 2 × 6 JOIST\$ 2 × 6 JOISTS

ON SOUTHERN YELLOW PINE.

CEILING JOIST & RAFTER NOTE:

CEILING JOISTS & RAFTERS ARE SELECTED BASED

IF ANOTHER SPECIES OF WOOD IS USED THE JOISTS MUST BE RE-SELECTED, AND IT IS THE BUILDER OR CONTRACTORS RESPONSIBILITY TO RECALCULATE JOIST & RAFTER SIZES TO ENSURE PROPER CONSTRUCTION OF THE HOME.


GENERAL FRAMING NOTES:

THE FOLLOWING NOTES ARE SUGGESTED MINIMUM REQUIREMENTS ONLY. DUE TO A VARIANCE OF CODES PER REGION, PLEASE REFER AND COMPLY WITH ALL YOUR LOCAL CODES. CONSULT WITH LOCAL ENGINEERS FOR ALL STRUCTURAL REQUIREMENTS.

- PROVIDE PURLING AT MID HEIGHT OF ALL WALLS.
- 2. ALL JOIST AND RAFTERS SHALL BE ALIGNED OVER STUDS BELOW.
- ALL HEADERS SHALL BE 2-2×10'S WITH ½" PLYWOOD FLITCH PLATE UNLESS OTHERWISE NOTED.
 PROVIDE IX4 CROSS BRACING AT MIDPOINT OF SPAN OR 8'-0" O.C.
- MAXIMUM IN ALL FLOORS. 5. ALL EXTERIOR CORNERS (INSIDE AND OUTSIDE CORNERS) SHALL BE BRACED WITH $\frac{1}{2}$ " CDX PLYWOOD, NAILING SCHEDULE SHALL BE 8D
- COMMONS AT 4" O.C. AT ALL EDGES AND 8D COMMONS AT 12" O.C. AT ALL INTERMEDIATE STUDS. (OPTION-APPROVED DIAGONAL CORNER BRACES BOTH DIRECTIONS AT ALL CORNERS). 6. ALL COLUMNS OR SOLID FRAMES SHALL EXTEND DOWN THRU ALL
- LEVELS AND TERMINATE AT THE BOTTOM FLOOR AND BE SUPPORTED BY THICKENED SLAB. GRADE BEAM, OR FOOTING DESIGNED TO CARRY
- 1 . PROVIDE DOUBLE 2X6 STRONGBACK AT MIDSPAN FOR CEILING JOISTS WITH SPAN GREATER THAN 10"-0".
- 8. PROVIDE COLLAR TIES AT UPPER \$\frac{1}{3}\$ OF VERTICAL DISTANCE BETWEEN RIDGE BOARD AND CEILING JOISTS AT 4'-0" O.C. MAXIMUM.
 9. HIP, VALLEY RAFTERS, AND RIDGE BOARDS SHALL BE ONE "2X" SIZE LARGER THAN RAFTERS.
- 10. ROOF DECKING SHALL BE $\frac{1}{2}$ " CDX PLYWOOD MINIMUM. 11. WHERE PRE ENGINEERED FLOOR AND ROOF TRUSSES ARE USED, TRUSS MANUFACTURER MUST PROVIDE SHOP DRAWINGS WHICH BEAR SEAL OF REGISTERED ENGINEER IN STATE IN WHICH WORK IS TO BE
- 12. ALL SOLID FRAMING, COLUMNS, BEAMS, ETC., TO BE DESIGNED BY LOCAL STRUCTURAL ENGINEER AND MEET ALL LOCAL CALLS.
- 13. ALL FRAMED WALL DIMENSIONS ARE BASED ON 2X4 STUDS UNLESS
- OTHERWISE NOTED.

 14. COLUMNS SHALL BE ADEQUATELY ANCHORED TO SLAB TO PREVENT LATERAL DISPLACEMENT PER IRC R407.3.
- 15. SITE-ASSEMBLED HEADERS AND GIRDERS TO BE SIZED PER IRC TABLE R502.5(1) AND (2). 16. HEADERS AND GIRDERS WHOSE SPAN EXCEEDS THOSE LISTED IN IRC
- TABLE R502.5(1) AND (2) ARE TO BE ENGINEERED BEAMS TO BE SIZED BY A QUALIFIED PARTY. 17. WALLS ADJACENT TO GARAGE DOOR OPENING TO BE BRACED TO THE
- MINIMUM LENGTHS LISTED IN IRC R602.10.3 VIA SHEATHING OR AN ALTERNATIVE METHOD OF RESISTING SHEAR AS DESIGNED BY A QUALIFIED ENGINEER.
- 18. ROOF AND FLOOR SHEATHING TO COMPLY WITH SPAN CHART R5Ø3.2.1.1 (1)

JAMIE FISHEF

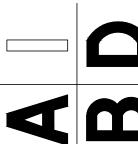

Project No.: HONEYSUCKLE

MARCH 14, 2022

Steven Madden DRAWN BY:

DESIGNED BY: Steven Madden

COPYRIGHT NOTE: © These Plans Are Subject To Federal Copyright Laws And Are To Be Used For The Lot Number And Subdivision Indicated In This Title Block Only. Use On Any Other Site is Prohibited.

© COPYRICHT 2022


Sheet Title

JOISTS FRAMING PLAN

□ Preliminary Dwg. ☐ Bidding Doc.


☐ Construction Do


JOISTS FRAMING PLAN SCALE: 1/4" = 1'-0"

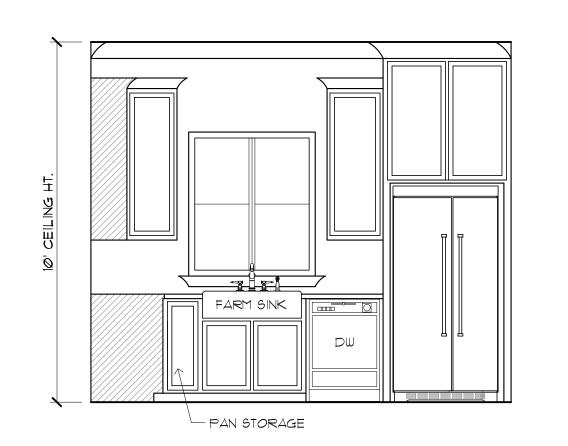



ISLAND ELEVS. SCALE: 3/8" = 1'-0"

SCALE: 3/8" = 1'-0"

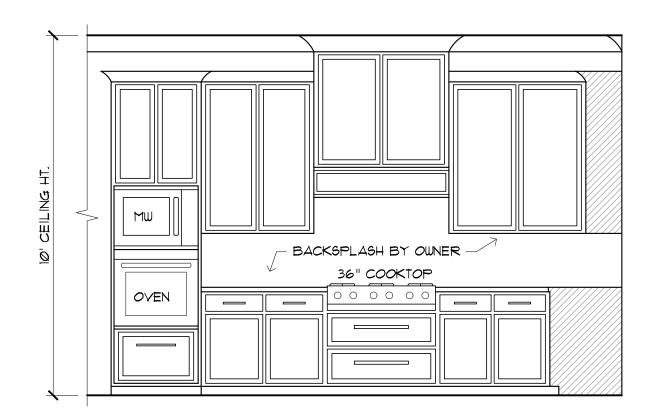

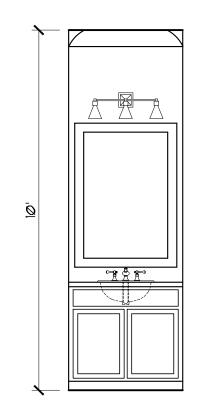

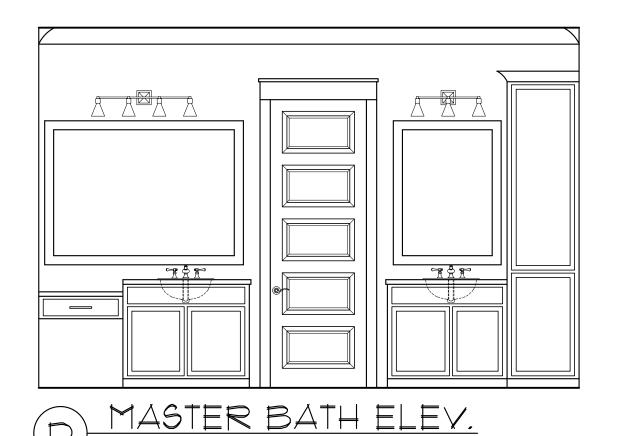

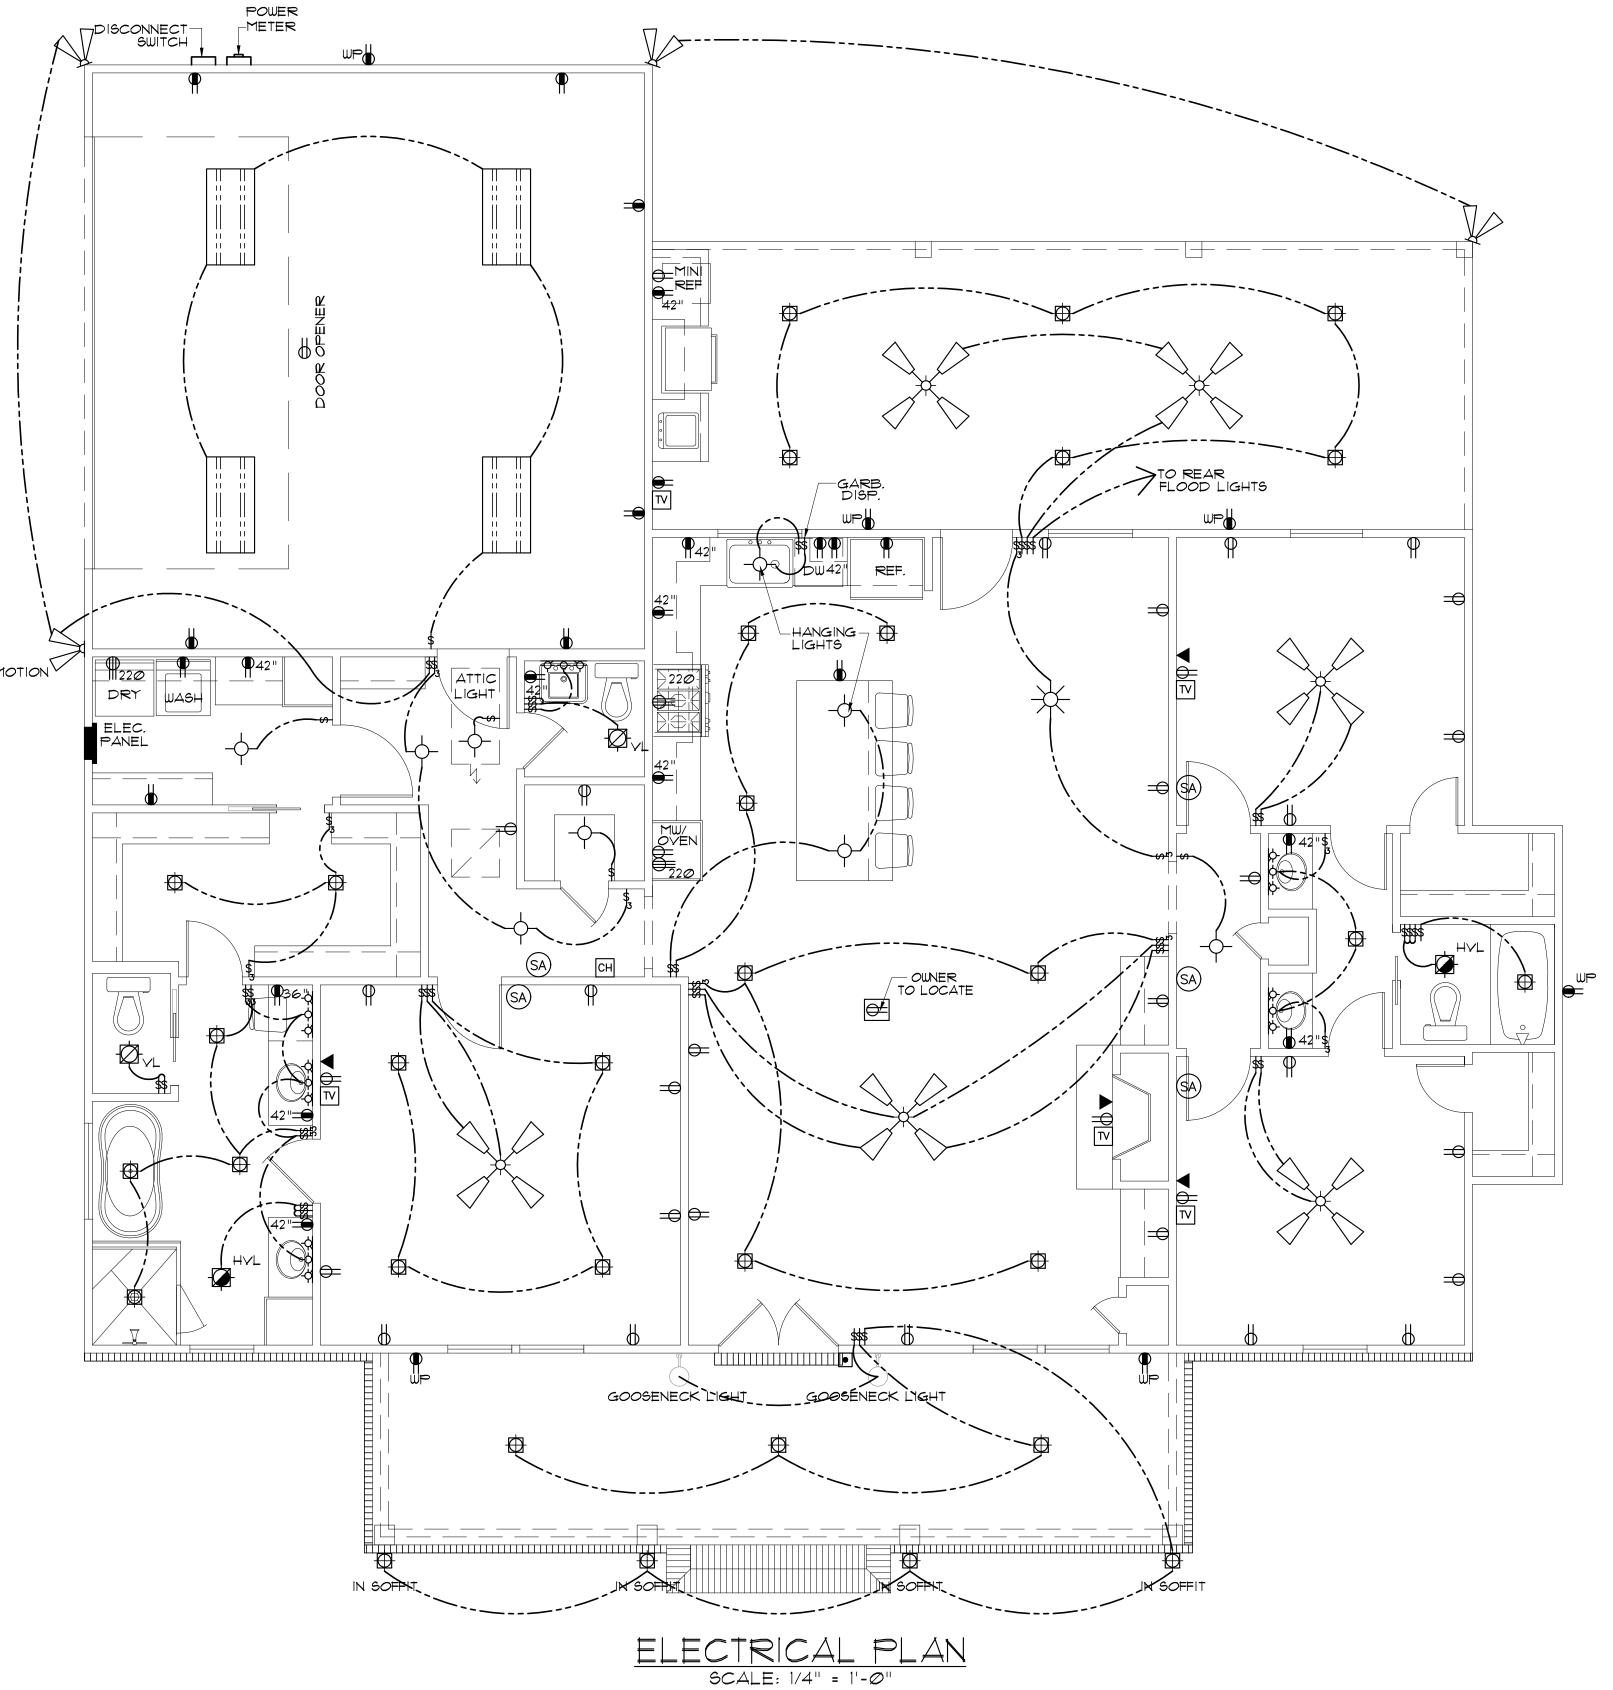

ELECTRICAL SYMBOL LEGEND

CABLE OUTLET

TELEPHONE/ ETHERNET OUTLET

RECEPTACLE, ISA, 125V, 2 POLE 3 WIRE, GROUNDED, DUPLEX

FLOOR DUPLEX RECEPTACLE

GROUND-FAULT-CIRCUIT-INTERLIFT RECEPTACLE-USE SQUARE D QUICK GUARD FOR WP LOCATIONS

 \parallel^{220} RECEPTACLE, 50A, 220V, 2 POLE 3 WIRE, GROUNDED

TOGGLE SWITCH, SINGLE POLE, 15A

TOOGLE SWITCH, 3 WAY, 15A

ELEC. DOOR BELL

DOORBELL CHIME

DIMMER SWITCH

LIGHT FIXTURE, INCANDESCENT CEILING MOUNTED

LIGHT FIXTURE, INCANCESCENT EXTERIOR FLOODS

CEILING FAN W/ LIGHT- PROVIDE SEPERATE SWITCHES FOR F & L

LIGHT FIXTURE - CHANDELIER W/ INCANDESCENT BULBS

LED RECESSED LIGHT

LIGHT FIXTURE - FLOURESCENT

SMOKE ALARM - 110V ELEC. W/ CARBON MONOXIDE DETECTOR

-Q-Q-Q- VANITY LIGHT

VENT/LIGHT RECESSED CAN

HEAT/VENT/LIGHT

VENT/LIGHT ONLY

 $\overline{\chi}$ SCONCE LIGHT

ELECTRIC LANTERN

PRE-WIRE FOR THE FOLLOWING:

- TELEPHONE *ONE INCOMING LINE*

- CABLE VISION *ONE OUTLET PER ROOM MINIMUM*

- SECURITY SYSTEM - COORDINATE W/ OWNER - COORDINATE ELECTRICAL SYSTEM WITH MECHANICAL CONTRACTOR

- ALL WIRING TO BE COPPER MIN. 12/2 W/ GROUND - VERIFY LOCATION OF FLOOR OUTLETS IN FAMILY ROOM

- PROVIDE 110Y OUTLET FOR GARAGE DISPOSAL UNDER KITCHEN SINK

- PROVIDE 110Y OUTLET FOR WHIRLPOOL TUB MOTOR UNDER WHIRLPOOL TUB IN MASTER BATH IF APPLICABLE

- PROVIDE 220V OUTLET FOR CLOTHES DRYER - COORDINATE SURROUND SYSTEM W/ OWNER

ELECTRICAL NOTES:

- MAIN FEED INTO HOUSE TO BE TRENCHED UNDERGROUND FROM SUPPLY

POLE TO METER THEN MAIN DISCONNECT OUTSIDE.

- ALL SMOKE DETECTORS TO BE ELECTRIC POWERED WITH BATTERY

BACKUP AND WIRED TO SET ALL ALARMS OFF IF ONE IS TRIPPED. - ALL EXTERIOR, KITCHEN, AND BATH OUTLETS TO BE GROUND FAULT

CIRCUIT INTERRUPT EQUIPPED AND ON A SEPARATE CIRCUIT. - ELECTRICAL DISCONNECTS ARE TO BE AT A/C UNIT, CONDENSING UNIT,

AND WATER HEATER. - HEAT VENT LIGHTS ARE TO BE ON A SEPARATE CIRCUIT.

- OUTLETS, INCLUDING PHONE AND CABLE, MAY BE ADDED OR CHANGED UPON OWNERS REQUEST.

- ELECTRICAL CONTRACTOR TO VERIFY EQUIPMENT TYPE AND SIZE. - INSTALL LIGHTS IN ATTIC SPACE W/ SWITCH AT FOOT OF DISP. STAIRS - ELECTRICAL SERVICE TO BE A 42 CIRCUIT 200 AMP MAIN LOCATED IN


- A SUB-PANEL MAY NEED TO BE ADDED FOR ENOUGH CIRCUITS. - HOUSE TO BE WIRED FOR A SECURITY SYSTEM.

- ALL KITCHEN OUTLETS ARE TO BE GFI EXCEPT APPLIANCE OUTLETS NOT

EASILY ACCESSIBLE.

- ARC FAULT BREAKERS ARE TO BE USED IN ALL BEDROOMS. - IF GAS FIRED APPLIANCES ARE USED IN HOME, CARBON MONOXIDE ALARMS ARE NEEDED (IRC R315).

JAMIE FISHEF

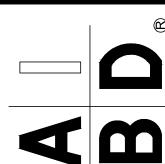

Project No.: HONEYSUCKLE

MARCH 14, 2022

Steven Madden

DESIGNED BY: Steven Madden

COPYRIGHT NOTE: © These Plans Are Subject To Federal Copyright Laws And Are To Be Used For The Lot Number And Subdivision Indicated In This Title Block Only. Use On Any Other Site is Prohibited.

OCOPYRICHT 2022

Sheet Title

ELECTRICAL PLAN

☐ Preliminary Dwg.

☐ Bidding Doc. ☐ Construction Do