

ELEVATION NOTES

BUILDING CODES:
THIS PLAN HAS BEEN DESIGNED
UNDER THE NC BUILDING CODES,
2018 RESIDENTIAL EDITION.
ICE GUARDS:
ICE GUARD & WATER SHIELD
REQUIRED ON ALL ROOF SLOPES
4:12 & LESS PER NCRBC

VENTING CALCULATIONS:


CRAWLSPACE:
THE MIN. NET FREE AREA OF CRAWL
VENTILATION OPENINGS SHALL NOT BE
LESS THAN 1 SQ. FT. FOR EACH 150 SQ. FT.
OF CRAWL SPACE AREA.

1827 SQ. FT. CRAWL SPACE AREA
/ 150

12.2 SQ. FT. NET FREE AREA REQUIRED
*MAY BE REDUCED BY 50% W. VAPOR BARRIER

ATTIC:
3272 SQ. FT. OF ATTIC / 300 = 11. SQ. FT.
OF INLET AND OUTLET.

VENTILATION MAY BE REDUCED 50% WHEN
VENTILATORS ARE USED AT LEAST 3'-0"
ABOVE THE CORNICE VENTS.

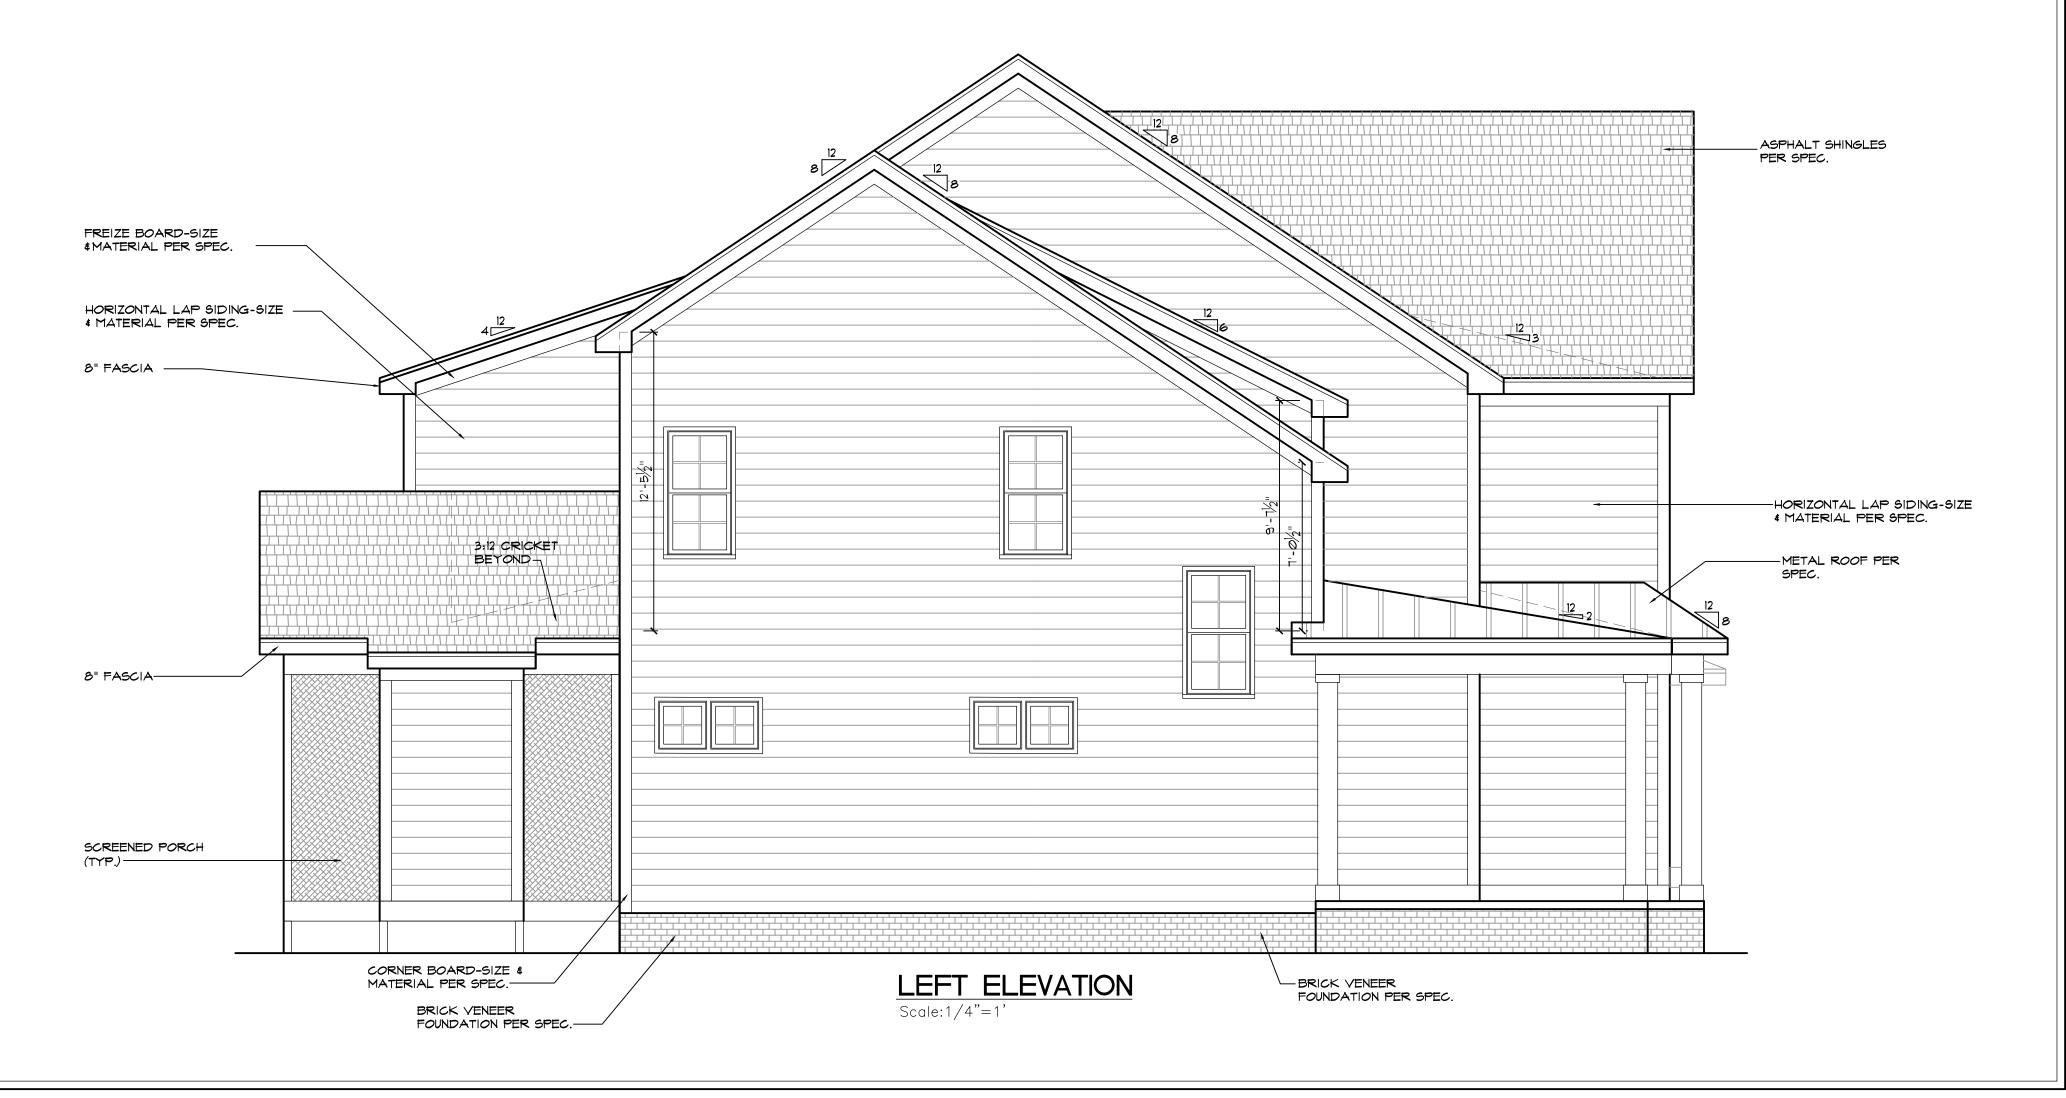

847 Wake Forest Business Park. Suite 102 Wake Forest, NC 27587 Office: 919.263.1509 / Fax: 919.263.1512 www.mcmillan-design.com

ICG Homes

FRONT & LEFT ELEVATIONS

	REVIS	SIONS
	NUMBER	DATE
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Plan Number
M213-2

Sheet No.

Drawn By: TB

COPVRIGHT 2021

Date: **08-31-21**

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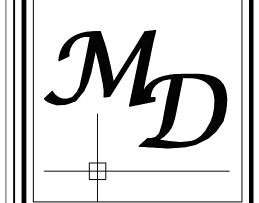




Scale:1/4"=1'

GARAGE AWNING

Scale:1/2"=1'



ICG Homes

REAR / RIGHT ELEVATIONS

REVIS	REVISIONS				
NUMBER	DATE				

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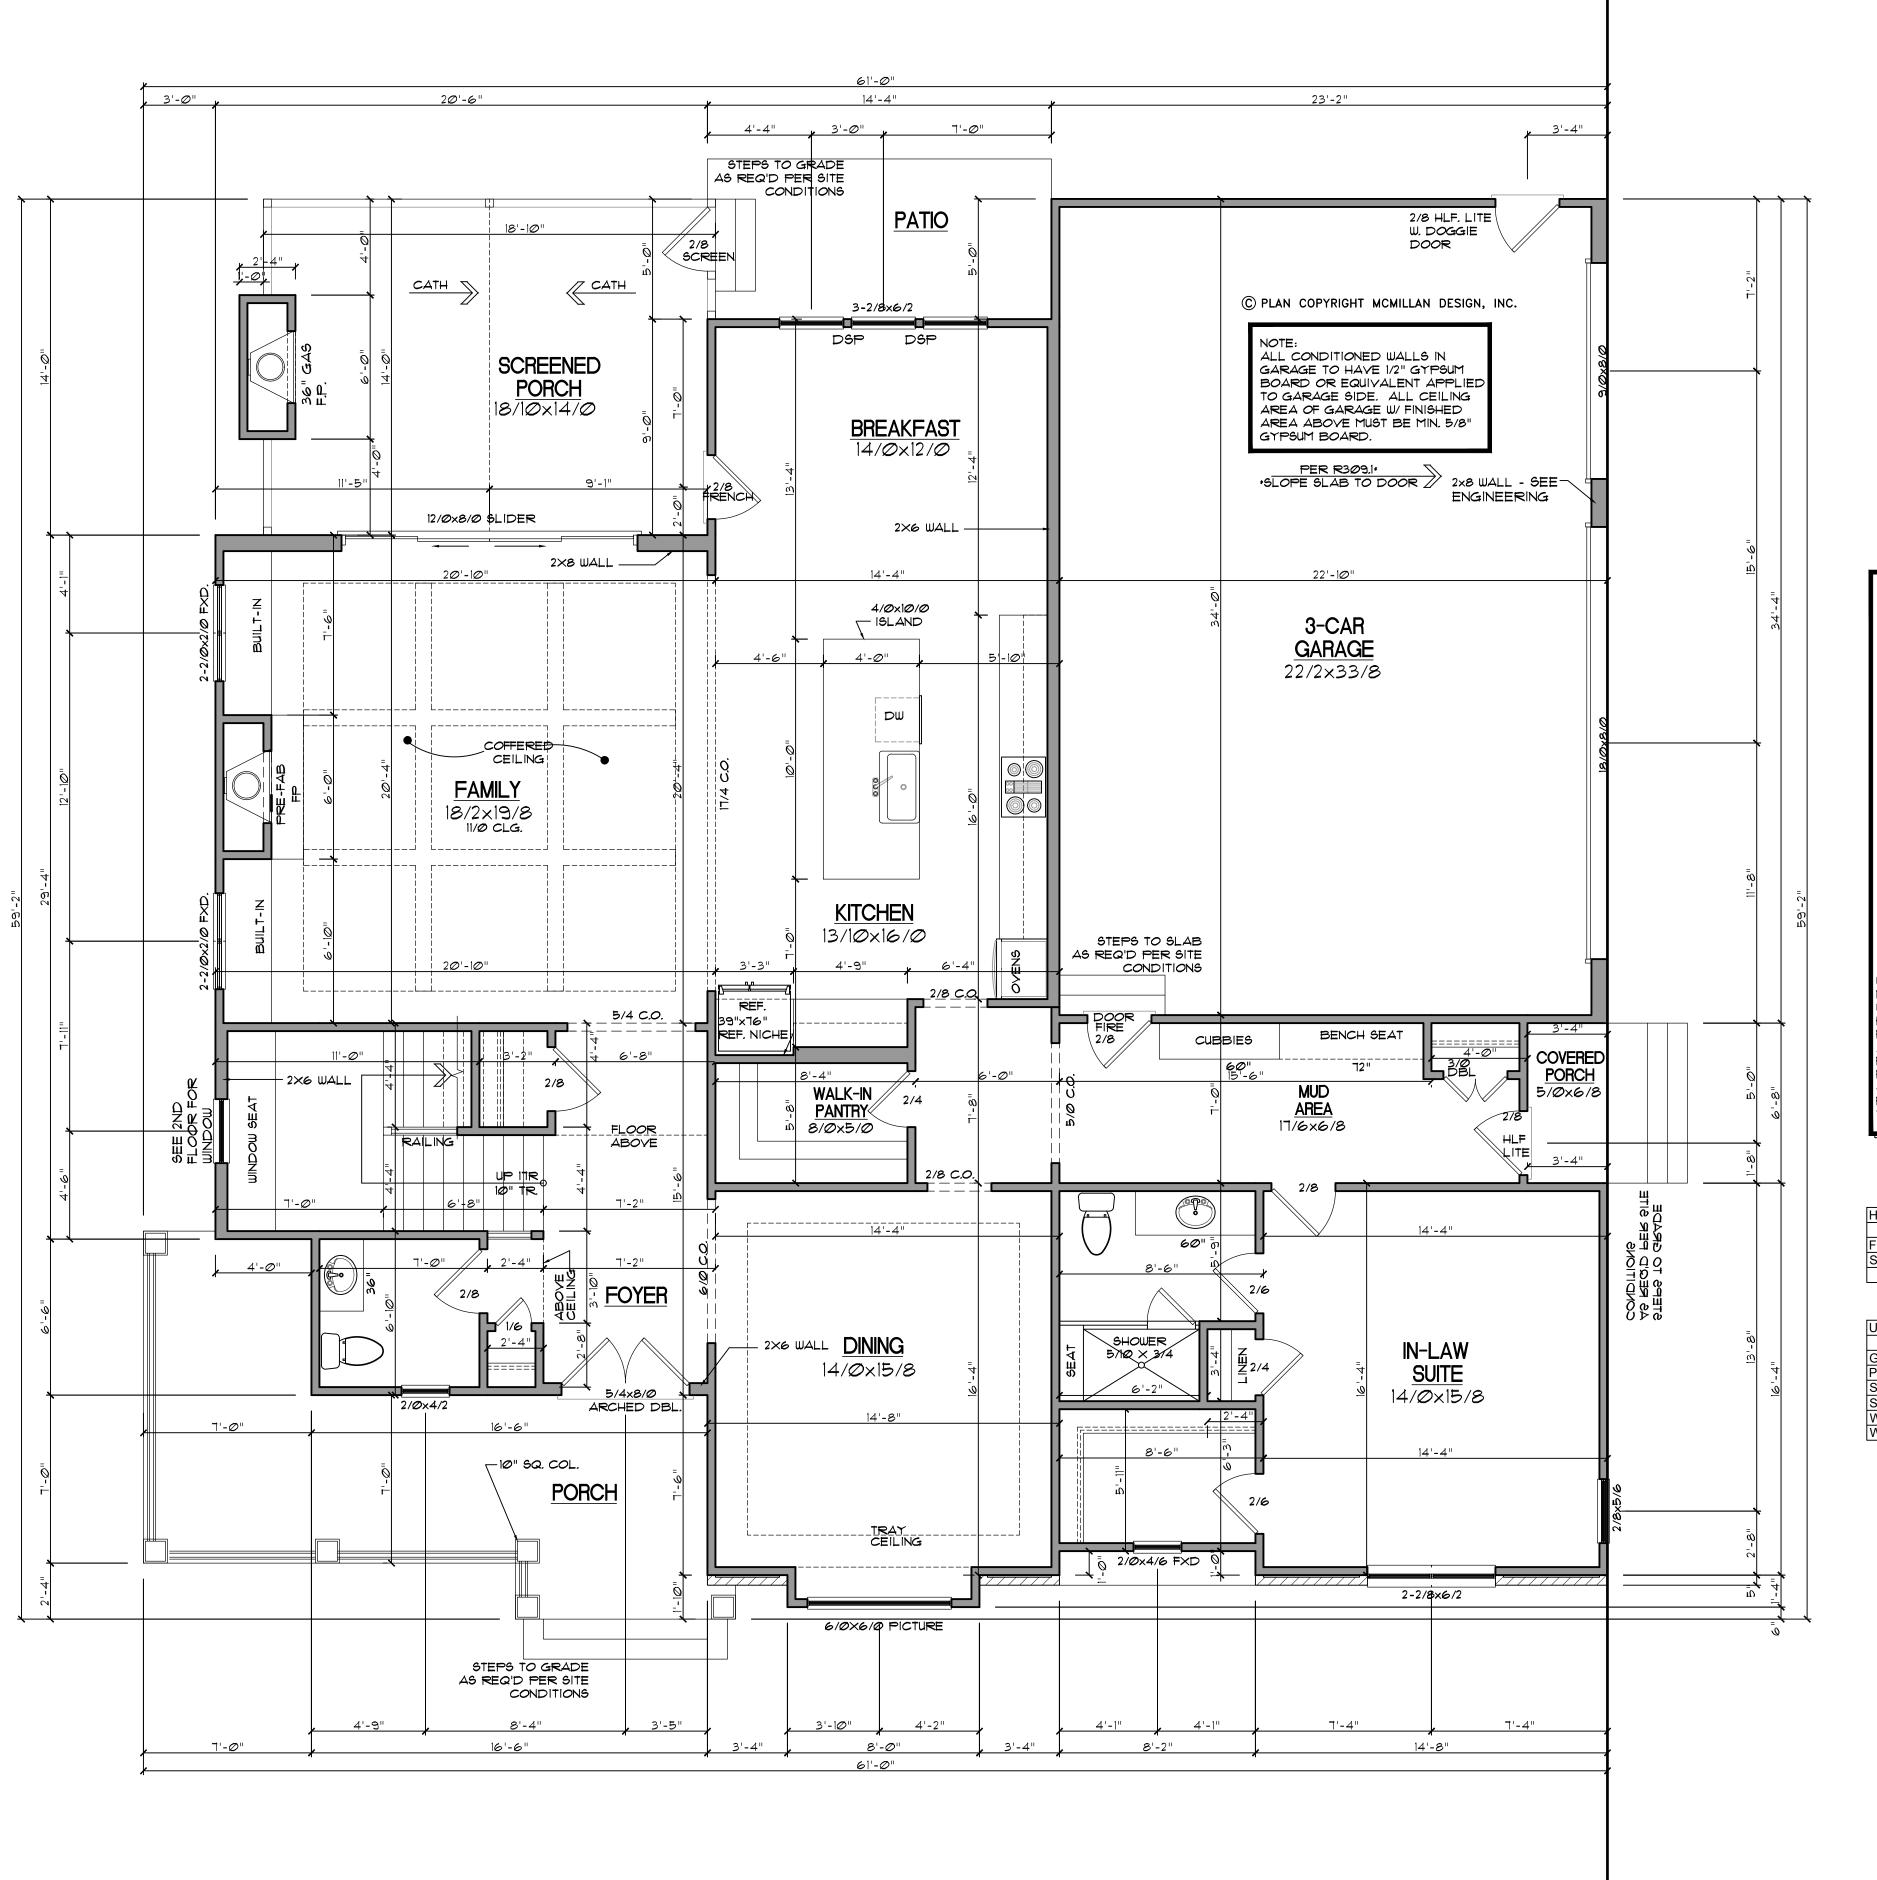
Sheet No.

A2

Drawn By: TB

Date: 08-31-21

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GENERAL NOTES ALL WALLS ARE DRAWN 4" THICK UN.O. ANGLED WALL ARE DRAWN @45° U.N.O. SMOKE DETECTORS: LOCATION AND NUMBER OF DETECTORS SHALL CONFORM EGRESS: ALL BEDROOMS MUST HAVE AT LEAST ONE WINDOW WHICH CONFORMS TO R-310 OF THE N.C. BLDG. CODE. IT IS THE CONTRACTOR'S RESPONSIBILITY TO VERIFY CHOSEN WINDOWS MEET EGRESS REQUIREMENTS AS MANUFATURERS VARY. ATTIC ACCESS: MIN. ATTIC ACCESS SHALL BE PROVIDED BY BUILDER AND LOCATED ON SITE. WALL/CEILING HGT. WALL AND CEILING HEIGHT NOTES ARE BASED ON NOMINAL WALL SIZE.
KNEE WALL HEIGHT LABELS
FOR WALLS UNDER RAFTERS ASSUME AN EXTRA 2" FOR FURRING (IN HEATED SPACES) FOR INSULATION. THE WALL
HEIGHT REFERS TO THE HGT.
FROM THE FLOOR DECKING TO THE BOTTOM OF THE FURRING.

SQUARE FOOTAGE

Heated Square Footage	
First Floor	1,988.2
Second Floor	2,297.0
	4,285.1

Unheated Square Footage	
Garage	779.7
Porch	231.9
Screened Porch	266.7
Side Porch	33.4
Walk up attic	749.4
Walk-In Storage (attic)	441.1

FIRST FLOOR SCALE: 1/4"=1'

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FIRST FLOOR PLAN

REVIS	SIONS
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[

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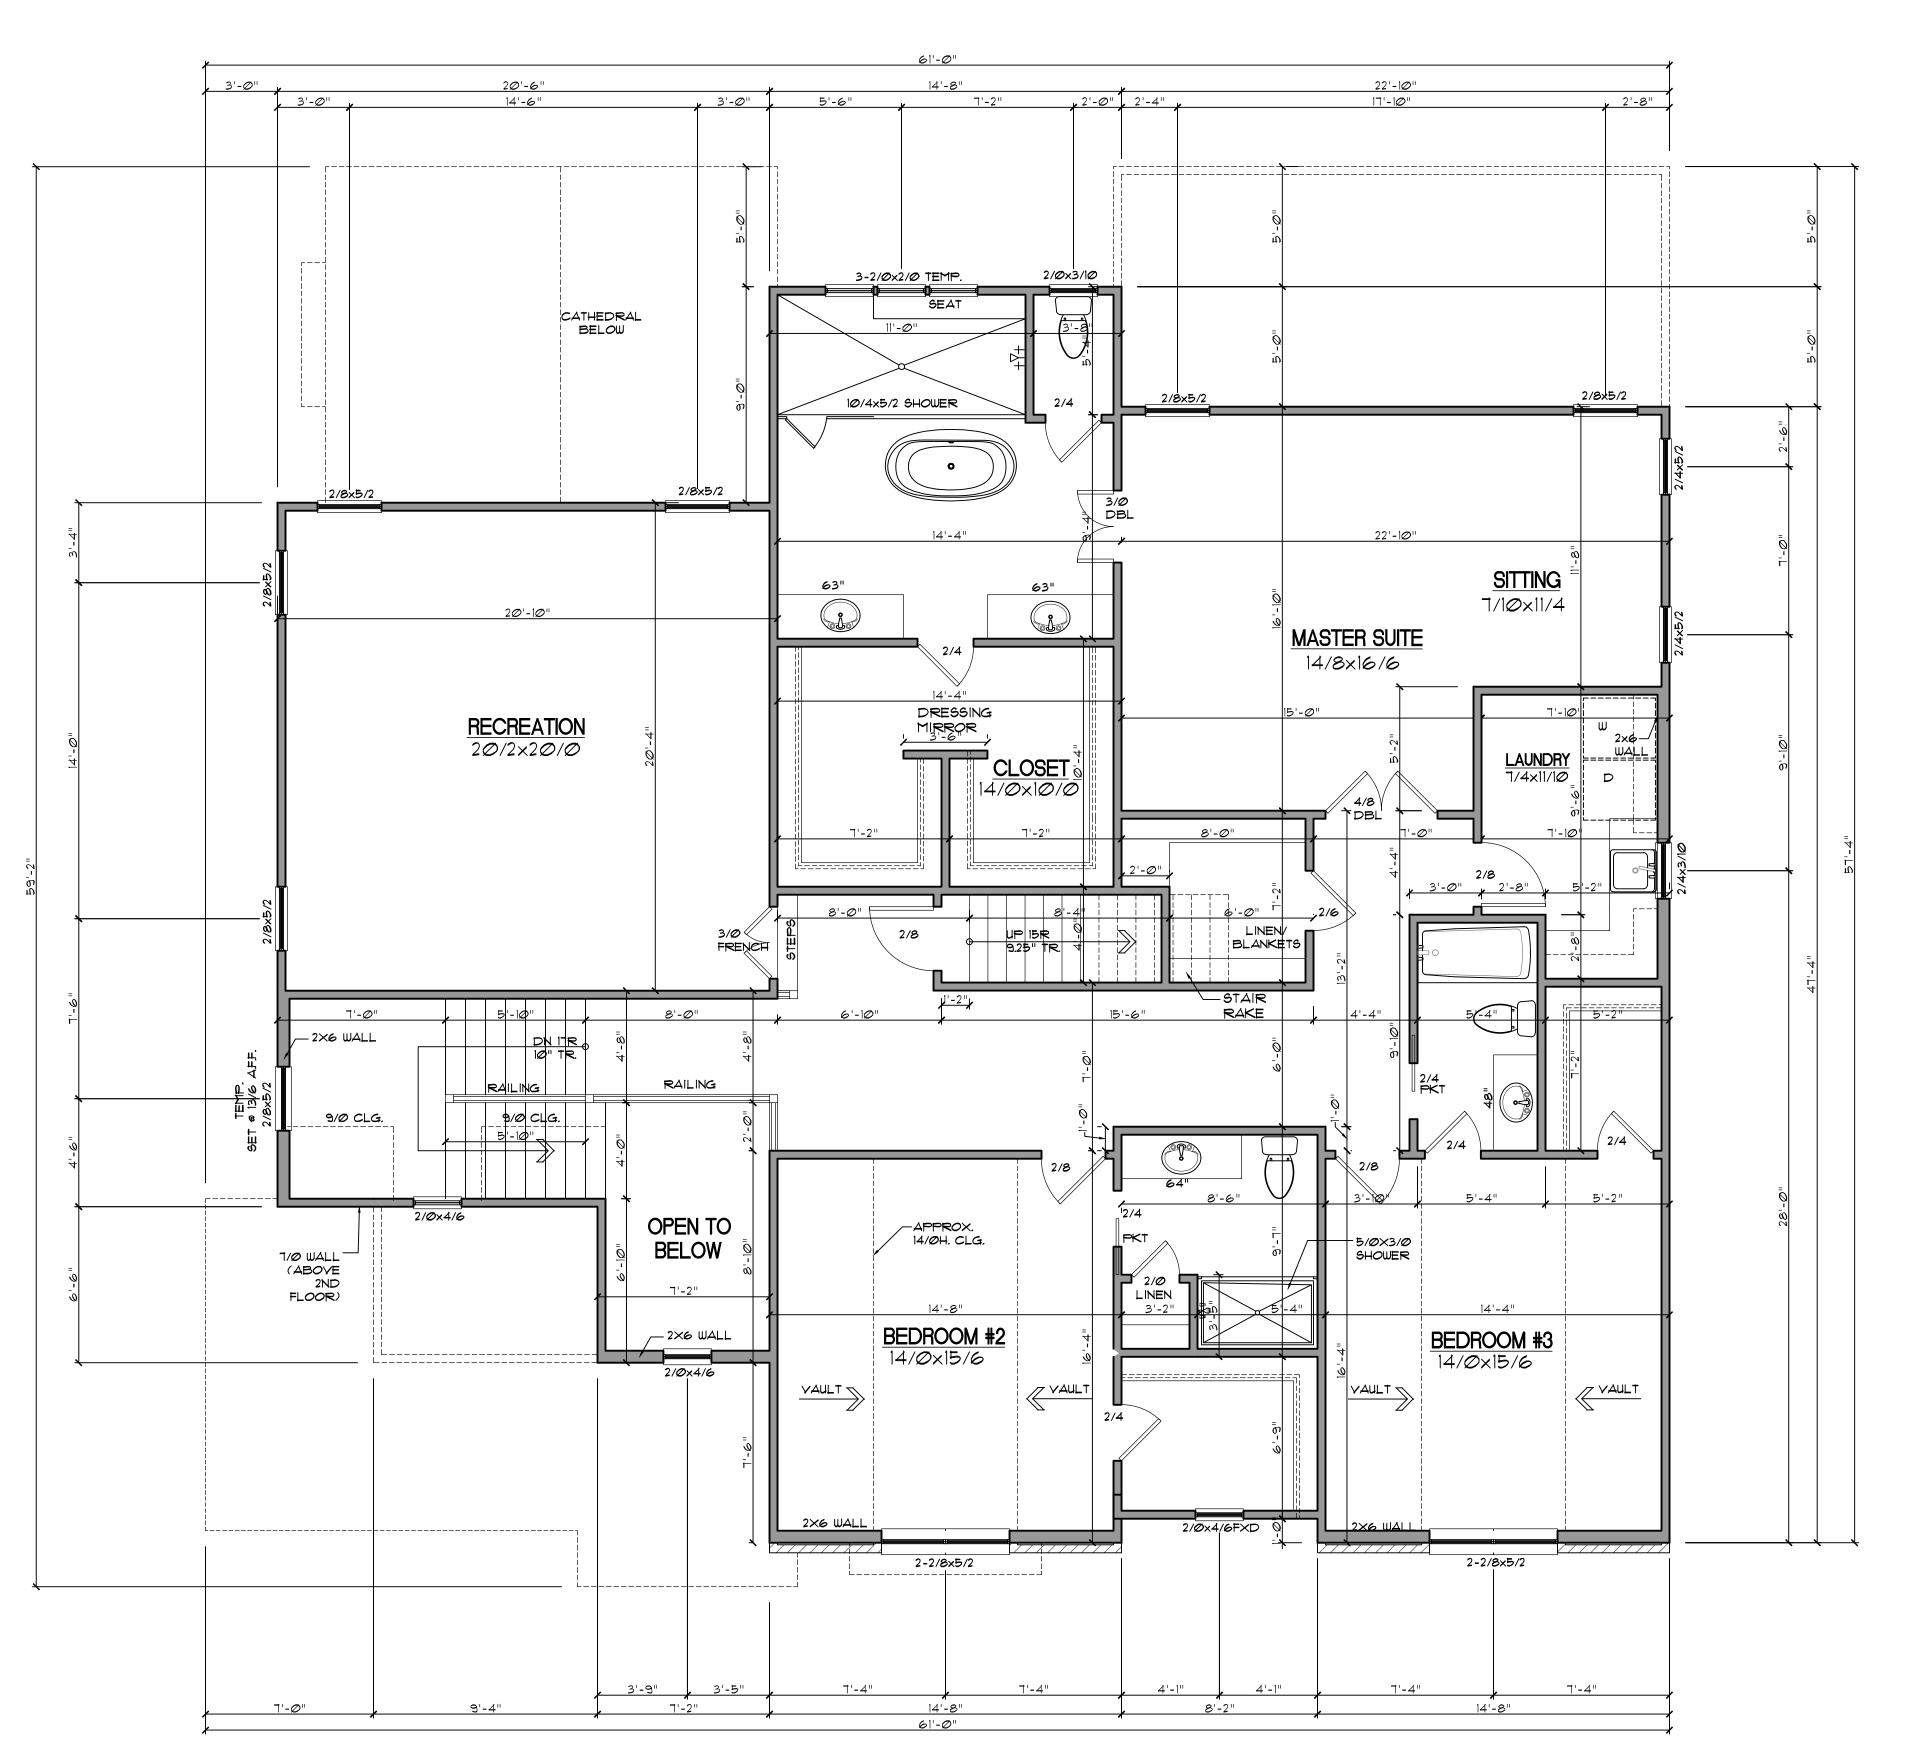
and conditions prior to construction. Caution must be exercised when making modifications to these drawings. If changes are made to these drawings, contact McMillan Design

Plan Number Sheet No. A3

Drawn By: **TB**

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SECOND FLOOR
SCALE: 1/4"=1'

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Sheet Title:
SECOND FLOOR
PLAN

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NUMBER	DATE				

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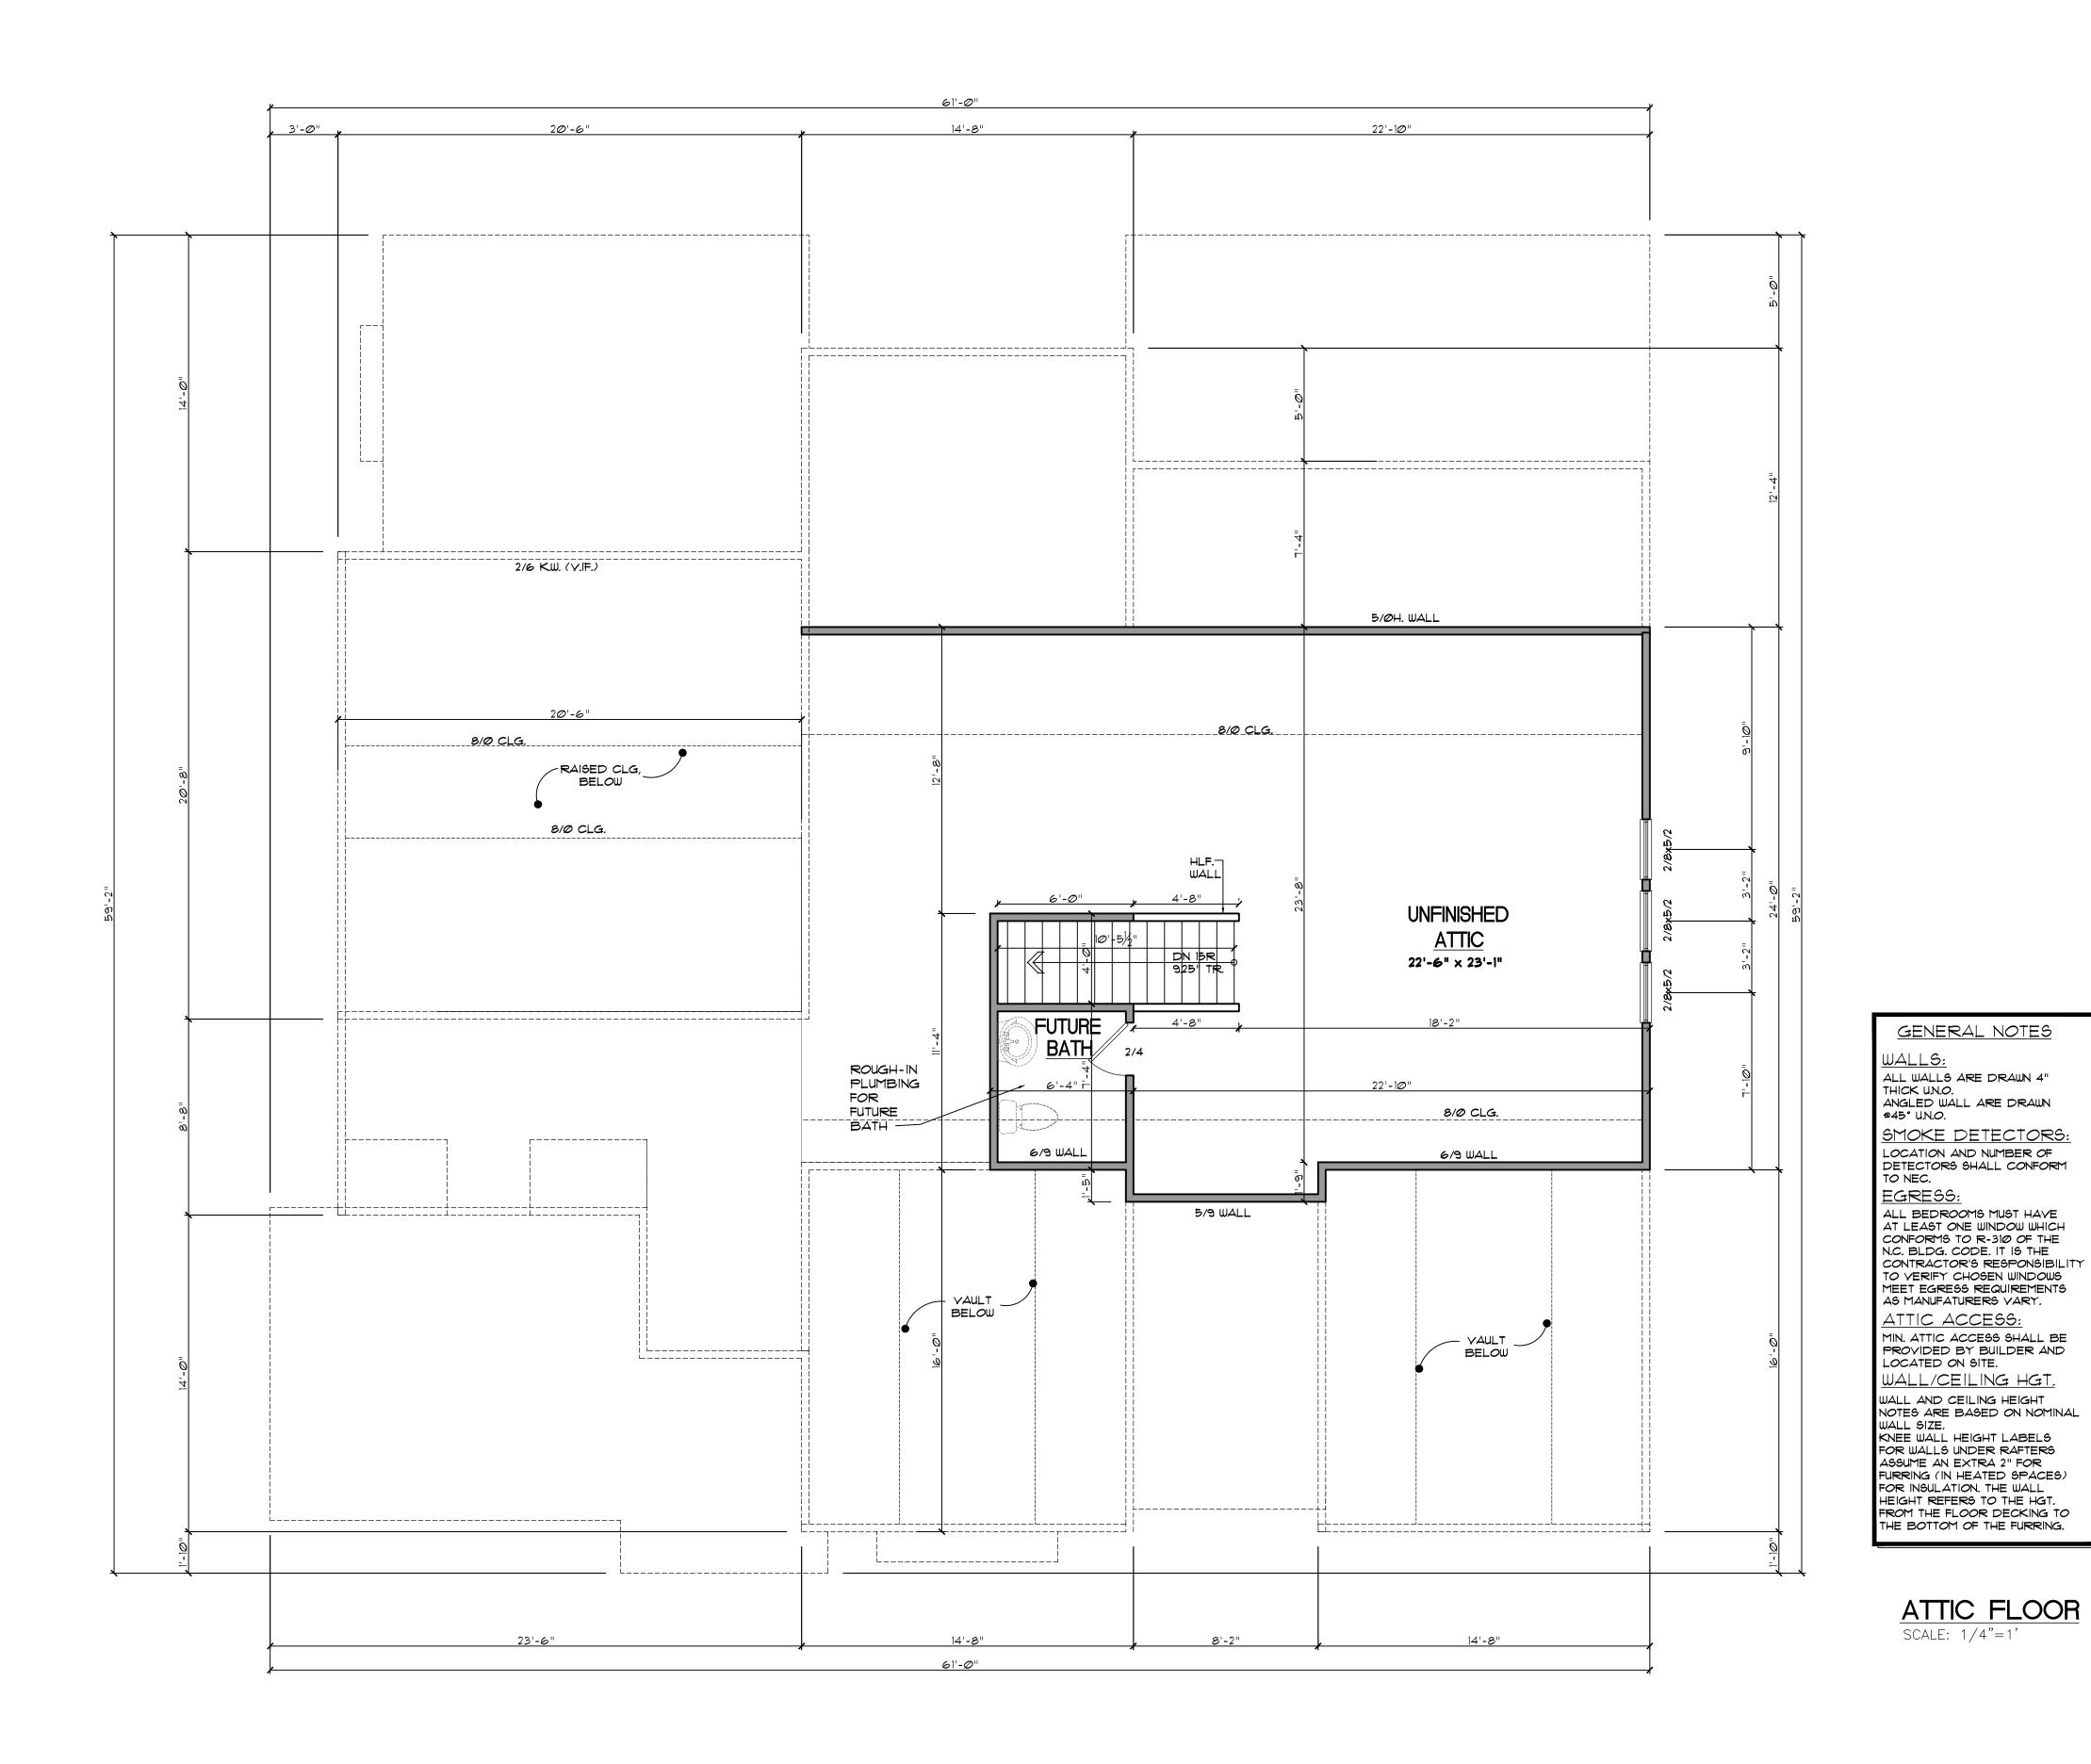
Plan Number M213-2


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ICG Homes

ATTIC FLOOR
PLAN

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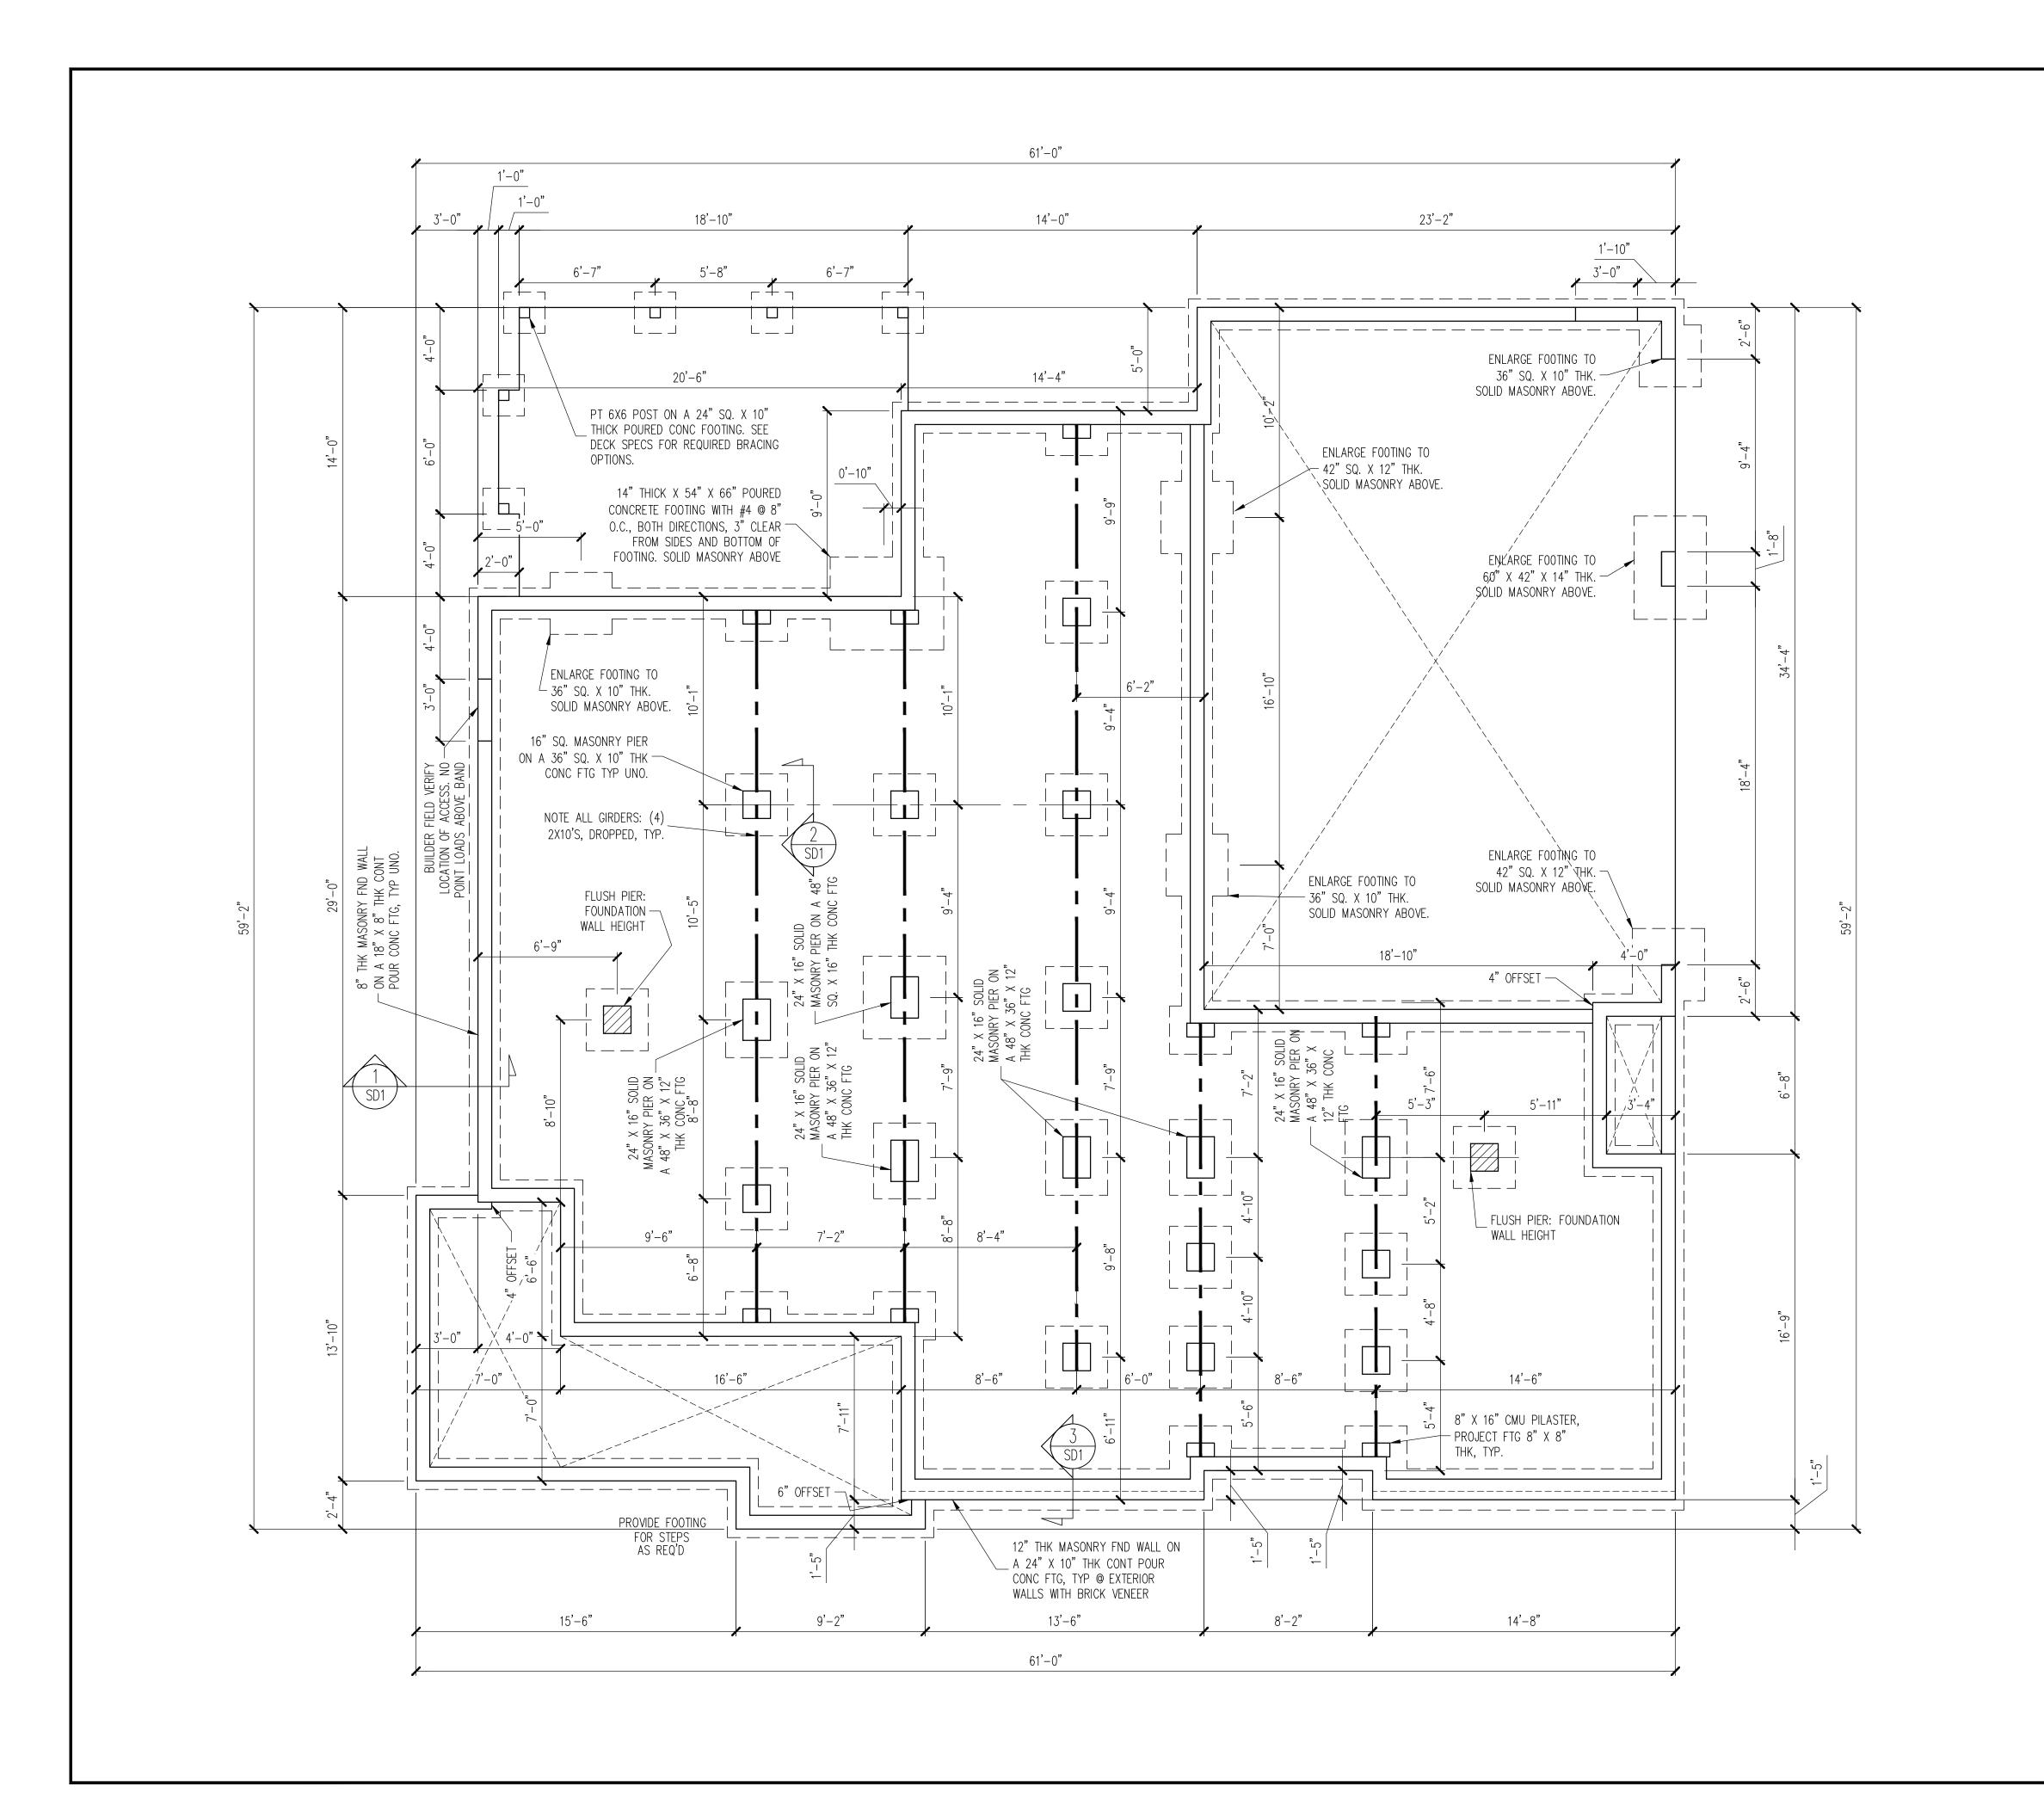
Sheet No. A5

Drawn By: MMc.


Date: **01.14.2020**
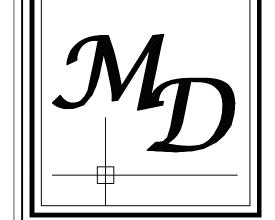
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ON GROU	BUM	ENG	REV:	DATE
INNOVATIVE CONSTRUCTION GROUP	STRUCTURAL ADDENEBUM			
CLIENT:	SCOPE	LOT #:		

PLAN NO. M213-21

-HEIGHT AND BACKFILL LIMITATIONS FOR FOUNDATION WALLS ARE TO BE GOVERNED BY THE NCSBC, LATEST EDITION.

-BUILDER TO FIELD LOCATE CRAWLSPACE ACCESS OPENING WITH MINIMUM DIMENSIONS

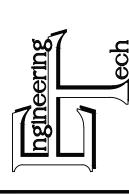OF 18X24. DO NOT LOCATE ACCESS OPENING BELOW POINT LOADS FROM ABOVE WITHOUT ENGINEER APPROVAL.


FOUNDATION PLAN

1/4" = 1'-0"

PROJECT NO. 21-21-209

SHEET NO.

1 of 8

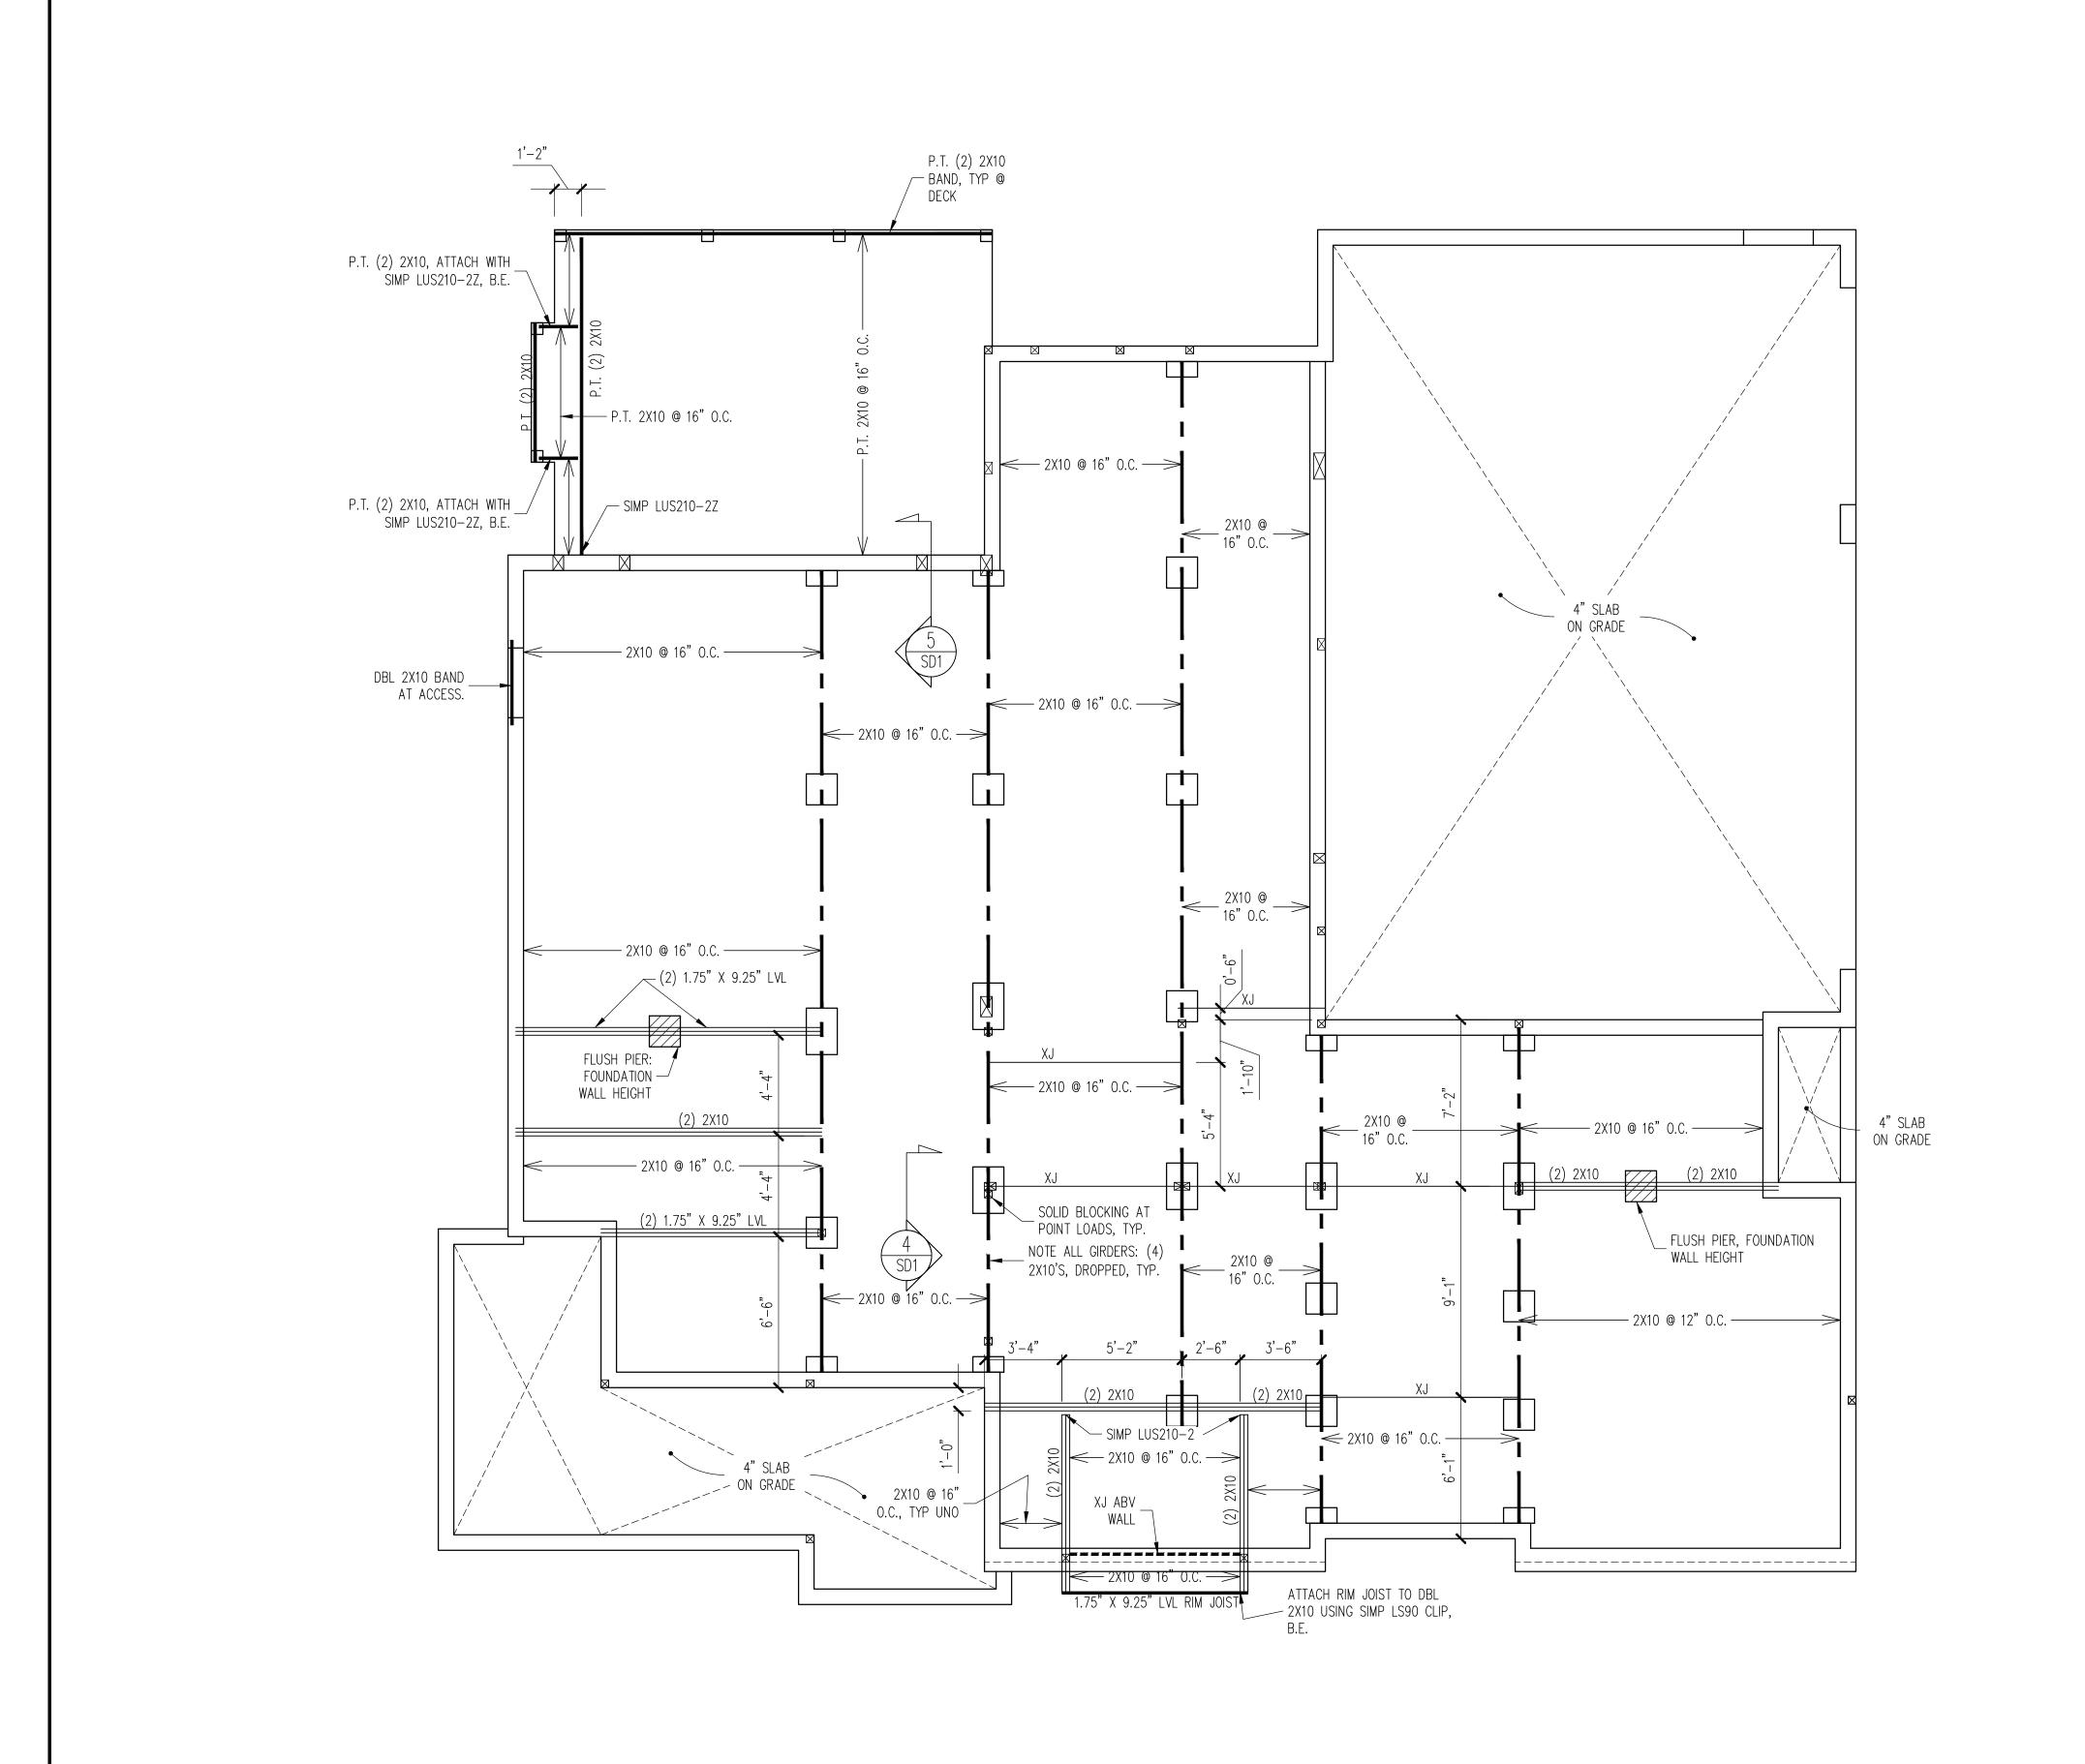

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	IN GROU	BUM	ENG	REV:	DATE
			#:		

PLAN NO. M213-21


PROJECT NO. 21-21-209

CRAWL SPACE FRAMING PLAN

1/4" = 1'-0"

S2 2 of 8

SHEET NO.

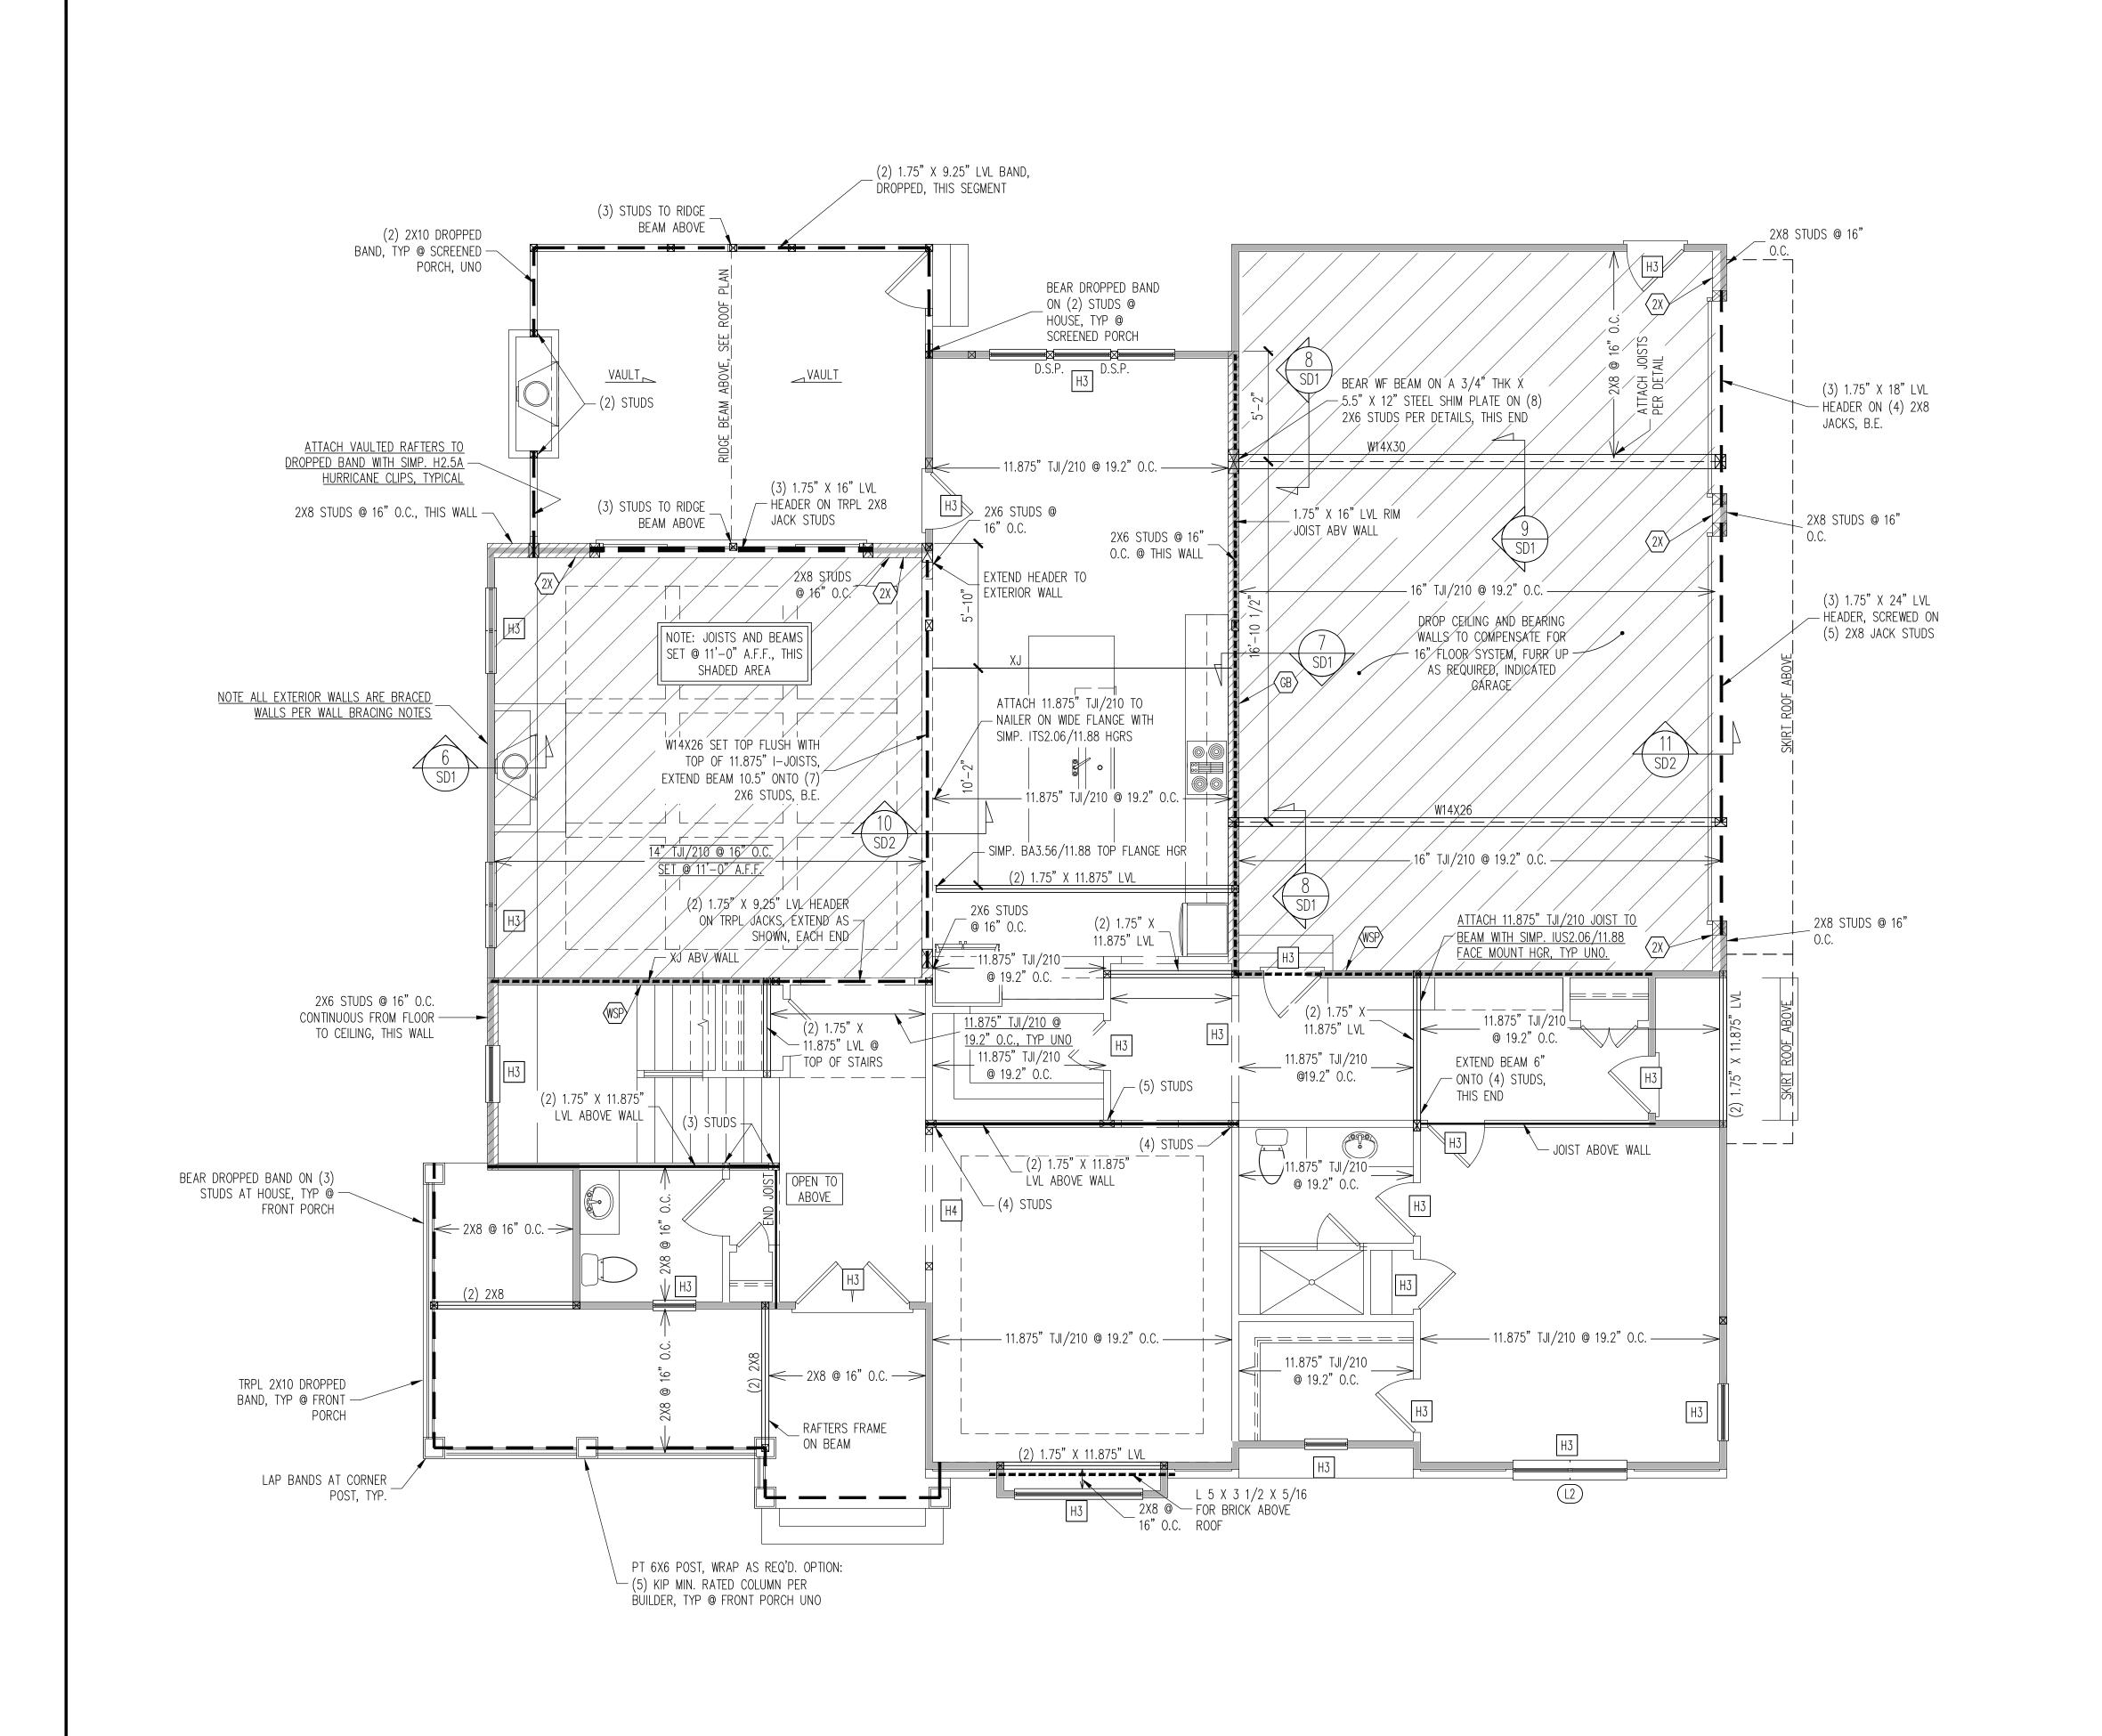

INSTANT REFERENCES

REFER TO THE CONSTRUCTION SPECIFICATIONS

PART 17: KING STUDS FOR EXTERIOR WALLS

SEE DETAIL / CONSTRUCTION SPECIFICATIONS SHEETS FOR I-JOISTS ALLOWABLE SUBSTITUTIONS

- L1 L 3 1/2 X 3 1/2 X 1/4 TYP UNO
- L2 L 5 X 3 1/2 X 5/16
- L3 L 6 X 4 X 5/16 ATTACHED TO HEADER WITH (2) 1/2" X 3" LAG SCREWS @ 16" O.C.

WALL BRACING

SHADED WALLS:

ALL EXTERIOR STUD WALLS, EXTERIOR SIDE, ARE TO BE CONTINUOUSLY SHEATHED WITH 7/16 APA RATED OSB NAILED TO STUDS WITH 8d NAILS @ 6" O.C. AT PANEL EDGES, 12" O.C.

REFERENCE PART 16.02 OF CONSTRUCTION SPECIFICATIONS FOR GENERAL WIND BRACING

HEADER SCHEDULE

- H1 SINGLE 2X4 TURNED FLAT (A)
- H2 (2) 2X4'S ON SINGLE JACKS (B)
- | H3 (2) 2X10'S ON SINGLE JACKS (C)

- WALLS ONLY, ROUGH OPENING 38" MAX.
- (B) TYPICAL FOR INTERIOR NON LOAD BEARING
- (C) TYPICAL FOR ALL CONDITIONS NOT LISTED IN (A) OR (B) UNO.

WALLS AND CEILING 1/4" = 1'-0"

CONSTRUCTION SPECIFICATIONS

SECTIONS FOR THE FOLLOWING INFORMATION:

PART 1.01: <u>CURRENT GOVERNING CODE</u>

PART 14: <u>STUD SUPPORT FOR BEAMS</u>

LINTEL SCHEDULE

- L4 16 GAGE STEEL FLEX LINTEL AT ARCH

IN PANEL FIELD.

- WSP ONE SIDE OF INTERIOR WALL OR INSIDE OF EXTERIOR WALL WITH 3/8" MIN. THICKNESS WOOD STRUCTURAL PANELING. ATTACH WSP TO STUD WALL WITH 8d NAILS @ 4" O.C. AT PANEL EDGES, 8" O.C. IN PANEL FIELD.
- GB INTERIOR BRACED WALL. 1/2" GB SECURED PER TABLE R602.10.2 OF THE 2018 NCRBC. (FASTENERS @ 7" O.C.) BOTH SIDES OF WALL, OR (FASTENERS @ 4" O.C.) ONE SIDE OF WALL AT STAIRS
- $2X SHEATH BOTH SIDES OF STUD WALL WITH <math>\frac{1}{16}$ APA RATED OSB, NAILED TO STUDS WITH 8d NAILS @ 6" O.C. AT PANEL EDGES, 12" O.C. IN PANEL FIELD.

PROVIDED CONTINUOUS SHEATHING = 242' MIN.


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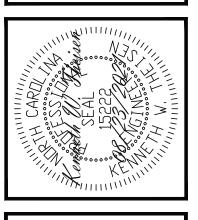
- H4 (2) 1.75" X 9.25" LVL'S ON DBL JACKS
- H5 (3) 2X10'S ON SINGLE JACKS
- (A) TYPICAL FOR INTERIOR NON LOAD BEARING
- WALLS ONLY, ROUGH OPNG 38" TO 74" MAX.

-HEADERS IN NON LOAD BEARING INTERIOR WALLS ARE NOT LABELED.

1ST FLOOR FRAMING PLAN

3 of 8



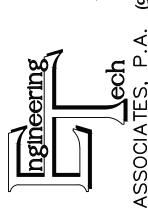


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INNOVATIVE CONSTRUCTION GROUP	STRUCTURAL ADDENEBUM			
CLIENT:	SCOPE	LOT #:		

PLAN NO. M213-21

PROJECT NO. 21-21-209

SHEET NO. \$3

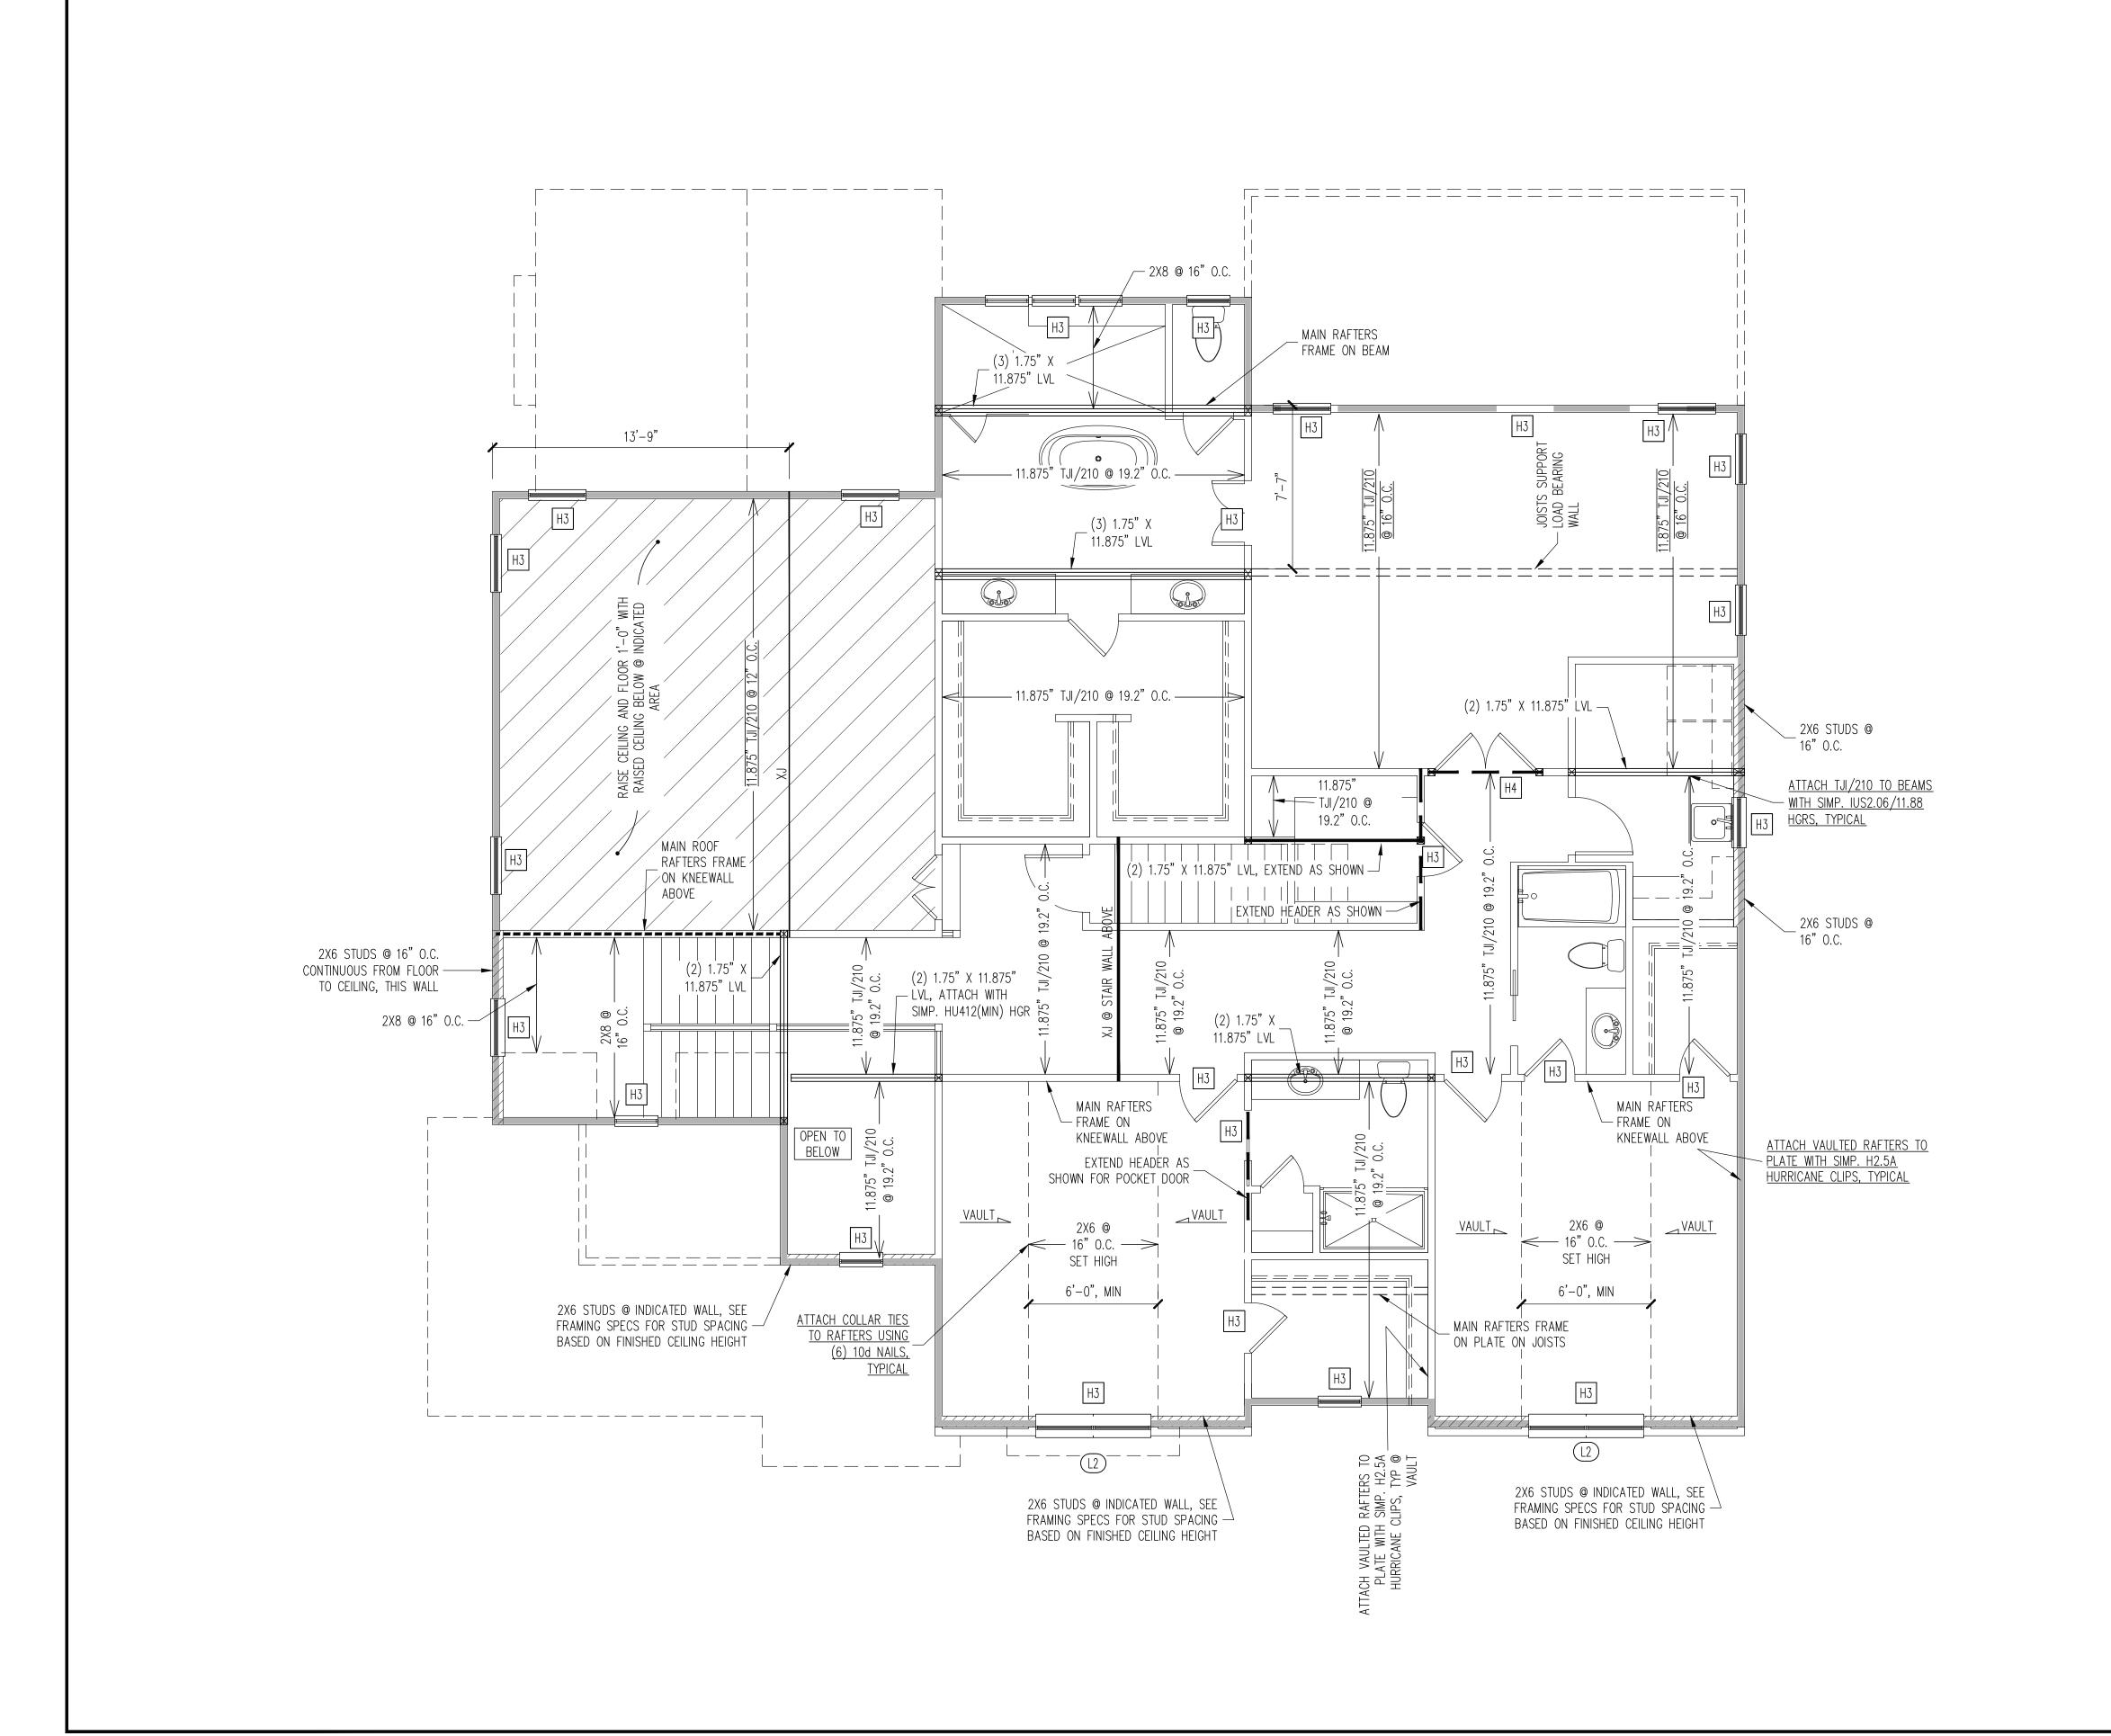

CONSTRUCTION SPECIFICATIONS INSTANT REFERENCES

REFER TO THE CONSTRUCTION SPECIFICATIONS SECTIONS FOR THE FOLLOWING INFORMATION:

PART 1.01: <u>CURRENT GOVERNING CODE</u>

PART 14: <u>STUD SUPPORT FOR BEAMS</u>

PART 17: KING STUDS FOR EXTERIOR WALLS

SEE DETAIL / CONSTRUCTION SPECIFICATIONS
SHEETS FOR I—JOISTS ALLOWABLE SUBSTITUTIONS

LINTEL SCHEDULE

- L1 L 3 1/2 X 3 1/2 X 1/4 TYP UNO
- L2 L 5 X 3 1/2 X 5/16
- L3 L 6 X 4 X 5/16 ATTACHED TO HEADER WITH (2) 1/2" X 3" LAG SCREWS @ 16" O.C.
- L4 16 GAGE STEEL FLEX LINTEL AT ARCH

WALL BRACING

SHADED WALLS:

ALL EXTERIOR STUD WALLS, EXTERIOR SIDE, ARE TO BE CONTINUOUSLY SHEATHED WITH 7/16 APA RATED OSB NAILED TO STUDS WITH 8d NAILS @ 6" O.C. AT PANEL EDGES, 12" O.C. IN PANEL FIELD.

NOTES:

PROVIDED CONTINUOUS SHEATHING = 222' MIN.

REFERENCE PART 16.02 OF CONSTRUCTION SPECIFICATIONS FOR GENERAL WIND BRACING INFORMATION.

HEADER SCHEDULE

- H1 SINGLE 2X4 TURNED FLAT (A)
- H2 (2) 2X4'S ON SINGLE JACKS (B)
- H3 (2) 2X10'S ON SINGLE JACKS (C)
- H4 (2) 1.75" X 9.25" LVL'S ON DBL JACKS
- H5 (3) 2X10'S ON SINGLE JACKS
- (A) TYPICAL FOR INTERIOR NON LOAD BEARING WALLS ONLY, ROUGH OPENING 38" MAX.
- (B) TYPICAL FOR INTERIOR NON LOAD BEARING WALLS ONLY, ROUGH OPNG 38" TO 74" MAX.
- (C) TYPICAL FOR ALL CONDITIONS NOT LISTED IN (A) OR (B) UNO.
- NOTES:

 -HEADERS IN NON LOAD BEARING INTERIOR


 WALLS ARE NOT LABELED.

2ND FLOOR FRAMING PLAN

WALLS AND CEILING $\frac{1/4" = 1'-0"}{}$

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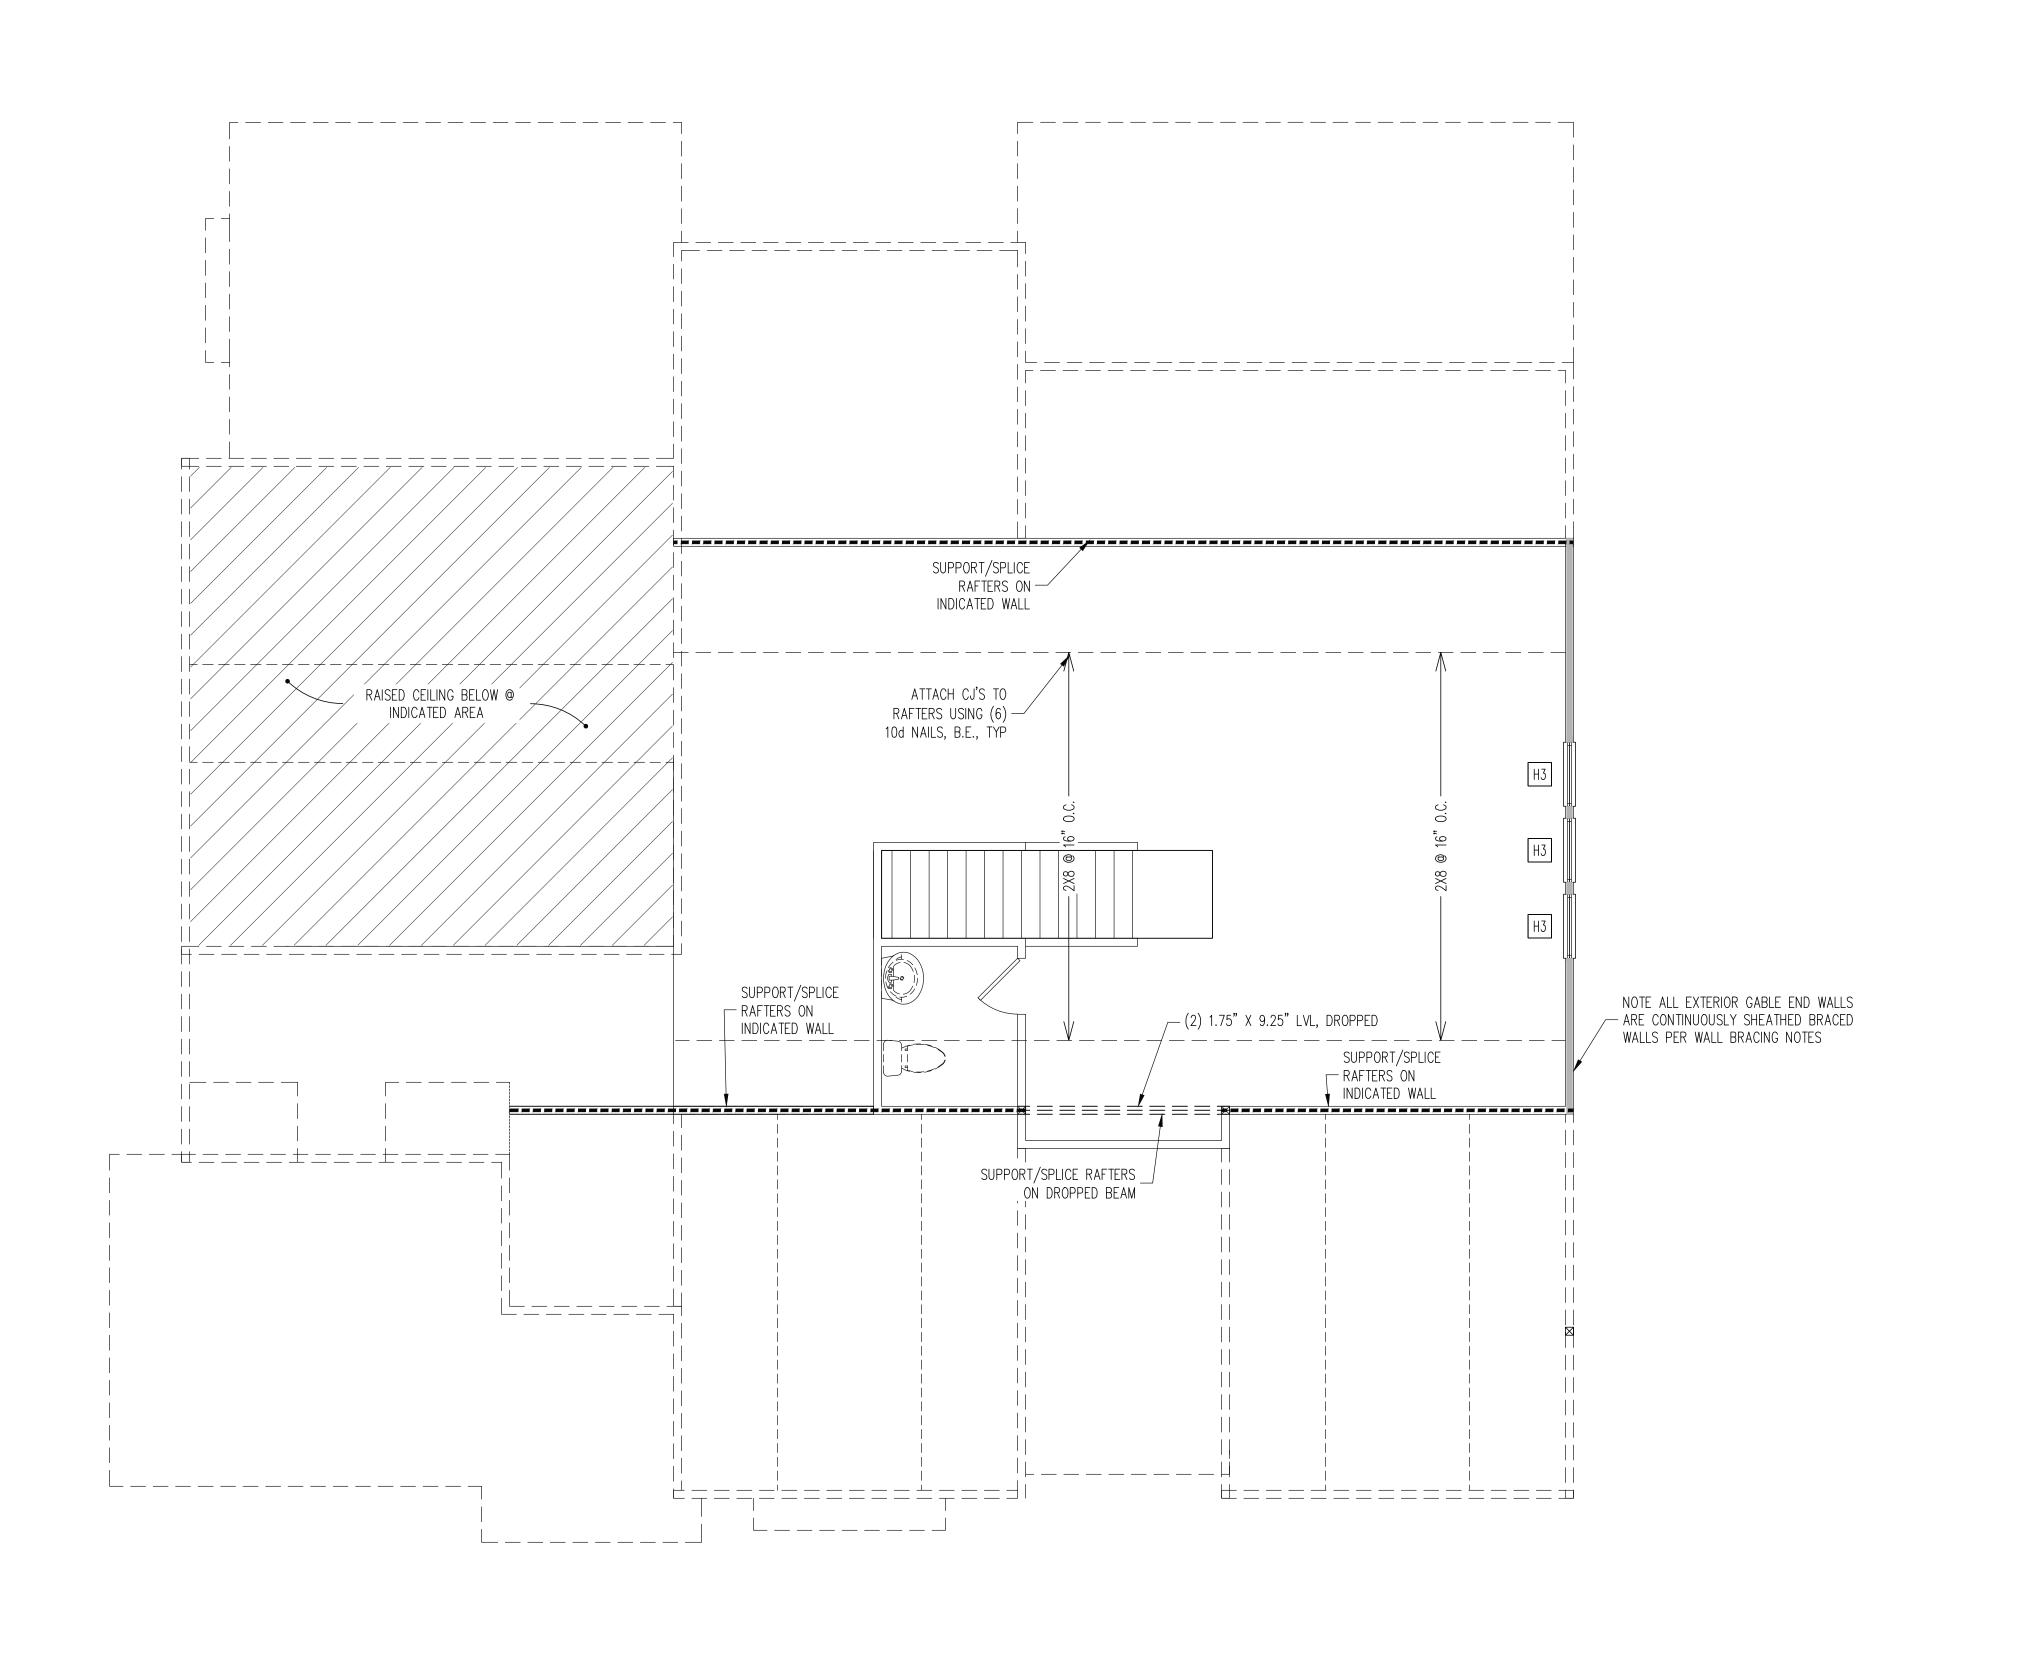
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PLAN NO. M213-21


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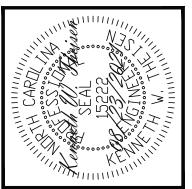
SHEET NO.
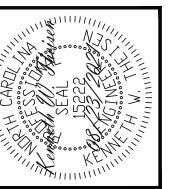
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CONSTRUCTION SPECIFICATIONS

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PART 1.01: <u>CURRENT GOVERNING CODE</u>

PART 14: <u>STUD SUPPORT FOR BEAMS</u>

PART 17: KING STUDS FOR EXTERIOR WALLS

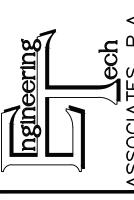SEE DETAIL / CONSTRUCTION SPECIFICATIONS
SHEETS FOR I—JOISTS ALLOWABLE SUBSTITUTIONS

WALL BRACING

SHADED WALLS:

ALL EXTERIOR STUD WALLS, EXTERIOR SIDE, ARE TO BE CONTINUOUSLY SHEATHED WITH 7/16 APA RATED OSB NAILED TO STUDS WITH 8d NAILS @ 6" O.C. AT PANEL EDGES, 12" O.C. IN PANEL FIELD.

NOTES:

PROVIDED CONTINUOUS SHEATHING = 24' MIN.

REFERENCE PART 16.02 OF CONSTRUCTION SPECIFICATIONS FOR GENERAL WIND BRACING INFORMATION.

HEADER SCHEDULE

- | | H1 SINGLE 2X4 TURNED FLAT (A)
- H2 (2) 2X4'S ON SINGLE JACKS (B)
- H3 (2) 2X10'S ON SINGLE JACKS (C)
- H4 (2) 1.75" X 9.25" LVL'S ON DBL JACKS
- H5 (3) 2X10'S ON SINGLE JACKS
- (A) TYPICAL FOR INTERIOR NON LOAD BEARING WALLS ONLY, ROUGH OPENING 38" MAX.
- (B) TYPICAL FOR INTERIOR NON LOAD BEARING WALLS ONLY, ROUGH OPNG 38" TO 74" MAX.
- (C) TYPICAL FOR ALL CONDITIONS NOT LISTED IN (A) OR (B) UNO.

NOTES:

-HEADERS IN NON LOAD BEARING INTERIOR

WALLS ARE NOT LABELED.

WALK-UP ATTIC FRAMING PLAN

WALLS AND CEILING $\frac{1/4" = 1'-0"}{}$

21-21-209 SHEET NO.


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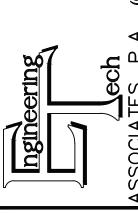
PLAN NO.

M213-21

PROJECT NO.

5 of 8



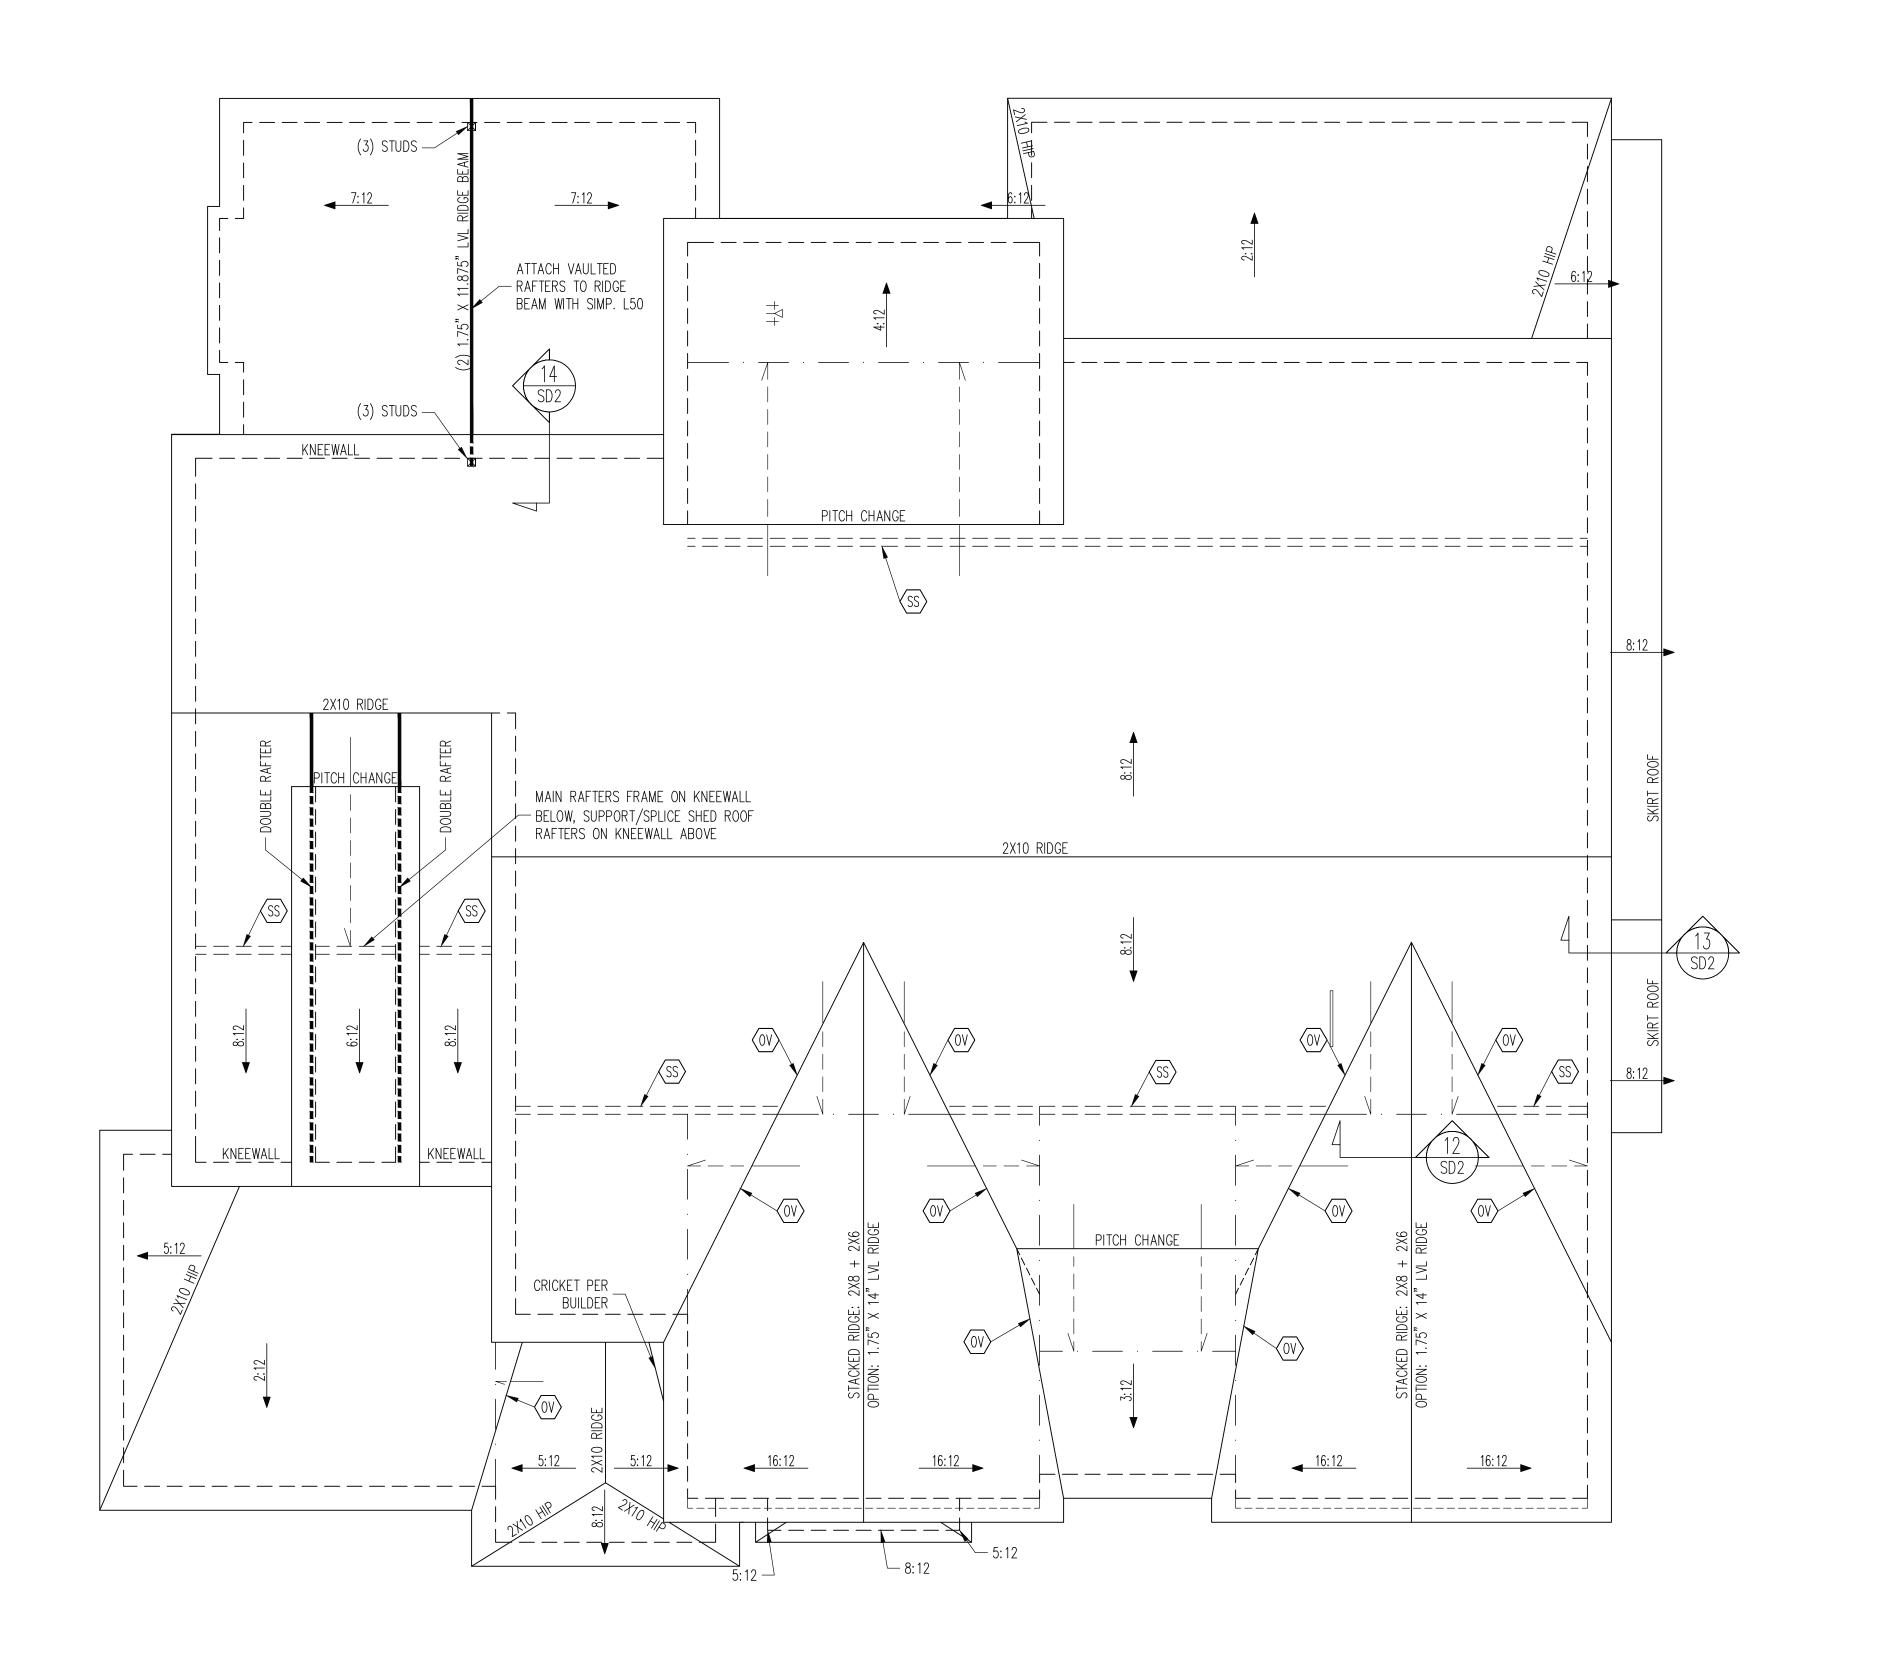



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PLAN NO. M213-21

PROJECT NO. 21-21-209

SHEET NO. **S6** 6 of 8

-COMMON RAFTERS 2X8 @ 16" O.C. TYP U.N.O. -COLLAR TIES 2X4 EVERY 3RD SET OF RAFTERS TYP U.N.O. -ROOF PITCHES 12:12 TYP U.N.O. -VERIFY ROOF PITCHES, OVERHANG LENGTHS, AND KNEEWALL FRAMING HGTS WITH ARCHITECTURAL DRAWINGS, TYPICAL.


FRAMING NOTES

ROOF ONLY

FRAMING SCHEDULE ROOF ONLY

- OV OVERFRAME VALLEY (2X10 SLEEPER) SB SUPPORT/SPLICE RAFTERS ON BEAM BELOW
- SK DBL 2X4 STIFF KNEE
- SS SUPPORT/SPLICE RAFTERS ON KNEEWALL BELOW


ROOF FRAMING PLAN 1/4" = 1'-0"

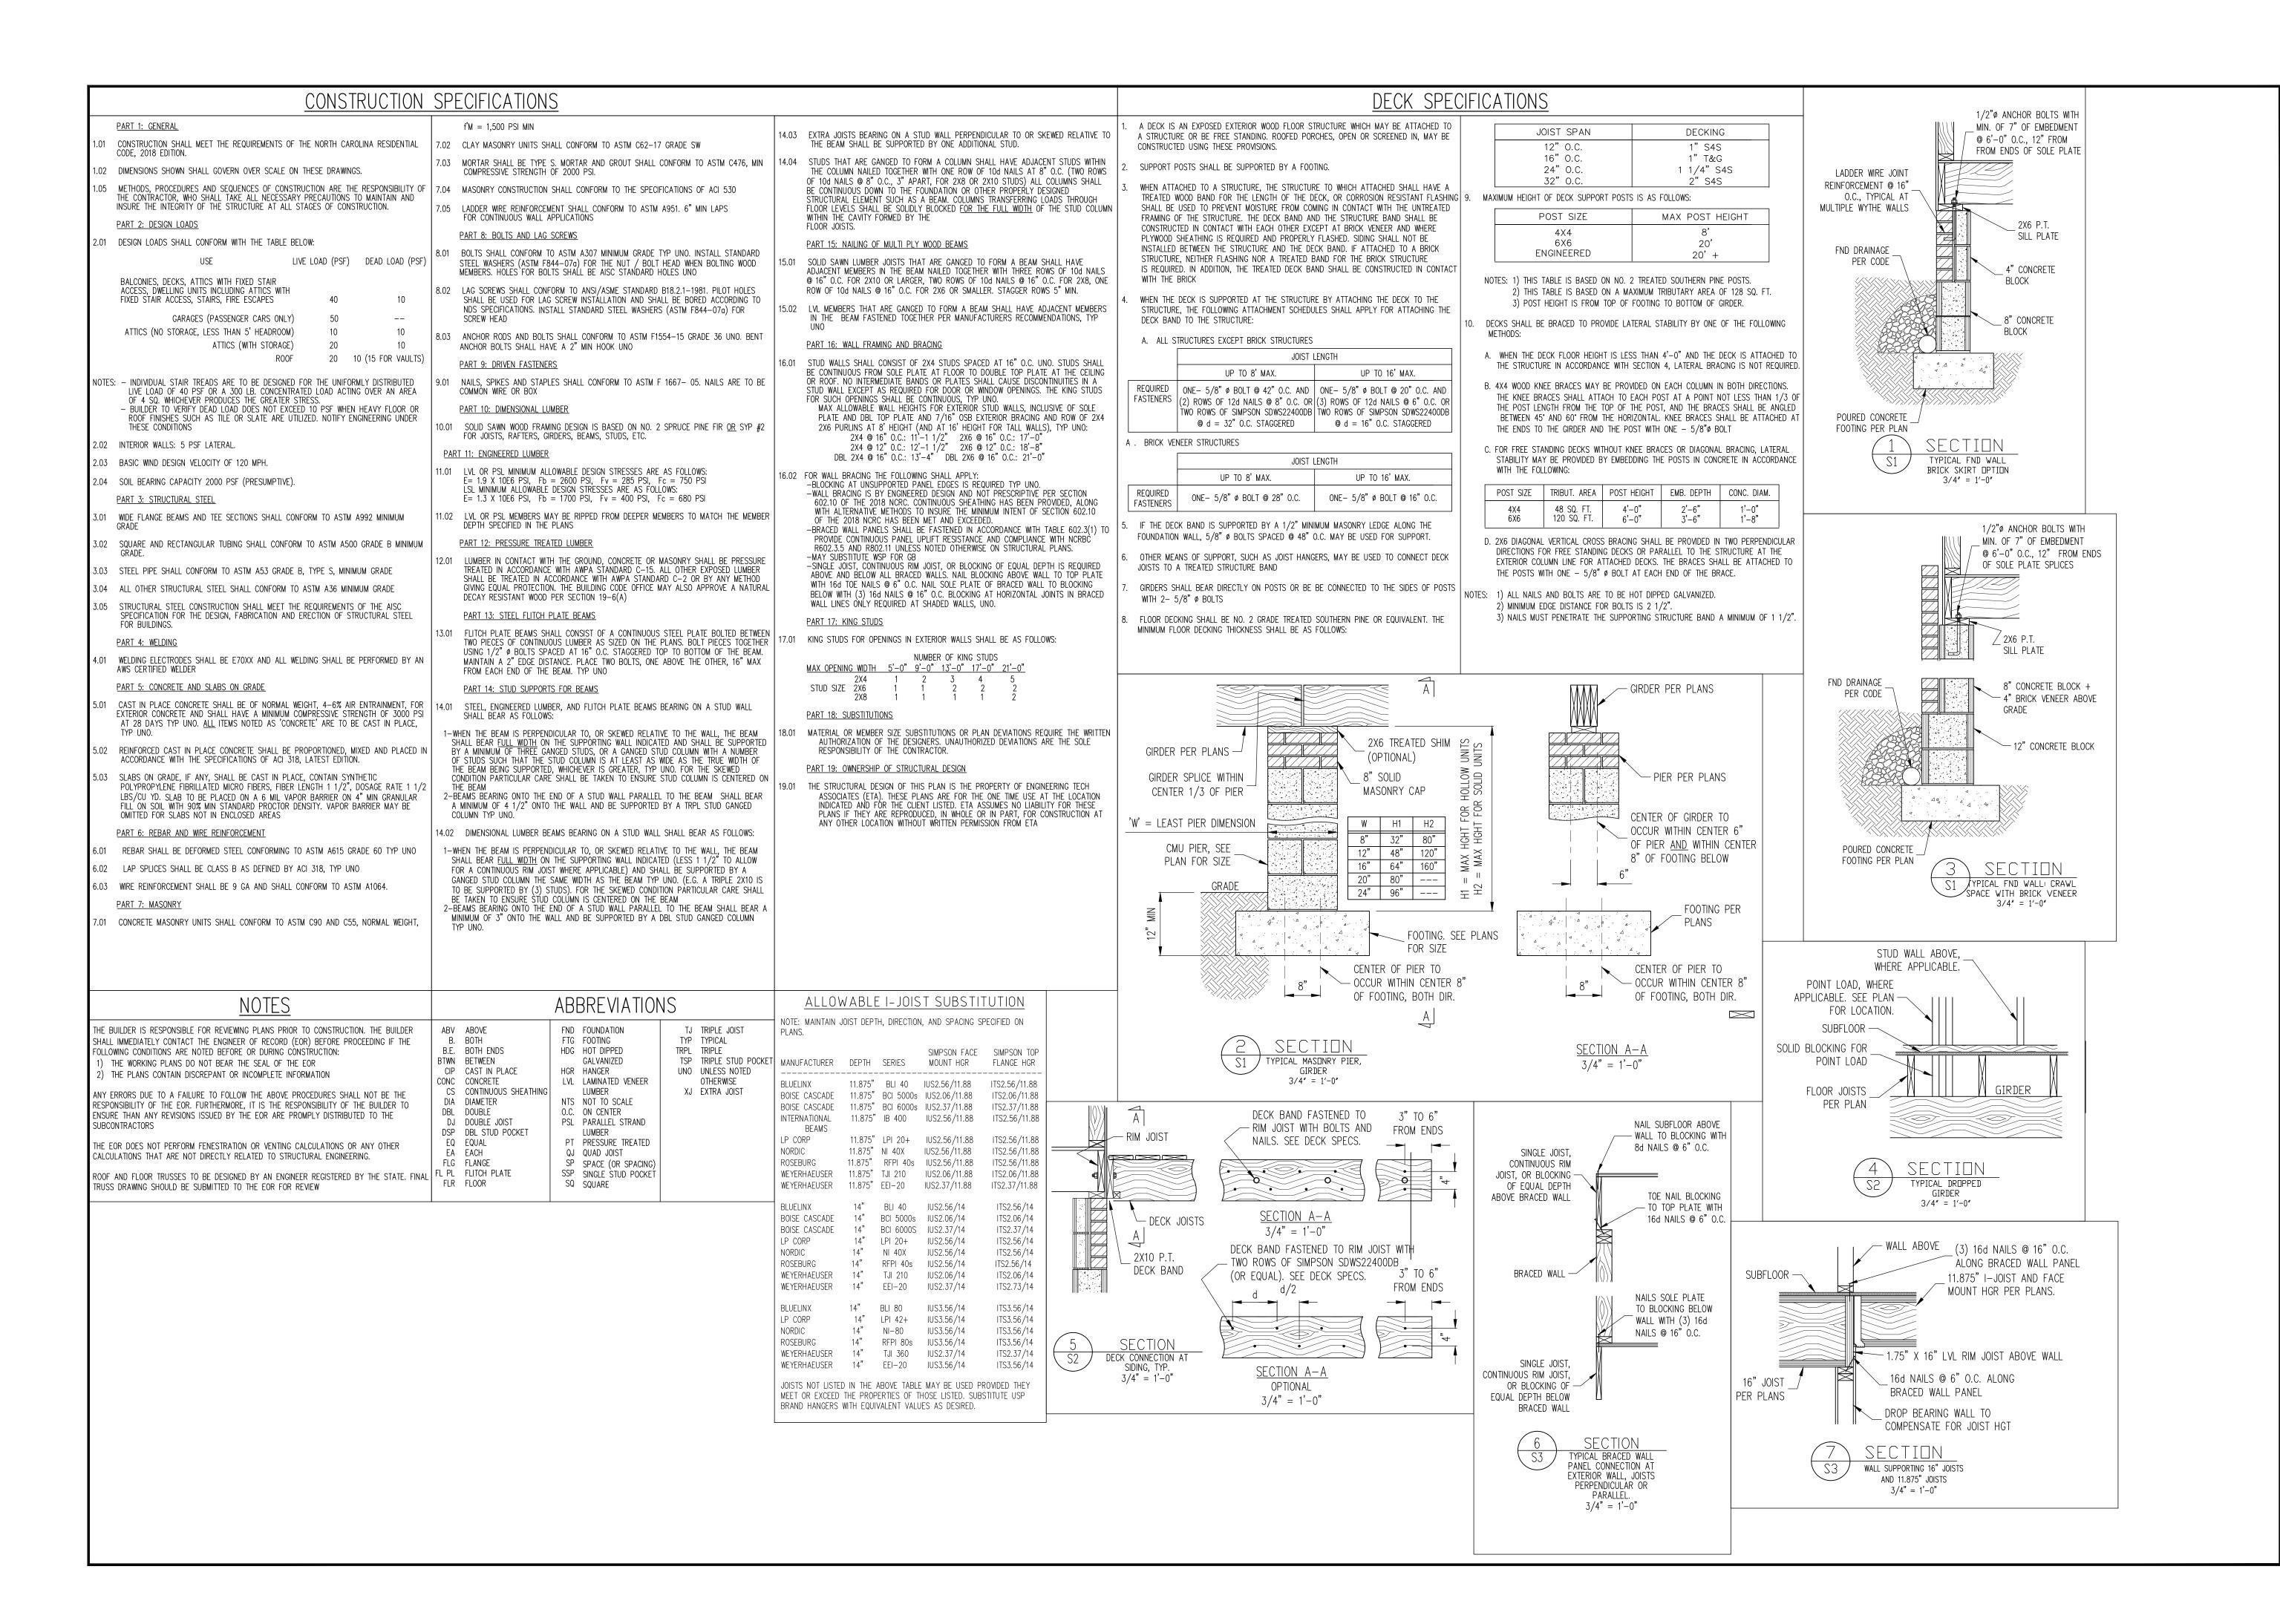

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183
ASSOCIATES, P.A. (919)



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SCOPE STRUCTURAL ADDENEBUM

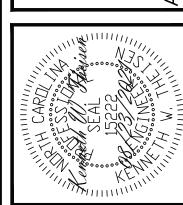LOT #: ENG KWT/TRB


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PLAN NO. M213-21

PROJECT NO. 21-21-209

SD1
7 of 8

SHEET NO.

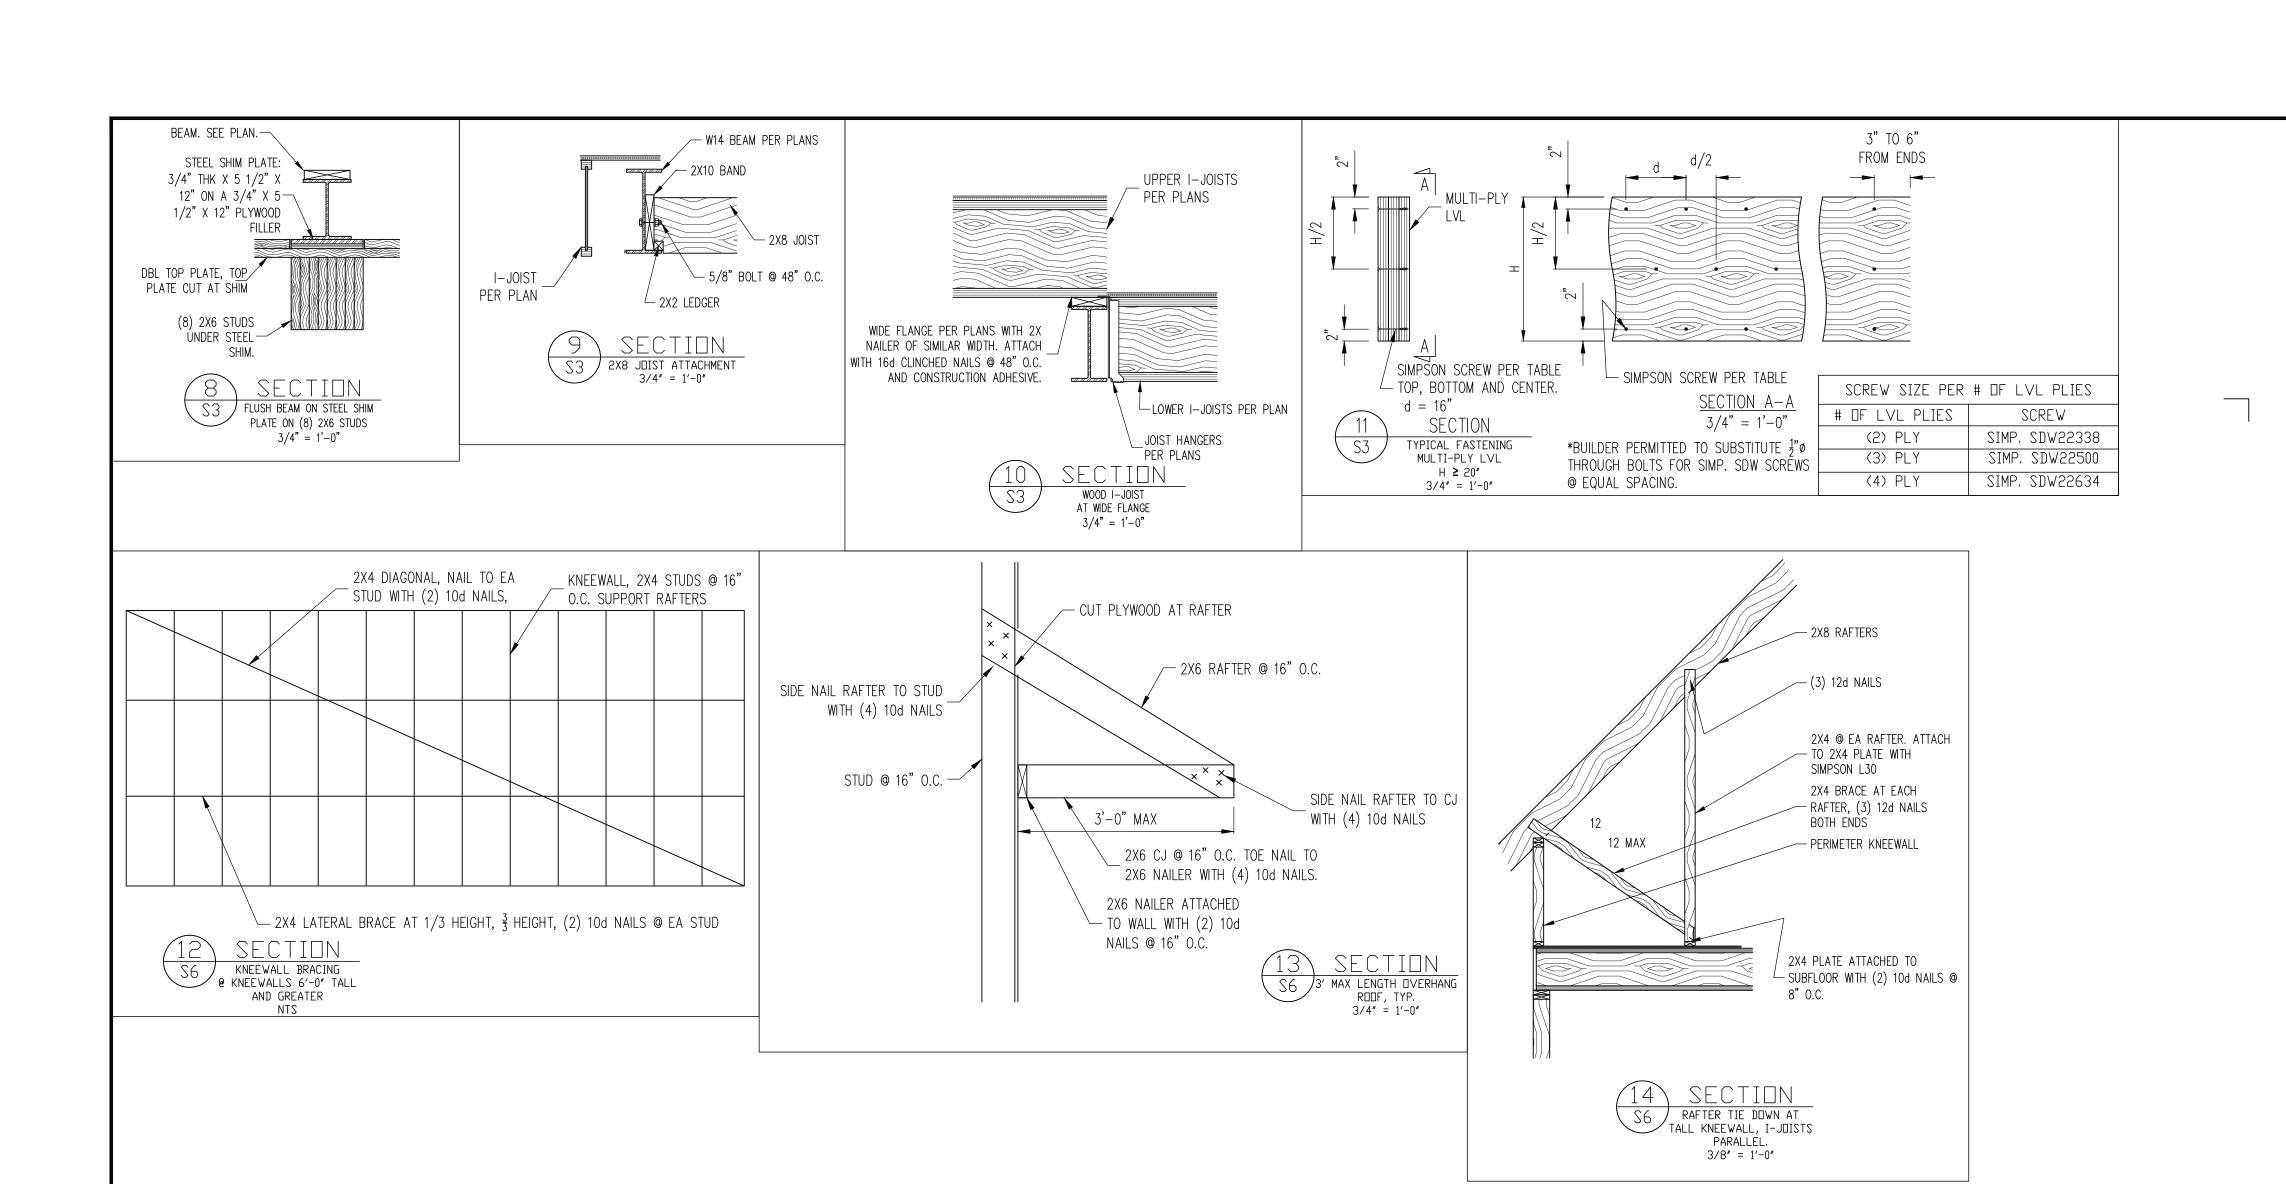

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SCOPE: STRUCTURAL ADDENEBUM
LOT #: ENG KWT/TRB
REV:
DATE 08/23/2021

PLAN NO. M213-21

PROJECT NO. 21-21-209

SD2 8 of 8

SHEET NO.

REQUIREMENT

ITEM

PROJECTION PASSED CHIMNEY

MASONRY OTHER THAN ABOVE

MASONRY SUPPORT (LINTELS):

FOOTING:

MORTAR:

<u>ASH DUMP</u>

CLEARANCES:

WOOD FRAMING

COMBUSTIBLE MATERIAL

ABOVE ROOF

HEARTH EXTENSION:

FIREBOX DEPTH:

FLUE REQUIREMENTS:

WALLS AROUND FLUE

DISTANCES BETWEEN

ADJACENT FLUES

TYPE OF MORTAR

EFFECTIVE FLUE AREA

(SEE TABLES 16A & 16B)

THICKNESS

SLOPE

F/P PENING (6 SQ. FT.

F/P OPENING 6 SQ. FT. OR)

THICKNESS OF FIREBOX WALLS:

THICKNESS

FIREBRICK

FLUE LINING

LETTER

12" MINIMUM

A 12" MINIMUM ALL SIDES

REFRACTORY

TYPE M, S OR N

TYPE M, S, N OR REFRACTORY

MASONRY, CONCRETE OR STEEL

I" CHIMNEY MASONRY (EXCEPTION:

D 4" AT BACK OF FIREPLACE MASONRY

NOT REQUIRED, HOWEVER, WHEN USED MUST

BE FIREPROOF AND MINIMUM 5" DIAMETER

MASONRY CHIMNEYS COMPLETELY ON THE

SHEATHING ARE NOT REQUIRED TO COMPLY

2" FIREPLACE MASONRY EXCLUDING FACING

6" FROM EDGES OF FIREPLACE OPENING

FROM THE FACE OF THE FIREPLACE SHALL

BE A MINIMUM OF 12" ABOVE FIREPLACE

2' ABOVE HIGHEST POINT OR 2' HIGHER

8" EACH SIDE OF OPENING, 16" IN FRONT

12" EACH SIDE OF OPENING, 20" IN FRONT

BACK & SIDE WALLS 6" SOLID MASONRY

THICKNESS FIREBRICK OR REFRACTORY

FLUE SHALL BE ENCASED IN NOT LESS

MORE THAN 2 FLUES IN SAME CHIMNEY

NO MORE THAN TWO FLUES ADJOIN

WITHOUT A WYTHE SEPARATION

ON THE INSIDE

WITH MITERED JOINTS

REQUIRE 4" WYTHE SEPARATION SO THAT

TYPE M, S, N OR REFRACTORY MORTAR

WITH CLOSE FITTING JOINTS LEFT SMOOTH

5/8" MINIMUM WITH VARIATION OF 1/8" IN WALLS

RECTANGULAR 1/10 OF FIREPLACE OPENING,

ROUND 1/12 OF FIREPLACE OPENING

MAXIMUM 30 DEGREES FROM VERTICAL

TWO FLUES ADJOINING EACH OTHER SHALL

OR REINFORCED CONCRETE WITH MINIMUM 2"

MATERIAL (EXCEPTION: 12" SOLID MASONRY

THAN ANY PORTION OF BUILDING WITHIN 10'

EXCEPT MATERIAL ABOVE FIREPLACE

OPENING PROJECTING MORE THAN 11/2"

EXTERIOR OF A BUILDING AGAINST THE

 $(3\frac{1}{2}" \times 3\frac{1}{2}" \times 5/16" \text{ MIN.})$

WITH THESE PROVISIONS.)

MATERIAL

OPENING

OF FACING MATERIAL


OF FACING MATERIAL

WALLS REQUIRE NO LINING)

H | 16" FROM FACE OF FIREPLACE

THAN 4" OF SOLID MASONRY.

HAVE JOINTS STAGGERED 7'

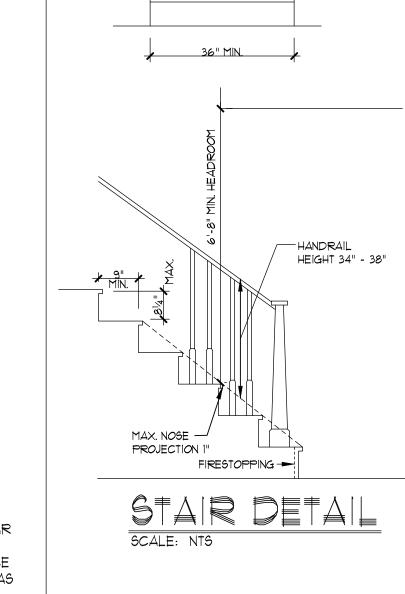

- SIZE LARGER THAN RAFTER

R-38 INSULATION

CLG. JOISTX

FL. JOIST

FL. JOIST

WIDTH OF WALL ABOVE

1ST FLOOR HYAC

IN CRAWL SPACE

(MIN. 22" CLEARANCE)

TREATED SILL

CORBEL BRICK TO

8" SOLID CAP-

1×4 PINE

1x10 SPRUCE+

ASSEMBLY -

2X4 COLLAR BEAM

R-20 INSULATION-

GIRDER

— 16" × 16" BLOCK

 \longrightarrow 32" \times 32" \times 10" FOOTING

ASSEMBLY

2ND FLOOR

CLG. JOIST

-1×10 SPRUCE

FL. JOIST

FL. JOIST

75%-80%

3" MIN. PROJECTION

MAX. - THICKNESS OF

FOOTING

/ TREATED SILL ▼ 8" SOLID CAP FOR 2 STORY


COVERED WITH 6 MILL. POLY

CRAWL SPACE TO BE

4" SOLID CAP FOR I STORY +

HYAC IN ATTIC

2'-8" MIN.

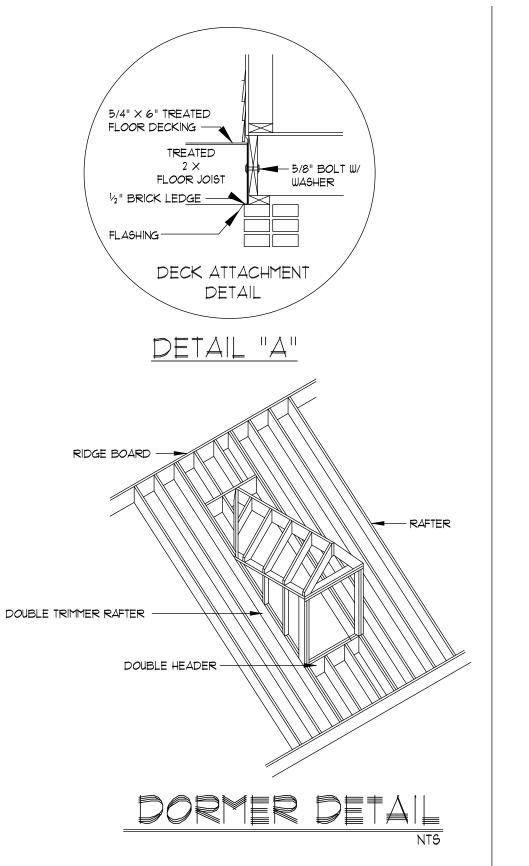

INSULATION BAFFLE

2×4 RAFTER TIE

--- 12" SQ. EDGE SIDING

- 2" CONT. YENT STRIP

-1x6 SPRUCE

R-16 INSULATION

-1/2" PLYWOOD SUBFLOOR

- 2 \times BAND

WEEP HOLES 48" O.C.

FOOTING PER

+ STRUCTURALS

-30# FELT OR FLASHING

UP 6" BEHIND SHEATHING

- FINISH FLOOR

BRICK SECTION

ASSEMBLY

__314" CROWN

- 1/2" SHEATHING


BRICK VENEER WITH

- I" AIR SPACE

- 2×4 STUDS

IX8 FASCIA

WHEN REQUIRED

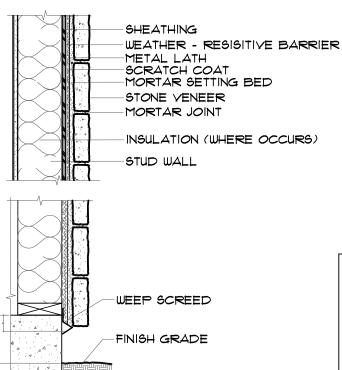

BUILDING CODES THIS PLAN HAS BEEN DESIGNED UNDER THE NO BUILDING CODES, 2018 RESIDENTIAL EDITION. ICE GUARDS ICE GUARD & WATER SHIELD REQUIRED ON ALL ROOF SLOPES 4:12 & LESS PER NCRBC

ELEVATION NOTES

WEEP SCREEP DETAIL SCALE: NTS

THE NET FREE AREA OF SQUARE OR RECTANGULAR FLUES AS LISTED IN TABLE 16A SHALL NOT BE LESS THAN 1/10 THE FACE AREA OF THE FIREPLACE

OPENING. THE NET FREE AREA OF ROUND FLUES AS LISTED IN TABLE 16B SHALL NOT BE LESS THAN 1/12 THE FACE AREA OF THE FIREPLACE OPENING. THE COMBINED AREAS OF ALL FACES SHALL BE

2×4 RAFTER TIE

12" SQ. EDGE SIDING -

2" CONT. VENT STRIP -

IX8 FASCIA -

31/4" CROWN _

SIDING-

1/2" SHEATHING -

1/2" PLYWOOD SUBFLOOR-

2×4 STUDS — @ 16" O.C.

FINISH FLOOR

2 × BAND-

FINISH GRADE

DETAIL "A"

FOOTING PER

STRUCTURALS

SIDING SECTION

ATTIC SPACES SHALL BE PROVIDED WITH AN INTERIOR ACCESS OPENING NOT LESS THAN 21" X 30". ACCESS OPENING SHALL BE READILY ACCESSIBLE AND PROVIDED WITH A LID OR DEVICE THAT MAY BE EASILY REMOVED OR OPERATED. WHEN MECHANICAL EQUIPMENT IS TO BE INSTALLED IN THE ATTIC, AND ONLY INTERIOR ACCESS IS TO BE PROVIDED, THE ACCESS OPENING SHALL BE NOT LESS THAN SPECIFIED ABOVE, BUT IN NO CASE LESS THAN THE SIZE REQUIRED TO INSTALL OR REMOVE THE LARGEST MAJOR COMPONENT OF THE UNIT WITHOUT

EXCEPTION: CONCEALED AREAS NOT LOCATED OVER THE MAIN STRUCTURE INCLUDING PORCHES, KNEEWALLS LESS THAN 5' IN HEIGHT, DORMERS, BAY WINDOWS, ETC. ARE NOT REQUIRED TO HAVE ACCESS.

CRAWL SPACE ACCESS - MINIMUM SIZE IS 36" X 22"

SAFETY GLAZING:

ALL SAFETY GLAZING MATERIALS MUST BE PERMANENTLY LABLELED TO INDICATE IT CONFORMS TO ANSI Z97.1. LAMINATED GLASS MAY BE PERMANENTLY LABELED OR ACCOMPANIED BY A CERTIFICATE CERTIFYING CONFORMANCE TO ANSI Z97.1.

SAFETY GLAZING MATERIAL MUST BE USED FOR THE FOLLOWING SPECIFIED HAZARDOUS LOCATIONS:

- 1. ALL BATHTUB DOORS AND ENCLOSURES
- 2. ALL SHOWER DOORS AND ENCLOSURES 3. ALL STORM DOORS OR COMBINATION DOORS
- 4. ALL SLIDING GLASS DOORS (PATIO TYPE)
- 5, ALL SWINGING EXIT AND ENTRANCE DOORS BOTH FRAMED AND UNFRAMED
- 6. ALL GLAZING IN FIXED PANELS HAVING A GLAZED AREA IN EXCESS OF 9 SQ. FT. WITH LOWEST EDGE LESS THAN 18" ABOVE THE FINISHED FLOOR LEVEL, SIDEWALKS, PATIOS OR DESIGNED WALKING SURFACE ON EITHER SIDE WITHIN 36" OF SUCH GLAZING (INCLUDES GLAZED PANELS IN MULTI-STORY STRUCTURES).

CRICKETS AND SADDLES:

CRICKETS OR CHIMNEY SADDLES SHALL BE INSTALLED ON THE UPPER SIDE OF ALL CHIMNEYS GREATER THAN 30" WIDE WHICH RUN PARALLEL TO BUT DO NOT INTERSECT THE RIDGEL THEY SHALL BE COVERED AND FLASHED SO AS NOT TO LEAK.

STAIR WIDTH:

INTERIOR 2'-8" CLEAR OF HANDRAIL EXTERIOR 3'-O" MINIMUM WIDTH

HANDRAIL AND GUARDRAIL:

HEIGHT FOR STEPS 30" MINIMUM HEIGHT FORALL OTHER RAILS 36" MINIMUM

NOTE: EVERY PORCH, DECK, TERRACE, RAISED PORCH SURFACE OR ENTRANCE PLATFORM WITH A HEIGHT ABOVE FINISHED GRADE OR SURFACE OF 2'-6" TO 6'-0" SHALL HAVE GUARDRAILS WITH INTERMEDIATE RAILS OR ORNAMENTAL PATTERNS SUCH THAT AN 18" SPHERE CANNOTPASS THROUGH ANY OPENINGS. WHEN THE PORCH, DECK, TERRACE, RAISED PORCH SURFACE JOR ENTRANCE PLATFORM IS AT A HEIGHT GREATER THAN 6'-0" ABOVE FINISHED GRADE OR SURFACE, THE GUARDRAILS SHALL HAVE INTERMEDIATE RAILS OR ORNAMENTAL PATTERNS SUCH THAT A 6" SPHERE CANNOT PASS THROUGH ANY OPENING. THE HEIGHT OF THE GUARDRAIL SHALL BE A MINIMUM OF 36".

FOOTINGS: SEE FOUNDATION PLAN ENGINEERED FOOTING

MAXIMUM UNSUPPORTED PIER HEIGHHT:

HOLLOW MASONRY SOLID MASONRY 8" X 16"

CRAWL SPACE DEBRIS:

16" × 16"

CRAWL SPACE GROUND SHALL BE FREE OF ALL DEBRIS SOD, TREE STUMPS AND OTHER ORGANIC MATERIAL AND PROVIDE A SMOOTH SURFACE FREE OF POCKETS. WHERE SOIL CONDITIONS EXIST WHICH IMPEDE WATER ABSORPTION OR NATURAL DRAINAGE, A POSITIVE DRAIN SHALL BE PROVIDED.

MINIMUM SHELF ANGLE 6" X 4" 5/16" WITH LONGER LEG VERTICAL

ALLOWABLE SPANS FOR LINTELS SUPPORTING MASONRY VENNER:

SIZE OF ANGLES (1,3) MAXIMUM SPAN (2,4) $3\frac{1}{2}$ " $\times 3\frac{1}{2}$ " $\times \frac{1}{4}$ " 6'-0" 5" × 3½" × 5/16" 10'-0"

FOOTNOTES:

- (1) LONG LEG OF THE ANGLE SHALL BE PLACED IN A VERTICAL
- (2) SPANS OVER 4' SHALL BE SHORED UP UNTIL CURED. (3) STEEL MEMBERS INDICATED ARE ADEQUATE TYPICAL EXAMPLES:
- OTHER STEEL MEMBERS, INCLUDING LIGHT GUAGE STEEL, MEETING STRUCTURAL DESIGN REQUIREMENTS MAY BE USED. (4) SPANS OVER 10'-0" SHALL BE DESIGNED BY A PROFESSIONAL ENGINEER.

MAXIMUM PROJECTION FOR FLOOR JOIST 15" EXCEPT WHERE STRUCTURAL SYSTEM SUPPORTS ONLY THE FLOOR & ROOF LOAD OF BAY WINDOW (SEE SKETCH APPENDIX "C" VOL. IB N.C. UNIFORM RESIDENTIAL BUILDING CODE) OR WHEN DESIGNED BY PROFESSIONAL.

COLLAR BEAM (2" X 4" MIN.) SHALL BE INSTALLED ON AT LEAST EACH THIRD PAIR OF RAFTERS AND SHALL BE DOUBLE NAILED.

MASONRY VENEER SHALL NOT EXCEED 35' IN HEIGHT ABOVE FOUNDATION AND SHALL BE ANCHORED BY CORROSION RESISTANT METAL TIES SPACED NO MORE THAN 16" VERTICALLY AND 32" HORIZONTALLY.

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DETAIL SHEET

REVISIONS	
UMBER	DATE
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