

DESIGN

PROJECT:

LOT 1 MORGAN **FARM**

STEPHENSON BUILDERS

1187 NORTH RALEIGH STREET ANGIER, NC 27501

BCR


DATE:

08-23-22

REVISIONS:


SHEET NO.

PLANS DESIGNED UNDER 2018 NORTH CAROLINA RESIDENTIAL CODE.
SEE ROOF PLAN FOR KNEEWALL HEIGHTS AND LOCATIONS.

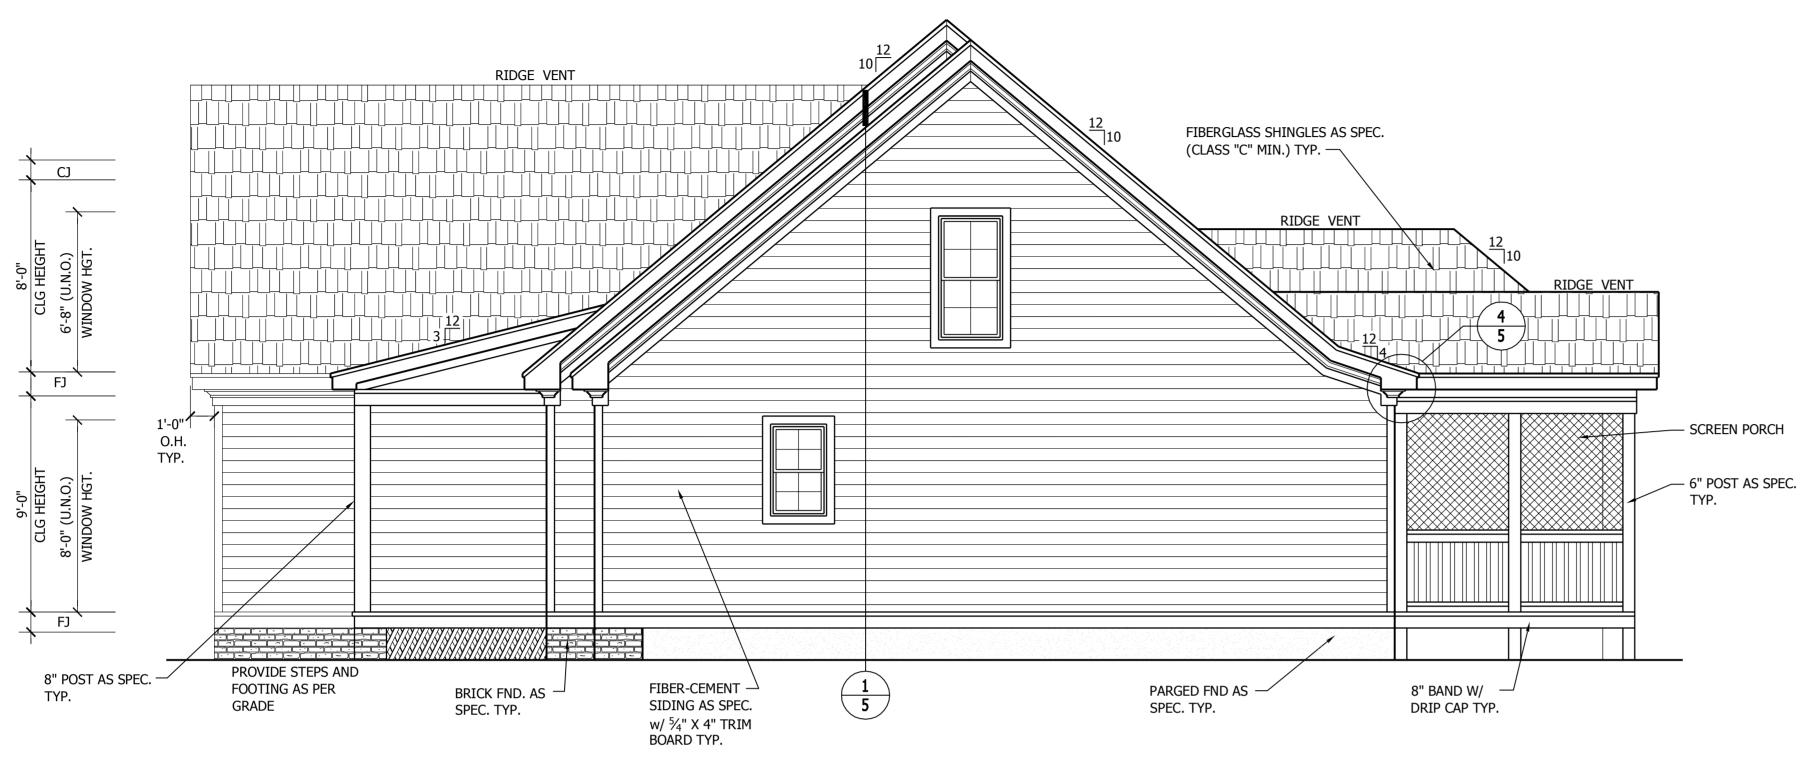

RIGHT-SIDE ELEVATION

SCALE: 1/4"=1'-0"

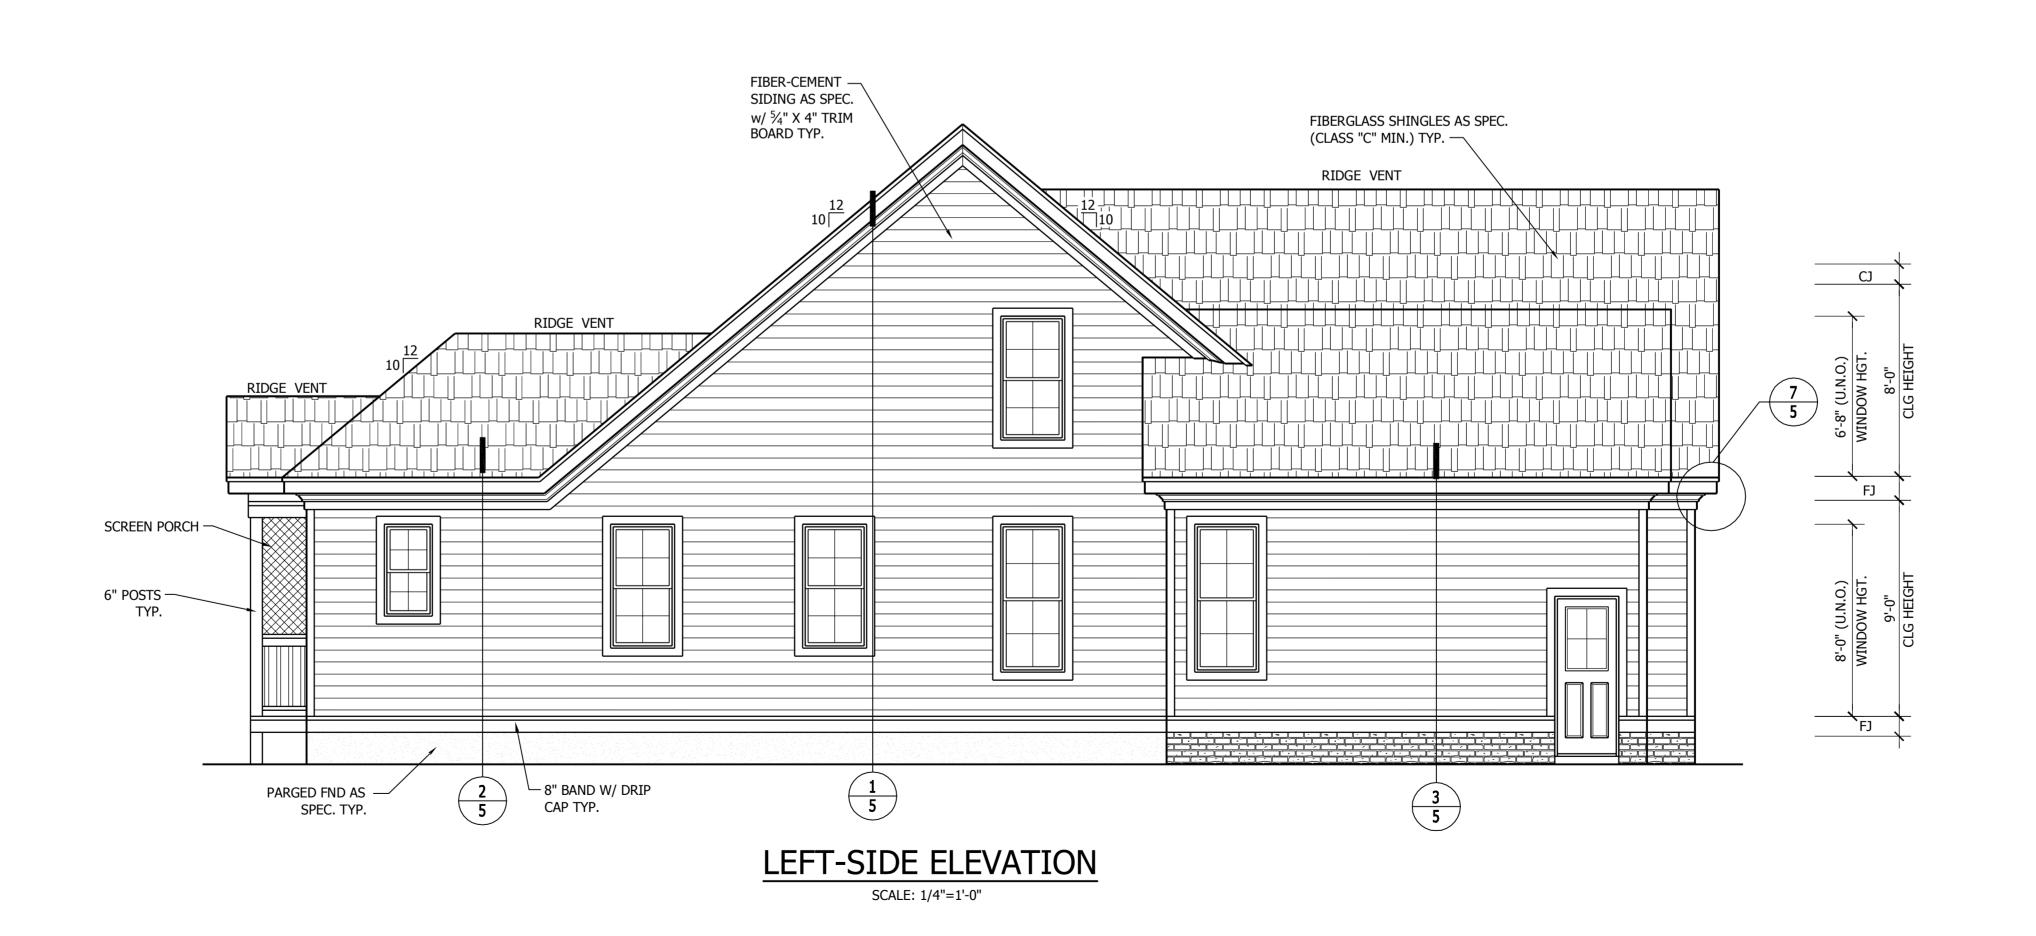

TIVE RESIDENTIA DESIGNS, LLC

DESIGNS, LL 5000 NEIMAN COV RALEIGH, N.C. 27612

PROJECT:

LOT 1 MORGAN FARM

STEPHENSON BUILDERS INC.

1187 NORTH RALEIGH STREET ANGIER, NC 27501

BCR

DATE:

08-23-22


REVISIONS:


SHEET NO.

2

4

AREA CALCULATIONS HEATED (SQ. FT.) N/A N/A STORAGE: 1131 BRICK: OVERALL DIMENSION 2844 TOTAL: (UNHEATED) 1363 WIDTH: 83'-4" DEPTH: 57'-10"

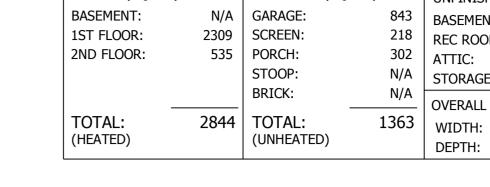

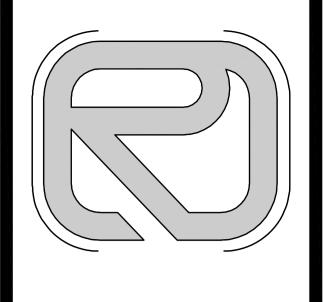

PROJECT:

LOT 1 MORGAN **FARM**

BUILDER

7 NORTH RALEIGH S ANGIER, NC 2750


BCR

DATE:

08-23-22

REVISIONS:

SHEET NO.

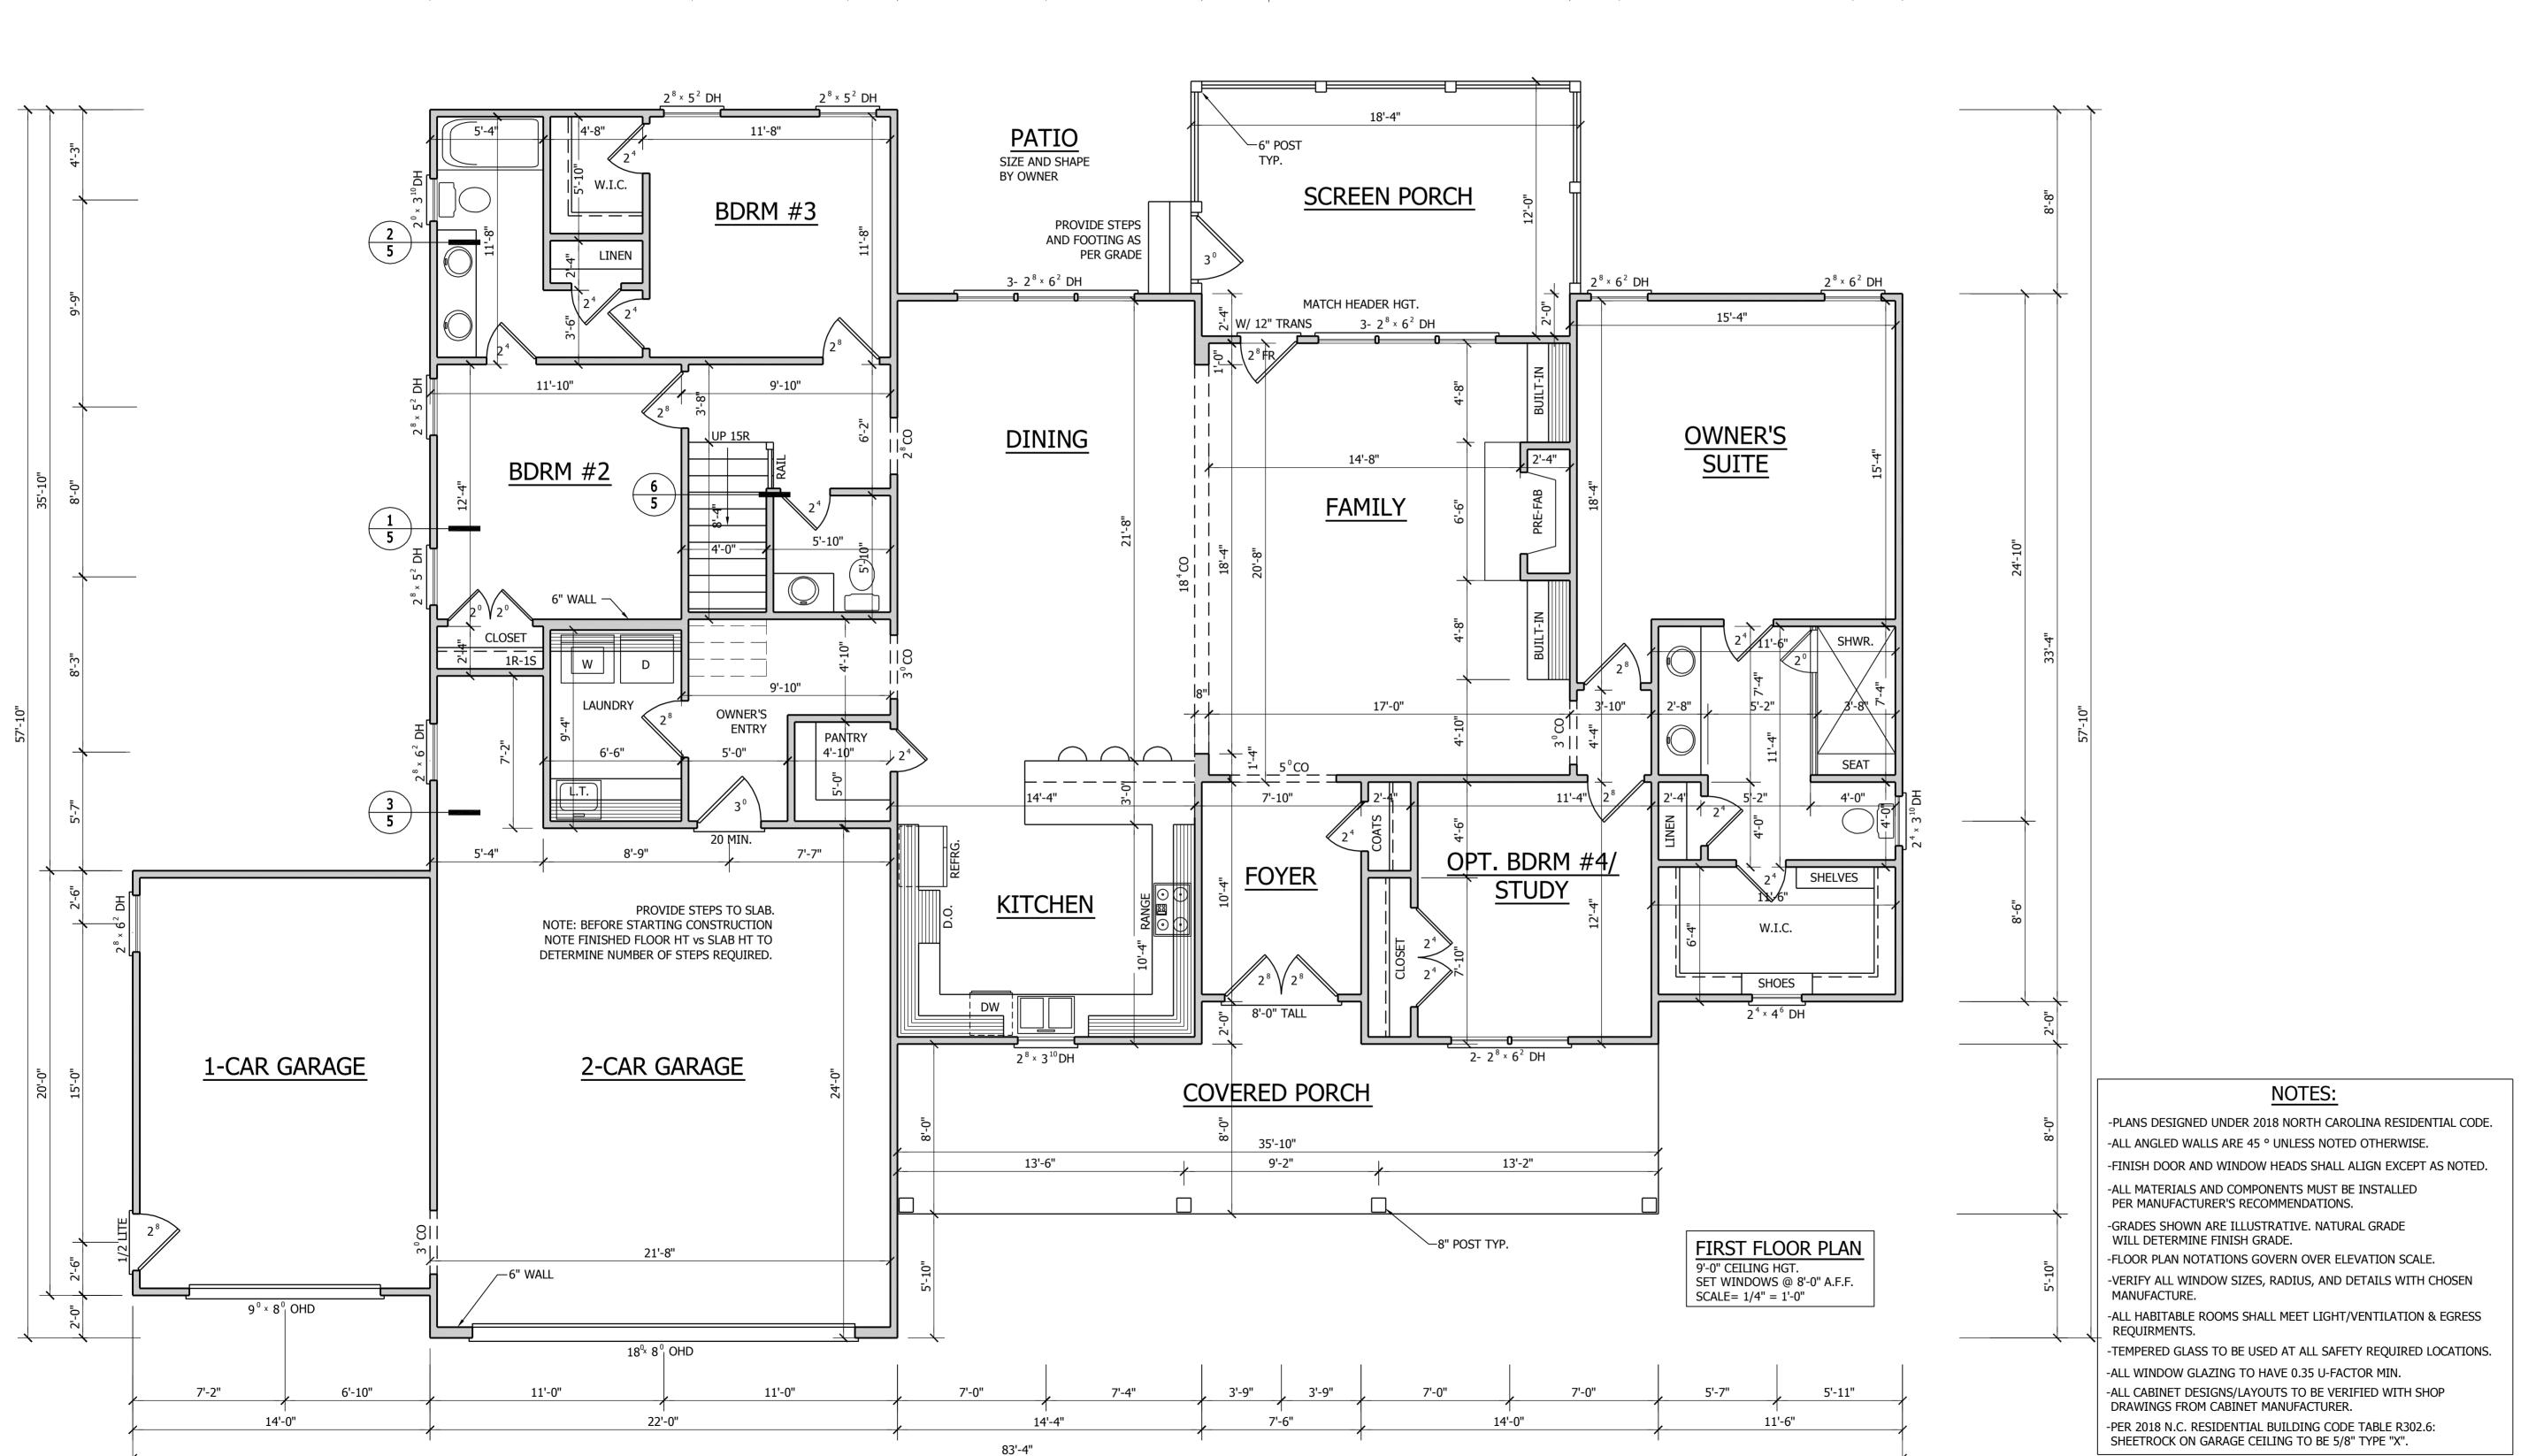

17'-4"

7'-8"

15'-8"

11'-0"

83'-4"

7'-0"

14'-4"


7'-4"

22'-0"

7'-4"

12'-4"

14'-0"

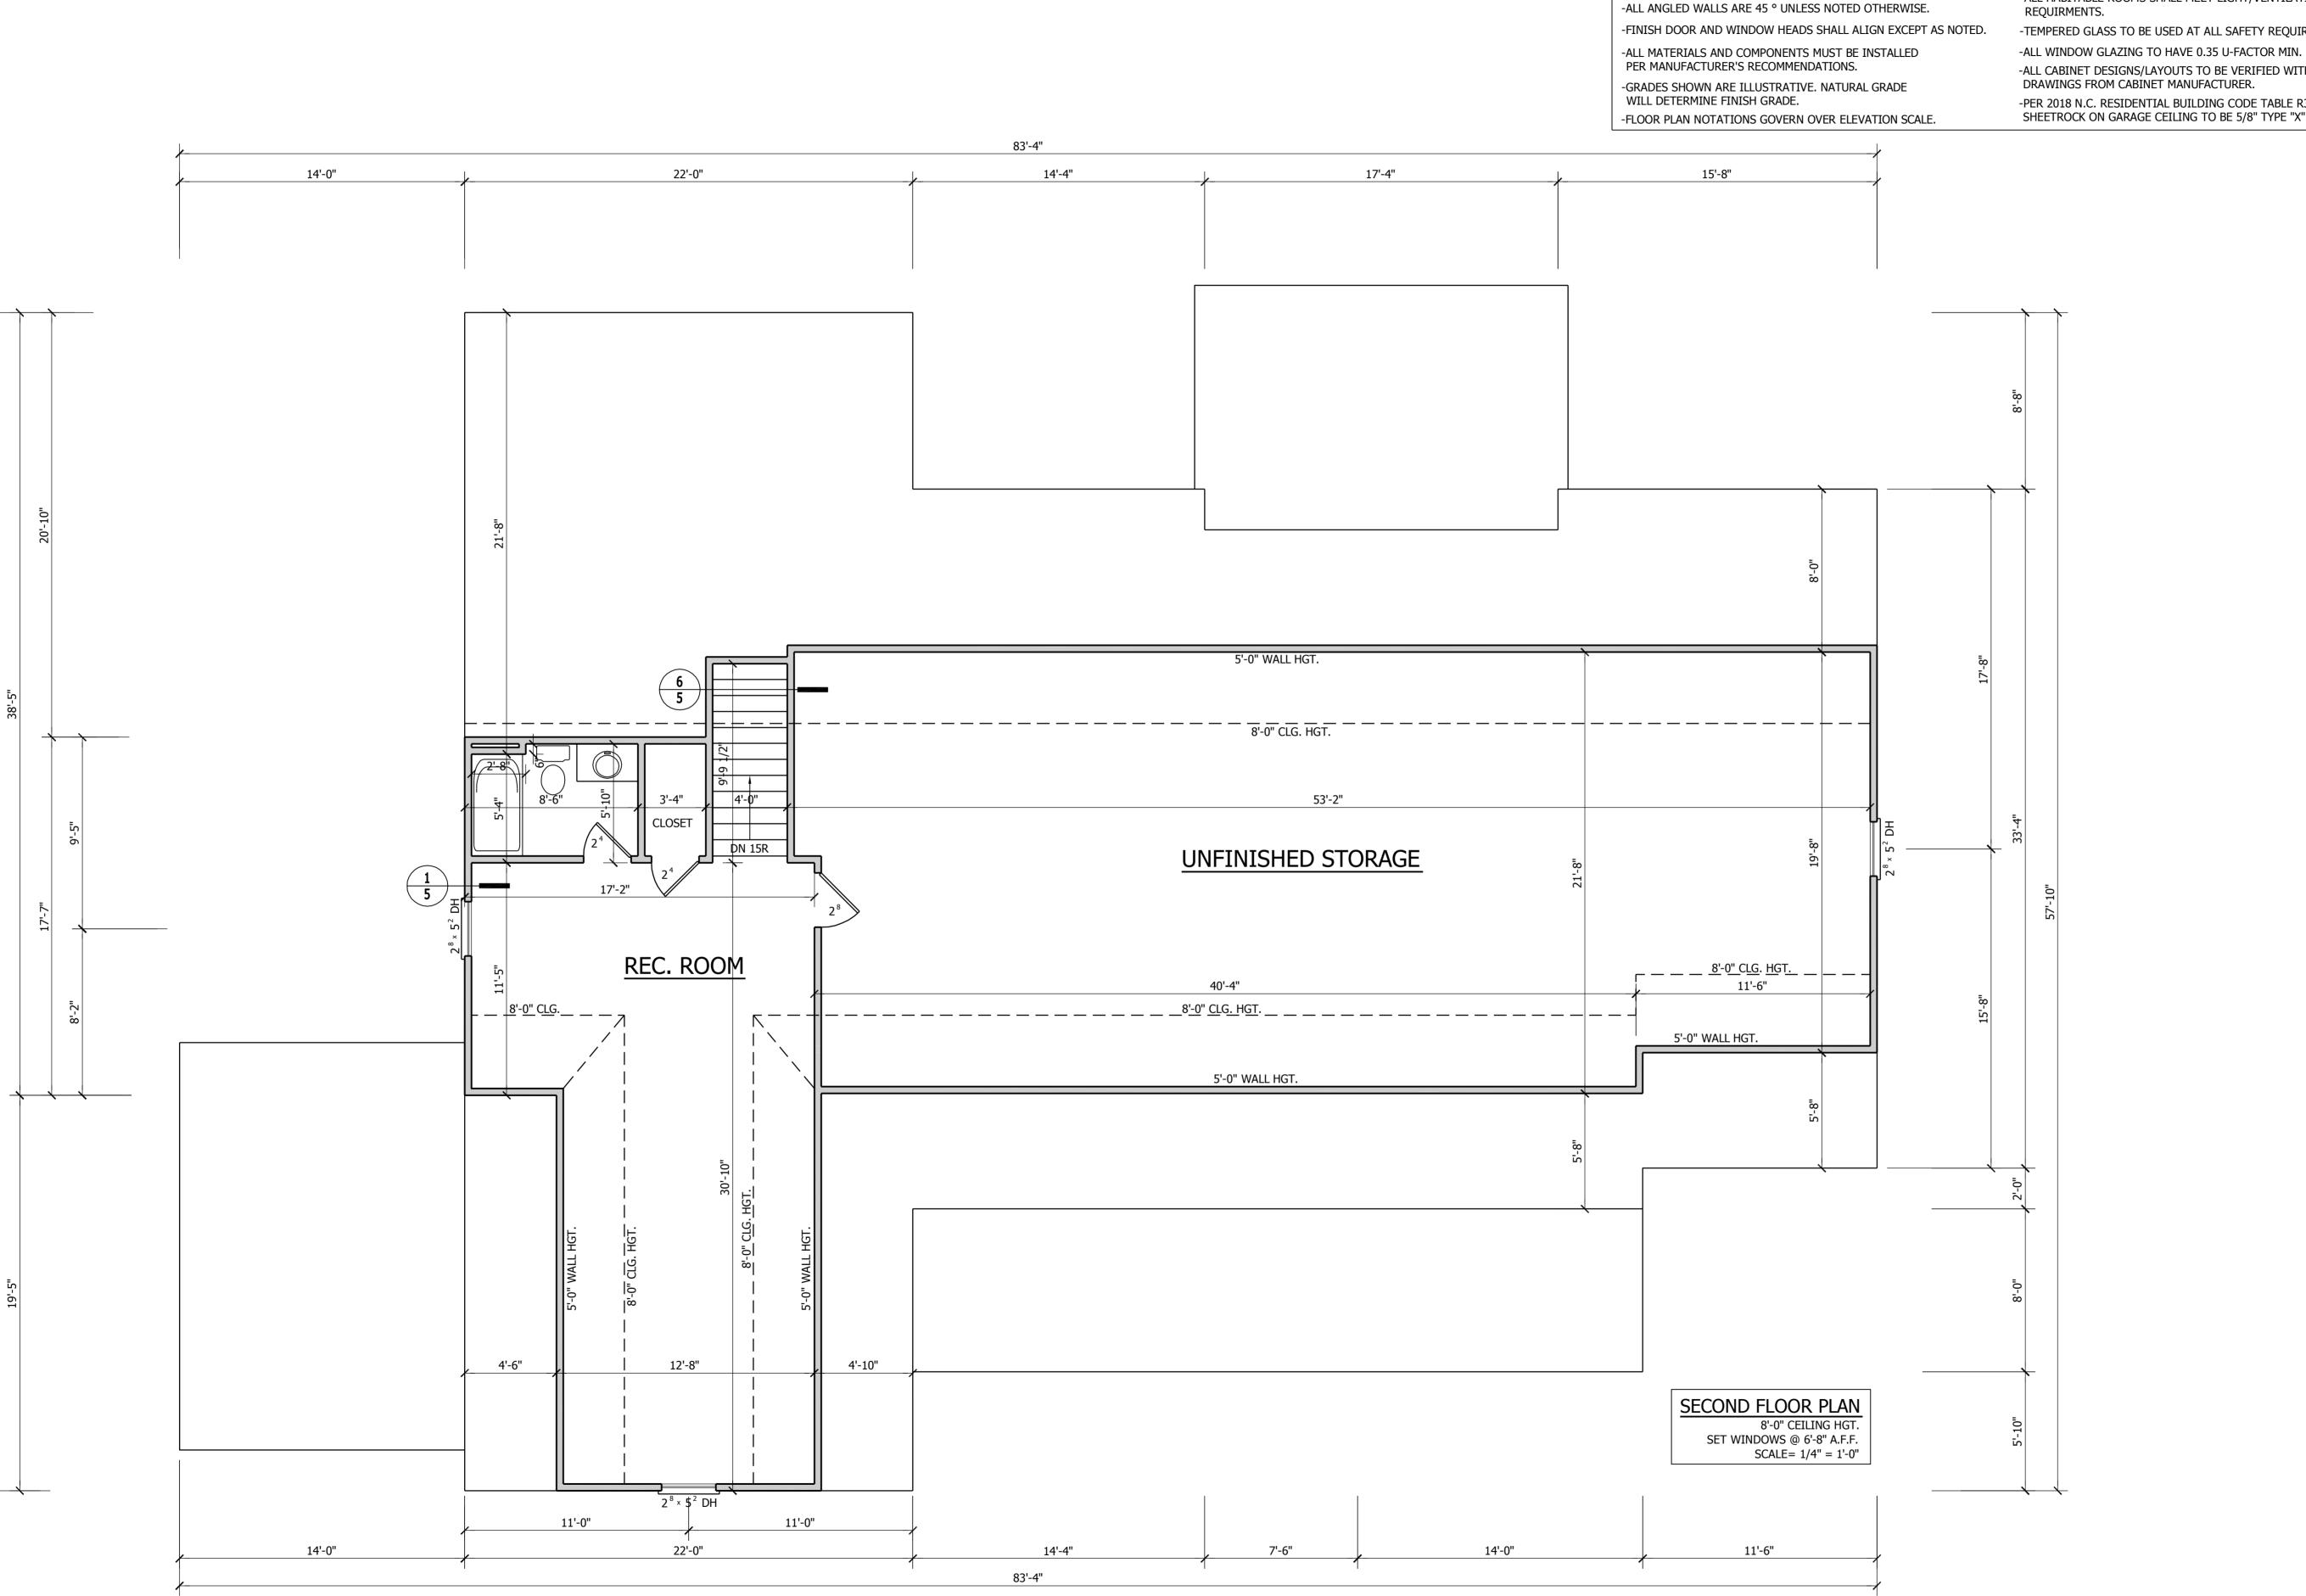

-VERIFY ALL WINDOW SIZES, RADIUS, AND DETAILS WITH CHOSEN MANUFACTURE.

NOTES:

-PLANS DESIGNED UNDER 2018 NORTH CAROLINA RESIDENTIAL CODE.

-ALL HABITABLE ROOMS SHALL MEET LIGHT/VENTILATION & EGRESS REQUIRMENTS.

-TEMPERED GLASS TO BE USED AT ALL SAFETY REQUIRED LOCATIONS.

-ALL CABINET DESIGNS/LAYOUTS TO BE VERIFIED WITH SHOP DRAWINGS FROM CABINET MANUFACTURER.

-PER 2018 N.C. RESIDENTIAL BUILDING CODE TABLE R302.6: SHEETROCK ON GARAGE CEILING TO BE 5/8" TYPE "X".

PROJECT:

LOT 1 MORGAN **FARM**

BUILDERS

DATE:


08-23-22

REVISIONS:

SHEET NO.

OF

BCR

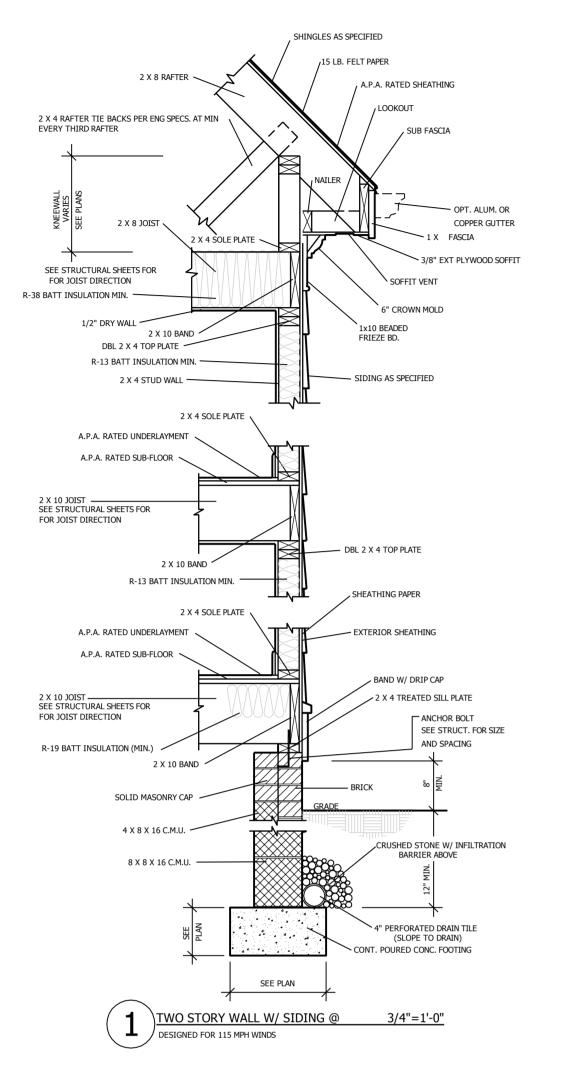

- OPTIONAL CAN LIGHTING

— OPTIONAL CROWN MOLDING

- ADJUSTABLE SHELVES

UNDERCABINET LIGHTING OPT.

SEE OWNER/BUILDER FOR

MODEL TO BE USED

BACKSPLASH

ADJUSTABLE SHELVES

PULL OUT TRAY

FOR 10' CLG HEIGHT USE 12" CABINETS SET ON TOP OF 42" UPPER

SEE OWNER/BUILDER FOR

VERIFICATION OF CABINET


2'-0"


TYP


5 TYP. KITCHEN CABINET SECTION @ 3/4"=1'-0"


OPTIONAL SOFFIT. ADJUST SOFFIT DIMENSIONS TO ACCEPT


TRIM WORK ON CABINETS AS SELECTED

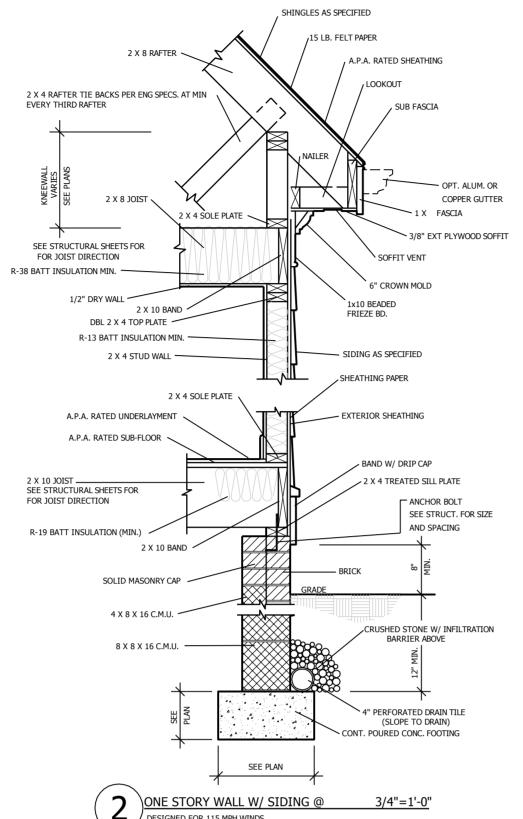


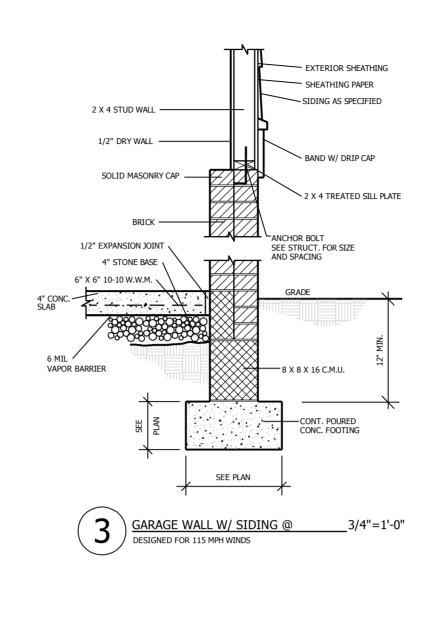

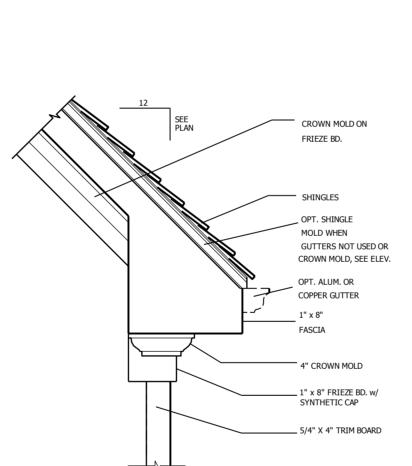

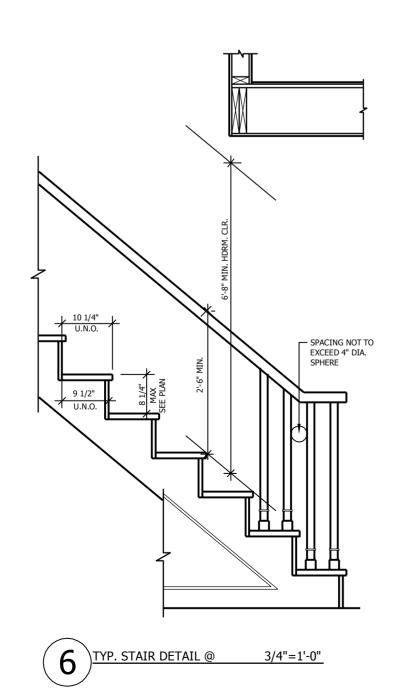

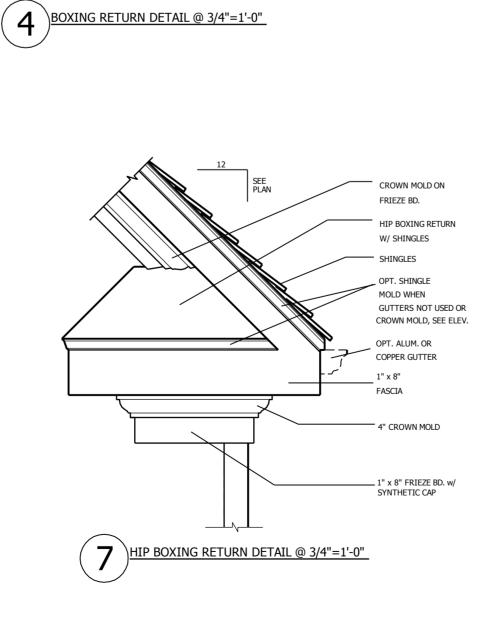

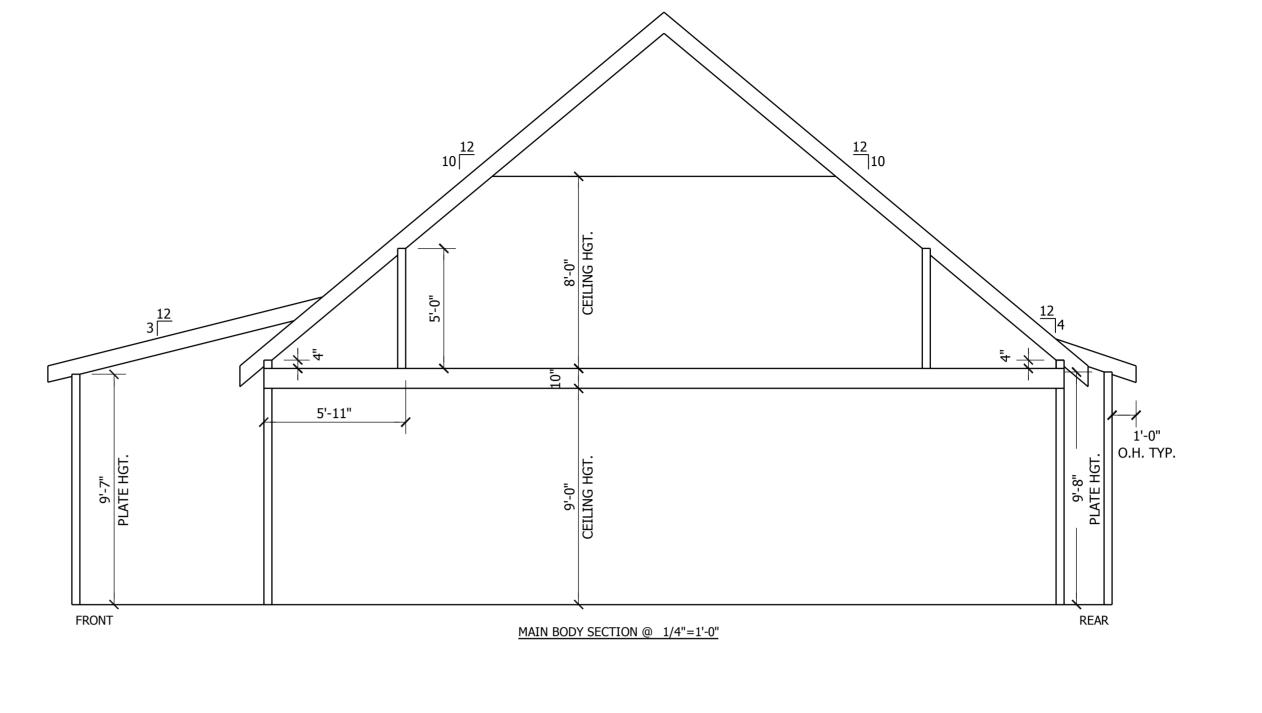

AREA CALCULATIONS


HEATED (SQ. FT	.)	UNHEATED (SQ). FT.)	UNFINISHED (SQ. FT.)
BASEMENT:	N/A	GARAGE:	843	BASEMENT:	N/A
1ST FLOOR:	2309	SCREEN:	218	REC ROOM:	N/A
2ND FLOOR:	535	PORCH:	302	ATTIC:	N/A
		STOOP:	N/A	STORAGE:	1131
		BRICK:	N/A	OVERALL DIMENSION	
TOTAL	2044	TOTAL.	1262	OVERALL DIFFE	INSION
TOTAL:	2844	TOTAL:	1363	WIDTH:	83'-4"
(HEATED)		(UNHEATED)		DEPTH:	57'-10"
•					

PLANS DESIGNED TO THE 2018 NORTH CAROLINA RESIDENTIAL CODE
HOUSE DESIGNED FOR 115 MPH 3 SECOND GUST, EXPOSURE B

ANCHOR BOLTS TO BE NO MORE THAN 6' O.C. AND WITHIN 12" OF ALL PLATES SPLICES ANCHOR BOLTS SHALL BE MIN. 1/2" DIAMETER & SHALL EXTEND A MINIMUM 7" INTO MASONRY OR CONCRETE

MEAN ROOF HEIGHT = < 30'-0"

COMPONENT & CLADDING DESIGNED FOR THE FOLLOWING LOADS MEAN ROOF HEIGHT UP TO 30' 30'-1" - 35' 35'-1" - 40' 40'-1" - 45' ZONE 1 16.5, -18.0 17.3, -18.9 18.0, -19.6 18.5, -20.2 ZONE 2 16.5, -21.0 17.3, -22.1 18.0, -22.9 18.5, -23.5 ZONE 3 17.3, -22.1 18.5, -23.5 16.5, -21.0 18.0, -22.9 ZONE 4 18.9, -20.5 20.2, -21.8 18.0, -19.5 19.6, -21.3 ZONE 5 18.0, -24.1 18.9, -25.3 19.6, -26.3 20.2, -27.0

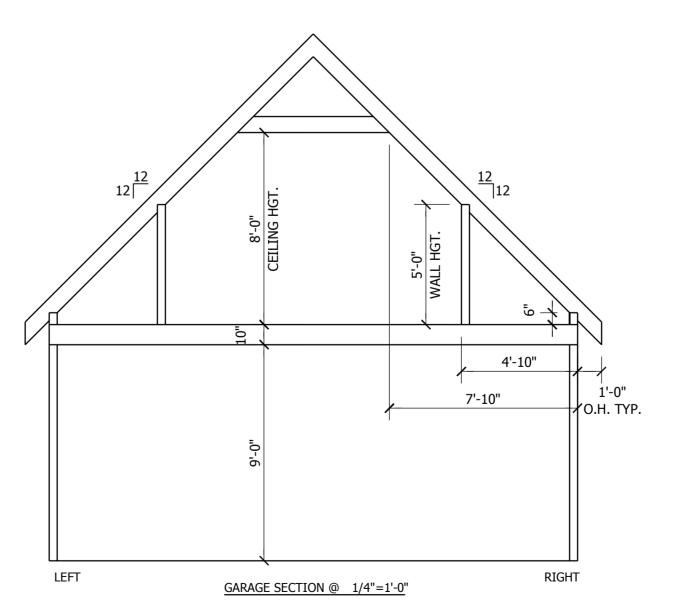

FOUNDATION VENT CALCS.

= 16.19 SQ. FT. VENT REQ'D.

= 29 VENTS TO BE PROVIDED

2429 SQ. FT. 150

16.19 SQ. FT. .56

NOTE: FIGURE BASED ON SECTION R-409 OF THE 2018 IRC. NOTE: FND VENT SPECS BASED ON PUSH/PULL POLYPROPYLENE FND. VENT THAT ALLOWS 72 SQ. IN. OF NET FREE AREA PER VENT.

- WHERE CONTINOUS OPERATED MECHANICAL VENTILATION IS PROVIDED AT A RATE OF 1.0 CFM FOR EACH 50 SQ. FT. OF CRAWL
- THE CRAWL SPACE IS SUPPLIED WITH CONDITIONED AIR AND THE PERIMETER WALLS ARE INSULATED IN ACCORDANCE WITH SECTION R409 OF THE 2018 IRC.
- BUILDER/OWNER TO VERIFY VENT SIZE AND REQUIREMENTS PRIOR TO CONSTRUCTION.
 SEE SECTION R409 OF THE 2018 IRC.

ROOF VENTILATING REQUIREMENTS

 $\frac{3383}{150}$ SQ.FT. = $\underline{22.55}$ SQ. FT. OF TOTAL ROOF VENTILATION REQ'D

280'-4" (LINEAR FT. OF SOFFIT) X = 9.81 SQ. FT. OF AVAILABLE SOFFIT VENT .035 (NET FREE AREA PER FT.)

22.55 $^{-}$ 9.81 = 12.74 SQ.FT. REMAINING REQ'D ROOF VENTILATION

 $\frac{12.74}{.125}$ SQ.FT. $=\frac{101.92}{.125}$ LINEAR FT. OF RIDGE VENT REQ'D

NOTE: FIGURE BASED ON SECTION R-806 OF THE 2018 IRC.

NOTE: - SOFFIT VENT SPECS BASED ON HARDISOFFIT PANELS THAT ALLOWS
5 SQ. IN. OF NET FREE AREA PER LINEAR FT.

- RIDGE VENT SPECS BASED ON VENTURIVENT PLUS THAT ALLOWS
18 SQ. IN. OF NET FREE AREA PER LINEAR FT.

TOTAL NET FREE VENTILATING AREA IS PERMITTED TO BE REDUCED TO 1 TO 300:

- PROVIDED AT LEAST 50% AND NOT MORE THAN 80% OF THE REQ'D VENTILATING AREA IS PROVIDED BY VENTILATORS. REFERENCE R806.2 OF THE 2018 IRC. FOR PROPER LOCATION.
- WHEN AN APPROVED VAPOR BARRIER HAVING A TRANSMISSION RATE NOT EXCEDING 1 PERM IS INSTALLED ON THE WARM SIDE OF THE CEILING

ATIVE RESIDENTIA DESIGNS, LLC

PROJECT:

LOT 1 MORGAN FARM

EPHENSON UILDERS INC.

7 NORTH RALEIGH S ANGIER, NC 2750

DATE:

08-23-22 BCR

REVISIONS:

SHEET NO.

5

OF

5