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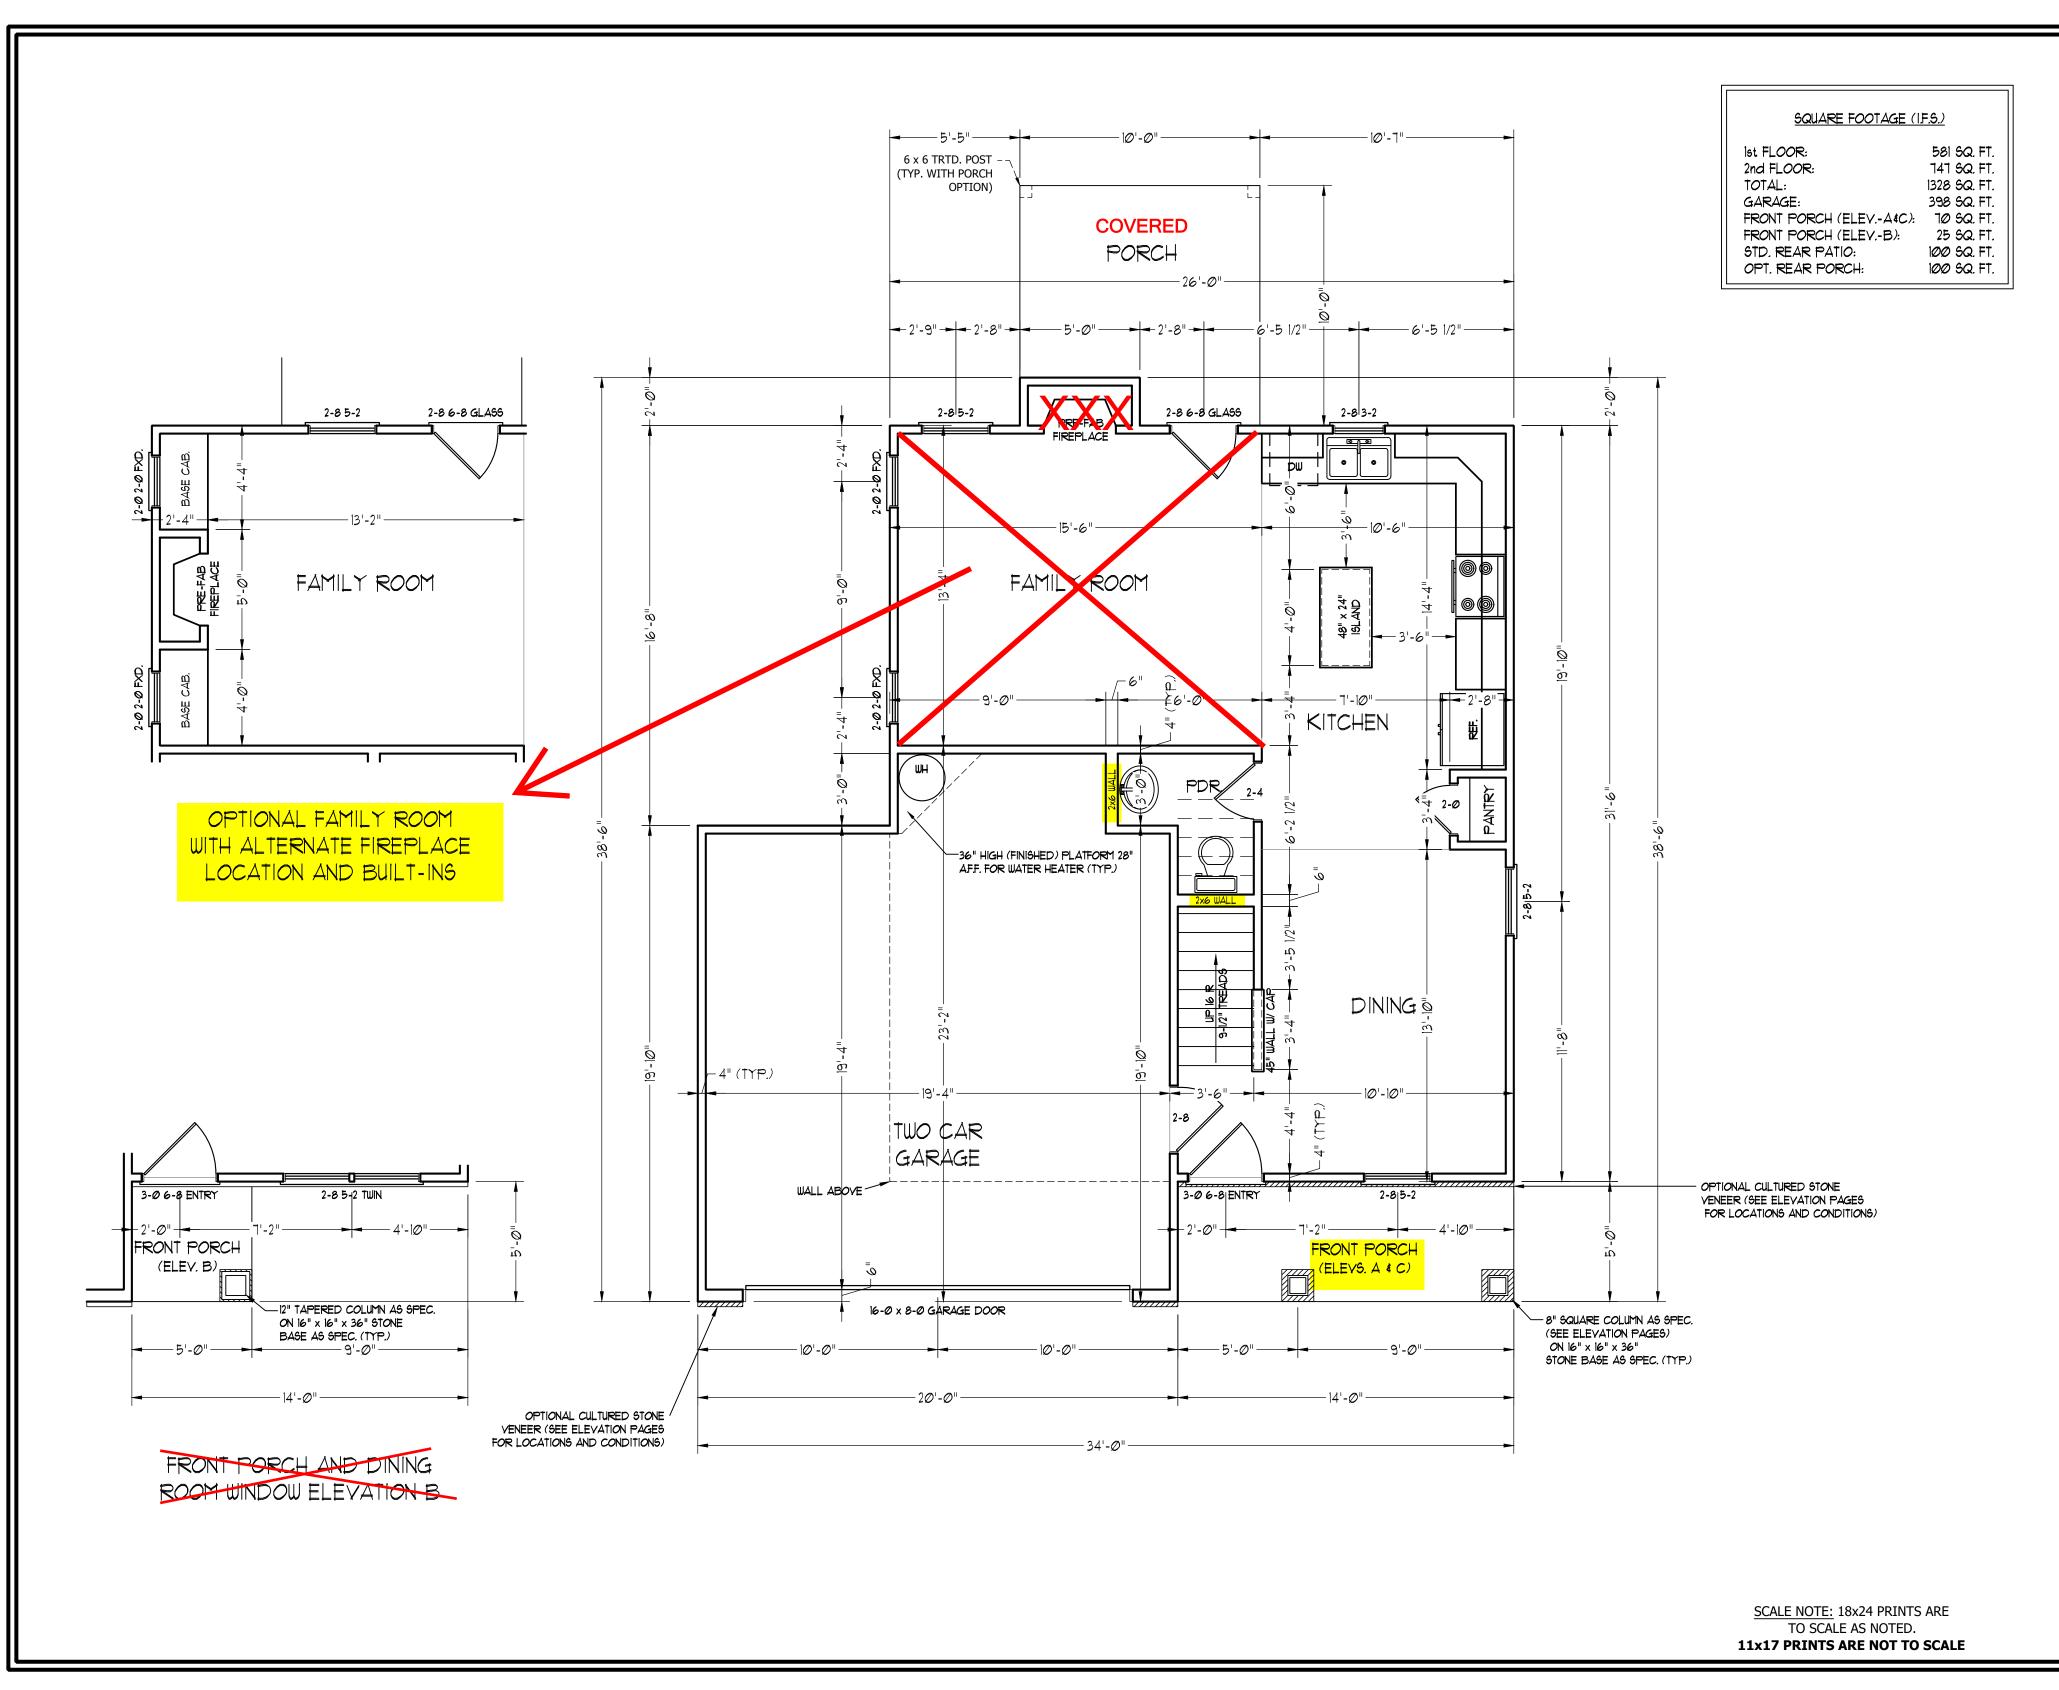
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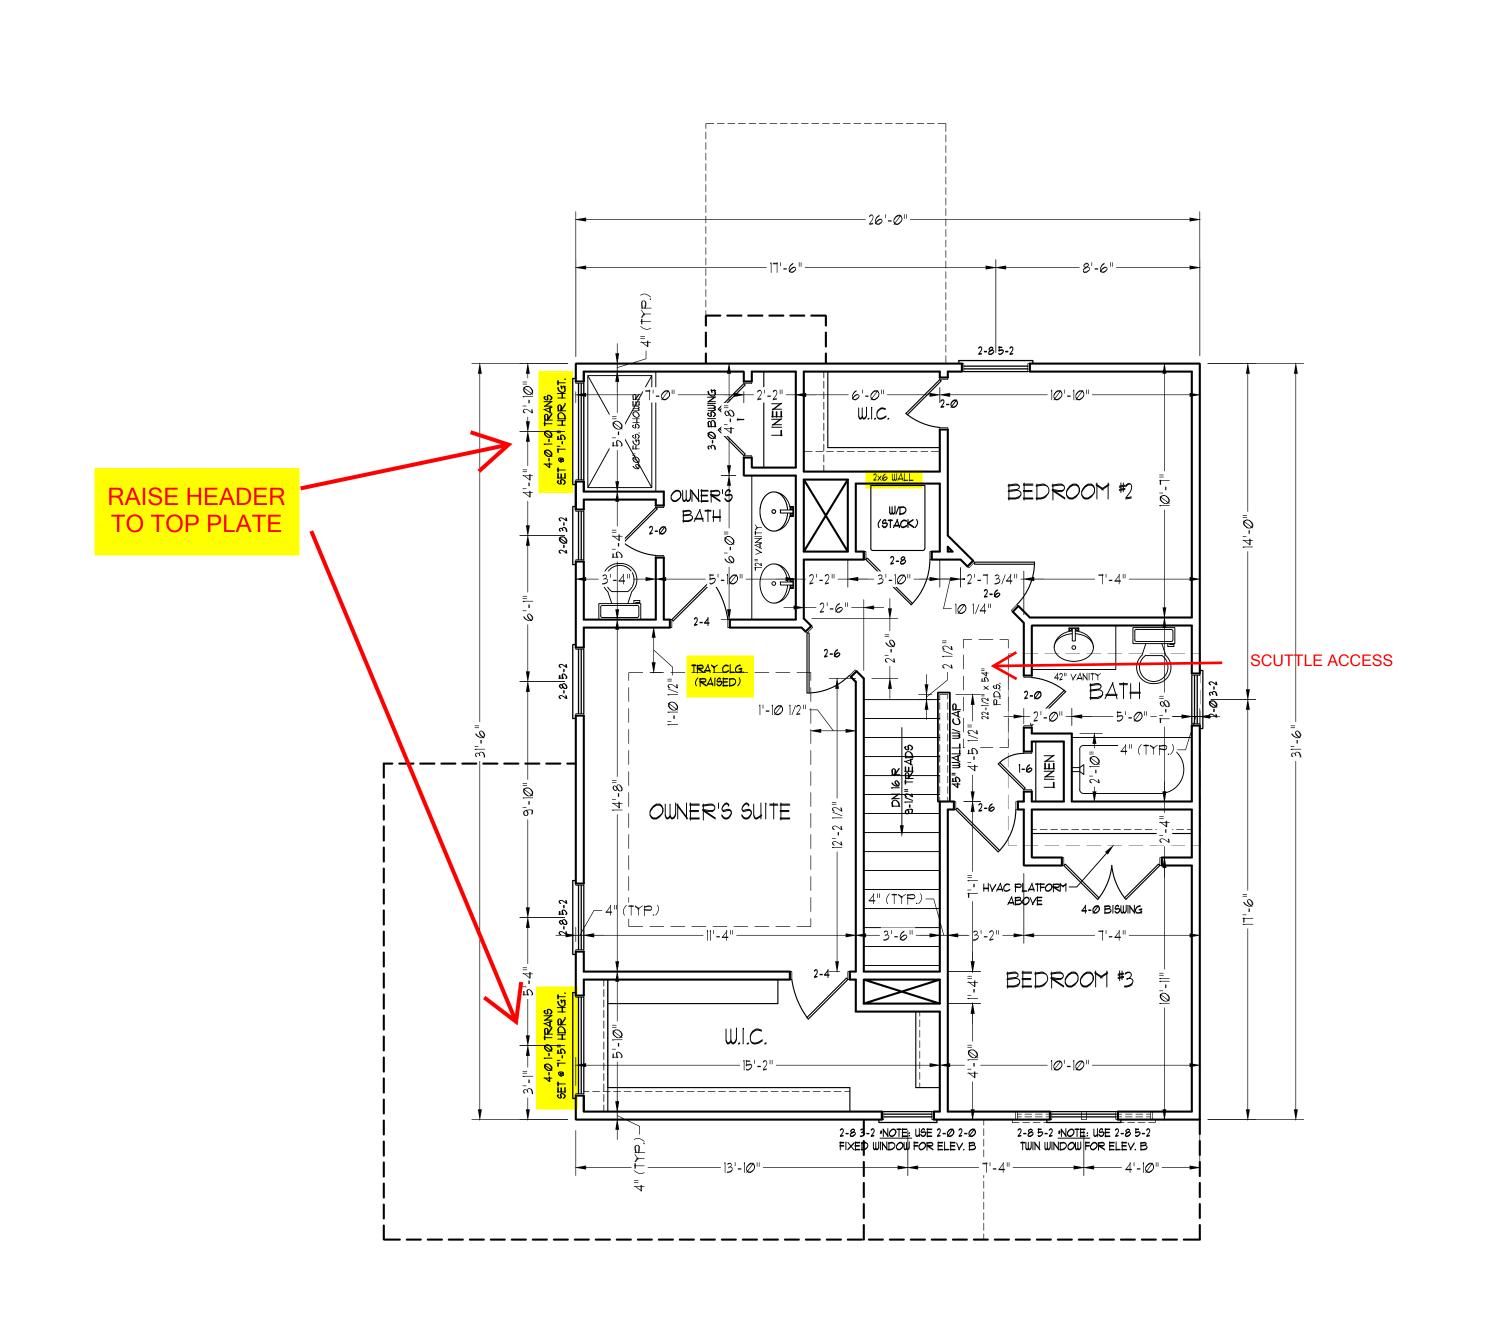
SCALE: 1/4" = 1'-0"

DRAWN BY: WG
ENGINEERED BY:

REVIEWED BY:

FIRST FLOOR PLAN

A-4



SCALE NOTE: 18x24 PRINTS ARE
TO SCALE AS NOTED.
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DATE: FEBRUARY 19, 2021

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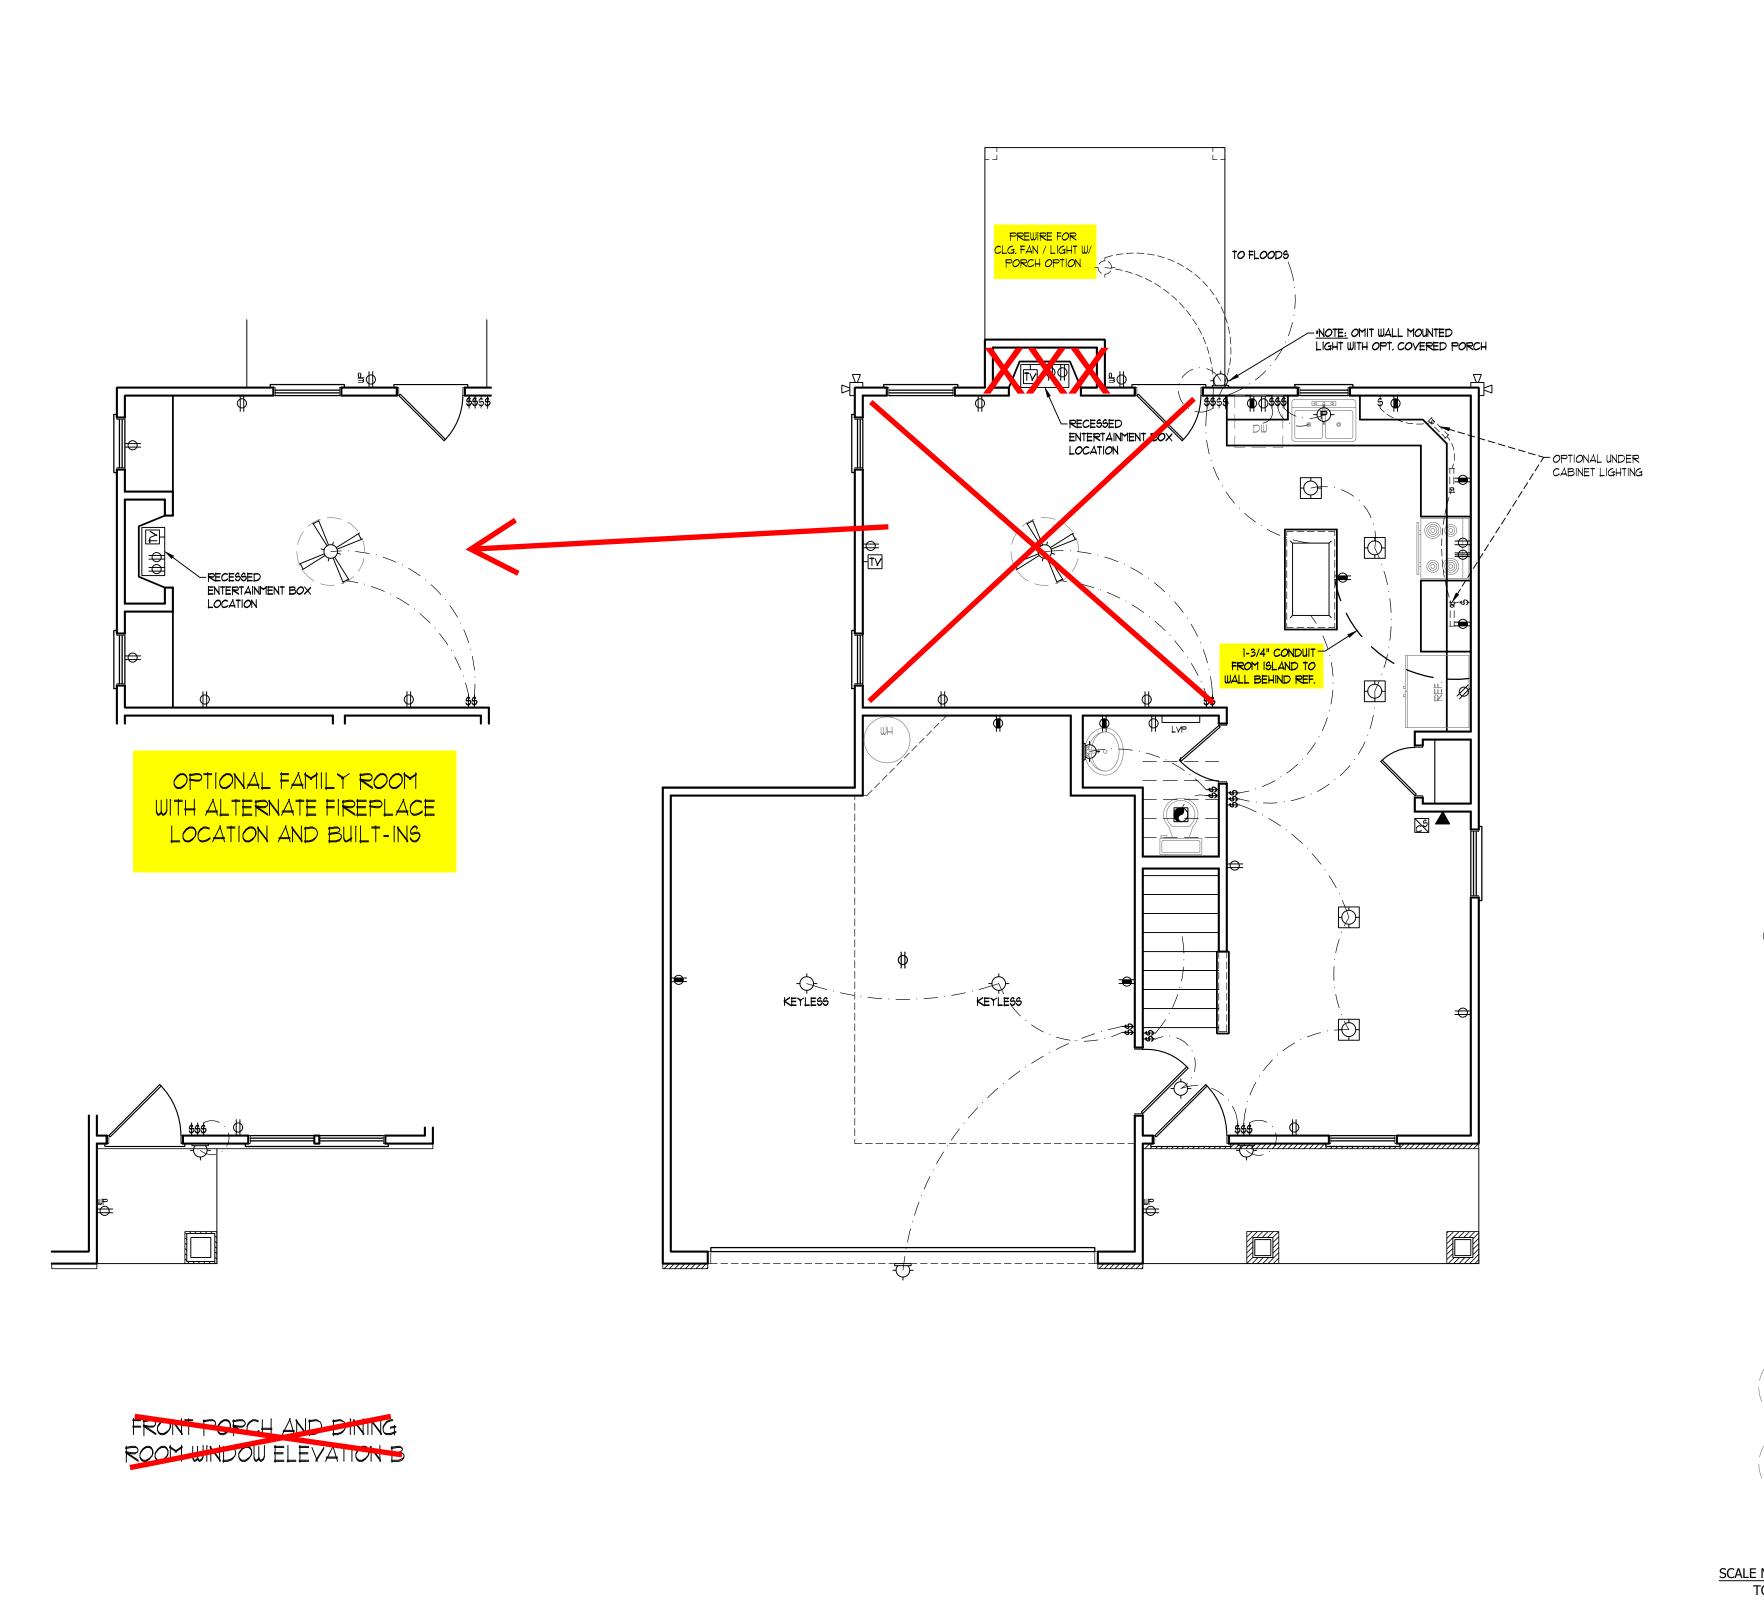
DRAWN BY: WG

ENGINEERED BY:

REVIEWED BY:

SECOND FLOOR PLAN

A-5





- I.) BLOCK AND WIRE FOR ALL CELING FANS PER PLAN.
- 2.) VANITY LIGHTS TO BE SET @ 90" AFF. (TYP.)
- 3.) ADDITIONAL EXTERIOR OUTLETS REQUIRED BY CODE TO BE LOCATED BY ELECTRICIAN.
- 4.) PLACE SWITCHES 8" (MIN.) FROM ROUGH OPENINGS.

#### ELECTRICAL LEGEND

- →
   IIØ ∨ OUTLET
- ₩ IIØ Y GFI OUTLET
- ⇒ 110 V SWITCHED OUTLET
- BB 110 Y BASEBOARD OUTLET
- 4-PLEX
- COUNTER OR FLOOR MOUNTED
- COUNTER OR FLOOR MOUNTED 110V GFI
- ₩EATHERPROOF
- **⇒** 22*0* ∨ *O*UTLET
- Ø IIØ Y DEDICATED CIRCUIT
- # 220 V DEDICATED CIRCUIT
- SPECIAL PURPOSE (240 V, ETC.)
- WALL MOUNT LIGHT
- -CEILING MOUNT LIGHT
- -P- PENDANT LIGHT
- RECESSED CAN LIGHT
- MINI CAN LIGHT
- EYEBALL LIGHT

FLUORESCENT LIGHT
UNDERCABINET LIGHT

— Undercadineilio 7

FLOOD LIGHT

SWITCH

\$D DIMMER SWITCH

▲ TELEPHONE

\_\_\_\_\_

△ DATA

TELEPHONE AND DATA

TY- TY CONNECTION

TV/ DATA

CD- CONDUIT FOR COMPONENT WIRING

SP SPEAKER

110 V SMOKE/ CM DETECTOR

6D 110 Y SMOKE DETECTOR

EXHAUST FAN

LOW VOLTAGE PANEL

ALARM PANEL



/



CEILING FAN W/ LIGHT

SCALE NOTE: 18x24 PRINTS ARE
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DATE: FEBRUARY 19, 2021

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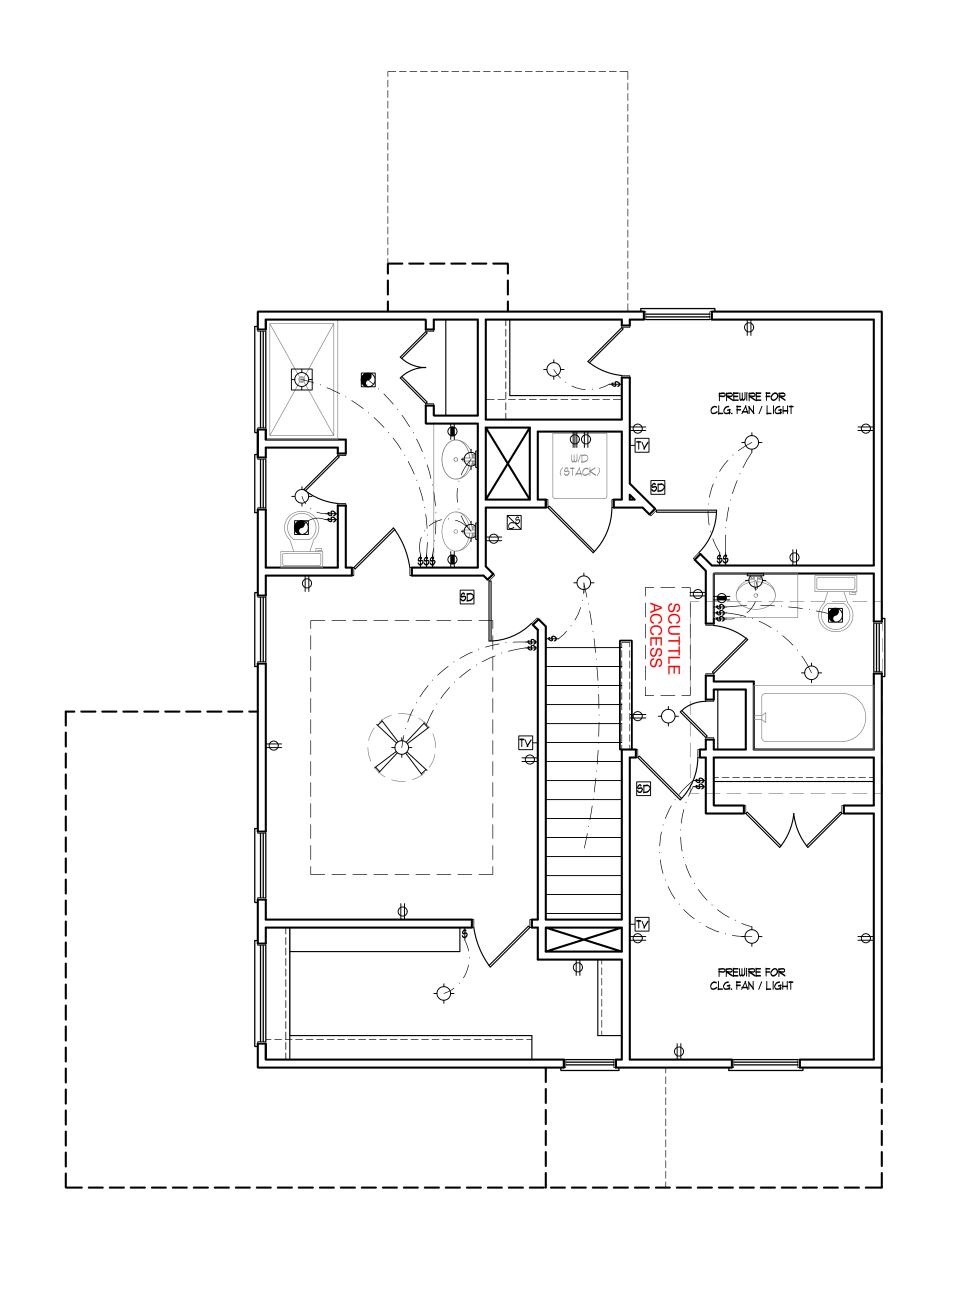
SCALE: 1/4" = 1'-0"

DRAWN BY: WG
ENGINEERED BY:

REVIEWED BY:

FIRST FLOOR ELECTRICAL PLAN

E-1



#### ELECTRICAL LAYOUT NOTES:

- 1.) BLOCK AND WIRE FOR ALL CELING FANS PER PLAN.
- 2.) VANITY LIGHTS TO BE SET @ 90" A.F.F. (TYP.)
- 3.) ADDITIONAL EXTERIOR OUTLETS REQUIRED BY CODE TO BE LOCATED BY ELECTRICIAN.
- 4.) PLACE SWITCHES 8" (MIN.) FROM ROUGH OPENINGS.

#### ELECTRICAL LEGEND

- ⇒ IIØ Y OUTLET
- ₩ IIØ Y GFI OUTLET
- → 110 V SWITCHED OUTLET
- BB IIØ V BASEBOARD OUTLET
- 4-PLEX
- COUNTER OR FLOOR MOUNTED
- COUNTER OR FLOOR MOUNTED 110V GFI
- ₩EATHERPROOF
- **⇒** 220 ∨ OUTLET
- 10 V DEDICATED CIRCUIT
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- PH SPECIAL PURPOSE (240 V, ETC.)
- WALL MOUNT LIGHT
- -P- PENDANT LIGHT
- RECESSED CAN LIGHT
- MINI CAN LIGHT
- EYEBALL LIGHT

FLUORESCENT LIGHT

undercabinet light

FLOOD LIGHT

SWITCH \$D DIMMER SWITCH

▲ TELEPHONE

△ DATA

TELEPHONE AND DATA

TV- TV CONNECTION

CD- CONDUIT FOR COMPONENT WIRING

SP SPEAKER

110 V SMOKE/ CO DETECTOR

SD 110 Y SMOKE DETECTOR

EXHAUST FAN

LOW VOLTAGE PANEL ALARM PANEL





SCALE NOTE: 18x24 PRINTS ARE TO SCALE AS NOTED. 11x17 PRINTS ARE NOT TO SCALE



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DATE: FEBRUARY 19, 2021

SCALE: 1/4" = 1'-0" DRAWN BY: WG


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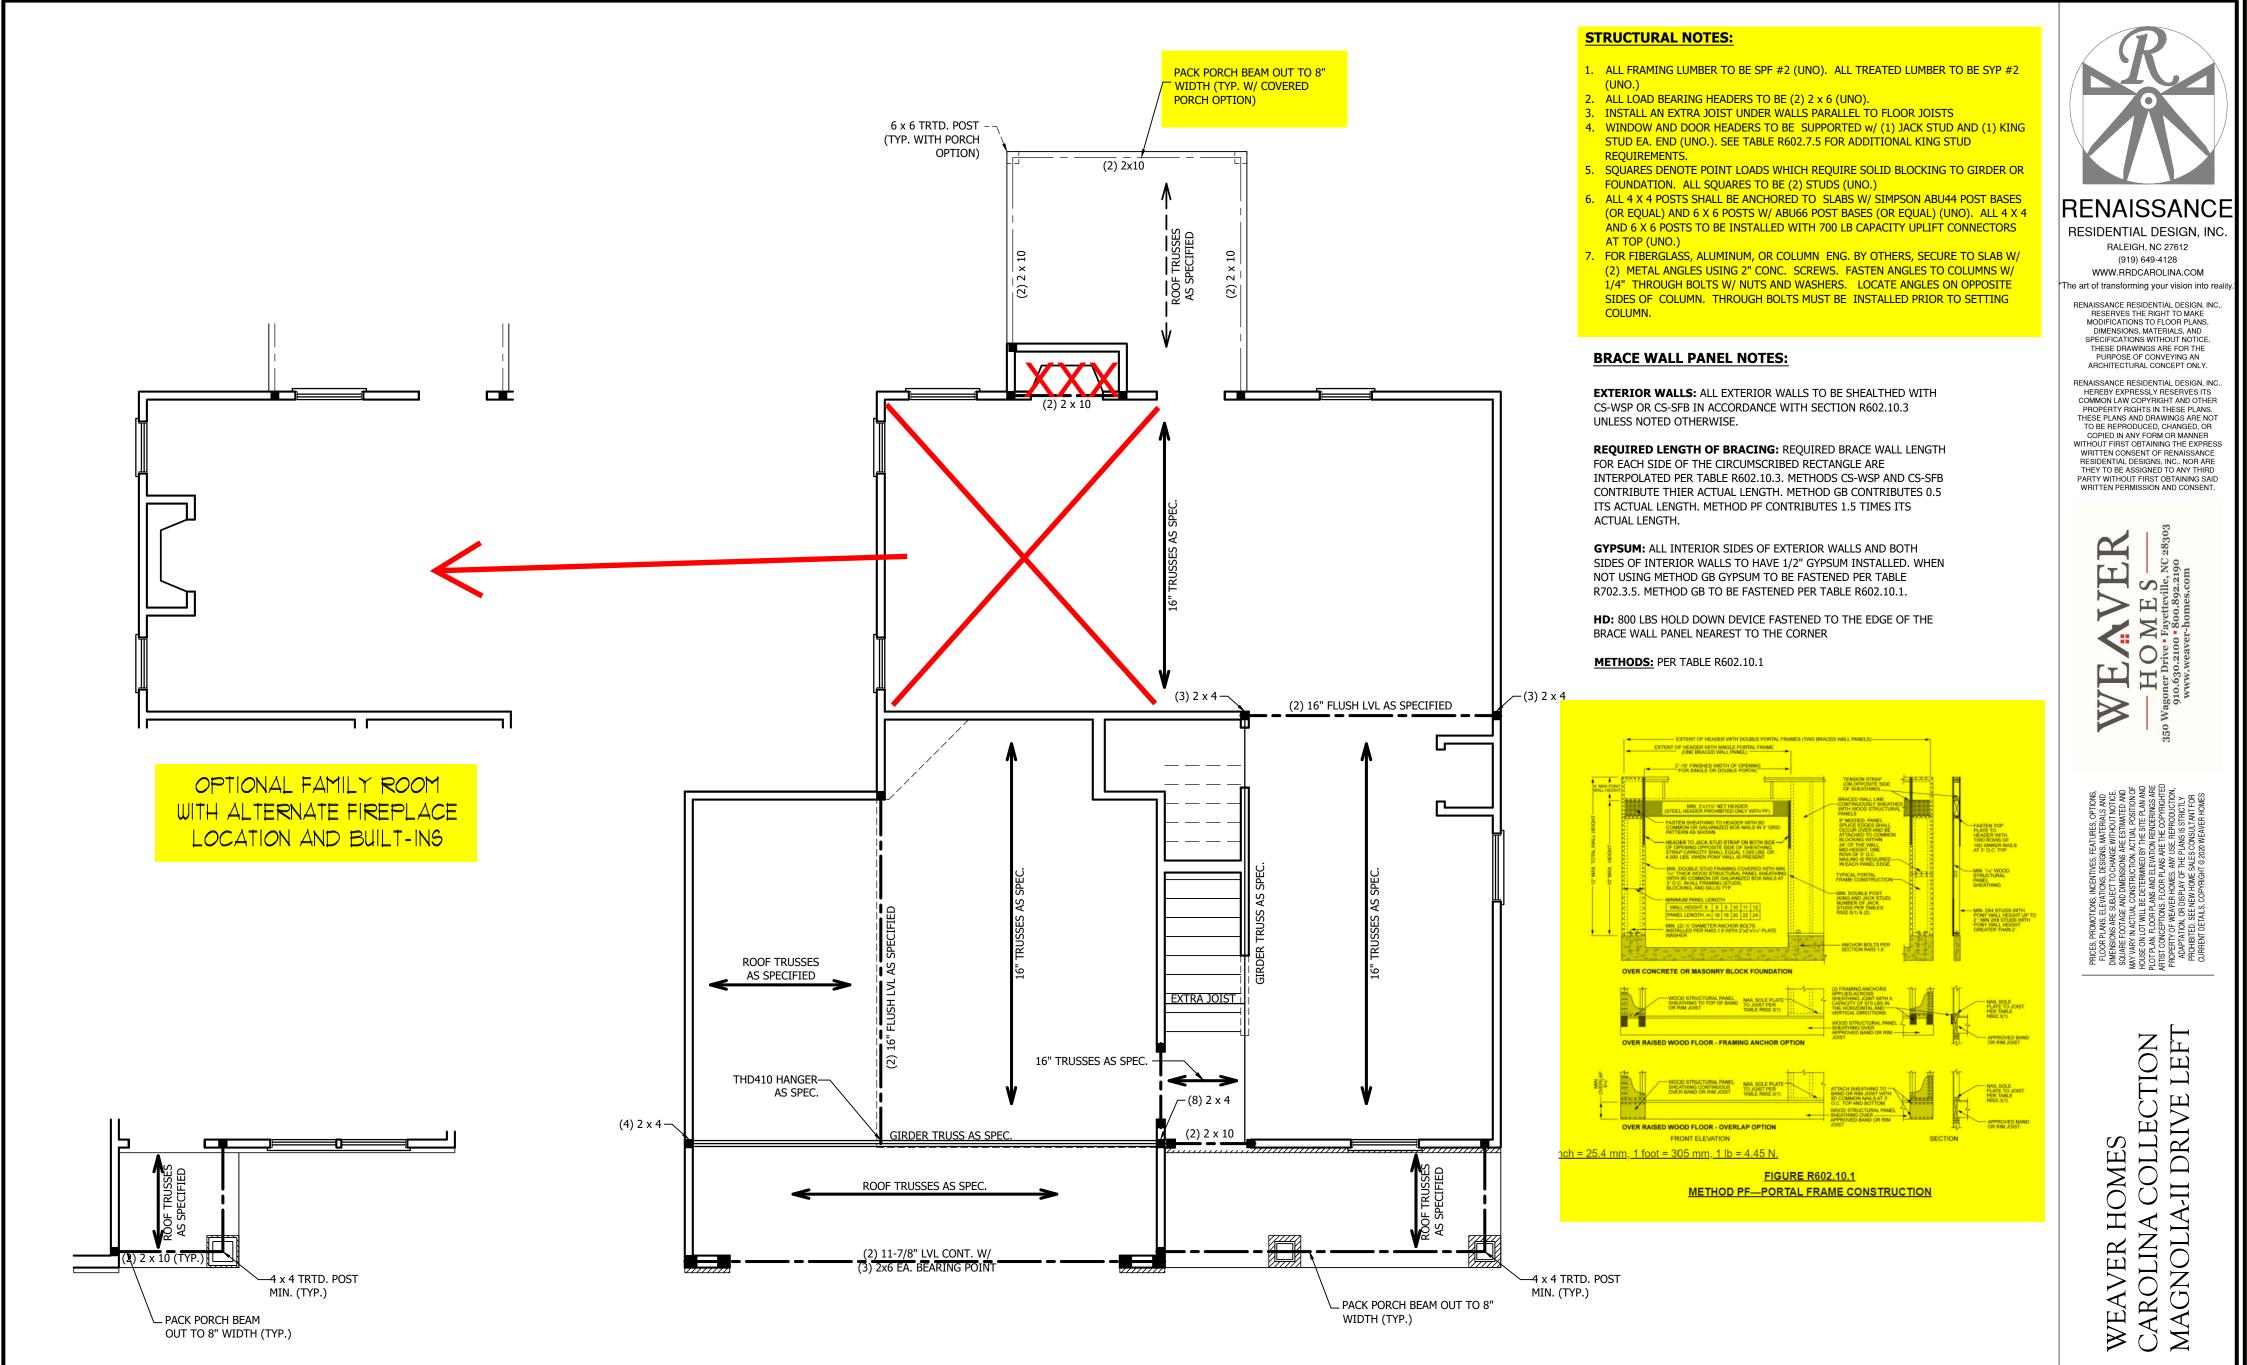
SECOND FLOOR ELCTRICAL

E-2

PLAN



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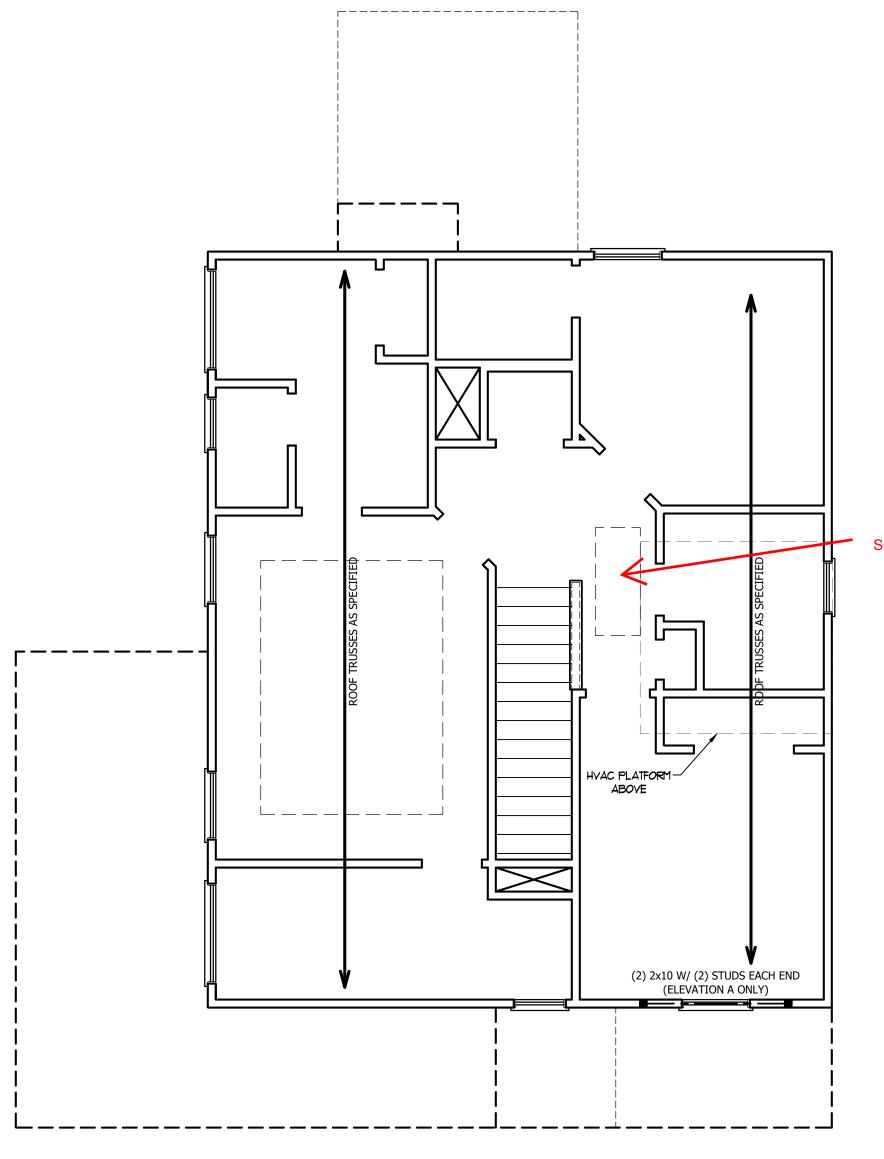
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ENGINEERED BY: REVIEWED BY:

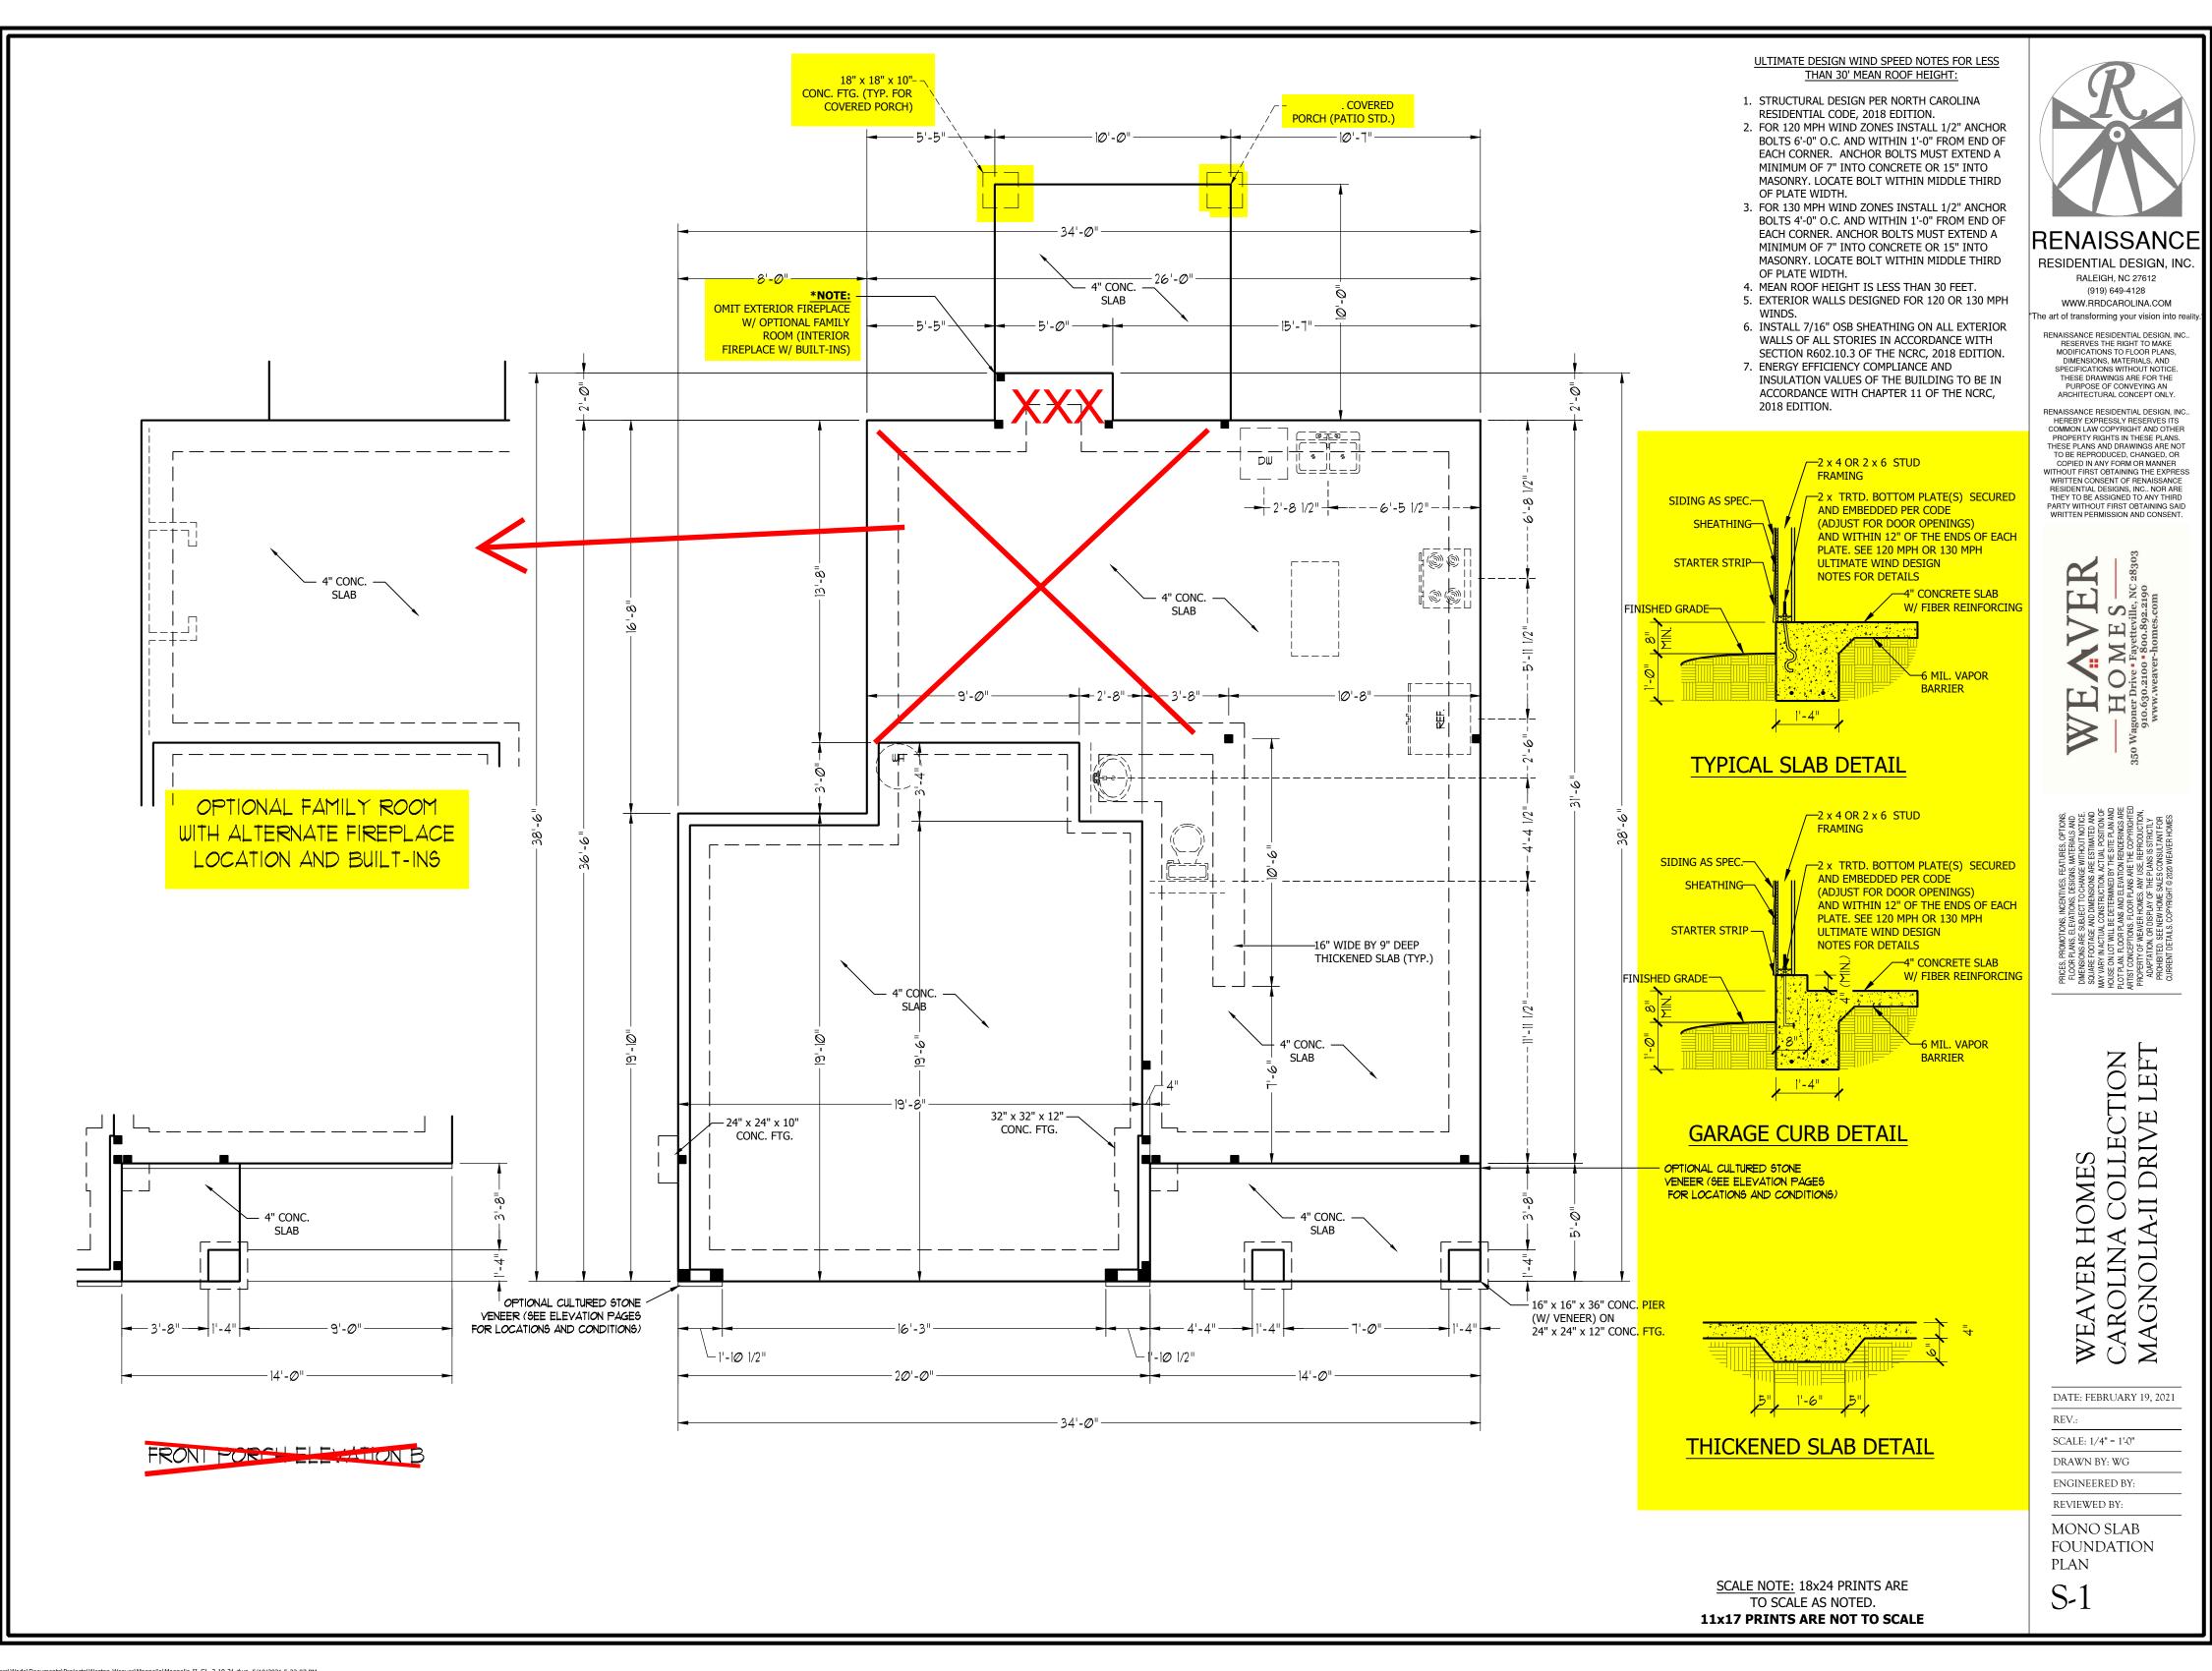SECOND FLOOR FRAMING PLAN

S-2

SCALE NOTE: 18x24 PRINTS ARE TO SCALE AS NOTED. 11x17 PRINTS ARE NOT TO SCALE



### TABLE R602.7.5 MINIMUM NUMBER OF FULL HEIGHT STUDS AT EACH END OF HEADERS IN EXTERIOR WALLS

		_
HEADER SPAN (FEET)		SPACING (INCHES) E R602.3(5)
( == . )	16	24
UP TO 3'	1	1
4'	2	1
8'	3	2
12'	5	3
16'	6	4

#### STRUCTURAL NOTES:

- 1. ALL FRAMING LUMBER TO BE SPF #2 (UNO). ALL TREATED LUMBER TO BE SYP #2 (UNO.)
- 2. ALL LOAD BEARING HEADERS TO BE (2) 2 x 6 (UNO).
- 3. WINDOW AND DOOR HEADERS TO BE SUPPORTED w/ (1) JACK STUD AND (1) KING STUD EA. END (UNO.). SEE TABLE R602.7.5 FOR ADDITIONAL KING STUD REQUIREMENTS.
- 4. SQUARES DENOTE POINT LOADS WHICH REQUIRE SOLID BLOCKING TO GIRDER OR FOUNDATION. ALL SQUARES TO BE (2) STUDS (UNO.)

DSP - DOUBLE STUD POCKET TSP - TRIPLE STUD POCKET

SCUTTLE ACCESS



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DATE: FEBRUARY 19, 2021

REV ·

SCALE: 1/4" = 1'-0"

DRAWN BY: WG

ENGINEERED BY:


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ATTIC FLOOR FRAMING PLAN

S-3

SCALE NOTE: 18x24 PRINTS ARE
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11x17 PRINTS ARE NOT TO SCALE




#### ATTIC VENT CALCULATION:

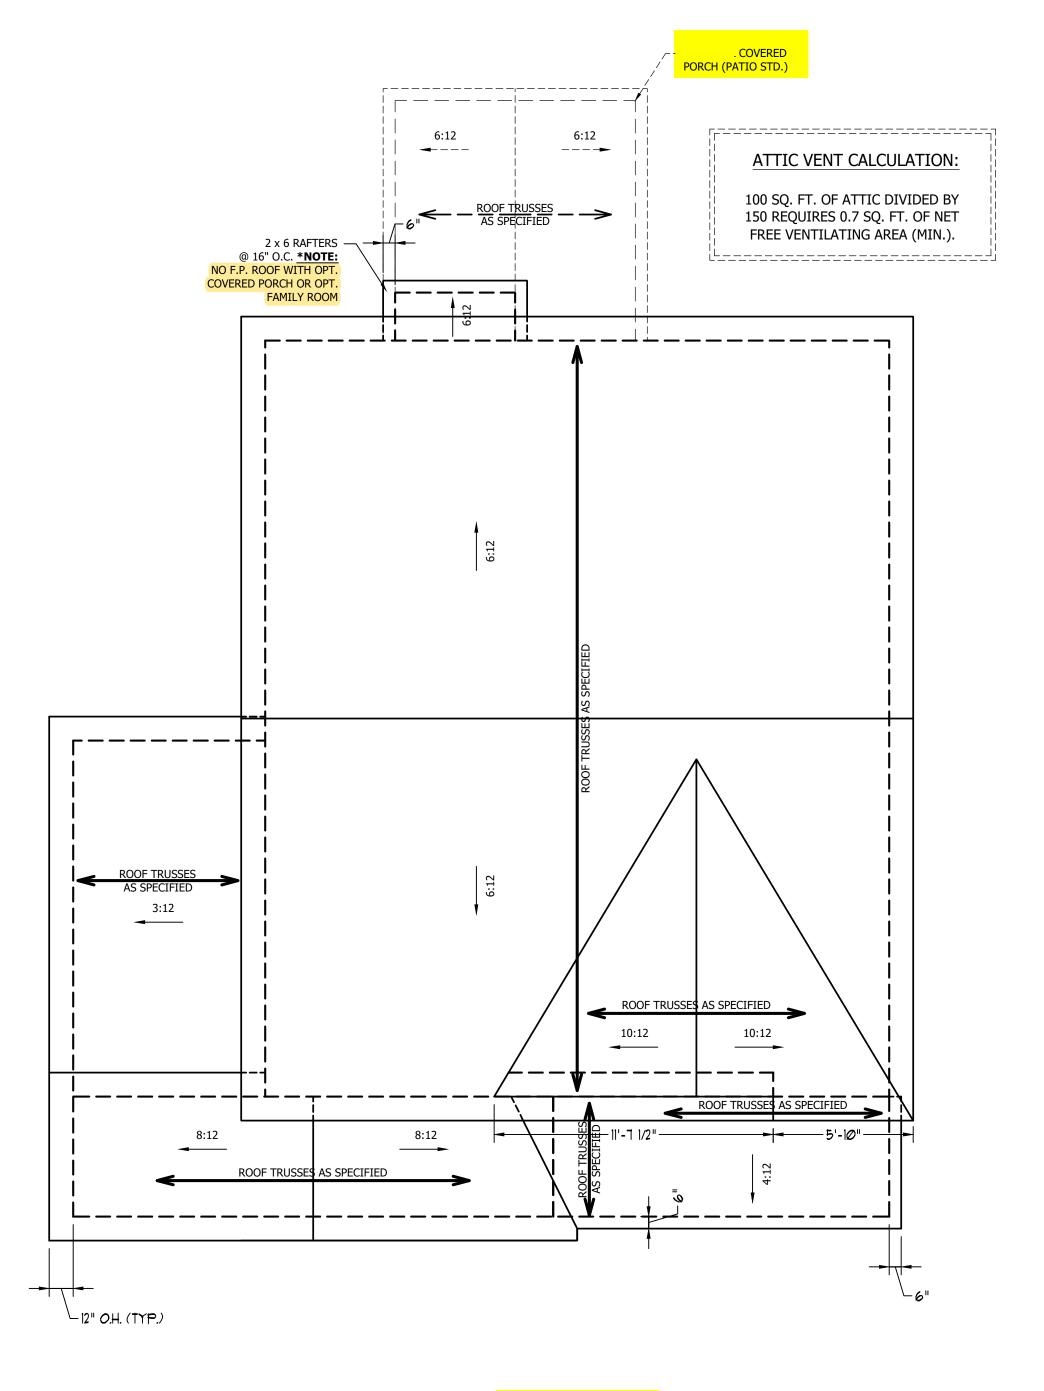1250 SQ. FT. OF ATTIC DIVIDED BY 150 REQUIRES 8.3 SQ. FT. OF NET FREE VENTILATING AREA (MIN.).

#### STRUCTURAL NOTES:

- 1. ALL FRAMING LUMBER TO BE #2 SPF (UNO).
- 2. HIP SPLICES ARE TO BE SPACED A MIN. OF 8'-0". FASTEN MEMBERS WITH THREE ROWS OF 12d NAILS @ 16" O.C. (TYP.)
- 3. STICK FRAME OVER-FRAMED ROOF SECTIONS W/ 2 x 8 RIDGES, 2 x 6 RAFTERS @ 16" O.C. AND FLAT 2 x 10 VALLEYS OR USE VALLEY TRUSSES.
- 4. FASTEN FLAT VALLEYS TO RAFTERS OR TRUSSES WITH SIMPSON H2.5A HURRICANE TIES @ 32" O.C. MAX. PASS HURRICANE TIES THROUGH NOTCH IN ROOF SHEATHING. EACH RAFTER IS TO BE FASTENED TO THE FLAT VALLEY WITH A MIN. OF (6) 12d TOE NAILS.
- REFER TO SECTION R802.11 OF THE 2018 NCRC FOR REQUIRED UPLIFT RESISTANCE AT RAFTERS AND TRUSSES.

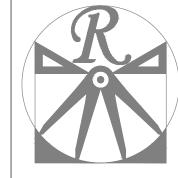

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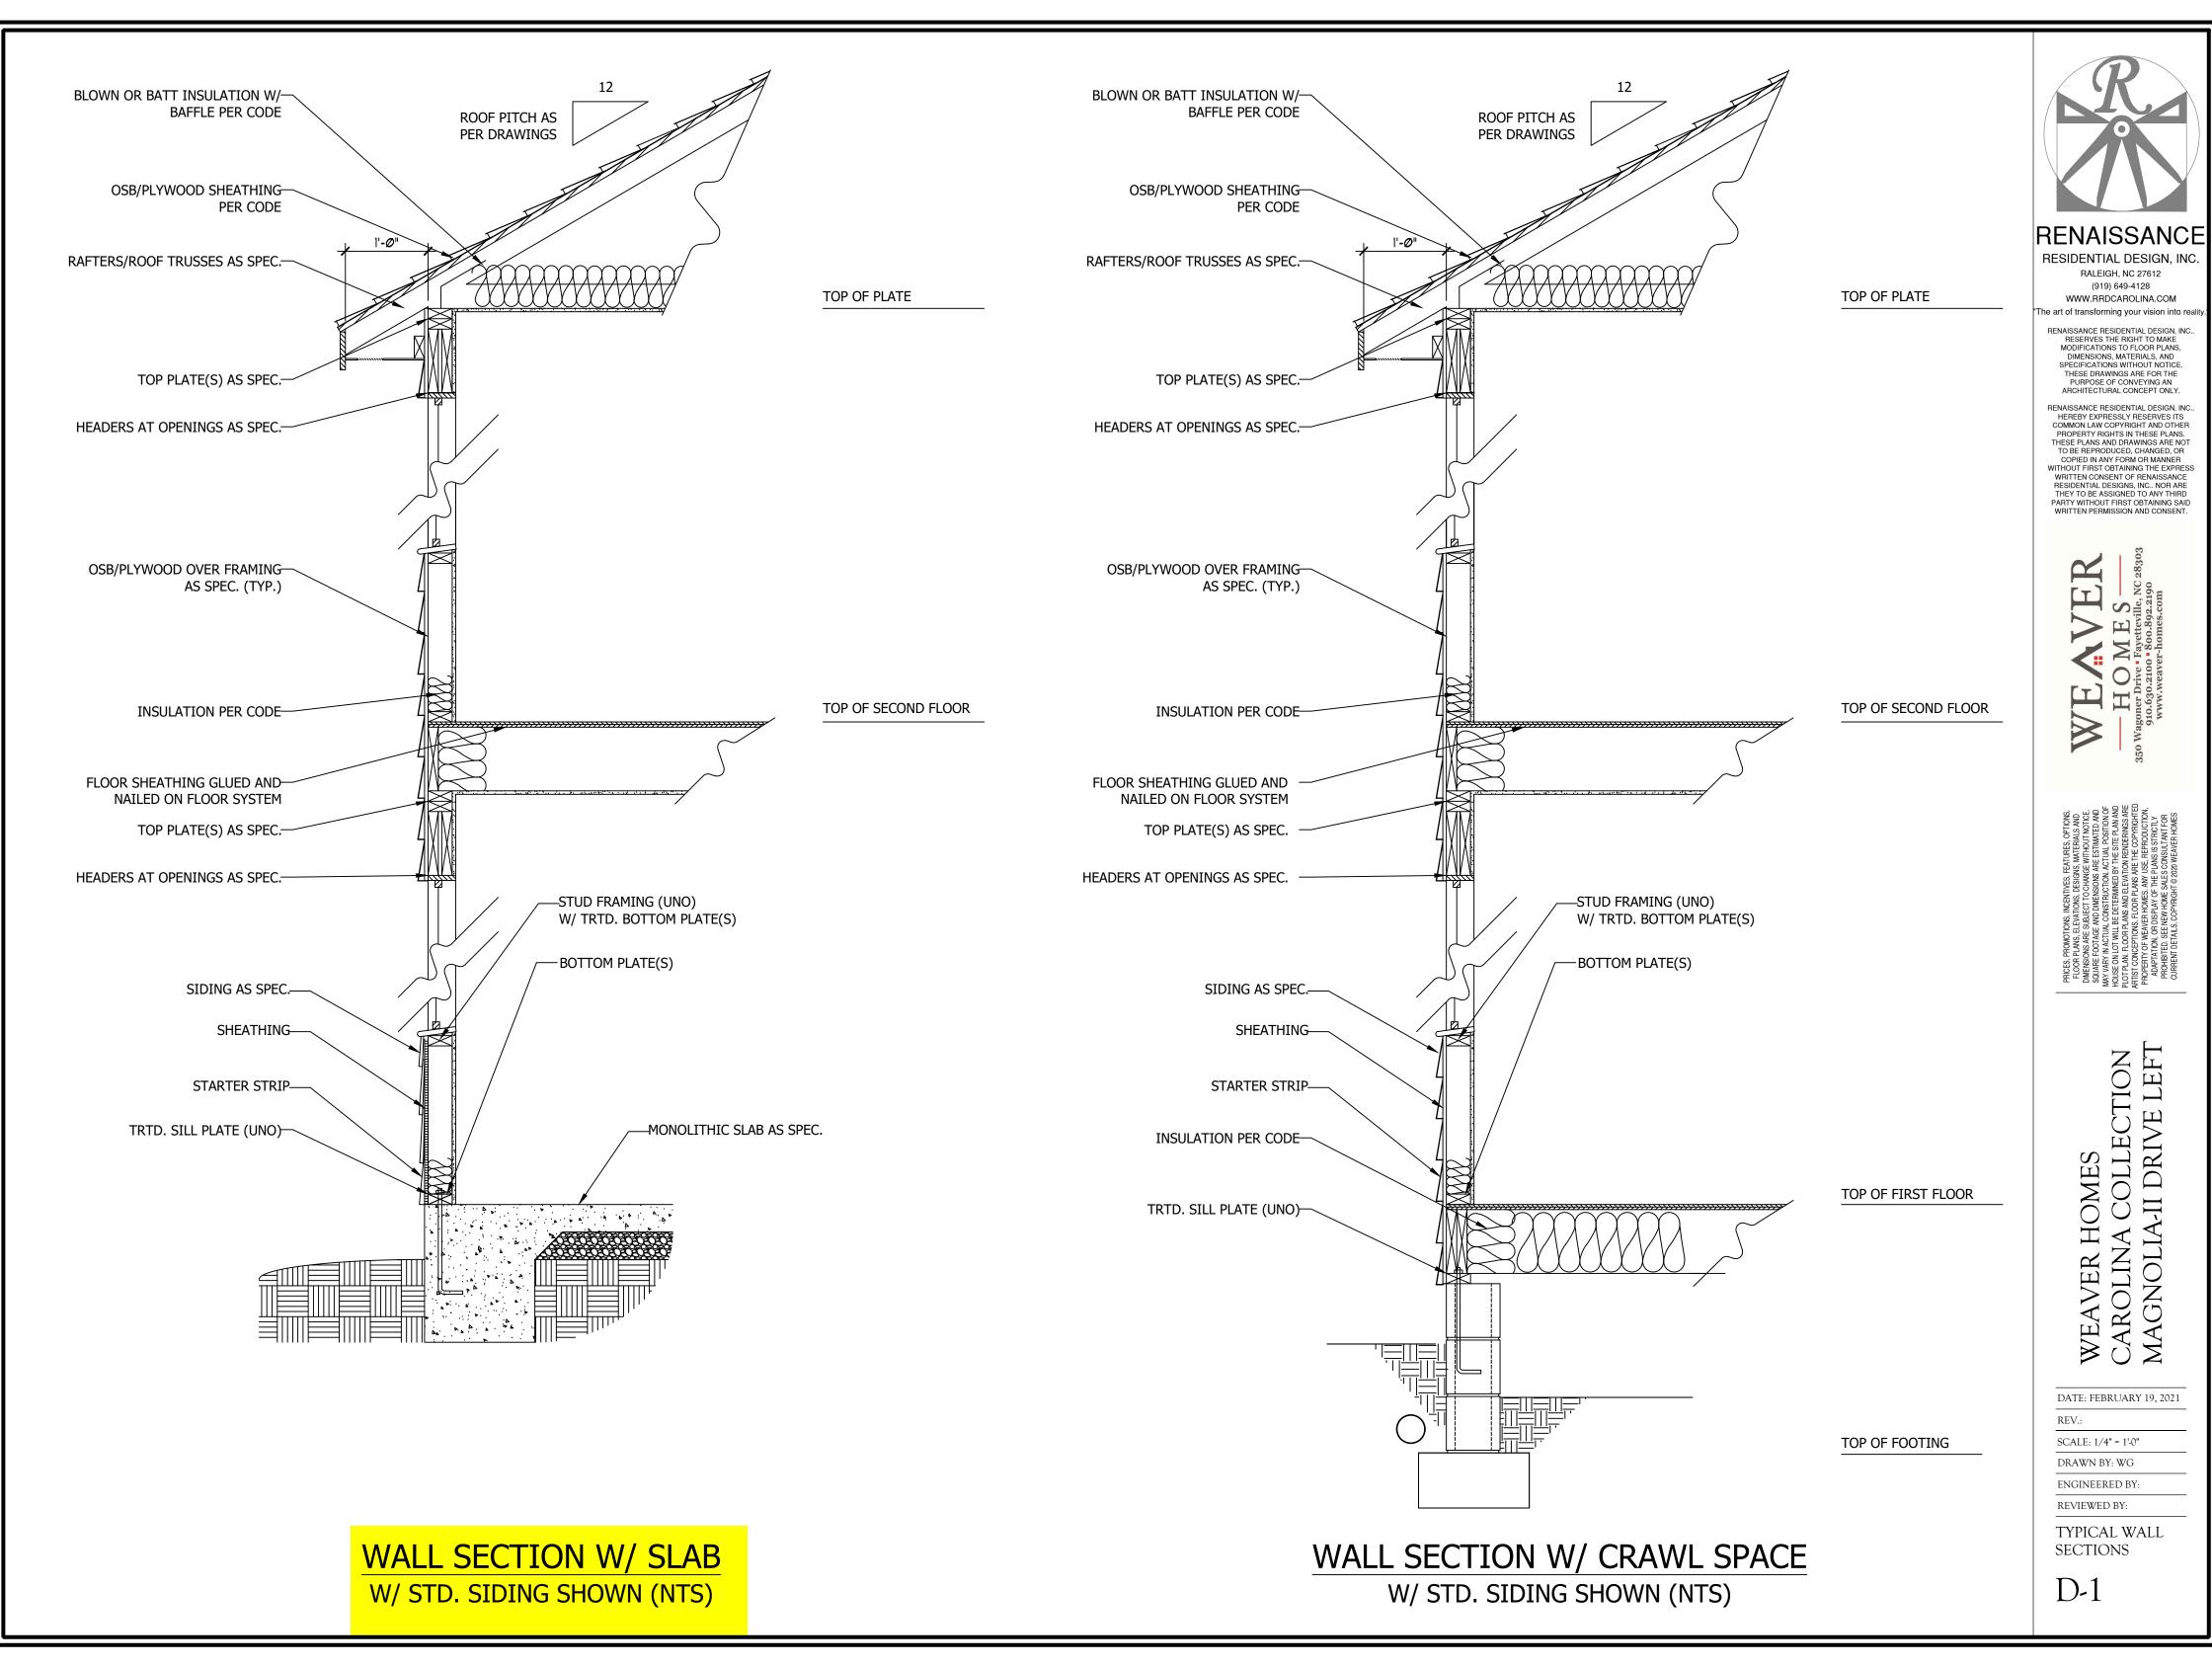
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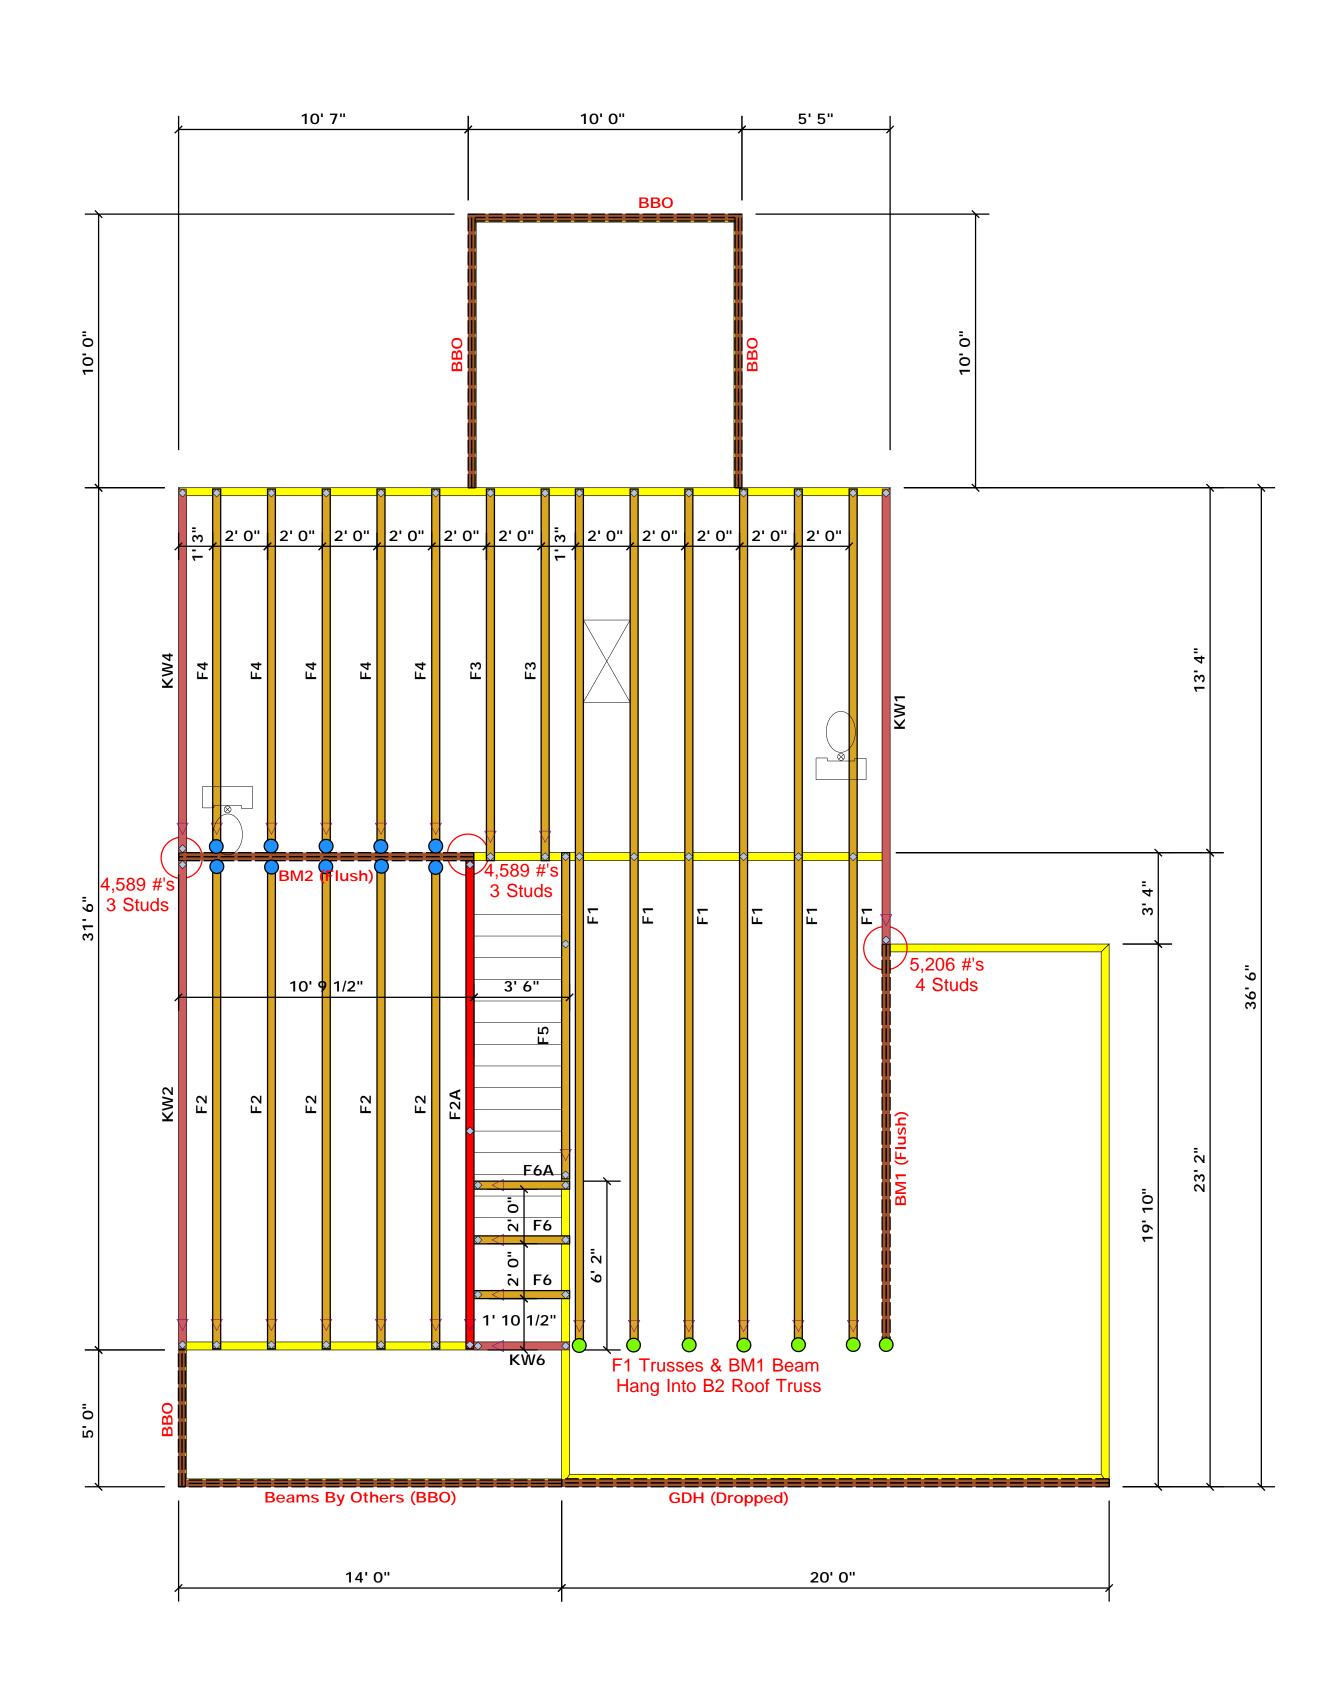
REVIEWED BY:

ROOF PLAN ELEVATION - C

S-4

ELEVATION C





Connector Information Nail Information Supported Member Product Manuf Qty Header Truss HUS410 USP 10 16d/3-1/2" NA 16d/3-1/2" THD410 USP NA 16d/3-1/2" 10d/3"

Truss Placement Plan SCALE: NTS

▲ = Denotes Left End of Truss
(Reference Engineered Truss Drawing)

Products								
PlotID	Length	Product	Plies	Net Qty	Fab Type			
GDH (Dropped)	20' 0"	1-3/4"x 11-7/8" LVL Kerto-S	2	2	FF			
BM1 (Flush)	15' 0"	1-3/4"x 16" LVL Kerto-S	2	2	FF			
BM2 (Flush)	11' 0"	1-3/4"x 16" LVL Kerto-S	2	2	FF			


All Truss Reactions are Less than 3,000 lbs. Unless Noted Otherwise.

-- Denotes Reaction Greater than 3,000 lbs.

Reaction / # of Studs

LOAD CHART FOR JACK STUDS  (BASED ON LABEL 8502.5(1) 4.0(1)  MARIE OF JACK STUDS SECURITY OF CALCUS OF											
		PEAGER/1	61R068								
END REACTION (OT FU)	SEC DISTUDS FOR COMPANY HEADER	SND PENCTION (LP TO)	MRQ IS STUDS FOR CIPAN - PARKIR	END REACTION (0.º 170)	REQUESTLES FOR (4) MY HEADER						
1700	1	2550	1	3400	1						
3400	2	5100	2	6600	2						
5100	3	7650	3	10200	3						
6800	4	10200	4	13600	4						
8500	5	12750	5	17000	5						
10200	6	15300	6								
11900	7										
13600	8										
15300	9										

	BUILDER	Weaver Development	CITY / CO.	Lillington / Harnett	THIS These the bui
	JOB NAME	Lot 4 Hales Farm	ADDRESS	NC 27 West	is resp the ove walls, regard
	PLAN	Magnolia I I "C"	MODEL	Floor	or onli
	SEAL DATE	Seal Date	DATE REV.	/ /	( deriv founda than 3 be reta
	QUOTE #	Quote #	DRAWN BY	Christine Shivy	specifi retaine
-	JOB#	J0822-4191	SALES REP.	Lenny Norris	Sig

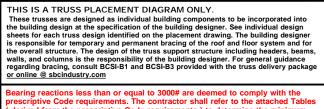


ROOF & FLOOR TRUSSES & BEAMS Reilly Road Industrial Park

Reilly Road Industrial Park
Fayetteville, N.C. 28309

Christine Shivy

Fax: (910) 864-4444

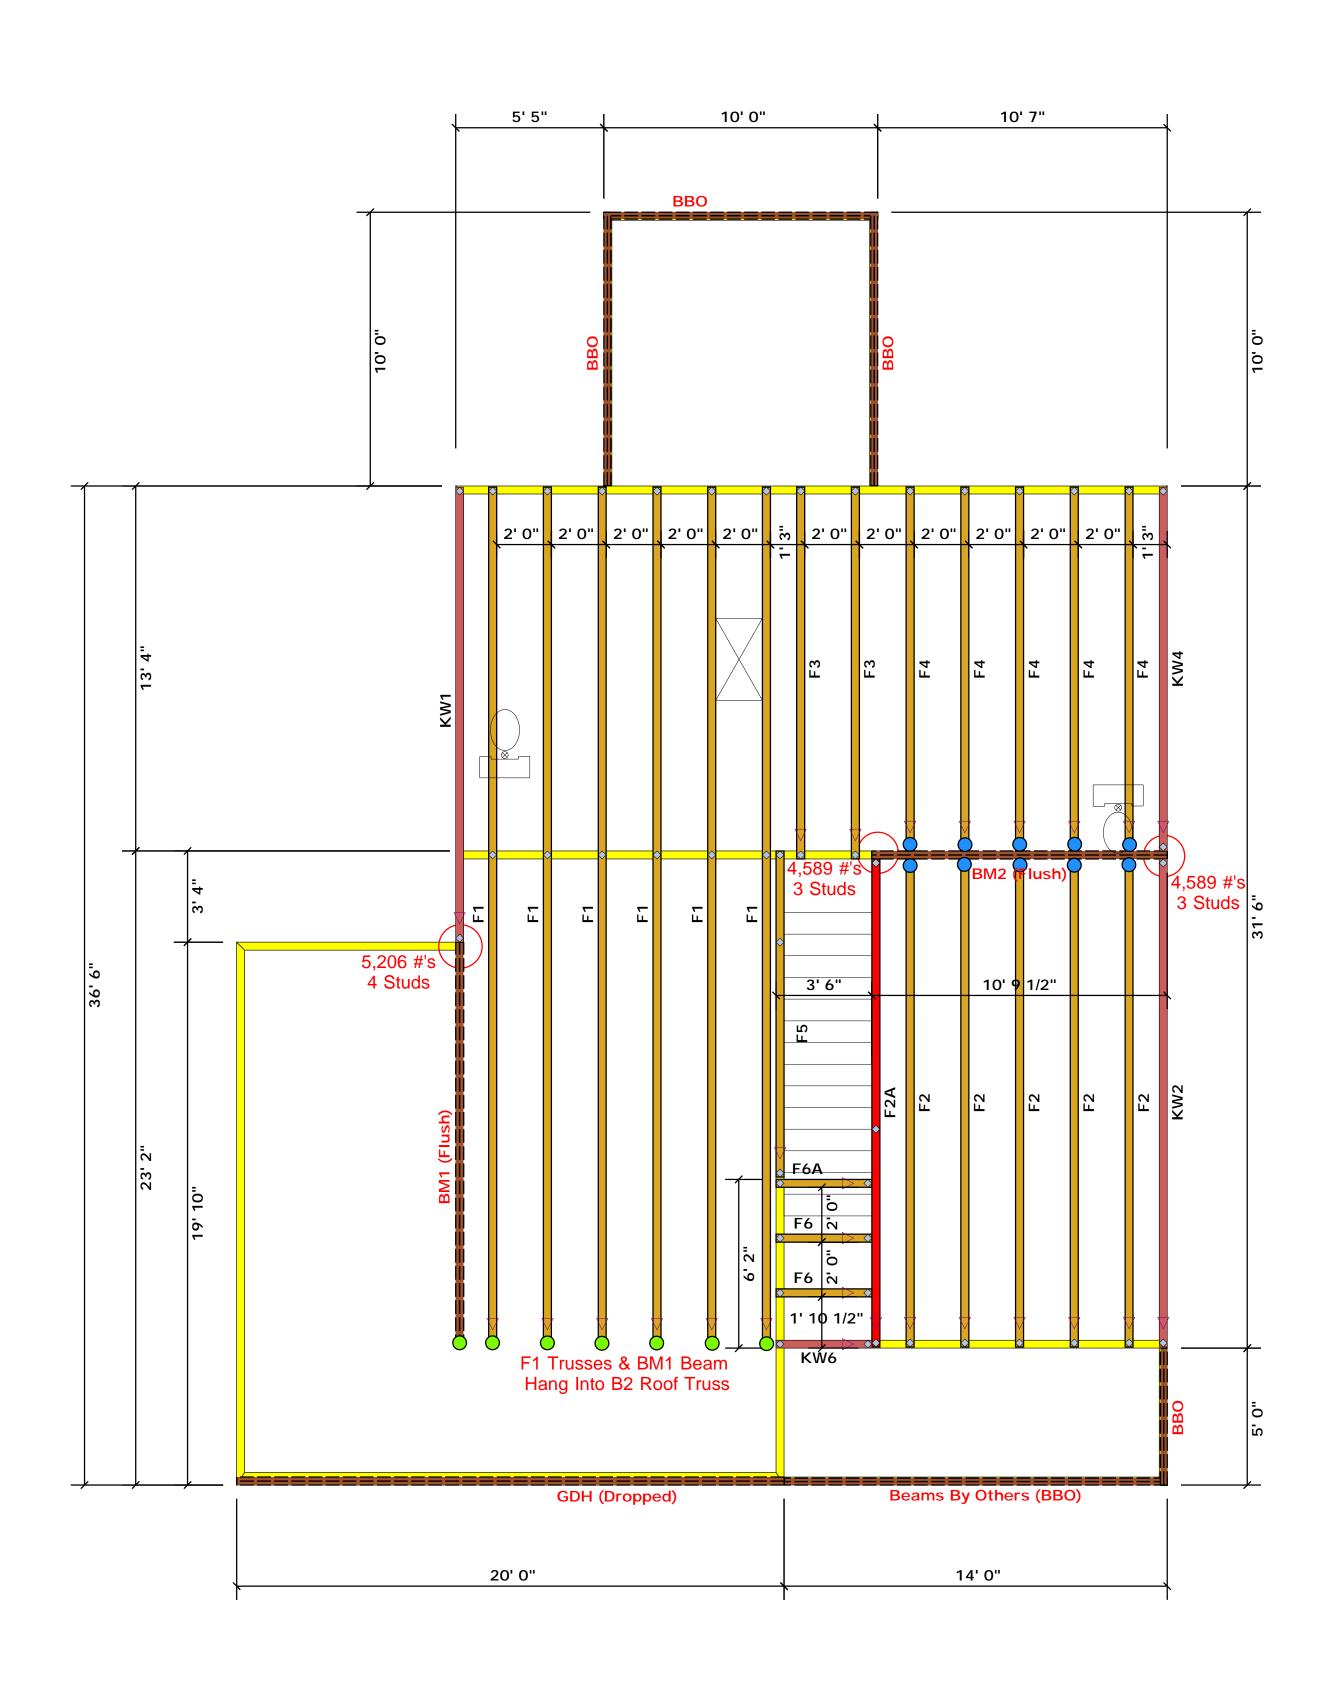

Connector Information Nail Information Supported Member Product Manuf Qty Header Truss HUS410 USP 10 16d/3-1/2" NA 16d/3-1/2" THD410 USP NA 16d/3-1/2" 10d/3"

Truss Placement Plan SCALE: NTS

▲ = Denotes Left End of Truss
(Reference Engineered Truss Drawing)

		Products			
PlotID	Length	Product	Plies	Net Qty	Fab Type
GDH (Dropped)	20' 0"	1-3/4"x 11-7/8" LVL Kerto-S	2	2	FF
BM1 (Flush)	15' 0"	1-3/4"x 16" LVL Kerto-S	2	2	FF
BM2 (Flush)	11' 0"	1-3/4"x 16" LVL Kerto-S	2	2	FF

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-- Denotes Reaction Greater than 3,000 lbs.

Reaction / # of Studs

LO.	AD (	CHART	FO	RЈ	ACK S	TUD	5				
(04556 CN 140455 8502 5(1) 4 (N))											
NU	MPCS C	# JACK 51				EVB SE					
		FE	ADER/8	71.70001 ~			~				
END REACTION (UT FU)	REQUESTUDS FOR CORN HEADER		(UL 41)	REQUESTUDS FOR CIPAN FEMORE		IND NIACTOON (UP TO)	REQUESTABLES FOR (4) MAY HEADER				
1700	1	2	550	1		3400	1				
3400	2	5	100	2		6800	2				
5100	3	7	650	3	1	10200	3				
6800	4	10	0030	4		13600	4				
8500	5	12	2750	5	1	17000	5				
10200	á	15	5300	6							
11900	7										
13600	8										
15300	9										

	BUILDER	Weaver Development	CITY / CO.	Lillington / Harnett	THI The: the b
	JOB NAME	Lot 4 Hales Farm	ADDRESS	NC 27 West	is re the d walls rega
	PLAN	Magnolia I I "C"	MODEL		Bear pres
	SEAL DATE	Seal Date	DATE REV.	/ /	( der foun than be re
	QUOTE #	Quote #	DRAWN BY	Christine Shivy	spec retai
-	JOB#	J0822-4191	SALES REP.	Lenny Norris	5



Bearing reactions less than or equal to 3000# are deemed to comply with the prescriptive Code requirements. The contractor shall refer to the attached Tables (derived from the prescriptive Code requirements) to determine the minimum foundation size and number of wood studs required to support reactions greater than 3000# but not greater than 15000#. A registered design professional shall be retained to design the support system for any reaction that exceeds those specified in the attached Tables. A registered design professional shall be retained to design the support system for all reactions that exceed 15000#.

ppport system for any reaction that exceeds those bles. A registered design professional shall be ort system for all reactions that exceed 15000#.


Christine Shivy

Christine Shivy

Reilly Road Industrial Park
Fayetteville, N.C. 28309
Phone: (910) 864-8787
Fax: (910) 864-4444

соттесн

ROOF & FLOOR TRUSSES & BEAMS

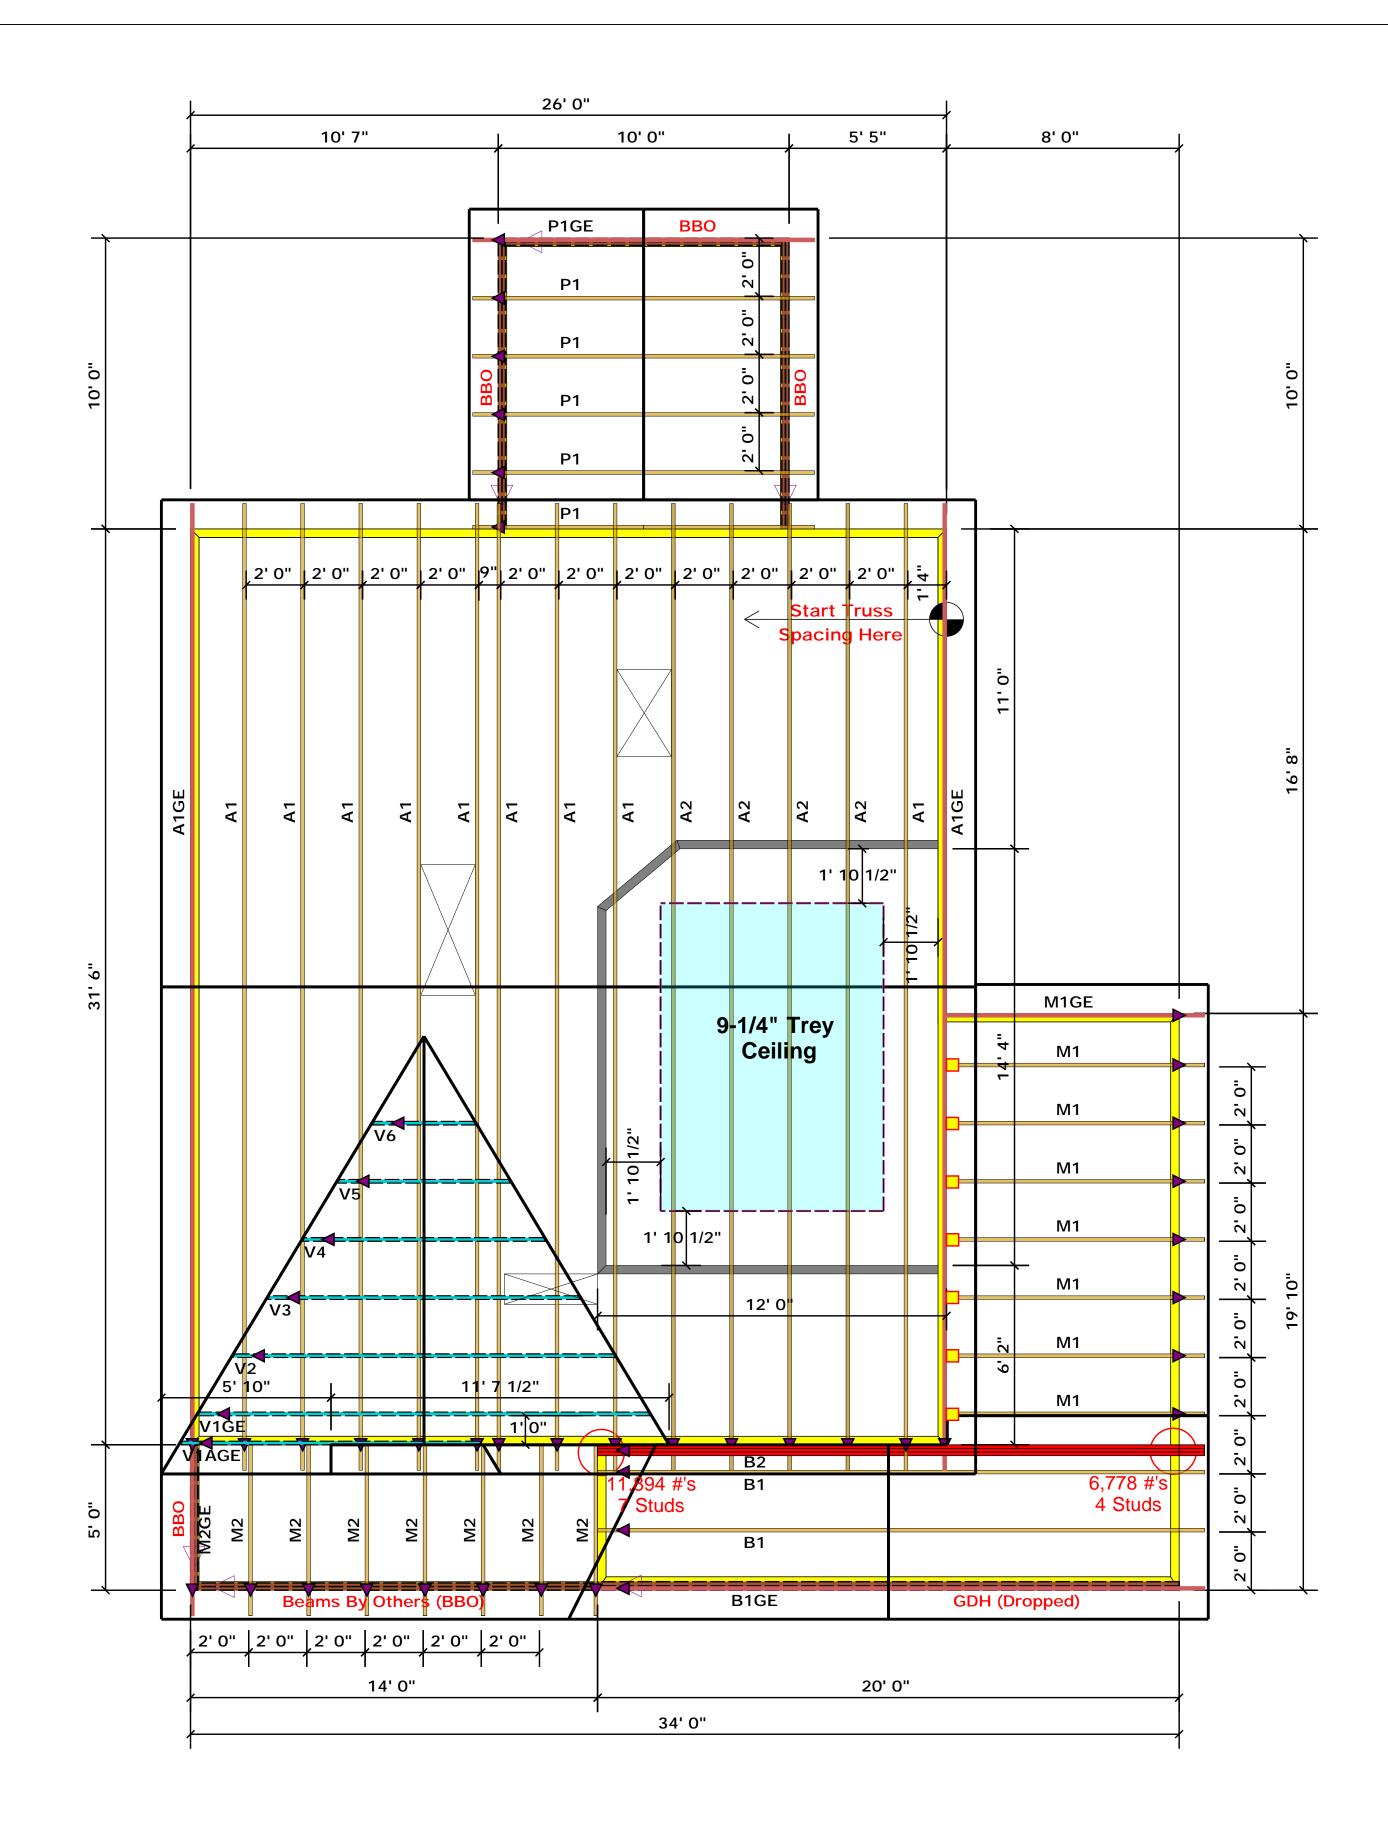

	Conne	Nail Info	ormation			
Sym	Product	Manuf	Qty	Supported Member	Header	Truss
	JUS24	USP	7	NA	10d/3"	10d/3"

▲ = Denotes Left End of Truss (Reference Engineered Truss Drawing)

## Truss Placement Plan SCALE: NTS

All Truss Reactions are Less than 3,000 lbs. Unless Noted Otherwise.



-- Denotes Reaction Greater than 3,000 lbs.
Reaction / # of Studs

	m	ANFIb o	N LABLES	s R502	5(1) A (	STUD	
NI.	majer i		HEADER/I			A CAD OF	
END REACTION (UF TO)	RQ bistudo Polt (1) NV HEADE?		SNE PENETION OF ALC	REQUESTUDS FOR CORN - EMBER		IND 8 ACTION (U* T0)	REQUESTABLE FOR (4) M.Y. HEADER
1700	1		2550	1		3400	1
3400	2		5100	2		6800	2
5100	3		7650	3		10200	3
6800	4		10200	4		13600	4
8500	5		12750	5		17000	5
10200	á		15300	6			
11900	7						
13600	8						
15300	9						

_		_		
BUILDER	Weaver Development	CITY / CO.	Lillington / Harnett	THIS IS A TRUSS PL These trusses are desig the building design at the sheets for each truss des
JOB NAME	Lot 4 Hales Farm	ADDRESS	NC 27 West	is responsible for tempor the overall structure. The walls, and columns is the regarding bracing, consu
PLAN	Magnolia I I "C"	MODEL	Roof	or online @ sbcindustry.  Bearing reactions less prescriptive Code requ
SEAL DATE	Seal Date	DATE REV.	/ /	( derived from the pres foundation size and nu than 3000# but not gre- be retained to design to
QUOTE #		DRAWN BY	Christine Shivy	specified in the attache retained to design the
JOB #	J0822-4190	SALES REP.	Lenny Norris	Signature



Bearing reactions less than or equal to 3000# are deemed to comply with the prescriptive Code requirements. The contractor shall refer to the attached Tables ( derived from the prescriptive Code requirements ) to determine the minimum foundation size and number of wood studs required to support reactions greater than 3000# but not greater than 15000#. A registered design professional shall be retained to design the support system for any reaction that exceeds those specified in the attached Tables. A registered design professional shall be retained to design the support system for all reactions that exceed 15000#.

Christine Shivy

**Christine Shivy** 


TRUSSES & BEAMS

Reilly Road Industrial Park
Fayetteville, N.C. 28309
Phone: (910) 864-8787

Fax: (910) 864-4444

соттесн

**ROOF & FLOOR** 

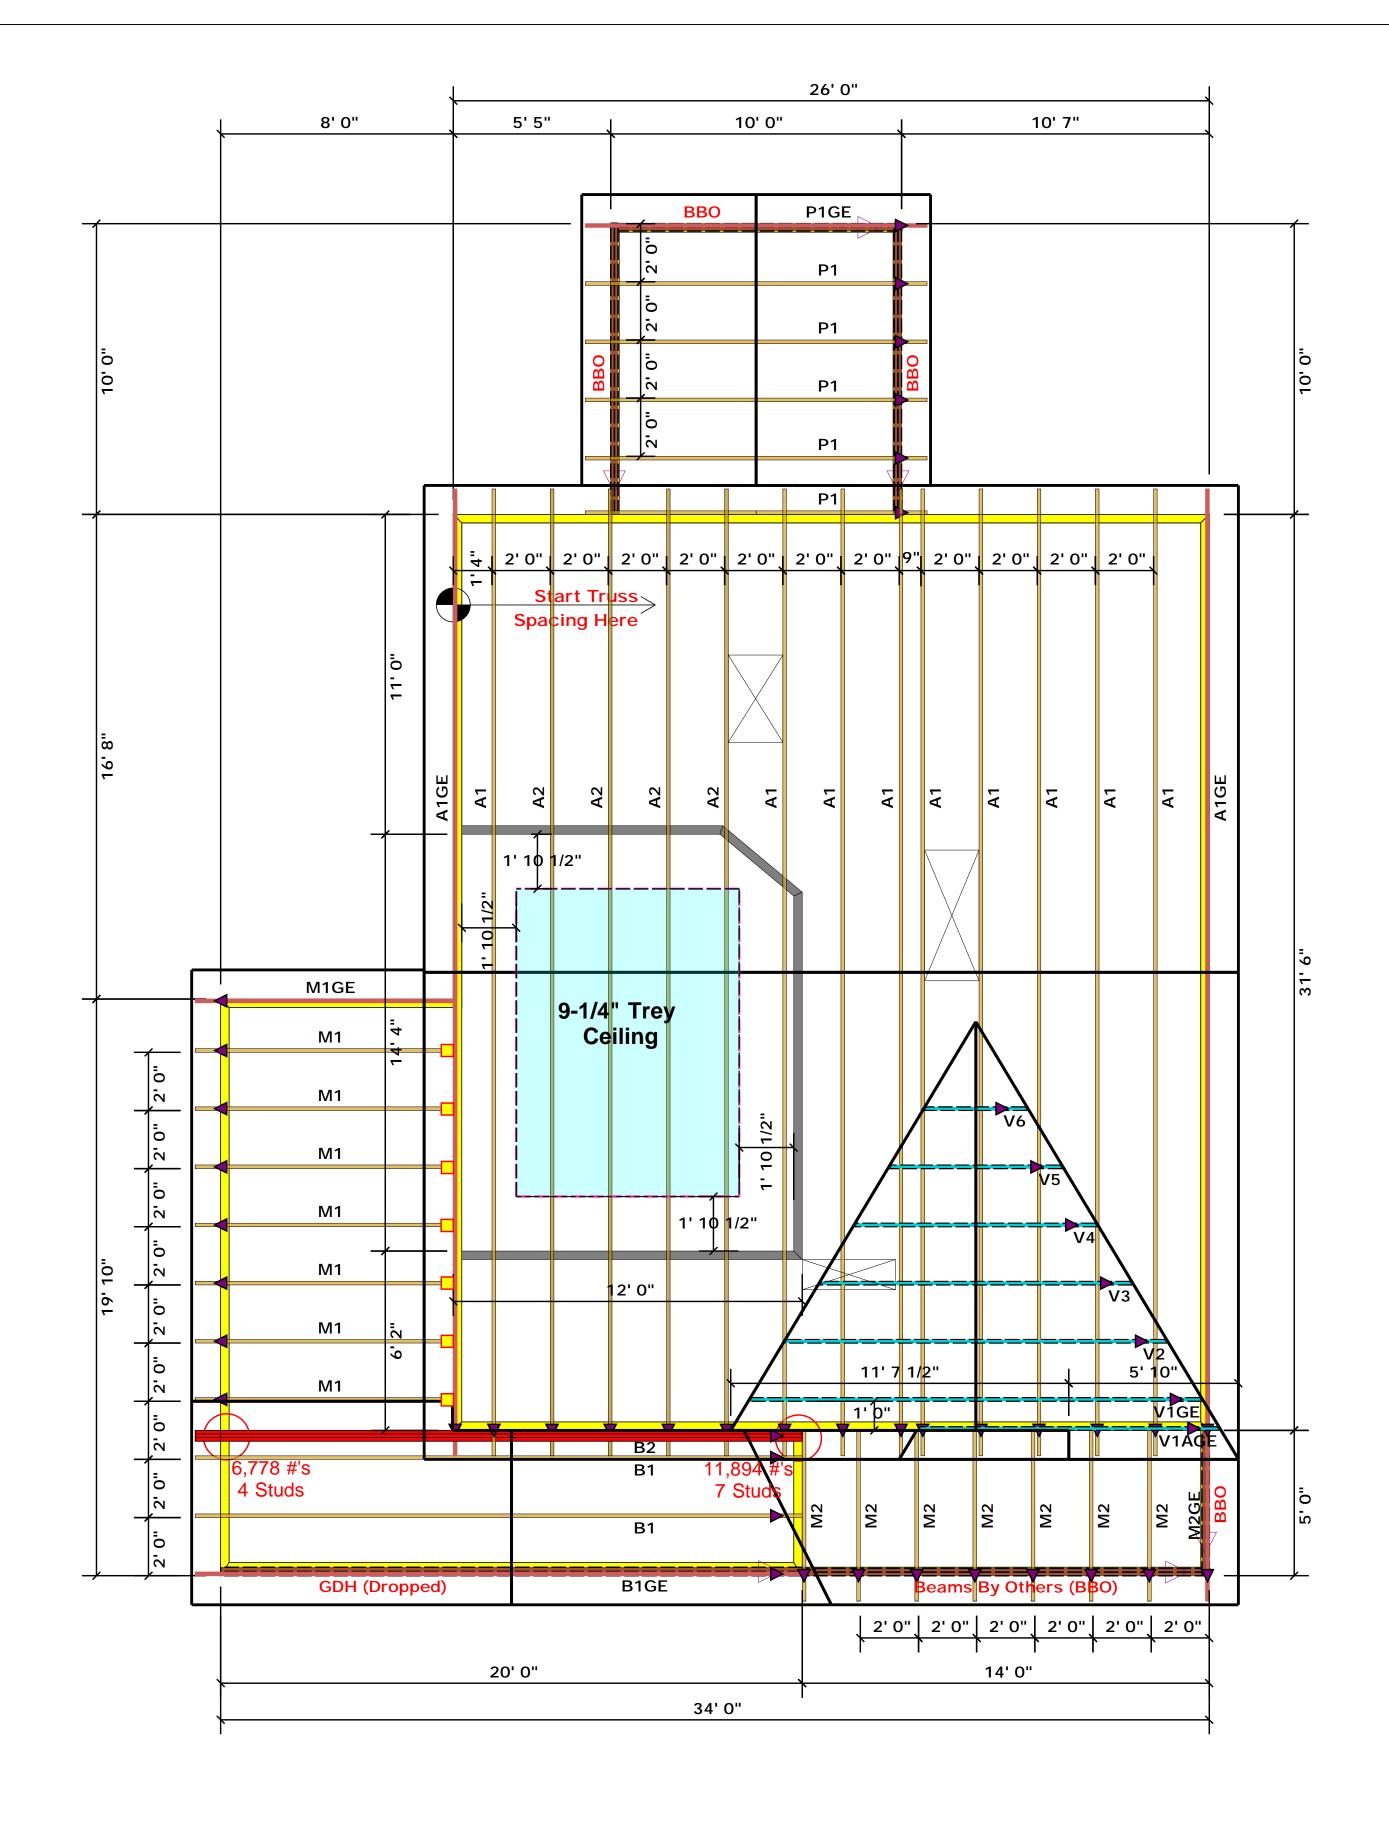

	Conne	Nail Info	ormation			
Sym	Product	Header	Truss			
	JUS24	USP	7	NA	10d/3"	10d/3"

▲ = Denotes Left End of Truss (Reference Engineered Truss Drawing)

# Truss Placement Plan SCALE: NTS


All Truss Reactions are Less than 3,000 lbs. Unless Noted Otherwise.



-- Denotes Reaction Greater than 3,000 lbs. Reaction / # of Studs

LO	AD (	CHA	RT FO	R J	4CK STUD	5
MLA			on i ables Cotudo a Peadera	Султа	CO @ CA CNO OF	
END REACTION (OT FU)	SQ DISTUTES FOR COMPANY HEADER		MOTE PENDENCIEDA (DE AU)	REQUESTABLE FOR CORN - EMBER	END NEACTOON (0° 10)	REQUESTABLE FOR
1700	1		2550	1	3400	1
3400	2		5100	2	6600	2
5100	3		7650	3	10200	3
6800	4		10200	4	13600	4
8500	5		12750	5	17000	5
10200	á		15300	6		
11900	7					
13600	8					
15300	9					

BUILDER	Weaver Development	CITY / CO.	Lillington / Harnett	t
JOB NAME	Lot 4 Hales Farm	ADDRESS	NC 27 West	i t v
PLAN	Magnolia I I "C"	MODEL	Roof	E F
SEAL DATE	Seal Date	DATE REV.	/ /	f t
QUOTE #		DRAWN BY	Christine Shivy	r
JOB#	J0822-4190	SALES REP.	Lenny Norris	

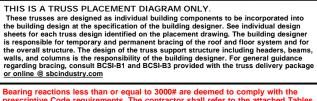

**TRUSSES & BEAMS** Reilly Road Industrial Park Fayetteville, N.C. 28309 Christine Shivy Phone: (910) 864-8787 Fax: (910) 864-4444 **Christine Shivy** 

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