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WEAVER HOMES CAROLINA COLLECTION MAGNOLIA-II DRIVE LEFT

DATE: FEBRUARY 19, 2021

REV.:

SCALE: 1/4" = 1'-0"


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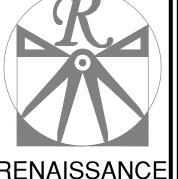
ENGINEERED BY:

REVIEWED BY:

FIRST FLOOR PLAN

A-4



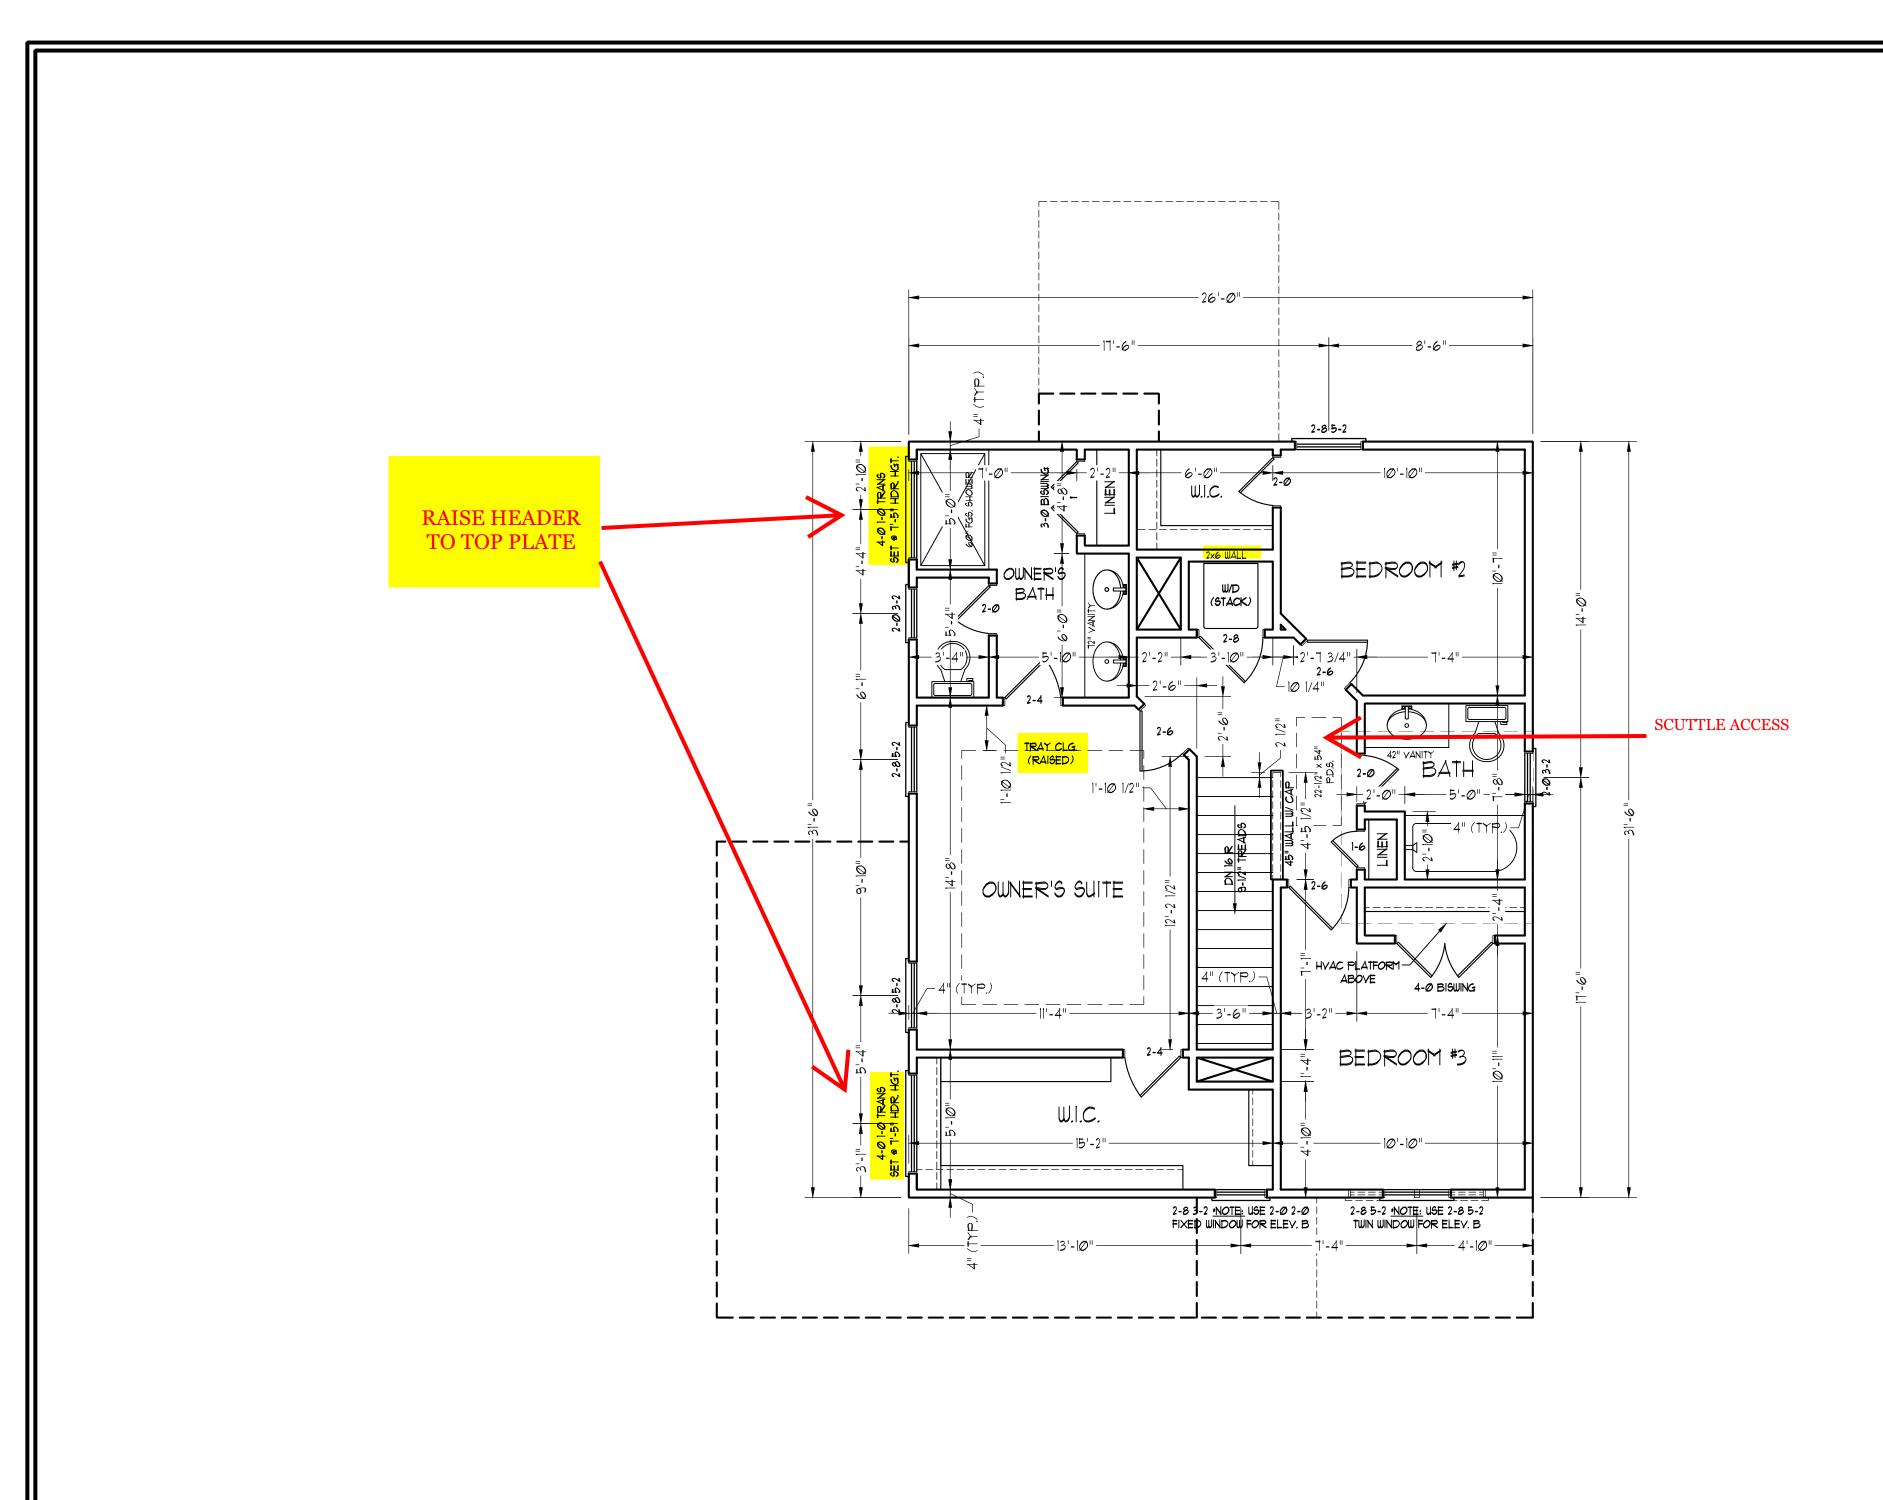

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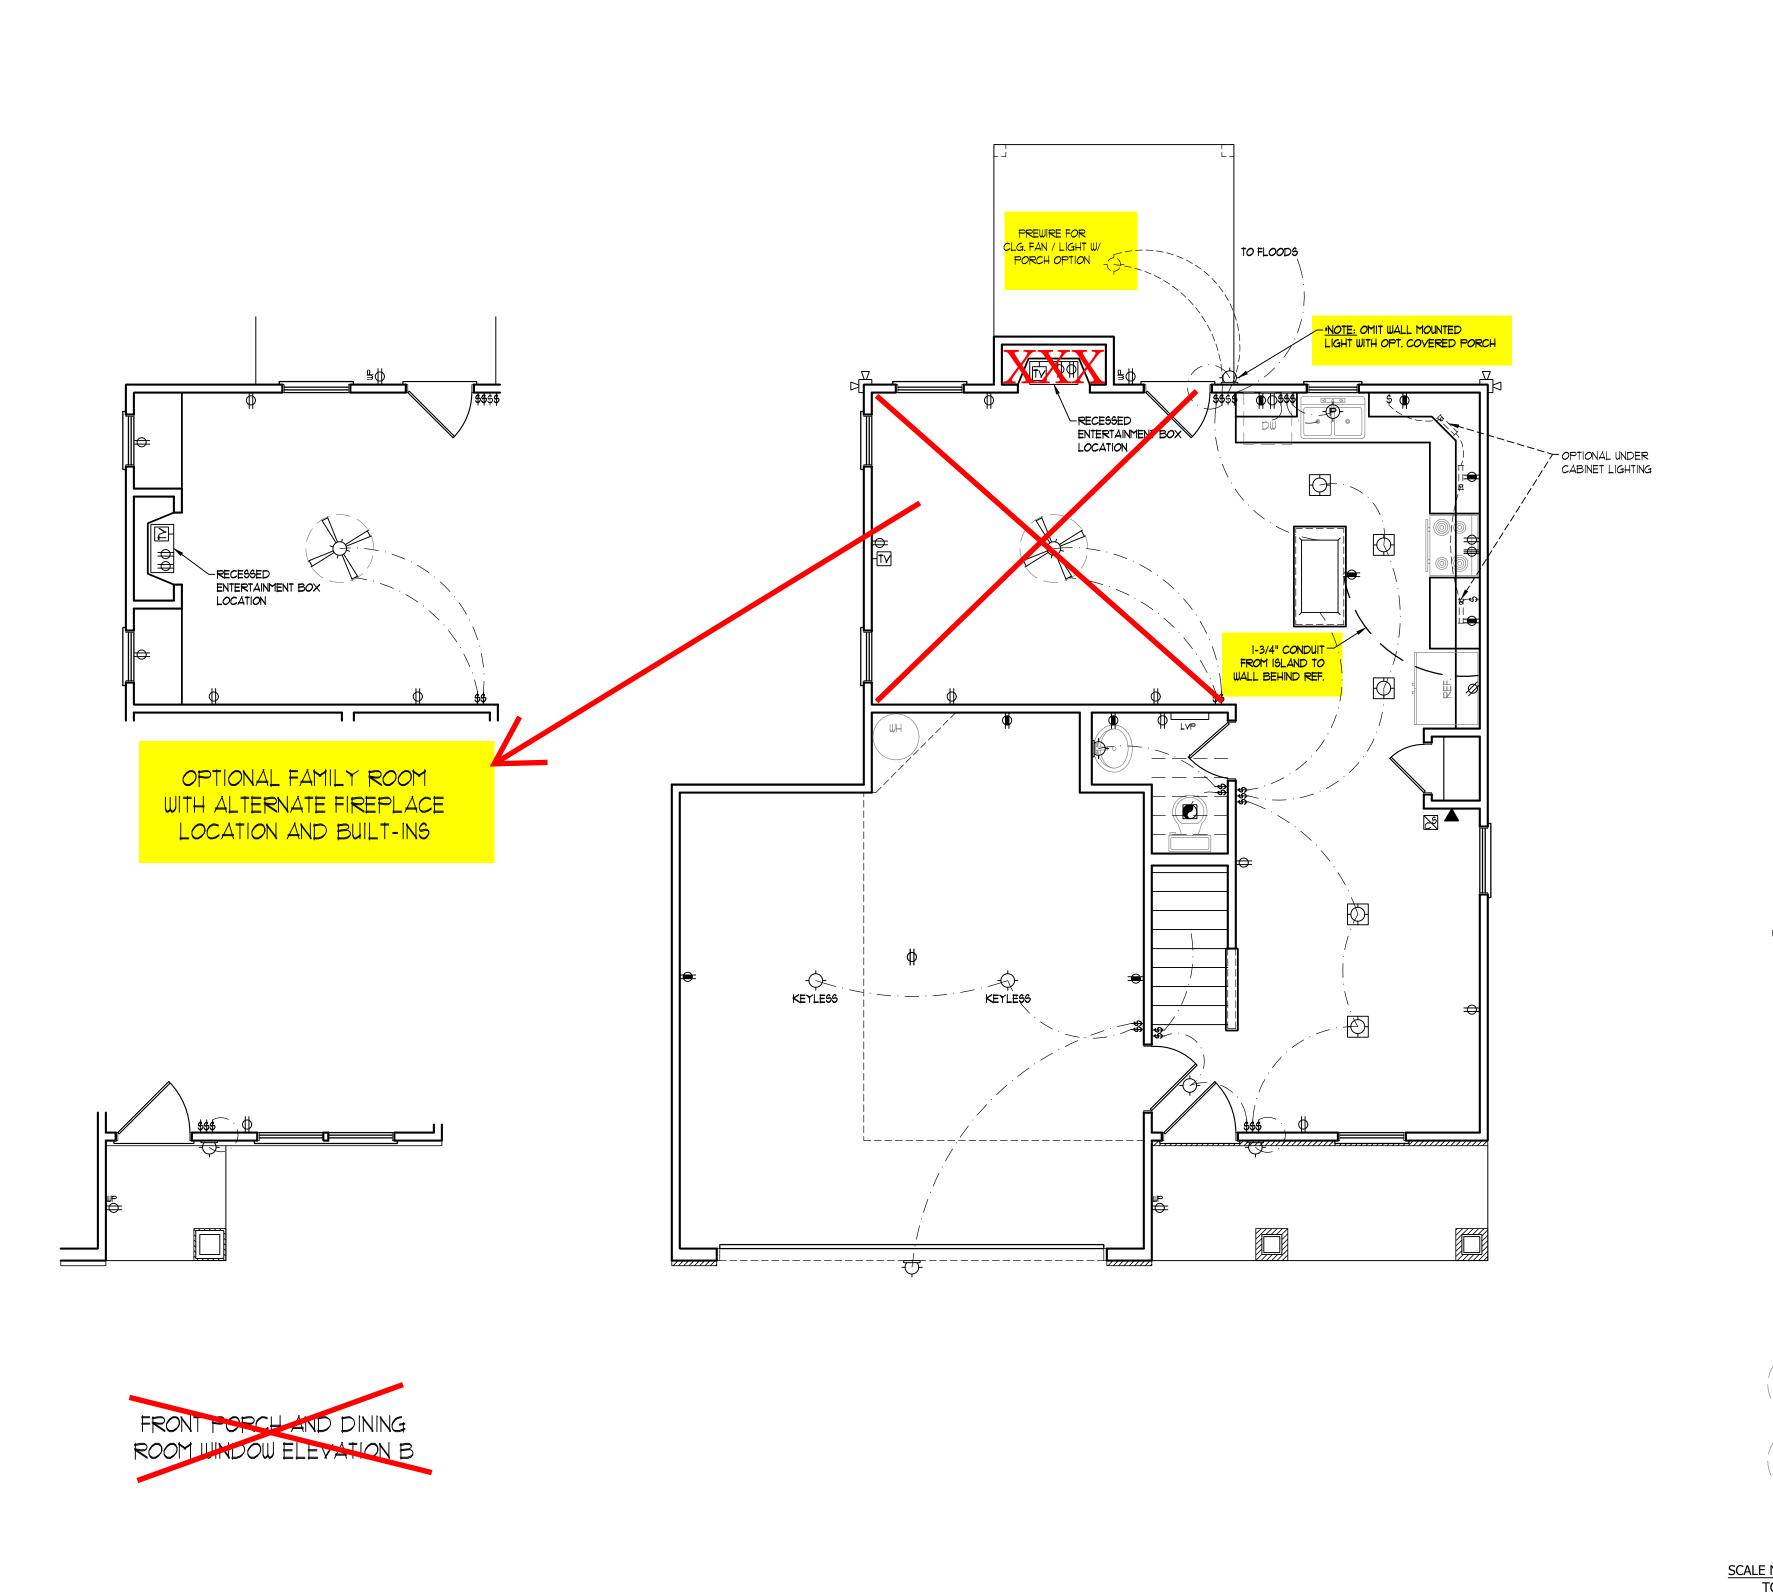
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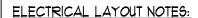
REVIEWED BY:

SECOND FLOOR PLAN

A-5

SCALE NOTE: 18x24 PRINTS ARE TO SCALE AS NOTED. 11x17 PRINTS ARE NOT TO SCALE





- I.) BLOCK AND WIRE FOR ALL CELING FANS PER PLAN.
- 2.) VANITY LIGHTS TO BE SET 9 90" AFF. (TYP.)
- 3.) ADDITIONAL EXTERIOR OUTLETS REQUIRED BY CODE TO BE LOCATED BY ELECTRICIAN.
- 4.) PLACE SWITCHES 8" (MIN.) FROM ROUGH OPENINGS.

ELECTRICAL LEGEND

- ⇒ IIØ ∨ OUTLET
- ₩ IIØ Y GFI OUTLET
- ⇒ 110 V SWITCHED OUTLET
- BB IIØ V BASEBOARD OUTLET
- 4-PLEX
- COUNTER OR FLOOR MOUNTED
- COUNTER OR FLOOR MOUNTED 110V GFI
- ₩EATHERPROOF
- **⇒** 22*0* ∨ *O*UTLET
- Ø IIØ Y DEDICATED CIRCUIT
- # 220 Y DEDICATED CIRCUIT
- TIS I DEDICATED CITICAL
- SPECIAL PURPOSE (240 V, ETC.)
- WALL MOUNT LIGHT
- -CEILING MOUNT LIGHT
- PENDANT LIGHT

 RECESSED CAN LIGHT
- MINI CAN LIGHT
- EYEBALL LIGHT
- FLUORESCENT LIGHT
- undercabinet light
 - Undercadineilio 7
- FLOOD LIGHT
- SWITCH

 DIMMER SWITCH
- •
- TELEPHONE
- △ DATA
- TELEPHONE AND DATA
- TV- TV CONNECTION
- M- TV/ DATA
- CD- CONDUIT FOR COMPONENT WIRING
- SP SPEAKER
- 110 V SMOKE/ CM DETECTOR
- 6D 110 Y SMOKE DETECTOR
- EXHAUST FAN








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HOUSE ON LOT WILL BE DETERMINE
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WEAVER HOMES CAROLINA COLLECTION MAGNOLIA-II DRIVE LEFI

DATE: FEBRUARY 19, 2021

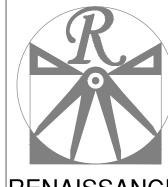REV.:

SCALE: 1/4" = 1'-0"

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ENGINEERED BY:


REVIEWED BY:

FIRST FLOOR ELECTRICAL

E-1

PLAN

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ELECTRICAL LAYOUT NOTES:

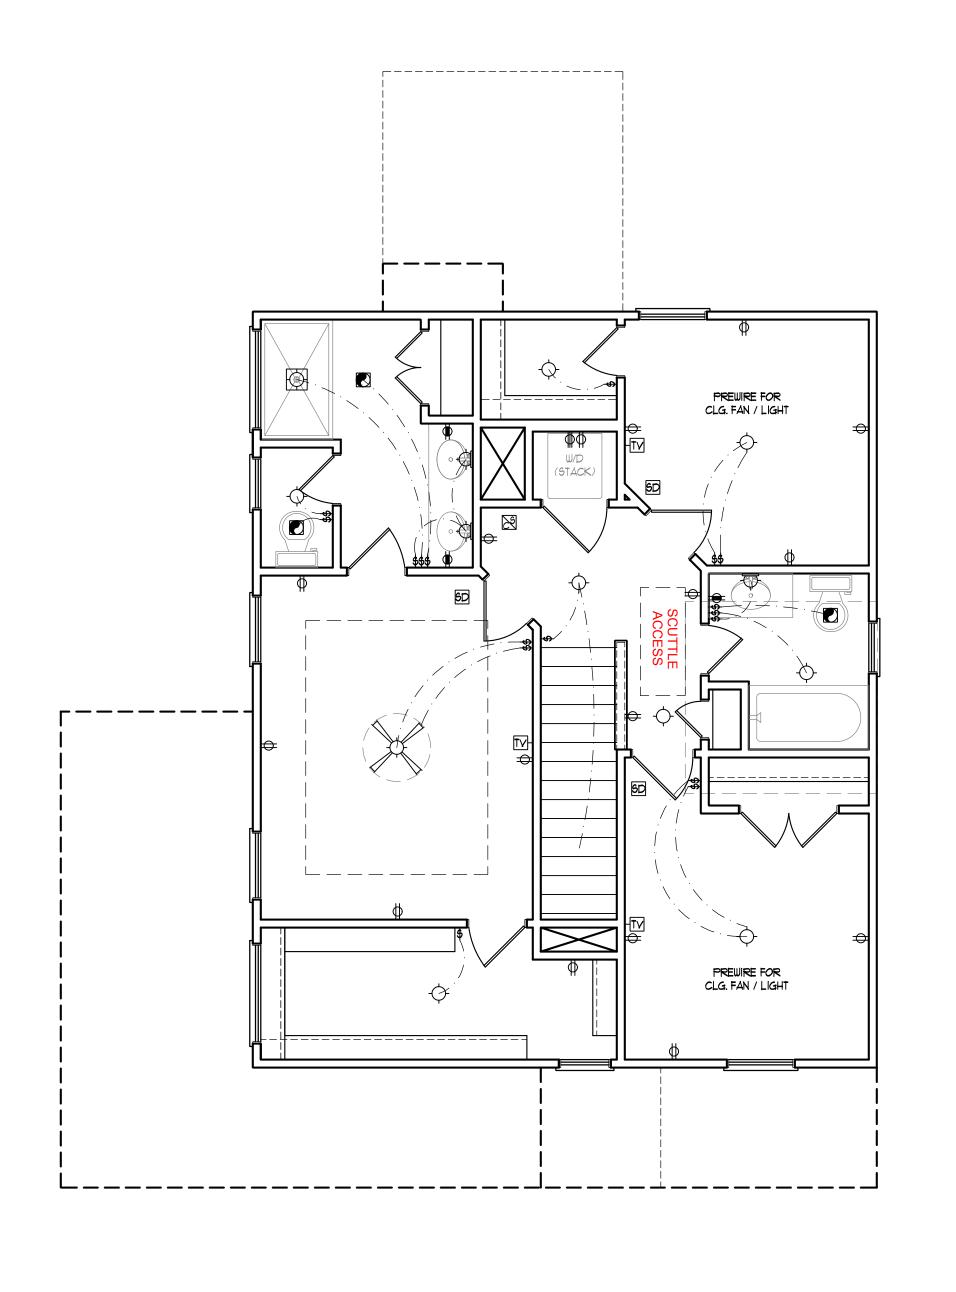- 1.) BLOCK AND WIRE FOR ALL CELING FANS PER PLAN.
- 2.) VANITY LIGHTS TO BE SET @ 90" A.F.F. (TYP.)
- 3.) ADDITIONAL EXTERIOR OUTLETS REQUIRED BY CODE TO BE LOCATED BY ELECTRICIAN.
- 4.) PLACE SWITCHES 8" (MIN.) FROM ROUGH OPENINGS.

ELECTRICAL LEGEND

- ⇒ IIØ Y OUTLET
- € 110 Y GFI OUTLET
- → 110 V SWITCHED OUTLET
- BB IIØ V BASEBOARD OUTLET
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- WALL MOUNT LIGHT
- -P- PENDANT LIGHT RECESSED CAN LIGHT
- MINI CAN LIGHT
- EYEBALL LIGHT

FLUORESCENT LIGHT

undercabinet light

FLOOD LIGHT

SWITCH

\$D DIMMER SWITCH

▲ TELEPHONE

△ DATA

TELEPHONE AND DATA

TV- TV CONNECTION

CD- CONDUIT FOR COMPONENT WIRING

SP SPEAKER

110 V SMOKE/ CO DETECTOR

SD 110 Y SMOKE DETECTOR

EXHAUST FAN

LOW VOLTAGE PANEL ALARM PANEL



SCALE NOTE: 18x24 PRINTS ARE TO SCALE AS NOTED. 11x17 PRINTS ARE NOT TO SCALE



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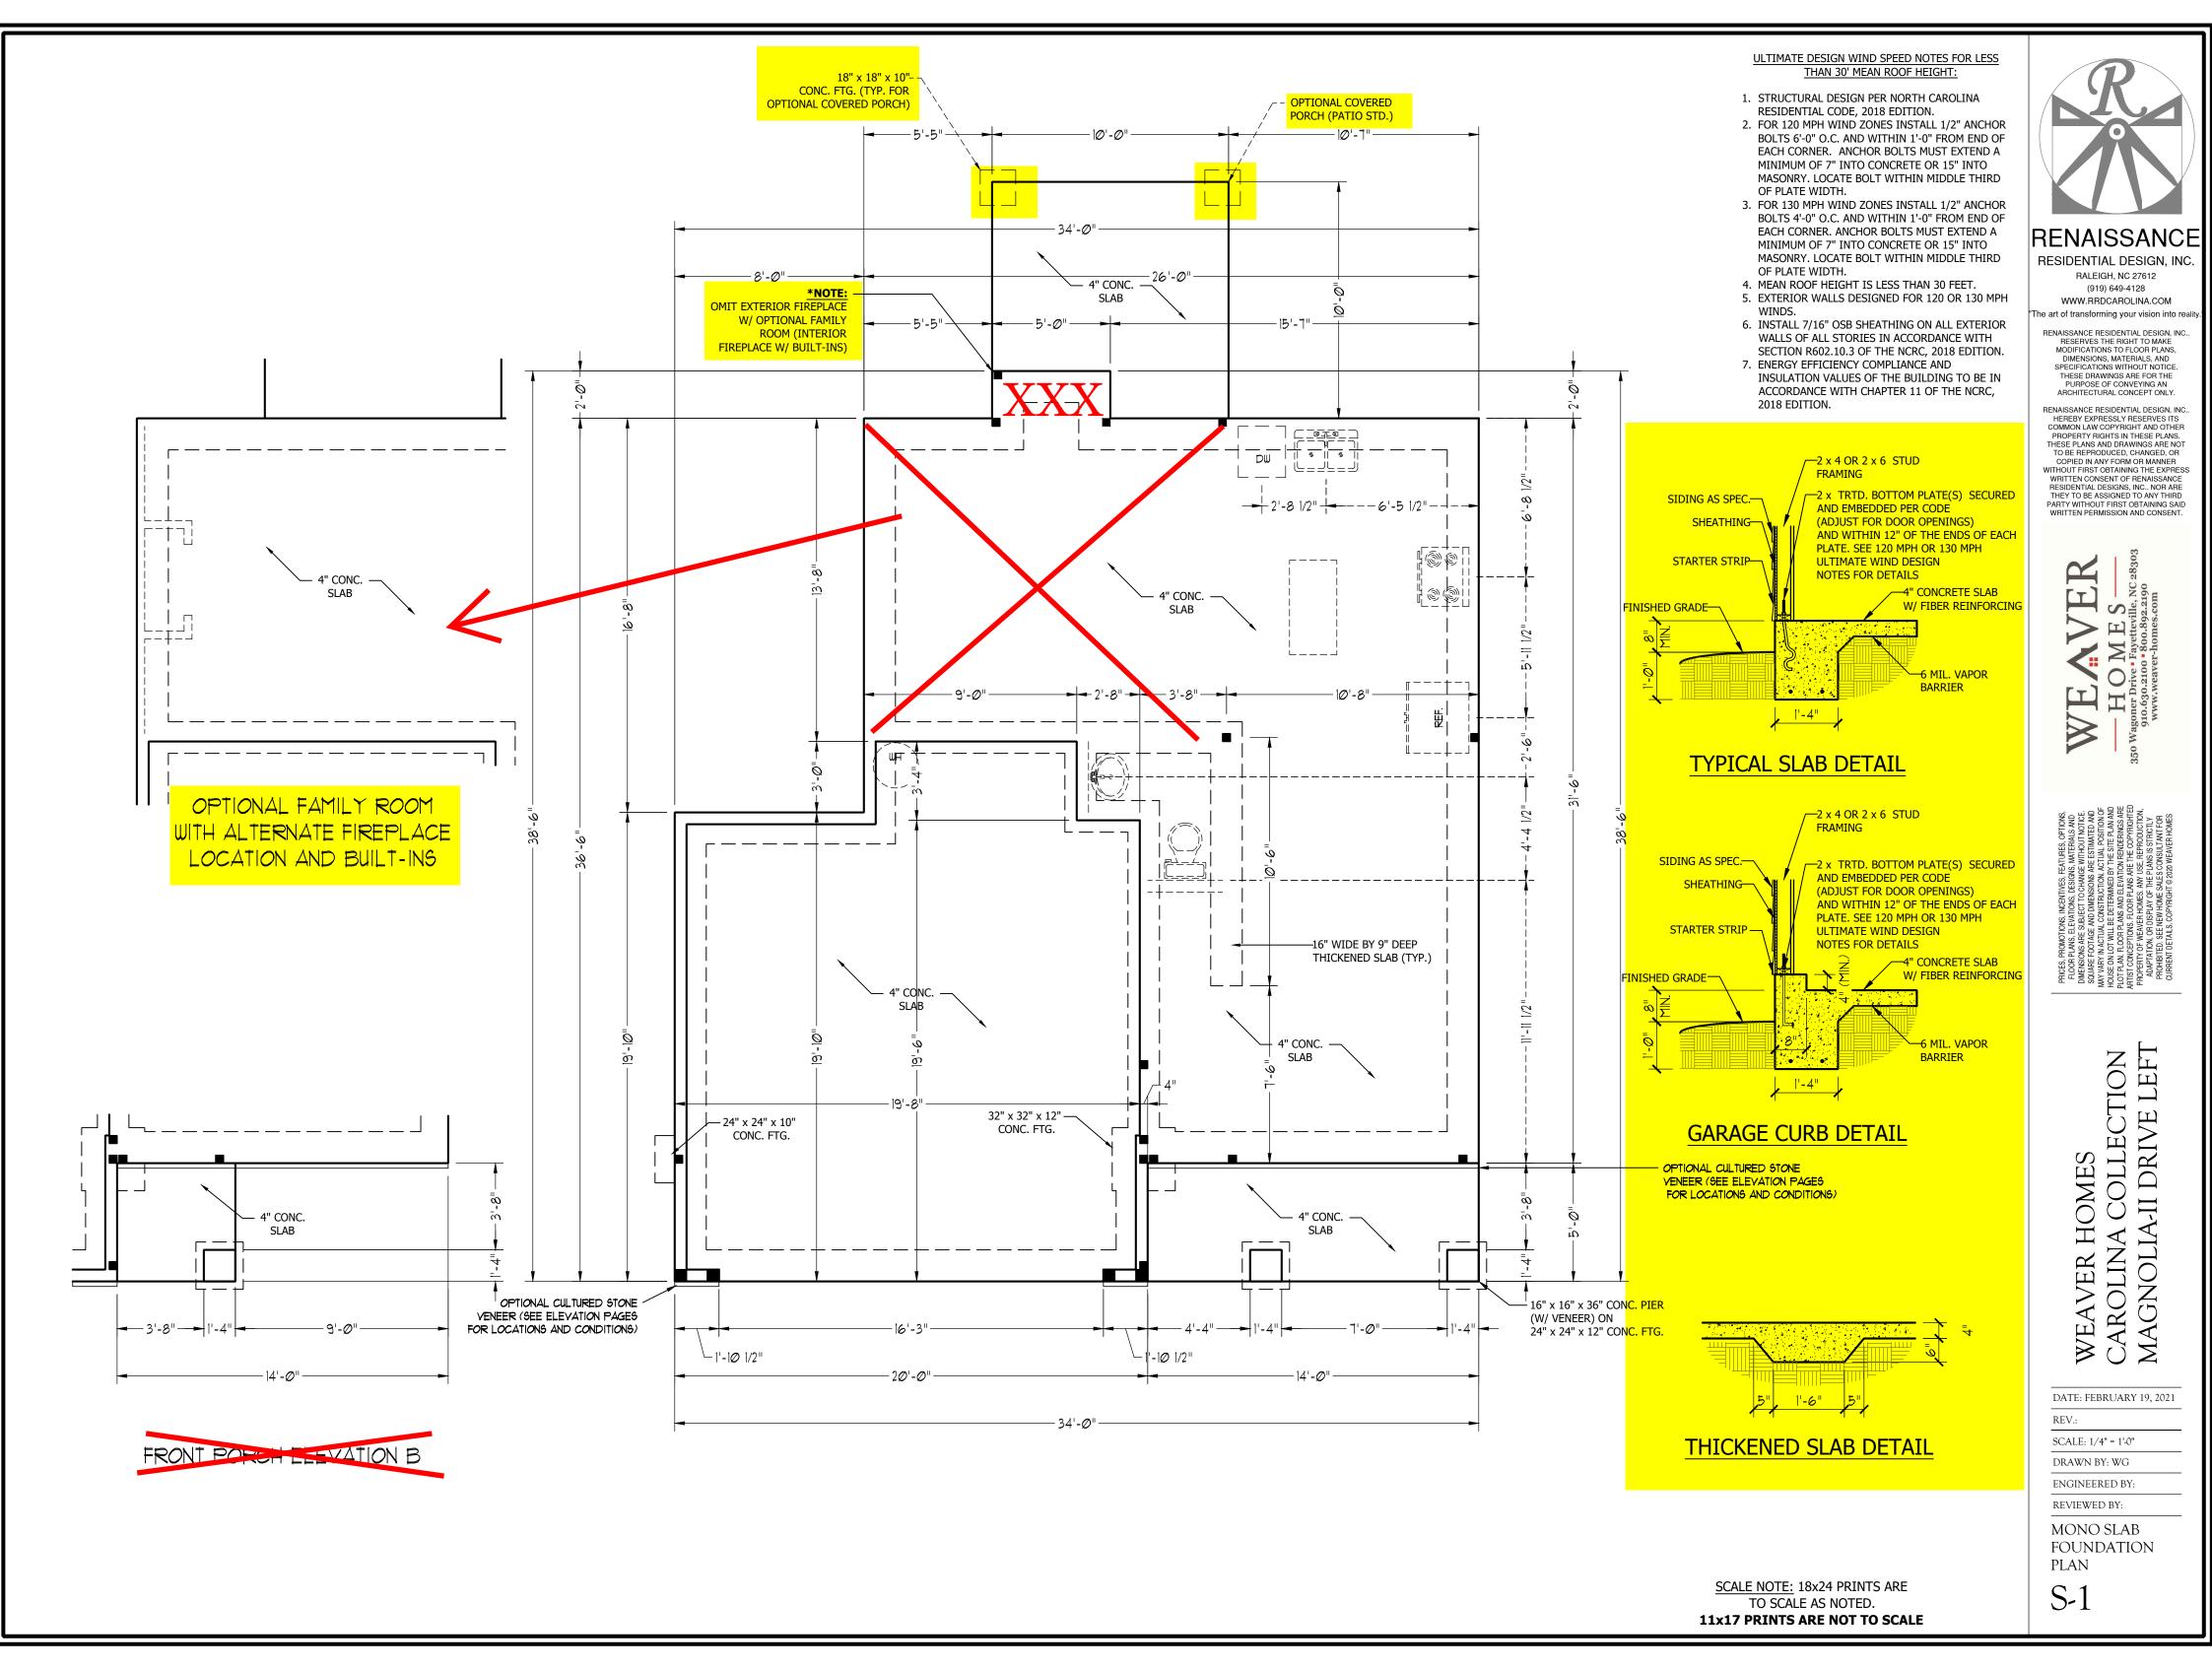
SCALE: 1/4" = 1'-0"


DRAWN BY: WG ENGINEERED BY:

REVIEWED BY: SECOND FLOOR ELCTRICAL

E-2

PLAN



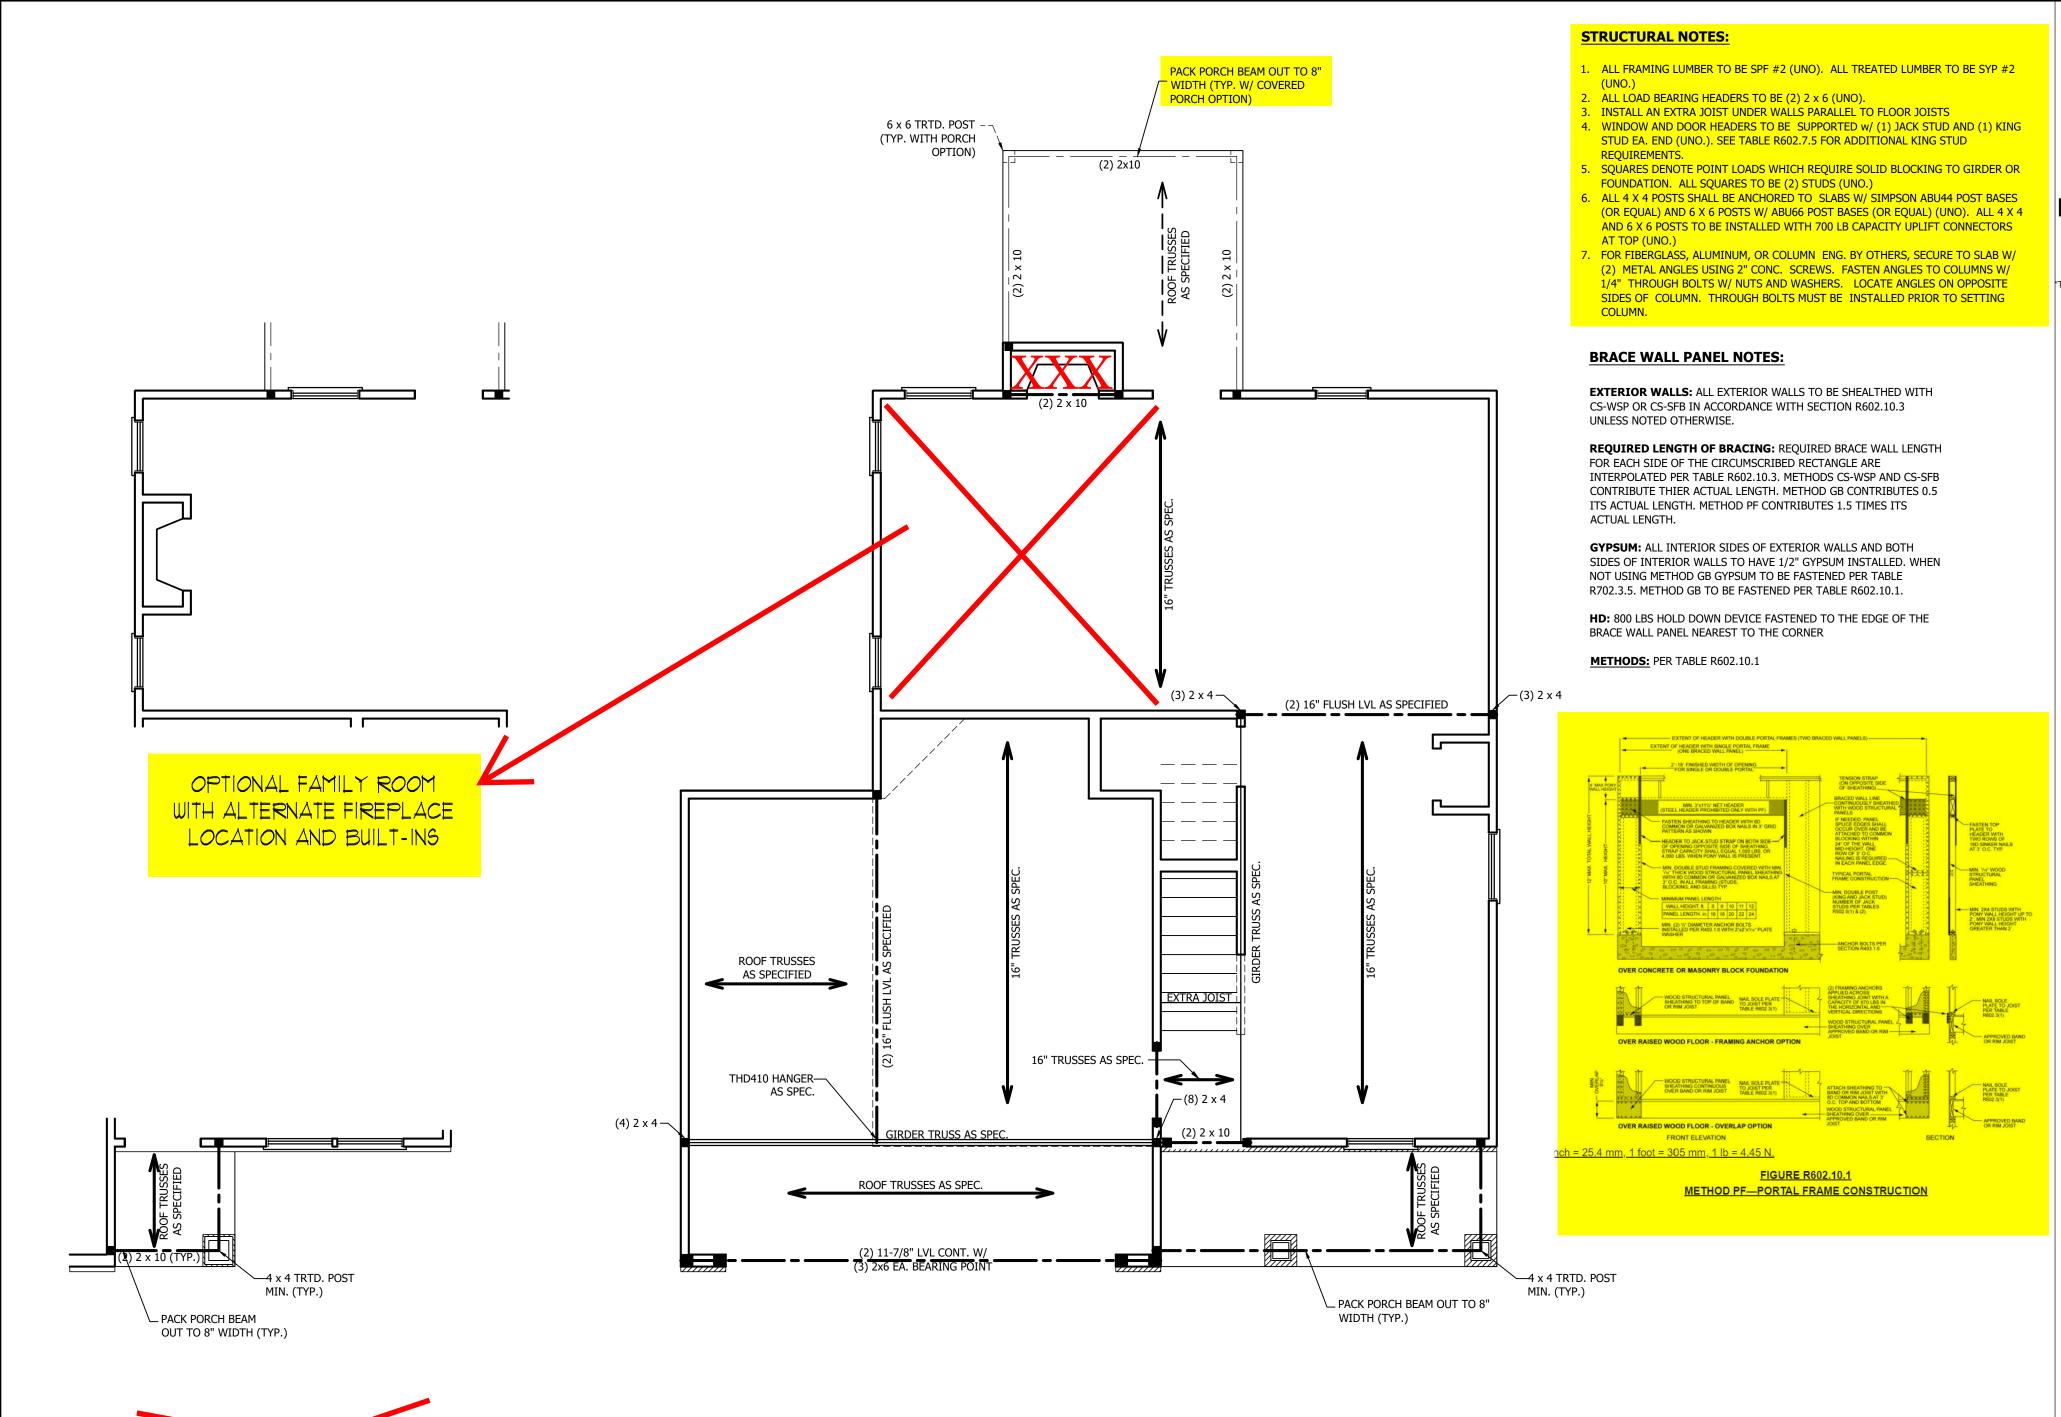

SCALE NOTE: 18x24 PRINTS ARE
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11x17 PRINTS ARE NOT TO SCALE

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DATE: FEBRUARY 19, 2021

REV.:

SCALE: 1/4" = 1'-0"

DRAWN BY: WG
ENGINEERED BY:

REVIEWED BY:

SECOND FLOOR FRAMING PLAN

S-2

ROOM WINDOW ELEVATION B

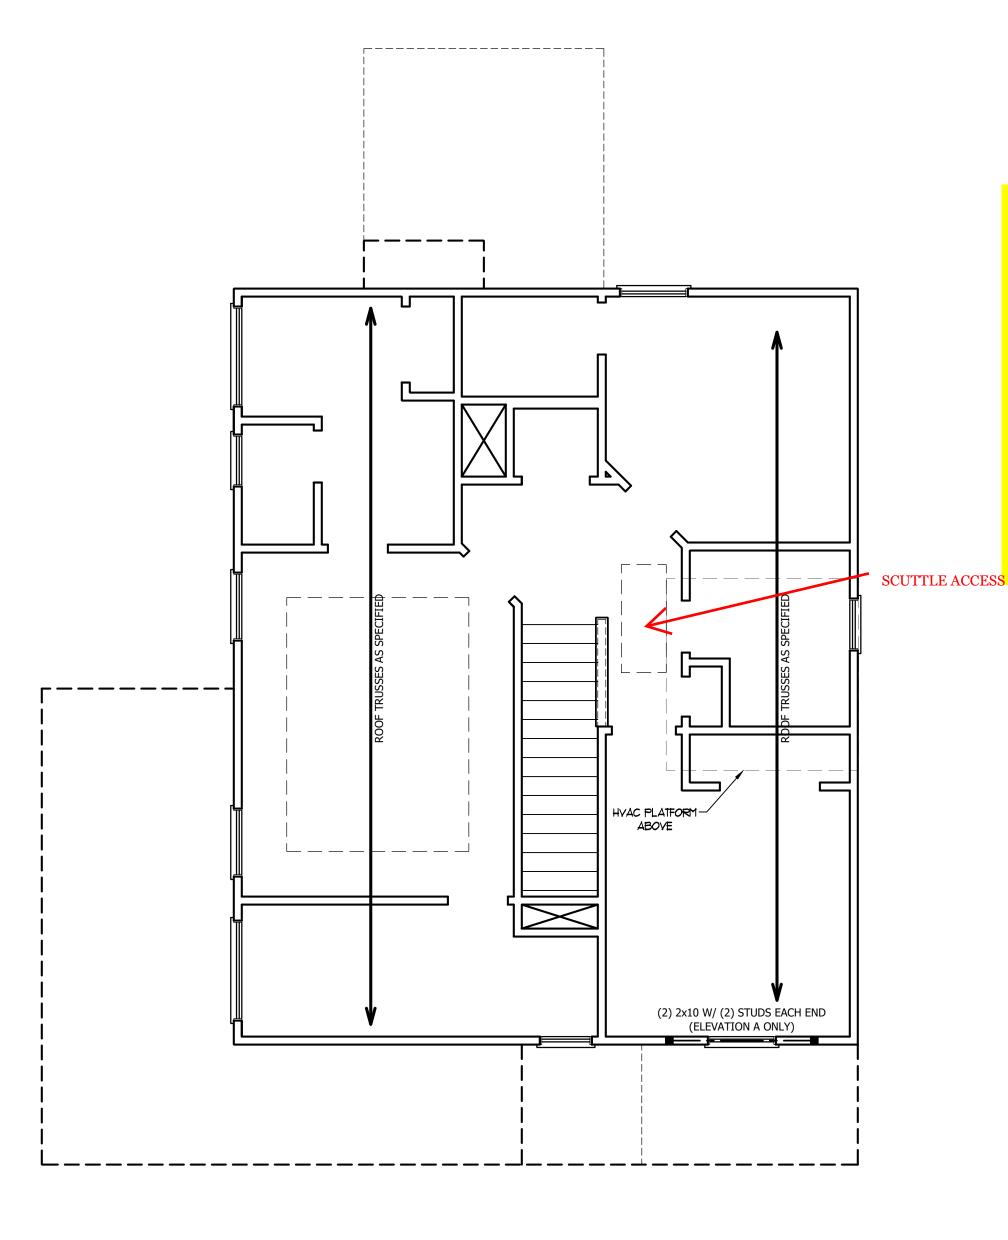


TABLE R602.7.5 MINIMUM NUMBER OF FULL HEIGHT STUDS AT EACH END OF HEADERS IN EXTERIOR WALLS

		_					
HEADER SPAN (FEET)	MAXIMUM STUD SPACING (INCHE (PER TABLE R602.3(5)						
(== .)	16	24					
UP TO 3'	1	1					
4'	2	1					
8'	3	2					
12'	5	3					
16'	6	4					

STRUCTURAL NOTES:

- 1. ALL FRAMING LUMBER TO BE SPF #2 (UNO). ALL TREATED LUMBER TO BE SYP #2 (UNO.)
- 2. ALL LOAD BEARING HEADERS TO BE (2) 2 x 6 (UNO).
- 3. WINDOW AND DOOR HEADERS TO BE SUPPORTED w/ (1) JACK STUD AND (1) KING STUD EA. END (UNO.). SEE TABLE R602.7.5 FOR ADDITIONAL KING STUD REQUIREMENTS.
- 4. SQUARES DENOTE POINT LOADS WHICH REQUIRE SOLID BLOCKING TO GIRDER OR FOUNDATION. ALL SQUARES TO BE (2) STUDS (UNO.)

DSP - DOUBLE STUD POCKET TSP - TRIPLE STUD POCKET

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SCALE: 1/4" = 1'-0" DRAWN BY: WG


ENGINEERED BY:

REVIEWED BY:

ATTIC FLOOR FRAMING PLAN

S-3

SCALE NOTE: 18x24 PRINTS ARE TO SCALE AS NOTED. 11x17 PRINTS ARE NOT TO SCALE

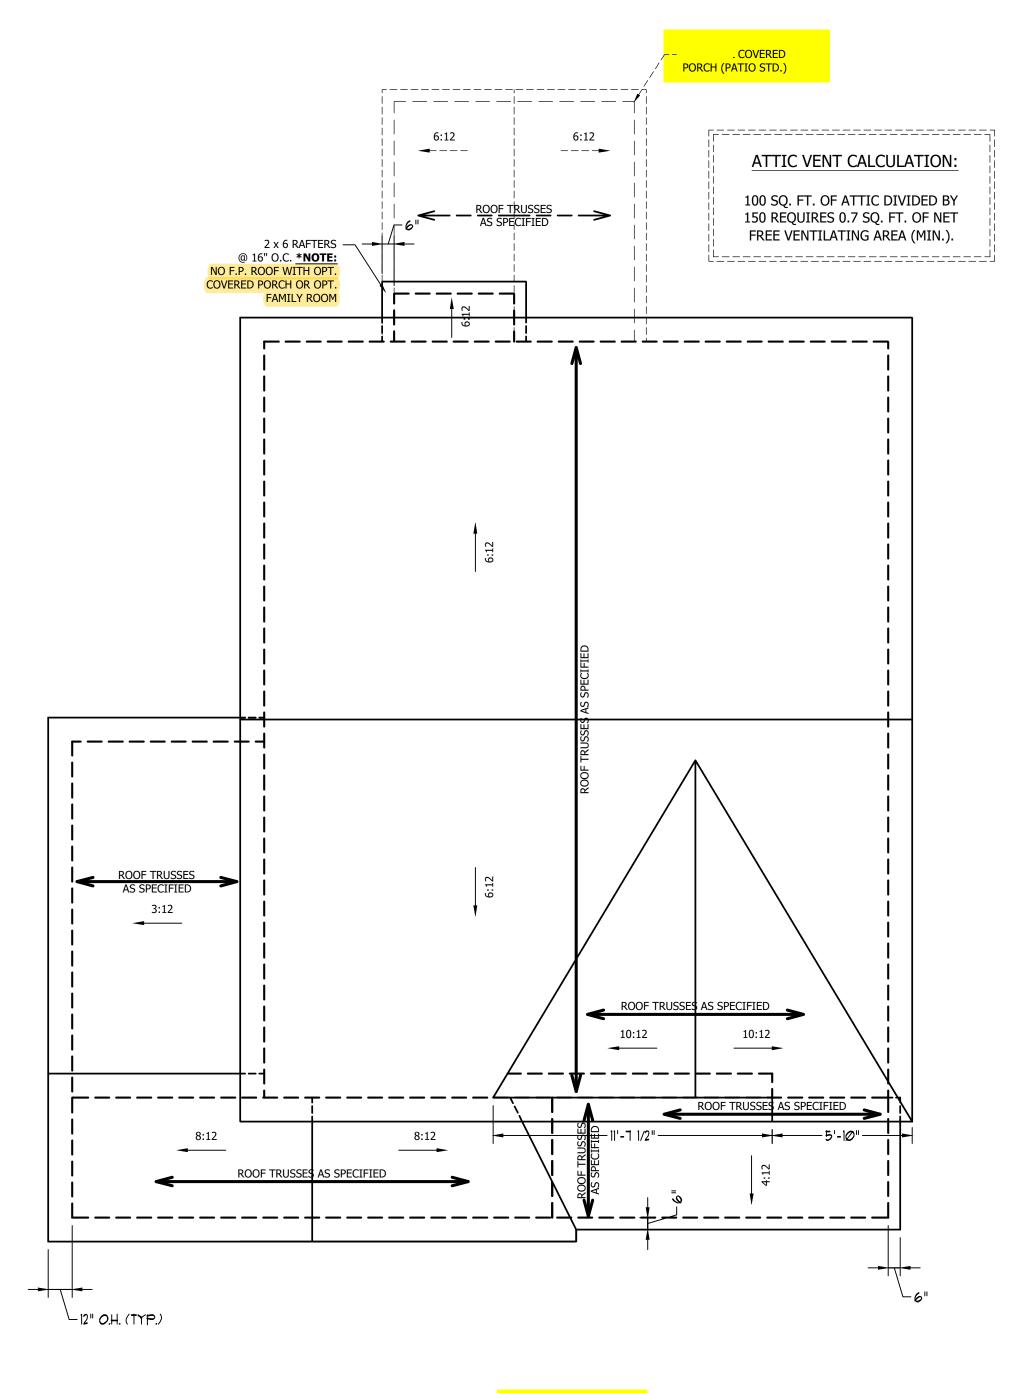

1250 SQ. FT. OF ATTIC DIVIDED BY 150 REQUIRES 8.3 SQ. FT. OF NET FREE VENTILATING AREA (MIN.).

STRUCTURAL NOTES:

- 1. ALL FRAMING LUMBER TO BE #2 SPF (UNO).
- 2. HIP SPLICES ARE TO BE SPACED A MIN. OF 8'-0". FASTEN MEMBERS WITH THREE ROWS OF 12d NAILS @ 16" O.C. (TYP.)
- 3. STICK FRAME OVER-FRAMED ROOF SECTIONS W/ 2 x 8 RIDGES, 2 x 6 RAFTERS @ 16" O.C. AND FLAT 2 x 10 VALLEYS OR USE VALLEY TRUSSES.
- 4. FASTEN FLAT VALLEYS TO RAFTERS OR TRUSSES WITH SIMPSON H2.5A HURRICANE TIES @ 32" O.C. MAX. PASS HURRICANE TIES THROUGH NOTCH IN ROOF SHEATHING. EACH RAFTER IS TO BE FASTENED TO THE FLAT VALLEY WITH A MIN. OF (6) 12d TOE NAILS.
- REFER TO SECTION R802.11 OF THE 2018 NCRC FOR REQUIRED UPLIFT RESISTANCE AT RAFTERS AND TRUSSES.





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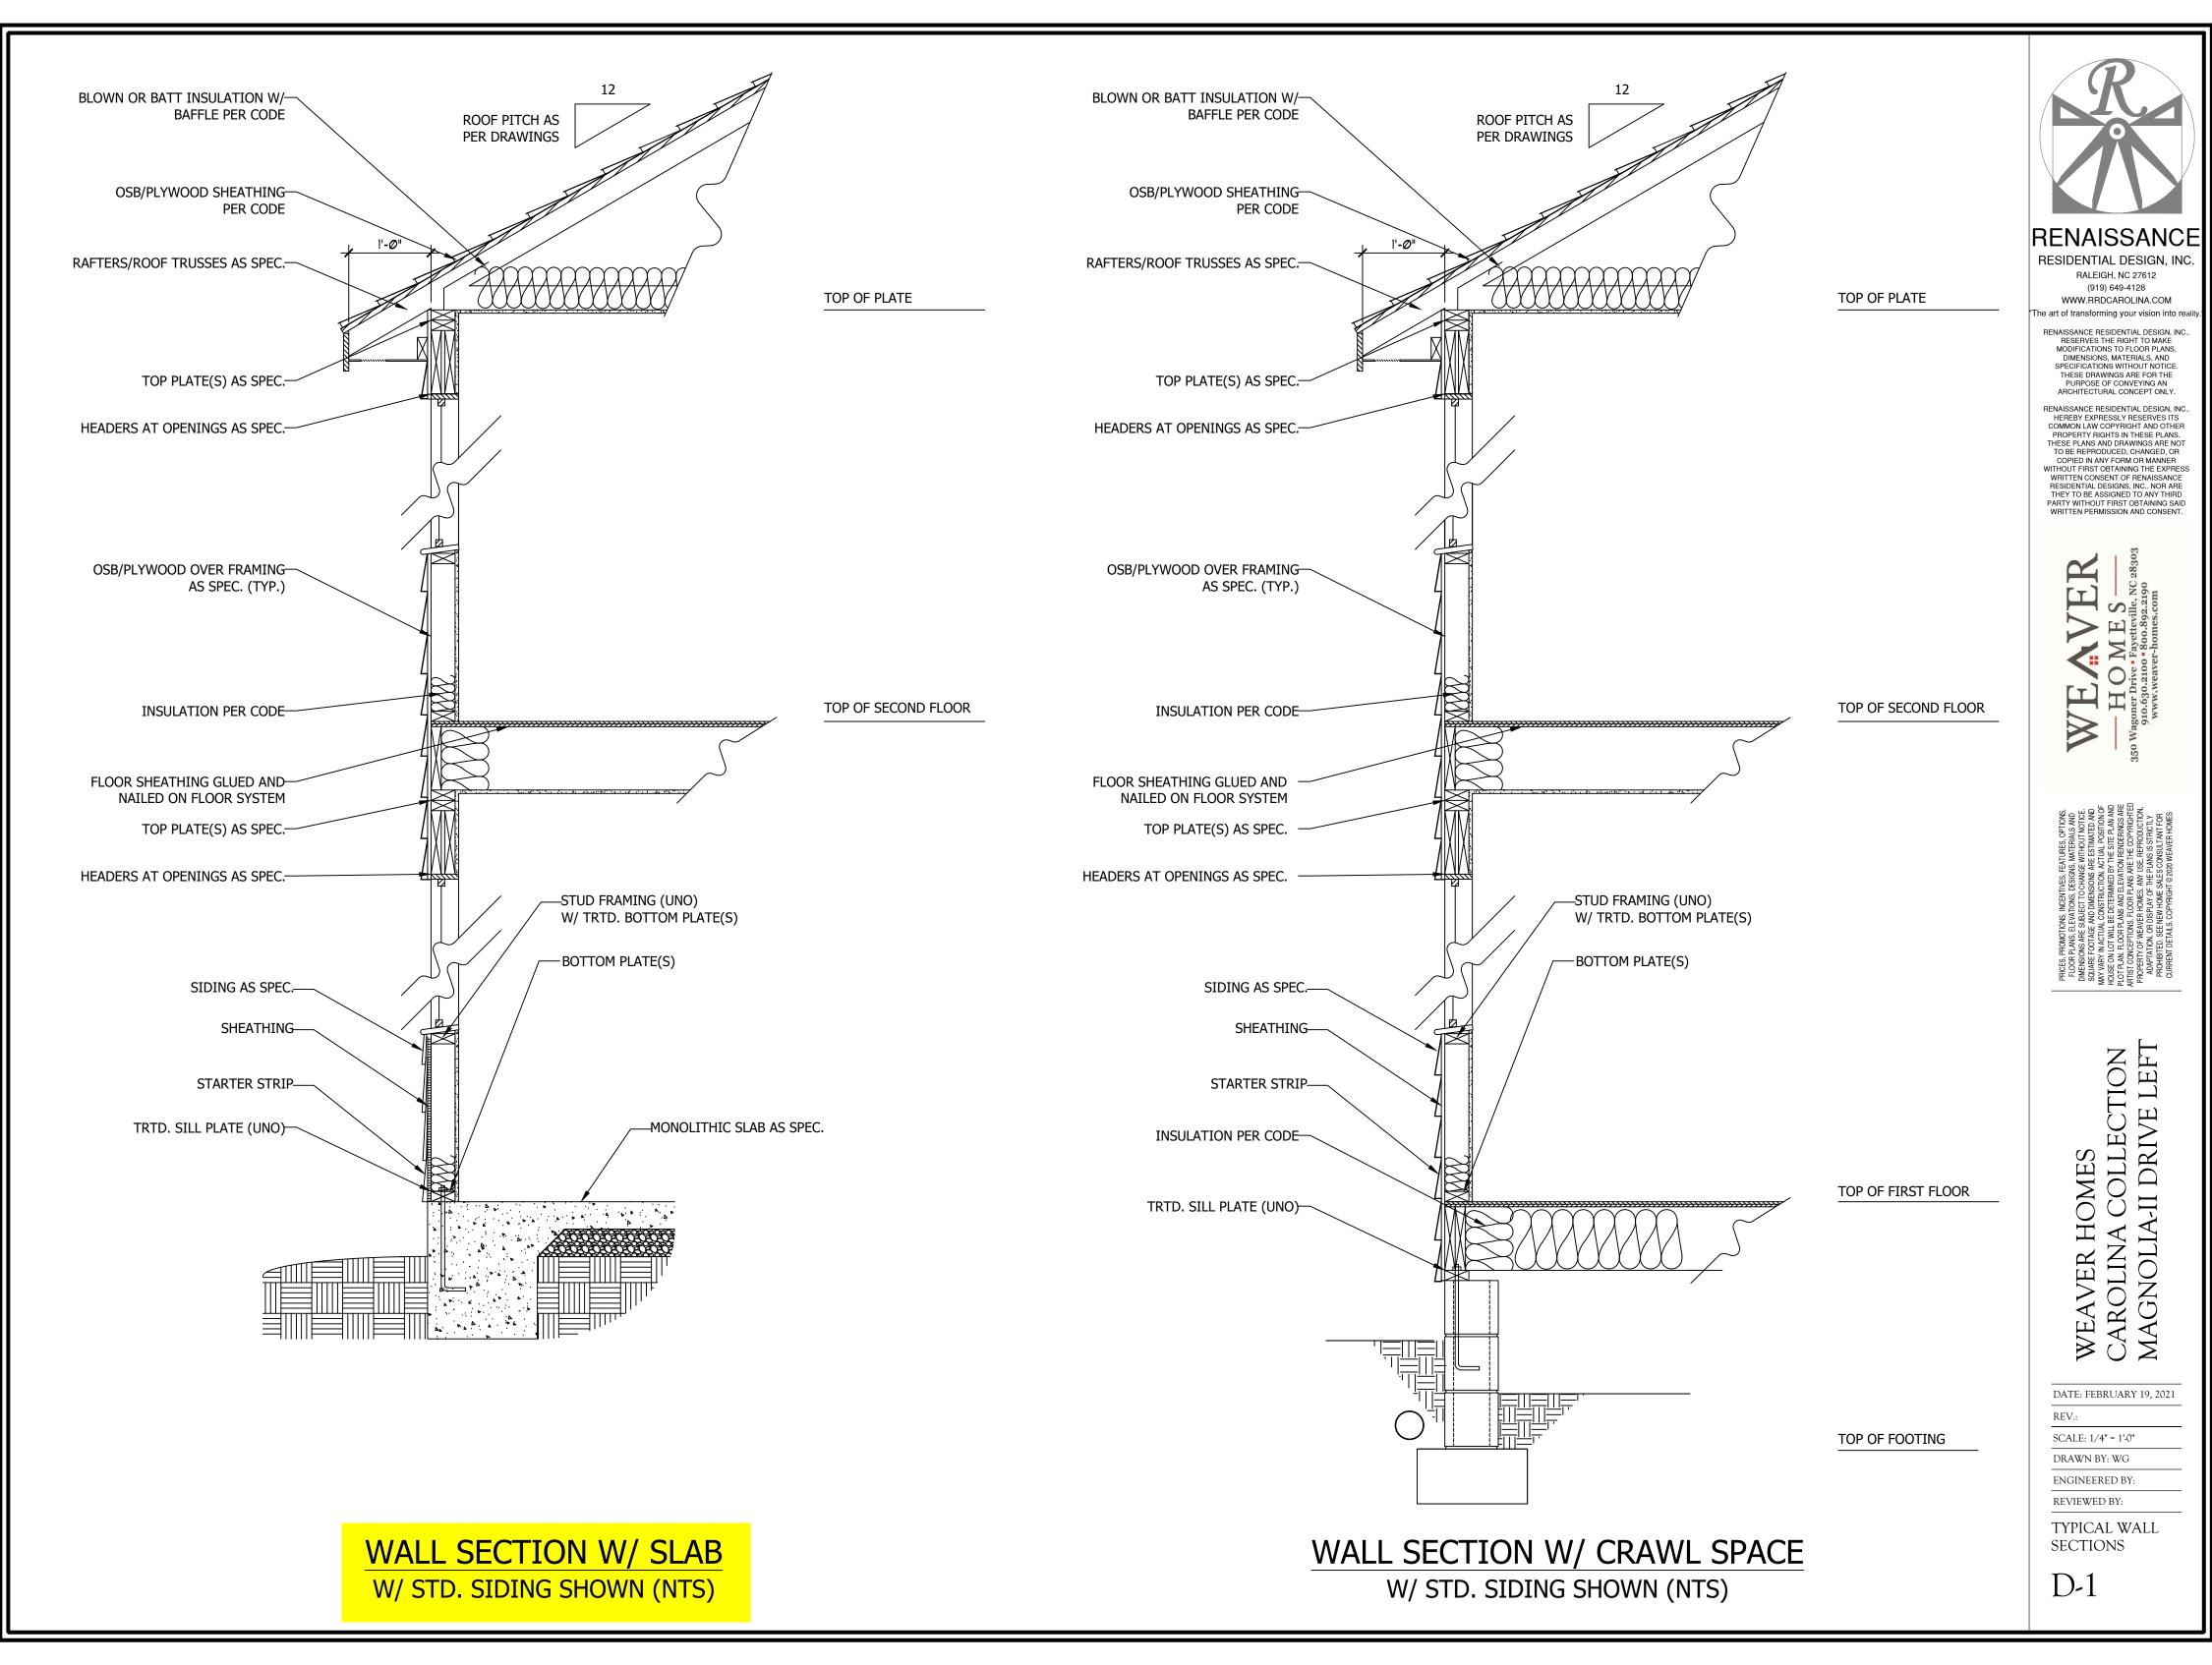
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ENGINEERED BY: REVIEWED BY:


ROOF PLAN ELEVATION - C

S-4

ELEVATION C



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Connector Information Nail Information Supported Member Product Manuf Qty Header Truss HUS410 USP 10 16d/3-1/2" NA 16d/3-1/2" THD410 USP 16d/3-1/2" 10d/3"

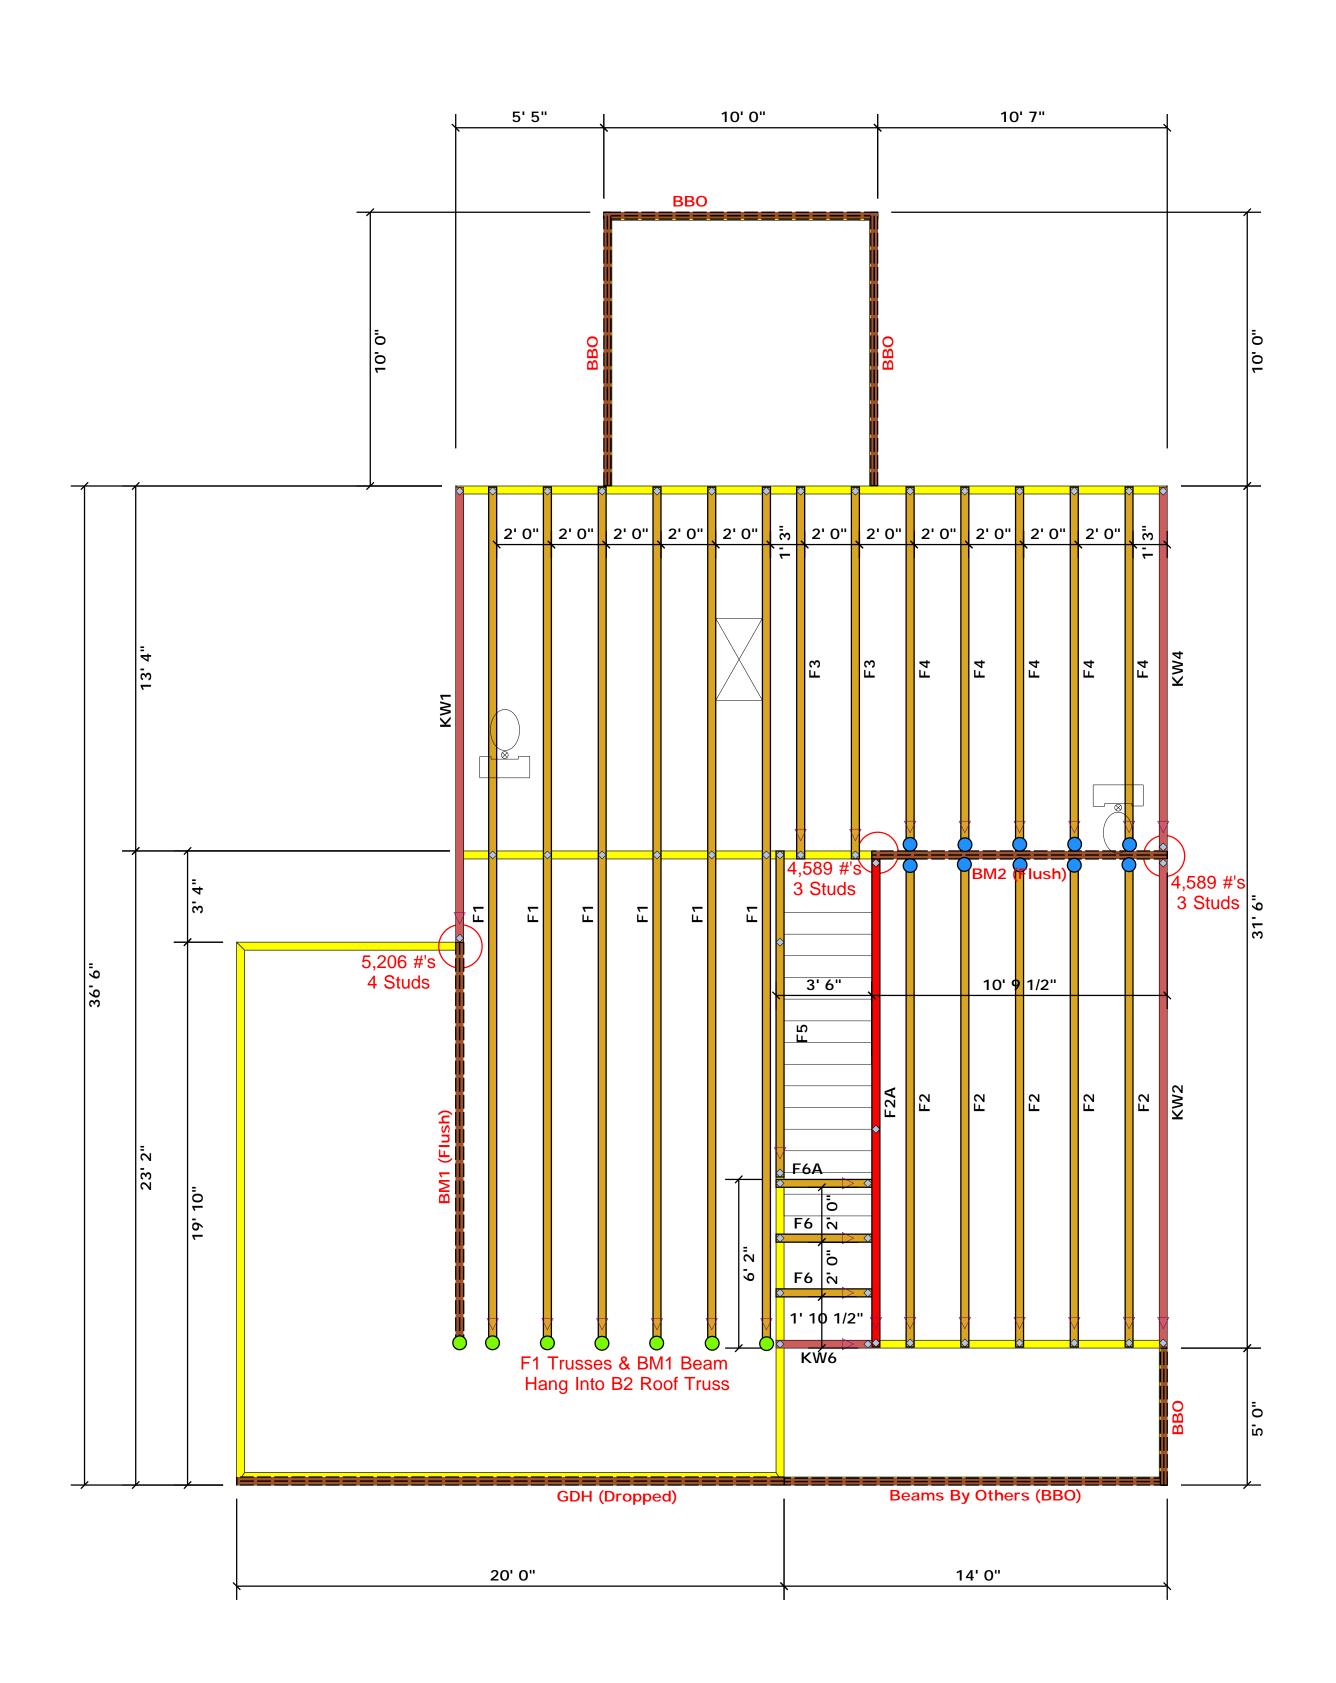Truss Placement Plan SCALE: NTS

▲ = Denotes Left End of Truss
(Reference Engineered Truss Drawing)

Products									
PlotID	Length	Product	Plies	Net Qty	Fab Type				
GDH (Dropped)	20' 0"	1-3/4"x 11-7/8" LVL Kerto-S	2	2	FF				
BM1 (Flush)	15' 0"	1-3/4"x 16" LVL Kerto-S	2	2	FF				
BM2 (Flush)	11' 0"	1-3/4"x 16" LVL Kerto-S	2	2	FF				


All Truss Reactions are Less than 3,000 lbs. Unless Noted Otherwise.

-- Denotes Reaction Greater than 3,000 lbs.

Reaction / # of Studs

_	LO.	AD 6	HART	FOI	R J	ACK.	STUD	5
		00	ASEN ON 1	ABLES	R502	5(1) 4.0	b))	
	No	MPES C	F JACK ST	ugo at Koerye			A CND OF	
		α	72	10000	a	ì		ø
	A5130N	HEADER HEADER	e e	į.	TUDS FOR		M2520 E 20	TEASE.
	CND 85ACT 07 FQ	SCORING SPANE	9	CLAS CLAS	86.00 57.00		25.50 27.50	(A) PLO
	_	77	_		1		2400	
	1700	1		550			3400	1
	3400	2	5	100	2		6600	2
	5100	3	7	650	3		10200	3
	6800	4	10	200	4		13600	4
	8500	5	12	750	5		17000	5
	10200	á	15	300	6			
	11900	7						
	13600	8						
	15300	~						

				_
BUILDER	Weaver Development	CITY / CO.	Cameron / Harnett	THI The the I
JOB NAME	Lot 5 Cedar Pointe	ADDRESS	Marks Road	is re the o walls rega
PLAN	Magnolia I I "C"	MODEL		Bear pres
SEAL DATE	Seal Date	DATE REV.	/ /	foun than be re
QUOTE #	Quote #	DRAWN BY	Christine Shivy	spec retai
JOB #	J0722-3628	SALES REP.	Lenny Norris	5

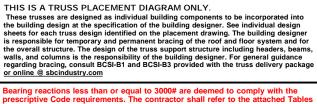


ctions less than or equal to 3000# are deemed to comply with the Code requirements. The contractor shall refer to the attached Tables on the prescriptive Code requirements) to determine the minimum size and number of wood studs required to support reactions greater but not greater than 15000#. A registered design professional shall to design the support system for any reaction that exceeds those the attached Tables. A registered design professional shall be design the support system for all reactions that exceed 15000#.

Christine Shivy

Christine Shivy



Phone: (910) 864-8787 Fax: (910) 864-4444

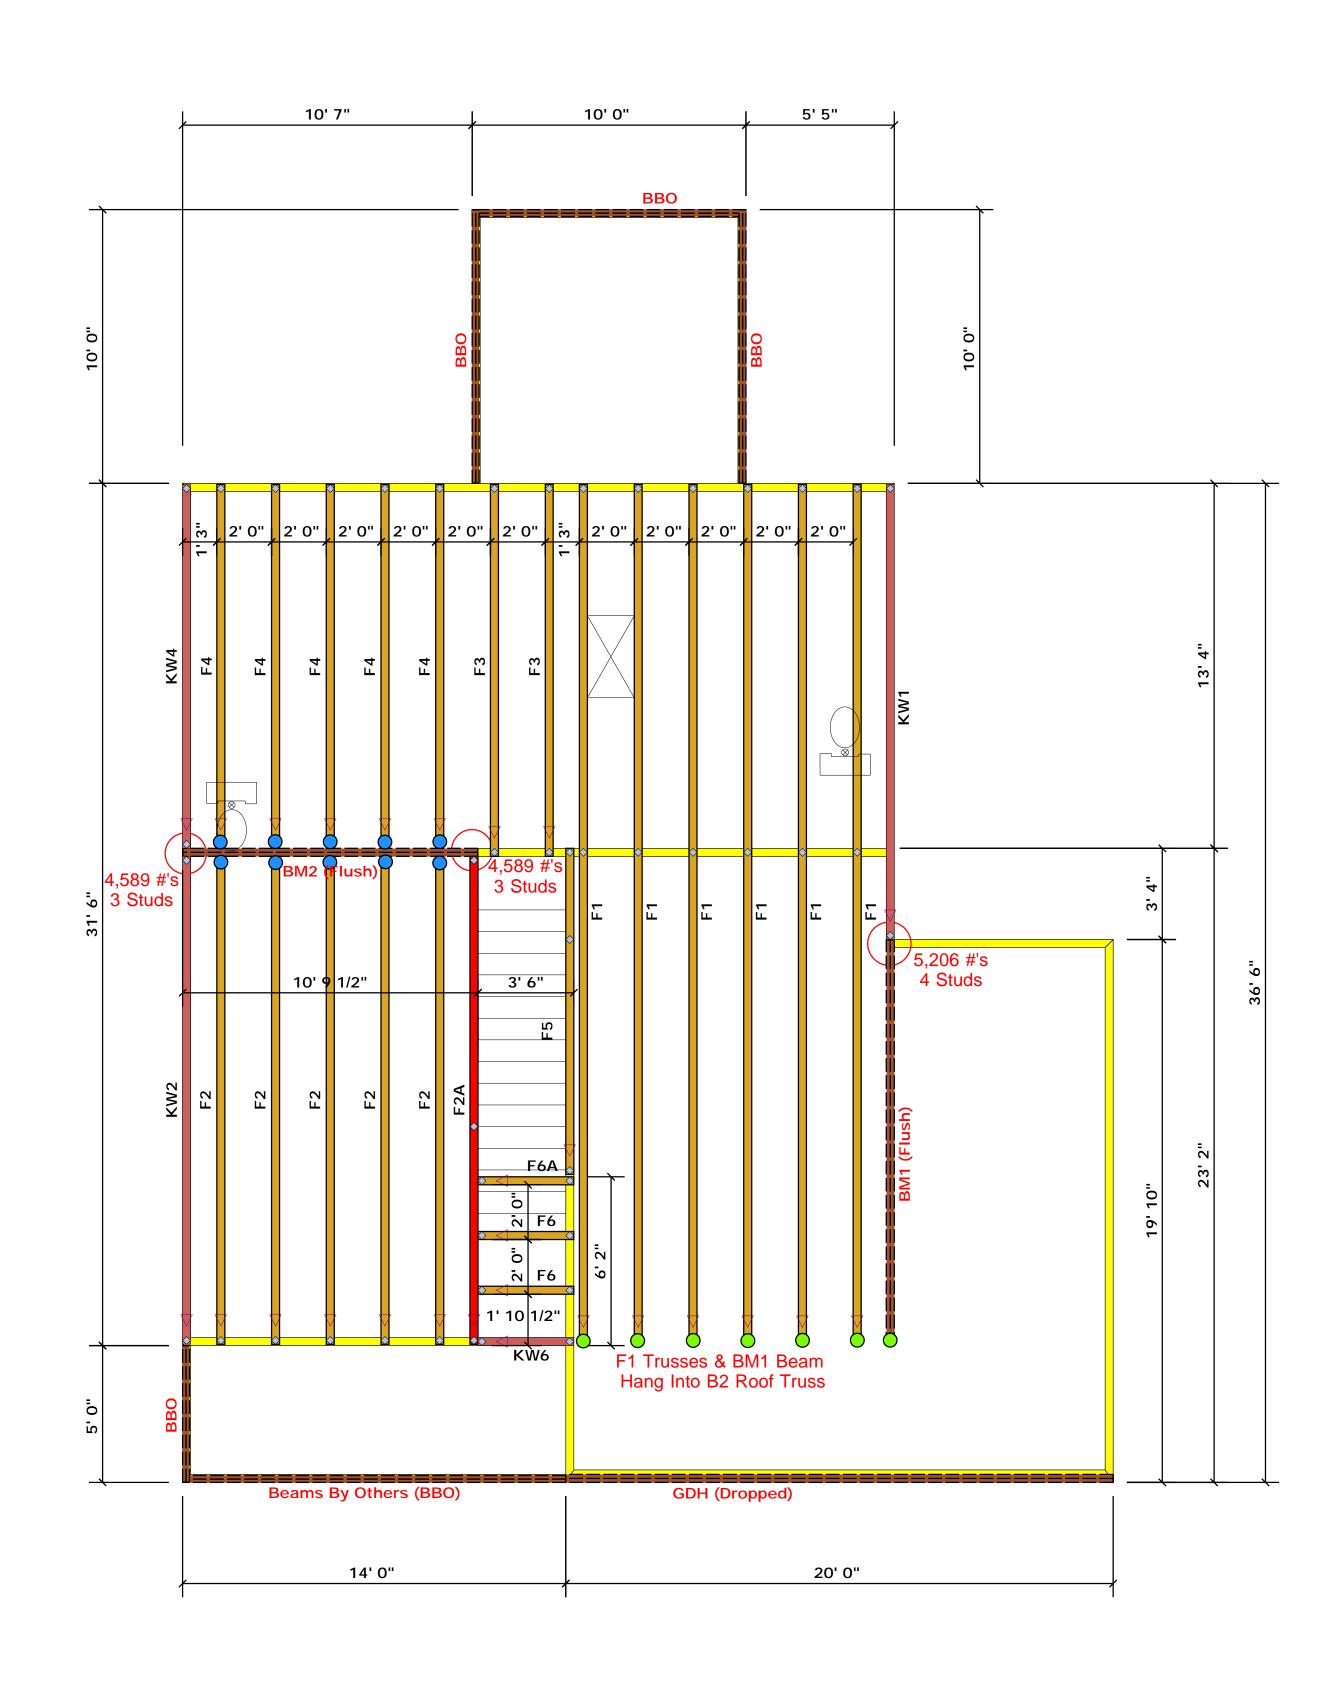

Connector Information Nail Information Supported Member Product Manuf Qty Header Truss USP 10 16d/3-1/2" HUS410 NA 16d/3-1/2" THD410 USP NA 16d/3-1/2" 10d/3"

Truss Placement Plan SCALE: NTS

▲ = Denotes Left End of Truss
(Reference Engineered Truss Drawing)

Products									
PlotID	Length	Product	Plies	Net Qty	Fab Type				
GDH (Dropped)	20' 0"	1-3/4"x 11-7/8" LVL Kerto-S	2	2	FF				
BM1 (Flush)	15' 0"	1-3/4"x 16" LVL Kerto-S	2	2	FF				
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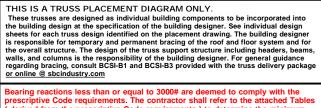
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-- Denotes Reaction Greater than 3,000 lbs.

Reaction / # of Studs

_	LO.	AD (HART F	OR J	ACK STUD	5
		00	ANED ON TABL	F5 R502	5(1) 4 (6))	
	NU	nr(s c			CO @ CA CNO SI	
			PEAGE	Welkoe.	`	er.
	END REACTION (OT FU)	SEC DISTURS FOR CORN HEADER	SNE PENCTION CLF TO	ABO SETUDS FOR ABON - MARK	ENB 81ACTOON (U* 10)	REQUESTADS FOR (4) MAY HEADER
	1700	1	2550	0 1	3400	1
	3400	2	5100	2 (6600	2
	5100	3	7650	0 3	10200	3
	6800	4	1020	0 4	13600	4
	8500	5	1275	0 5	17000	5
	10200	á	1530	0 6		
	11900	7				
	13600	8				
	15300	9				

	BUILDER	Weaver Development	CITY / CO.	Cameron / Harnett	THIS IS These to the build sheets for
	JOB NAME	Lot 5 Cedar Pointe	ADDRESS	Marks Road	is respon the over walls, an regardin
	PLAN	Magnolia I I "C"	MODEL	Floor	or online Bearing prescrip
	SEAL DATE	Seal Date	DATE REV.	/ /	(derived foundate than 300 be retain
	QUOTE #	Quote #	DRAWN BY	Christine Shivy	specifie retained
-	JOB #	J0722-3628	SALES REP.	Lenny Norris	Sign



Christine Shivy

Christine Shivy

ROOF & FLOOR TRUSSES & BEAMS Reilly Road Industrial Park

Reilly Road Industrial Park Fayetteville, N.C. 28309 Phone: (910) 864-8787 Fax: (910) 864-4444



Client: Weaver Development Project: Magnolia-II Elev. C Address: Magnolia-II Elev. C


Date: 4/13/2022 Input by: Christine Shivy Job Name: Magnolia-II Elev. C

Project #:

1.750" X 16.000" **Kerto-S LVL** 2-Ply - PASSED BM₁

Level: Level

Reactions UNPATTERNED Ib (Uplift)

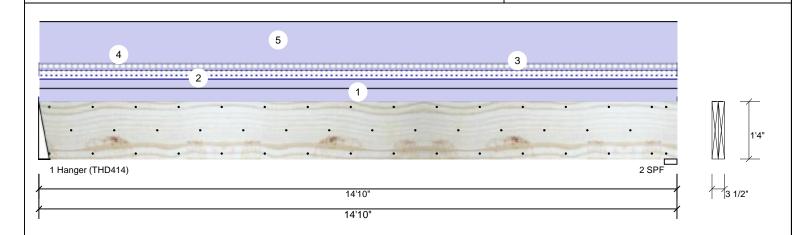

Type:	Girder	Application:	Floor	Brg	Direction	Live	Dead	l Sno	w Wind	Const
Plies:	2	Design Method:	ASD	1	Vertical	296	4522	. 57	77 0	0
Moisture Condition	on: Dry	Building Code:	IBC/IRC 2015	2	Vertical	298	4548	58	30 0	0
Deflection LL:	480	Load Sharing:	No							
Deflection TL:	360	Deck:	Not Checked							
Importance:	Normal - II									
Temperature:	Temp <= 100°F									
				Bear	ings					
				Bea	ring Length	Dir.	Cap. Reac	D/L lb T	otal Ld. Case	Ld. Comb.
				1 -	3.000"	Vert	59% 452	22 / 655 5	5177 L	D+0.75(L+S)
-				Har	nger					
Analysis Resu	lts			2 - 3	SPF 3.500"	Vert	100% 454	18 / 658 5	206 L	D+0.75(L+S)

Analysis	Actual	Location	Allowed	Сараспу	Comb.	Case
Moment	15931 ft-lb	7'4 3/4"	31109 ft-lb	0.512 (51%)	D	Uniform
Unbraced	18237 ft-lb	7'4 3/4"	18273 ft-lb	0.998 (100%)	D+0.75(L+S)	L
Shear	3695 lb	1'7"	10752 lb	0.344 (34%)	D	Uniform
LL Defl inch	0.041 (L/4231)	7'4 13/16"	0.361 (L/480)	0.113 (11%)	0.75(L+S)	L
TL Defl inch	0.324 (L/535)	7'4 13/16"	0.481 (L/360)	0.673 (67%)	D+0.75(L+S)	L

Design Notes

Member Information

- 1 Provide support to prevent lateral movement and rotation at the end bearings. Lateral support may also be required at the interior bearings by the building code.
- 2 Fasten all plies using 3 rows of 10d Box nails (.128x3") at 12" o.c. Maximum end distance not to exceed 6".
- 3 Refer to last page of calculations for fasteners required for specified loads.
- 4 Fill all hanger nailing holes.
- 5 Girders are designed to be supported on the bottom edge only.
- 6 Top loads must be supported equally by all plies.
- 7 Top must be laterally braced at a maximum of 6'5 1/8" o.c.
- 8 Bottom must be laterally braced at end bearings.
- 9 Lateral slenderness ratio based on single ply width.

ID	Load Type	Location	Trib Width	Side	Dead 0.9	Live 1	Snow 1.15	Wind 1.6	Const. 1.25	Comments
1	Uniform			Тор	125 PLF	0 PLF	0 PLF	0 PLF	0 PLF	Exterior Wall
2	Uniform			Near Face	78 PLF	0 PLF	78 PLF	0 PLF	0 PLF	M1
3	Uniform			Far Face	15 PLF	40 PLF	0 PLF	0 PLF	0 PLF	Floor Load

Continued on page 2...

Notes

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- Dry service conditions, unless noted otherwise
 LVL not to be treated with fire retardant or corrosive
- Handling & Installation
- I. LVL beams must not be cut or drilled
 Refer to manufacturer's product information regarding installation requirements, multi-ply fastening details, beam strength values, and code approvals
 Damaged Beams must not be used

- Design assumes top edge is laterally restrained
 Provide lateral support at bearing points to avoid
 lateral displacement and rotation
- 6. For flat roofs provide proper drainage to prevent ponding

This design is valid until 11/3/2024

Metsä Wood 301 Merritt 7 Building, 2nd Floor Norwalk, CT 06851 (800) 622-5850 www.metsawood.com/us

Manufacturer Info

Comtech, Inc. 1001 S. Reilly Road, Suite #639 Fayetteville, NC USA 28314 910-864-TRUS



Page 1 of 2






Continued from page 1

Client: Weaver Development Project: Magnolia-II Elev. C Address: Magnolia-II Elev. C Date: 4/13/2022 Input by: Christine Shivy Job Name: Magnolia-II Elev. C

Project #:

1.750" X 16.000" 2-Ply - PASSED **Kerto-S LVL** BM₁

Level: Level

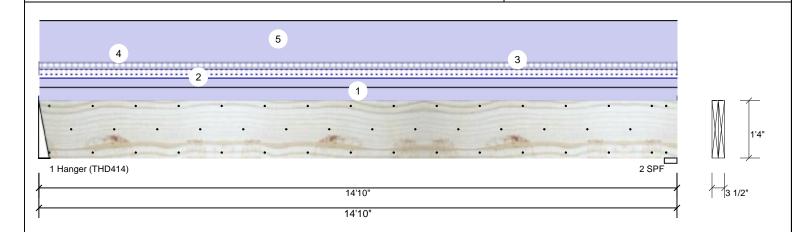

ID	Load Type	Location	Trib Width	Side	Dead 0.9	Live 1	Snow 1.15	Wind 1.6	Const. 1.25	Comments
4	Uniform			Тор	130 PLF	0 PLF	0 PLF	0 PLF	0 PLF	Exterior Load
5	Uniform			Тор	251 PLF	0 PLF	0 PLF	0 PLF	0 PLF	A1GE
	Self Weight				12 PLF					

Notes

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Dry service conditions, unless noted otherwise
 LVL not to be treated with fire retardant or corrosive

Handling & Installation

Handling & Installation

1. IVI beams must not be out or drilled

2. Refer to manufacturer's product information regarding installation requirements, multi-ply fastering details, beam strength values, and code approvals

3. Damaged Beams must not be used

4. Design assumes top edge is laterally restrained

5. Provide lateral support at bearing points to avoid lateral displacement and rotation

6. For flat roofs provide proper drainage to prevent ponding

This design is valid until 11/3/2024

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Page 2 of 2





Client: Project: Address:

Weaver Development Magnolia-II Elev. C Magnolia-II Elev. C Date: 4/13/2022 Input by:


Christine Shivy Job Name: Magnolia-II Elev. C


Project #:

Kerto-S LVL 2-Ply - PASSED 1.750" X 16.000" BM₂

Level: Level

Reactions UNPATTERNED Ib (Uplift)

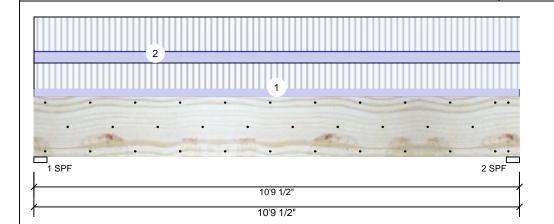

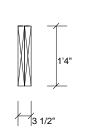

Page 1 of 1

Member Information Туре: Girder Plies: 2 Moisture Condition: Dry Deflection LL: 480 Deflection TL: 360 Importance: Normal - II Temperature: Temp <= 100°F

Application: Floor Design Method: ASD **Building Code: IBC/IRC 2015** Load Sharing: No Deck: Not Checked

Brg Snow Wind Const Direction Live Dead Vertical 3389 1200 0 0 0 1 3389 1200 0 2 Vertical 0 0

Bearings Bearing Length Dir. Cap. React D/L lb Total Ld. Case Ld. Comb. D+L 1 - SPF 3.500" Vert 1200 / 3389 4589 L 3.500" 2 - SPF Vert 88% 1200 / 3389 4589 L D+I

Analysis Results

Analysis	Actual	Location	Allowed	Capacity	Comb.	Case
Moment	11397 ft-lb	5'4 3/4"	34565 ft-lb	0.330 (33%)	D+L	L
Unbraced	11397 ft-lb	5'4 3/4"	11764 ft-lb	0.969 (97%)	D+L	L
Shear	4341 lb	1'7 1/2"	11947 lb	0.363 (36%)	D+L	L
LL Defl inch	0.085 (L/1457)	5'4 3/4"	0.259 (L/480)	0.329 (33%)	L	L
TL Defl inch	0.115 (L/1076)	5'4 3/4"	0.345 (L/360)	0.335 (33%)	D+L	L

Design Notes

- 1 Provide support to prevent lateral movement and rotation at the end bearings. Lateral support may also be required at the interior bearings by the building code.
- 2 Fasten all plies using 3 rows of 10d Box nails (.128x3") at 12" o.c. Maximum end distance not to exceed 6".
- 3 Refer to last page of calculations for fasteners required for specified loads.
- 4 Girders are designed to be supported on the bottom edge only.
- 5 Top must be laterally braced at end bearings.
- 6 Bottom must be laterally braced at end bearings.
- 7 Lateral slenderness ratio based on single ply width.

ID	Load Type	Location	Trib Width	Side	Dead 0.9	Live 1	Snow 1.15	Wind 1.6	Const. 1.25	Comments	
1	Uniform			Far Face	89 PLF	267 PLF	0 PLF	0 PLF	0 PLF	F4	
2	Uniform			Near Face	121 PLF	361 PLF	0 PLF	0 PLF	0 PLF	F2	
	Self Weight				12 PLF						

Notes

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- Dry service conditions, unless noted otherwise
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- Handling & Installation
- LVL beams must not be cut or drilled Refer to manufacturer's product information regarding installation requirements, multi-ply fastening details, beam strength values, and code approvals Damaged Beams must not be used
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 Provide lateral support at bearing points to avoid
 lateral displacement and rotation
- 6. For flat roofs provide proper drainage to prevent ponding

This design is valid until 11/3/2024

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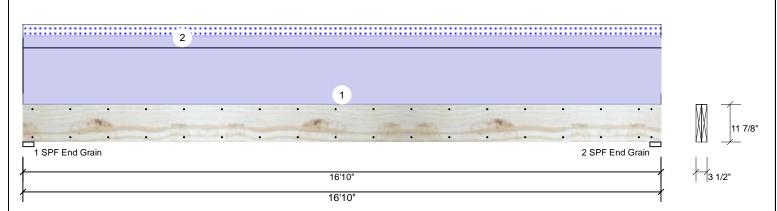
Client: Project: Address: Weaver Development Magnolia-II Elev. C Magnolia-II Elev. C Date: 4/13/2022

Input by: Christine Shivy Job Name: Magnolia-II Elev. C Page 1 of 1

Project #:

Kerto-S LVL 2-Ply - PASSED 1.750" X 11.875" **GDH**

Level: Level



Member Info	rmation						React	ions UNP	ATTERN	IED I	b (Uplift)			
Type:	Girder		Applicat	ion: F	loor		Brg	Direction	Live		Dead	Snow	Wind	Cons
Plies:	2		Design I	Method: A	ASD		1	Vertical	0		2098	337	0	(
Moisture Condition	on: Dry		Building	Code:	BC/IRC 2015		2	Vertical	0		2098	337	0	(
Deflection LL:	480		Load Sh	aring: N	١o									
Deflection TL:	360		Deck:	١	Not Checked									
Importance:	Normal - II													
Temperature:	Temp <= 10	0°F												
							Beari	ngs						
							Beari	ng Length	Dir.	Cap.	React D/L lb	Total	Ld. Case	Ld. Comb.
							1 - SI End	PF 3.500"	Vert	24%	2098 / 337	2434	L	D+S
Analysis Resu	ılts						Grain)						
Analysis A	Actual	Location	Allowed	Capacity	Comb.	Case	2 - SI	PF 3.500"	Vert	24%	2098 / 337	2434	L	D+S
Moment 8	354 ft-lb	8'5"	17919 ft-lb	0.466 (47%	6) D	Uniform	End Grain	1						
Unbraced 9	694 ft-lb	8'5"	9704 ft-lb	0.999	D+S	L								

Uniform

1

TL Defl inch **Design Notes**

Shear

1 Provide support to prevent lateral movement and rotation at the end bearings. Lateral support may also be required at the interior bearings by the building code.

8'5 1/16" 0.409 (L/480) 0.171 (17%) S

8'5 1/16" 0.546 (L/360) 0.927 (93%) D+S

1'3 3/8" 7980 lb

0.224 (22%) D

- 2 Fasten all plies using 2 rows of 10d Box nails (.128x3") at 12" o.c. Maximum end distance not to exceed 6".
- 3 Refer to last page of calculations for fasteners required for specified loads.
- 4 Girders are designed to be supported on the bottom edge only.
- 5 Top loads must be supported equally by all plies.

1788 lb

0.506 (L/388)

LL Defl inch 0.070 (L/2809)

- 6 Top must be laterally braced at a maximum of 9'6 3/4" o.c.
- 7 Bottom must be laterally braced at end bearings.
- 8 Lateral slenderness ratio based on single ply width

o Latorar t	diditaditiodd fallo badda di										
ID	Load Type	Location	Trib Width	Side	Dead 0.9	Live 1	Snow 1.15	Wind 1.6	Const. 1.25	Comments	
1	Uniform			Тор	200 PLF	0 PLF	0 PLF	0 PLF	0 PLF	Exterior Loads	
2	Uniform			Тор	40 PLF	0 PLF	40 PLF	0 PLF	0 PLF	2'-0" Gable End	
	Self Weight				9 PLF						

Notes

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- Dry service conditions, unless noted otherwise
 LVL not to be treated with fire retardant or corrosive
- Handling & Installation
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 regarding installation requirements, multi-ply
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 approvals
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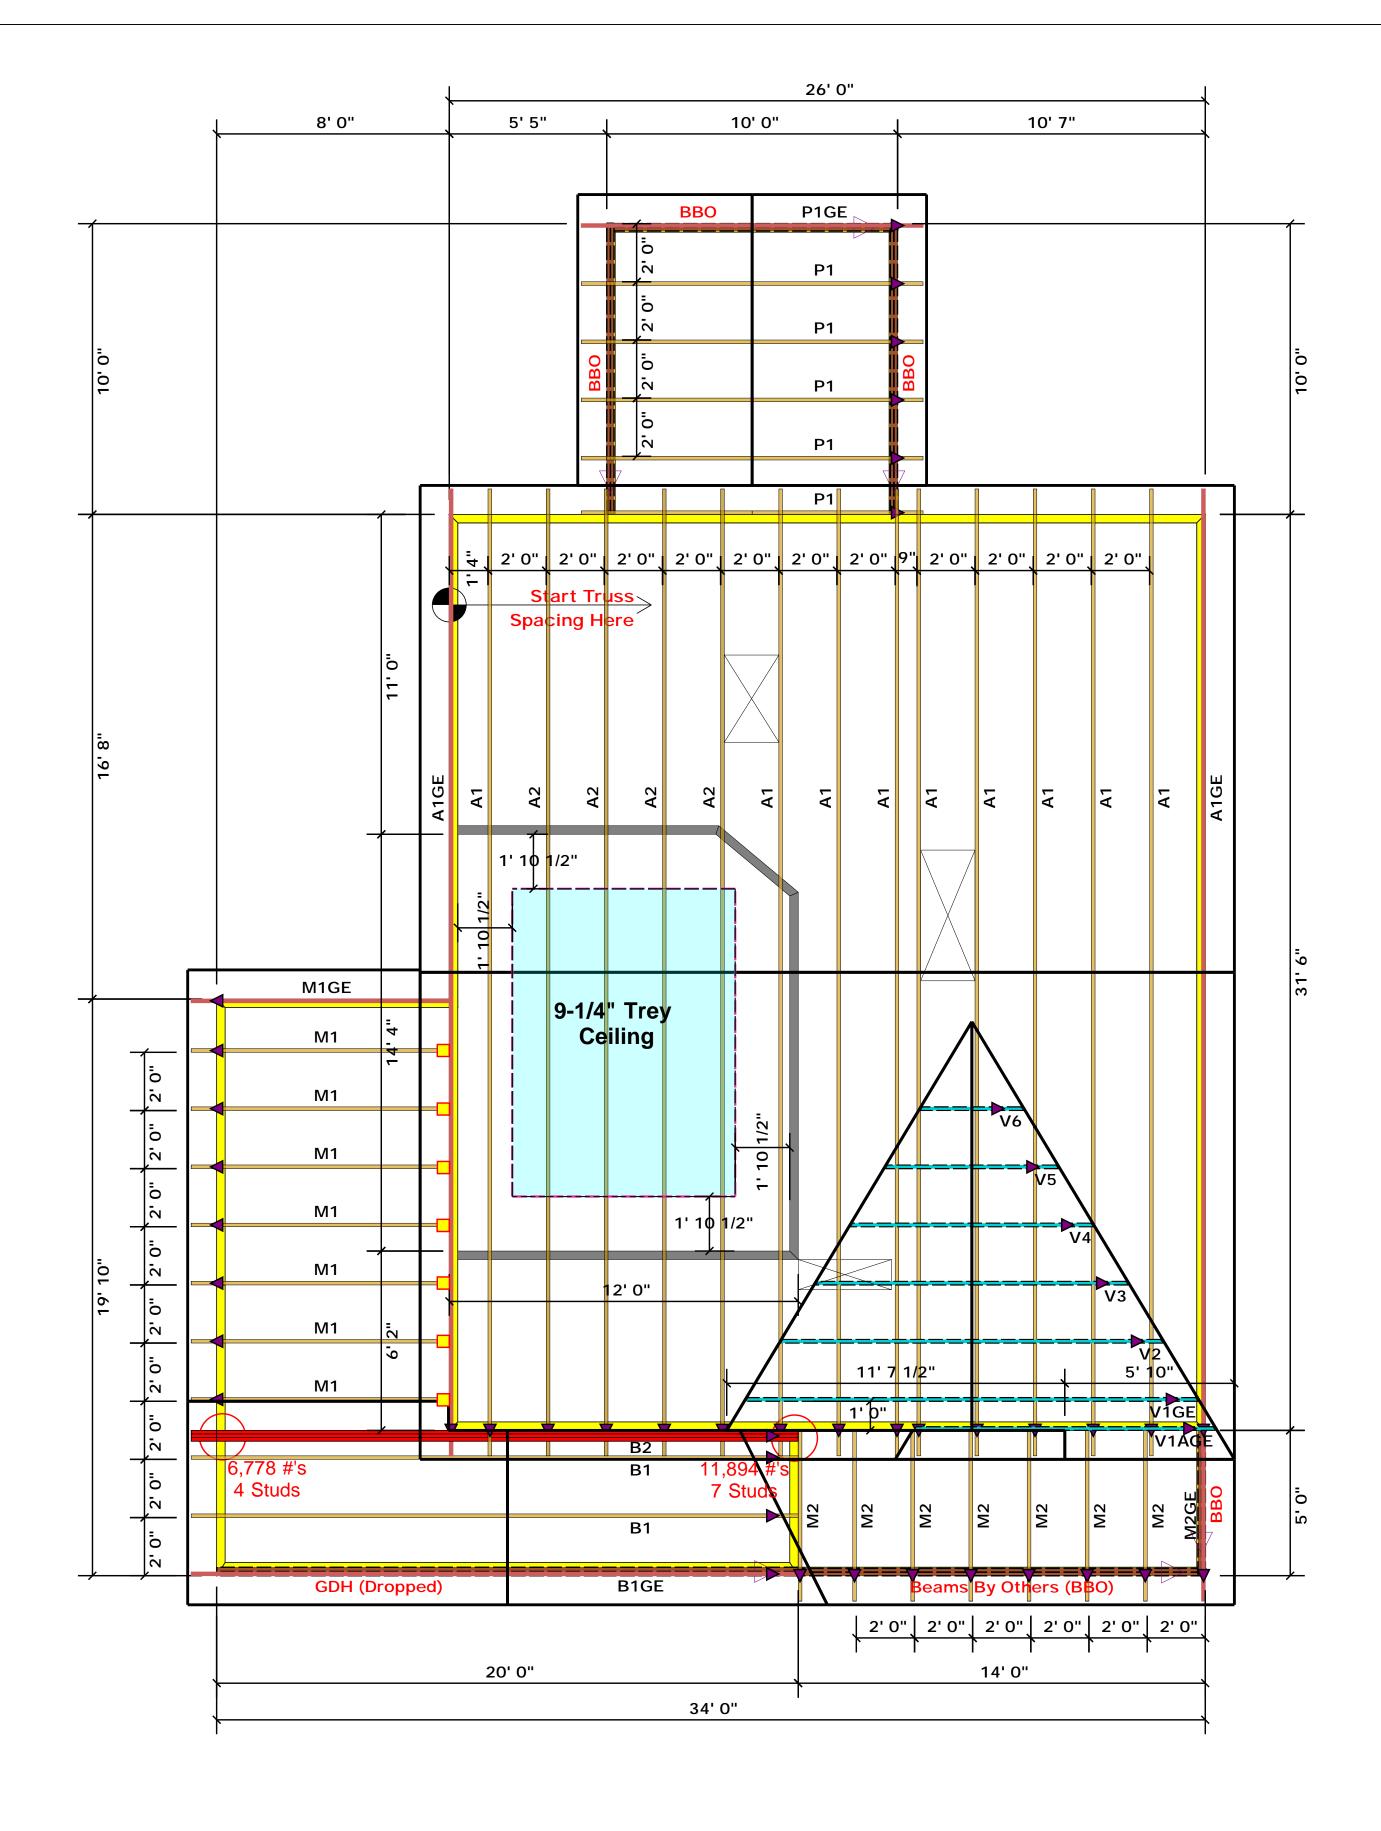
This design is valid until 11/3/2024

Manufacturer Info Metsä Wood 301 Merritt 7 Building, 2nd Floor Norwalk, CT 06851 (800) 622-5850 www.metsawood.com/us

Comtech, Inc. 1001 S. Reilly Road, Suite #639 Fayetteville, NC USA 28314 910-864-TRUS







	Conne	Nail Information				
Syr	n Product	Manuf	Qty	Supported Member	Header	Truss
	JUS24	USP	7	NA	10d/3"	10d/3"

▲ = Denotes Left End of Truss
(Reference Engineered Truss Drawing)


Truss Placement Plan SCALE: NTS

All Truss Reactions are Less than 3,000 lbs. Unless Noted Otherwise.

-- Denotes Reaction Greater than 3,000 lbs.
Reaction / # of Studs

	LO.	AD (CHAI	RT FO	R J	ACK.	STUD	5			
	(045Fb ON 148LF5 R5025(1) & (b))										
	NU	uu(e c		STUDG A			A CND OF				
				HEADER/	SERDER						
Care at a manage	(0° TO)	SEC DISTURS FOR CORN HEADER		SNE PENCTION OF ALL	NEQ 15 STUDS FOR CIPAN HEADER		ENB RIMCTION (UP 10)	REQUESTADS FOR ANNA HEADER			
1	700	1		2550	1		3400	1			
3	400	2		5100	2		6800	2			
5	100	3		7650	3		10200	3			
6	008	4		10200	4		13600	4			
8	500	5		12750	5		17000	5			
10	200	á		15300	6						
11	900	7									
13	600	8									
15	200										

BUILDER	Weaver Development	CITY / CO.	I Cameron / Harnett	TH Th the
JOB NAME	Lot 5 Cedar Pointe	ADDRESS	Marks Road	is r the wal reg
PLAN	Magnolia I I "C"	MODEL	Roof	Bea pre
SEAL DATE	Seal Date	DATE REV.	/ /	(de fou that be
QUOTE #		DRAWN BY	Christine Shivy	spe reta
JOB #	J0722-3627	SALES REP.	Lenny Norris	

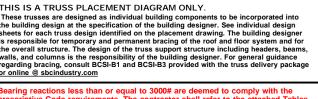

Bearing reactions less than or equal to 3000# are deemed to comply with the prescriptive Code requirements. The contractor shall refer to the attached Tables (derived from the prescriptive Code requirements) to determine the minimum foundation size and number of wood studs required to support reactions greater than 3000# but not greater than 15000#. A registered design professional shall be retained to design the support system for any reaction that exceeds those specified in the attached Tables. A registered design professional shall be retained to design the support system for all reactions that exceed 15000#.

ppport system for any reaction that exceeds those bles. A registered design professional shall be ort system for all reactions that exceed 15000#.


Christine Shivy

Christine Shivy

Reilly Road Industrial Park
Fayetteville, N.C. 28309
Phone: (910) 864-8787
Fax: (910) 864-4444

соттесн

ROOF & FLOOR TRUSSES & BEAMS

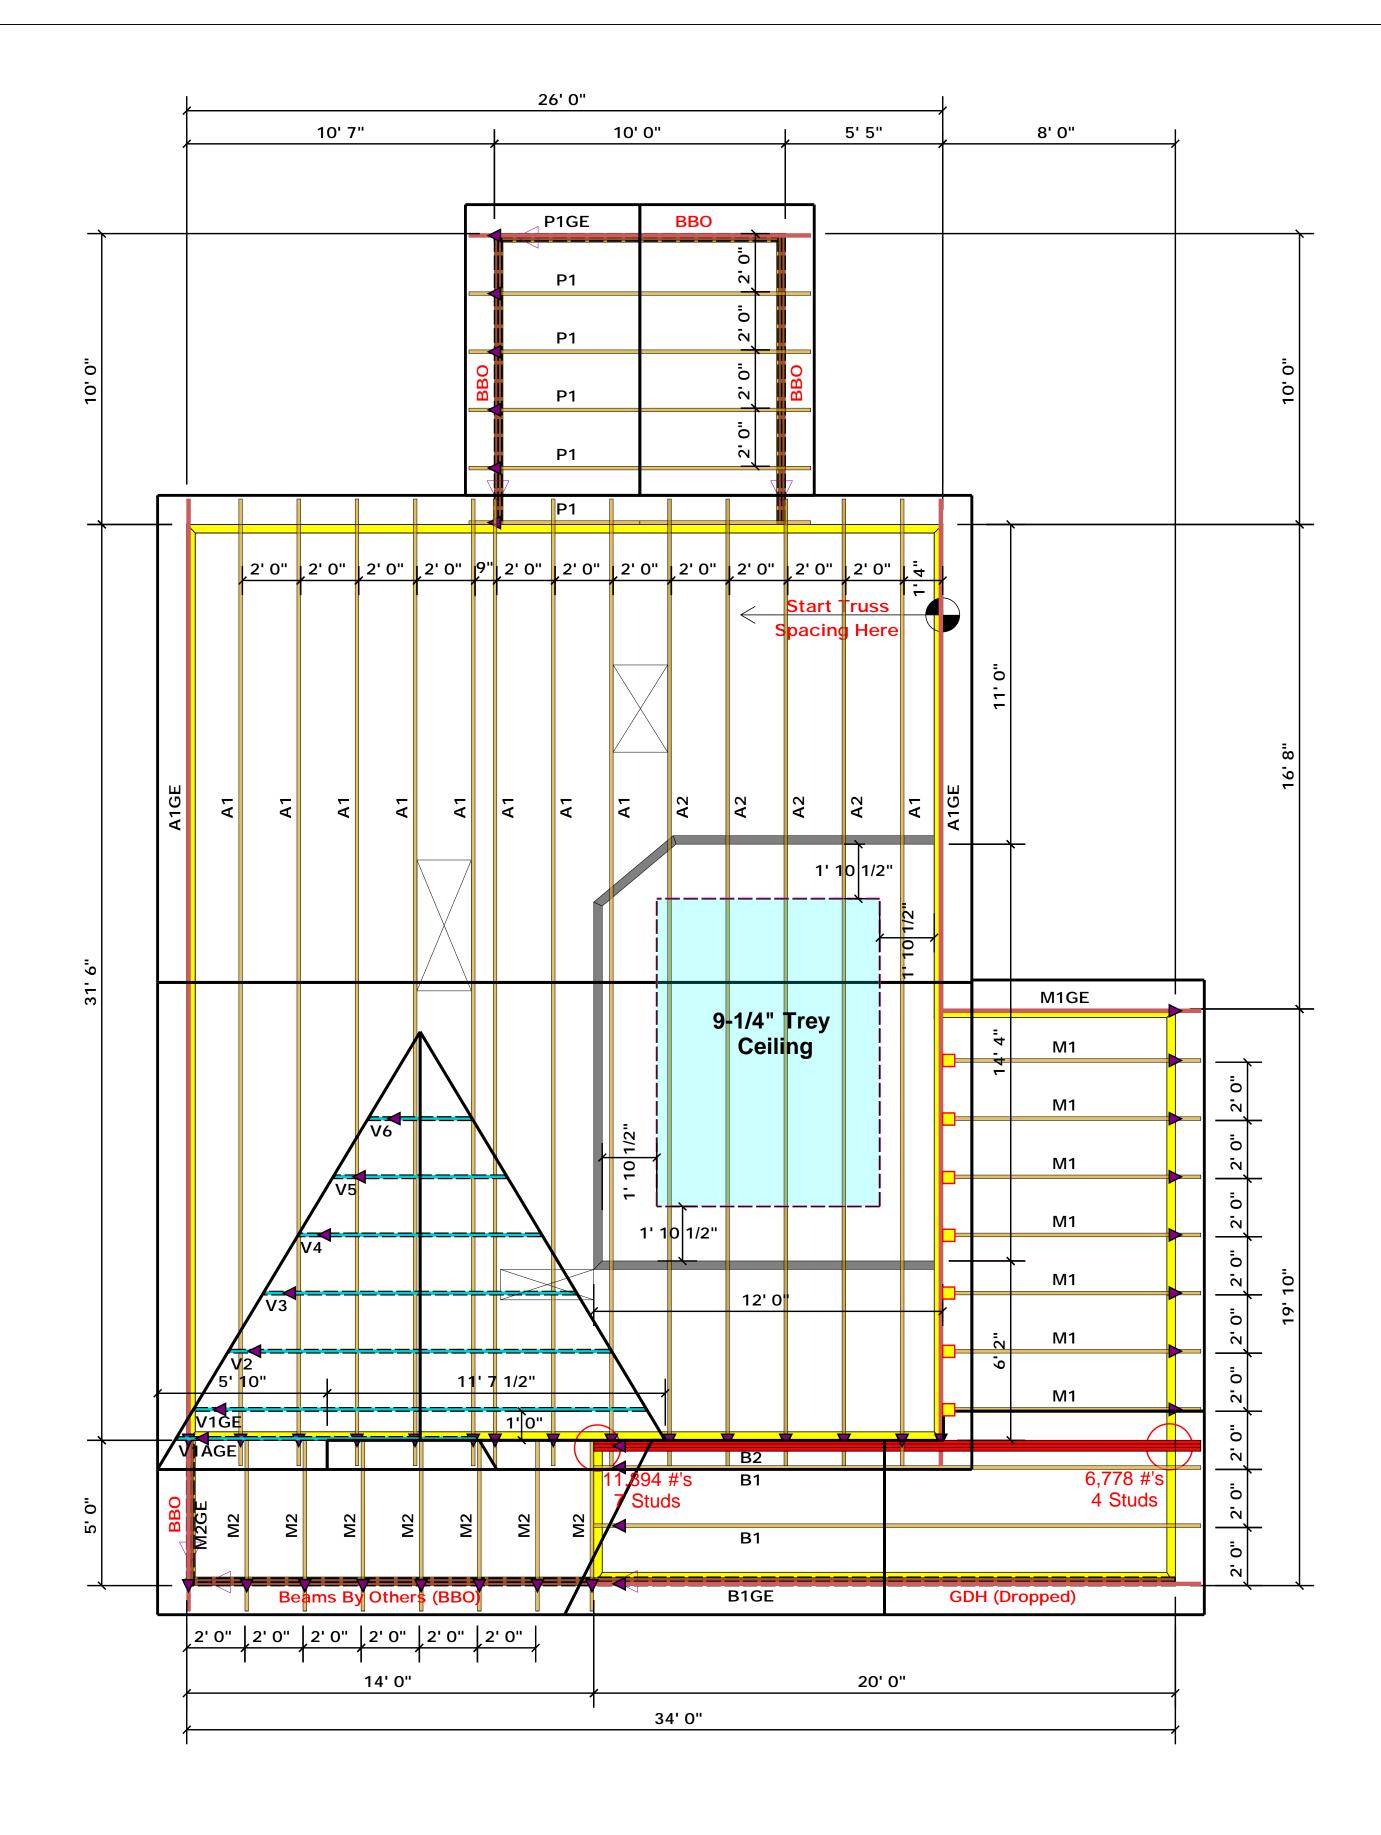

	Conne	Nail Info	ormation			
Sym	Product	Manuf	Qty	Supported Member	Header	Truss
	JUS24	USP	7	NA	10d/3"	10d/3"

▲ = Denotes Left End of Truss (Reference Engineered Truss Drawing)

Truss Placement Plan SCALE: NTS


All Truss Reactions are Less than 3,000 lbs. Unless Noted Otherwise.



-- Denotes Reaction Greater than 3,000 lbs. Reaction / # of Studs

LO.	AD (SHART F	OR	J	ACK.	STUD	s
	m	ASEN ON LAD	LES R	502	5(1) 4 (b))	
NU	nr(sc	N JACK STUD				A END OF	
		PEASE	.7061.1 ~	0001			~
END REACTION (OT PU)	SEQ DISTURS FOR CORN HEADER	SND PEACTLON	50. SQUES C 050	COURTY - DADER		ENB & ACTION (UP TO)	REQ'D STUDS FOR (4) MY HEADER
1700	1	255	iO .	1		3400	1
3400	2	510	0 7	2		6600	2
5100	3	765	i0 :	3		10200	3
6800	4	1020	00 -	4		13600	4
8500	5	1279	50 9	5		17000	5
10200	á	1530	00 6	6			
11900	7						
13600	8						
15300	9						

	BUILDER	Weaver Development	CITY / CO.	Cameron / Harnett	THIS IS A These truss the building sheets for ea	
	JOB NAME	Lot 5 Cedar Pointe	ADDRESS	Marks Road	is responsib the overall s walls, and co regarding br	
	PLAN	Magnolia I I "C"	MODEL	Roof	or online @ : Bearing rea prescriptive	
	SEAL DATE	Seal Date	DATE REV.	/ /	(derived from foundation than 3000# be retained	
	QUOTE #		DRAWN BY	Christine Shivy	specified in retained to	
-	JOB#	J0722-3627	SALES REP.	Lenny Norris	Signatu	

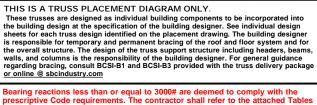

ROOF & FLOOR

Christine Shivy

Christine Shivy

Fayetteville, N.C. 28309

TRUSSES & BEAMS Reilly Road Industrial Park Phone: (910) 864-8787

Fax: (910) 864-4444

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