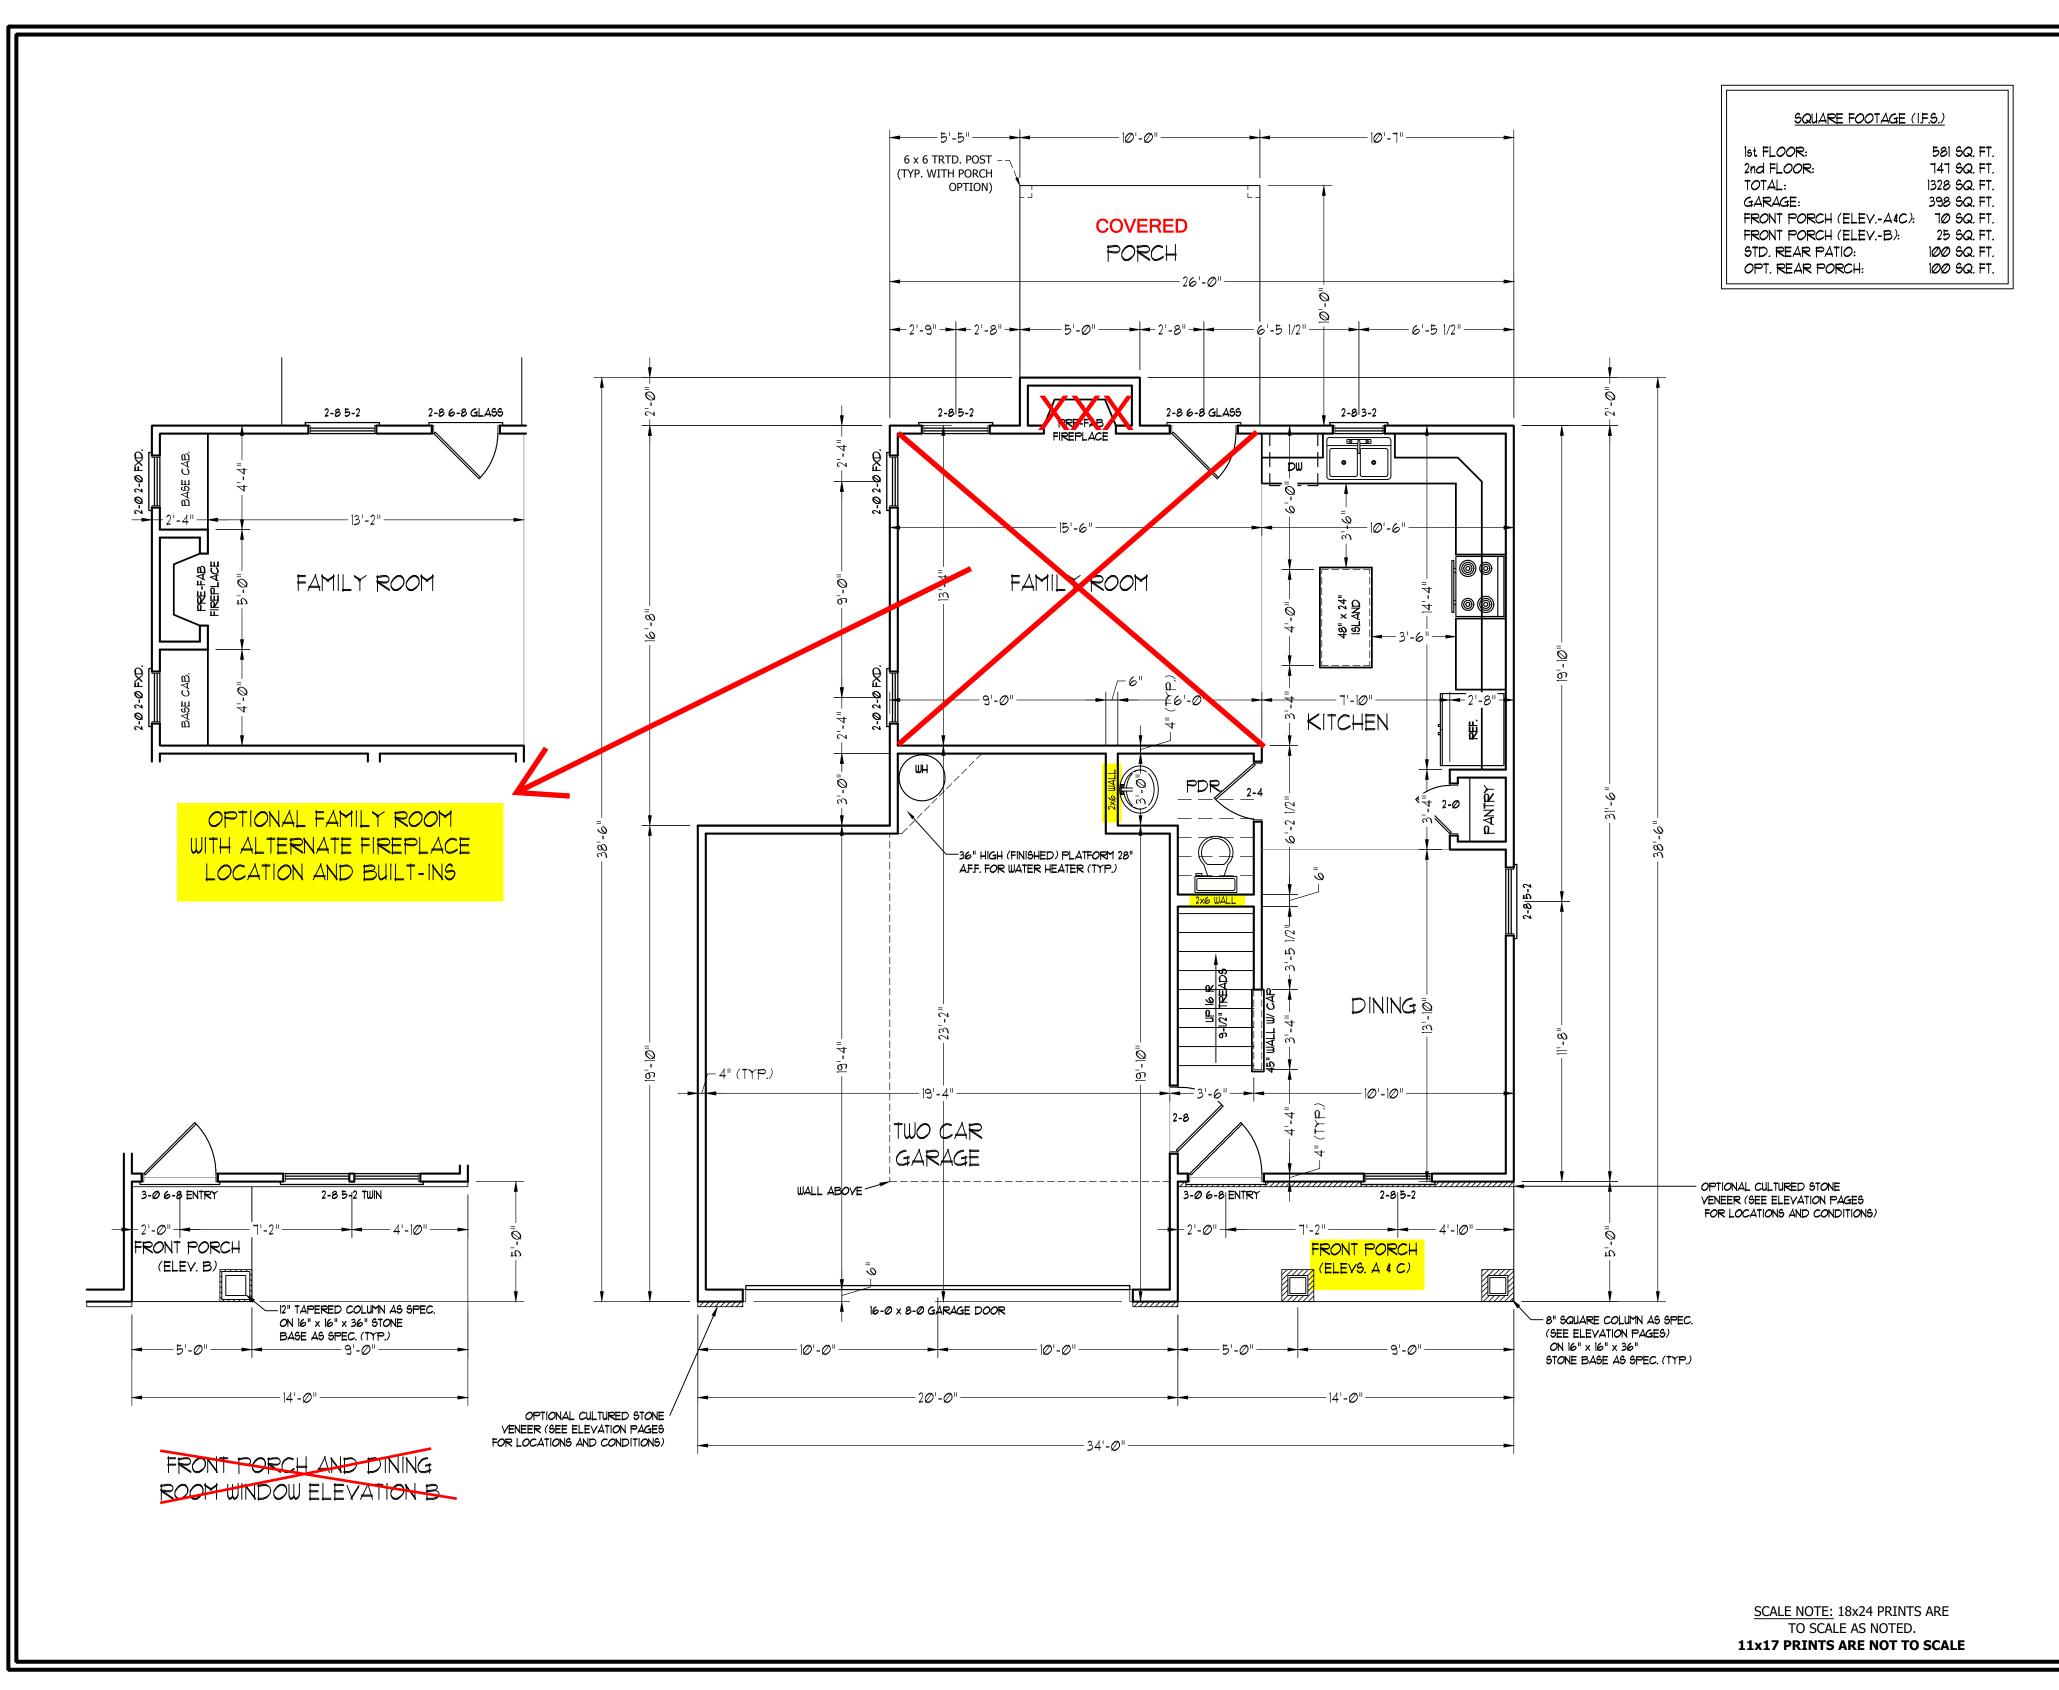


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WEAVER HOMES CAROLINA COLLECTION MAGNOLIA-II DRIVE LEFT

DATE: FEBRUARY 19, 2021

REV.:

SCALE: 1/4" = 1'-0"


DRAWN BY: WG

ENGINEERED BY:

REVIEWED BY:

FIRST FLOOR PLAN

A-4

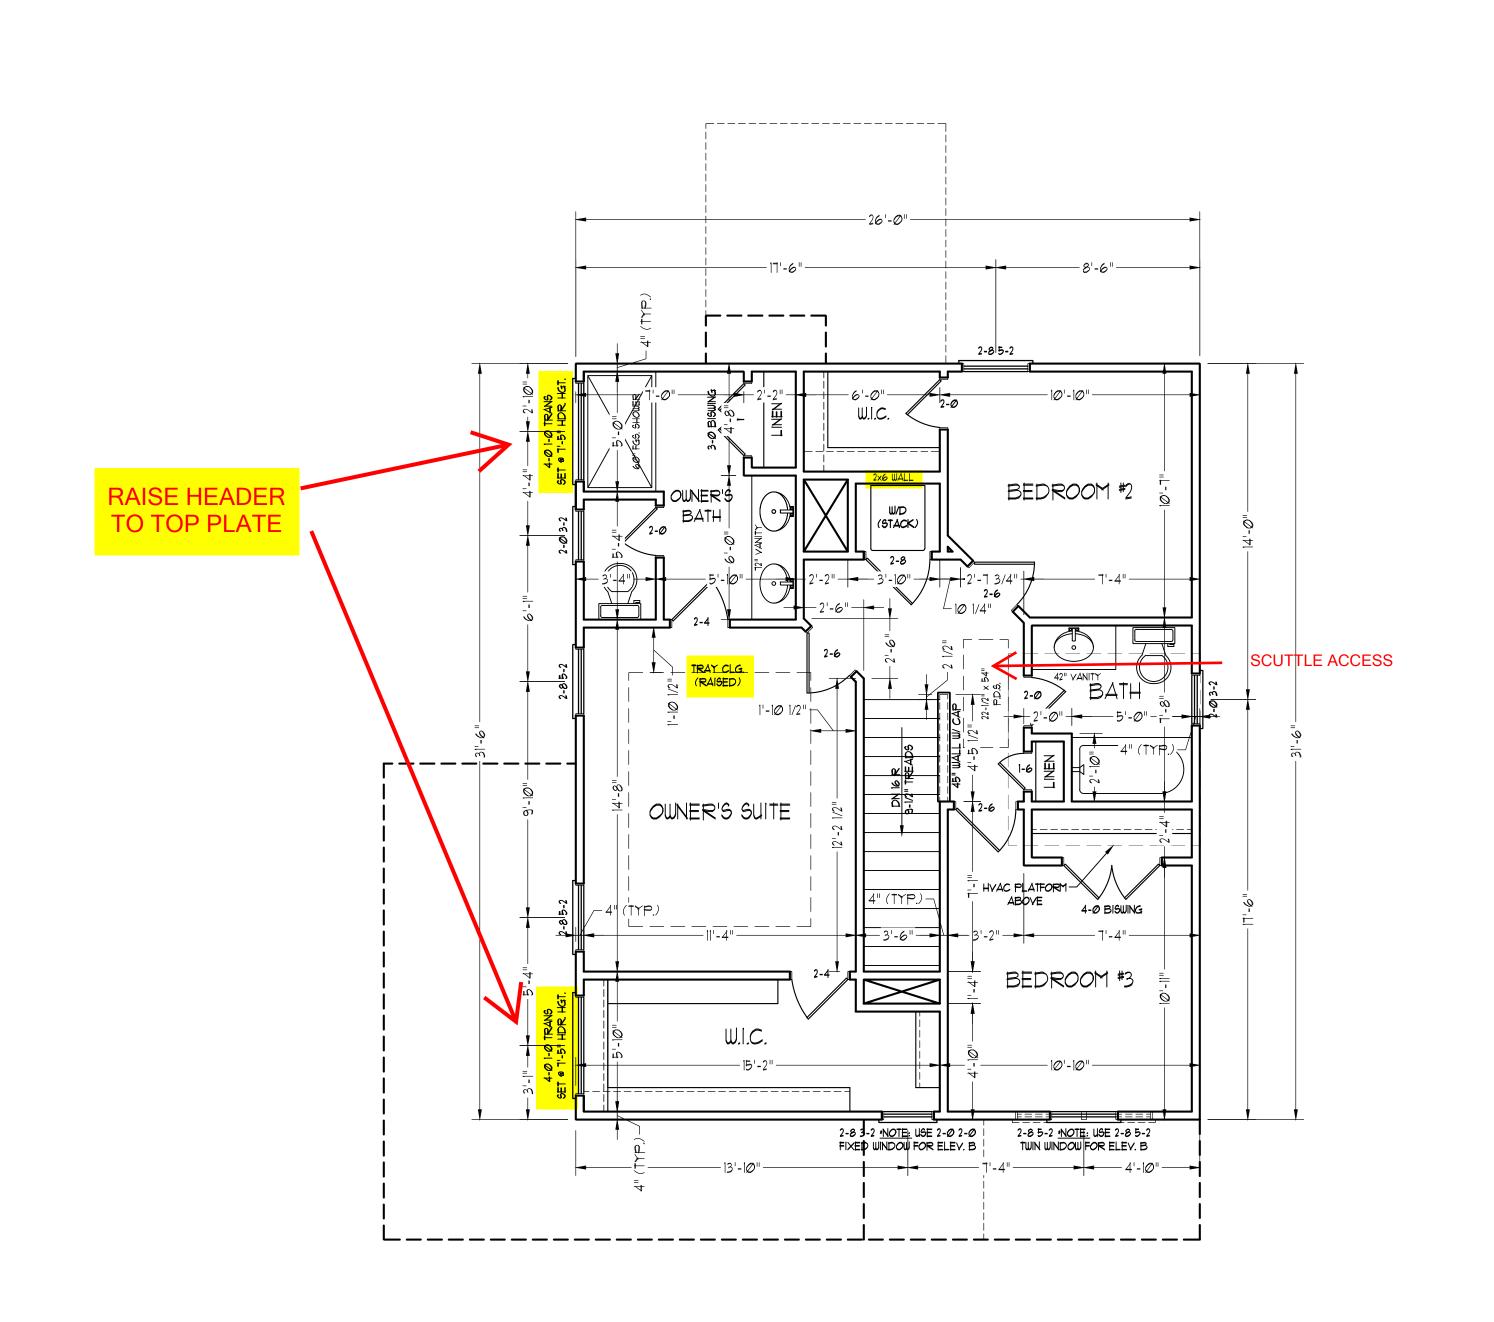

SCALE NOTE: 18x24 PRINTS ARE
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WEAVER HOMES CAROLINA COLLECTION MAGNOLIA-II DRIVE LEF

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SCALE: 1/4" = 1'-0"


DRAWN BY: WG

ENGINEERED BY:

REVIEWED BY:

SECOND FLOOR PLAN

A-5

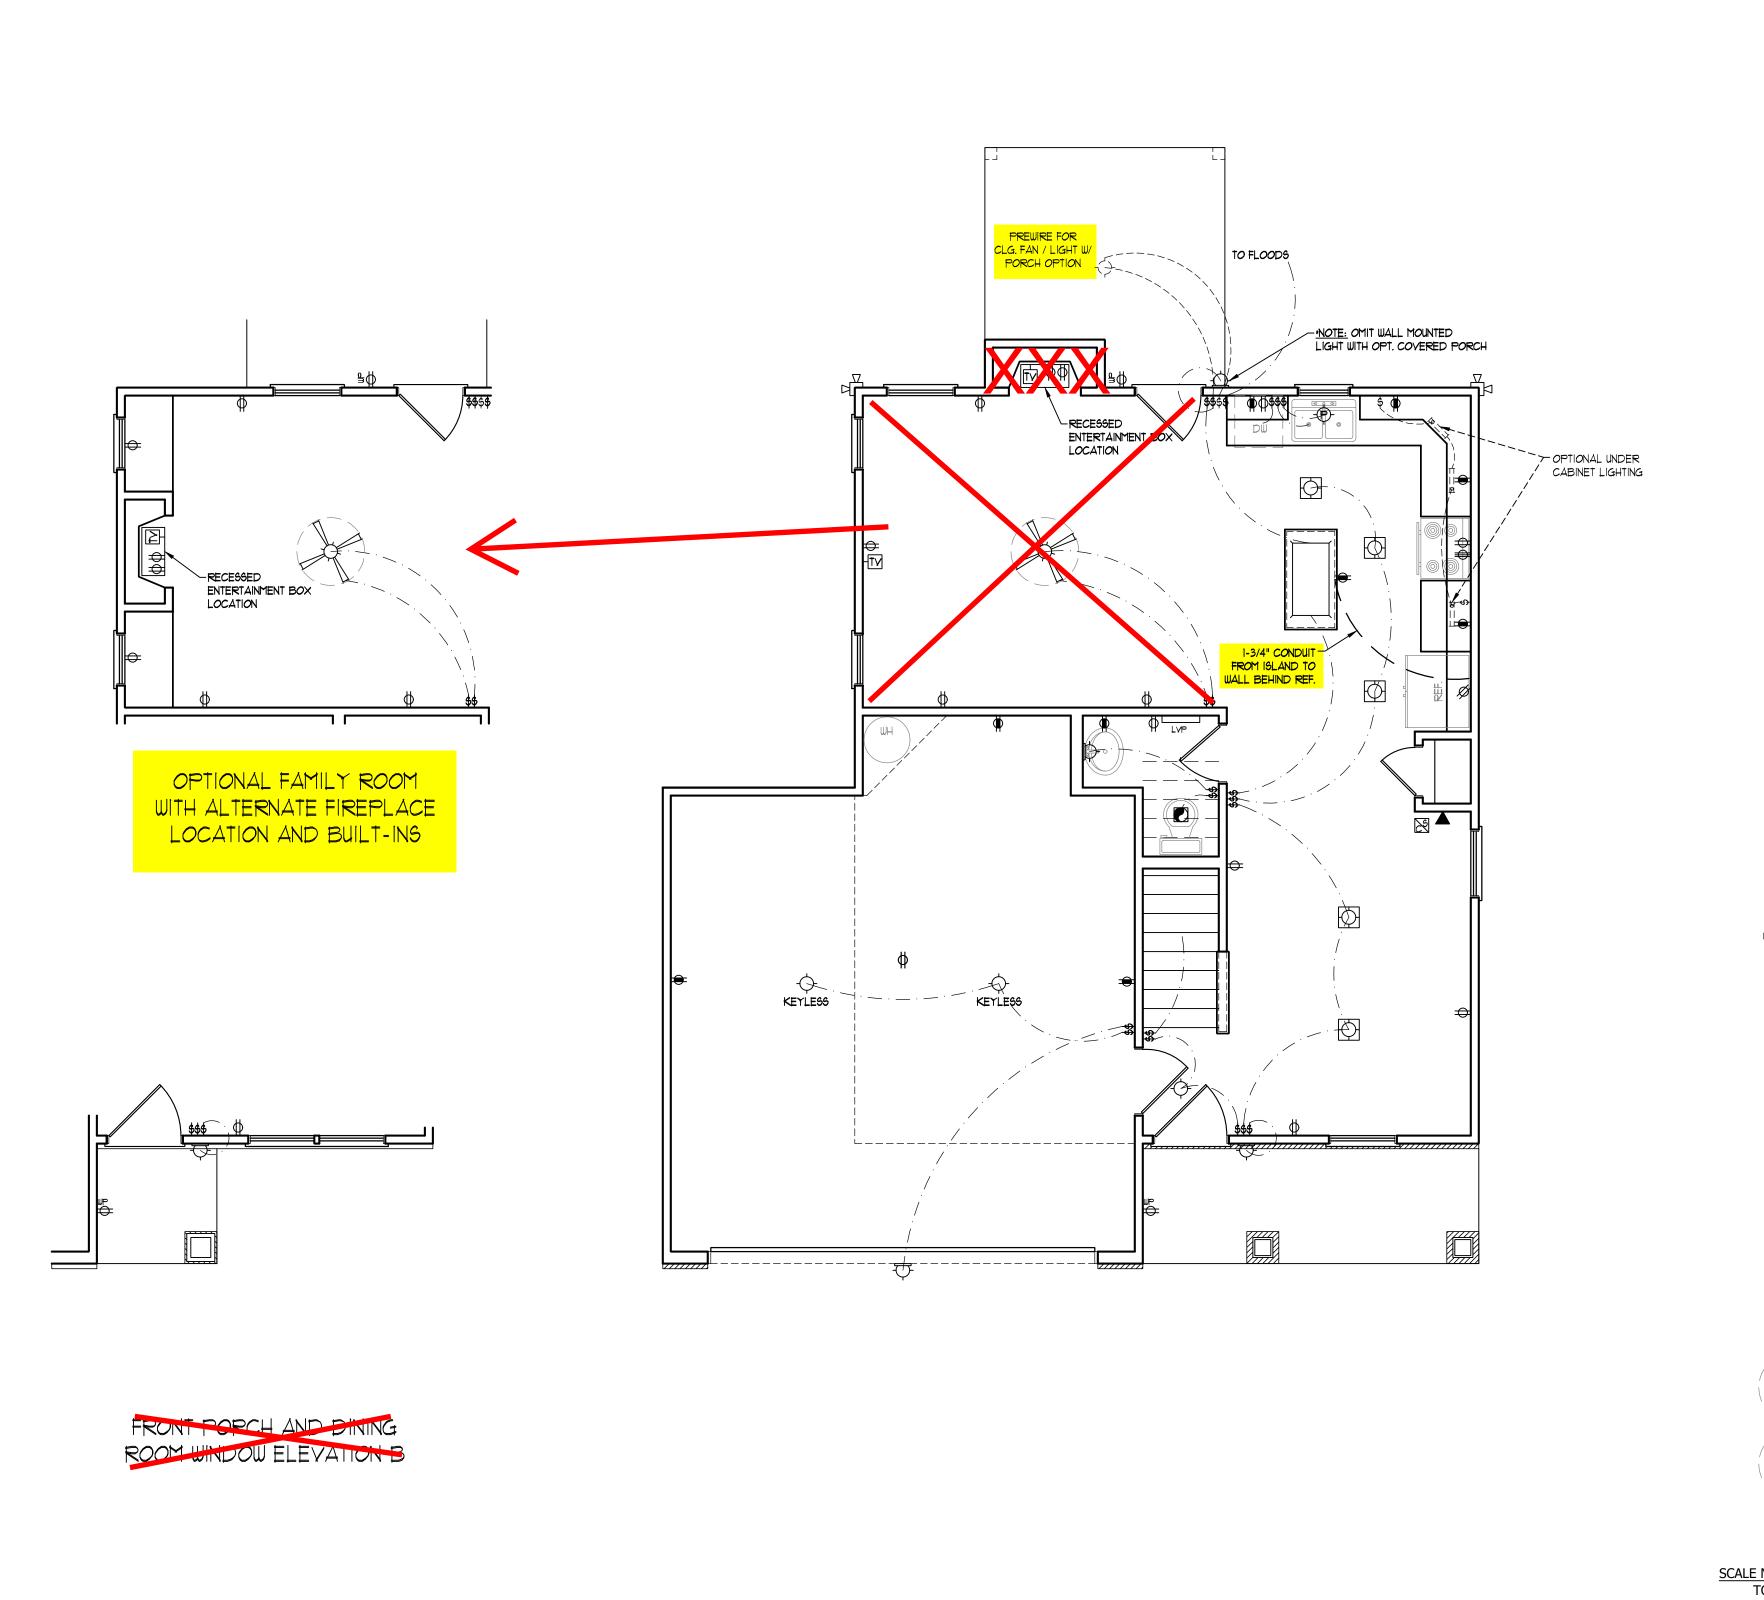



- I.) BLOCK AND WIRE FOR ALL CELING FANS PER PLAN.
- 2.) VANITY LIGHTS TO BE SET @ 90" AFF. (TYP.)
- 3.) ADDITIONAL EXTERIOR OUTLETS REQUIRED BY CODE TO BE LOCATED BY ELECTRICIAN.
- 4.) PLACE SWITCHES 8" (MIN.) FROM ROUGH OPENINGS.

ELECTRICAL LEGEND

- →
 IIØ ∨ OUTLET
- ₩ IIØ Y GFI OUTLET
- ⇒ 110 V SWITCHED OUTLET
- BB 110 Y BASEBOARD OUTLET
- 4-PLEX
- COUNTER OR FLOOR MOUNTED
- COUNTER OR FLOOR MOUNTED 110V GFI
- ₩EATHERPROOF
- **⇒** 22*0* ∨ *O*UTLET
- Ø IIØ Y DEDICATED CIRCUIT
- # 220 V DEDICATED CIRCUIT
- SPECIAL PURPOSE (240 V, ETC.)
- WALL MOUNT LIGHT
- -CEILING MOUNT LIGHT
- -P- PENDANT LIGHT
- RECESSED CAN LIGHT
- MINI CAN LIGHT
- EYEBALL LIGHT

FLUORESCENT LIGHT
UNDERCABINET LIGHT

— Undercadineilio 7

FLOOD LIGHT

SWITCH

\$D DIMMER SWITCH

▲ TELEPHONE

△ DATA

TELEPHONE AND DATA

TY- TY CONNECTION

TV/ DATA

CD- CONDUIT FOR COMPONENT WIRING

SP SPEAKER

110 V SMOKE/ CM DETECTOR

6D 110 Y SMOKE DETECTOR

EXHAUST FAN

LOW VOLTAGE PANEL

ALARM PANEL



/



CEILING FAN W/ LIGHT

SCALE NOTE: 18x24 PRINTS ARE
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DATE: FEBRUARY 19, 2021

DATE: FEBRUART I


SCALE: 1/4" = 1'-0"

DRAWN BY: WG
ENGINEERED BY:

REVIEWED BY:

FIRST FLOOR ELECTRICAL PLAN

E-1

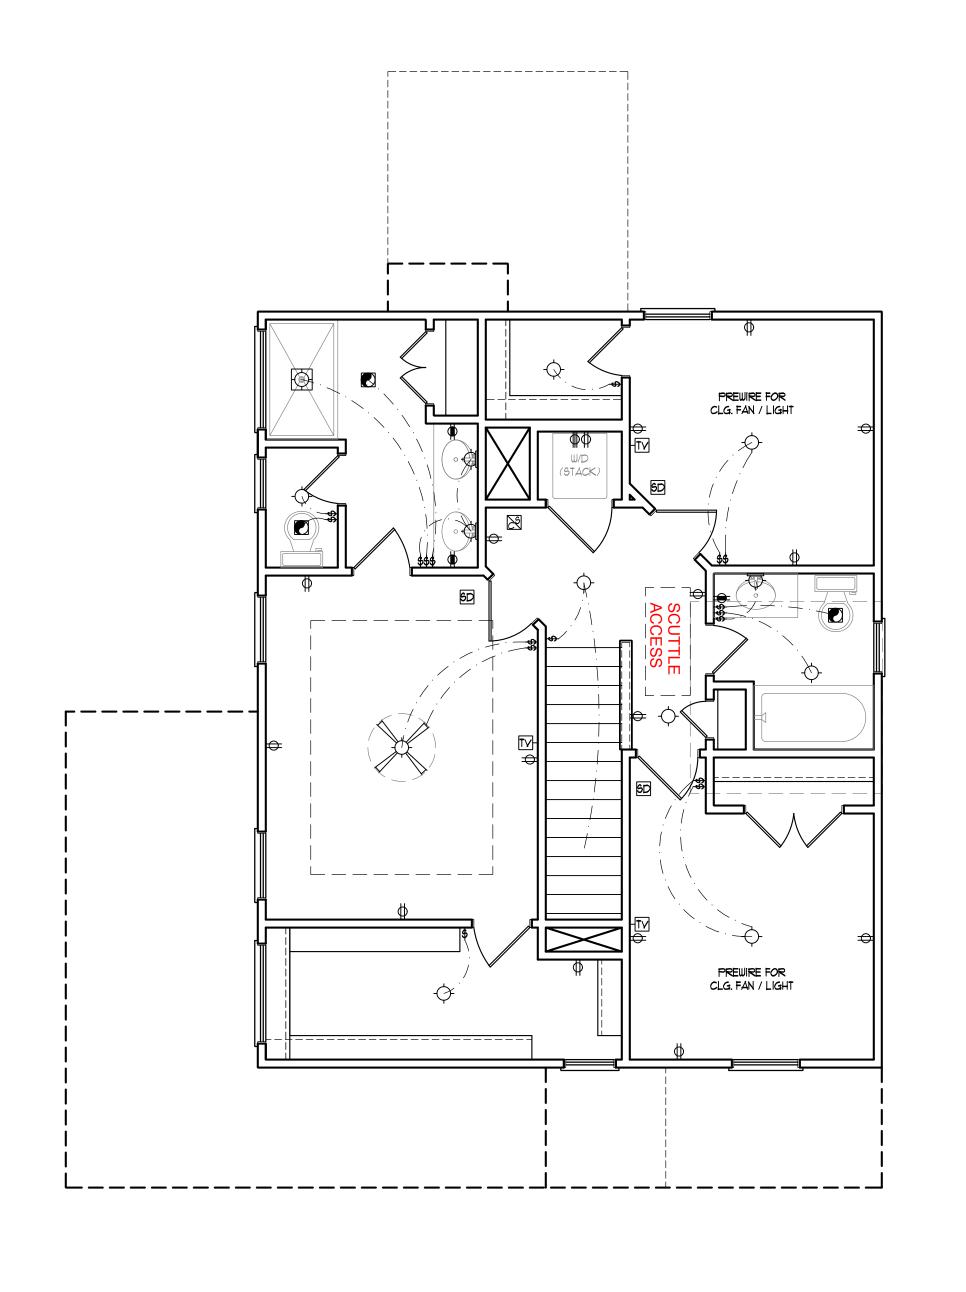

ELECTRICAL LAYOUT NOTES:

- 1.) BLOCK AND WIRE FOR ALL CELING FANS PER PLAN.
- 2.) VANITY LIGHTS TO BE SET @ 90" A.F.F. (TYP.)
- 3.) ADDITIONAL EXTERIOR OUTLETS REQUIRED BY CODE TO BE LOCATED BY ELECTRICIAN.
- 4.) PLACE SWITCHES 8" (MIN.) FROM ROUGH OPENINGS.

ELECTRICAL LEGEND

- ⇒ IIØ Y OUTLET
- ₩ IIØ Y GFI OUTLET
- → 110 V SWITCHED OUTLET
- BB IIØ V BASEBOARD OUTLET
- 4-PLEX
- COUNTER OR FLOOR MOUNTED
- COUNTER OR FLOOR MOUNTED 110V GFI
- ₩EATHERPROOF
- **⇒** 220 ∨ OUTLET
- 10 V DEDICATED CIRCUIT
- # 220 V DEDICATED CIRCUIT
- PH SPECIAL PURPOSE (240 V, ETC.)
- WALL MOUNT LIGHT
- -P- PENDANT LIGHT
- RECESSED CAN LIGHT
- MINI CAN LIGHT
- EYEBALL LIGHT

FLUORESCENT LIGHT

undercabinet light

FLOOD LIGHT

SWITCH \$D DIMMER SWITCH

▲ TELEPHONE

△ DATA

TELEPHONE AND DATA

TV- TV CONNECTION

CD- CONDUIT FOR COMPONENT WIRING

SP SPEAKER

110 V SMOKE/ CO DETECTOR

SD 110 Y SMOKE DETECTOR

EXHAUST FAN

LOW VOLTAGE PANEL ALARM PANEL





SCALE NOTE: 18x24 PRINTS ARE TO SCALE AS NOTED. 11x17 PRINTS ARE NOT TO SCALE



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DATE: FEBRUARY 19, 2021

SCALE: 1/4" = 1'-0" DRAWN BY: WG


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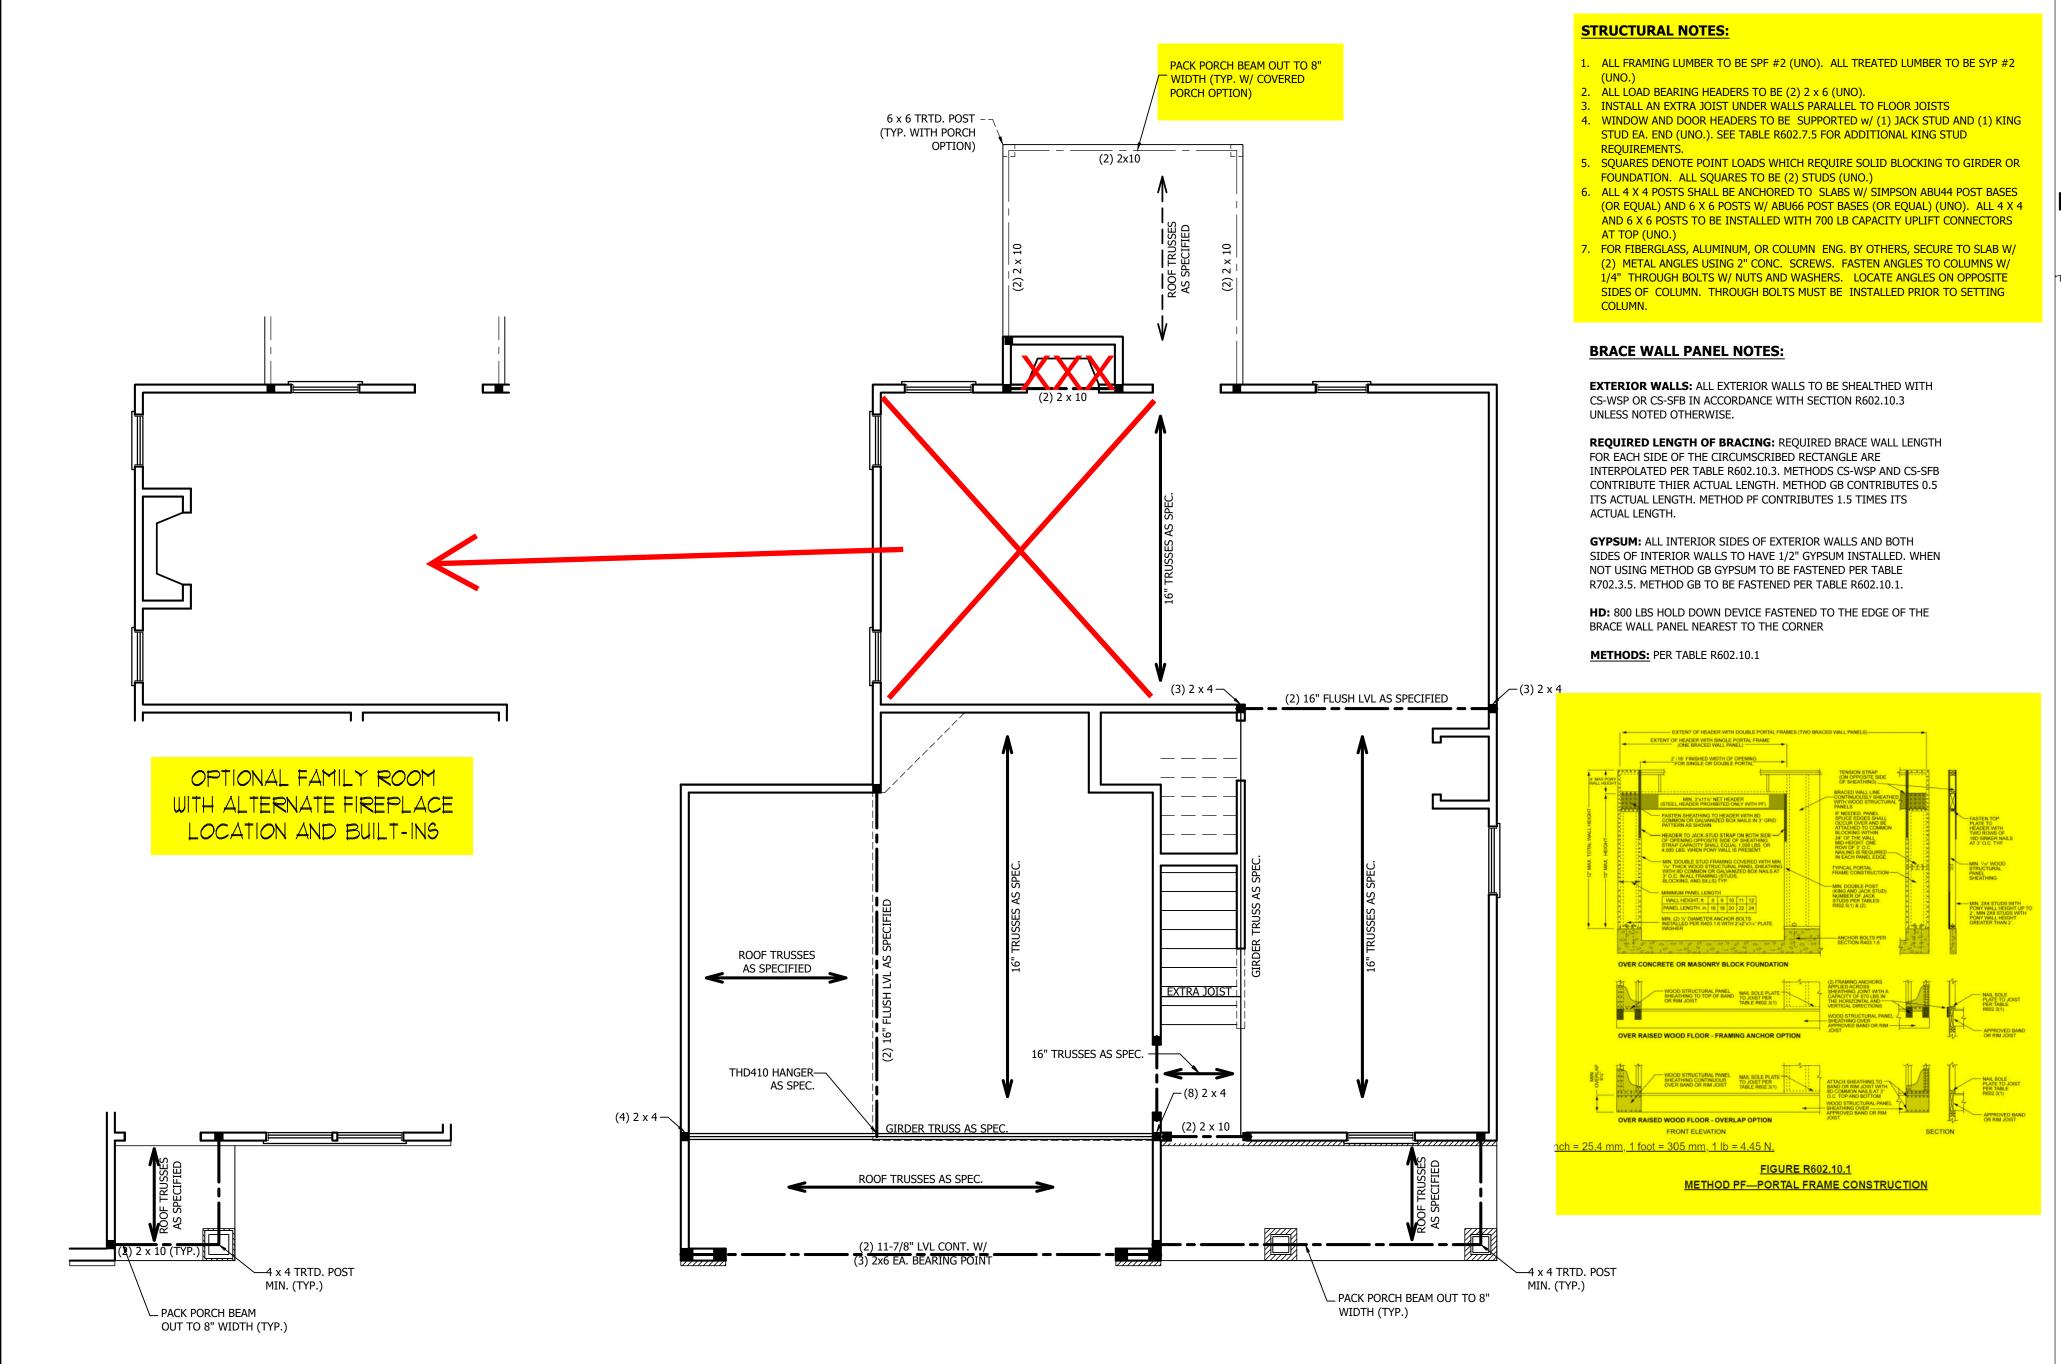
REVIEWED BY:

SECOND FLOOR ELCTRICAL

E-2

PLAN



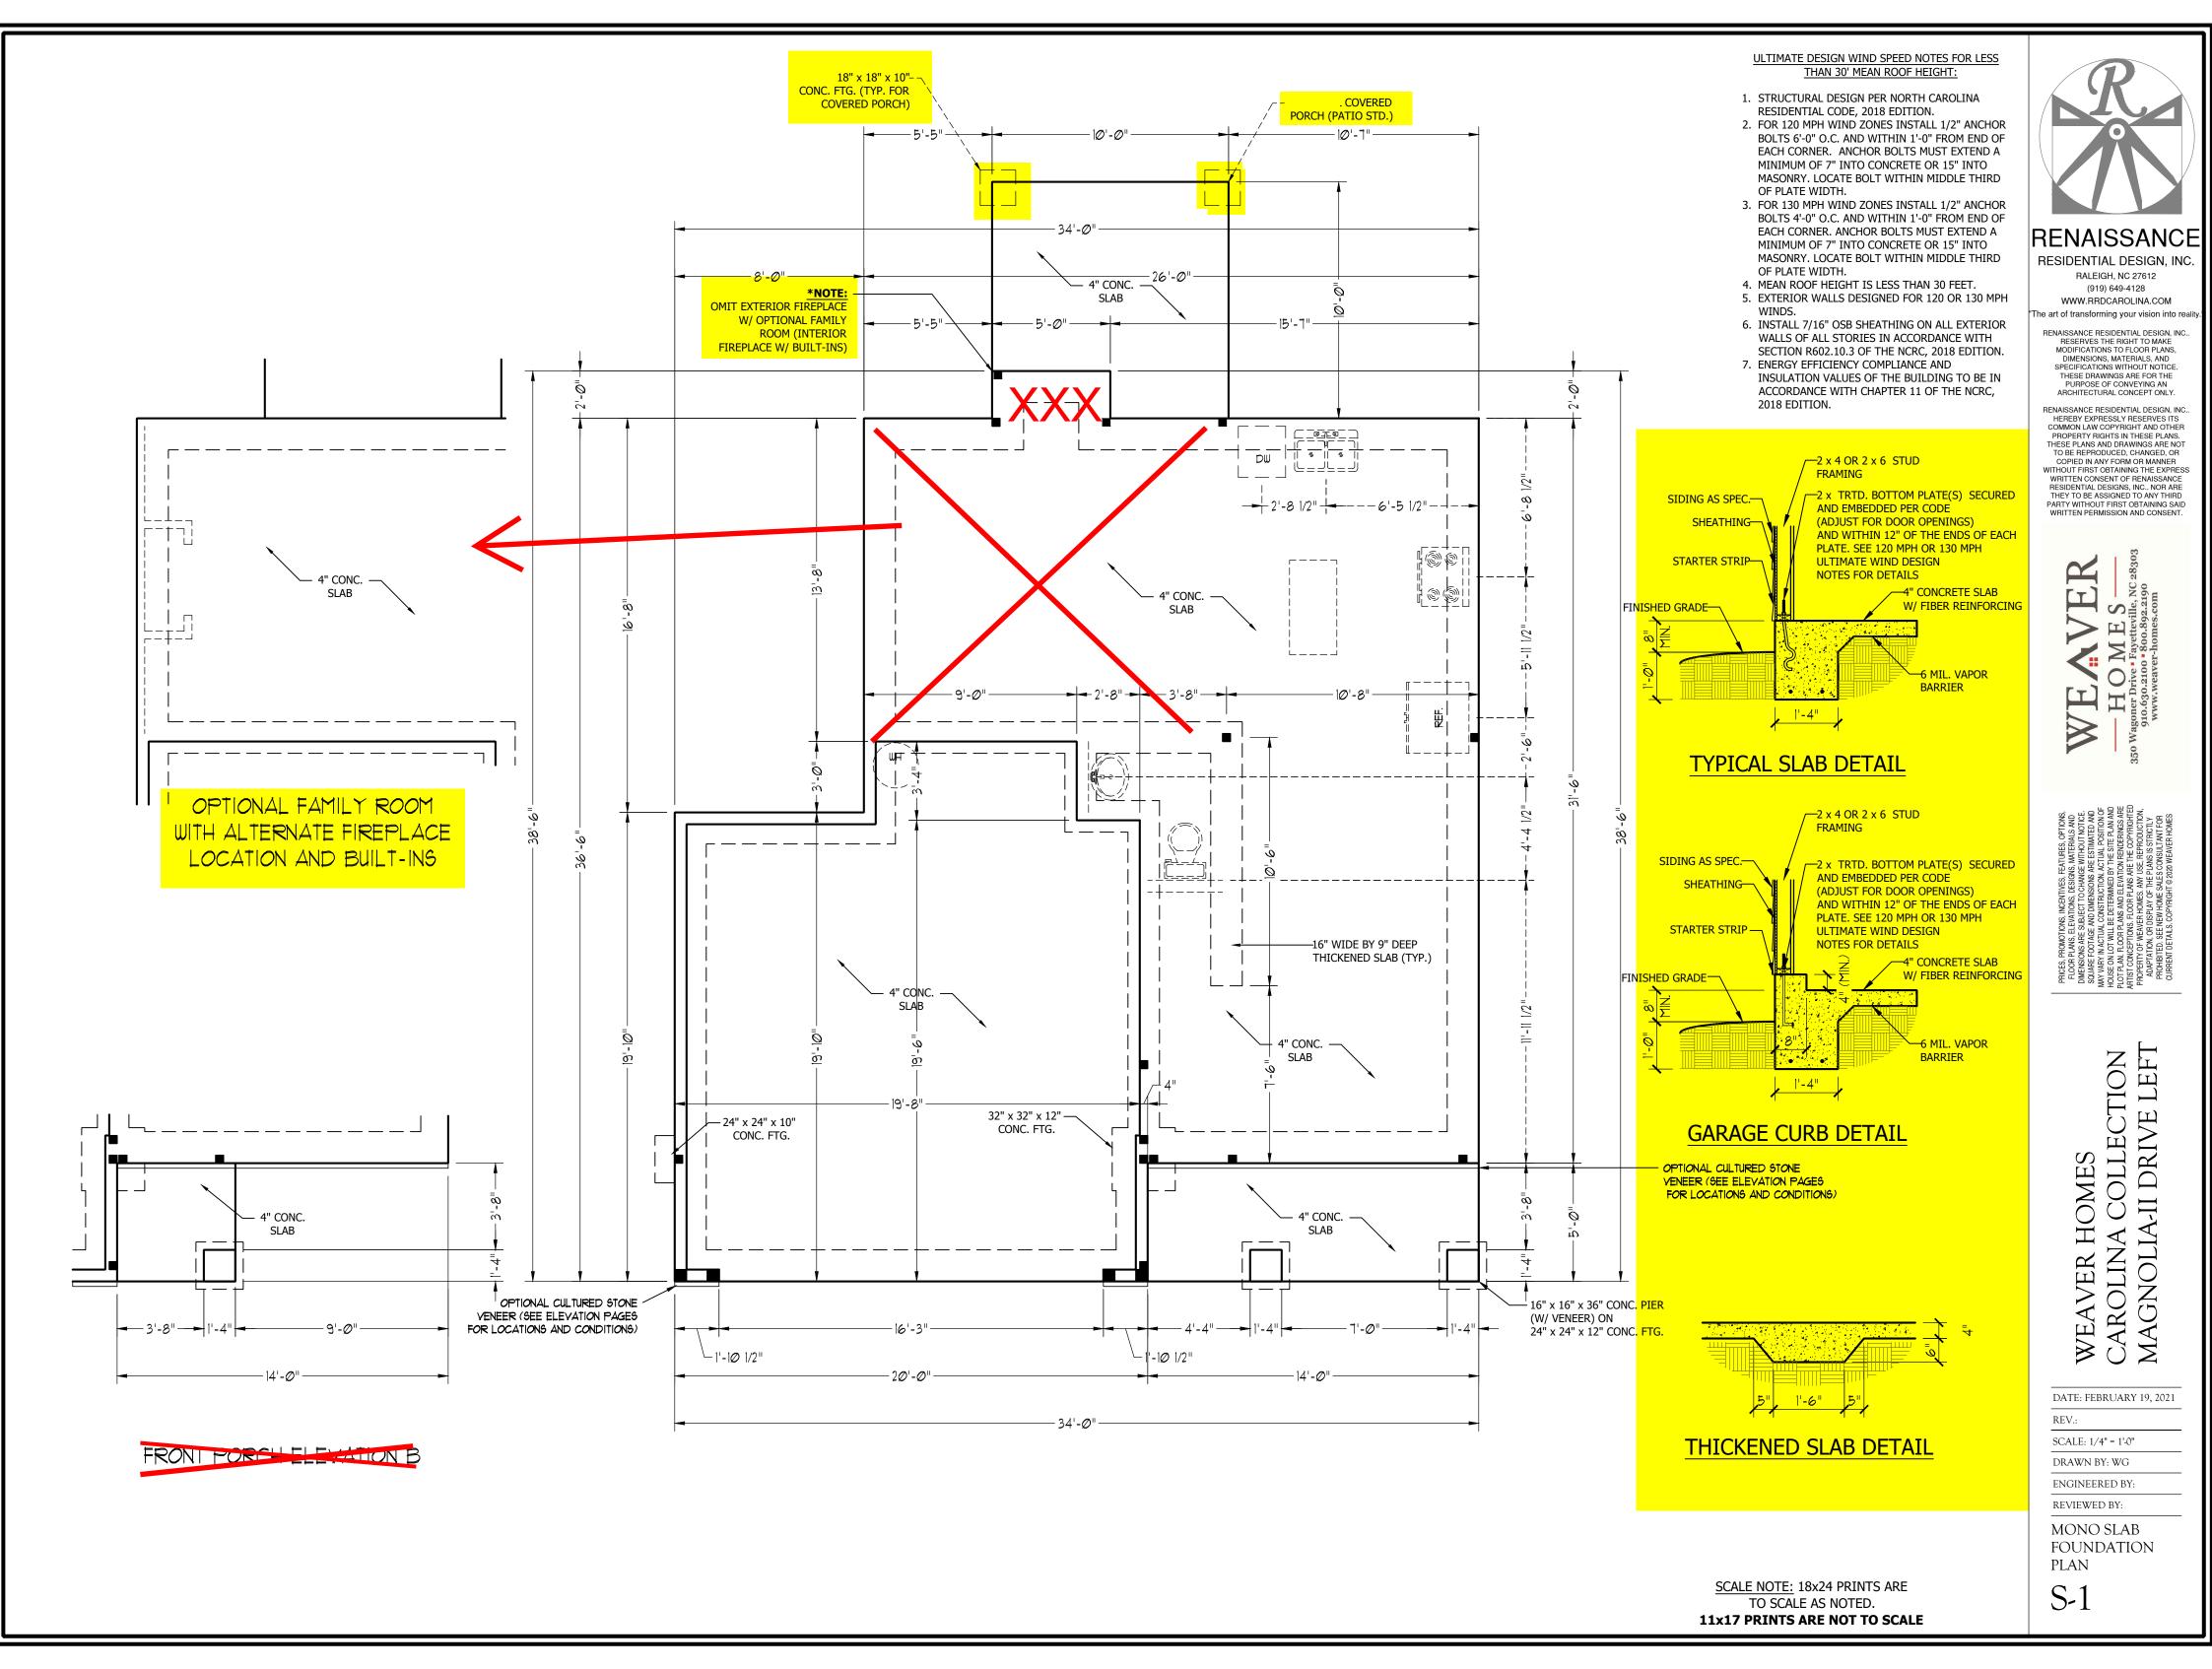

SCALE NOTE: 18x24 PRINTS ARE
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WEAVER HOMES CAROLINA COLLECTION MAGNOLIA-II DRIVE LEFT

DATE: FEBRUARY 19, 2021

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SCALE: 1/4" = 1'-0"

DRAWN BY: WG

ENGINEERED BY:

REVIEWED BY:

SECOND FLOOR FRAMING PLAN

S-2

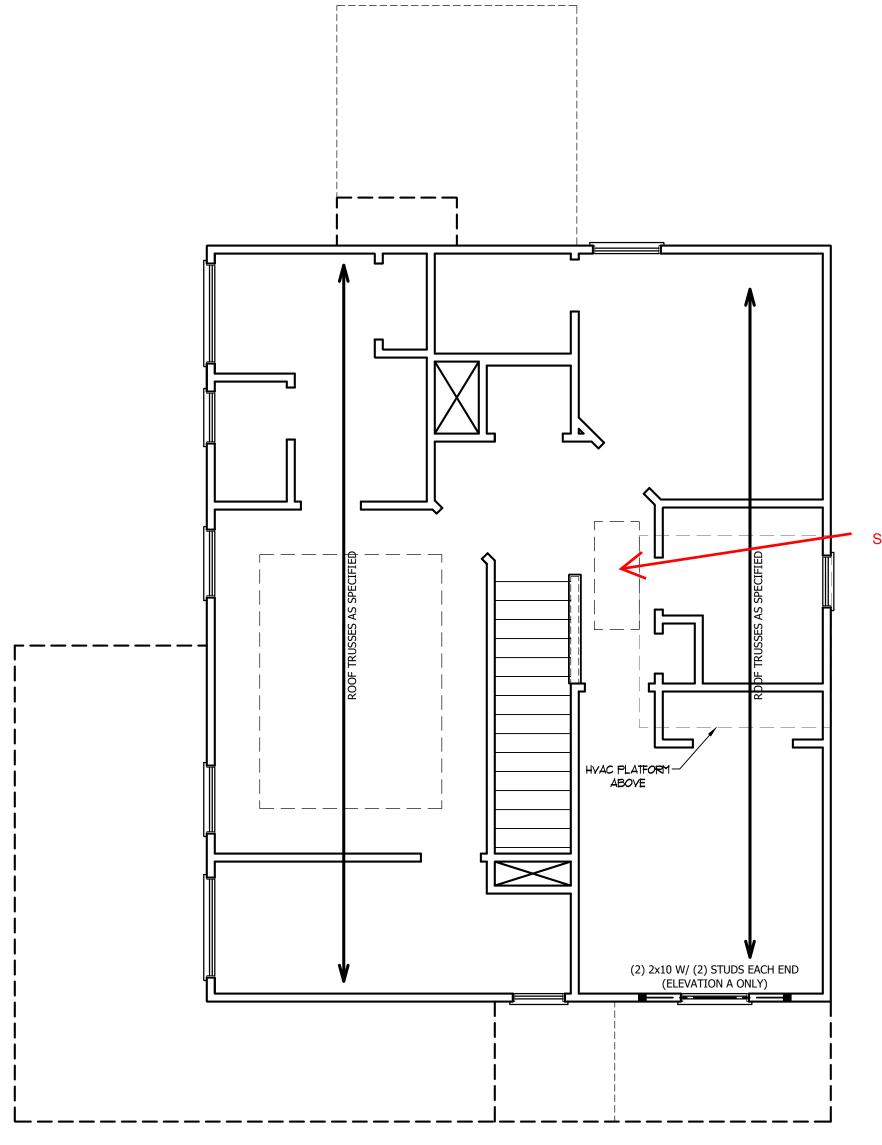


TABLE R602.7.5 MINIMUM NUMBER OF FULL HEIGHT STUDS AT EACH END OF HEADERS IN EXTERIOR WALLS

HEADER SPAN (FEET)	MAXIMUM STUD SPACING (INCHES) (PER TABLE R602.3(5)						
(== .)	16	24					
UP TO 3'	1	1					
4'	2	1					
8'	3	2					
12'	5	3					
16'	6	4					

STRUCTURAL NOTES:

- 1. ALL FRAMING LUMBER TO BE SPF #2 (UNO). ALL TREATED LUMBER TO BE SYP #2 (UNO.)
- 2. ALL LOAD BEARING HEADERS TO BE (2) 2 x 6 (UNO).
- 3. WINDOW AND DOOR HEADERS TO BE SUPPORTED w/ (1) JACK STUD AND (1) KING STUD EA. END (UNO.). SEE TABLE R602.7.5 FOR ADDITIONAL KING STUD REQUIREMENTS.
- 4. SQUARES DENOTE POINT LOADS WHICH REQUIRE SOLID BLOCKING TO GIRDER OR FOUNDATION. ALL SQUARES TO BE (2) STUDS (UNO.)

DSP - DOUBLE STUD POCKET TSP - TRIPLE STUD POCKET

SCUTTLE ACCESS



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DATE: FEBRUARY 19, 2021

SCALE: 1/4" = 1'-0" DRAWN BY: WG


ENGINEERED BY:

REVIEWED BY:

ATTIC FLOOR FRAMING PLAN

S-3

SCALE NOTE: 18x24 PRINTS ARE TO SCALE AS NOTED. 11x17 PRINTS ARE NOT TO SCALE

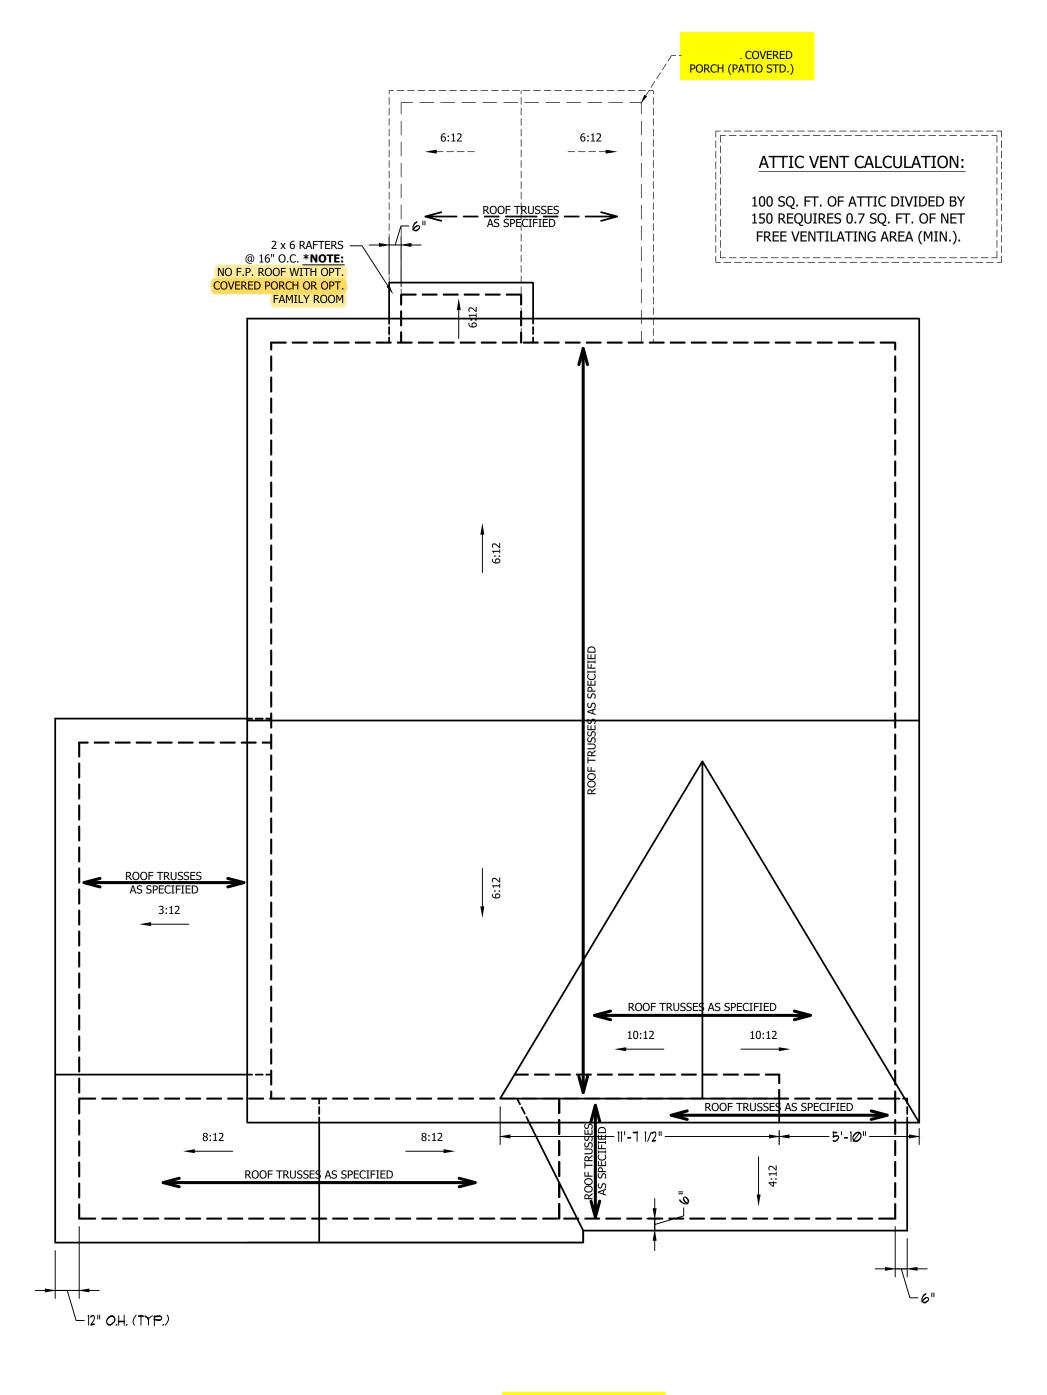

ATTIC VENT CALCULATION:

1250 SQ. FT. OF ATTIC DIVIDED BY 150 REQUIRES 8.3 SQ. FT. OF NET FREE VENTILATING AREA (MIN.).

STRUCTURAL NOTES:

- 1. ALL FRAMING LUMBER TO BE #2 SPF (UNO).
- 2. HIP SPLICES ARE TO BE SPACED A MIN. OF 8'-0". FASTEN MEMBERS WITH THREE ROWS OF 12d NAILS @ 16" O.C. (TYP.)
- 3. STICK FRAME OVER-FRAMED ROOF SECTIONS W/ 2 x 8 RIDGES, 2 x 6 RAFTERS @ 16" O.C. AND FLAT 2 x 10 VALLEYS OR USE VALLEY TRUSSES.
- 4. FASTEN FLAT VALLEYS TO RAFTERS OR TRUSSES WITH SIMPSON H2.5A HURRICANE TIES @ 32" O.C. MAX. PASS HURRICANE TIES THROUGH NOTCH IN ROOF SHEATHING. EACH RAFTER IS TO BE FASTENED TO THE FLAT VALLEY WITH A MIN. OF (6) 12d TOE NAILS.
- REFER TO SECTION R802.11 OF THE 2018 NCRC FOR REQUIRED UPLIFT RESISTANCE AT RAFTERS AND TRUSSES.





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VEAVER HOMES SAROLINA COLLECTION 1AGNOLIA-II DRIVE LEFT

DATE: FEBRUARY 19, 2021

REV ·

SCALE: 1/4" = 1'-0"

DRAWN BY: WG


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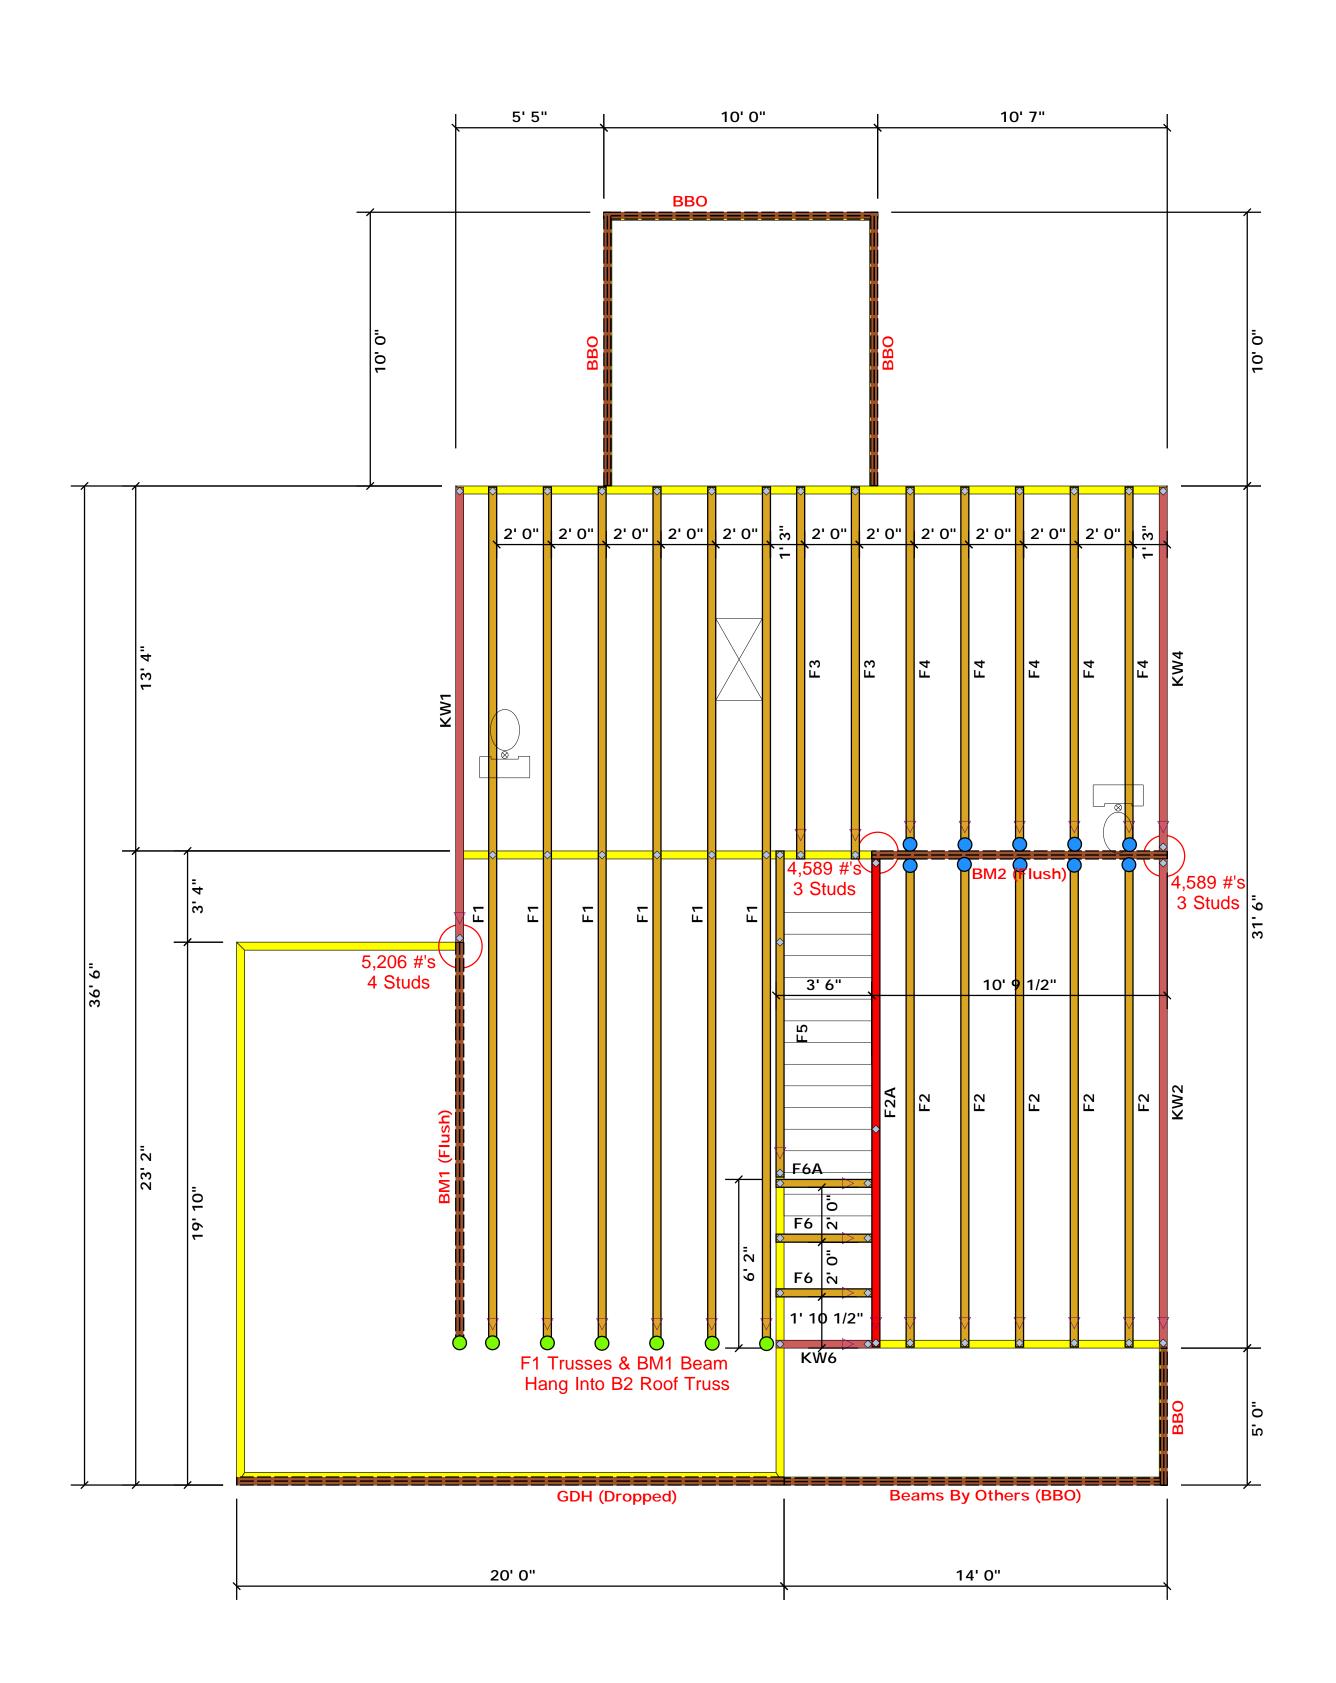
REVIEWED BY:

ROOF PLAN ELEVATION - C

S-4

ELEVATION C



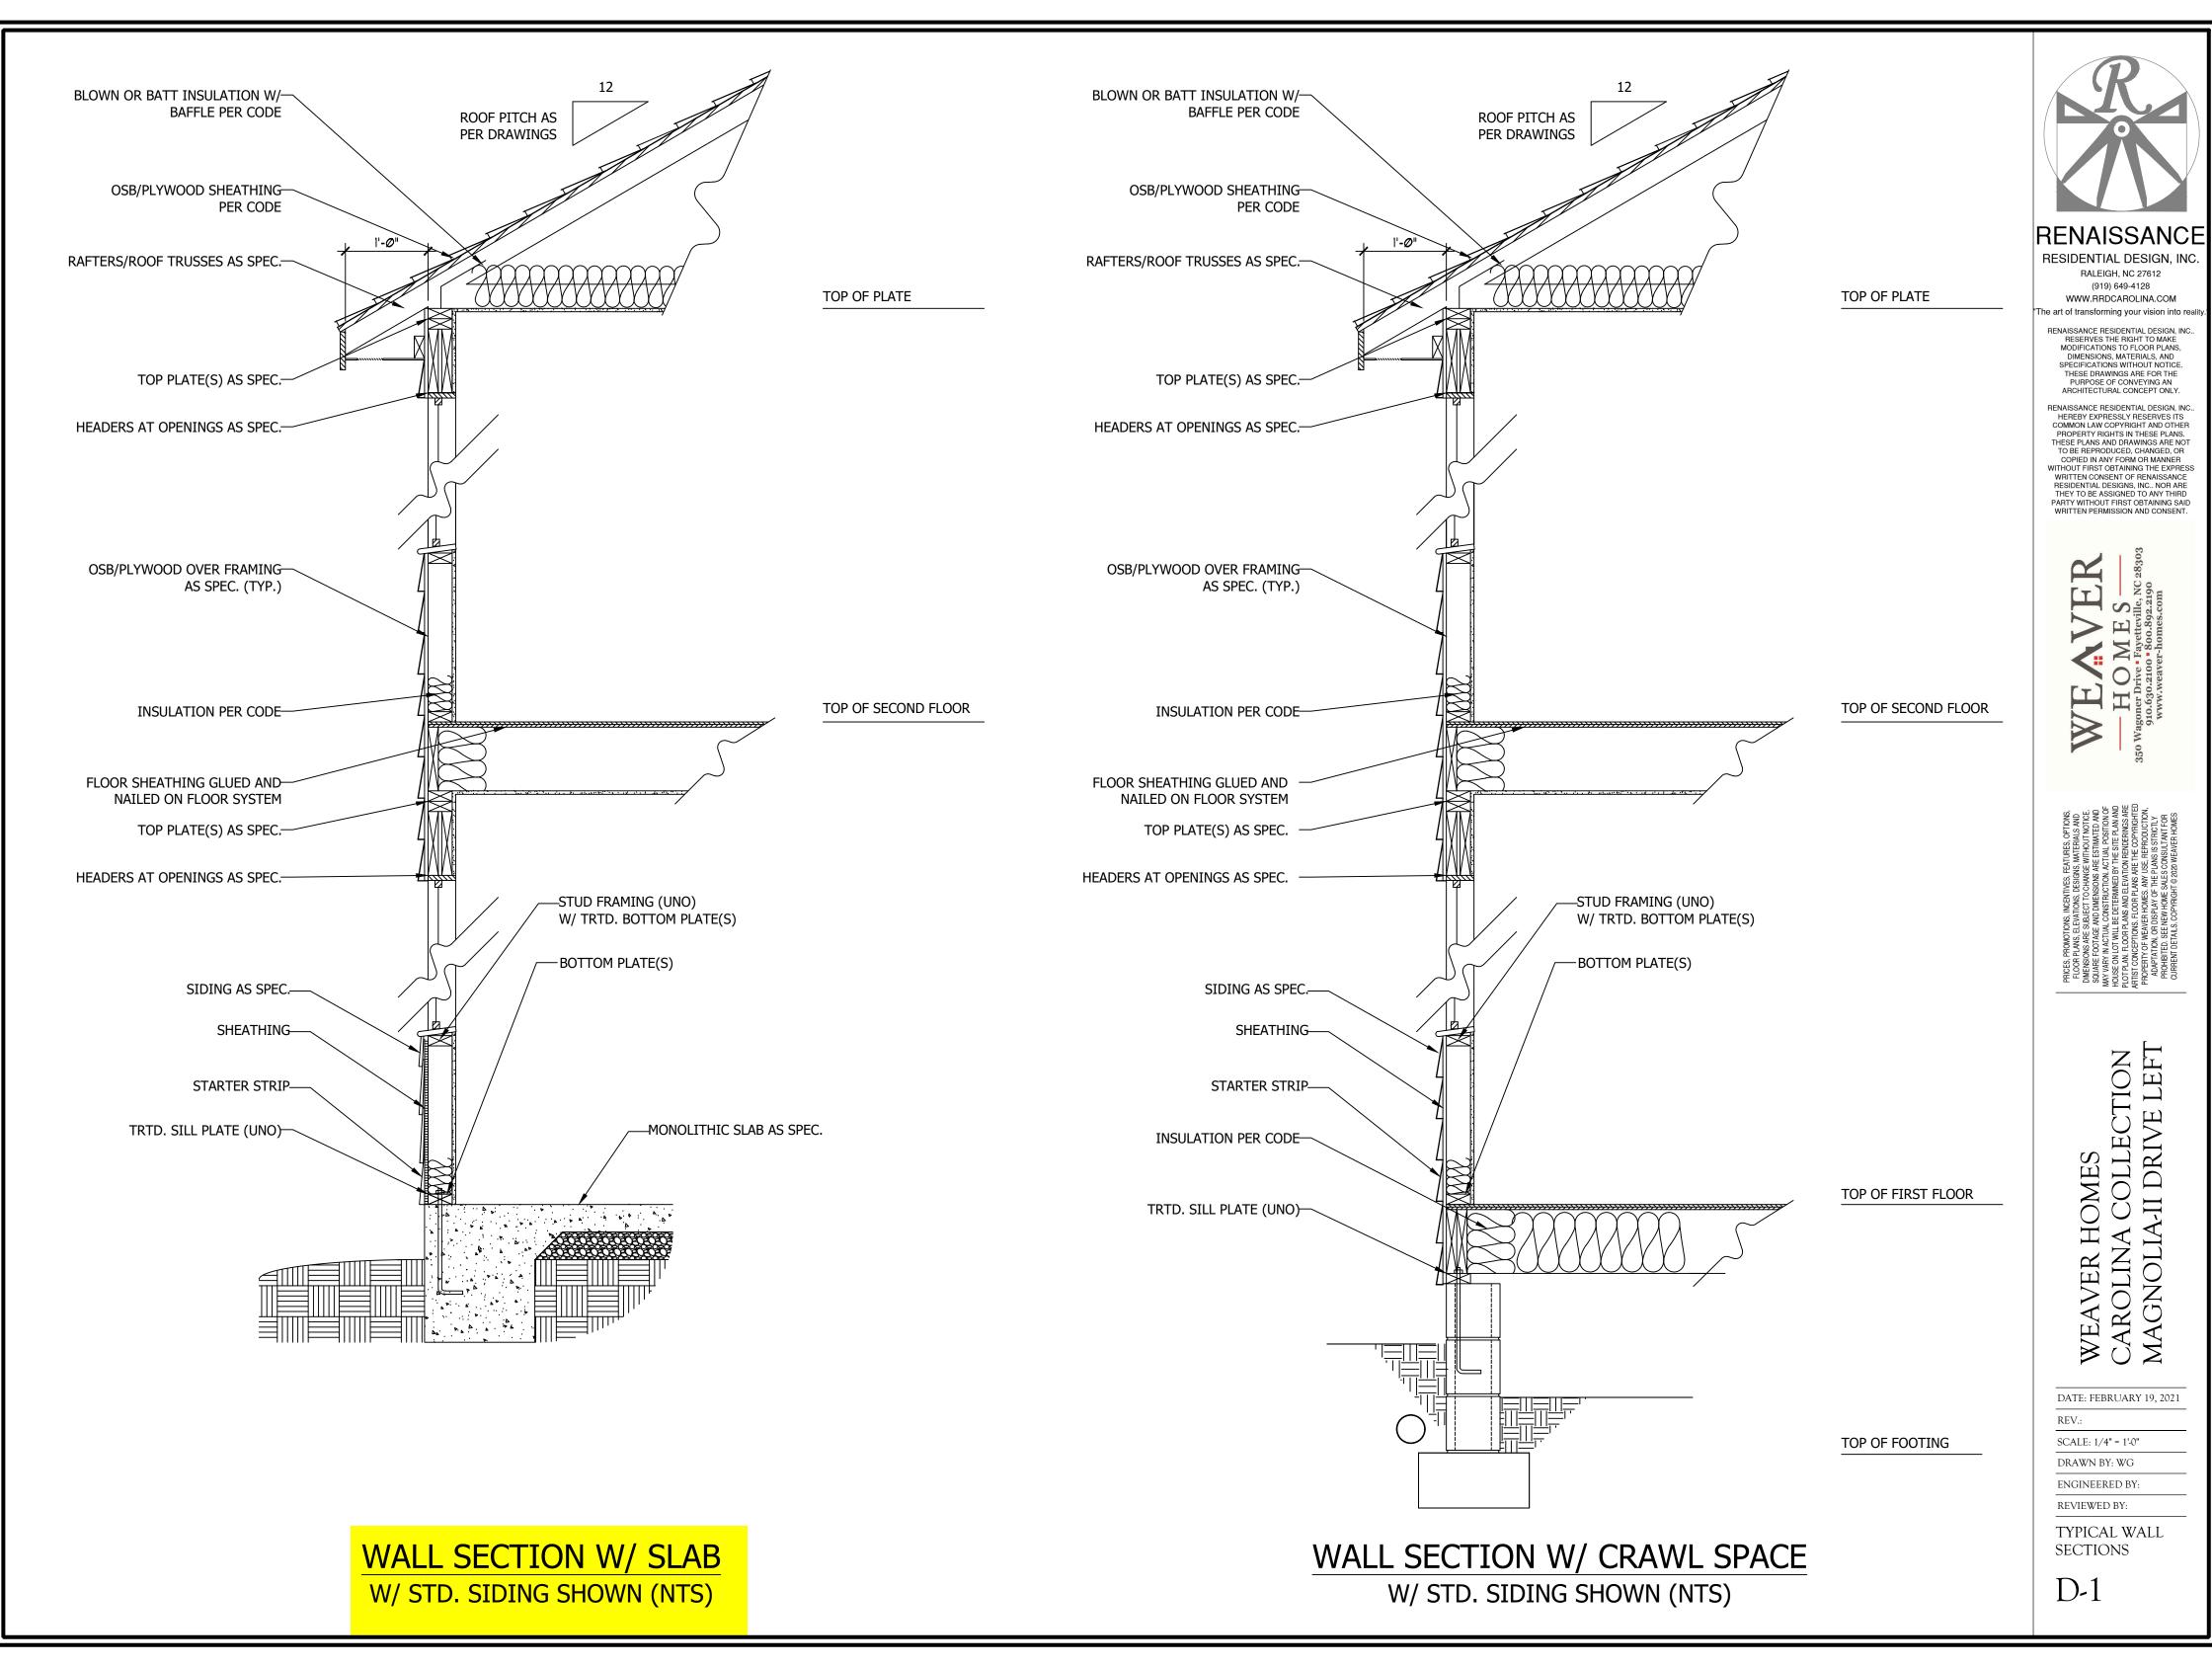

Connector Information Nail Information Supported Member Product Manuf Qty Header Truss USP 10 16d/3-1/2" HUS410 NA 16d/3-1/2" THD410 USP 16d/3-1/2" 10d/3"

Truss Placement Plan SCALE: NTS

▲= Denotes Left End of Truss (Reference Engineered Truss Drawing)

		Products			
PlotID	Length	Product	Plies	Net Qty	Fab Type
GDH (Dropped)	20' 0"	1-3/4"x 11-7/8" LVL Kerto-S	2	2	FF
BM1 (Flush)	15' 0"	1-3/4"x 16" LVL Kerto-S	2	2	FF
BM2 (Flush)	11' 0"	1-3/4"x 16" LVL Kerto-S	2	2	FF

All Truss Reactions are Less than 3,000 lbs. Unless Noted Otherwise.

-- Denotes Reaction Greater than 3,000 lbs. Reaction / # of Studs

_	LO.	AD 6	HART	FOI	R J	ACK.	STUD	5
		00	ASEN ON 1	ABLES	R502	5(1) 4.0	b))	
	No	MPES C	F JACK ST	ugo at Koerye			A CND OF	
		α	72	10000	a	ì		ø
	A5130N	HEADER HEADER	e e	į.	TUDS FOR		M2520 E 20	TEASE.
	CND 85ACT 07 FQ	SCORING SPANE	9	CLAS CLAS	86.00 57.00		25.50 27.50	(A) PLO
	_	77	_		1		2400	
	1700	1		550			3400	1
	3400	2	5	100	2		6600	2
	5100	3	7	650	3		10200	3
	6800	4	10	200	4		13600	4
	8500	5	12	750	5		17000	5
	10200	á	15	300	6			
	11900	7						
	13600	8						
	15300	~						

BUILDER	Weaver Development	CITY / CO.	Cameron / Harnett	tl s
JOB NAME	Lot 3 Cedar Pointe	ADDRESS	Marks Road	is tl v
PLAN	Magnolia I I "C"	MODEL	Floor	B
SEAL DATE	Seal Date	DATE REV.	/ /	fo tl b
QUOTE #	Quote #	DRAWN BY	Christine Shivy	s r
JOB #	J0722-3633	SALES REP.	Lenny Norris	




Christine Shivy

Christine Shivy

ROOF & FLOOR TRUSSES & BEAMS Reilly Road Industrial Park

соттесн

Fayetteville, N.C. 28309 Phone: (910) 864-8787 Fax: (910) 864-4444

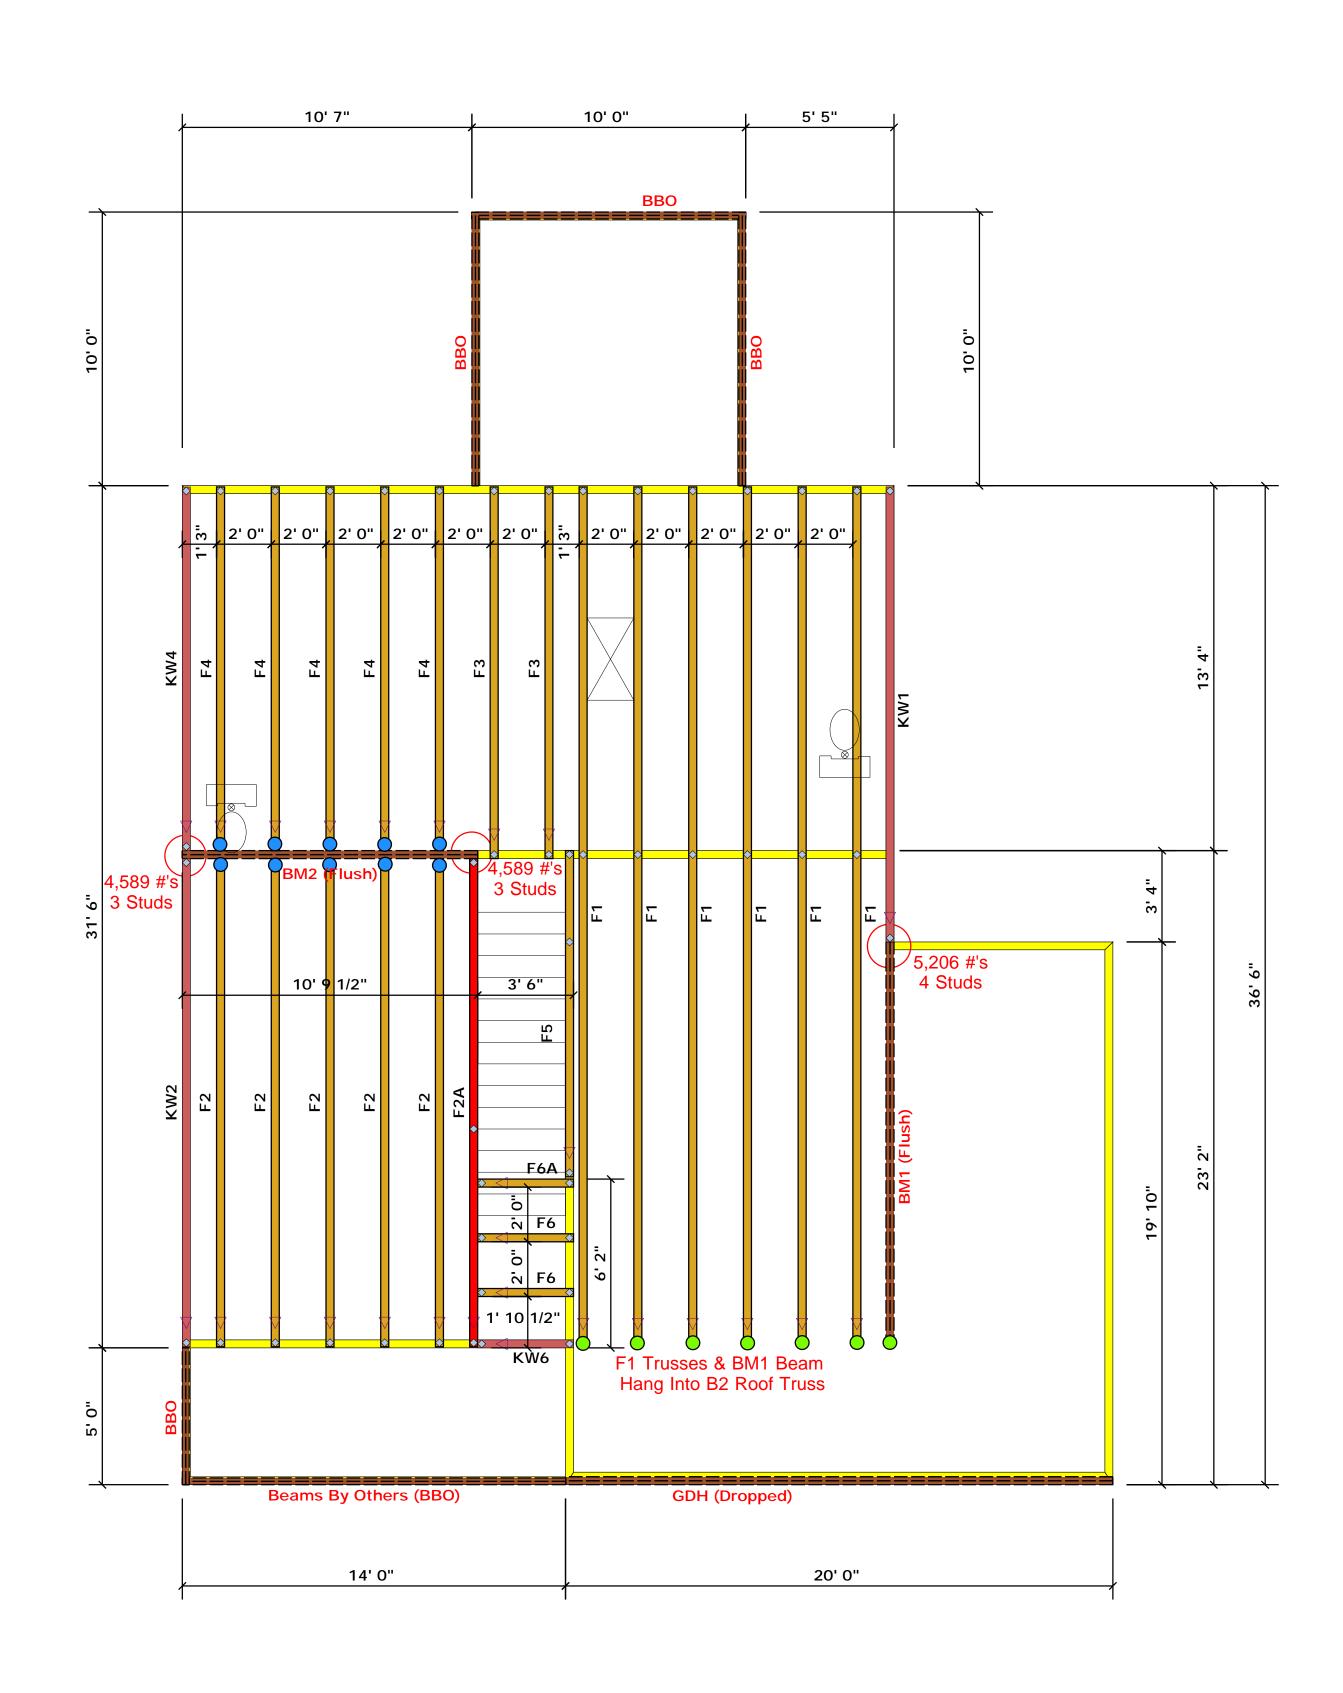

Connector Information Nail Information Supported Member Product Manuf Qty Header Truss HUS410 USP 10 16d/3-1/2" NA 16d/3-1/2" THD410 USP NA 16d/3-1/2" 10d/3"

Truss Placement Plan SCALE: NTS

▲ = Denotes Left End of Truss
(Reference Engineered Truss Drawing)

Products								
PlotID	Length	Product	Plies	Net Qty	Fab Type			
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BM1 (Flush)	15' 0"	1-3/4"x 16" LVL Kerto-S	2	2	FF			
BM2 (Flush)	11' 0"	1-3/4"x 16" LVL Kerto-S	2	2	FF			

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-- Denotes Reaction Greater than 3,000 lbs.

Reaction / # of Studs

_	LO.	AD (HART F	OR J	ACK STUD	5
		00	ANED ON TABL	F5 R502	5(1) 4 (6))	
	NU	nr(s c			(C) (Q) (A) (Q) (Q)	
			PEAGE	Welkoe.	`	er.
	END REACTION (OT FU)	SEC DISTURS FOR CORN HEADER	SNE PENCTION CLF TO	ABO SETUDS FOR ABON - MARK	ENB 81ACTOON (U* 10)	REQUESTADS FOR (4) MAY HEADER
	1700	1	2550	0 1	3400	1
	3400	2	5100	2 (6600	2
	5100	3	7650	0 3	10200	3
	6800	4	1020	0 4	13600	4
	8500	5	1275	0 5	17000	5
	10200	á	1530	0 6		
	11900	7				
	13600	8				
	15300	9				

	BUILDER	Weaver Development	CITY / CO.	Cameron / Harnett	THIS IS These true the building
	JOB NAME	Lot 3 Cedar Pointe	ADDRESS	Marks Road	is respons the overall walls, and regarding
	PLAN	Magnolia I I "C"	MODEL	Floor	Bearing represcripti
	SEAL DATE	Seal Date	DATE REV.	/ /	(derived foundation than 3000 be retained
	QUOTE #	Quote #	DRAWN BY	Christine Shivy	specified retained t
-	JOB #	J0722-3633	SALES REP.	Lenny Norris	Signat



Christine Shivy


Christine Shivy

ROOF & FLOOR
TRUSSES & BEAMS

Reilly Road Industrial Park

Reilly Road Industrial Park Fayetteville, N.C. 28309 Phone: (910) 864-8787 Fax: (910) 864-4444

соттесн

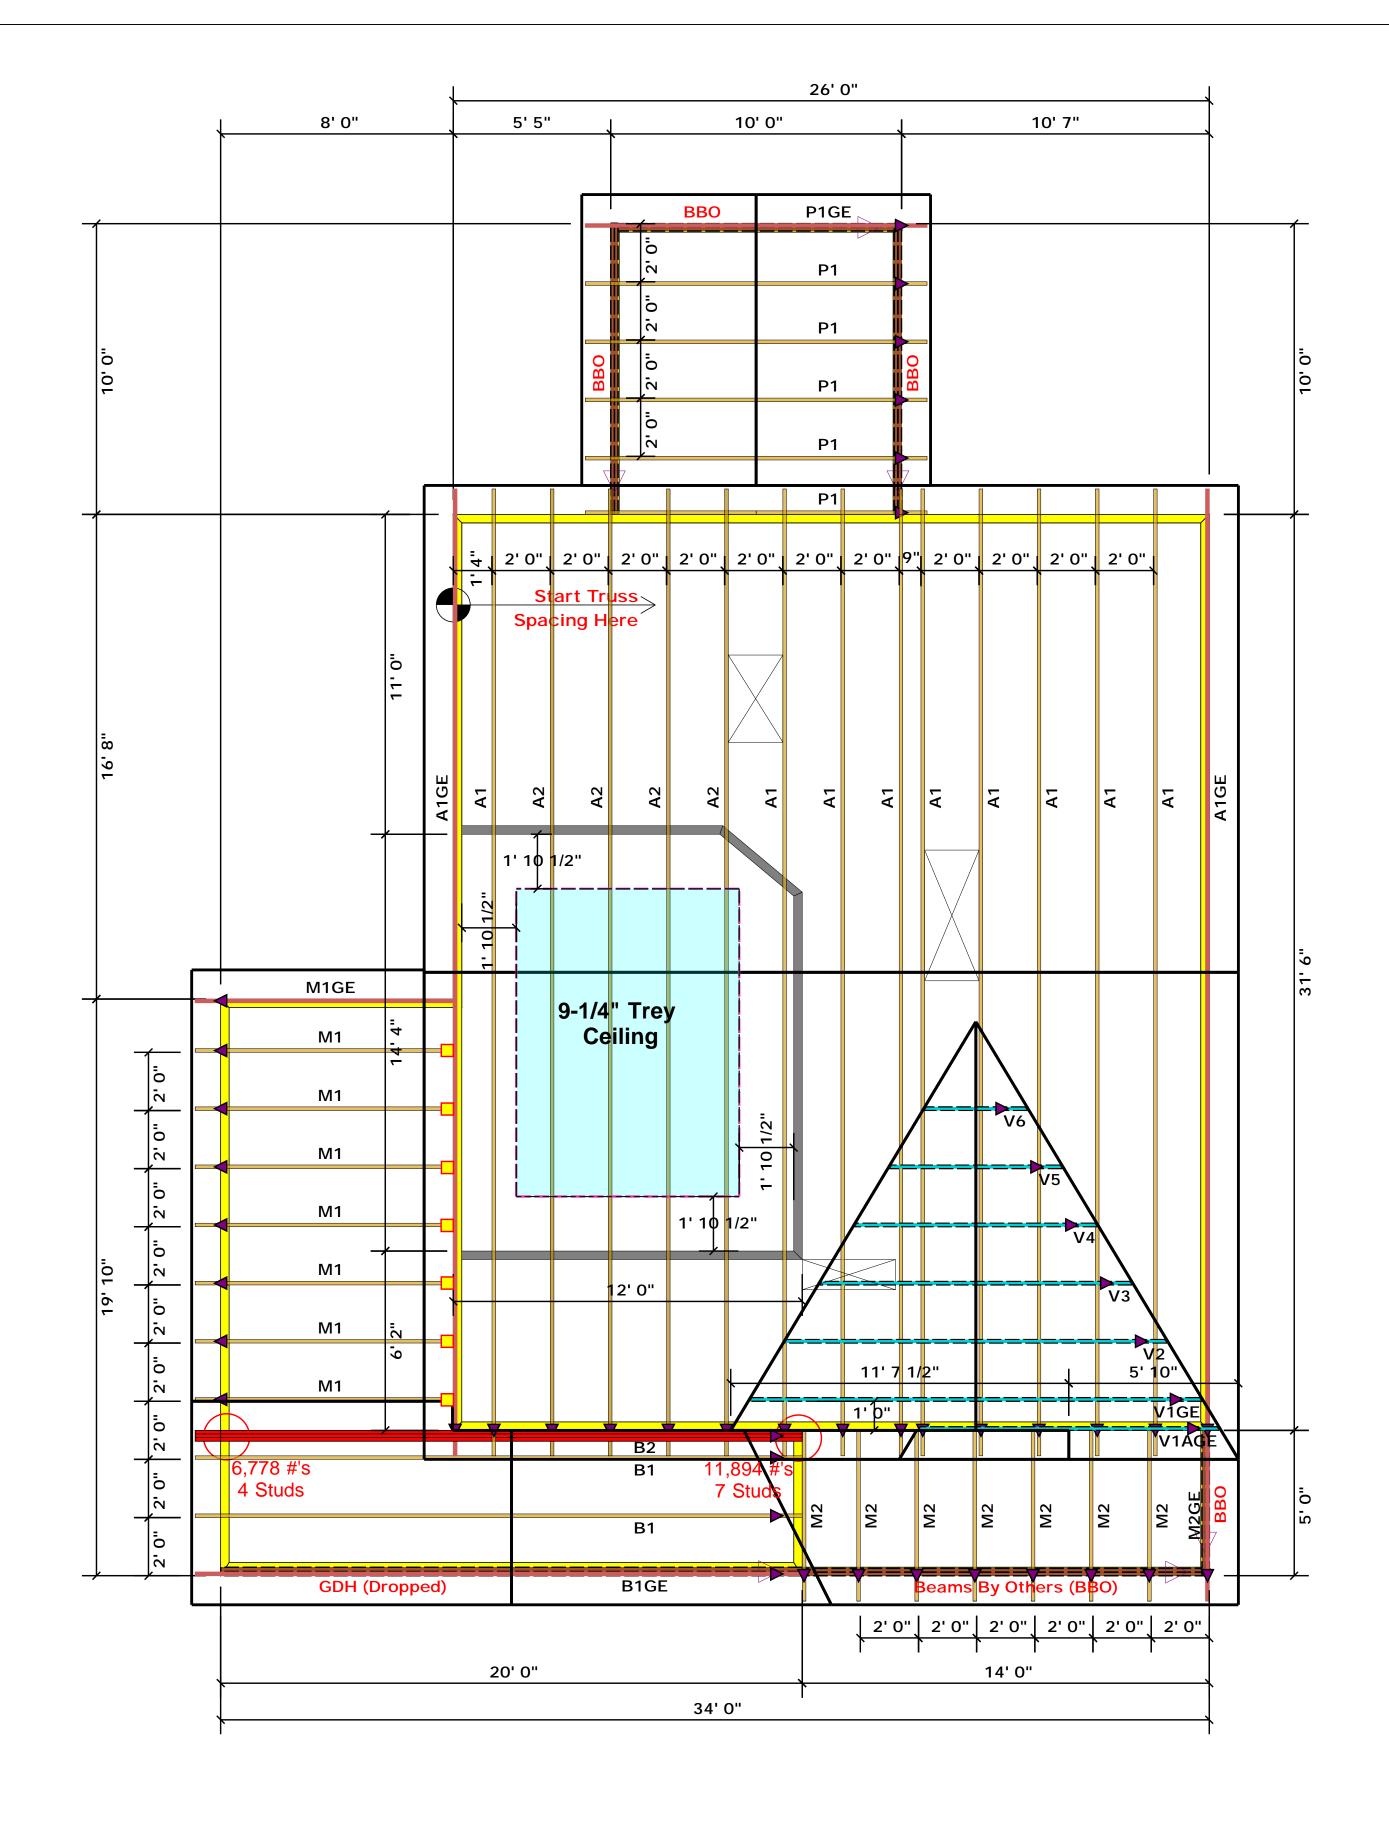

	Conne	Nail Info	ormation			
Sym	Product	Manuf	Qty	Supported Member	Header	Truss
	JUS24	USP	7	NA	10d/3"	10d/3"

▲ = Denotes Left End of Truss
(Reference Engineered Truss Drawing)

Truss Placement Plan SCALE: NTS

All Truss Reactions are Less than 3,000 lbs. Unless Noted Otherwise.



-- Denotes Reaction Greater than 3,000 lbs.
Reaction / # of Studs

LO.	AD 6	CHART FO	R J	ACK STUD	5
	m	ASEB ON LABLES	R502	5(1) 4 (6()	
NU	NN(2.0	N JACK STUDG A			
		PEAGER/6	TROES		
END REACTION (OT FU)	SEC DISTURS FOR CORN HEADER	CCLATO CCLATO	ARQ IS STUDS FOR CIPAN - EMBER	END SURCESON (OT 10)	REQUESTUDS FOR
1700	1	2550	1	3400	1
3400	2	5100	2	6600	2
5100	3	7650	3	10200	3
6800	4	10200	4	13600	4
8500	5	12750	5	17000	5
10200	á	15300	6		
11900	7				
13600	8				
15200					

BUILDER	Weaver Development	CITY / CO.	Cameron / Harnett	TH Th the
JOB NAME	Lot 3 Cedar Pointe	ADDRESS	Marks Road	is r the wal reg
PLAN	Magnolia I I "C"	MODEL		Bea pre
SEAL DATE	Seal Date	DATE REV.	/ /	(de fou that be
QUOTE #		DRAWN BY	Christine Shivy	spe
JOB #	J0722-3632	SALES REP.	Lenny Norris	

THIS IS A TRUSS PLACEMENT DIAGRAM ONLY.


These trusses are designed as individual building components to be incorporated into the building design at the specification of the building designer. See individual design sheets for each truss design identified on the placement drawing. The building designer is responsible for temporary and permanent bracing of the roof and floor system and for the overall structure. The design of the truss support structure including headers, beams, walls, and columns is the responsibility of the building designer. For general guidance egarding bracing, consult BCSI-B1 and BCSI-B3 provided with the truss delivery package or online @ sbcindustry.com

Bearing reactions less than or equal to 3000# are deemed to comply with the prescriptive Code requirements. The contractor shall refer to the attached Tables (derived from the prescriptive Code requirements) to determine the minimum foundation size and number of wood studs required to support reactions greater than 3000# but not greater than 15000#. A registered design professional shall be retained to design the support system for any reaction that exceeds those specified in the attached Tables. A registered design professional shall be retained to design the support system for all reactions that exceed 15000#.

Christine Shivy
Christine Shivy



Phone: (910) 864-8787 Fax: (910) 864-4444

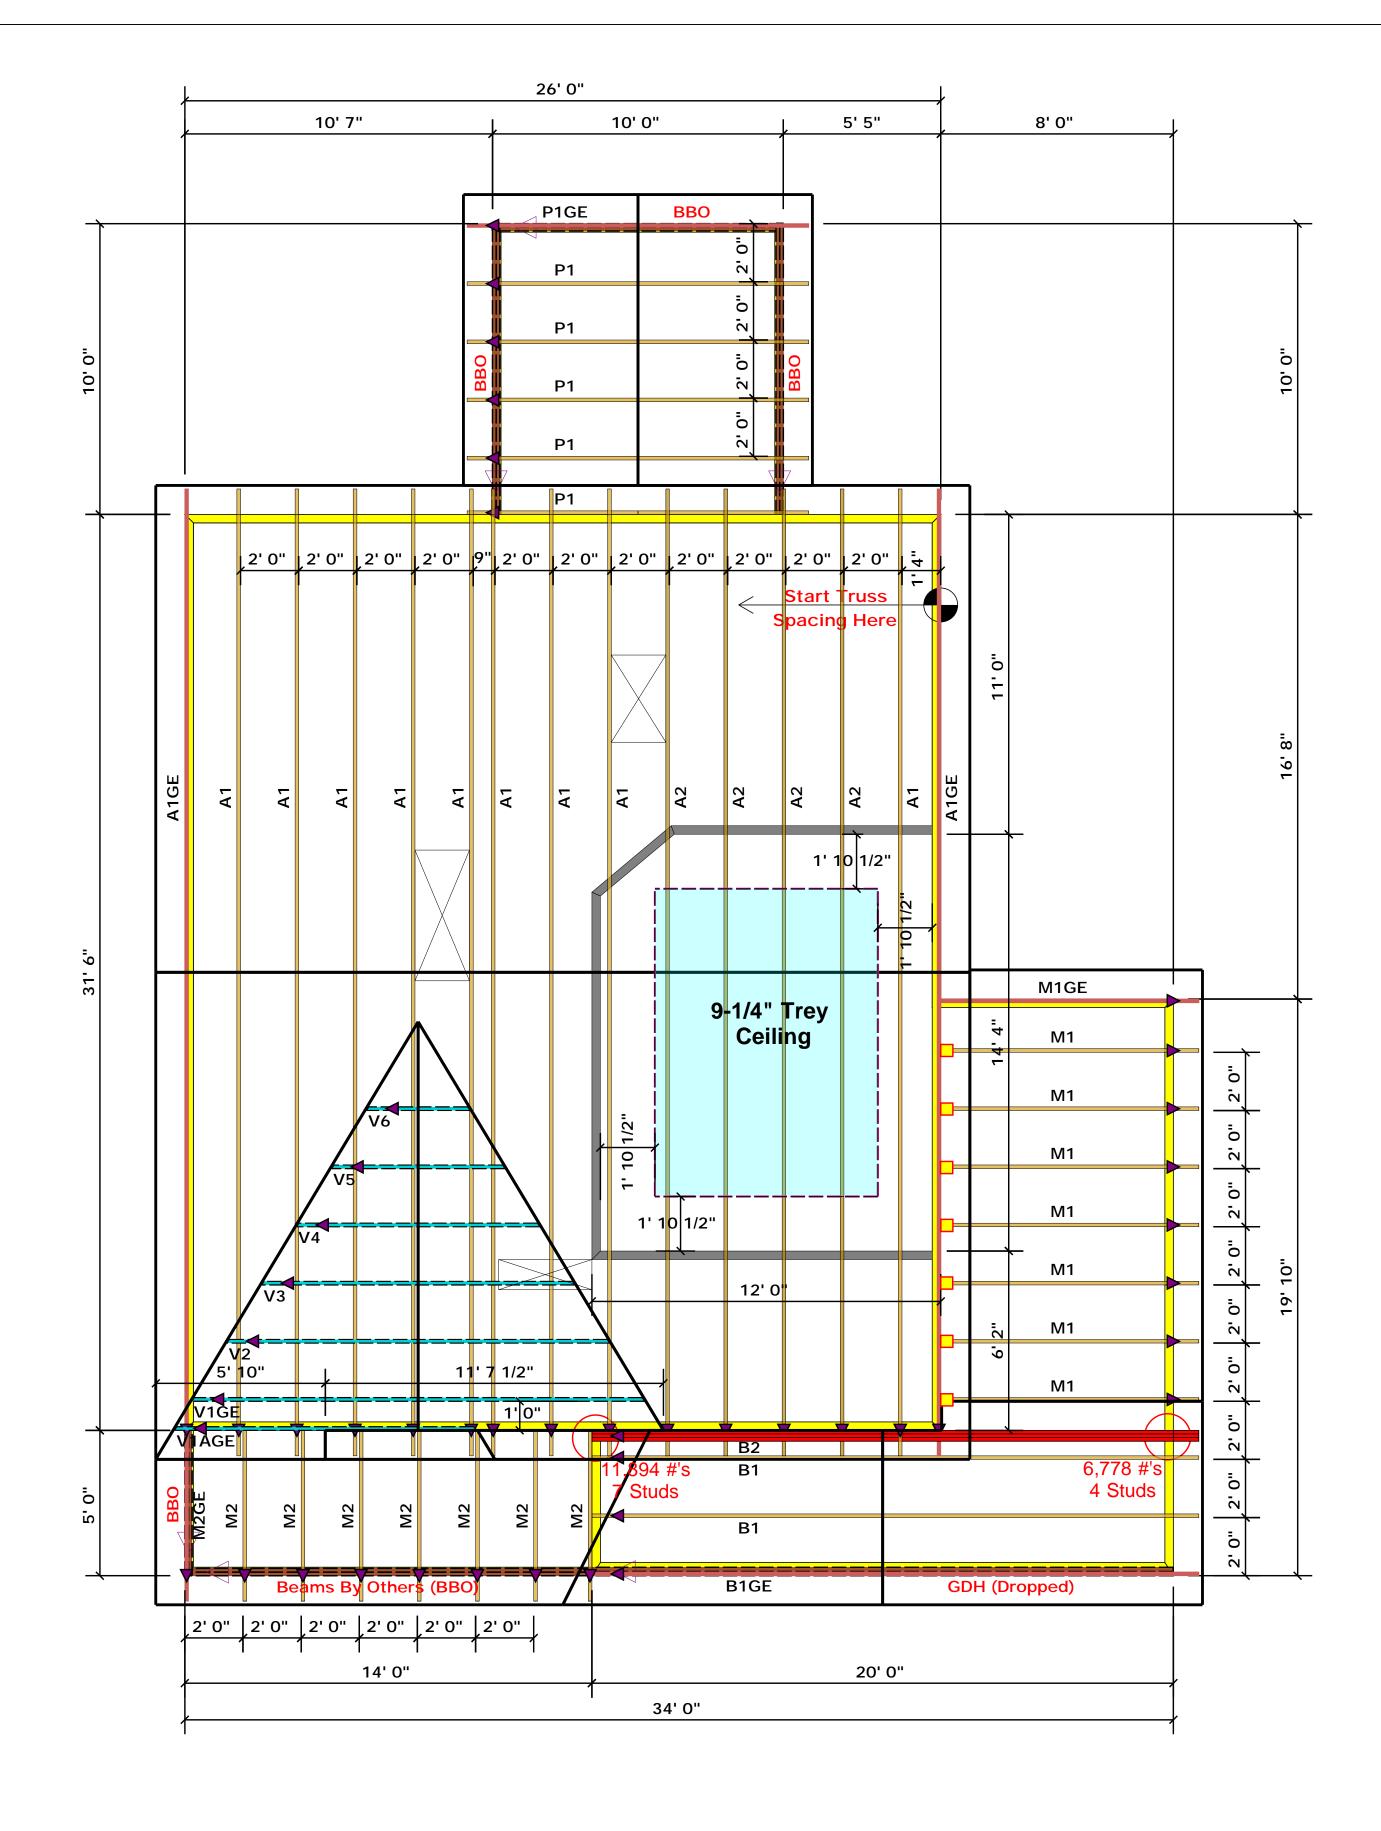

	Conne	Nail Info	ormation			
Sym	Product	Manuf	Qty	Supported Member	Header	Truss
	JUS24 U		7	NA	10d/3"	10d/3"

▲ = Denotes Left End of Truss (Reference Engineered Truss Drawing)

Truss Placement Plan SCALE: NTS

All Truss Reactions are Less than 3,000 lbs. Unless Noted Otherwise.



-- Denotes Reaction Greater than 3,000 lbs.
Reaction / # of Studs

LO.	AD 6	SHAR	T FO	RЈ	ACK	STUD	5
	00	ASEB Of	d Later	s R502	5(1) 4 (ь))	
NU	MP(5.0					A END OF	
		,	EAGERN		1		
END REACTION (OT 3.0)	SEC DISTURS FOR CORY HEADER		SND PENCTION OF ALC	REQUESTUDS FOR CORN - EADER		ENB SUACTOON (UP TO)	REQ'D STUDS FOR (4) RIY HEADER
1700	1		2550	1		3400	1
3400	2		5100	2		6600	2
5100	3		7650	3		10200	3
6800	4		10200	4		13600	4
8500	5		12750	5		17000	5
10200	6		15300	6			
11900	7						
13600	8						
15300							

				_
BUILDER	Weaver Development	CITY / CO.	Cameron / Harnett	THIS IS A TRUSS PLACEMENT DIAGRAM ONLY. These trusses are designed as individual building components to be the building design at the specification of the building designer. Set sheets for each truss design identified on the placement drawing. The sheets for each truss design identified on the placement drawing. The sheets for each truss design identified on the placement drawing. The sheets for each truss design identified on the placement of the placement of the sheet of the shee
JOB NAME	Lot 3 Cedar Pointe	ADDRESS	Marks Road	is responsible for temporary and permanent bracing of the roof and the overall structure. The design of the truss support structure inclu- walls, and columns is the responsibility of the building designer. For regarding bracing, consult BCSI-B1 and BCSI-B3 provided with the
PLAN	Magnolia I I "C"	MODEL	Roof	or online @ sbcindustry.com Bearing reactions less than or equal to 3000# are deemed to prescriptive Code requirements. The contractor shall refer to
SEAL DATE	Seal Date	DATE REV.	/ /	(derived from the prescriptive Code requirements) to detern foundation size and number of wood studs required to suppor than 3000# but not greater than 15000#. A registered design per testined to design the support system for any reaction that
QUOTE #		DRAWN BY	Christine Shivy	specified in the attached Tables. A registered design profession retained to design the support system for all reactions that except the system of the syste
JOB #	J0722-3632	SALES REP.	Lenny Norris	Christine Shivy



Phone: (910) 864-8787 Fax: (910) 864-4444



Client: Weaver Development Project: Magnolia-II Elev. C Address: Magnolia-II Elev. C


Date: 4/13/2022 Input by: Christine Shivy Job Name: Magnolia-II Elev. C

Project #:

1.750" X 16.000" **Kerto-S LVL** 2-Ply - PASSED BM₁

Level: Level

Reactions UNPATTERNED Ib (Uplift)

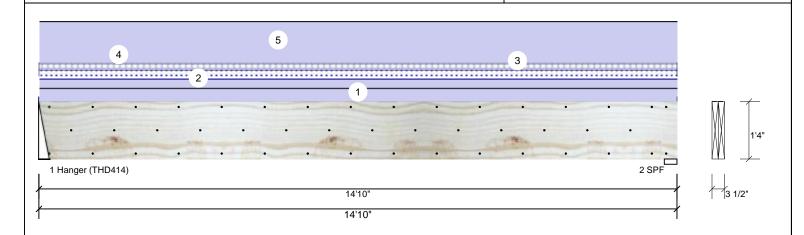

Type:	Girder	Application:	Floor	Brg	Direction	Live	Dead	d Sno	ow V	Vind	Const
Plies:	2	Design Method:	ASD	1	Vertical	296	4522	2 5	577	0	0
Moisture Condition	on: Dry	Building Code:	IBC/IRC 2015	2	Vertical	298	4548	3 5	80	0	0
Deflection LL:	480	Load Sharing:	No								
Deflection TL:	360	Deck:	Not Checked								
Importance:	Normal - II										
Temperature:	Temp <= 100°F										
				Bear	ings						
				Bea	ring Length	Dir.	Cap. Reac	t D/L lb	Total Ld. C	ase	Ld. Comb.
				1 -	3.000"	Vert	59% 45	22 / 655	5177 L		D+0.75(L+S)
				Har	nger						
Analysis Resu	lts			2 - 3	SPF 3.500"	Vert	100% 45	48 / 658	5206 L		D+0.75(L+S)

Analysis	Actual	Location	Allowed	Сараспу	Comb.	Case
Moment	15931 ft-lb	7'4 3/4"	31109 ft-lb	0.512 (51%)	D	Uniform
Unbraced	18237 ft-lb	7'4 3/4"	18273 ft-lb	0.998 (100%)	D+0.75(L+S)	L
Shear	3695 lb	1'7"	10752 lb	0.344 (34%)	D	Uniform
LL Defl inch	0.041 (L/4231)	7'4 13/16"	0.361 (L/480)	0.113 (11%)	0.75(L+S)	L
TL Defl inch	0.324 (L/535)	7'4 13/16"	0.481 (L/360)	0.673 (67%)	D+0.75(L+S)	L

Design Notes

Member Information

- 1 Provide support to prevent lateral movement and rotation at the end bearings. Lateral support may also be required at the interior bearings by the building code.
- 2 Fasten all plies using 3 rows of 10d Box nails (.128x3") at 12" o.c. Maximum end distance not to exceed 6".
- 3 Refer to last page of calculations for fasteners required for specified loads.
- 4 Fill all hanger nailing holes.
- 5 Girders are designed to be supported on the bottom edge only.
- 6 Top loads must be supported equally by all plies.
- 7 Top must be laterally braced at a maximum of 6'5 1/8" o.c.
- 8 Bottom must be laterally braced at end bearings.
- 9 Lateral slenderness ratio based on single ply width.

ID	Load Type	Location	Trib Width	Side	Dead 0.9	Live 1	Snow 1.15	Wind 1.6	Const. 1.25	Comments
1	Uniform			Тор	125 PLF	0 PLF	0 PLF	0 PLF	0 PLF	Exterior Wall
2	Uniform			Near Face	78 PLF	0 PLF	78 PLF	0 PLF	0 PLF	M1
3	Uniform			Far Face	15 PLF	40 PLF	0 PLF	0 PLF	0 PLF	Floor Load

Continued on page 2...

Notes

Calculated Structured Designs is responsible only of the structural adequacy of this component based on the design criteria and loadings shown. It is the responsibility of the customer and/or the contractor to ensure the component suitability of the intended application, and to verify the dimensions and loads.

- Dry service conditions, unless noted otherwise
 LVL not to be treated with fire retardant or corrosive
- Handling & Installation
- I. LVL beams must not be cut or drilled
 Refer to manufacturer's product information regarding installation requirements, multi-ply fastening details, beam strength values, and code approvals
 Damaged Beams must not be used

- Design assumes top edge is laterally restrained
 Provide lateral support at bearing points to avoid
 lateral displacement and rotation
- 6. For flat roofs provide proper drainage to prevent ponding

This design is valid until 11/3/2024

Metsä Wood 301 Merritt 7 Building, 2nd Floor Norwalk, CT 06851 (800) 622-5850 www.metsawood.com/us

Manufacturer Info

Comtech, Inc. 1001 S. Reilly Road, Suite #639 Fayetteville, NC USA 28314 910-864-TRUS



Page 1 of 2






Continued from page 1

Client: Weaver Development Project: Magnolia-II Elev. C Address: Magnolia-II Elev. C Date: 4/13/2022 Input by: Christine Shivy Job Name: Magnolia-II Elev. C

Project #:

1.750" X 16.000" 2-Ply - PASSED **Kerto-S LVL** BM₁

Level: Level

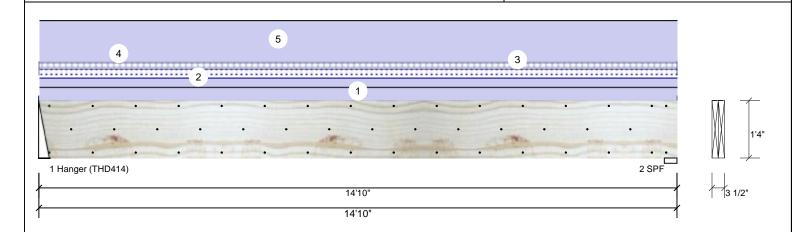

ID	Load Type	Location	Trib Width	Side	Dead 0.9	Live 1	Snow 1.15	Wind 1.6	Const. 1.25	Comments
4	Uniform			Тор	130 PLF	0 PLF	0 PLF	0 PLF	0 PLF	Exterior Load
5	Uniform			Тор	251 PLF	0 PLF	0 PLF	0 PLF	0 PLF	A1GE
	Self Weight				12 PLF					

Notes

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Dry service conditions, unless noted otherwise
 LVL not to be treated with fire retardant or corrosive

Handling & Installation

Handling & Installation

1. IVI beams must not be out or drilled

2. Refer to manufacturer's product information regarding installation requirements, multi-ply fastering details, beam strength values, and code approvals

3. Damaged Beams must not be used

4. Design assumes top edge is laterally restrained

5. Provide lateral support at bearing points to avoid lateral displacement and rotation

6. For flat roofs provide proper drainage to prevent ponding

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Page 2 of 2





Client: Project: Address:

Weaver Development Magnolia-II Elev. C Magnolia-II Elev. C Date: 4/13/2022 Input by:


Christine Shivy Job Name: Magnolia-II Elev. C


Project #:

Kerto-S LVL 2-Ply - PASSED 1.750" X 16.000" BM₂

Level: Level

Reactions UNPATTERNED Ib (Uplift)

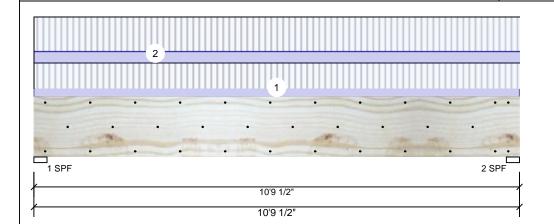

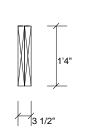

Page 1 of 1

Member Information Туре: Girder Plies: 2 Moisture Condition: Dry Deflection LL: 480 Deflection TL: 360 Importance: Normal - II Temperature: Temp <= 100°F

Application: Floor Design Method: ASD **Building Code: IBC/IRC 2015** Load Sharing: No Deck: Not Checked

Brg Snow Wind Const Direction Live Dead Vertical 3389 1200 0 0 0 1 3389 1200 0 2 Vertical 0 0

Bearings Bearing Length Dir. Cap. React D/L lb Total Ld. Case Ld. Comb. D+L 1 - SPF 3.500" Vert 1200 / 3389 4589 L 3.500" 2 - SPF Vert 88% 1200 / 3389 4589 L D+I

Analysis Results

Analysis	Actual	Location	Allowed	Capacity	Comb.	Case
Moment	11397 ft-lb	5'4 3/4"	34565 ft-lb	0.330 (33%)	D+L	L
Unbraced	11397 ft-lb	5'4 3/4"	11764 ft-lb	0.969 (97%)	D+L	L
Shear	4341 lb	1'7 1/2"	11947 lb	0.363 (36%)	D+L	L
LL Defl inch	0.085 (L/1457)	5'4 3/4"	0.259 (L/480)	0.329 (33%)	L	L
TL Defl inch	0.115 (L/1076)	5'4 3/4"	0.345 (L/360)	0.335 (33%)	D+L	L

Design Notes

- 1 Provide support to prevent lateral movement and rotation at the end bearings. Lateral support may also be required at the interior bearings by the building code.
- 2 Fasten all plies using 3 rows of 10d Box nails (.128x3") at 12" o.c. Maximum end distance not to exceed 6".
- 3 Refer to last page of calculations for fasteners required for specified loads.
- 4 Girders are designed to be supported on the bottom edge only.
- 5 Top must be laterally braced at end bearings.
- 6 Bottom must be laterally braced at end bearings.
- 7 Lateral slenderness ratio based on single ply width.

ID	Load Type	Location	Trib Width	Side	Dead 0.9	Live 1	Snow 1.15	Wind 1.6	Const. 1.25	Comments	
1	Uniform			Far Face	89 PLF	267 PLF	0 PLF	0 PLF	0 PLF	F4	
2	Uniform			Near Face	121 PLF	361 PLF	0 PLF	0 PLF	0 PLF	F2	
	Self Weight				12 PLF						

Notes

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- Handling & Installation
- LVL beams must not be cut or drilled Refer to manufacturer's product information regarding installation requirements, multi-ply fastening details, beam strength values, and code approvals Damaged Beams must not be used
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 Provide lateral support at bearing points to avoid
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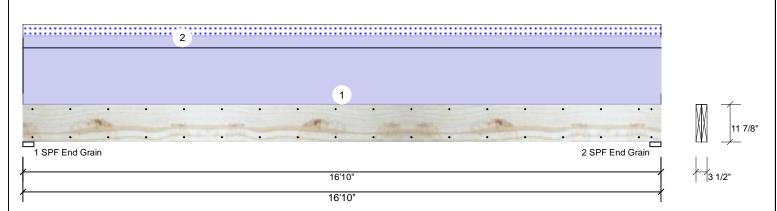
Client: Project: Address: Weaver Development Magnolia-II Elev. C Magnolia-II Elev. C Date: 4/13/2022

Input by: Christine Shivy Job Name: Magnolia-II Elev. C Page 1 of 1

Project #:

Kerto-S LVL 2-Ply - PASSED 1.750" X 11.875" **GDH**

Level: Level



Member Info	rmation						React	ions UNP	ATTERN	IED I	b (Uplift)			
Type:	Girder		Applicat	ion: F	loor		Brg	Direction	Live		Dead	Snow	Wind	Cons
Plies:	2		Design I	Method: A	ASD		1	Vertical	0		2098	337	0	(
Moisture Condition	on: Dry		Building	Code:	BC/IRC 2015		2	Vertical	0		2098	337	0	(
Deflection LL:	480		Load Sh	aring: N	١o									
Deflection TL:	360		Deck:	١	Not Checked									
Importance:	Normal - II													
Temperature:	Temp <= 10	0°F												
							Beari	ngs						
							Beari	ng Length	Dir.	Cap.	React D/L lb	Total	Ld. Case	Ld. Comb.
							1 - SI End	PF 3.500"	Vert	24%	2098 / 337	2434	L	D+S
Analysis Resu	ılts						Grain)						
Analysis A	Actual	Location	Allowed	Capacity	Comb.	Case	2 - SI	PF 3.500"	Vert	24%	2098 / 337	2434	L	D+S
Moment 8	354 ft-lb	8'5"	17919 ft-lb	0.466 (47%	6) D	Uniform	End Grain	1						
Unbraced 9	694 ft-lb	8'5"	9704 ft-lb	0.999	D+S	L								

Uniform

1

TL Defl inch **Design Notes**

Shear

1 Provide support to prevent lateral movement and rotation at the end bearings. Lateral support may also be required at the interior bearings by the building code.

8'5 1/16" 0.409 (L/480) 0.171 (17%) S

8'5 1/16" 0.546 (L/360) 0.927 (93%) D+S

1'3 3/8" 7980 lb

0.224 (22%) D

- 2 Fasten all plies using 2 rows of 10d Box nails (.128x3") at 12" o.c. Maximum end distance not to exceed 6".
- 3 Refer to last page of calculations for fasteners required for specified loads.
- 4 Girders are designed to be supported on the bottom edge only.
- 5 Top loads must be supported equally by all plies.

1788 lb

0.506 (L/388)

LL Defl inch 0.070 (L/2809)

- 6 Top must be laterally braced at a maximum of 9'6 3/4" o.c.
- 7 Bottom must be laterally braced at end bearings.
- 8 Lateral slenderness ratio based on single ply width

o Latorar t	diditaditiodd fallo badda di	i diligio piy widili.									
ID	Load Type	Location	Trib Width	Side	Dead 0.9	Live 1	Snow 1.15	Wind 1.6	Const. 1.25	Comments	
1	Uniform			Тор	200 PLF	0 PLF	0 PLF	0 PLF	0 PLF	Exterior Loads	
2	Uniform			Тор	40 PLF	0 PLF	40 PLF	0 PLF	0 PLF	2'-0" Gable End	
	Self Weight				9 PLF						

Notes

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