Residence for

Garman Homes Lot 0098 Serenity Fuquay Varina, North Carolina

INDEX TO DRAWINGS

COVER SHEET

- FRONT & LEFT SIDE ELEVATIONS
- **REAR & RIGHT SIDE ELEVATIONS**
- FIRST & SECOND FLOOR PLANS FIRST & SECOND FLOOR ELECTRICAL PLANS
- FIRST & SECOND FLOOR MECHANICAL PLANS
- FIRST FLOOR PLUMBING PLAN
- D CONSTRUCTION DETAILS

- FOUNDATION PLAN & FIRST FLOOR FRAMING PLAN SECOND FLOOR FRAMING PLAN & ROOF FRAMING PLAN
- SD1 STRUCTURAL DETAILS STRUCTURAL DETAILS STRUCTURAL NOTES

GENERAL NOTES

- . ALL WORK TO BE DONE IN STRICT ACCORDANCE WITH NORTH CAROLINA STATE RESIDENTIAL BUILDING CODE, 2018 EDITION (HEREWITH SHOWN AS N.C.S.R.B.C.)
- 2. DIMENSIONS SHOWN ON DRAWINGS GOVERN OVER SCALE.
- 3. STUD WALL DESIGN SHALL CONFORM TO ALL N.C.S.R.B.C.
- 4. CONTRACTOR SHALL USE TEMPERED SAFETY GLASS IN ALL LOCATIONS AS REQUIRED BY N.C.S.R.B.C., 2018 EDITION, SECTION
- 5. ANY HABITABLE ROOM SHALL MEET ALL LIGHT/VENTILATION AND EGRESS AS REQUIRED BY N.C.S.R.B.C. 2018 EDITION, SECTIONS
- 6. ALL EXTERIOR WALLS SHOWN ON FLOOR PLANS ARE 2X6 FRAME UNLESS NOTED OTHERWISE. ALL INTERIOR WALLS SHOWN ON FLOOR PLANS ARE 2X4 FRAME UNLESS NOTED OTHERWISE.
- 7. ALL ANGLED WALLS SHOWN ON FLOOR PLANS ARE 45 UNLESS NOTED OTHERWISE.
- 8. ALL WINDOWS SHALL HAVE A MINIMUM DPI RATING OF 25. BUILDER SHALL VERIFY WITH WINDOW MANUFACTURER THAT UNITS INSTALLED MEET THESE REQUIREMENTS AS PER N.C.S.R.B.C., 2018 EDITION, TABLE 301.2(4).
- 9. ENERGY EFFICIENCY REQUIREMENTS FOR THE SPECIFIC CLIMATE ZONE WHERE STRUCTURE IS BEING BUILT SHALL BE IN ACCORDANCE WITH CHAPTER 11 OF THE N.C.S.R.B.C., 2018 EDITION, AS SHOWN IN SECTION N1101.2.

MATERIALS LEGEND

ļ∟			
a	À	CONCRETE	ROUGH WOOD
		BRICK	BLOCKING
		CONCRETE BLOCK/STONE	PLYWOOD
		STEEL	BATT INSULATIO
		ALUMINUM	RIGID INSULATIO
\vdash			

ATTIC VENTILATION REQUIREMENTS

NATURAL ROOF VENTILATION **CALCULATIONS**

<u>1165 SQ. FT.</u> = 7.77 SQ. FT. VENT REQ'D

EARTH/COMPACT FILL

BUILDER TO PROVIDE APPROPRIATE VENTILATING AS REQUIRED PER CODE MECHANICAL ROOF VENTILATION **CALCULATIONS**

/ FINISH WOOD

= 3.88 SQ. FT. VENT REO'D

BUILDER TO PROVIDE APPROPRIATE VENTILATING AS REQUIRED PER CODE

RESIDENTIAL BUILDING CODE SUMMARY

- 1. PLANS ARE DESIGNED TO THE 2018 N.C.S.R.B.C.
- 2. HOUSE IS DESIGNED FOR 115 MPH ULTIMATE DESIGN WIND SPEED (89 MPH NOMINAL DESIGN WIND SPEED), EXPOSURE B.
- 3. ANCHOR BOLTS SHALL BE MIN. 1/2" DIAMETER AND SHALL EXTEND 7" MIN. INTO MASONRY OR CONCRETE. BOLTS TO BE NO MORE THAN 6' O.C. AND WITHIN 12"
- 4. MEAN ROOF HEIGHT: 28'-8"
- 5. COMPONENT & CLADDING DESIGNED FOR THE FOLLOWING LOADS:

MEAN ROOF HGT:	UP TO 30'	30'-1" TO 35'	35'-1" TO 40'	40'-1" TO 45'
ZONE 1	16.5,-18.0	17.3,-18.9	17.3,-18.9	17.3,-18.9
ZONE 2	16.5,-21.0	17.3,-22.1	17.3,-22.1	17.3,-22.1
ZONE 3	16.5,-21.0	17.3,-22.1	17.3,-22.1	17.3,-22.1
ZONE 4	18.0,-19.5	18.9,-20.5	18.9,-20.5	18.9,-20.5
ZONE 5	18.0,-24.1	18.9,-25.3	18.9,-25.3	18.9,-25.3

- 6. MINIMUM VALUES FOR ENERGY COMPLIANCE: Zone 4
- 7. MAXIMUM GLAZING U-FACTOR: .35

HEATED (SQ. FT.)

8. INSULATING VALUES: CEILING: R-38 / WALLS: R-15 / FLOOR: R-19 SLABS: R-10. CODE REFERENCE: TABLE N1102.1

AREA CALCULATIONS UNHEATED (SQ. FT.)

UNFINISHED (SQ. FT.)

BREAKFAST

DINING

KITCHEN

20'-6"X6'-0"

П

				10 01 11/
745 699	FRONT PORCH: SCREENED PORCH: GARAGE:	120 100 300	1ST FLOOR: 2ND FLOOR:	N/A N/A
1444	TOTAL:	520	TOTAL:	N/A
			OVERALL DIMEN	ISIONS
			WIDTH: DEPTH:	34'-8" 49'-4"
	699	699 SCREENED PORCH: GARAGE:	699 SCREENED PORCH: 100 GARAGE: 300	699 SCREENED PORCH: 100 GARAGE: 300 TOTAL: TOTAL: 520 OVERALL DIMEN WIDTH:

FOUNDATION VENTILATION CALCULATIONS

REFERENCE: N.C.S.R.B.C. 2018 EDITION SECTION R408)

NOT APPLICABLE WITH SLAB FOUNDATIONS






This document is property of Garman Homes Inc, and was prepared for their use only The plans elevations illustrations, and other material contained within this set may not be reproduced, either in part or wholly, in any manner without the express written permission of Garman Homes Inc. All right reserved and protected under federal law.

Project Number

Project Number Plan Number FP-1456

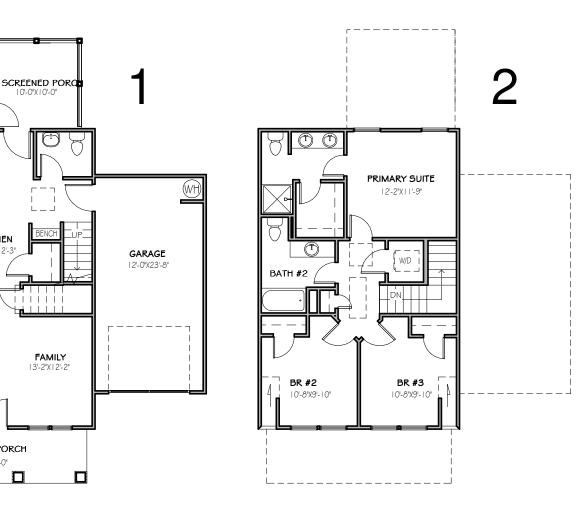

SER ELEVATION B LOT 0098 SERENITY

Drawn By MMH Checked By CM Date Drawn 2/16/20 **Revision Date** 7/1/20 4/5/22

RIDGE VENT FIBERGLASS SHINGLE ROOF (CLASS 'C' MIN.) TRUSS BRIDGE 4" FRIEZE BOARD AS SPEC SHAKE SIDING WINDOWS RIDGE VENT 4" TRIM AS SPEC @ WINDOWS AND DOORS 2ND FIN. FLR . NOTE: PROVIDE RAILS @ CEMENTITIOUS SIDING WINDOWS CORNER TRIM AS SPEC PORCH ONLY IF REQUIRED BY CODE 12" SQ. COL. ON 16" SQ. BRICK PIER 15" MIN. HGT. FOUNDATION FRONT GRADE TO FINISHED FRONT PORCH BRICK VENEER FND. WALL STEPS TO GRADE AS PER SITE

NOTE - SLOPE ALL GRADE AWAY FROM HOUSE FOR POSITIVE DRAINAGE

TRATED FRAMING WITH INSECT SOREEN

WEAR DRICK VIDINER 24' WHEEE SHOWN

WEAR DRICK VIDINER 24' WHEEE SHOWN

FRONT ELEVATION

LEFT SIDE ELEVATION

1/8" = 1'-0"

WIV

THE PURPOSE OF THESE DRAWINGS IS TO SHOW THE INTENT OF THE DESIGN AND CONSTRUCTION OF THIS HOME. CONTRACTOR SHOULD VERIFY ALL CONDITIONS AND DIMENSIONS PRIOR TO CONSTRUCTION. ONCE A PERMIT HAS BEEN ISSUED, CONTRACTOR SHALL ASSUME ALL RESPONSIBILITY TO THE ACCURACY OF THE PLANS AND ANY CHANGES MADE DURING CONSTRUCTION.



This document is property of Garman Homes Inc, and was prepared for their use only. The plans, elevations, illustrations, and other material contained within this set may not be reproduced, either in part or wholly, in any manner without the express written permission of Garman Homes, Inc. All right reserved and protected under federal law.

Project Number
Project Number
Plan Number
FP-1850

BUTTERCUP SER ELEVATION B LOT 0098 SERENITY

Drawn By


MH
Checked By
CM
Date Drawn
4/8/20
Revision Date
7/1/20
4/5/22

1

REAR ELEVATION

1/8" = 1'-0"

NOTE - SLOPE ALL GRADES AWAY FROM HOUSE FOR POSITIVE DRAINAGE

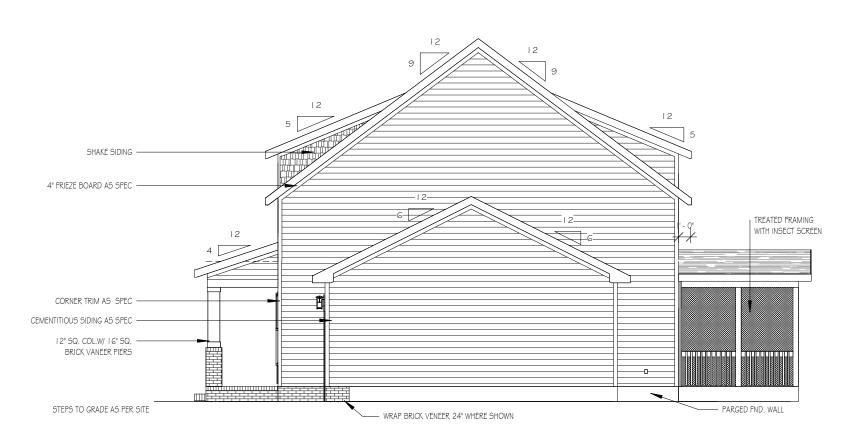


THE PURPOSE OF THESE DRAWINGS IS TO SHOW THE INTENT OF THE DESIGN AND CONSTRUCTION OF THIS HOME. CONTRACTOR SHOULD VERIFY ALL CONDITIONS AND DIMENSIONS PRIOR TO CONSTRUCTION. ONCE A PERMIT HAS BEEN ISSUED, CONTRACTOR SHALL ASSUME ALL RESPONSIBILITY TO THE ACCURACY OF THE PLANS AND ANY CHANGES MADE DURING CONSTRUCTION.



This document is property of Garman Homes Inc, and was prepared for their use only. The plans, elevations, illustrations, and other material contained within this set may not be reproduced, either in part or wholly, in any manner without the express written permission of Garman Homes, Inc. All right reserved and protected under federal law.

Project Number
Project Number
Plan Number
FP-1850

BUTTERCUP SER ELEVATION B LOT 0098 SERENITY

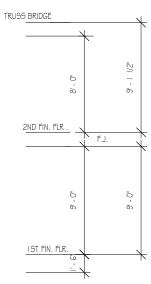

Drawn By

MH Checked By

RIGHT SIDE ELEVATION

THE PURPOSE OF THESE DRAWINGS IS TO SHOW THE INTENT OF THE DESIGN AND CONSTRUCTION OF THIS HOME. CONTRACTOR SHOULD VERIFY ALL
CONDITIONS AND DIMENSIONS PRIOR TO
CONSTRUCTION. ONCE A PERMIT HAS BEEN ISSUED, CONTRACTOR SHALL ASSUME ALL RESPONSIBILITY TO THE ACCURACY OF THE PLANS AND ANY CHANGES MADE DURING CONSTRUCTION.



This document is property of Garman Homes Inc, and was prepared for their use only. The plans, elevations, illustrations, and other material contained within this set may not be reproduced, either in part or wholly, in any manner without the express written permission of Garman Homes, Inc. All right reserved and protected under federal law.

Project Number Project Number Plan Number FP-1850

> TTERCUP SER ELEVATION B LOT 0098 SERENITY


Drawn By

MH Checked By CM Date Drawn 4/8/20 Revision Date 7/1/20 4/5/22

Sheet

SECOND FLOOR 1/8" = 1'-0"

9'-0" CLG. HGT. U.N.O. SET WINDOWS @ 7'-4" U.N.O.

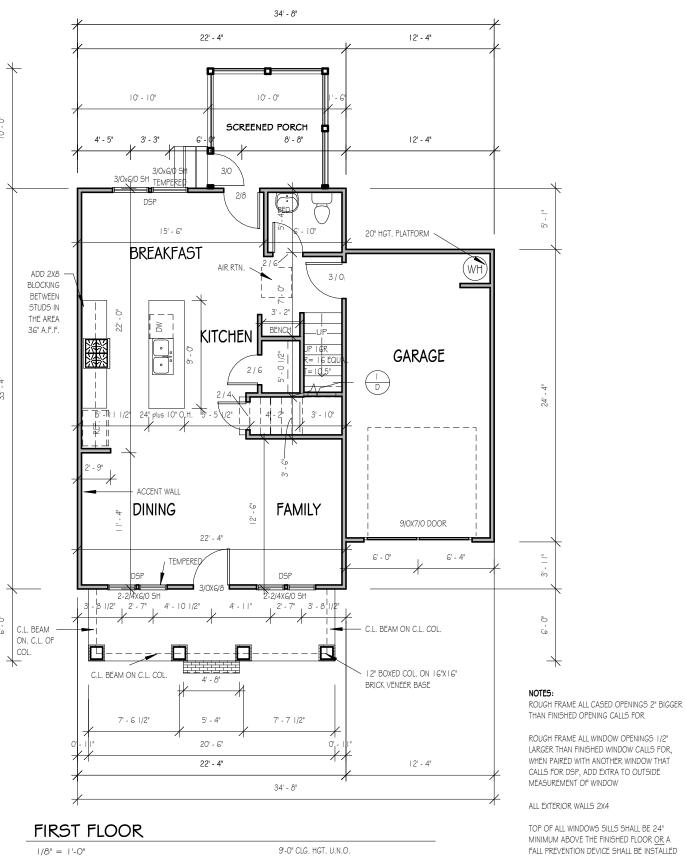


22' - 4" 12' - 1" 7' - 6" 3/0X5/0 SH 3/0X5/0 SH 12' - 6" PRIMARY SUITE : UPGRADE: THERE'S — N NO DEVIL IN THE DETAIL | ACCENT WALL -BATH #2 T25.5"X54' ~ 6" WALL BR #2 BR #3 2-3/0X5/0 SH 2-3/0X5/0 SH 5'-0" WALL HGT. > 5'-0" WALL HGT. 22' - 4"

SET WINDOWS @ 7'-6" U.N.O. CASED OPENINGS 8'-0" TALL


FALL PREVENTION DEVICE SHALL BE INSTALLED IN ACCORDANCE WITH SECTION R312.2 OF

N.C.S.R.B.C., 2018 EDITION

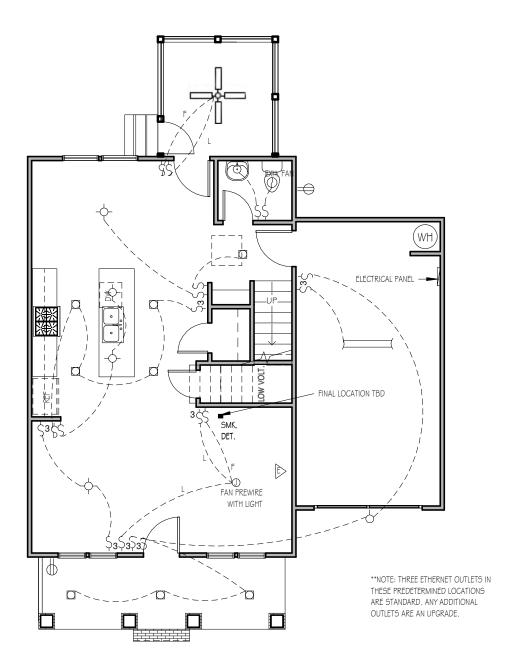

FIRST FLOOR ELECTRICAL PLAN

NOTE - ELECTRICAL RECEPTACLE AND SWITCH QUANTITIES AND LOCATIONS SHOWN ON PLAN ARE FOR ILLUSTRATION PURPOSES ONLY. ACTUAL NUMBER AN D LOCATIONS SHALL BE FIELD DETERMINED AS PER CLIENT AND BUILDER EXCEPT WHERE CODE REQUIREMENTS APPLY.

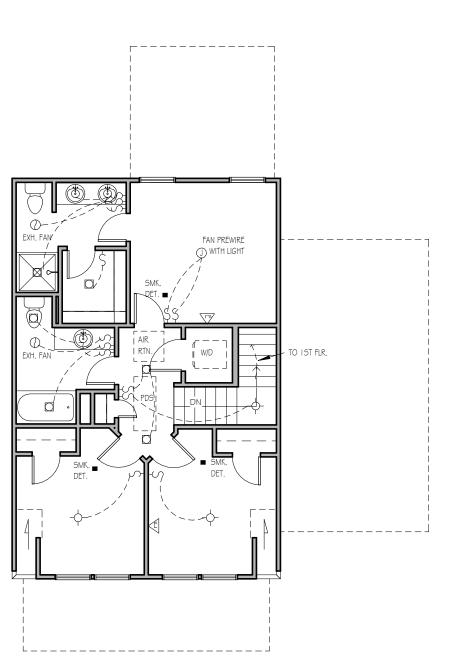

THE PURPOSE OF THESE DRAWINGS IS TO SHOW THE INTENT OF THE DESIGN AND CONSTRUCTION OF THIS HOME. CONTRACTOR SHOULD VERIFY ALL CONDITIONS AND DIMENSIONS PRIOR TO CONSTRUCTION. ONCE A PERMIT HAS BEEN ISSUED, CONTRACTOR SHALL ASSUME ALL RESPONSIBILITY TO THE ACCURACY OF THE PLANS AND ANY CHANGES MADE DURING CONSTRUCTION.

ELECTRICAL LECEND

-- LIGHT FIXTURE

O - PAVLUHT

OMP- PHATERPROOF OUTLET

☐ - MEXESSEED TREHLLINE

• - BINKLE PULL BATCH

t - 4-MAY SMITCH

€ - DINHER SHITCH■ - BMOKE PETECTOR


A - Hrood hartia

A - EAEDATT SUCIS

DUPLEX RECEPTABLE (IKV)
 - .220 VOLT WEGETABLE

- SWITCHED RECEPTABLE (TOP WIRE ONLY)

A - ENGIND FAILT CIRCUIT MIERRAPTOR

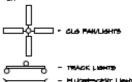

O - CABLE OUTLET

A - TELEPHONE OUTLET

A - COMPUTER DATA CUILET

E - DURGLAR ALARM

- INTERSOM

NOTE: ALL ELECTRICAL TO SE VERIFIED BY OWNER/BULDER. BETOTE ROUGH-IN. FRESH: PAINT by Garman Homes

This document is property of Garman Homes Inc, and was prepared for their use only. The plans, elevations, illustrations, and other material contained within this set may not be reproduced, either in part or wholly, in any manner without the express written permission of Garman Homes, Inc. All right reserved and protected under federal law.

Project Number
Project Number

Plan Number FP-1850

BUTTERCUP
SER ELEVATION B
LOT 0098 SERENITY

Drawn By
MH
Checked By
CM
Date Drawn
4/8/20
Revision Date
7/1/20
4/5/22

Shoo

Ε

SECOND FLOOR ELECTRICAL PLAN

1/8" = 1'-0"

I '-O"

NOTE - ELECTRICAL RECEPTACLE AND SWITCH QUANTITIES AND LOCATIONS
SHOWN ON PLAN ARE FOR ILLUSTRATION PURPOSES ONLY. ACTUAL NUMBER
AN D LOCATIONS SHALL BE FIELD DETERMINED AS PER CLIENT AND BUILDER
EXCEPT WHERE CODE REQUIREMENTS APPLY.

THE PURPOSE OF THESE DRAWINGS IS TO SHOW THE INTENT OF THE DESIGN AND CONSTRUCTION OF THIS HOME. CONTRACTOR SHOULD VERIFY ALL CONDITIONS AND DIMENSIONS PRIOR TO CONSTRUCTION. ONCE A PERMIT HAS BEEN ISSUED, CONTRACTOR SHALL ASSUME ALL RESPONSIBILITY TO THE ACCURACY OF THE PLANS AND ANY CHANGES MADE DURING CONSTRUCTION.



This document is property of Garman Homes Inc, and was prepared for their use only. The plans, elevations, illustrations, and other material contained within this set may not be reproduced, either in part or wholly, in any manner without the express written permission of Garman Homes, Inc. All right reserved and protected under federal law.

Project Number

Project Number Plan Number


FP-1850

BUTTERCUP SER ELEVATION B LOT 0098 SERENITY

Drawn By МН Checked By CM Date Drawn 4/8/20 Revision Date 7/1/20 4/5/22

SECOND FLOOR MECHANICAL

(WH) AIR I WATER SHUT OFF

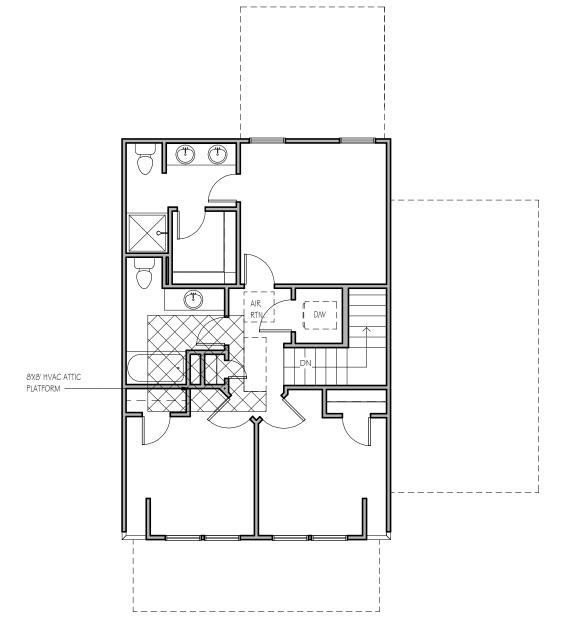


FIRST FLOOR MECHANICAL PLAN

1/8" = 1'-0"

1/8" = 1'-0"

PLAN

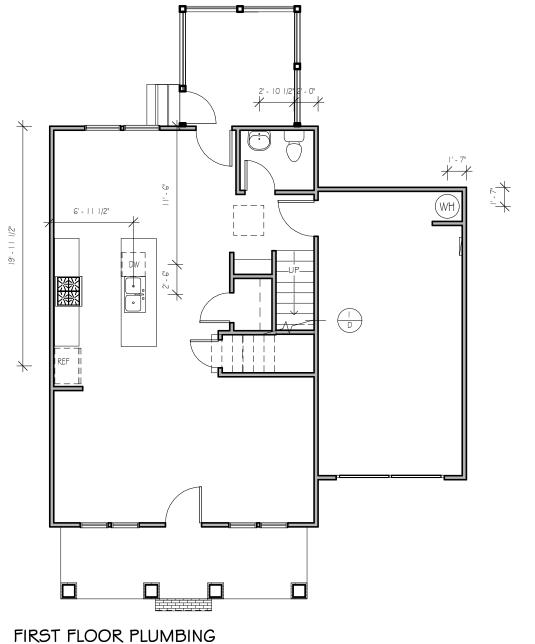

1/8" = 1'-0"

THE PURPOSE OF THESE DRAWINGS IS TO SHOW THE INTENT OF THE DESIGN AND CONSTRUCTION OF THIS HOME. CONTRACTOR SHOULD VERIFY ALL CONDITIONS AND DIMENSIONS PRIOR TO CONSTRUCTION. ONCE A PERMIT HAS BEEN ISSUED, CONTRACTOR SHALL ASSUME ALL RESPONSIBILITY TO THE ACCURACY OF THE PLANS AND ANY ACCURACY OF THE PLANS AND ANY CHANGES MADE DURING CONSTRUCTION.




This document is property of Garman Homes Inc, and was prepared for their use only. The plans, elevations, illustrations, and other material contained within this set may not be reproduced, either in part or wholly, in any manner without the express written permission of Garman Homes, Inc. All right reserved and protected under federal law.

Project Number
Project Number
Plan Number
FP-1850

BUTTERCUP SER ELEVATION B LOT 0098 SERENITY


Drawn By	
MH	
Checked By	
CM	
Date Drawn	
4/8/20	
Revision Date	
7/1/20	
4/5/22	

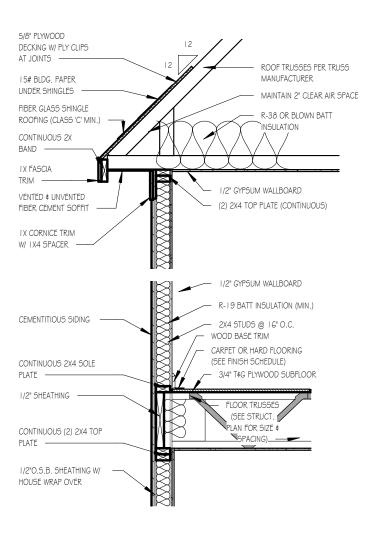

TWO-STORY WALL SECTION

1/2" = 1'-0"

1/2" = 1'-0"

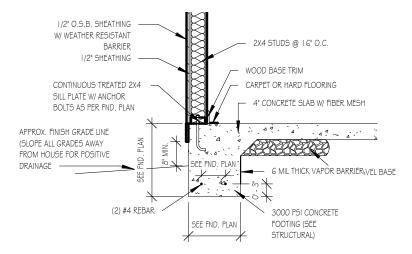

FOUNDATION DETAIL - SLAB

LUG FOOTING

THE PURPOSE OF THESE DRAWINGS IS TO SHOW THE INTENT OF THE DESIGN AND CONSTRUCTION OF THIS HOME. CONTRACTOR SHOULD VERIFY ALL CONDITIONS AND DIMENSIONS PRIOR TO CONSTRUCTION. ONCE A PERMIT HAS BEEN ISSUED, CONTRACTOR SHALL ASSUME ALL RESPONSIBILITY TO THE ACCURACY OF THE PLANS AND ANY CHANGES MADE DURING CONSTRUCTION.



This document is property of Garman Homes Inc, and was prepared for their use only. The plans, elevations, illustrations, and other material contained within this set may not be reproduced, either in part or wholly, in any manner without the express written permission of Garman Homes, Inc. All right reserved and protected under federal law.

Project Number
Project Number
Plan Number


TYPICAL DETAIL SHEET

SERENITY COLLECTION

Drawn By

MMH
Checked By
CM
Date Drawn
10/28/20
Revision Date
4/26/22

1/2" = 1'-0"

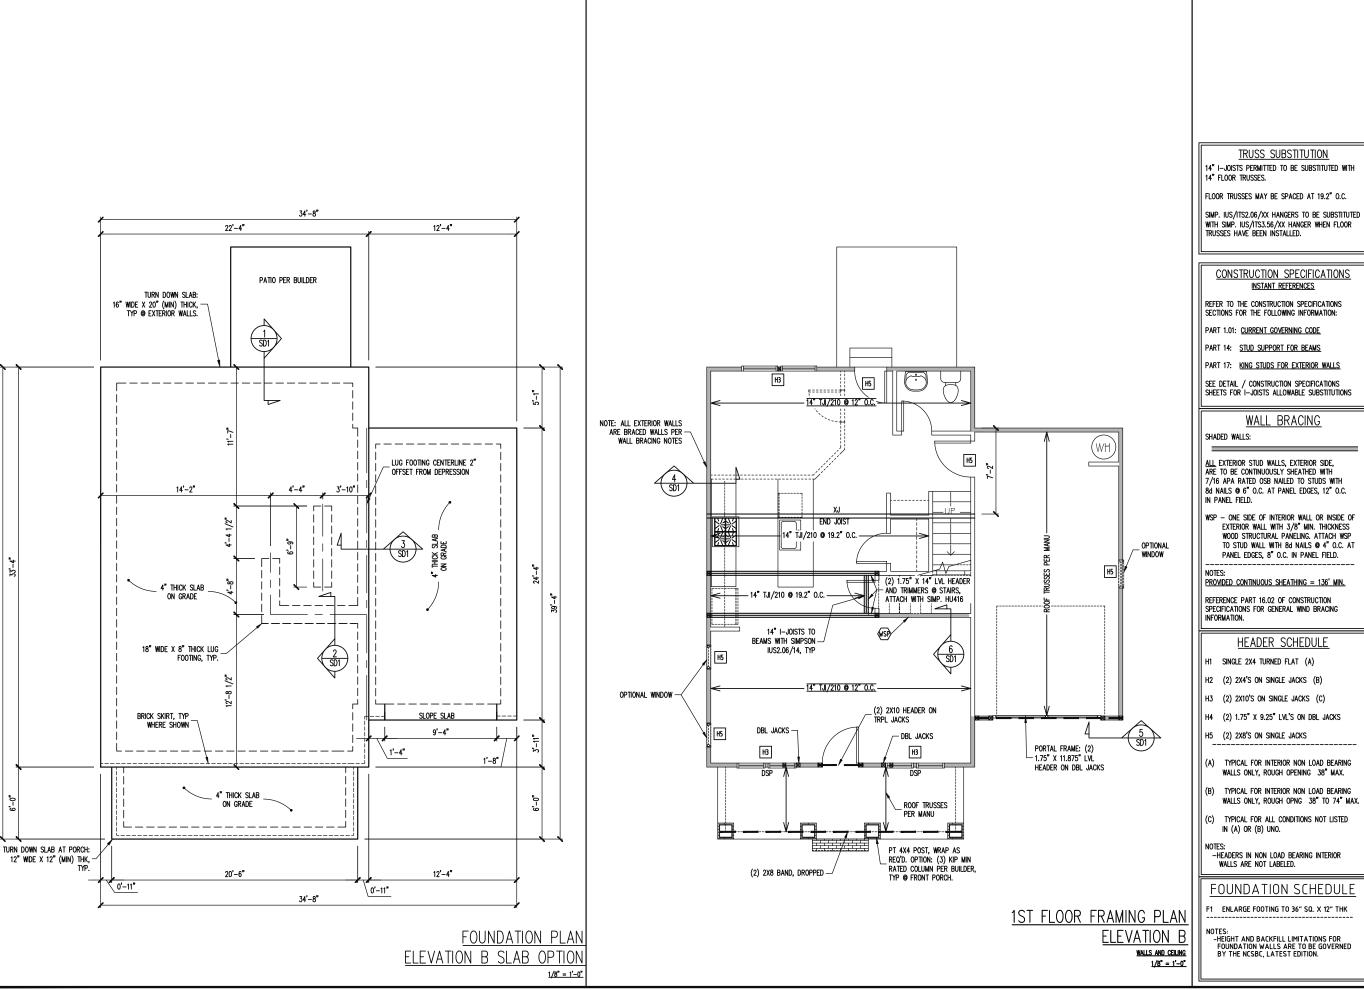

8d NAILS @ 6" O.C. AT PANEL EDGES, 12" O.C.

TO STUD WALL WITH 8d NAILS @ 4" O.C. AT PANEL EDGES, 8" O.C. IN PANEL FIELD.

only. ission listed perm client li written plans are seal date P.A. These Engin takes) FOR 1 YEAR ONLY. I this plan is the prof if construction or per

STRUCTURAL ENGINEERS License No. C-3870 W Millbrook Rd, Suite 201 leigh, North Carolina 27609 Phone (919) 844-1661

× leigh,

FRESH PAINT STRUCTURAL ADDENDUM


ENG: NBG/CMC DATE: 5/19/2022 **PLAN**

> PROJECT NO. 22-30-059

BUTTERCUP

TBD

SHEET NO. S₁B

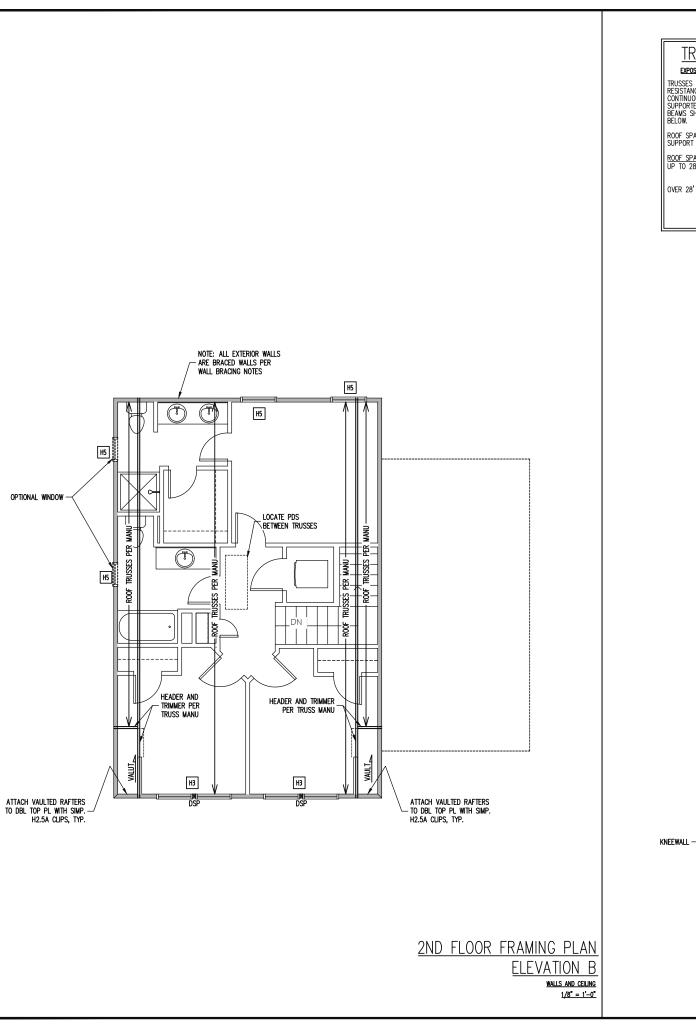

TRUSS UPLIFT CONNECTORS

TRUSSES SHALL BE ATTACHED TO SUPPORT WALL FOR UPLIFT
RESISTANCE. CONTINUOUS OSB WALL SHEATHING BELOW PROVIDES
CONTINUOUS UPLIFT RESISTANCE TO FOUNDATION. ALL TRUSSES
SUPPORTED BY INTERMEDIATE SUPPORT WALLS, KNEEWALLS OR
BEAMS SHALL BE ATTACHED TO SUPPORTING MEMBER PER SCHEDULE
BELOW.

ROOF SPAN IS MEASURED HORIZONTALLY BETWEEN FURTHEST SUPPORT POINTS.

(1) SIMPSON H2.5A HURRICANE CLIP TO DBL TOP PLATE OR BEAM


OR (1) SIMPSON H3 CLIP TO SINGLE 2X4 PLATE

- OPTIONAL SCREENED PORCH DN 4:12 DN 4:12 PITCH CHANGE PITCH CHANGE STICK FRAME HATCHED ROOF: 2X6 RAFTERS @ 16" O.C.

ROOF FRAMING PLAN **ELEVATION B**

1/8" = 1'-0"

-HEADERS IN NON LOAD BEARING INTERIOR WALLS ARE NOT LABELED.

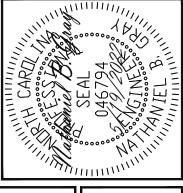

STRUCTURAL ENGINEERS
License No. C-3870
B W Millbrook Rd, Suite 201
aleigh, North Carolina 27609
Phone (919) 844-1661

Engineering from Engine

only. ission

listed perm

for the without

FRAMING NOTES

-ROOF TRUSSES PER MANU. TYPICAL U.N.O. -VERIFY ALL KNEEWALL HEIGHTS, ROOF PITCHES, AND ARCHITECTURAL OVERHANGS PRIOR TO

CONSTRUCTION SPECIFICATIONS INSTANT REFERENCES

REFER TO THE CONSTRUCTION SPECIFICATIONS SECTIONS FOR THE FOLLOWING INFORMATION:

PART 1.01: CURRENT GOVERNING CODE PART 14: STUD SUPPORT FOR BEAMS

PART 17: KING STUDS FOR EXTERIOR WALLS

WALL BRACING

ALL EXTERIOR STUD WALLS, EXTERIOR SIDE, ARE TO BE CONTINUOUSLY SHEATHED WITH 7/16 APA RATED OSB NAILED TO STUDS WITH 8d NAILS @ 6" O.C. AT PANEL EDGES, 12" O.C. IN PANEL FIELD.

PROVIDED CONTINUOUS SHEATHING = 111' MIN. REFERENCE PART 16.02 OF CONSTRUCTION

SPECIFICATIONS FOR GENERAL WIND BRACING INFORMATION. HEADER SCHEDULE


- H1 SINGLE 2X4 TURNED FLAT (A)
- (2) 2X4'S ON SINGLE JACKS (B)
- (2) 2X10'S ON SINGLE JACKS (C)
- H4 (2) 1.75" X 9.25" LVL'S ON DBL JACKS
- H5 (2) 2X8'S ON SINGLE JACKS
- TYPICAL FOR INTERIOR NON LOAD BEARING WALLS ONLY, ROUGH OPENING 38" MAX.
- TYPICAL FOR INTERIOR NON LOAD BEARING WALLS ONLY, ROUGH OPNG 38" TO 74" MAX.
- TYPICAL FOR ALL CONDITIONS NOT LISTED IN (A) OR (B) UNO.


FRESH PAINT STRUCTURAL ADDENDUM TBD plans are seal date P.A. These Engine takes property of permitting t FOR 1 YEAR ONLY. this plan is the propif construction or per ENG: NBG/CMC DATE: 5/19/2022 **PLAN**

BUTTERCUP

PROJECT NO. 22-30-059


> SHEET NO. S₂B

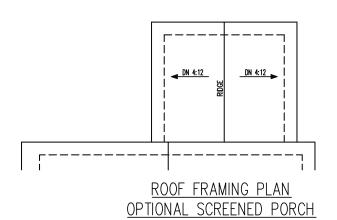

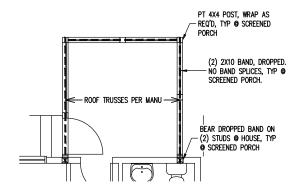

<u>1/8" = 1'-0"</u>

OPTIONAL SCREENED PORCH
1/8" = 1'-0"

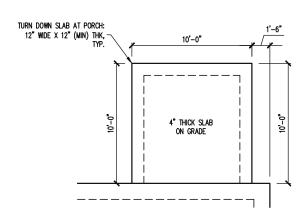


FOUNDATION PLAN
OPTIONAL SCREENED PORCH SLAB
FOUNDATION


1/6" = 1'-0'

G SEAL VALID FOR 1 YEAR ONLY. Inal design of this plan is the property of Engineering Tech Associates, P.A. These plans are for the client listed only. Engineering Tech Associates, P.A. assumes no these plans if construction or permitting takes place more than 1 year after the seal date without written permission from Engineering Tech Associates, P.A.

STRUCTURAL ADDENDUM
TBD | ENG: NBG/CMC DATE: 5/19/2022 PLAN **BUTTERCUP** PROJECT NO. 22-30-059 SHEET NO.


S3B

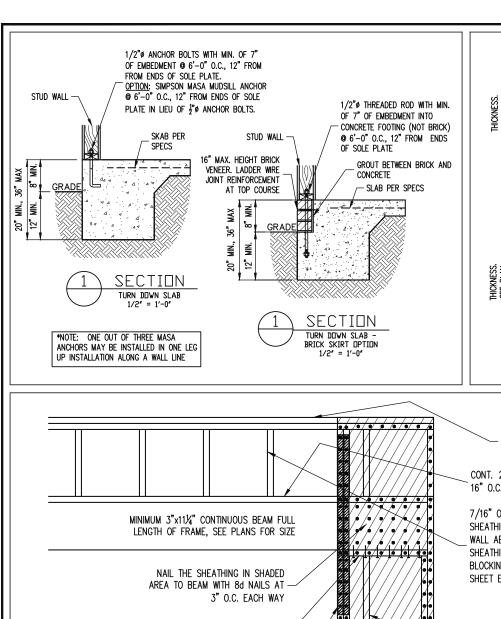


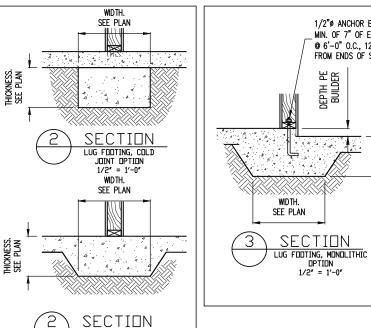


ANCHOR BOLTS WITH A 3/16"x2"x2" PLATE

WASHERS OR ADDITIONAL HOLDOWN PER PLANS

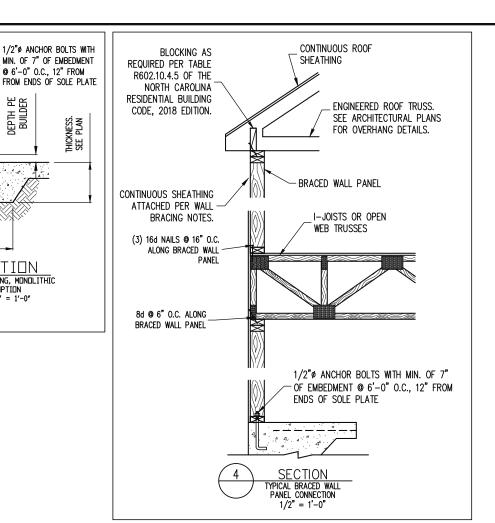

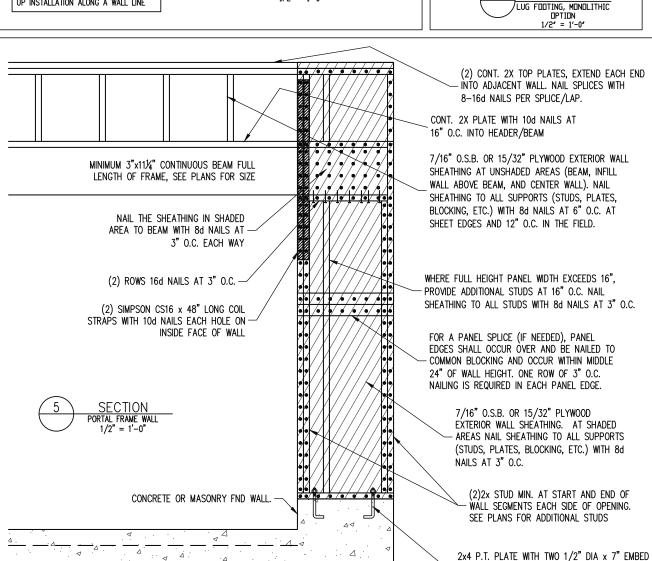

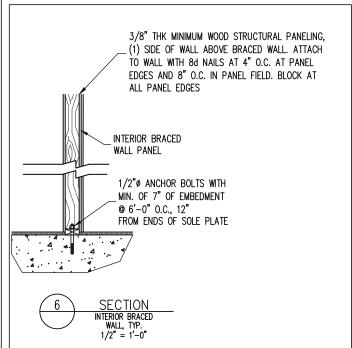

Engineering T from Enginee only. ission listed permi client li written for the without tes, P.A. These plans are year after the seal date FRESH PAINT eering place 1 Engin takes PROJECT NO. 22-30-059 SHEET NO.

STRUCTURAL ENGINEERS
License No. C-3870
8 W Millbrook Rd, Suite 201
aleigh, North Carolina 27609
Phone (919) 844-1661 CTURAL ADDENDUM O FOR 1 YEAR ONLY. If this plan is the property of E if construction or permitting to

BD ENG: NBG/CMC DATE: 5/19/2022 **PLAN BUTTERCUP**

> SD1 4 of 5

CONSTRUCTION SPECIFICATIONS

LIVE LOAD (PSF) DEAD LOAD (PSF)

PART 1: GENERAL

- 1.01 CONSTRUCTION SHALL MEET THE REQUIREMENTS OF THE NORTH CAROLINA RESIDENTIAL CODE, 2018 EDITION
- 1.02 DIMENSIONS SHOWN SHALL GOVERN OVER SCALE ON THESE DRAWINGS.
- METHODS, PROCEDURES AND SEQUENCES OF CONSTRUCTION ARE THE RESPONSIBILITY OF THE CONTRACTOR, WHO SHALL TAKE ALL NECESSARY PRECAUTIONS TO MAINTAIN AND INSURE THE INTEGRITY OF THE STRUCTURE AT ALL STAGES OF CONSTRUCTION. 1.05

2.01 DESIGN LOADS SHALL CONFORM WITH THE TABLE BELOW:

40	10
50	
10	10
20	10
20	10 (15 FOR VAULTS)
	50 10 20

- Notes: individual stair treads are to be designed for the uniformly distributed Live load of 40 PSF or a 300 lb. concentrated load acting over an area of 4 sq. whichever produces the greater stress.

 builder to verify dead load does not exceed 10 PSF when heavy floor or roof finishes such as tile or slate are utilized. Notify engineering under
- 2.02 INTERIOR WALLS: 5 PSF LATERAL.
- 2.03 BASIC WIND DESIGN VELOCITY OF 120 MPH.
- 2.04 SOIL BEARING CAPACITY 2000 PSF (PRESUMPTIVE).

PART 5: CONCRETE AND SLABS ON GRADE

- 5.01 CAST IN PLACE CONCRETE SHALL BE OF NORMAL WEIGHT, 6% AIR ENTRAINMENT, AND SHALL HAVE A MINIMUM COMPRESSIVE STRENGTH OF 3000 PSI AT 28 DAYS TYP UNO. ALL CONCRETE, INCLUDING CONCRETE FOR FOOTINGS, IS TO BE CAST IN PLACE, TYP
- 5.02 REINFORCED CAST IN PLACE CONCRETE SHALL BE PROPORTIONED, MIXED AND PLACED IN ACCORDANCE WITH THE SPECIFICATIONS OF ACI 318, LATEST EDITION.
- SLABS ON GRADE, IF ANY, SHALL CONTAIN SYNTHETIC POLYPROPYLENE FIBRILLATED MICRO FIBERS, FIBER LENGTH 1 1/2", DOSAGE RATE 1 1/2 LBS/CU YD. SLAB TO BE PLACED ON A 6 MIL VAPOR BARRIER ON 2" MIN GRANULAR FILL ON SOIL WITH 90% MIN STANDARD PROCTOR DENSITY. VAPOR BARRIER MAY BE OMITTED FOR SLABS NOT IN FNCLOSED AREAS

PART 6: REBAR AND WIRE REINFORCEMENT

- 6.01 REBAR SHALL BE DEFORMED STEEL CONFORMING TO ASTM A615 GRADE 60 TYP UNO
- LAP SPLICES SHALL BE CLASS B AS DEFINED BY ACI 318, TYP UNO
- 6.03 WIRE REINFORCEMENT SHALL BE 9 GA AND SHALL CONFORM TO ASTM A1064.

PART 7: MASONRY

- 7.01 CONCRETE MASONRY UNITS SHALL CONFORM TO ASTM C90 AND C55, NORMAL WEIGHT,
- 7.02 CLAY MASONRY UNITS SHALL CONFORM TO ASTM C62-17 GRADE SW
- 7.03 MORTAR SHALL BE TYPE S. MORTAR AND GROUT SHALL CONFORM TO ASTM C476, MIN

7.04 MASONRY CONSTRUCTION SHALL CONFORM TO THE SPECIFICATIONS OF ACI 530

7.05 LADDER WIRE REINFORCEMENT SHALL CONFORM TO ASTM A951. 6" MIN LAPS FOR CONTINUOUS WALL APPLICATIONS

PART 8: BOLTS AND LAG SCREWS

ANCHOR RODS AND BOLTS SHALL CONFORM TO ASTM F1554-15 GRADE 36 UNO. BENT ANCHOR BOLTS SHALL HAVE A 2" MIN HOOK UNO

9.01 NAILS, SPIKES AND STAPLES SHALL CONFORM TO ASTM F 1667- 05. NAILS ARE TO BE COMMON WIRE OR BOX

PART 10: DIMENSIONAL LUMBER

10.01 SOLID SAWN WOOD FRAMING DESIGN IS BASED ON NO. 2 SPRUCE PINE FIR <u>OR</u> SYP #2 FOR JOISTS, RAFTERS, GIRDERS, BEAMS, STUDS, ETC.

- LVL OR PSL MINIMUM ALLOWABLE DESIGN STRESSES ARE AS FOLLOWS: E= 1,9 \times 10c6 PSl, Fb = 2600 PSl, Fv = 285 PSl, Fc = 750 PSl LSL MINIMUM ALLOWABLE DESIGN STRESSES ARE AS FOLLOWS: E= 1.3 \times 10c6 PSl, Fb = 1700 PSl, Fv = 400 PSl, Fc = 680 PSl 11.01
- 11.02 LVL OR PSL MEMBERS MAY BE RIPPED FROM DEEPER MEMBERS TO MATCH THE MEMBER DEPTH SPECIFIED IN THE PLANS

PART 12: PRESSURE TREATED LUMBER

LUMBER IN CONTACT WITH THE GROUND, CONCRETE OR MASONRY SHALL BE PRESSURE TREATED IN ACCORDANCE WITH AWPA STANDARD C-15. ALL OTHER EXPOSED LUMBER SHALL BE TREATED IN ACCORDANCE WITH AWPA STANDARD C-2 OR BY ANY METHOD GIVING EQUAL PROTECTION. THE BUILDING CODE OFFICE MAY ALSO APPROVE A NATURAL DECAY RESISTANT WOOD PER SECTION 19-6(A)

PART 14: STUD SUPPORTS FOR BEAMS

- 14.01 STEEL, ENGINEERED LUMBER, AND FLITCH PLATE BEAMS BEARING ON A STUD WALL SHALL BEAR AS FOLLOWS:
- 1-WHEN THE BEAM IS PERPENDICULAR TO, OR SKEWED RELATIVE TO THE WALL, THE BEAM SHALL BEAR <u>FULL WIDTH</u> ON THE SUPPORTING WALL INDICATED AND SHALL BE SUPPORTED BY A MINIMUM OF THREE GANGED STUDS, OR A GANGED STUD COLUMN WITH A NUMBER OF STUDS SUCH THAT THE STUD COLUMN IS AT LEAST AS WIDE AS THE TRUE WIDTH OF THE BEAM BEING SUPPORTED, WHICHEVER IS GREATER, TYP UNO, FOR THE SKEWED ON
- 2-BEAMS BEARING ONTO THE END OF A STUD WALL PARALLEL TO THE BEAM SHALL BEAR 2 DECIMING DEPARTMENT WITH THE END OF A STUD WALL PARALLEL TO THE BEAM SHALL BE. A MINIMUM OF 4 1/2" ONTO THE WALL AND BE SUPPORTED BY A TRPL STUD GANGED COLUMN TYP UNO.
- 4.02 DIMENSIONAL LUMBER BEAMS BEARING ON A STUD WALL SHALL BEAR AS FOLLOWS:
- 1-WHEN THE BEAM IS PERPENDICULAR TO, OR SKEWED RELATIVE TO THE WALL, THE BEAM SHALL BEAR <u>FULL WIDTH</u> ON THE SUPPORTING WALL INDICATED (LESS 1 1/2" TO ALLOW FOR A CONTINUOUS RIM JOIST WHERE APPLICABLE) AND SHALL BE SUPPORTED BY A TO BE SUPPORTED BY (3) STUDS). FOR THE SKEWED CONDITION PARTICULAR CARE SHALL BE TAKEN TO ENSURE STUD COLUMN IS CENTERED ON THE BEAM 2—BEAMS BEARING ONTO THE END OF A STUD WALL PARALLEL TO THE BEAM SHALL BEAR A
- MINIMUM OF 3" ONTO THE WALL AND BE SUPPORTED BY A DBL STUD GANGED COLUMN
- 4.03 EXTRA JOISTS BEARING ON A STUD WALL PERPENDICULAR TO OR SKEWED RELATIVE TO THE BEAM SHALL BE SUPPORTED BY ONE ADDITIONAL STUD.
- STUDS THAT ARE GANGED TO FORM A COLUMN SHALL HAVE ADJACENT STUDS WITHIN STUDS THAT ARE GARGED TO FORM A COLUMN SHALL HAVE ADJACENT STUDS WITHIN THE COLUMN NAILED TOGETHER WITH ONE ROW OF 10d NAILS & 18" O.C. (TWO ROWS OF 10d NAILS & 8" O.C., 3" APART, FOR 2XB OR 2X10 STUDS) ALL COLUMNS SHALL BE CONTINUOUS DOWN TO THE FOUNDATION OR OTHER PROPERLY DESIGNED STRUCTURAL ELEMENT SUCH AS A BEAM. COLUMNS TRANSFERRIG LOADS THROUGH FLOOR LEVELS SHALL BE SOLIDLY BLOCKED FOR THE FULL WIDTH OF THE STUD COLUMN

LUMBER

OJ OLIAD JOIST

SQ SQUARE

SP STUD POCKET

PRESSURE TREATED

WITHIN THE CAVITY FORMED BY THE FLOOR JOISTS.

- SOLID SAWN LUMBER JOISTS THAT ARE GANGED TO FORM A BEAM SHALL HAVE ADJACENT MEMBERS IN THE BEAM NAILED TOGETHER WITH THREE ROWS OF 10d NAILS @ 16" O.C. FOR 2X10 OR LARGER, TWO ROWS OF 10d NAILS @ 16" O.C. FOR 2X8, ONE ROW OF 10d NAILS @ 16" O.C. FOR 2X6 OR SMALLER, STAGGER ROWS 5" MIN.
- LVL MEMBERS THAT ARE GANGED TO FORM A BEAM SHALL HAVE ADJACENT MEMBERS IN THE BEAM FASTENED TOGETHER PER MANUFACTURERS RECOMMENDATIONS, TYP

PART 16: WALL FRAMING AND BRACING

PART 15: NAILING OF MULTI PLY WOOD BEAMS

STUD WALLS SHALL CONSIST OF 2X4 STUDS SPACED AT 16" O.C. UNO. STUDS SHALL BE CONTINUOUS FROM SOLE PLATE AT FLOOR TO DOUBLE TOP PLATE AT THE CELLING OR ROOF. NO INTERMEDIATE BANDS OR PLATES SHALL CAUSE DISCONTINUITIES IN A STUD WALL EXCEPT AS REQUIRED FOR DOOR OR WINDOW OPENINGS. THE KING STUDS FOR SUCH OPENINGS SHALL BE CONTINUOUS, TYP UNO.

MAX ALLOWABLE WALL HEIGHTS FOR EXTERIOR STUD WALLS, WITH SOLE PLATE AND DBL TOP PLATE AND 7/16" OSB EXTERIOR STUD WALLS, WITH SOLE PLATE AND DBL TOP PLATE AND 7/16" OSB EXTERIOR BRACING AND ROW OF 2X4 / 2X6 PURLINS AT 8" HEIGHT (AND AT 16" HEIGHT FOR TALL WALLS), TYP UNO:

2X4 @ 16" O.C.: 112"-0" 2X6 @ 12" O.C.: 18"-8"

DBL 2X4 @ 16" O.C.: 13"-4" DBL 2X6 @ 16" O.C.: 21"-0"

16.02 FOR WALL BRACING THE FOLLOWING SHALL APPLY:

-BLOCKING AT UNSUPPORTED PANEL EDGES IS REQUIRED TYP UNO.

-WALL BRACING IS BY ENGINEERED DESIGN AND NOT PRESCRIPTIVE PER SECTION
602.10 OF THE 2018 NORC. CONTINUOUS SHEATHING HAS BEEN PROVIDED, ALONG
WITH ALTERNATIVE METHODS TO INSURE THE MINIMUM INTENT OF SECTION 602.10
OF THE 2018 NORC HAS BEEN MET AND EXCEEDED.

-BRACED WALL PANELS SHALL BE FASTENED IN ACCORDANCE WITH TABLE 602.3(1) TO
PROVIDE CONTINUOUS PANEL UPLIET RESISTANCE AND COMPULANCE WITH NORBC
R602.35 AND R802.11 UNLESS NOTED OTHERWISE ON STRUCTURAL PLANS.

-MAY SUBSTITUTE WSP FOR GB

-SINGLE JOIST, CONTINUOUS RIM JOIST, OR BLOCKING OF EQUAL DEPTH IS REQUIRED
ABOVE AND BELOW ALL BRACED WALLS. NAIL BLOCKING ABOVE WALL TO TOP PLATE
WITH 16d TOE NAILS @ 6" OC. NAIL SOLE PLATE OF BRACED WALL IO BLOCKING
BELOW WITH 3.1 JIGH NAILS @ 16" OC. BLOCKING AT HORIZONTAL JOINTS IN RRACED

BELOW WITH (3) 16d NAILS @ 16" O.C. BLOCKING AT HORIZONTAL JOINTS IN BRACED WALL LINES ONLY REQUIRED AT SHADED WALLS, UNO.

7.01 KING STUDS FOR OPENINGS IN EXTERIOR WALLS SHALL BE AS FOLLOWS:

		NUMBER OF KING STUDS				
IAX OPENIN	G WIDTH	5'-0"	9'-0"	13'-0"	17'-0"	21'-0"
	2X4	1	2	3	4	5
STUD SIZE	2X6	1	1	2	2	2
	2X8	1	1	1	1	2

PART 18: SUBSTITUTIONS

MATERIAL OR MEMBER SIZE SUBSTITUTIONS OR PLAN DEVIATIONS REQUIRE THE WRITTEN AUTHORIZATION OF THE DESIGNERS. UNAUTHORIZED DEVIATIONS ARE THE SOLE RESPONSIBILITY OF THE CONTRACTOR. 18.01

PART 19: OWNERSHIP OF STRUCTURAL DESIGN

THE STRUCTURAL DESIGN OF THIS PLAN IS THE PROPERTY THE STROCTURAL DEASON OF THIS PLAN IS THE PROPERTY OF ENGINEERING TECH ASSOCIATES (ETA). THESE PLANS ARE FOR THE ONE TIME USE AT THE LOCATION INDICATED AND FOR THE CLIENT LISTED. ETA ASSUMES NO LIABILITY FOR THESE PLANS IF THEY ARE REPRODUCED, IN WHOLE OR IN PART, FOR CONSTRUCTION AT ANY OTHER LOCATION WITHOUT WRITTEN PERMISSION FROM ETA

NOTES

THE BUILDER IS RESPONSIBLE FOR REVIEWING PLANS PRIOR TO CONSTRUCTION. THE BUILDER SHALL IMMEDIATELY CONTACT THE ENGINEER OF RECORD (EOR) BEFORE PROCEEDING IF THE FOLLOWING CONDITIONS ARE NOTED BEFORE OR DURING CONSTRUCTION:

- 1) THE WORKING PLANS DO NOT BEAR THE SEAL OF THE EOR 2) THE PLANS CONTAIN DISCREPANT OR INCOMPLETE INFORMATION

ANY ERRORS DUE TO A FAILURE TO FOLLOW THE ABOVE PROCEDURES SHALL NOT BE THE RESPONSIBILITY OF THE EOR. FURTHERMORE, IT IS THE RESPONSIBILITY OF THE BUILDER TO ENSURE THAN ANY REVISIONS ISSUED BY THE EOR ARE PROMPLY DISTRIBUTED TO THE SUBCONTRACTORS

THE EOR DOES NOT PERFORM FENESTRATION OR VENTING CALCULATIONS OR ANY OTHER CALCULATIONS THAT ARE NOT DIRECTLY RELATED TO STRUCTURAL ENGINEERING.

ROOF AND FLOOR TRUSSES TO BE DESIGNED BY AN ENGINEER REGISTERED BY THE STATE, FINAL TRUSS DRAWING SHOULD BE SUBMITTED TO THE EOR FOR REVIEW

ABV ABOVE FND FOUNDATION R F ROTH FNDS HDG HOT DIPPED GALVANIZED BTWN BETWEEN HGR HANGER

CAST IN PLACE CONC CONCRETE CONTINUOUS SHEATHIN DOUBLE PSL PARALLEL STRAND

DIA DIAMETER DJ DOUBLE JOIST
DSP DBL STUD POCKET **EQUAL** EA EACH FLG FLANGE L PL FLITCH FLR FLOOR FLITCH PLATE

ABBREVIATIONS TJ TRIPLE JOIST TYP TYPICAL TRPI TRIPI F LVL LAMINATED VENEER OTHERWISE XJ EXTRA JOIST NTS NOT TO SCALE O.C. ON CENTER

TRIPLE STUD POCKET UNO UNLESS NOTED


ALLOWABLE I-JOIST SUBSTITUTION

SIMPSON FACE SIMPSON TOP

NOTE: MAINTAIN JOIST DEPTH DIRECTION, AND SPACING SPECIFIED ON PLANS.

MANUFACTURER	DEPTH	SERIES	MOUNT HGR	FLANGE HGR
BLUELINX BOISE CASCADE BOISE CASCADE LP CORP NORDIC ROSEBURG WEYERHAEUSER	14" 14" 14" 14" 14" 14" 14"	BLI 40 BCI 5000s BCI 6000S LPI 20+ NI 40X RFPI 40s TJI 210	IUS2.56/14 IUS2.06/14 IUS2.37/14 IUS2.56/14 IUS2.56/14 IUS2.56/14 IUS2.06/14	ITS2.56/14 ITS2.06/14 ITS2.37/14 ITS2.56/14 ITS2.56/14 ITS2.56/14 ITS2.06/14
WEYERHAEUSER	14"	EEI-20	IUS2.37/14	ITS2.73/14

JOISTS NOT LISTED IN THE ABOVE TABLE MAY BE USED PROVIDED THEY MFET OR EXCEED THE PROPERTIES OF THOSE LISTED SUBSTITUTE USP BRAND HANGERS WITH EQUIVALENT VALUES AS DESIRED.

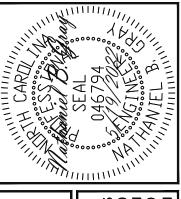

2

eering Engine

only. ission

listed perm

client I written

for the without

plans are seal date

These r

P.A. Traffer

eering place

Engin takes

ತ್ರಕ್ಷ

STRUCTURAL ENGINEERS
License No. C-3870
W Millbrook Rd, Suite 201
leigh, North Carolina 27609
Phone (919) 844-1661 × eigh,

CTURAL FRESH 8

property of permitting t the pr ENG: NBG/CMC DATE: 5/19/2022 BUTTERCUP PROJECT NO.

> 22-30-059 SHEET NO. SD2

PLAN