Residence for

Garman Homes Lot 0097 Serenity Fuquay Varina, North Carolina

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FIRST & SECOND FLOOR ELECTRICAL PLANS FIRST & SECOND FLOOR MECHANICAL PLANS FIRST FLOOR PLUMBING PLAN D CONSTRUCTION DETAILS

COVER SHEET

FRONT & LEFT SIDE ELEVATIONS

REAR & RIGHT SIDE ELEVATIONS FIRST & SECOND FLOOR PLANS

GENERAL NOTES

1. ALL WORK TO BE DONE IN STRICT ACCORDANCE WITH NORTH CAROLINA STATE RESIDENTIAL BUILDING CODE, 2018 EDITION (HEREWITH SHOWN AS N.C.S.R.B.C.)

2. DIMENSIONS SHOWN ON DRAWINGS GOVERN OVER SCALE.

3. STUD WALL DESIGN SHALL CONFORM TO ALL N.C.S.R.B.C. REQUIREMENTS

4. CONTRACTOR SHALL USE TEMPERED SAFETY GLASS IN ALL LOCATIONS AS REQUIRED BY N.C.S.R.B.C., 2018 EDITION, SECTION R308.4.

5. ANY HABITABLE ROOM SHALL MEET ALL LIGHT/VENTILATION AND EGRESS AS REQUIRED BY N.C.S.R.B.C. 2018 EDITION, SECTIONS R-303.1 AND R-310.1

6. ALL EXTERIOR WALLS SHOWN ON FLOOR PLANS ARE 2X6 FRAME UNLESS NOTED OTHERWISE. ALL INTERIOR WALLS SHOWN ON FLOOR PLANS ARE 2X4 FRAME UNLESS NOTED OTHERWISE

7. ALL ANGLED WALLS SHOWN ON FLOOR PLANS ARE 45 UNLESS NOTED OTHERWISE.

8. ALL WINDOWS SHALL HAVE A MINIMUM DPI RATING OF 25. BUILDER SHALL VERIFY WITH WINDOW MANUFACTURER THAT UNITS INSTALLED MEET THESE REQUIREMENTS AS PER N.C.S.R.B.C., 2018 EDITION, TABLE 301.2(4)

9. ENERGY EFFICIENCY REQUIREMENTS FOR THE SPECIFIC CLIMATE ZONE WHERE STRUCTURE IS BEING BUILT SHALL BE IN ACCORDANCE WITH CHAPTER 11 OF THE N.C.S.R.B.C., 2018 EDITION, AS SHOWN IN SECTION N1101.2.

MATERIALS LEGEND

TOILET ACCESSORIES LEGEND

PROVIDE 2X4 BLOCKING IN THE WALL FOR THE FOLLOWING:

MEDICINE CABINET

MAGAZINE RACK

TOWEL RING

TOWEL BAR TOILET PAPER HOLDER

EARTH/COMPACT

CONCRETE

CONCRETE

BLOCK/STONE

TP TR

MC

MR

FILL

BRICK

STEEL

FINISH WOOD

ROUGH

WOOD

RIGID INSULATION

BLOCKING

PLYWOOD

BATT INSULATION

- FOUNDATION PLAN CRAWLSPACE STANDARD FIRST FLOOR FRAMING PLAN
- SECOND FLOOR FRAMING ROOF FRAMING PLAN
- OPTIONAL IN-LAW SUITE DETAILS SD1 STRUCTURAL DETAILS
- SD2 STRUCTURAL DETAILS
- SD3 STRUCTURAL DETAILS
- SPEC CONSTRUCTION SPECIFICATIONS

RESIDENTIAL BUILDING CODE SUMMARY

1. PLANS ARE DESIGNED TO THE 2018 N.C.S.R.B.C

2. HOUSE IS DESIGNED FOR 115 MPH ULTIMATE DESIGN WIND SPEED (89 MPH NOMINAL DESIGN WIND SPEED), EXPOSURE B.

3. ANCHOR BOLTS SHALL BE MIN. 1/2" DIAMETER AND SHALL EXTEND 7" MIN. INTO MASONRY OR CONCRETE. BOLTS TO BE NO MORE THAN 6' O.C. AND WITHIN 12" FROM THE CORNER

4. MEAN ROOF HEIGHT: 29'-3"

5. COMPONENT & CLADDING DESIGNED FOR THE FOLLOWING LOADS:

MEAN ROOF HGT:	UP TO 30'	<u>30'-1" TO 35'</u>	<u>35'-1" TO 40'</u>	40'-1" TO 45'
ZONE 1	16.5,-18.0	17.3,-18.9	17.3,-18.9	17.3,-18.9
ZONE 2	16.5,-21.0	17.3,-22.1	17.3,-22.1	17.3,-22.1
ZONE 3	16.5,-21.0	17.3,-22.1	17.3,-22.1	17.3,-22.1
ZONE 4	18.0,-19.5	18.9,-20.5	18.9,-20.5	18.9,-20.5
ZONE 5	18.0,-24.1	18.9,-25.3	18.9,-25.3	18.9,-25.3

- 6. MINIMUM VALUES FOR ENERGY COMPLIANCE: Zone 4
- 7. MAXIMUM GLAZING U-FACTOR: .35

8. INSULATING VALUES: CEILING: R-38 / WALLS: R-15 / FLOOR: R-19 SLABS: R-10. CODE REFERENCE: TABLE N1102.1

AREA CALCULATIONS

HEATED (SQ. FT.)		UNHEATED (SQ. FT.)		UNFINISHED (SQ. FT.)	
BASEMENT: 1ST FLOOR: 2ND FLOOR: TOTAL:	N/A 894 750 1644	GARAGE: FRONT PORCH: SCREEN PORCH: TOTAL:	280 38 100 418	BASEMENT: 1ST FLOOR: 2ND FLOOR: ATTIC:	N/A N/A N/A N/A
				TOTAL:	N/A
				OVERALL DIMENSIONS	
				WIDTH: DEPTH:	43'-0" 54'-0"
FOUNDATION VENTILATION CALCULATIONS					
(REFERENCE: N.C.S.R.B.C. 2018 EDITION SECTION R408)					

NOT APPLICABLE WITH SLAB FOUNDATIONS


ATTIC VENTILATION REQUIREMENTS

NATURAL ROOF VENTILATION CALCULATIONS MECHANICAL ROOF VENTILATION CALCULATIONS

1212 SQ. FT. = 8.08 SQ. FT. VENT REQ'D 150 BUILDER TO PROVIDE APPROPRIATE VENTILATING AS REQUIRED PER CODE


<u>1212 SQ. FT.</u> = 4.04 SQ. FT. VENT REQ'D 300 BUILDER TO PROVIDE APPROPRIATE VENTILATING AS REQUIRED PER CODE




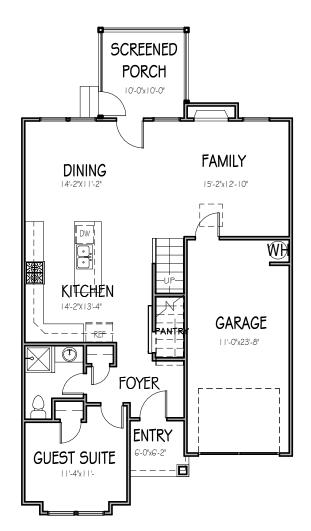



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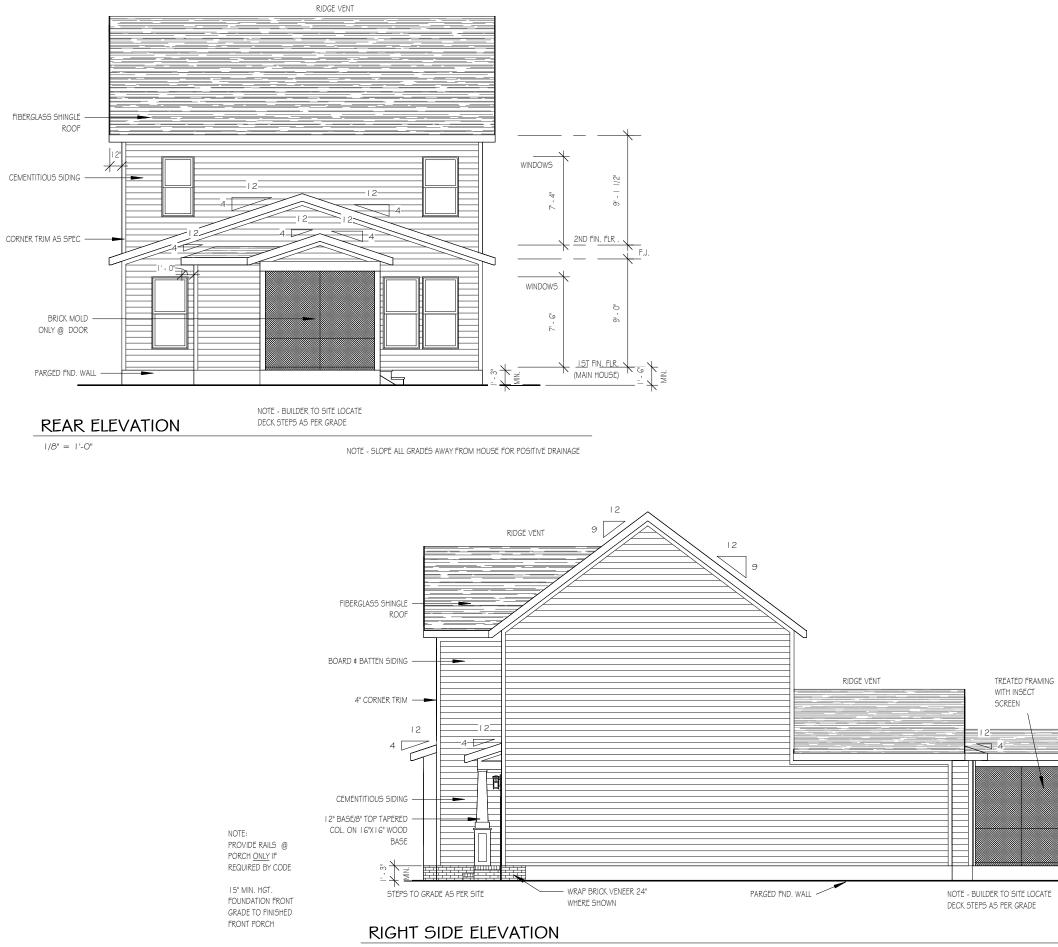
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Plan Number			
FP-1644			

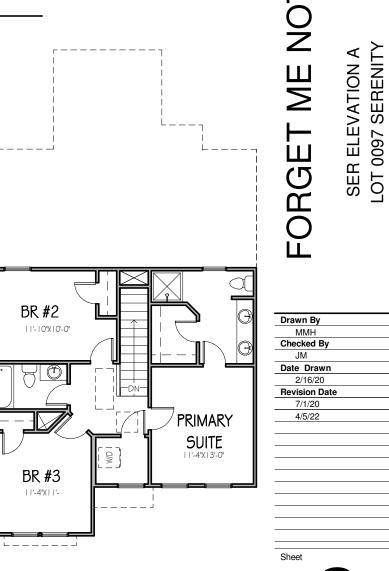
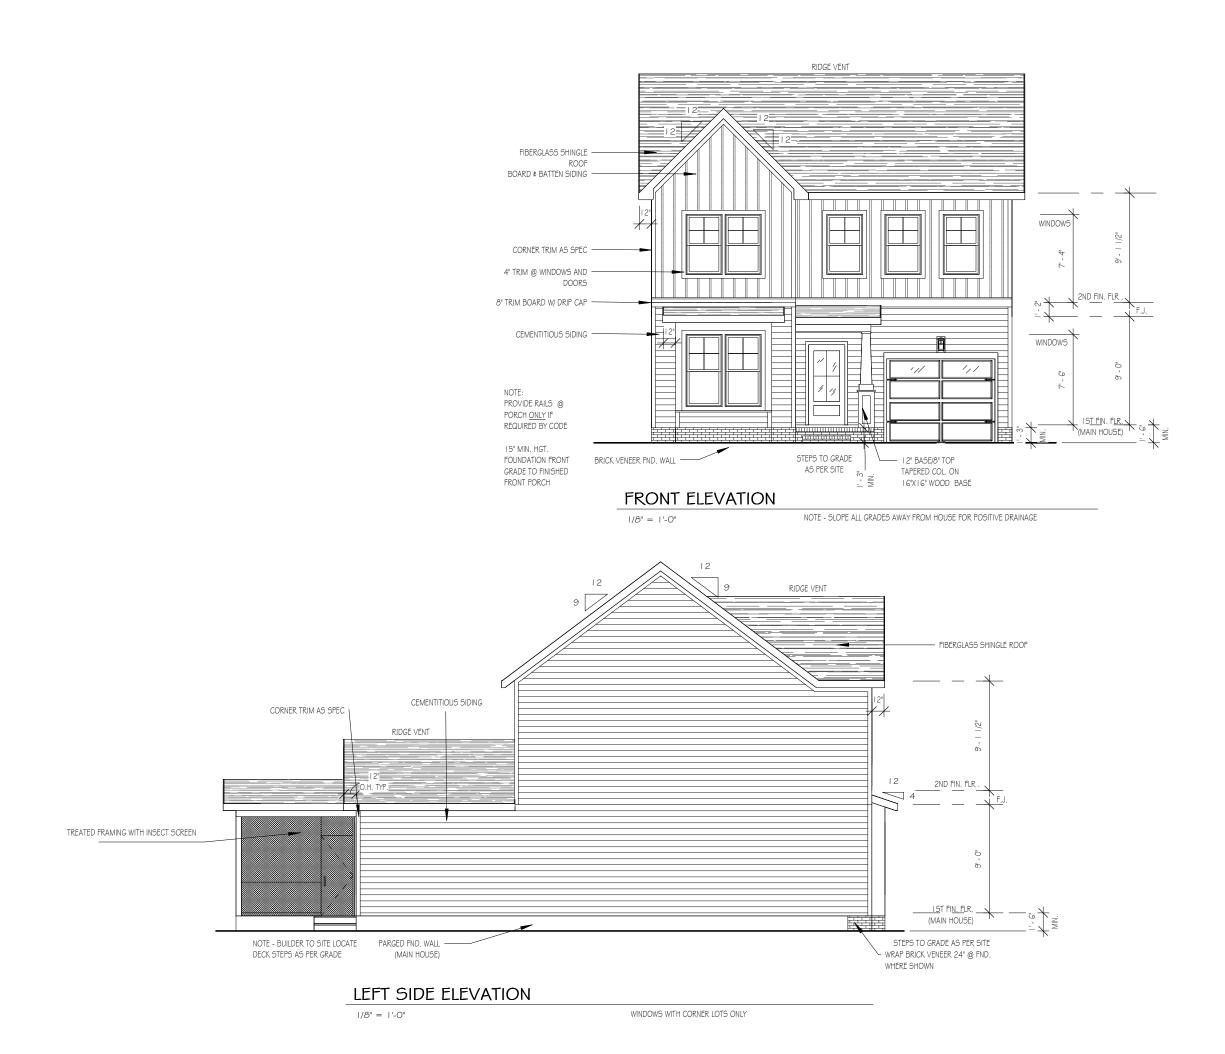
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4/5/22			



1/8" = 1'-0"

WINDOWS WITH CORNER LOTS ONLY

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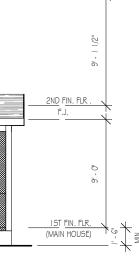
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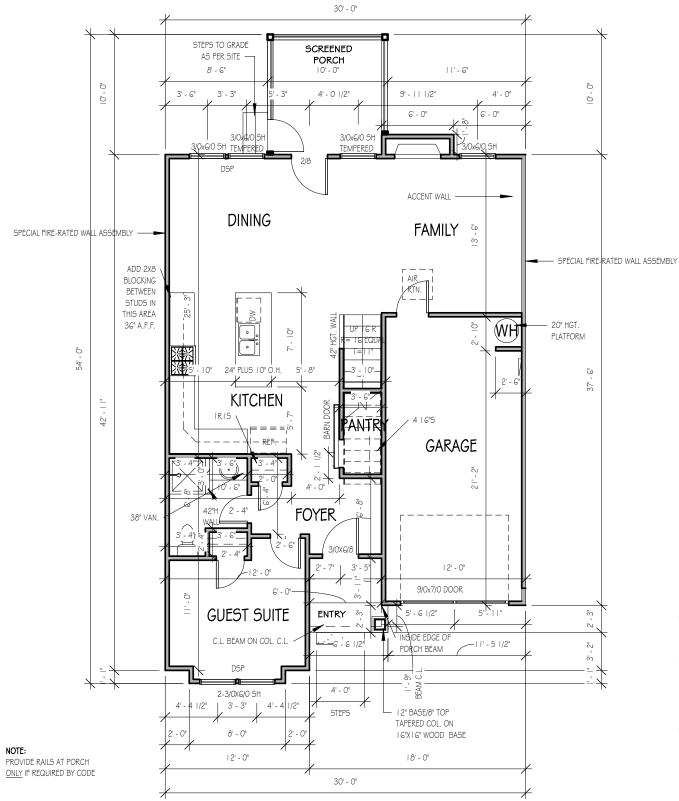


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Sheet

2





FIRST FLOOR

1/8" = 1'-0"

9'-0" CLG. HGT. U.N.O. SET WINDOWS @ 7'-6" U.N.O.

NOTES:

ROUGH FRAME ALL CASED OPENINGS 2" BIGGER THAN FINISHED OPENING CALLS FOR

ROUGH FRAME ALL WINDOW OPENINGS 1/2" LARGER THAN FINISHED WINDOW CALLS FOR, WHEN PAIRED WITH ANOTHER WINDOW THAT CALLS FOR DSP, ADD EXTRA TO OUTSIDE MEASUREMENT OF WINDOW


ALL EXTERIOR WALLS 2X4

TOP OF ALL WINDOWS SILLS SHALL BE 24" MINIMUM ABOVE THE FINISHED FLOOR <u>OR</u> A FALL PREVENTION DEVICE SHALL BE INSTALLED IN ACCORDANCE WITH SECTION R312.2 OF N.C.S.R.B.C., 2018 EDITION THE PURPOSE OF THESE DRAWINGS IS TO SHOW THE INTENT OF THE DESIGN AND CONSTRUCTION OF THIS HOME. CONTRACTOR SHOULD VERIFY ALL CONDITIONS AND DIMENSIONS PRIOR TO CONSTRUCTION. ONCE A PERMIT HAS BEEN ISSUED, CONTRACTOR SHALL ASSUME ALL RESPONSIBILITY TO THE ACCURACY OF THE PLANS AND ANY CHANGES MADE DURING CONSTRUCTION.



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FORGET ME NOT SER ELEVATION A LOT 0097 SERENITY

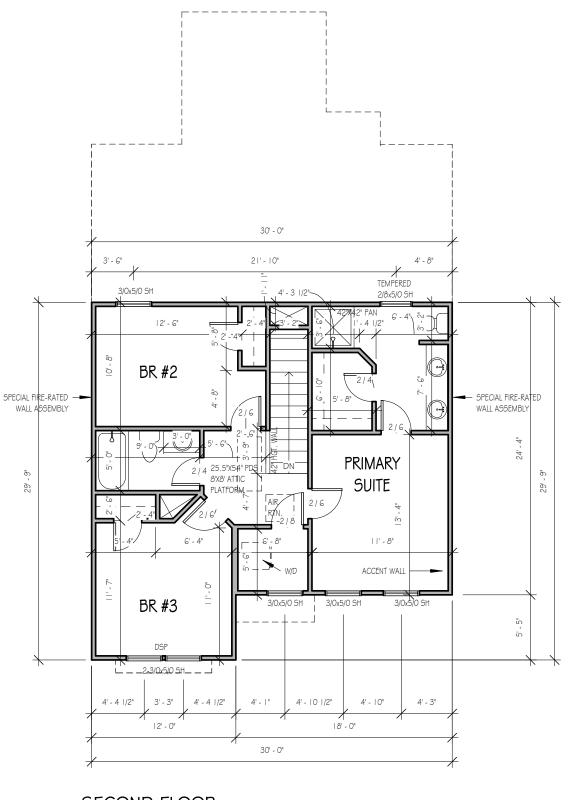

NOTES: ROUGH FRAME ALL CASED OPENINGS 2" BIGGER THAN FINISHED OPENING CALLS FOR

ROUGH FRAME ALL WINDOW OPENINGS 1/2* LARGER THAN FINISHED WINDOW CALLS FOR, WHEN PAIRED WITH ANOTHER WINDOW THAT CALLS FOR DSP, ADD EXTRA TO OUTSIDE MEASUREMENT OF WINDOW

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SECOND FLOOR

|/8" = |'-0"


9'-0" CLG. HGT. U.N.O. SET WINDOWS @ 7'-4" U.N.O. THE PURPOSE OF THESE DRAWINGS IS TO SHOW THE INTENT OF THE DESIGN AND CONSTRUCTION OF THIS HOME. CONTRACTOR SHOULD VERIFY ALL CONDITIONS AND DIMENSIONS PRIOR TO CONSTRUCTION. ONCE A PERMIT HAS BEEN ISSUED, CONTRACTOR SHALL ASSUME ALL RESPONSIBILITY TO THE ACCURACY OF THE PLANS AND ANY CHANGES MADE DURING CONSTRUCTION.



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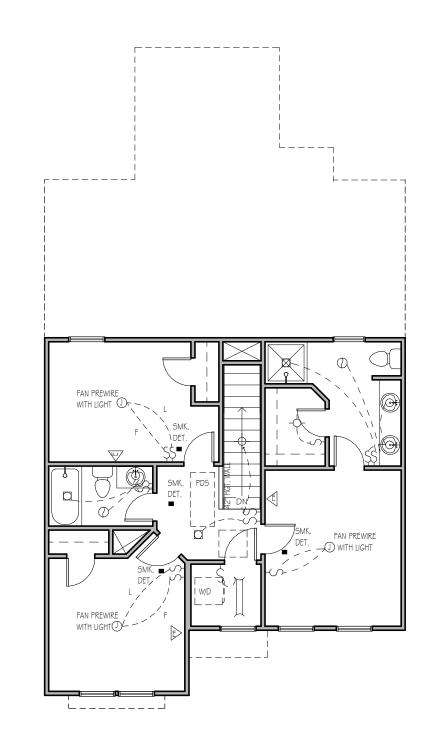


**NOTE: THREE ETHERNET OUTLETS IN THESE PREDETERMINED LOCATIONS ARE STANDARD. ANY ADDITIONAL OUTLETS ARE AN UPGRADE.

FIRST FLOOR ELECTRICAL PLAN

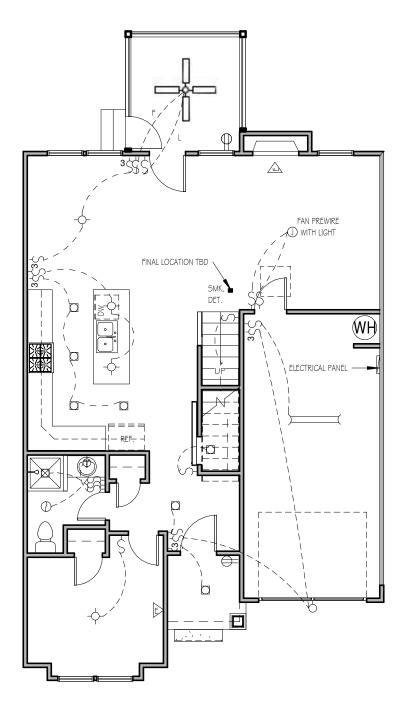1/8" = 1'-0"


NOTE - ELECTRICAL RECEPTACLE AND SWITCH QUANTIFIES AND LOCATIONS SHOWN ON PLAN ARE FOR ILLUSTRATION PURPOSES ONLY. ACTUAL NUMBER AN D LOCATIONS SHALL BE FIELD DETERMINED AS PER CLIENT AND BUILDER EXCEPT WHERE CODE REQUIREMENTS APPLY.



SECOND FLOOR ELECTRICAL PLAN

|/8" = |'-0"

NOTE - ELECTRICAL RECEPTACLE AND SWITCH QUANTITIES AND LOCATIONS SHOWN ON PLAN ARE FOR ILLUSTRATION PURPOSES ONLY. ACTUAL NUMBER AN D LOCATIONS SHALL BE FIELD DETERMINED AS PER CLIENT AND BUILDER EXCEPT WHERE CODE REQUIREMENTS APPLY. THE PURPOSE OF THESE DRAWINGS IS TO SHOW THE INTENT OF THE DESIGN AND CONSTRUCTION OF THIS HOME. CONTRACTOR SHOULD VERIFY ALL CONDITIONS AND DIMENSIONS PRIOR TO CONSTRUCTION. ONCE A PERMIT HAS BEEN ISSUED, CONTRACTOR SHALL ASSUME ALL RESPONSIBILITY TO THE ACCURACY OF THE PLANS AND ANY CHANGES MADE DURING CONSTRUCTION.

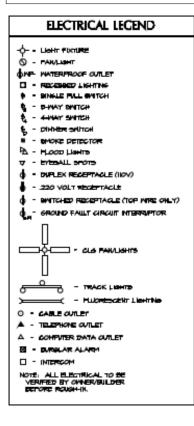



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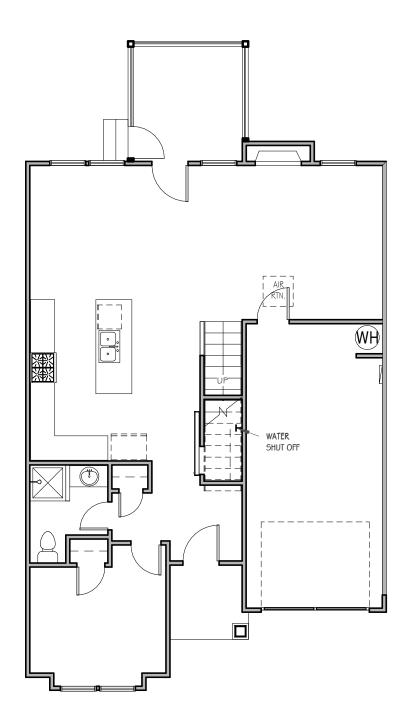
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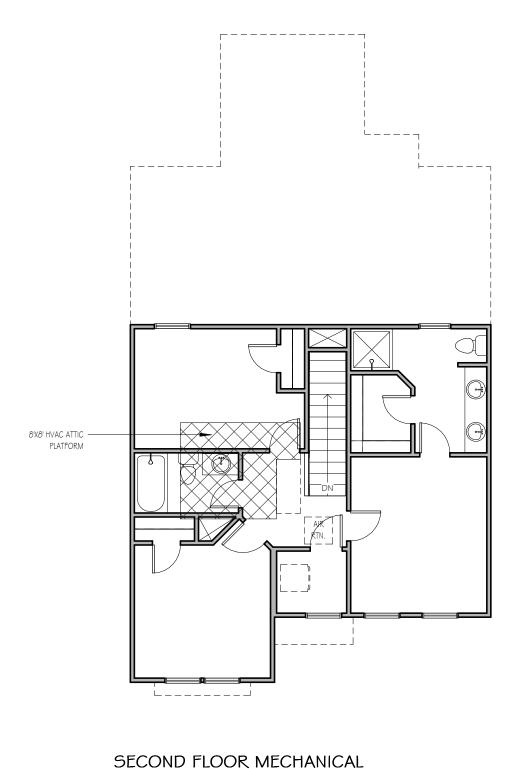


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PAGE

|/8" = |'-0"

1/8" = 1'-0"

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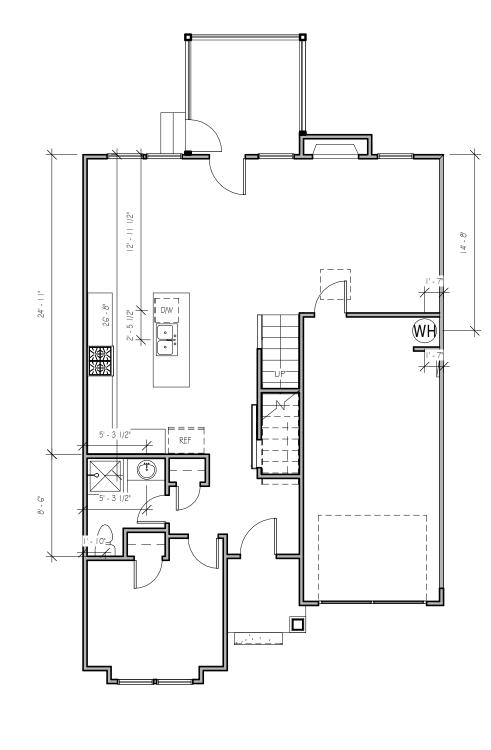
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1/8" = 1'-0"



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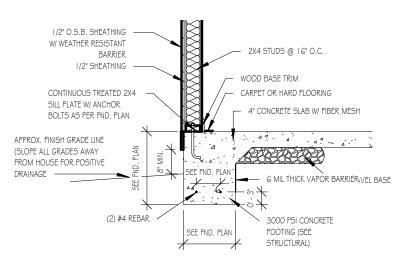



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FOUNDATION DETAIL - SLAB

1/2" = 1'-0"






LUG FOOTING

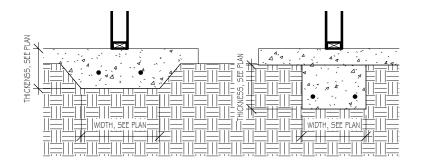1/2" = 1'-0"

1/2" = 1'-0"

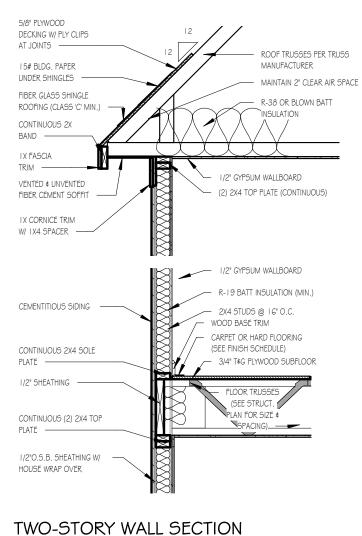

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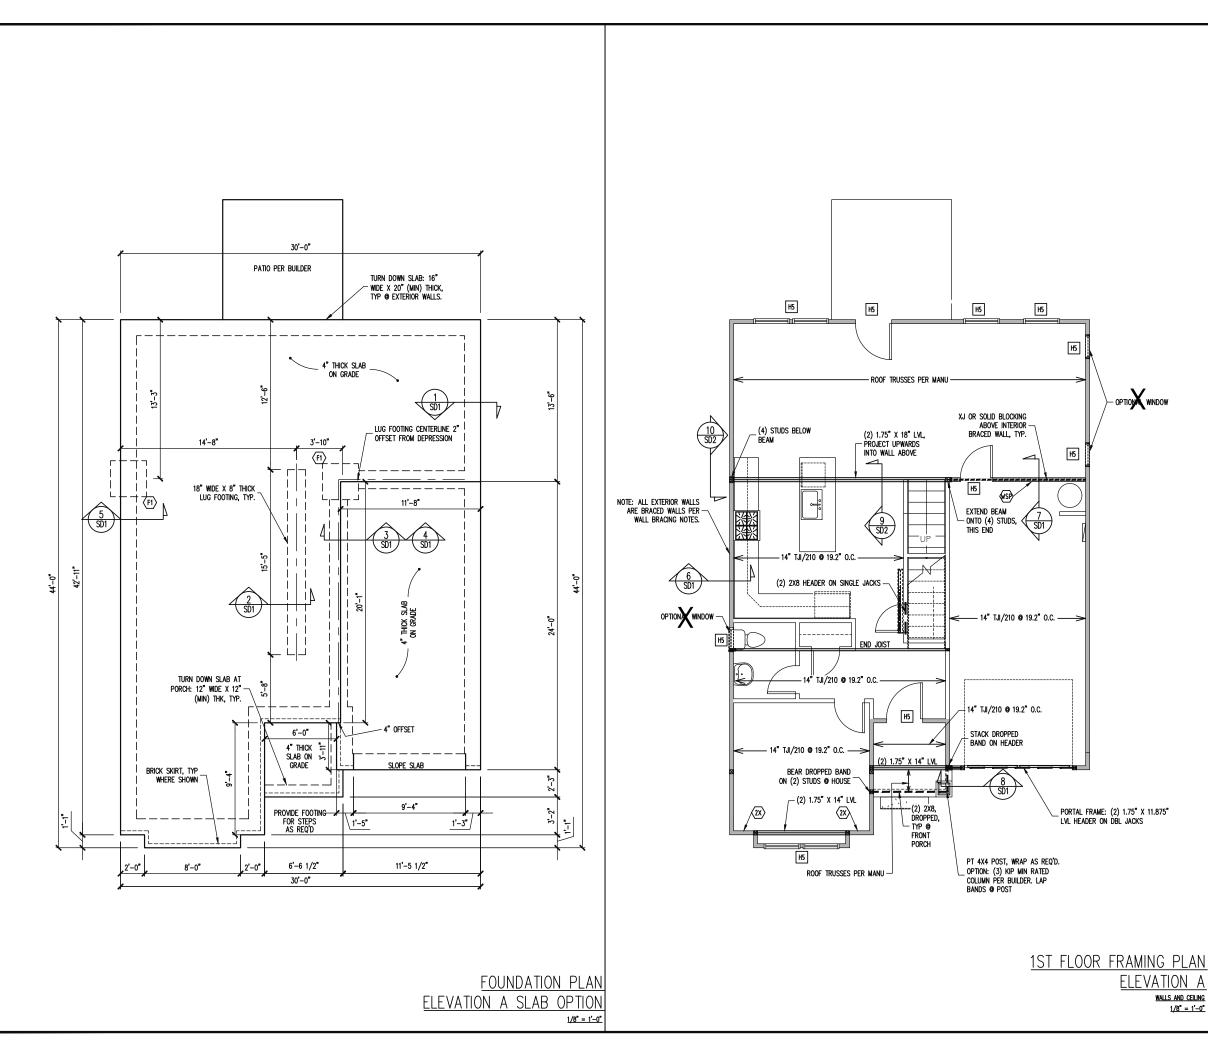



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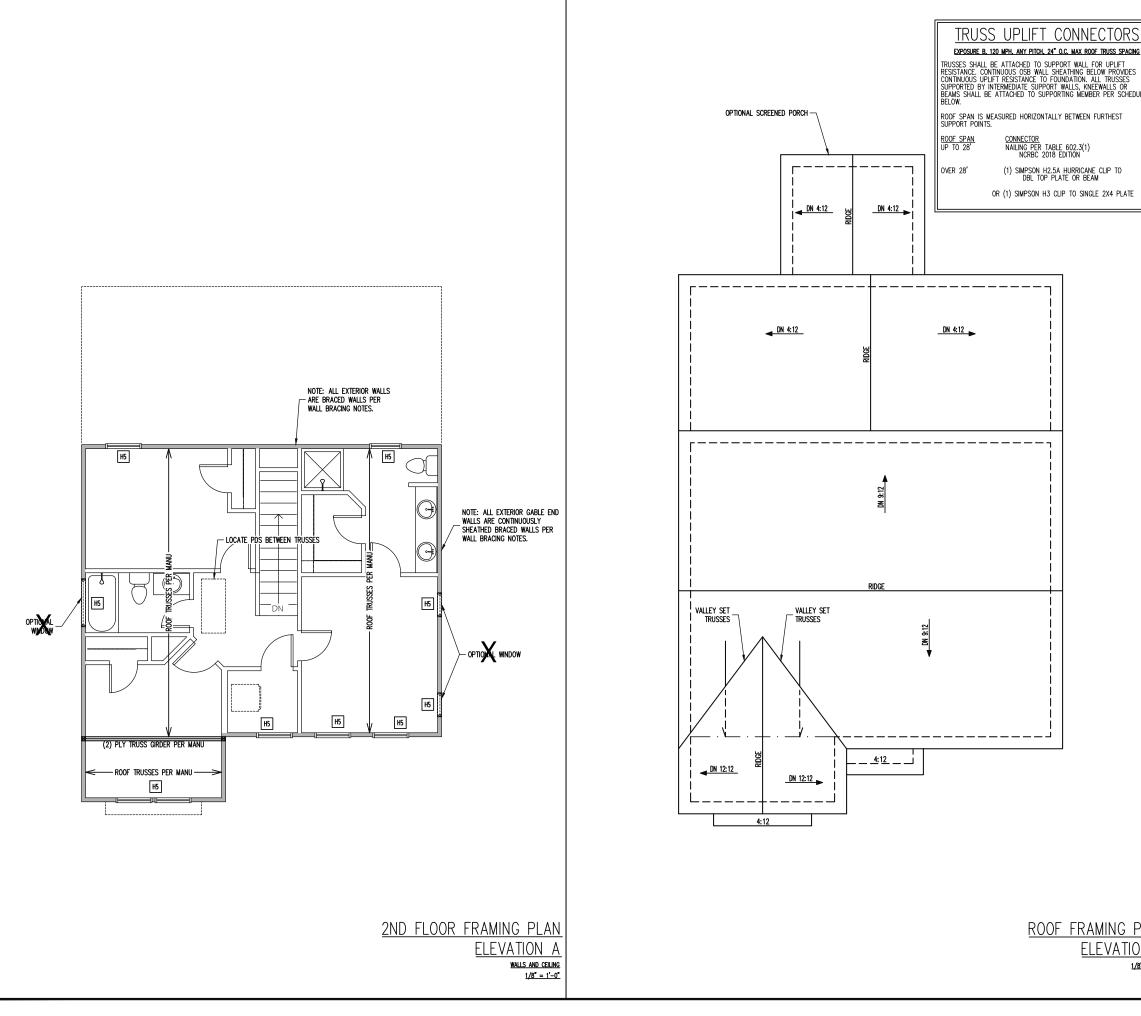
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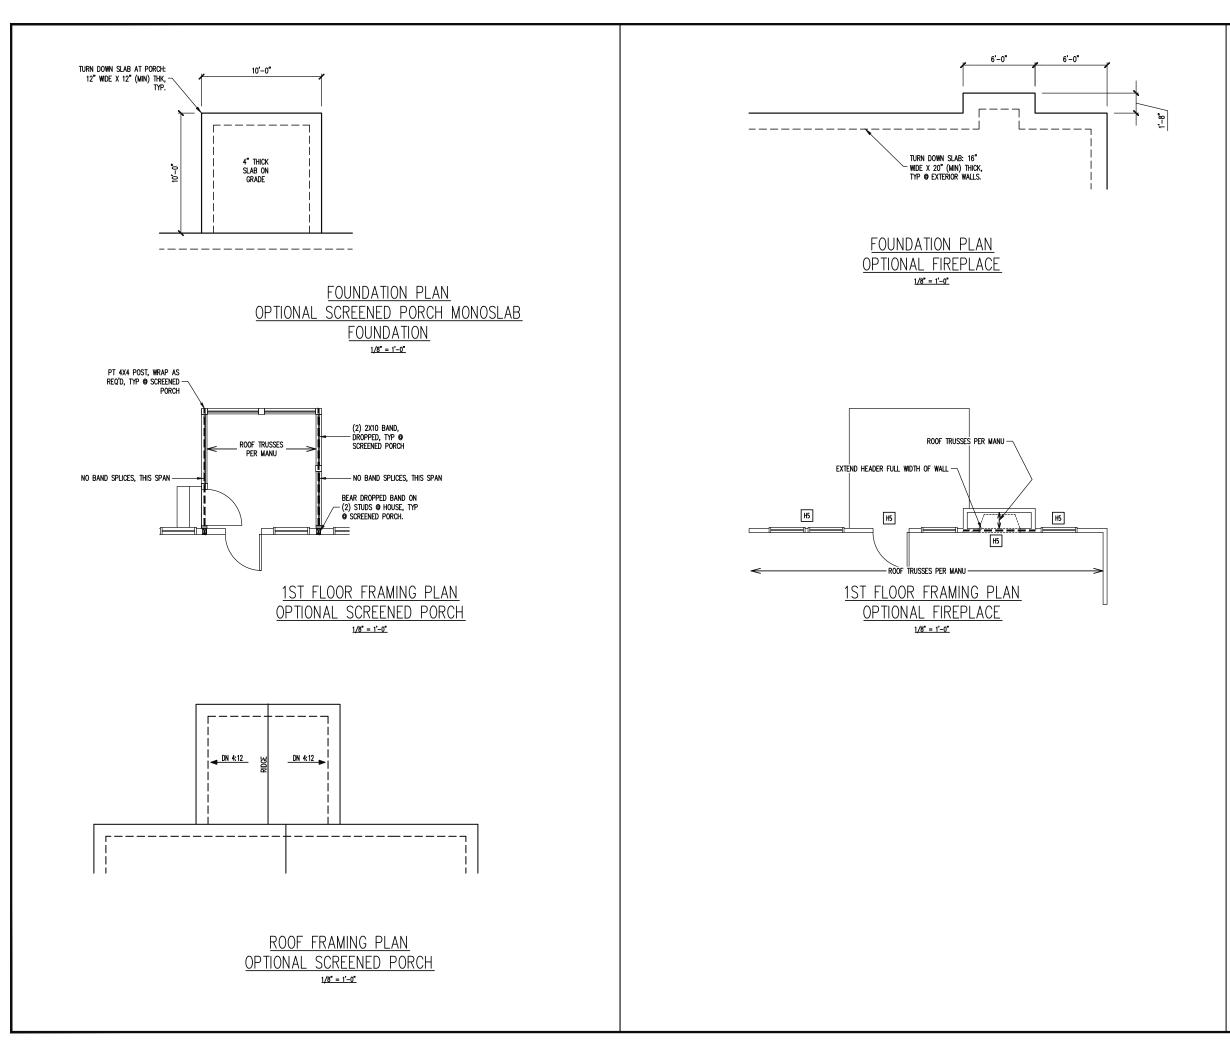
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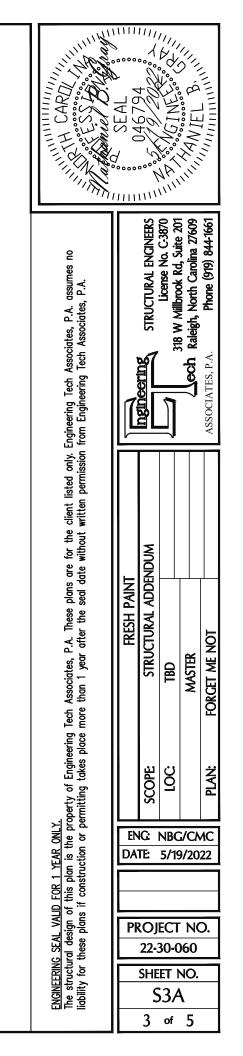







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	ROOF TRUSSES PER MANU. TYPICAL UN.O. -VERIFY ALL KNEEWALL HEIGHTS, ROOF PITCHES, AND ARCHITECTURAL OVERHANGS PRIOR TO CONSTRUCTION SPECIFICATIONS INSTANT REFERENCES REFER TO THE CONSTRUCTION SPECIFICATIONS SECTIONS FOR THE FOLLOWING INFORMATION: PART 1.01: CURRENT GOVERNING CODE PART 1.7: KING STUDS FOR EXTERIOR WALLS WALL BRACING SHADED WALLS: ALL EXTERIOR STUD WALLS, EXTERIOR SIDE, ARE TO BE CONTINUOUSLY SHEATHED WITH BI NAILS 06 °O.C. AT PANEL EDGES, 12° O.C. IN PANEL FIELD. NOTES: PROVIDED CONTINUOUS SHEATHING = 119' MIN. REFERENCE PART 16.02 OF CONSTRUCTION SPECIFICATIONS FOR GENERAL WIND BRACING INFORMATION. HEADER SCHEDULE H1 SINGLE 2X4 TURNED FLAT (A)	FOR 1 YEAR ONLY. this plan is the property of Engineering Tech Associates, P.A. These plans are for the client listed only. f construction or permitting takes place more than 1 year after the seal date without written permission red RESH PAINT red RESH PAINT red RECOPE STRUCTURAL ADDENDUM red LOC TBD PI AN- FORCHT ME NOT		
	 H2 (2) 2X4'S ON SINGLE JACKS (B) H3 (2) 2X10'S ON SINGLE JACKS (C) H4 (2) 1.75" X 9.25" LVL'S ON DBL JACKS H5 (2) 2X8'S ON SINGLE JACKS (A) TYPICAL FOR INTERIOR NON LOAD BEARING WALLS ONLY, ROUGH OPENING 38" MAX. (B) TYPICAL FOR INTERIOR NON LOAD BEARING (B) TYPICAL FOR INTERIOR NON LOAD BEARING (B) TYPICAL FOR INTERIOR NON LOAD BEARING 	ା କ୍ରାଚ୍ଚ 		
<u>PLAN</u> <u>ON A</u> /8" = 1'-0"	WALLS ONLY, ROUGH OPNG 38" TO 74" MAX. (C) TYPICAL FOR ALL CONDITIONS NOT LISTED IN (A) OR (B) UNO. NOTES: -HEADERS IN NON LOAD BEARING INTERIOR WALLS ARE NOT LABELED.	PROJECT NO. PROJECT NO. 22-30-060 22-30-060 SHEET NO. SHEET NO. SHEET NO. SALAR SHEET NO. SHEET NO. STACK SHEET NO. SHEET NO. SHEET NO. SHEET NO. SHEET NO.		



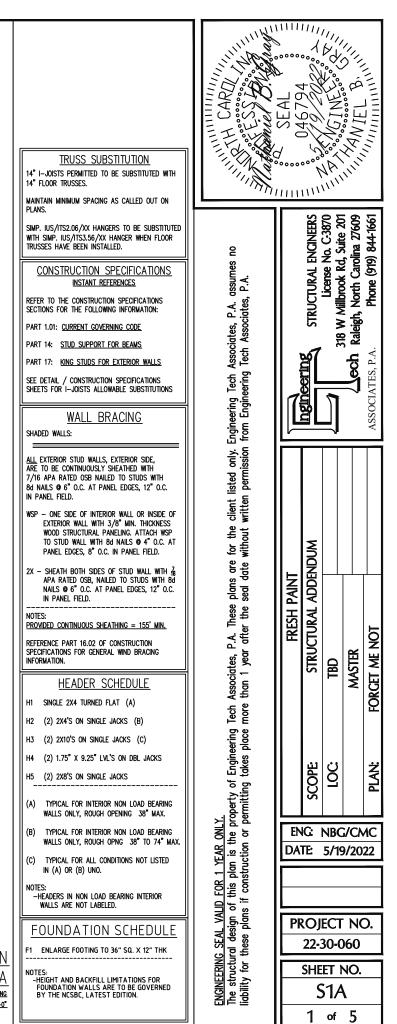

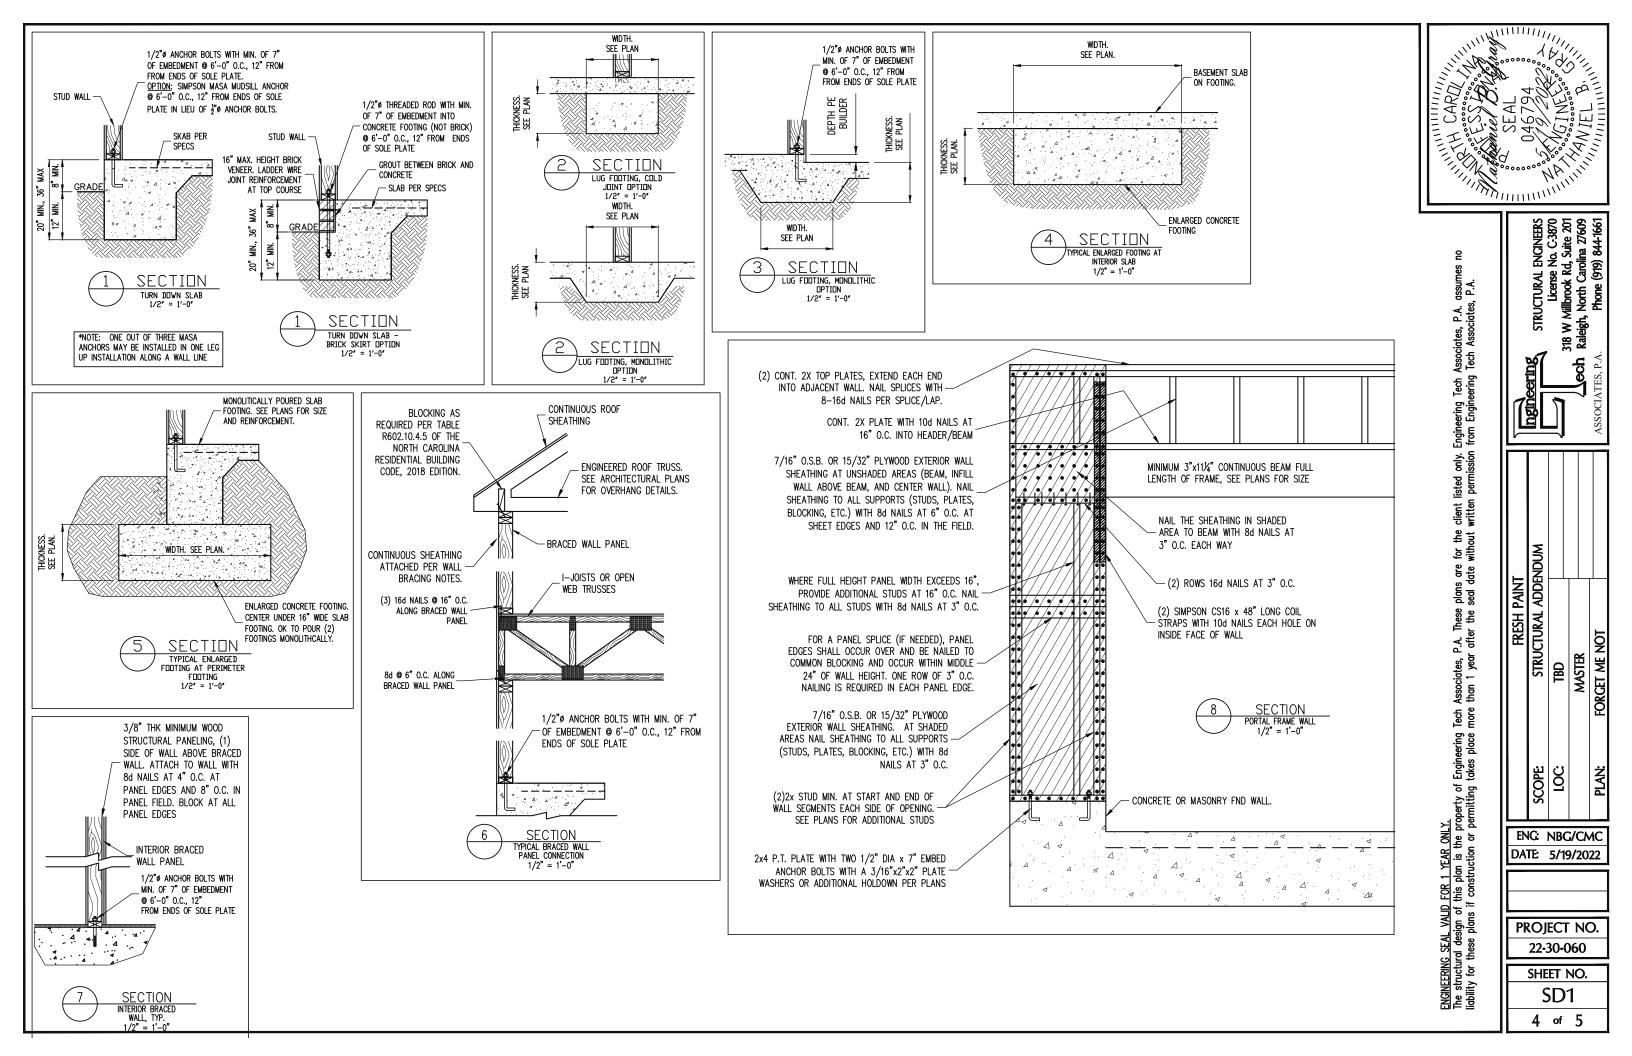

CONSTRUCTION SPECIFICATIONS	WALL ABOVE
CONSTRUCTION SPECIFICATIONS PART 1: GENERAL 7.04 MASONRY CONSTRUCTION SHALL CONFORM TO THE SPECIFICATIONS OF ACI 530 7.04 MASONRY CONSTRUCTION SHALL CONFORM TO ASTM A951. 6° MIN LAPS FOR CONTINUOUS WALL APPLICATIONS 7.04 MASONRY CONSTRUCTION SHALL CONFORM TO ASTM A951. 6° MIN LAPS FOR CONTINUOUS WALL APPLICATIONS 7.04 MASONRY CONSTRUCTION SHALL CONFORM TO ASTM A951. 6° MIN LAPS FOR CONTINUOUS WALL APPLICATIONS 7.04 MASONRY CONSTRUCTION SHALL CONFORM TO ASTM A951. 6° MIN LAPS FOR CONTINUOUS WALL APPLICATIONS 7.04 MASONRY CONSTRUCTION SHALL CONFORM TO ASTM A951. 6° MIN LAPS FOR CONTINUOUS WALL APPLICATIONS 7.04 MASONRY CONSTRUCTION SHALL CONFORM TO ASTM A951. 6° MIN LAPS FOR CONTINUOUS WALL APPLICATIONS 7.04 MASONRY CONSTRUCTION SHALL CONFORM TO ASTM A951. 6° MIN LAPS FOR CONTINUOUS WALL APPLICATIONS 7.04 MASONRY CONSTRUCTION SHALL CONFORM TO ASTM A951. 6° MIN LAPS FOR CONTINUOUS WALL APPLICATIONS 7.04 MASONRY CONSTRUCTION SHALL CONFORM TO ASTM F1554-15 6.01 SOLD SAMUL LINEER, OSTS THAT ARE CONSTRUCTION ARE THE RESPONSIBILITY OF MADORY OF THE STRUCTURE AT ARE CONSTRUCTION ARE THE RESPONSIBILITY OF THE CONTACTOR WITH THE CAUSES OF CONSTRUCTION ARE THE RESPONSION TO ASTM F1554-15 GRADE 36 UND. BENT ANCHOR BOLTS SHALL HAVE A 2' MIN HOK UND PART 19. DRIVEN FASTENES ANCHOR BOLTS SHALL HAVE A 2' MIN HOK UND ANCHOR BOLTS SHALL HAVE A 2' MIN HOK UND PART 19. DRIVEN FASTENES 5.01 SOLD SAMUL HAVE A 2' MIN HOK UND PART 19. DRIVEN FASTENES 5.01 SOLD SAMUL HAVE A 2' MIN HOK UND PART 1	SUBFLOOR LVL BEAM PER PLANS, PROJECT UPWARDS INTO WALL ABOVE 9' CEILING 9' CEILING 9 SECTION BEAM PROJECTING INTO WALL ABOVE 1/2" = 1'-0"
 ATISS (NO STROLE, LESS TWAS 'F LEARNON') ATISS (NO STROLE) AT	(2) ROWS OF 10d NAILS @ 2" O.C. SUPPORTING STUDS PER PLAN DBL TOP PL O REINFORCEMENT DF BEAM FOR BEARING AT TOP PL 1/2" = 1'-0"
NOTES ABBRE VIA TIONS THE BUILDER IS RESPONSIBLE FOR REVIEWING PLANS PRIOR TO CONSTRUCTION. THE BUILDER SHALL IMMEDIATELY CONTACT THE ENGINEER OF RECORDING DEGNOE PROCEEDING IF THE FOLLOWING CONTINUES ARE NOTED BEFORE OR DURING CONSTRUCTION: 1) THE WORKING PLANS DOT BEAR THE SEAL OF THE EOR 2) THE PLANS CONTAIN DISCREPANT OR INCOMPLETE INFORMATION ABV ABV BOTH BE BOTH HODS BTIMN BETWEEN 2) THE PLANS CONTAIN DISCREPANT OR INCOMPLETE INFORMATION TJ TRIPLE JOINT TO TOTIONS CONCONTINUES ARE NOTED DURING CONTINUES ARE NOTED DOT BEAR THANGER UNL LAMINATED VENEER RESPONSIBLE TO A FAILURE TO FOLLOW THE ABOVE PROCEEDING IF THE BE BOTH HODS DTHE WARKING PLANS DURING CONSTRUCTION: 2) THE PLANS CONTAIN DISCREPANT OR INCOMPLETE INFORMATION ABV ABOVE BE BOTH HODS DTHE PLANS CONTAIN DISCREPANT OR INCOMPLETE INFORMATION CONCORTENCE DOT DOUBLE DIA FAILURE TO FOLLOW THE ABOVE PROCEEDURES SHALL NOT BE THE DIA DIAMETER DIA DIAME	

