


Left Elevation


Scale: 1/8"= 1'0"

DATE: 6/29/2021 REVISED DRAWING#

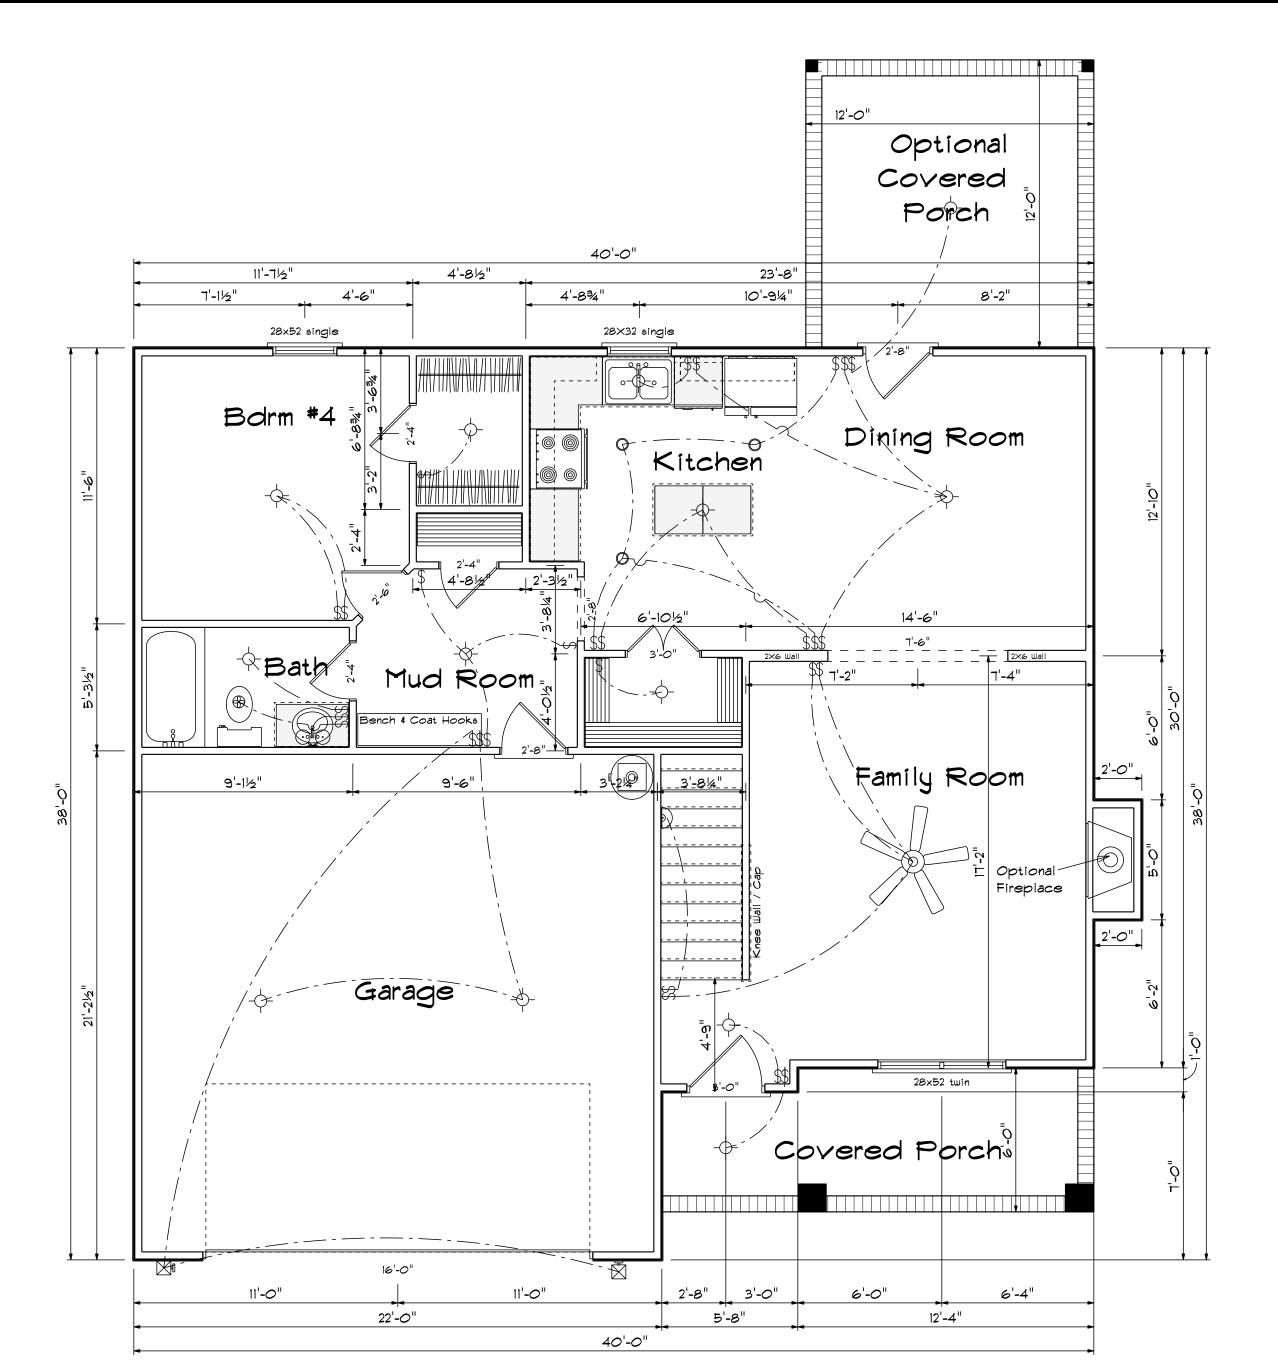


First Floor Plan

Kitchen Cabinets

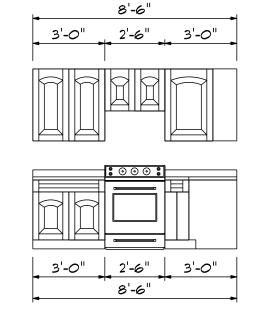

2'-0" 2'-0"

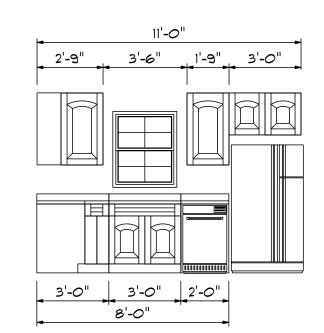


FIRST FLOOR OPENING SCHEDULE						
PRODUCT CODE	SIZE	HINGE	COUNT			
36X80 COLONIAL A 1	3'-0"	L	1			
32X80 FRENCH DOOR	2'-8"	L	1			
192X84 - 8 PANEL - 4 WINDOW	16'-0"	U	1			
2-4 Door Unit	2'-4"	L	1			
2-4 Door Unit	2'-4"	R	2			
2-6 Door Unit	2'-6"	R	1			
2-8 Door Unit	2'-8"	R	1			
4-0 Doublehung Door Unit	4'-0"	LR	1			
28X32 single	2'-8" x 3'-2"	N	1			
28x52 single	2'-8" x 5'-2"	N	1			
28x52 twin	5'-4" x 5'-2"	NN	1			

Areas

First Floor 927 Second Floor 1209

Total Heated 2136
Garage 461
Front Porch 101
Covered Porch 144

SCALE: 1/4" DRAWN BY APPROYED

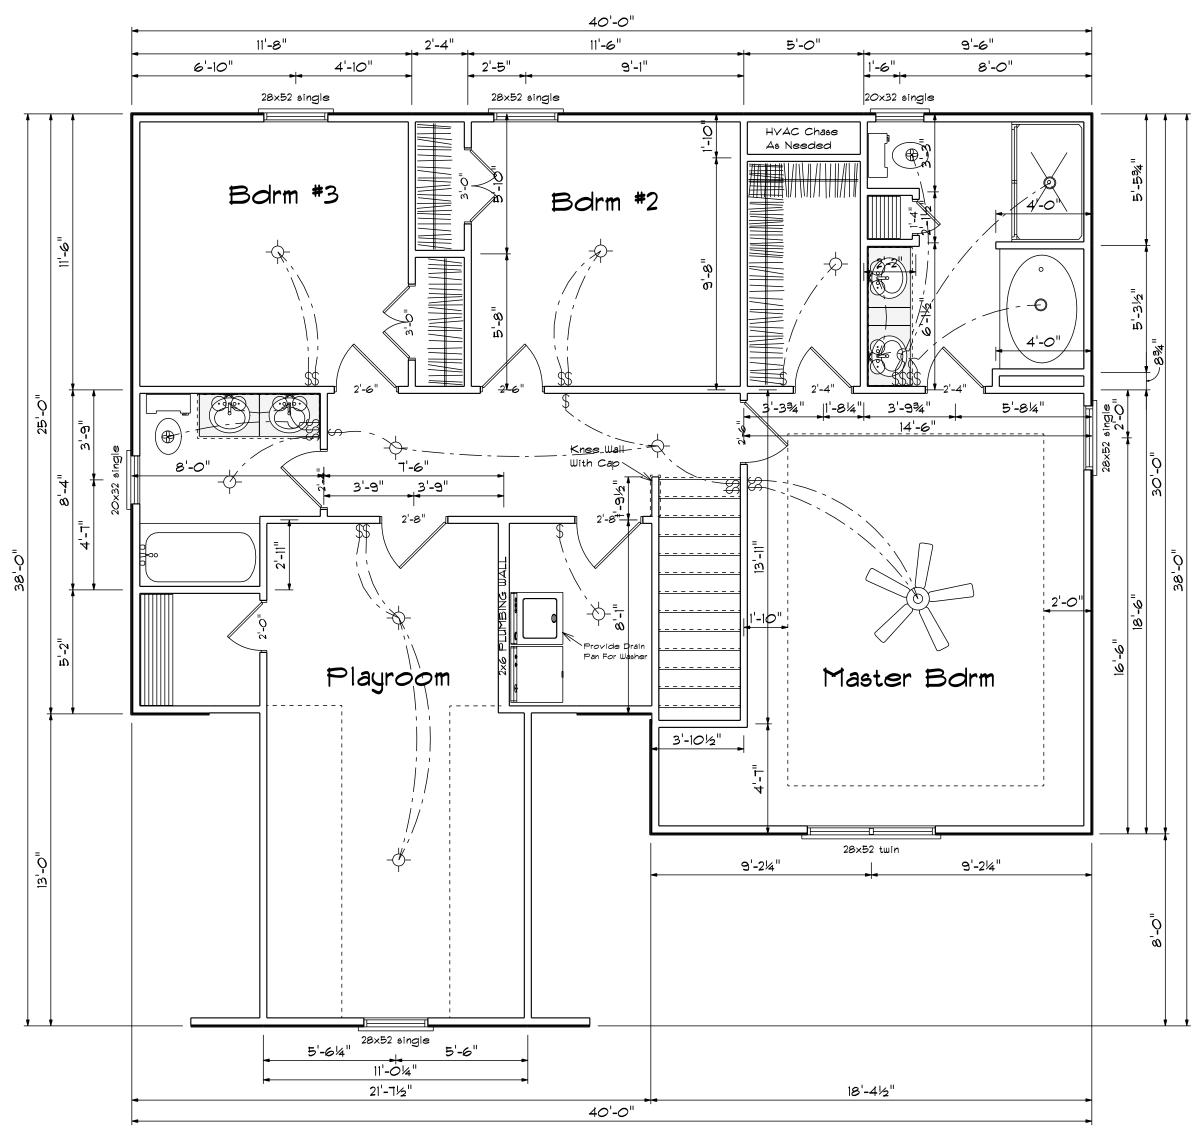



Second	Floor	Plan
		1 1011

SECOND FLOOR OPENING SCHEDULE						
PRODUCT CODE	SIZE	HINGE	COUNT			
1-6 Door Unit	1'-4"	L	1			
2-0 Door Unit	2'-0"	R	1			
2-4 Door Unit	2'-4"	L	1			
2-4 Door Unit	2'-4"	R	2			
2-6 Door Unit	2'-6"	L	2			
2-6 Door Unit	2'-6"	R	1			
2-8 Door Unit	2'-8"	L	2			
4-0 Doublehung Door Unit	4'-0"	LR	2			
20x32 single	2'-0" x 3'-2"	N	2			
28x52 single	2'-8" x 5'-2"	N	5			
28x52 twin	5'-4" x 5'-2"	NN	1			


DATE: 6/29/2021 REVISED DRAWING#

SCALE: 1/4"
DRAWN BY
APPROYED

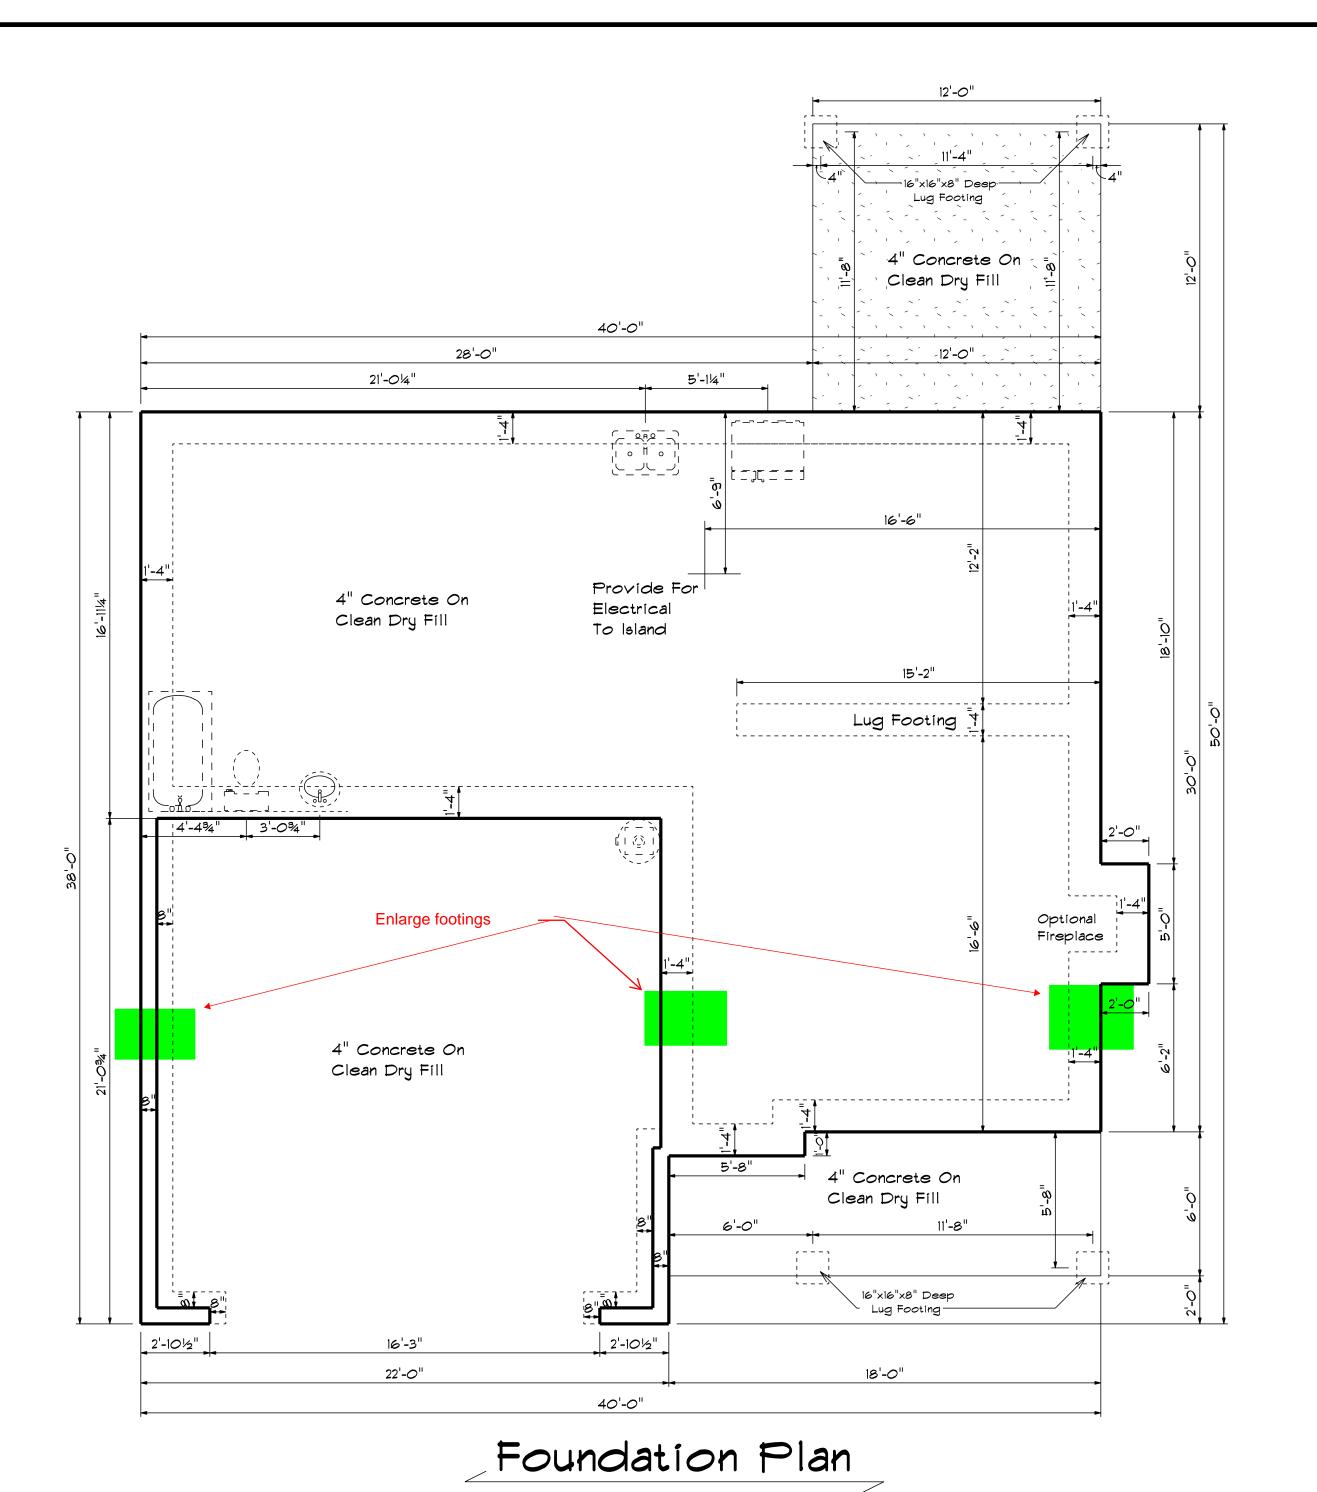


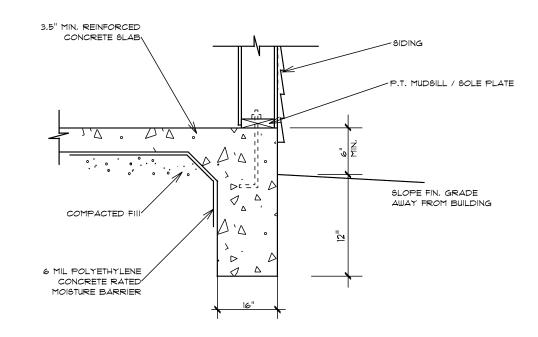

TURN-DOWN FOOTING DETAIL

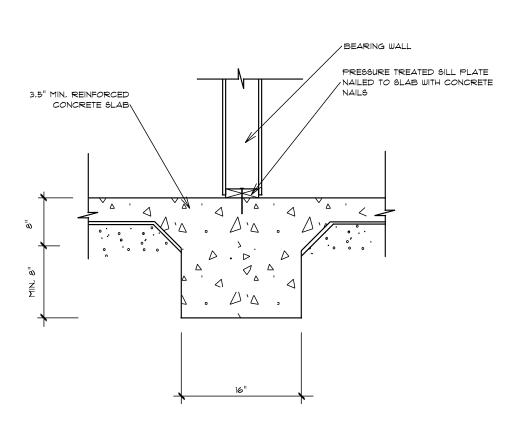


INTEGRAL SLAB FOOTING DETAIL AT BEARING WALL

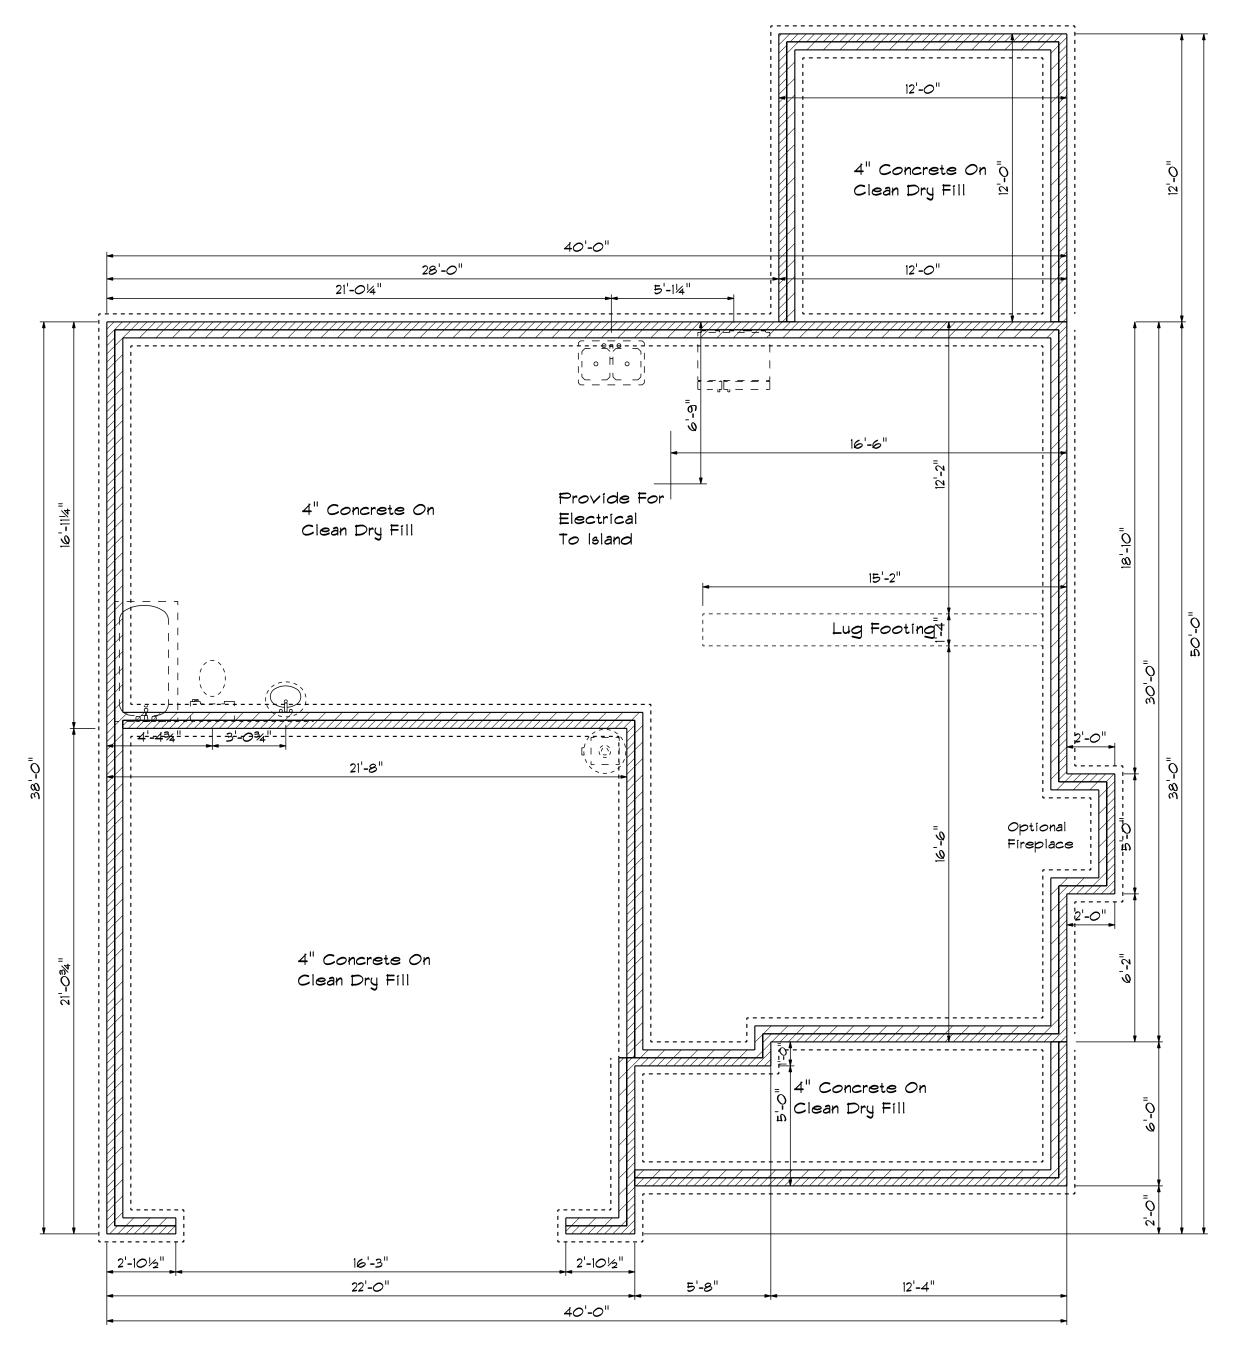



Foundation Plan

Foundation Detail Siding

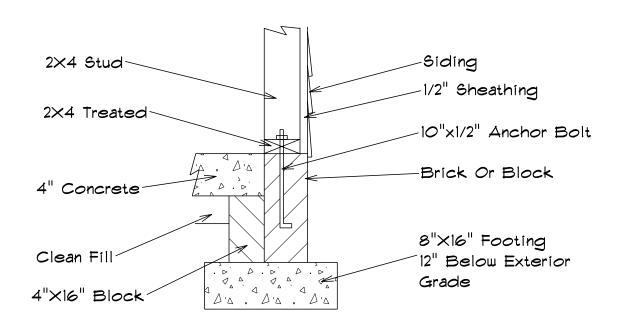

Lug Footing Detail

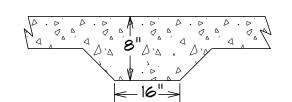

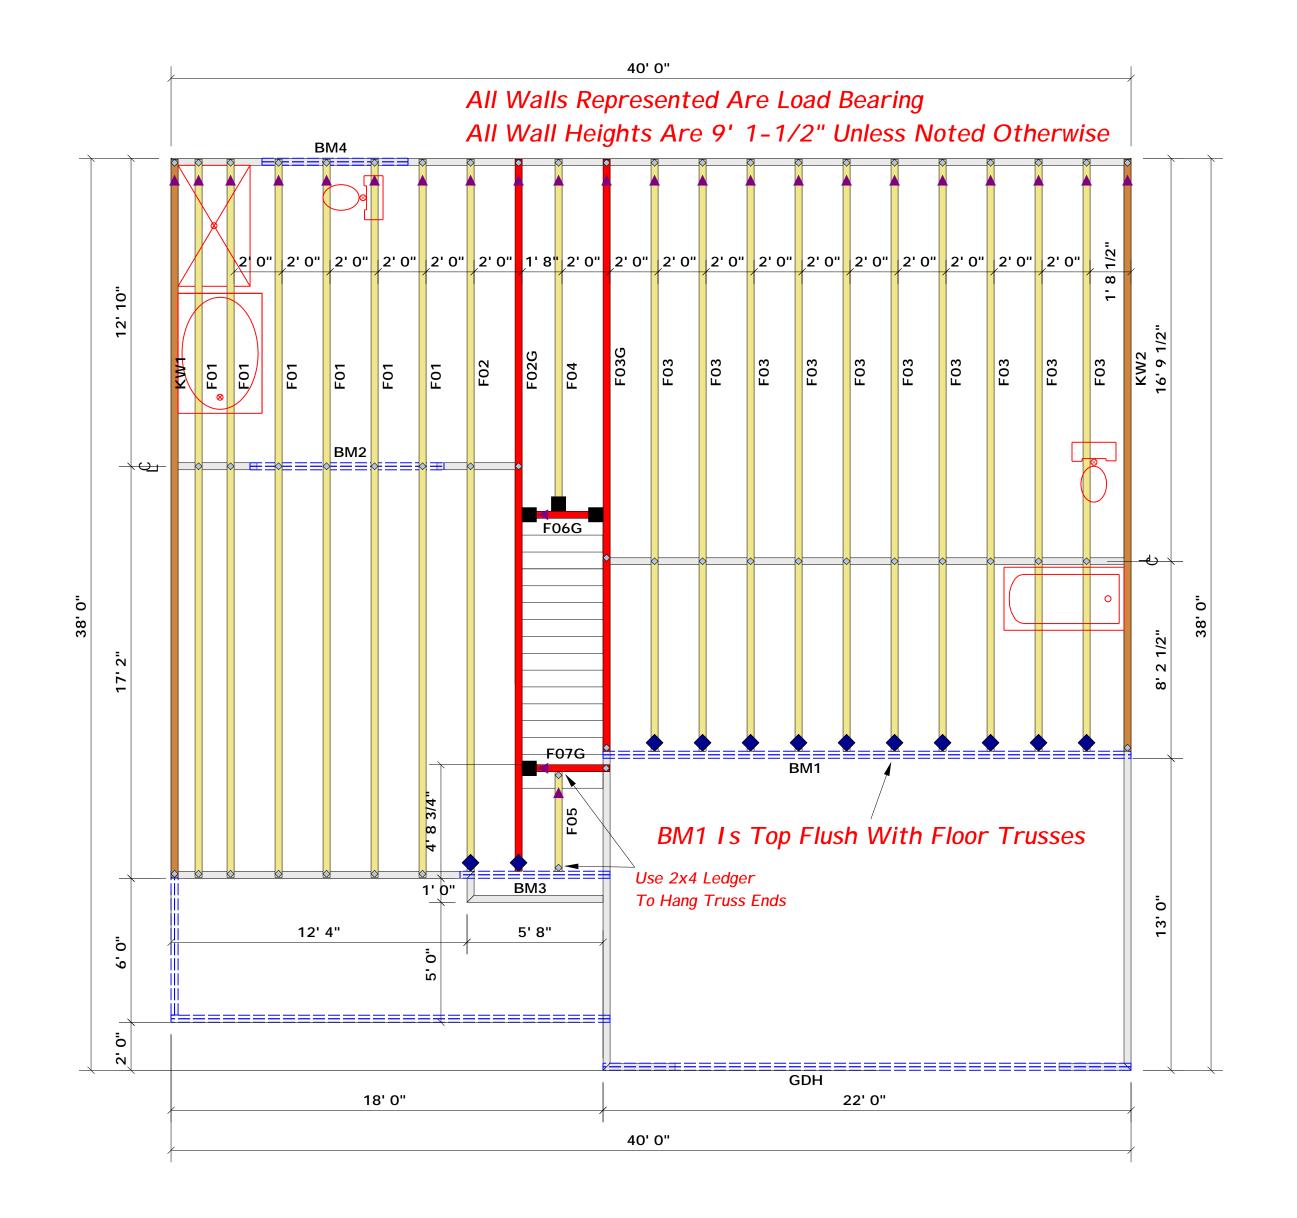

Truss Placement Plan SCALE: 1/4" = 1'

		HANGER
= Denotes Left End of Truss Reference Engineered Truss Drawing)		= USP MSH422
Do Not Erect Trusses Backwards		= USP JUS414

<u>HANGER</u> <u>LEGEND</u>
= USP MSH422 / Strap Hanger
= USP JUS414/ Single 4x Hanger
-

Products						
PlotID	Length	Product	Plies	Net Qty	Fab Type	
BM1	22' 0"	1-3/4"x 18" LVL Kerto-S	2	2	FF	
BM2	9' 0"	1-3/4"x 9-1/4" LVL Kerto-S	2	2	FF	
ВМ3	7' 0"	1-3/4"x 14" LVL Kerto-S	2	2	FF	
BM4	7' 0"	1-3/4"x 9-1/4" LVL Kerto-S	2	2	FF	
GDH	22' 0"	1-3/4"x 11-7/8" LVL Kerto-S	2	2	FF	

ROOF & FLOOR TRUSSES & BEAMS

Reilly Road Industrial Park Fayetteville, N.C. 28309 Phone: (910) 864-8787 Fax: (910) 864-4444

Bearing reactions less than or equal to 3000# are deemed to comply with the prescriptive Code requirements. The contractor shall refer to the attached Tables (derived from the prescriptive Cod requirements) to determine the minimum foundatic size and number of wood studs required to suppor reactions greater than 3000# but not greater than 15000#. A registered design professional shall be retained to design the support system for any reaction that exceeds those specified in the attached Tables. A registered design professional shall be retained to design the support system for all reactions that exceed 15000#.

Signature____

Curtis Quick

Curtis Quick


LOAD CHART FOR JACK STUDS
(84350 ON TABLÉS ROCEDIO & (b))


NU	WBER C	F JAC	HEADER/	GERDER)F
END REACHION (UP 10)	REQ'O STUDS FOR (2) PLY HEADER		END REACTION (UP TO)	REQ15 STUDS FOR (3) ALY HEADER	END REACTION (UP 10)	REQ'S STUBS FOR
1700	1		2550	1	3400	1
3400	2		5100	2	6800	2
5100	3		7650	3	1020	3
6800	4		10200	4	1360	0 4
8500	5		12750	5	1700	0 5
10200	6		15300	6		
11900	7					
13600	8					
15300	9					

CITY / CO. Harnett Co. / Harnett	SS 44 Melvill Ln.	Floor	EV. 08/04/22	DRAWN BY Curtis Quick	SALES REP. Marshall Naylor
CI TY / C	ADDRESS	MODEL	DATE REV.	DRAWN	SALES R

BUI LDERBenjamin StoutJOB NAMELot 47 Liberty MeadowPLANThe ReedsvilleSEAL DATEN/AQUOTE #Quote #JOB #J0822-3968

THIS IS A TRUSS PLACEMENT DIAGRAM ONLY. These trusses are designed as individual building components to be incorporated into the building design at the specification of the building designer. See individual design sheets for each truss design identified on the placement drawing. The building designer is responsible for temporary and permanent bracing of the roof and floor system and for the overall structure. The design of the truss support structure including headers, beams, walls, and columns is the responsibility of the building designer. For general guidance regarding bracing, consult BCSI-B1 and BCSI-B3 provided with the truss delivery package or online @ sbcindustry.com

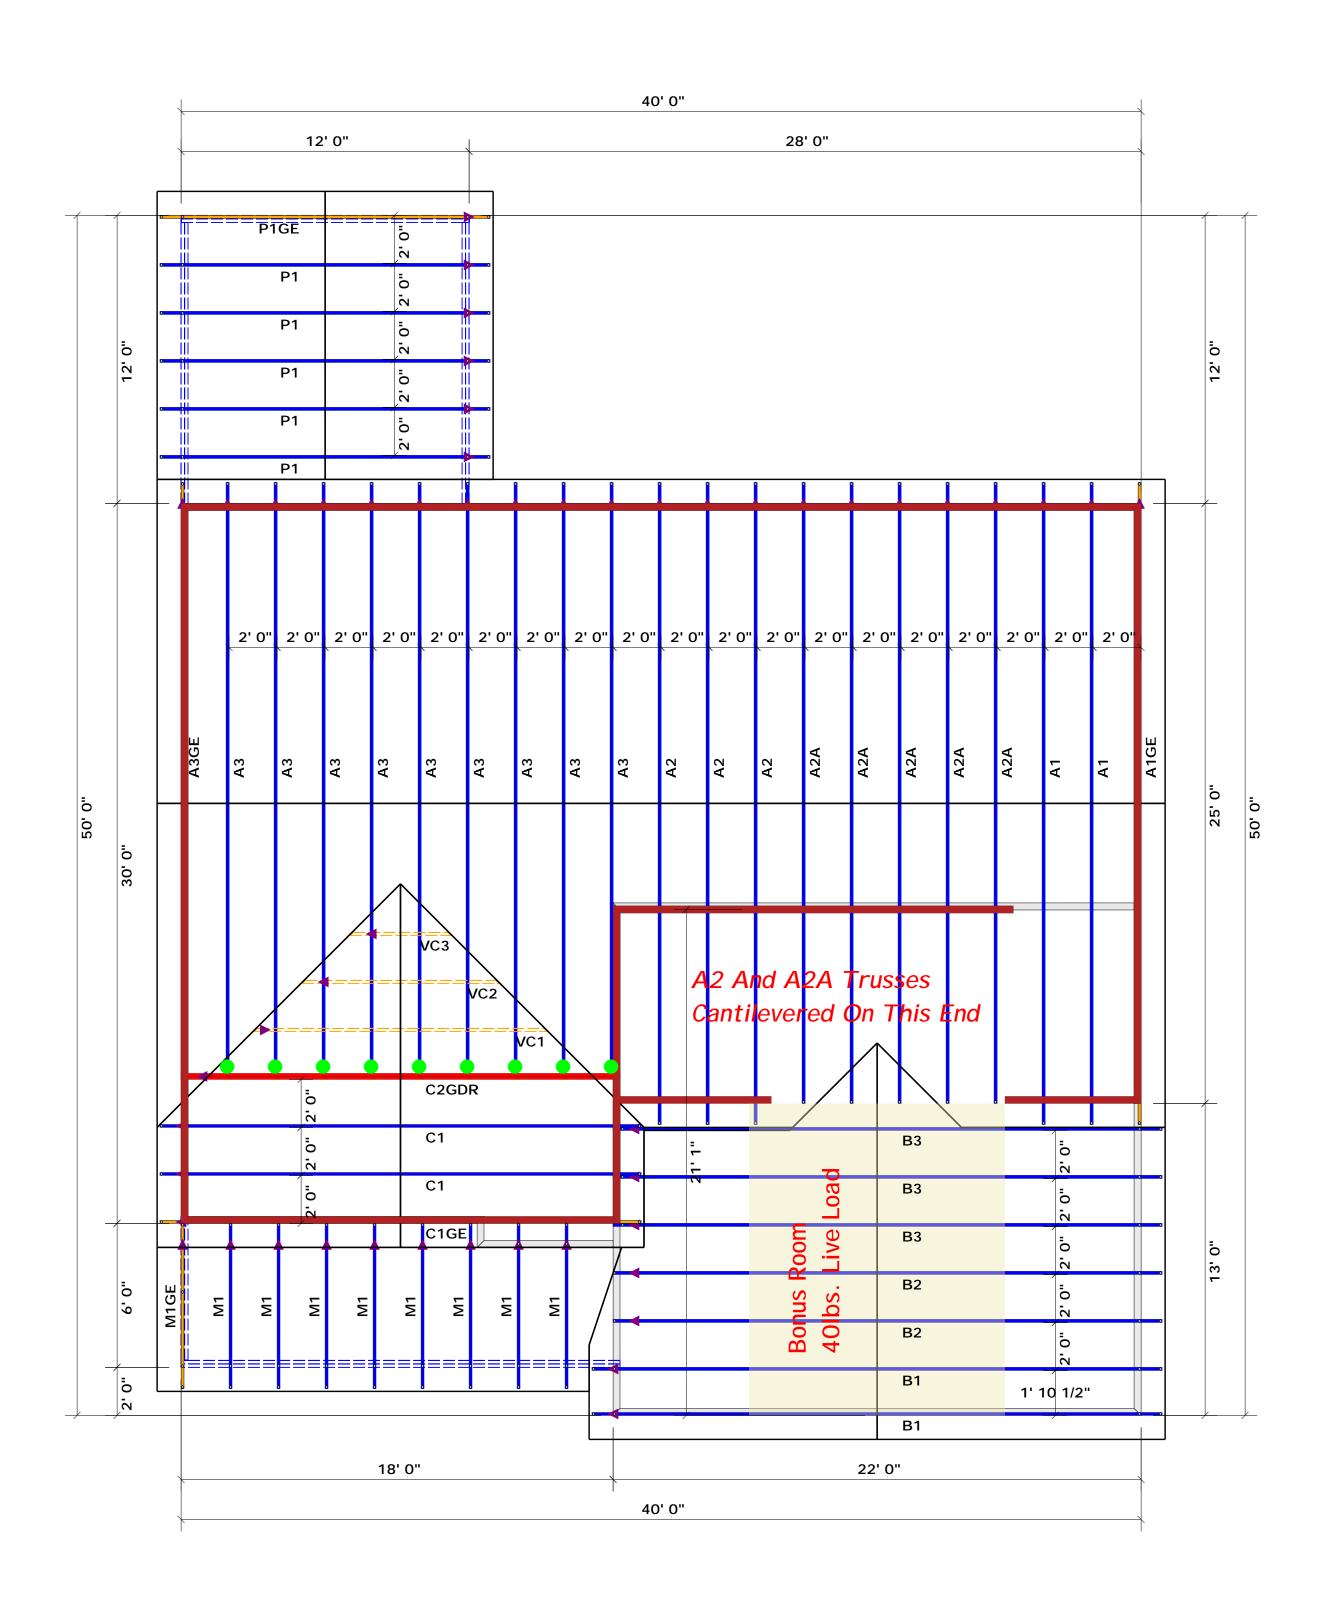

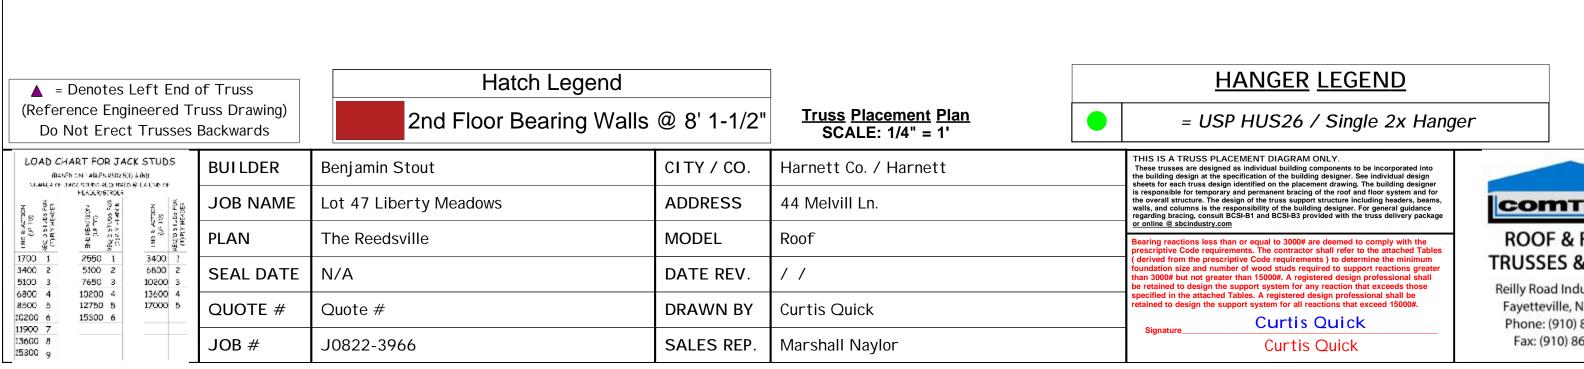

Curtis Quick

Marshall Naylor

DRAWN BY

SALES REP.

7650 3

10200 4 12750 5 15300 6

10200 3

13600 4

17000 5

QUOTE #

JOB #

Quote #

J0822-3966



Phone: (910) 864-8787 Fax: (910) 864-4444

Curtis Quick

Curtis Quick