

*NOTE: ALL EXTERIOR WALLS AND ATTIC WALLS ARE TO BE 2 x 6 @ 16" 0.C. (UNO). 2 x 4 @ 16" O.C. EXTERIOR WALLS MAY BE CONSTRUCTED IN LIEU OF 2 x 6 WALLS (UNO). ALL INTERIOR LOAD BEARING WALLS ARE TO BE 2 X | 4 @ 16" O.C. (UNO) AND NON-LOAD BEARING INTERIOR WALLS ARE TO BE || 2 x 4 @ 24" O.C. (UNO).

* SHADED WALLS ARE TO BE 2 x 6 @ 16" O.C. (LOAD BEARING) OR 2 x 6 @ 24" O.C. (NON-LOAD BEARING) REGARDLESS OF EXTERIOR WALL CONDITION

STAIR PROFILE (FROM DINING ROOM. STANDRD STAIRS SHOWN) OPTIONAL BATHROOM TRANSOM WINDOW OVER TUB DETAIL

6 x & TR7D. POST MIN. W/--

PVC SLEEVE FOR OPT. PORCH

OPTIONAL 12-01

DEEP PATIO

OPTIONAL 12-0 DEEP COVERED PORCH

OPTIONAL 10-0 DEEP

COVERED PORCH

(PÁTIO STÁNDÁRD)

SQUARE FOOTAGE Ist FLOOR: 1280 SQ. FT. 1585 SQ. FT. 2nd FLOOR: TOTAL: 2865 SQ. FT. FRONT PORCH: 89 SQ. FT. 110 GQ. FT. 428 SQ. FT. GARAGE:

SQUARE FOOTAGE (OPTIONS)

-CAR GARAGE:	240 SQ FT
REAR PORCH (10-0 DEEP):	110 SQ. FT.
REAR PORCH (12-0 DEEP):	132 S Q. FT.
OPT. PATIO/ DECK: (10-0 DEEP):	120 SQ. FT.
OPT. PATIO/ DECK: (12-Ø DEEP):	144 SQ. FT.

-16'-Ø 1/2"----

FIREPLACE

DROPPED BEAM OR FRAME
DOWN TO 1'-6" AFF.

(BISWING DOORS OPTIONAL)

~ 8" SQUARE COLUMN

AS SPEC. (TYP.)

THESE DRAWINGS ARE FOR THE PURPOSE OF CONVEYING AN ARCHITECTURAL CONCEPT ONLY RENAISSANCE RESIDENTIAL DESIGN, INC. COMMON LAW COPYRIGHT AND OTHER PROPERTY RIGHTS IN THESE PLANS. THESE PLANS AND DRAWINGS ARE NOT

RENAISSANCE

RESIDENTIAL DESIGN, INC

WILMINGTON, NC 28401 (919) 649-4128 WWW.RRDCAROLINA.COM The art of transforming your vision into reality

RENAISSANCE RESIDENTIAL DESIGN, INC. RESERVES THE RIGHT TO MAKE MODIFICATIONS TO FLOOR PLANS, DIMENSIONS, MATERIALS, AND

SPECIFICATIONS WITHOUT NOTICE

TO BE REPRODUCED, CHANGED, OR COPIED IN ANY FORM OR MANNER WITHOUT FIRST OBTAINING THE EXPRESS WRITTEN CONSENT OF RENAISSANCE RESIDENTIAL DESIGN, INC. NOR ARE THEY TO BE ASSIGNED TO ANY THIRD PARTY WITHOUT FIRST OBTAINING SAID WRITTEN PERMISSION AND CONSENT.

J.S.THOMPSON ENGINEERING, INC 606 WADE AVE., SUITE 104 RALEIGH, NC 27605 PHONE: (919) 789-9919 FAX: (919) 789-9921

N.C. CERTIFICATE NO.: C-1733



RESIDENTIAL ENS DRIVE LEF

DATE: MAY 3, 2022

SCALE: 1/4"=1'-0"

- OPTIONAL VENEER SKIRT (SEE ELEVATION PAGES

FOR LOCATIONS AND CONDITIONS)


PORCH COLUMN OPTION


(ELEVATION-B ONLY)


12" TAPERED COL. ON 16" × 16" × 36" BRICK OR STONE BASE AS SPEC. (TYPE


DRAWN BY: WG ENGINEERED BY: JAG **REVIEWED BY: MGS**

FIRST FLOOR PLAN

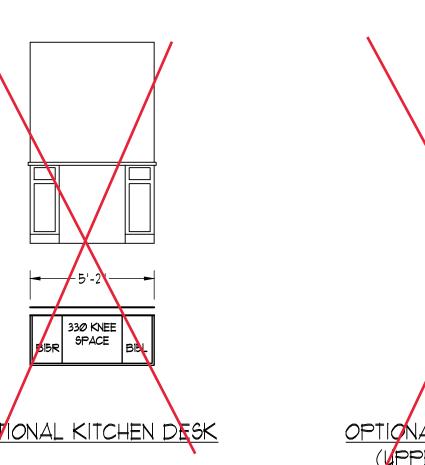

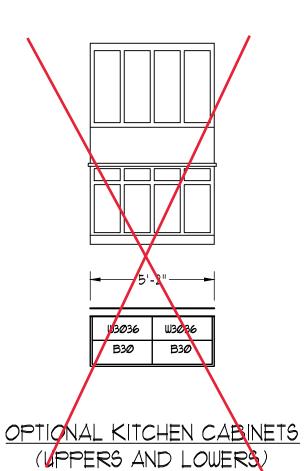


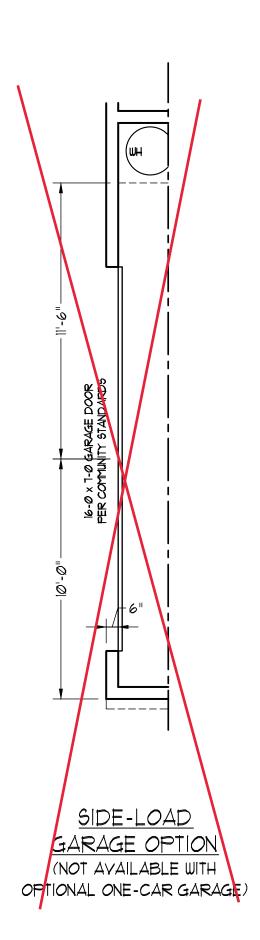


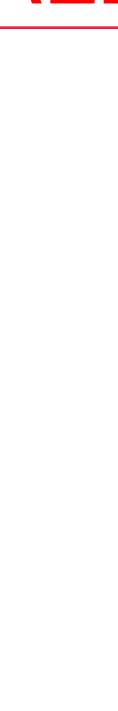



(NOT AVAILABLE WITH

OPTIONAL ONE-CAR GARAGE)

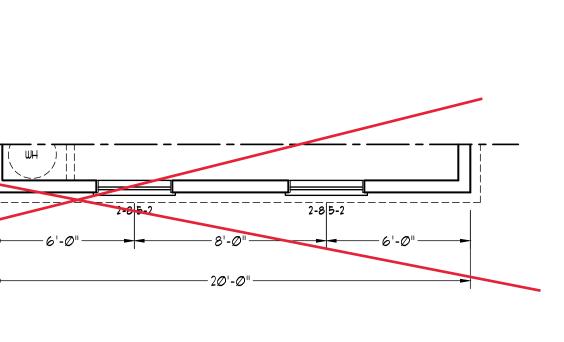

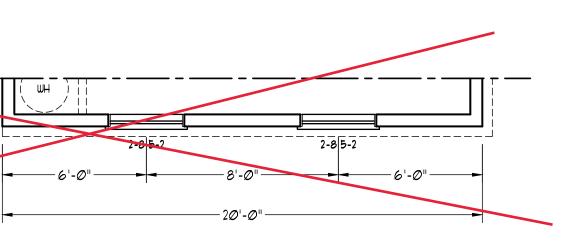

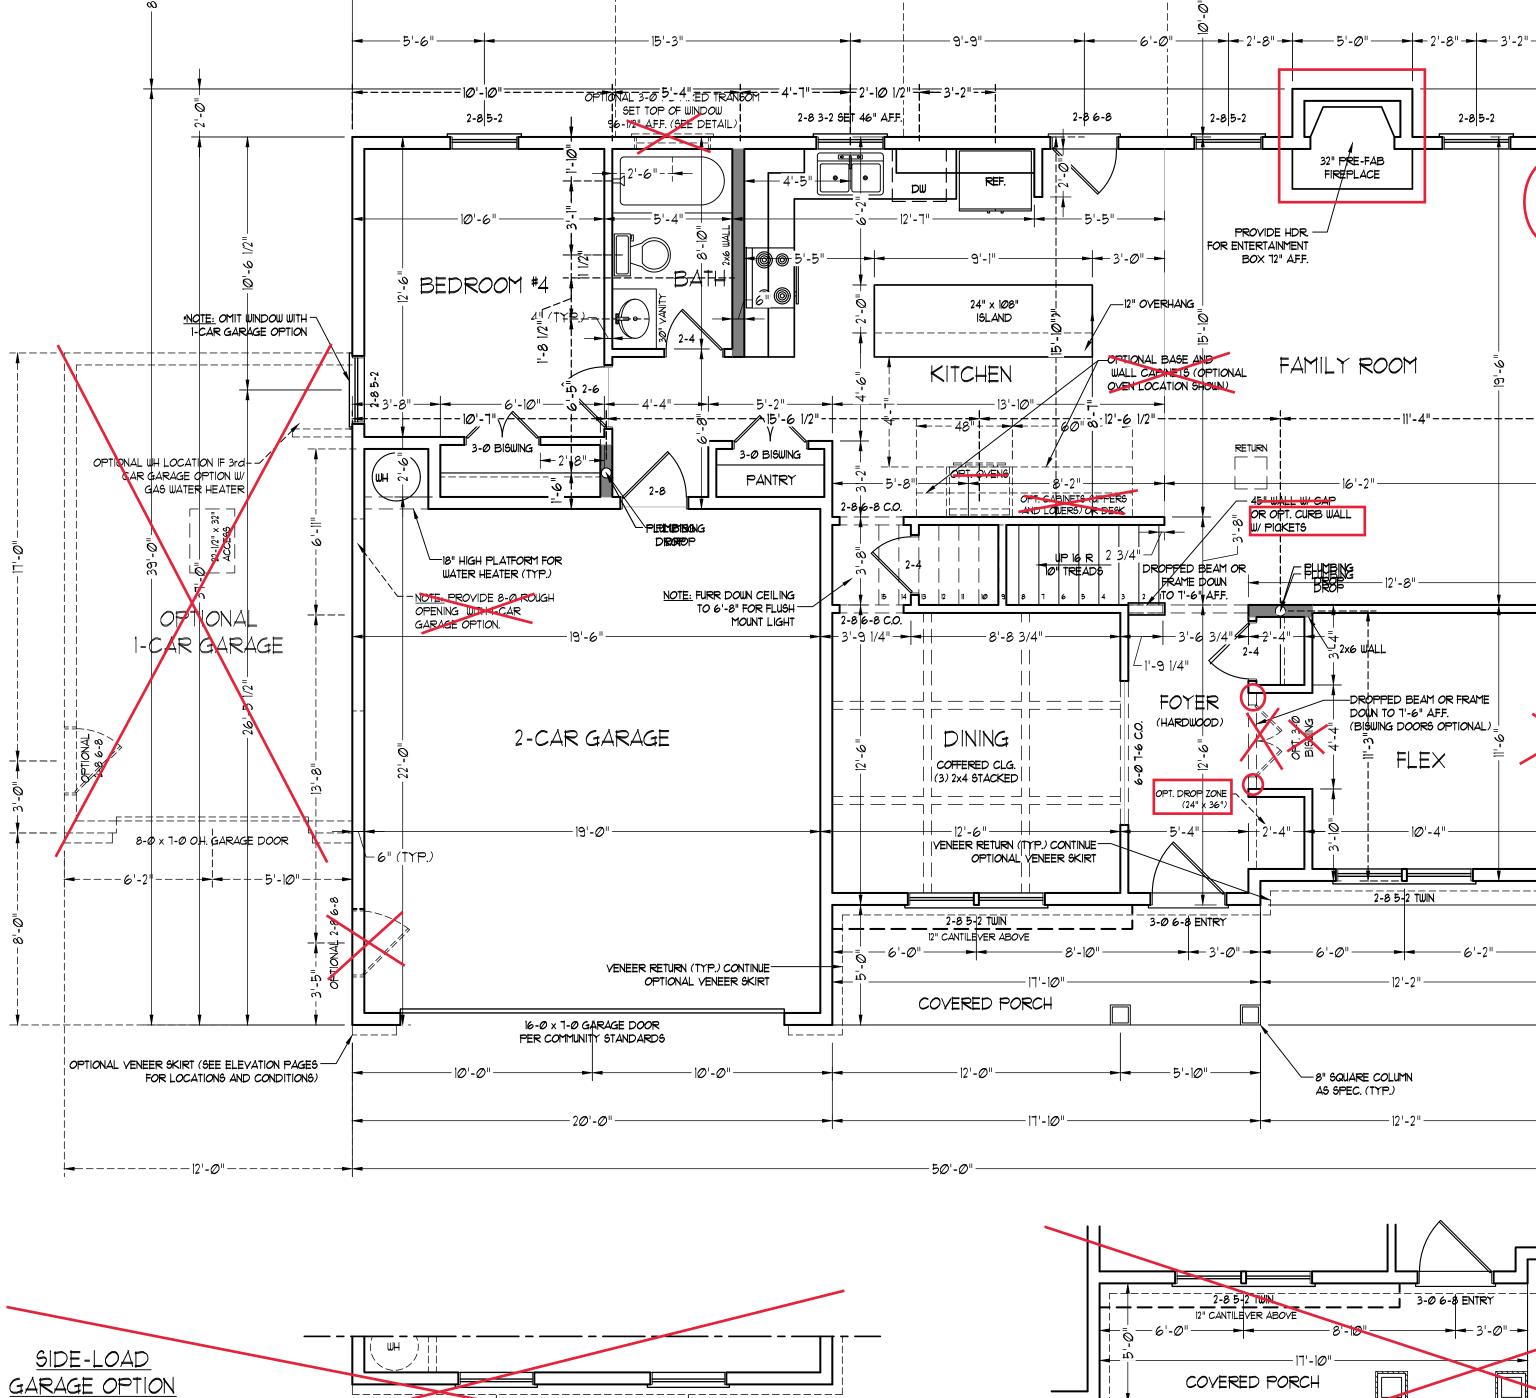


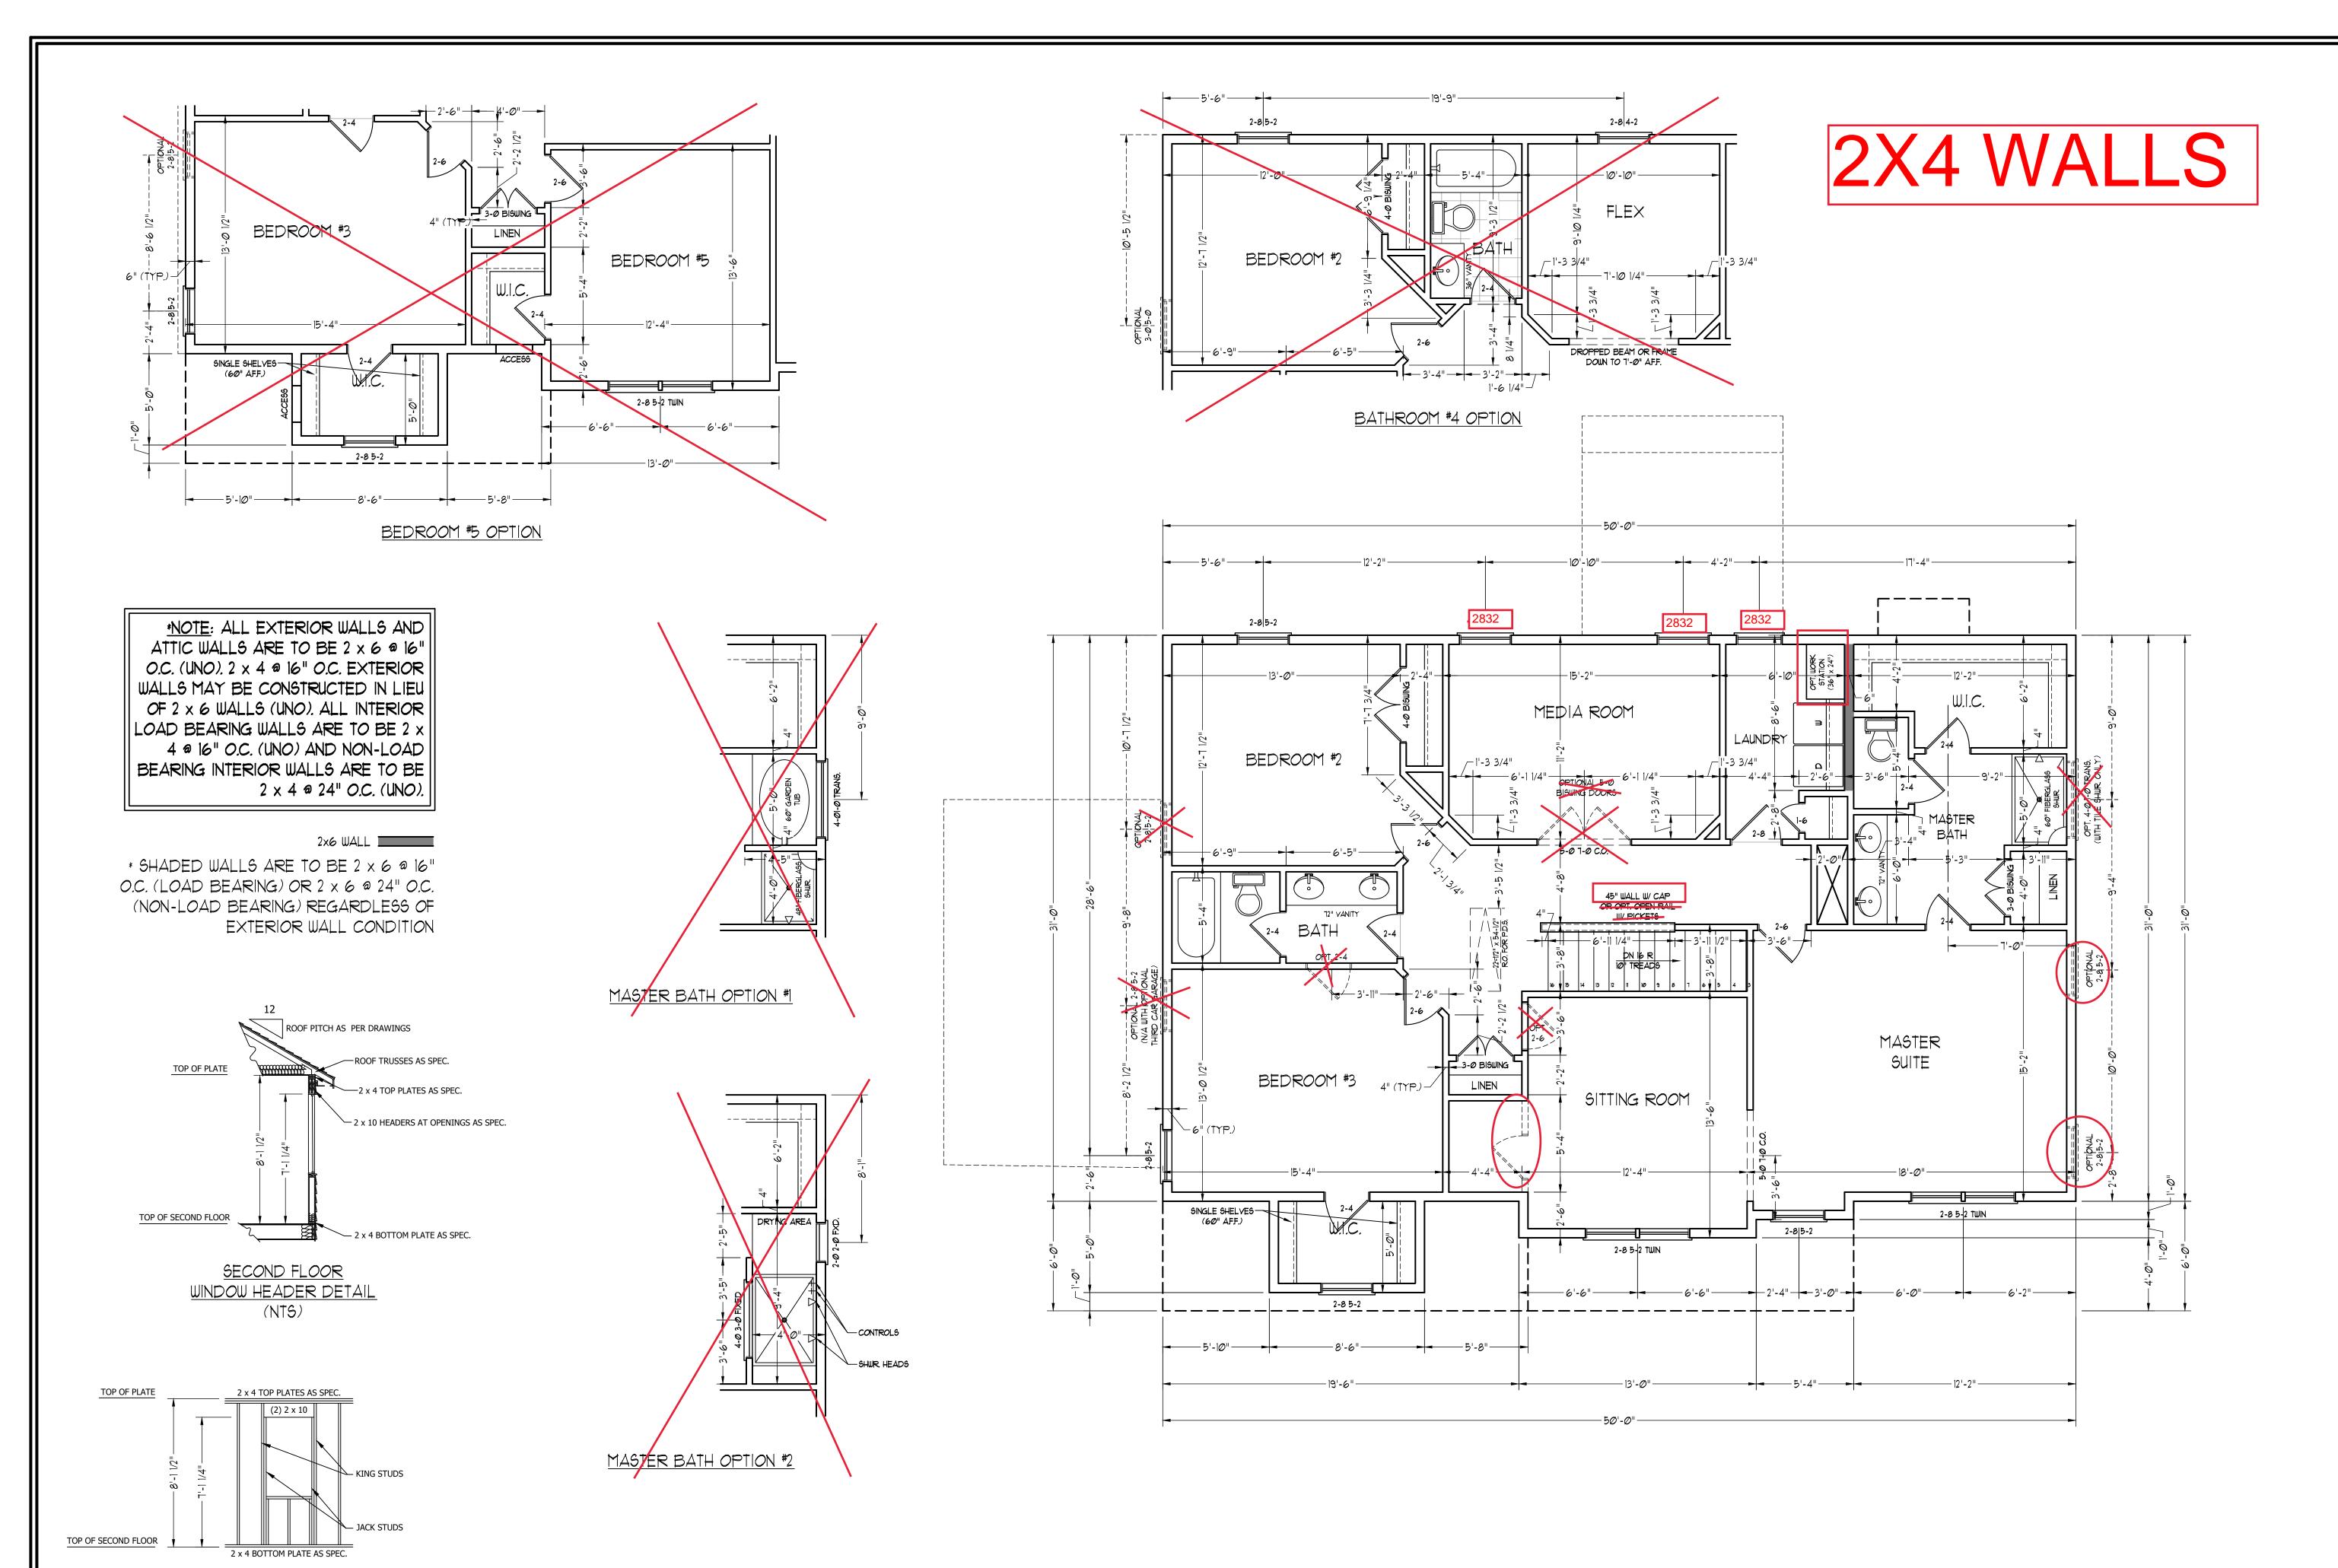

SECOND FLOOR

WINDOW HEADER DETAIL

(NTS)

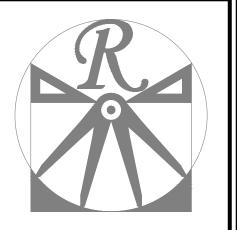

RENAISSANCE

RESIDENTIAL DESIGN, INC.
WILMINGTON, NC 28401
(919) 649-4128
WWW.RRDCAROLINA.COM

"The art of transforming your vision into reality

RENAISSANCE RESIDENTIAL DESIGN, INC.

RESERVES THE RIGHT TO MAKE

MODIFICATIONS TO FLOOR PLANS,

DIMENSIONS, MATERIALS, AND

SPECIFICATIONS WITHOUT NOTICE.

THESE DRAWINGS ARE FOR THE

PURPOSE OF CONVEYING AN

ARCHITECTURAL CONCEPT ONLY.

RENAISSANCE RESIDENTIAL DESIGN, INC. HEREBY EXPRESSLY RESERVES ITS COMMON LAW COPYRIGHT AND OTHER PROPERTY RIGHTS IN THESE PLANS. THESE PLANS AND DRAWINGS ARE NOT TO BE REPRODUCED, CHANGED, OR COPIED IN ANY FORM OR MANNER WITHOUT FIRST OBTAINING THE EXPRESS WRITTEN CONSENT OF RENAISSANCE RESIDENTIAL DESIGN, INC. NOR ARE THEY TO BE ASSIGNED TO ANY THIRD PARTY WITHOUT FIRST OBTAINING SAID WRITTEN PERMISSION AND CONSENT.

J.S.THOMPSON ENGINEERING, INC 606 WADE AVE., SUITE 104 RALEIGH, NC 27605 PHONE: (919) 789-9919 FAX: (919) 789-9921

N.C. CERTIFICATE NO.: C-1733



S. PHOMO ITONS, INCENTIVES, PEATURES, OPTIONS, DR PLANS, ELEVATIONS, DESIGNS, MATERIALS AND ISIONS ARE SUBJECT TO CHANGE WITHOUT NOTICE. FOOTAGE AND DIMENSIONS ARE ESTIMATED AND MAY ACTUAL CONSTRUCTION. ACTUAL POSITION OF HOUSE TWILL BE DETERMINED BY THE SITE PLAN AND PLOT OOR PLANS AND ELEVATION RENDERINGS ARE ARTIST ICEPTIONS. FLOOR PLANS ARE THE COPYRIGHTED RITY OF A&G RESIDENTIAL. ANY USE, REPRODUCTION, PATATION, OR DISPLAY OF THE PLANS IS STRICTLY HIBITED. SEE NEW HOME SALES CONSULTANT FOR

A&G RESIDENTIAL PICKENS DRIVE LEFT

DATE: MAY 3, 2022

KEV.:

SCALE: 1/4"=1'-0"

DRAWN BY: WG


ENGINEERED BY: JAG

REVIEWED BY: MGS

SECOND FLOOR PLAN

A-5

2X4 WALLS

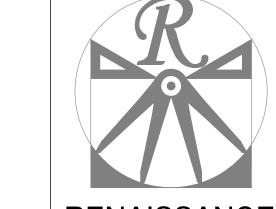

RENAISSANCE

RESIDENTIAL DESIGN, INC.
WILMINGTON, NC 28401
(919) 649-4128
WWW.RRDCAROLINA.COM

"The art of transforming your vision into reality."

RENAISSANCE RESIDENTIAL DESIGN, INC.
RESERVES THE RIGHT TO MAKE
MODIFICATIONS TO FLOOR PLANS,
DIMENSIONS, MATERIALS, AND
SPECIFICATIONS WITHOUT NOTICE.
THESE DRAWINGS ARE FOR THE
PURPOSE OF CONVEYING AN

ARCHITECTURAL CONCEPT ONLY.

RENAISSANCE RESIDENTIAL DESIGN, INC.
HEREBY EXPRESSLY RESERVES ITS
COMMON LAW COPYRIGHT AND OTHER
PROPERTY RIGHTS IN THESE PLANS.
THESE PLANS AND DRAWINGS ARE NOT
TO BE REPRODUCED, CHANGED, OR
COPIED IN ANY FORM OR MANNER
WITHOUT FIRST OBTAINING THE EXPRESS
WRITTEN CONSENT OF RENAISSANCE
RESIDENTIAL DESIGN, INC. NOR ARE
THEY TO BE ASSIGNED TO ANY THIRD
PARTY WITHOUT FIRST OBTAINING SAID
WRITTEN PERMISSION AND CONSENT.

J.S.THOMPSON ENGINEERING, INC 606 WADE AVE., SUITE 104 RALEIGH, NC 27605 PHONE: (919) 789-9919 FAX: (919) 789-9921

N.C. CERTIFICATE NO.: C-1733



R PLANS, ELEVATIONS, DESIGNS, MATERIALS AND SIONS ARE SUBJECT TO CHANGE WITHOUT NOTICE. COOTAGE AND DIMENSIONS ARE ESTIMATED AND MAY CITUAL CONSTRUCTION. ACTUAL POSITION OF HOUSE WILL BE DETERMINED BY THE SITE PLAN AND PLOT OOR PLANS AND ELEVATION RENDERINGS ARE ARTIST SEPTIONS. FLOOR PLANS ARE THE COPYRIGHTED TY OF A&G RESIDENTIAL. ANY USE, REPRODUCTION, PATATION, OR DISPLAY OF THE PLANS IS STRICTLY IBITED. SEE NEW HOME SALES CONSULTANT FOR INT DETAILS. COPYRIGHT © 2021 A&G RESIDENTIAL

A&G RESIDENTIAL PICKENS DRIVE LEFT

DATE: MAY 3, 2022

REV.:

SCALE: 1/4"=

SCALE: 1/4"=1'-0"

DRAWN BY: WG

ENGINEERED BY: JAG

REVIEWED BY: MGS

FIRST FLOOR ELECTRICAL PLAN

E-

ELECTRICAL LAYOUT NOTES:

1.) BLOCK AND WIRE FOR ALL CELING FANS PER PLAN.

2.) VANITY LIGHTS TO BE SET

9 90" AFF. (TYP.)

3.) ADDITIONAL EXTERIOR OUTLETS
REQUIRED BY CODE TO BE
LOCATED BY ELECTRICIAN.

4.) PLACE SWITCHES 8" (MIN.) FROM

ROUGH OPENINGS.

ELECTRICAL LEGEND

- IIØ ∨ OUTLET ⇔
- iiø∨gfi outlet 👄
- 110 ∨ SWITCHED OUTLET 😛
- 110 V BASEBOARD OUTLET ↔ BB
- COUNTER OR FLOOR MOUNTED
- ER OR ELOOR MOUNTED LIQU GEL
- COUNTER OR FLOOR MOUNTED 110V GFI
 - WEATHERPROOF +

4-PLEX 🖶

- 220 Y DEDICATED CIRCUIT
- SPECIAL PURPOSE (240 V, ETC.)
- WALL MOUNT LIGHT -
- CEILING MOUNT LIGHT -
- PENDANT LIGHT -P-
- RECESSED CAN LIGHT
- MINI CAN LIGHT O
- FLUORESCENT LIGHT CUNDERCABINET LIGHT
- FLOOD LIGHT
- DIMMER SWITCH D\$

SWITCH \$

- TELEPHONE A
- DATA \triangle TELEPHONE AND DATA \triangle
- TV CONNECTION -TV
- CONDUIT FOR COMPONENT WIRING -CD
- SPEAKER SP
- 110 V SMOKE DETECTOR 6D
- EXHAUST FAN
- LOW VOLTAGE PANEL LVP
- ALARM PANEL ALARM

CEILING FAN


CEILING FAN W/ LIGHT


SIDE-LOAD

GARAGE OPTION


(NOT AVAILABLE WITH

OPTIONAL ONE-CAR GARAGE)

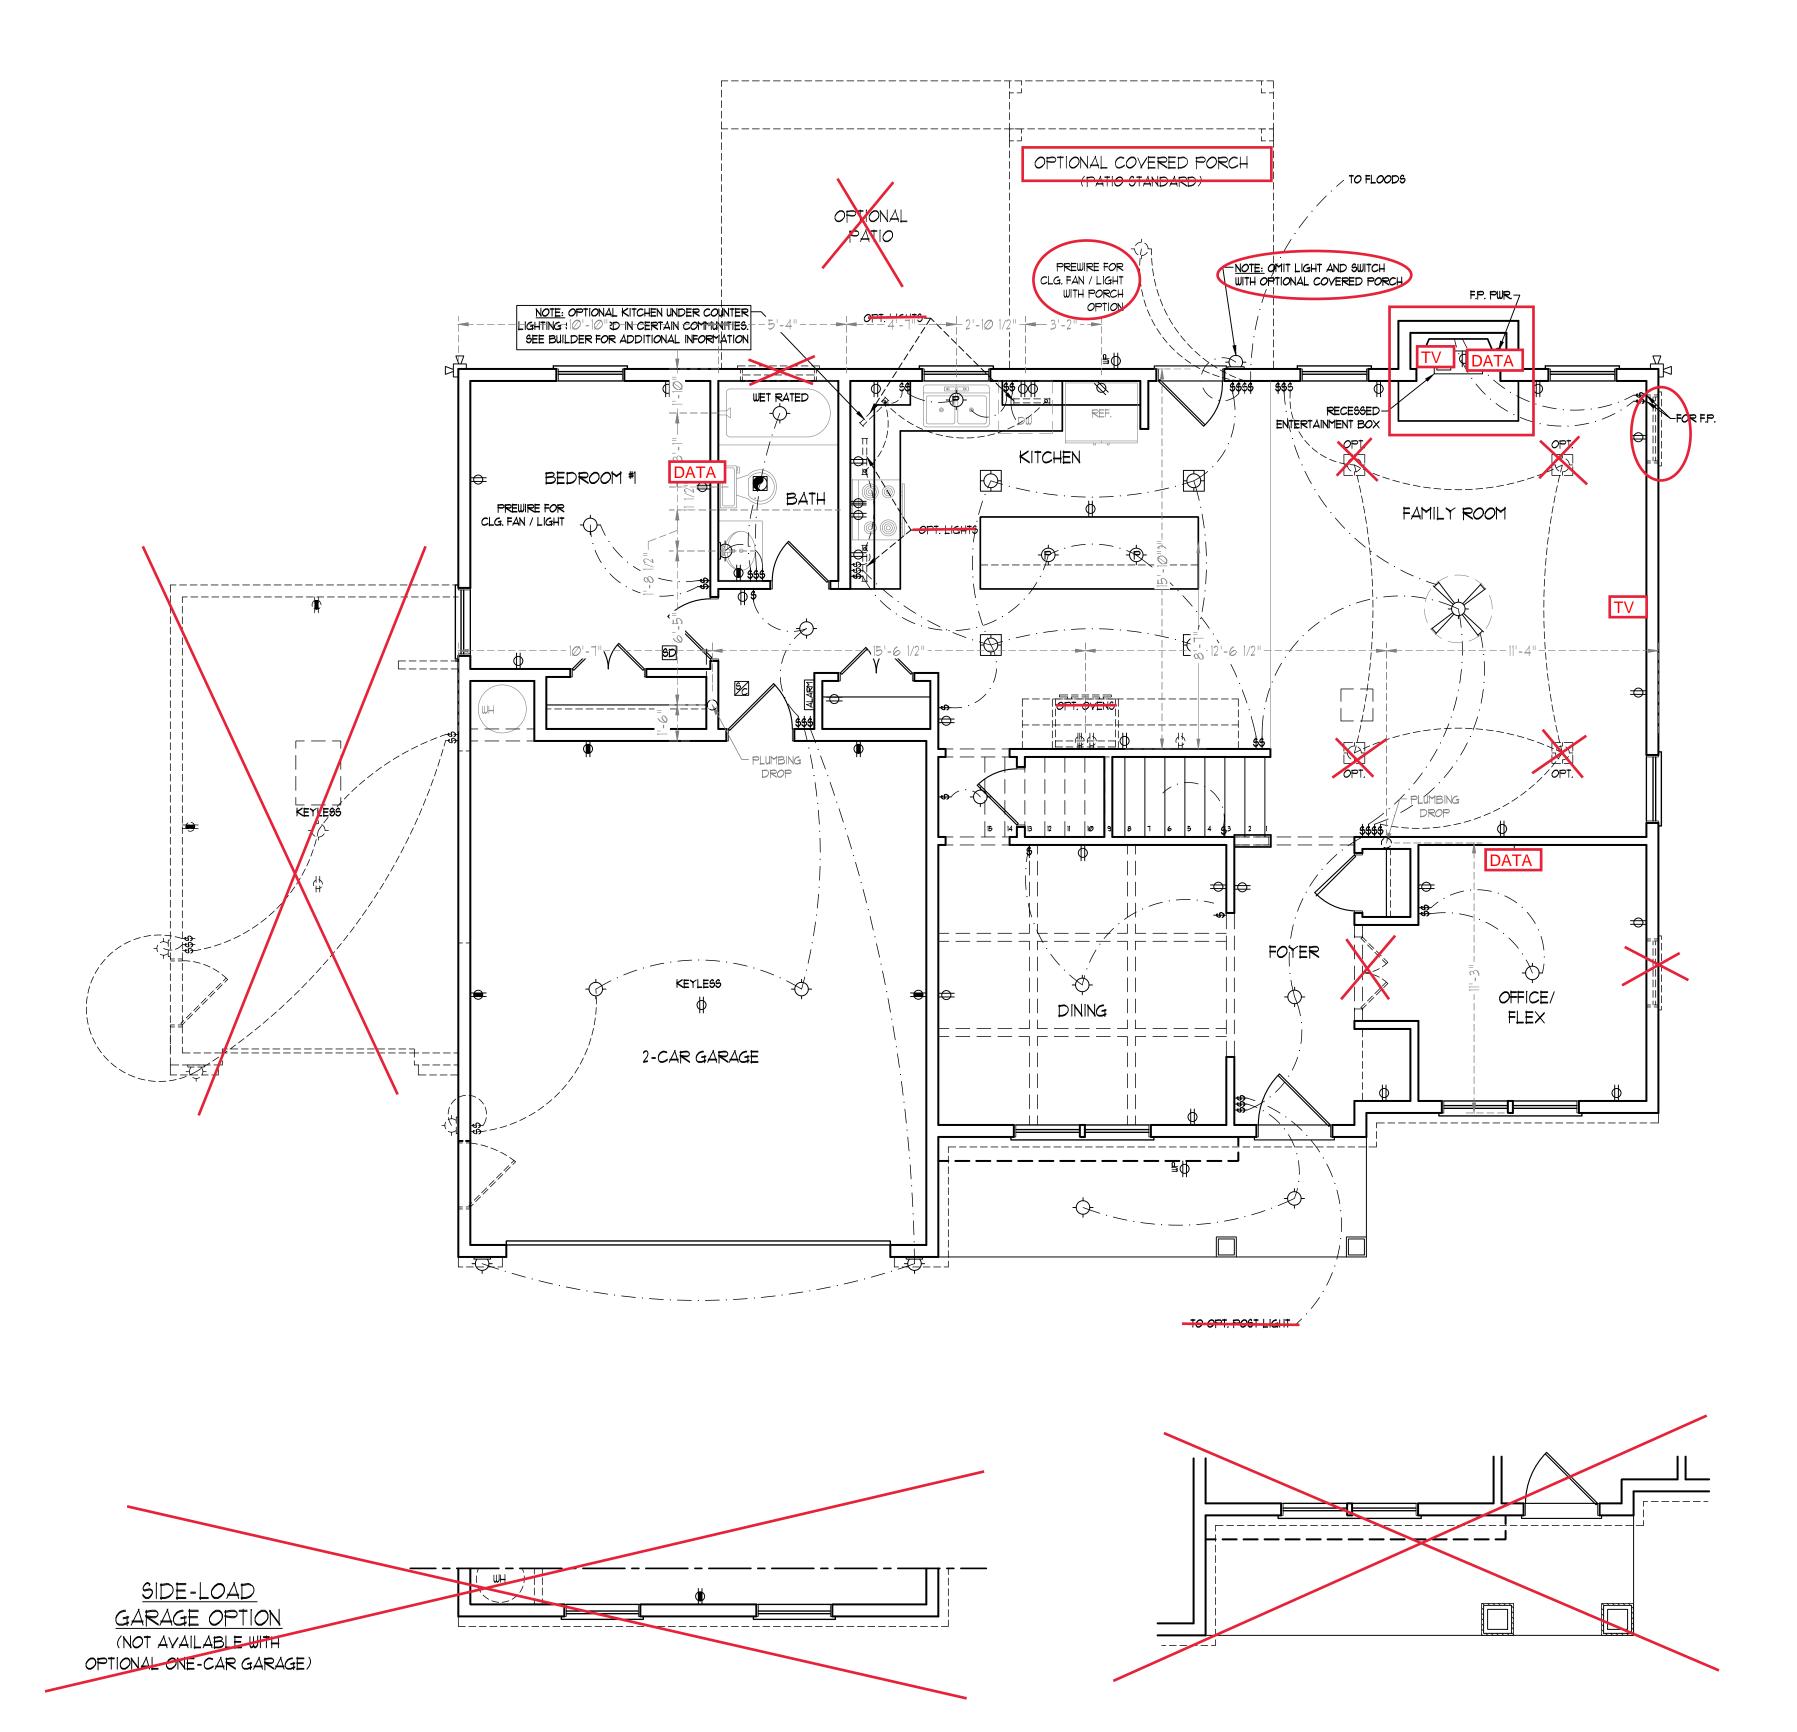

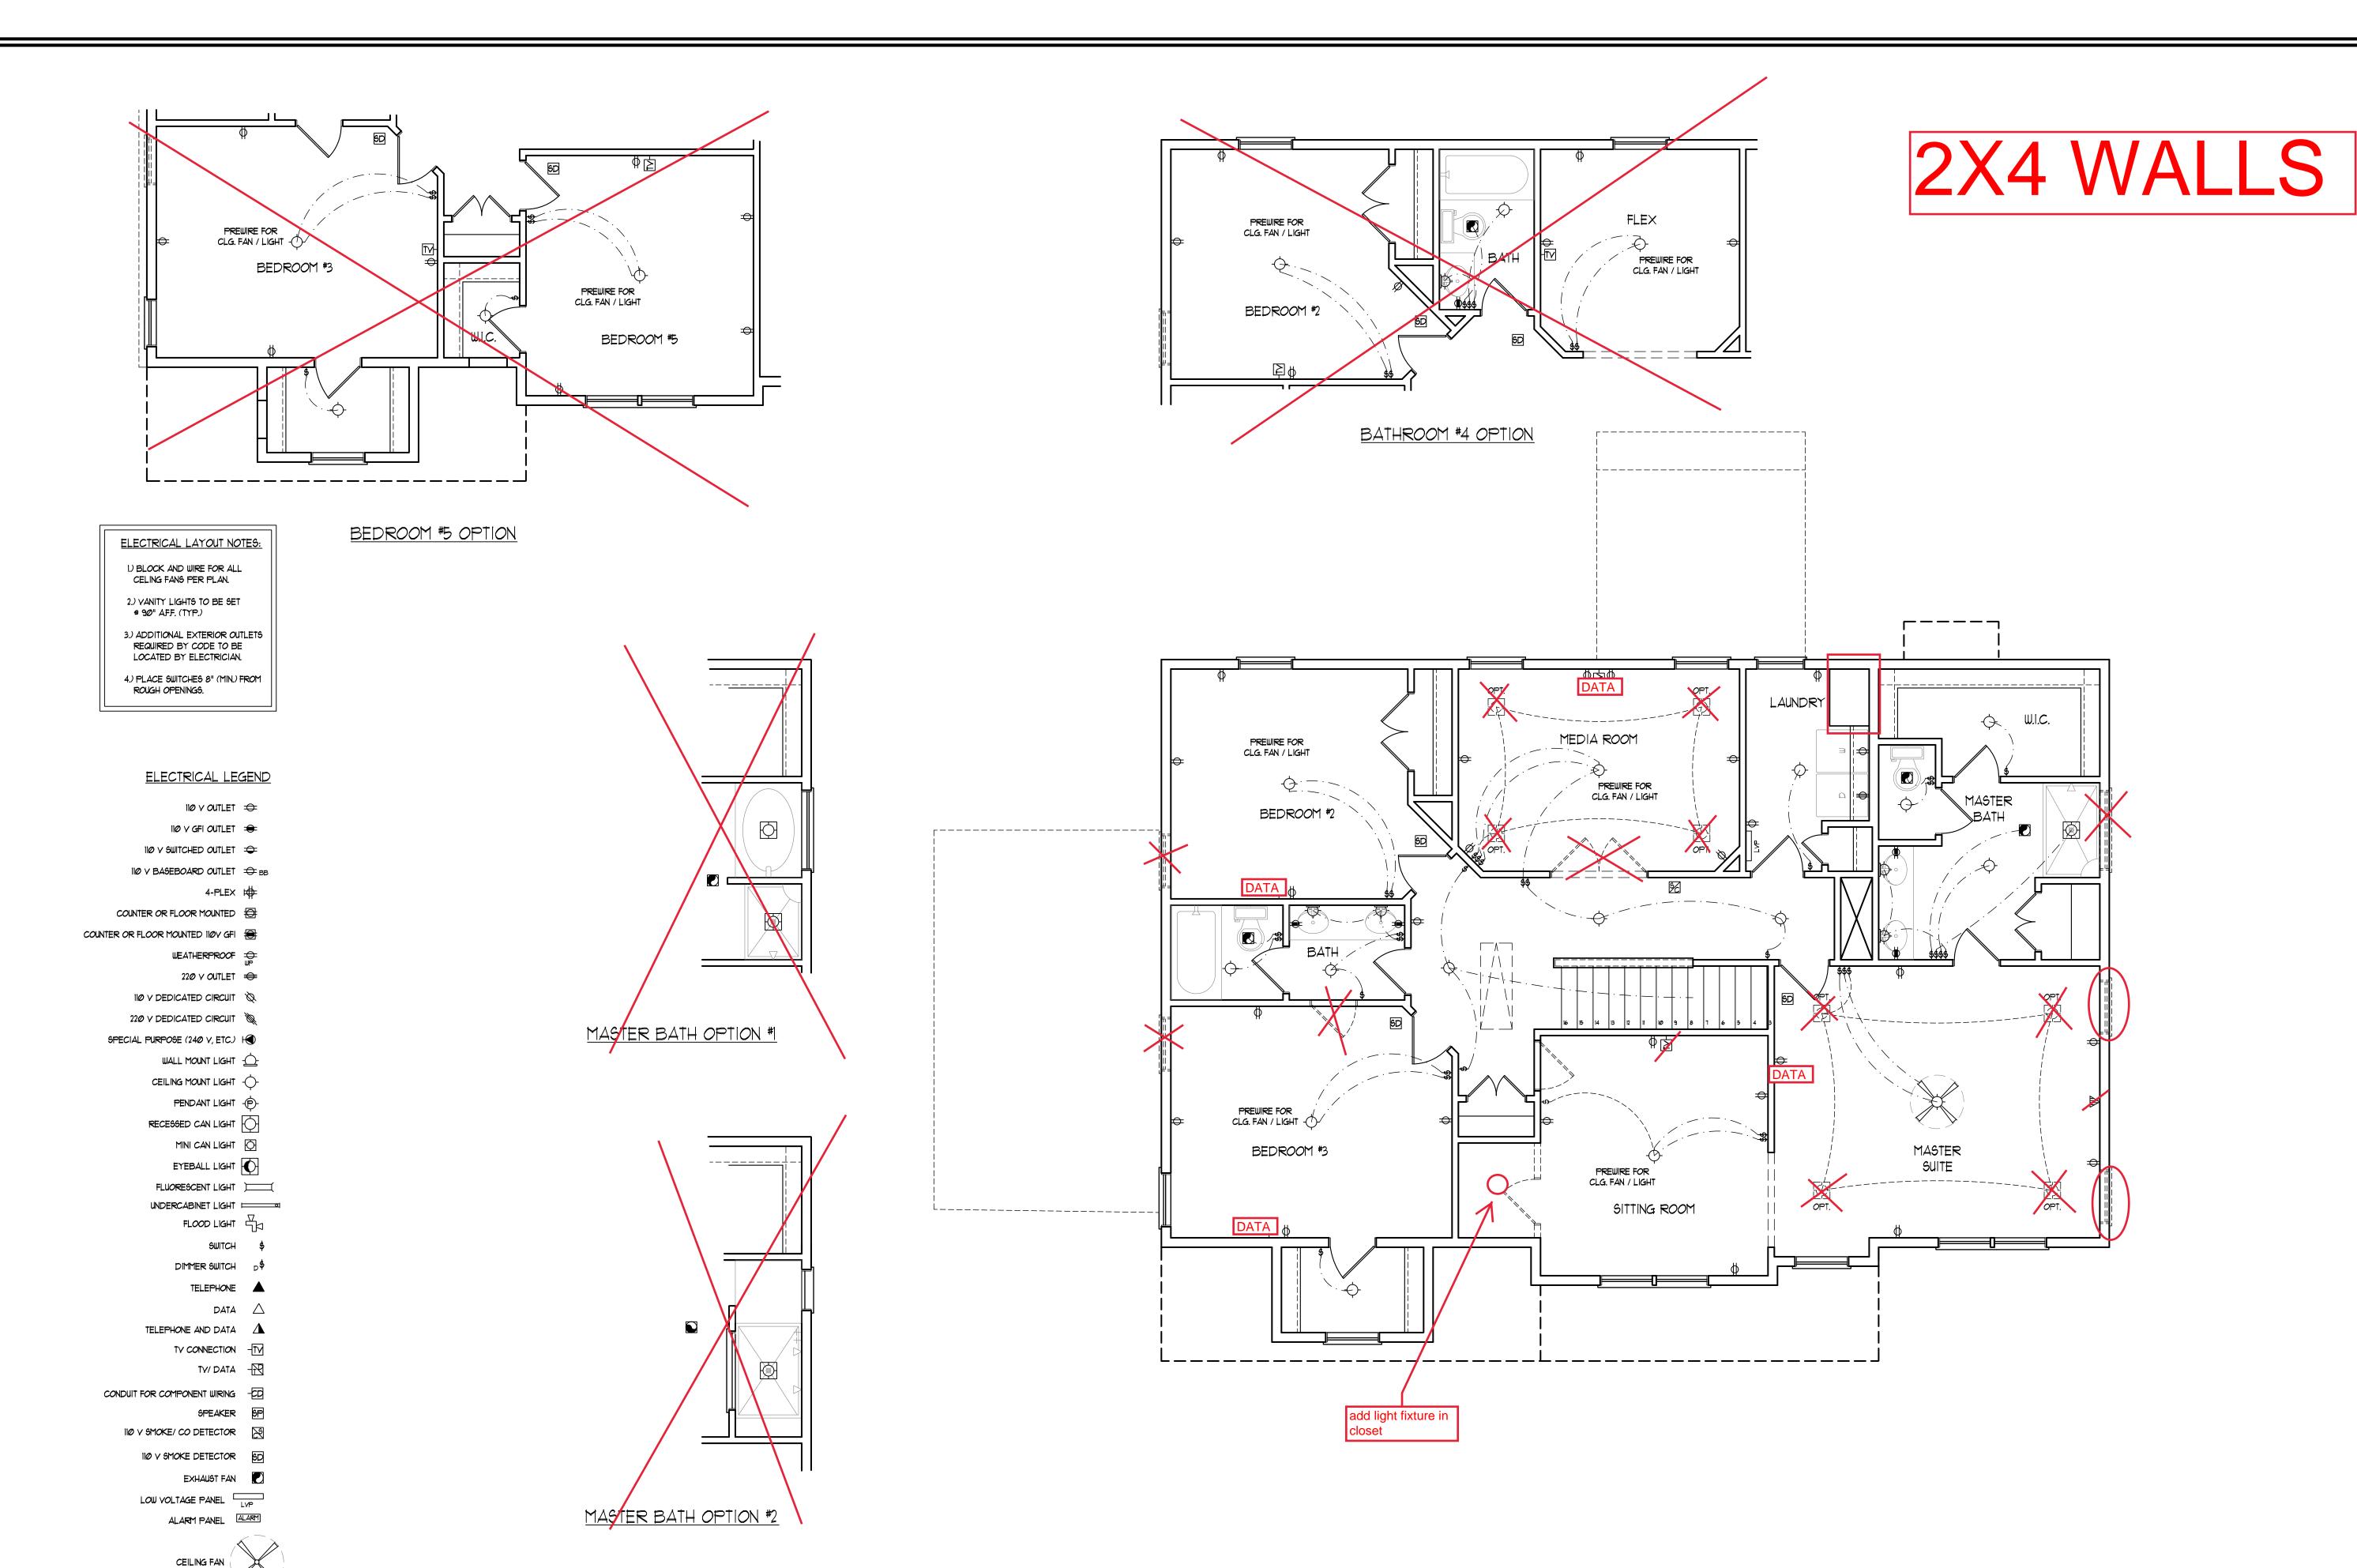

CEILING FAN W/ LIGHT

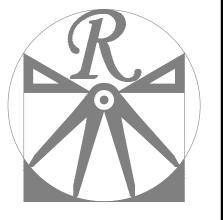

RENAISSANCE

RESIDENTIAL DESIGN, INC.
WILMINGTON, NC 28401
(919) 649-4128

WWW.RRDCAROLINA.COM
"The art of transforming your vision into reality."


RENAISSANCE RESIDENTIAL DESIGN, INC.
RESERVES THE RIGHT TO MAKE
MODIFICATIONS TO FLOOR PLANS,
DIMENSIONS, MATERIALS, AND

SPECIFICATIONS WITHOUT NOTICE.
THESE DRAWINGS ARE FOR THE
PURPOSE OF CONVEYING AN
ARCHITECTURAL CONCEPT ONLY.

RENAISSANCE RESIDENTIAL DESIGN, INC.
HEREBY EXPRESSLY RESERVES ITS
COMMON LAW COPYRIGHT AND OTHER
PROPERTY RIGHTS IN THESE PLANS.
THESE PLANS AND DRAWINGS ARE NOT
TO BE REPRODUCED, CHANGED, OR
COPIED IN ANY FORM OR MANNER
WITHOUT FIRST OBTAINING THE EXPRESS
WRITTEN CONSENT OF RENAISSANCE
RESIDENTIAL DESIGN, INC. NOR ARE
THEY TO BE ASSIGNED TO ANY THIRD
PARTY WITHOUT FIRST OBTAINING SAID
WRITTEN PERMISSION AND CONSENT.

J.S.THOMPSON ENGINEERING, INC 606 WADE AVE., SUITE 104 RALEIGH, NC 27605 PHONE: (919) 789-9919 FAX: (919) 789-9921

N.C. CERTIFICATE NO.: C-1733

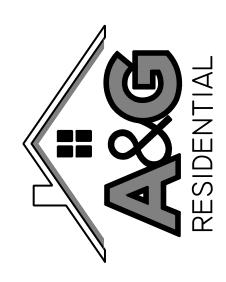

PRICES, PROMOTIONS, INCENTIVES, FEATURES, OPTIONS, FLOOR PLANS, ELEVATIONS, DESIGNS, MATERIALS AND DIMENSIONS ARE SUBJECT TO CHANGE WITHOUT NOTICE. QUARE FOOTAGE AND DIMENSIONS ARE ESTIMATED AND MAY ARY IN ACTUAL CONSTRUCTION. ACTUAL POSITION OF HOUSE ON LOT WILL BE DETERMINED BY THE SITE PLAN AND PLOT LAN. FLOOR PLANS AND ELEVATION RENDERINGS ARE ARTIST CONCEPTIONS. FLOOR PLANS ARE THE COPYRIGHTED PROPERTY OF A&G RESIDENTIAL. ANY USE, REPRODUCTION, ADAPTATION, OR DISPLAY OF THE PLANS IS STRICTLY PROHIBITED. SEE NEW HOME SALES CONSULTANT FOR

A&G RESIDENTIAL PICKENS DRIVE LEF

DATE: MAY 3, 2022

KEV.:

SCALE: 1/4"=1'-0"

DRAWN BY: WG

ENGINEERED BY: JAG

REVIEWED BY: MGS

SECOND FLOOR ELECTRICAL PLAN

E-2

130 MPH ULTIMATE DESIGN WIND SPEED NOTES FOR LESS THAN 30' MEAN ROOF HEIGHT:

- ENGINEER'S SEAL APPLIES ONLY TO STRUCTURAL COMPONENTS. ENGINEER'S SEAL DOES NOT CERTIFY DIMENSIONAL ACCURACY OR ARCHITECTURAL LAYOUT INCLUDING ROOF SYSTEM.
- STRUCTURAL DESIGN PER NORTH CAROLINA RESIDENTIAL CODE, 2018 EDITION.
 INSTALL 1/2" ANCHOR BOLTS 4'-0" O.C. AND WITHIN 1'-0" FROM END OF EACH CORNER. ANCHOR BOLTS MUST EXTEND A MINIMUM OF
- 1" INTO MASONRY OR CONCRETE. LOCATE
 BOLT WITHIN MIDDLE THIRD OF PLATE WIDTH.
 4. MEAN ROOF HEIGHT IS LESS THAN 30 FEET.
 5. EXTERIOR WALLS DESIGNED FOR 130 MPH
- 6. WALL CLADDING DESIGNED FOR +182 PSF AND -24 PSF (+/- INDICATE POSITIVE / NEGATIVE PRESSURE (TYP).
 1. ROOF CLADDING DESIGNED FOR +16.1 PSF AND -21 PSF FOR ROOF PITCHES 1/12 TO 12/12
- AND +10.5 PSF AND -4.3 PSF FOR ROOF PITCHED 2.25/12 TO 1/12.

 8. INSTALL 1/16" OSB SHEATHING ON ALL EXTERIOR WALLS OF ALL STORIES IN ACCORDANCE WITH SECTION R602.10.3 OF THE NCRC, 2018 EDITION. SEE THE WALL BRACING NOTES AND DETAILS SHEET FOR
- MORE INFORMATION.

 9. ENERGY EFFICIENCY COMPLIANCE AND INSULATION VALUES OF THE BUILDING TO BE IN ACCORDANCE WITH CHAPTER II OF THE NCRC, 2018 EDITION.
- 10. REFER TO NOTES AND DETAIL SHEETS FOR ADDITIONAL STRUCTURAL INFORMATION.

120 MPH ULTIMATE DESIGN WIND SPEED NOTES FOR LESS THAN 30' MEAN ROOF HEIGHT:

- ENGINEER'S SEAL APPLIES ONLY TO STRUCTURAL COMPONENTS, ENGINEER'S SEAL DOES NOT CERTIFY DIMENSIONAL ACCURACY OR ARCHITECTURAL LAYOUT INCLUDING ROOF SYSTEM.
- 2. STRUCTURAL DESIGN PER NORTH CAROLINA RESIDENTIAL CODE, 2018 EDITION.
 3. INSTALL 1/2" ANCHOR BOLTS 6'-0" O.C. AND
- WITHIN I'-O" FROM END OF EACH CORNER
 ANCHOR BOLTS MUST EXTEND A MINIMUM OF
 T" INTO MASONRY OR CONCRETE, LOCATE
 BOLT WITHIN MIDDLE THIRD OF PLATE WIDTH,
 MEAN ROOF HEIGHT IS LESS THAN 30 FEFT
- BOLT WITHIN MIDDLE THIRD OF PLATE WIDTH


 4. MEAN ROOF HEIGHT IS LESS THAN 30 FEET.


 5. EXTERIOR WALLS DESIGNED FOR 120 MPH
 WINDS
- 6. WALL CLADDING DESIGNED FOR +15.5 PSF AND -20 PSF (+/- INDICATE POSITIVE / NEGATIVE PRESSURE (TYP)
- NEGATIVE PRESSURE (TYP).

 ROOF CLADDING DESIGNED FOR +14.2 PSF AND -18 PSF FOR ROOF PITCHES 7/12 TO 12/12 AND +10 PSF AND -36 PSF FOR ROOF
- PITCHED 225/12 TO 7/12.


 8. INSTALL 7/16" OSB SHEATHING ON ALL EXTERIOR WALLS OF ALL STORIES IN ACCORDANCE WITH SECTION R602.10.3 OF THE NCRC, 2018 EDITION. SEE THE WALL BRACING NOTES AND DETAILS SHEET FOR MORE INFORMATION.
- 9. ENERGY EFFICIENCY COMPLIANCE AND INSULATION VALUES OF THE BUILDING TO BE IN ACCORDANCE WITH CHAPTER II OF THE NCRC, 2018 EDITION.
- IØ. REFER TO NOTES AND DETAIL SHEETS FOR ADDITIONAL STRUCTURAL INFORMATION.


2x4 WALLS

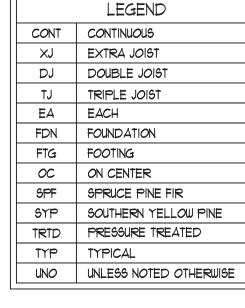

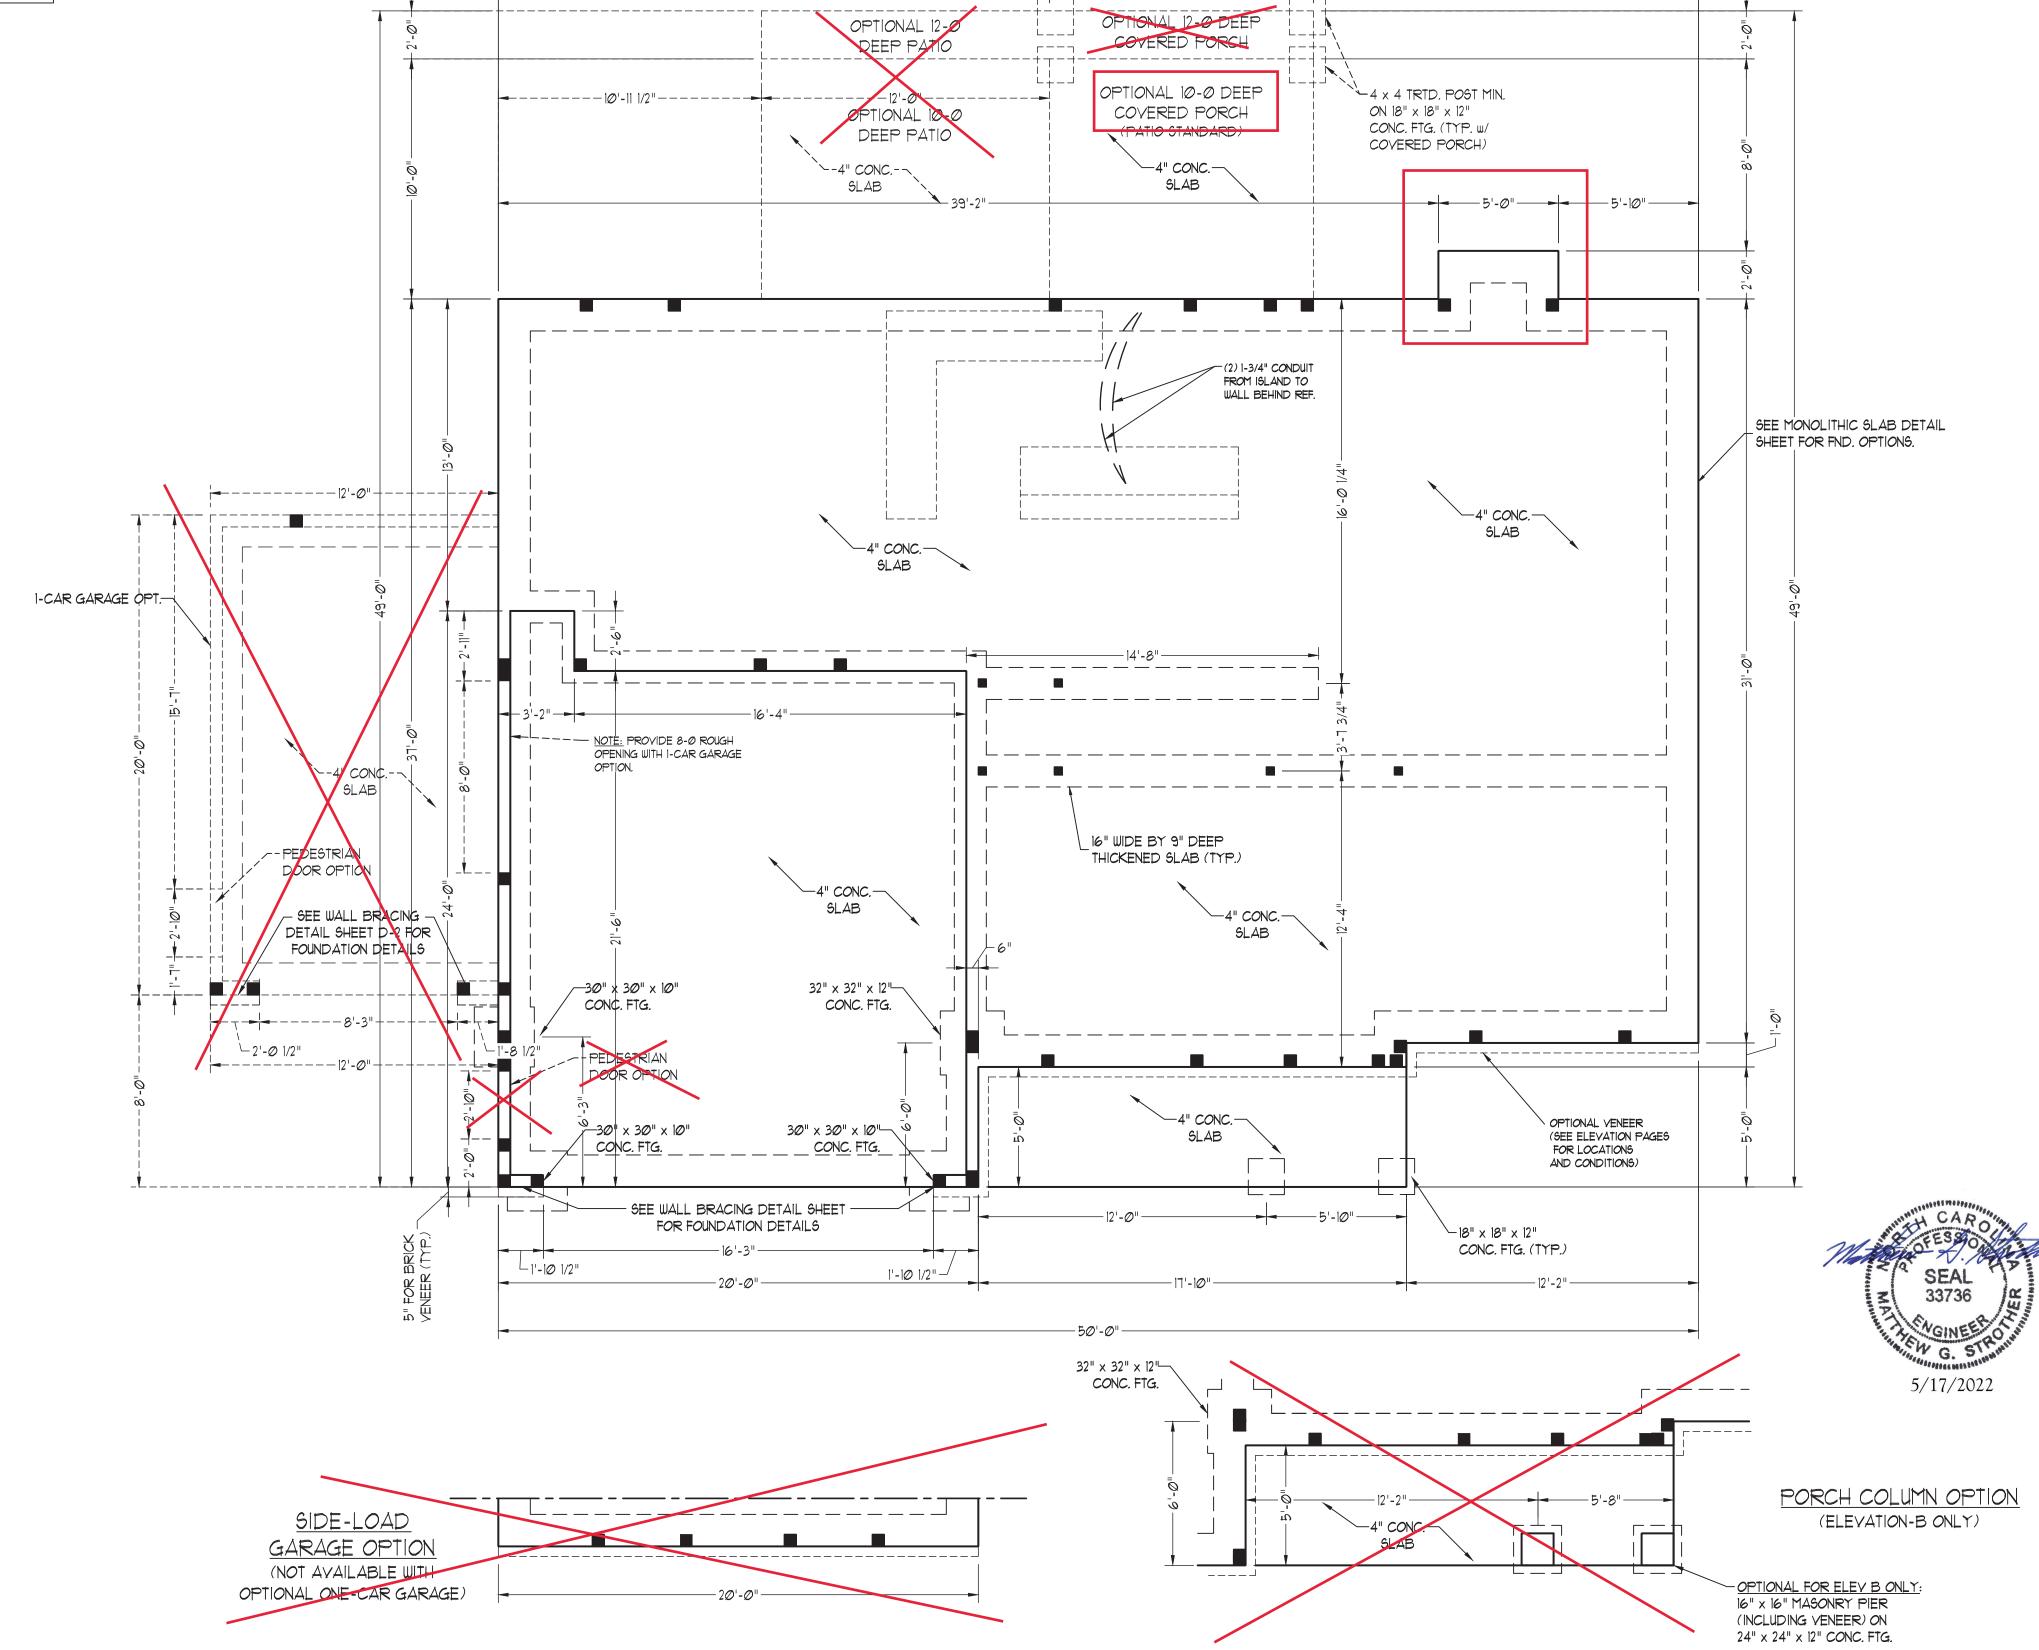

-16'-Ø 1/2" —

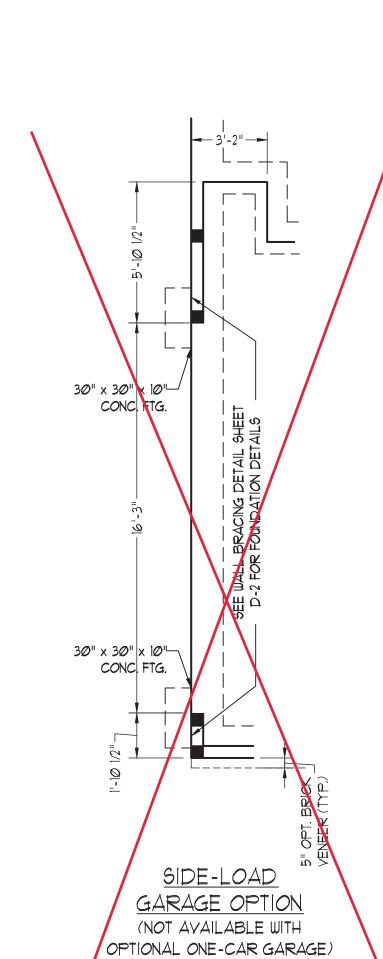

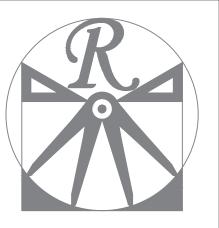

RENAISSANCE

RESIDENTIAL DESIGN, INC.
WILMINGTON, NC 28401
(919) 649-4128
WWW.RRDCAROLINA.COM

"The art of transforming your vision into reality."

RENAISSANCE RESIDENTIAL DESIGN, INC.
RESERVES THE RIGHT TO MAKE
MODIFICATIONS TO FLOOR PLANS,
DIMENSIONS, MATERIALS, AND
SPECIFICATIONS WITHOUT NOTICE.
THESE DRAWINGS ARE FOR THE
PURPOSE OF CONVEYING AN
ARCHITECTURAL CONCEPT ONLY.

RENAISSANCE RESIDENTIAL DESIGN, INC.
HEREBY EXPRESSLY RESERVES ITS
COMMON LAW COPYRIGHT AND OTHER
PROPERTY RIGHTS IN THESE PLANS.
THESE PLANS AND DRAWINGS ARE NOT
TO BE REPRODUCED, CHANGED, OR
COPIED IN ANY FORM OR MANNER
WITHOUT FIRST OBTAINING THE EXPRESS
WRITTEN CONSENT OF RENAISSANCE
RESIDENTIAL DESIGN, INC. NOR ARE
THEY TO BE ASSIGNED TO ANY THIRD
PARTY WITHOUT FIRST OBTAINING SAID
WRITTEN PERMISSION AND CONSENT.

J.S.THOMPSON ENGINEERING, INC 606 WADE AVE., SUITE 104 RALEIGH, NC 27605 PHONE: (919) 789-9919 FAX: (919) 789-9921

N.C. CERTIFICATE NO.: C-1733



ASTOR ARE SUBJECT TO CHANGE WITHOUT NOTICE.
FOOTAGE AND DIMENSIONS ARE ESTIMATED AND MAY
ACTUAL CONSTRUCTION. ACTUAL POSITION OF HOUSE
T WILL BE DETERMINED BY THE SITE PLAN AND PLOT
OOR PLANS AND ELEVATION RENDERINGS ARE ARTIST
ICEPTIONS. FLOOR PLANS ARE THE COPYRIGHTED
RTY OF A&G RESIDENTIAL. ANY USE, REPRODUCTION,
APTATION, OR DISPLAY OF THE PLANS IS STRICTLY
HIBITED. SEE NEW HOME SALES CONSULTANT FOR

A&G RESIDENTIAL PICKENS DRIVE LEFT

DATE: MAY 3, 2022

REV.:

SCALE: 1/4"=1'-0"

DRAWN BY: WG

ENGINEERED BY: JAG
REVIEWED BY: MGS

MONO SLAB FOUNDATION PLAN

S₋1

STRUCTURAL NOTES:

- ALL FRAMING LUMBER TO BE SPF #2 (UNO). ALL TREATED LUMBER TO BE SYP #2 (UNO.)
- ALL LOAD BEARING HEADERS TO BE (2) 2 x 6 SPF #2 OR SYP #2 (KILN DRIED) (UNO). HEADERS HAVE BEEN DESIGNED BASED ON CALCULATED LOADS. CODE TABLES HAVE NOT BEEN USED.
- PROVIDE AN EXTRA JOIST UNDER ALL WALLS PARALLEL TO FLOOR JOISTS WHERE NOTED ON PLANS...
- WINDOW AND DOOR HEADERS TO BE SUPPORTED w/(1) JACK STUD AND (1) KING STUD EA. END (UNO.). SEE TABLE R602.7.5 FOR ADDITIONAL KING STUD REQUIREMENTS.
- SQUARES DENOTE POINT LOADS WHICH REQUIRE SOLID BLOCKING TO GIRDER OR FOUNDATION. ALL SQUARES TO BE (2) STUDS (UNO.)
- 6. ALL 4 x 4 POSTS SHALL BE ANCHORED TO SLABS W/ SIMPSON ABU44 POST BASES (OR EQUAL) AND 6 x 6 POSTS w/ ABU66 POST BASES (OR EQUAL) (UNO). ALL 4 x 4 AND 6 x 6 POSTS TO BE INSTALLED WITH 700 LB CAPACITY UPLIFT CONNECTORS AT
- TOP (UNO.) FOR FIBERGLASS, ALUMINUM, OR COLUMN ENG. BY OTHERS, SECURE TO SLAB w/(2) METAL ANGLES USING 2" CONC. SCREWS. FASTEN ANGLES TO COLUMNS w/ 1/4" THROUGH BOLTS w/ NUTS AND WASHERS. LOCATE ANGLES ON OPPOSITE SIDES OF COLUMN. THROUGH BOLTS MUST BE INSTALLED
- PRIOR TO SETTING COLUMN. REFER TO NOTES AND DETAIL SHEETS FOR ADDITIONAL STRUCTURAL INFORMATION.

LEGEND CONT CONTINUOUS		
DJ	DOUBLE JOIST	
ŤJ	TRIPLE JOIST	
EΑ	EACH	
()	NUMBER OF STUDS	
DSP	DOUBLE STUD POCKET	
TSP	TRIPLE STUD POCKET	
oc	ON CENTER	
SPF	SPRUCE PINE FIR	
SYP	SOUTHERN YELLOW PINE	
TRTD	PRESSURE TREATED	
TYP	TYPICAL	
UNO	UNLESS NOTED OTHERWISE	

*NOTE: ALL EXTERIOR WALLS AND ATTIC WALLS ARE TO BE 2 x 6 @ 16" O.C. (UNO). 2 x 4 @ 16" O.C. EXTERIOR WALLS MAY BE CONSTRUCTED IN LIEU OF 2 x 6 WALLS (UNO). ALL INTERIOR LOAD BEARING WALLS ARE TO BE 2 x 4 @ 16" O.C. (UNO) AND NON-LOAD BEARING INTERIOR WALLS ARE TO BE 2 x 4 @ 24" O.C. (UNO).

BCI 45005-1.8 JOISTS MAY BE INSTALLED IN LIEU OF TJI 110 JOISTS AT THE DEPTH AND SPACING INDICATED ON THE PLAN BCI 5000s-1.8 JOISTS MAY BE INSTALLED

IN LIEU OF TJI 210 JOISTS AT THE DEPTH AND SPACING INDICATED ON THE PLAN.

TABLE R602.7.5 MINIMUM NUMBER OF FULL HEIGHT KING STUDS AT FACH FND OF HEADERS IN EXTERIOR WALLS

1 1	EACH END OF HEADERS IN EXTERIOR W			
	HEADER SPAN (FEET)	MINIMUM NUMBER OF FULL HEIGHT STUDS (KINGS)		
	UP TO 3'	1		
	> 3' TO 6'	2		
	> 6' TO 9'	3		
	> 9' TO 12'	4		
	> 12' TO 15'	5		

SIDE-LOAD

GARAGE OPTION

(NOT AVAILABLE WITH

OPTIONAL ONE-CAR GARAGE

BRACED WALL DESIGN

RECTANGLE B RECTANGLE A SIDE IB

SIDE IA (FRONT LOAD) METHOD: CS-WSP/PF TOTAL REQUIRED LENGTH: 4.56 TOTAL REQUIRED LENGTH: 17.2' TOTAL PROVIDED LENGTH: 6' TOTAL PROVIDED LENGTH: 19.37'

W 16 x 26 STEEL BEAM -

PACK WEB OUT w/ STACKED

2x MATERIAL EA. SIDE.

SECURE w/ (2) ROWS OF 1/2"

THROUGH BOLTS @ 24" O.C. -

SIDE 2B METHOD: CS-WSP METHOD: CS-WSP TOTAL REQUIRED LENGTH: 4.56' TOTAL REQUIRED LENGTH: 17.2' TOTAL PROVIDED LENGTH: 28.42' TOTAL PROVIDED LENGTH: 12' SIDE 3B / SIDE 4A CUMULATIVE SIDE 3A METHOD: CS-WSP

STEEL DETAIL 2

METHOD: CS-WSP/GB TOTAL REQUIRED LENGTH: 18.64' TOTAL REQUIRED LENGTH: 21.83' TOTAL PROVIDED LENGTH: 21.42' TOTAL PROVIDED LENGTH: 24.61' SIDE 4B SIDE 4A (SIDE LOAD) METHOD: CS-WSP METHOD: CS-WSP/PF

TOTAL REQUIRED LENGTH: 18.64' TOTAL REQUIRED LENGTH: 3.19' TOTAL PROVIDED LENGTH: 15.58' TOTAL PROVIDED LENGTH: 21.16'

2x NAILER SECURED TO TOP

FLANGE W/ (2) ROWS OF 1/2"

THROUGH BOLTS @ 24" O.C.

SIDE-LOAD

GARAGE OPTION

(NOT AVAILABLE WITH

OPTIONAL ONE CAR GARAGE)

- 7/16" CONTINUOUS

SHEATHING

METHOD: PF/CS-WSP

BRACED WALL DESIGN NOTES:

- BRACED WALL DESIGN PER SECTION R602.10 OF THE NCRC 2018 EDITION.
- CS-WSP REFERS TO "CONTINUOUS SHEATHING WOOD STRUCTURAL PANELS" CONTRACTOR IS TO INSTALL 1/16" OSB ON ALL EXTERIOR WALLS ATTACHED w/8d NAILS SPACED 6" O.C. ALONG PANEL EDGES AND 12" O.C. IN THE FIELD. *GB REFERS TO "GYPSUM BOARD" CONTRACTOR IS TO INSTALL
- 1/2" (MIN.) GYPSUM WALL BOARD WHERE NOTED ON THE PLANS. FASTEN GB WITH 1 1/4" SCREWS OR 1 5/8" NAILS SPACED 7" O.C. ALONG PANEL EDGES AND IN THE FIELD INCLUDING TOP AND BOTTOM PLATES.
- BRACED WALL DESIGN APPLIED IN WIND ZONES UP TO 130 MPH. FOR HIGH WIND ZONES, BRACE WALLS ARE TO BE CONSTRUCTED IN ACCORDANCE WITH CHAPTER 45 OF THE NCRC 2018 EDITION. SEE NOTES AND DETAIL SHEETS FOR ADDITIONAL BRACED

4 x 4 TRTD. POST-

4 x 4 TRTD. POST-

MIN. (TYP. w/ 10' PORCH)

MIN. (TYP. w/ 12' PORCH)

WALL INFORMATION.

2x4 WALLS

COVERED PORCH

ROOF TRUSSES ENG.


(1) 1 3/4" x 14" LSL-

RIM BOARD ATT.

CANT. JOISTS W/

INVERTED HGRS.


(2) 2 x 10

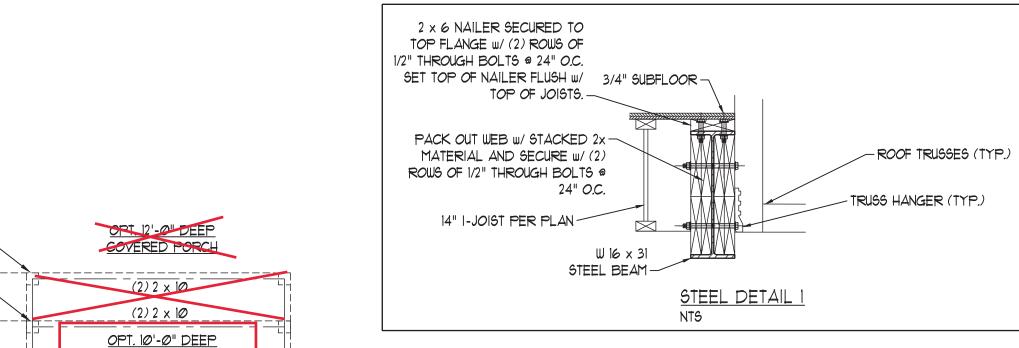

 $(2) 2 \times 10 (TYP)$

MIN. (TYP.)

ROOF TRUSSES ENG. BY OTHERS

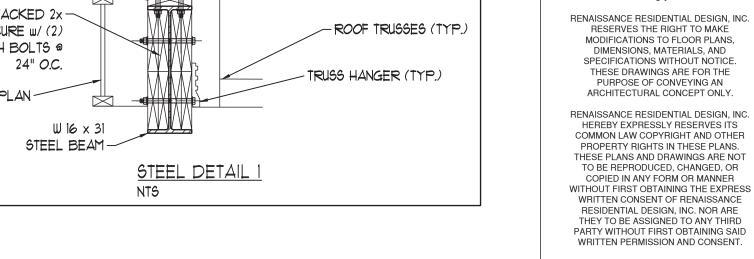

J.S.THOMPSON ENGINEERING, INC 606 WADE AVE., SUITE 104 RALEIGH, NC 27605 PHONE: (919) 789-9919 FAX: (919) 789-9921 N.C. CERTIFICATE NO.: C-1733

RENAISSANCE

RESIDENTIAL DESIGN, INC

WILMINGTON, NC 28401

(919) 649-4128

WWW.RRDCAROLINA.COM

The art of transforming your vision into reality.



RESIDENTIAI ENS DRIVE LE


DATE: MAY 3, 2022 REV.:


SCALE: 1/4"=1'-0" DRAWN BY: WG

5/17/2022

ENGINEERED BY: JAG REVIEWED BY: MGS

SECOND FLOOR FRAMING PLAN

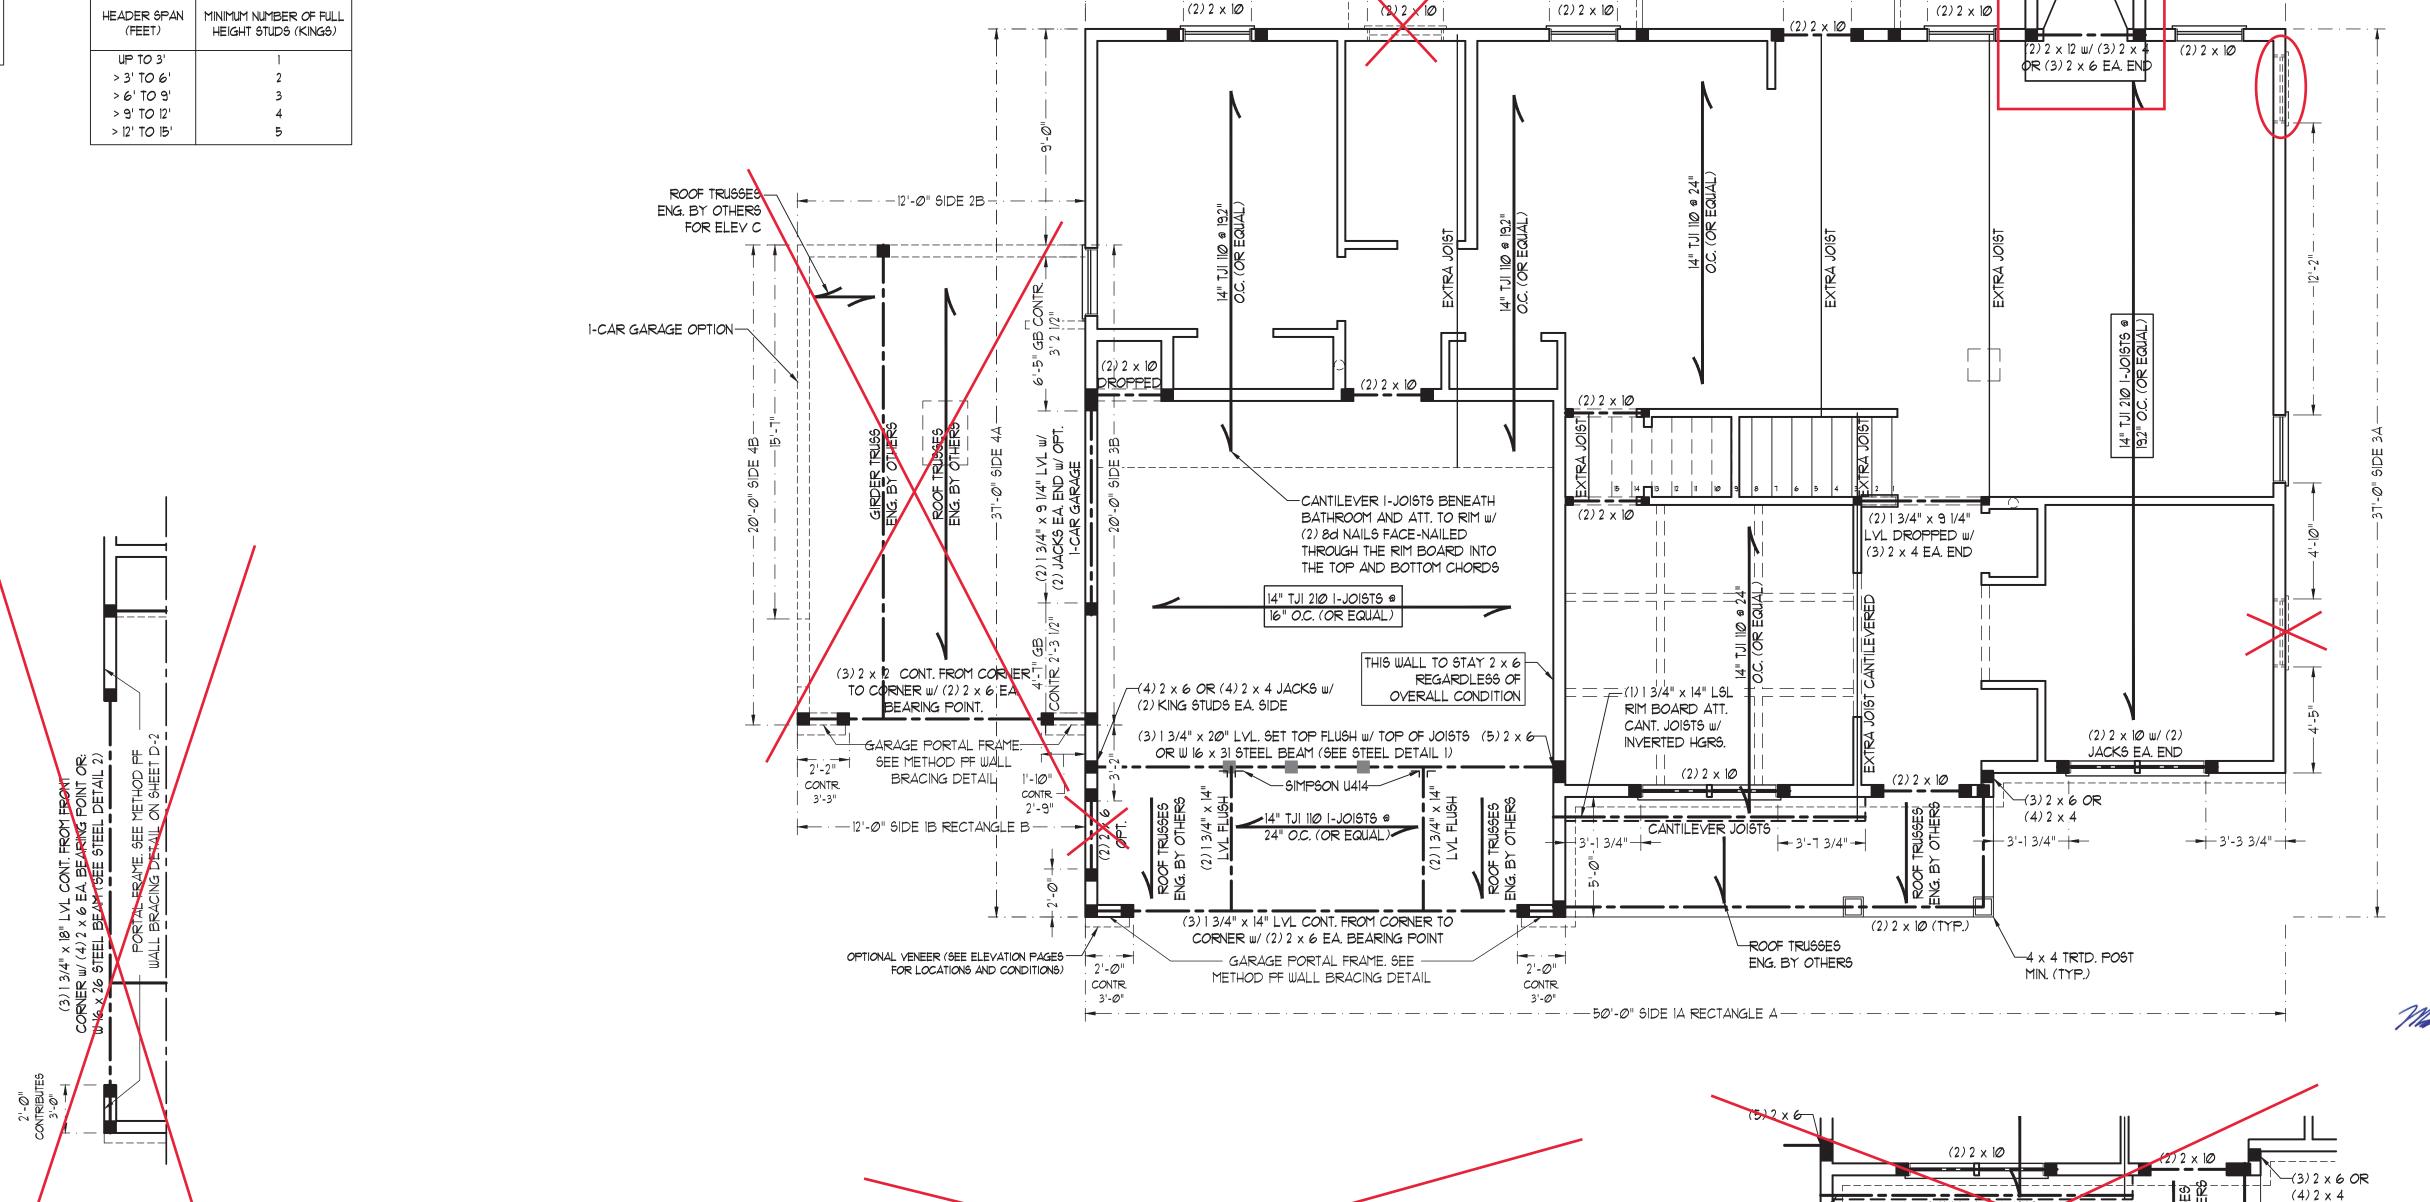

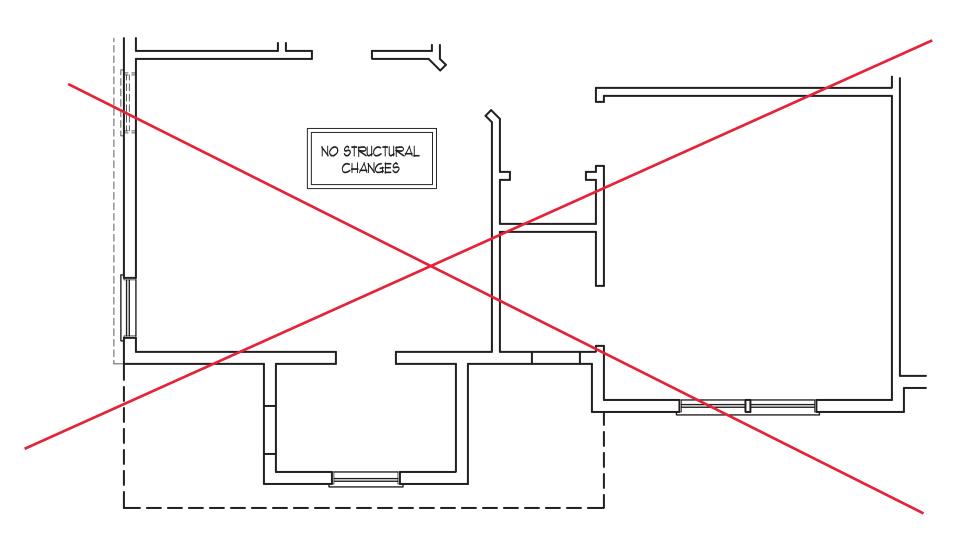

BEDROOM #5 OPTION

BRACED WALL DESIGN NOTES:

- 1. BRACED WALL DESIGN PER SECTION R602.10 OF THE NCRC 2018 EDITION.
- 2. CS-WSP REFERS TO "CONTINUOUS SHEATHING WOOD STRUCTURAL PANELS" CONTRACTOR IS TO INSTALL 1/16" OSB
- ON ALL EXTERIOR WALLS ATTACHED W/80 NAILS SPACED 6"
 O.C. ALONG PANEL EDGES AND 12" O.C. IN THE FIELD.

 3. *GB REFERS TO "GYPSUM BOARD" CONTRACTOR IS TO INSTALL
 1/2" (MIN.) GYPSUM WALL BOARD WHERE NOTED ON THE PLANS.
 FASTEN GB WITH 1 1/4" SCREWS OR 1 5/8" NAILS SPACED 1" O.C.
 ALONG PANEL EDGES AND IN THE FIELD INCLUDING TOP AND
- 4. BRACED WALL DESIGN APPLIED IN WIND ZONES UP TO 130 MPH. FOR HIGH WIND ZONES, BRACE WALLS ARE TO BE CONSTRUCTED
- IN ACCORDANCE WITH CHAPTER 45 OF THE NCRC 2018 EDITION.

 5. SEE NOTES AND DETAIL SHEETS FOR ADDITIONAL BRACED WALL INFORMATION.

NOTE:

- 1. PER SECTION R602.10.3.2 OF THE 2018 NCRC, THE AMOUNT OF BRACING ON THE SECOND FLOOR EXCEEDS THE AMOUNT REQUIRED FOR THE FIRST FLOOR AND NO BRACED WALL ANALYSIS IS REQUIRED.
- 2. SHEATH ALL EXTERIOR WALLS WITH 1/16" OSB SHEATHING ATTACHED WITH 8d NAILS AT 6" O.C. ALONG PANEL EDGES AND 12" O.C. IN THE FIELD.

STRUCTURAL NOTES:

- 1. ALL FRAMING LUMBER TO BE #2 SPF
- 2. ALL LOAD BEARING HEADERS TO BE (2) 2 x 6 (UNO).
- 3. WINDOW AND DOOR HEADERS TO BE SUPPORTED w/ (1) JACK STUD AND (1) KING STUD EA. END (UNO.). SEE TABLE R602.7.5 FOR ADDITIONAL KING STUD
- 4. SQUARES DENOTE POINT LOADS
 WHICH REQUIRE SOLID BLOCKING TO
 GIRDER OR FOUNDATION. SQUARES
 TO BE (2) STUDS (UNO.)

REQUIREMENTS.


5. REFER TO NOTES AND DETAIL SHEETS FOR ADDITIONAL STRUCTURAL INFORMATION.

LEGEND		
CONT	CONTINUOUS	
XJ	EXTRA JOIST	
DJ	DOUBLE JOIST	
ŤJ	TRIPLE JOIST	
EA	EACH	
()	NUMBER OF STUDS	
DSP	DOUBLE STUD POCKET	
TSP	TRIPLE STUD POCKET	
ОС	ON CENTER	
SPF	SPRUCE PINE FIR	
SYP	SOUTHERN YELLOW PINE	
TRID	PRESSURE TREATED	
TYP	TYPICAL	
UNO	UNLESS NOTED OTHERWISE	

TABLE R602.7.5 MINIMUM NUMBER OF FULL HEIGHT KING STUDS AT EACH END OF HEADERS IN EXTERIOR WALLS

HEADER SPAN (FEET)	MINIMUM NUMBER OF FULL HEIGHT STUDS (KINGS)		
UP TO 3'	1		
> 3' TO 6'	2		
> 6' TO 9'	3		
> 9' TO 12'	4		
> 12' TO 15'	5		

*NOTE: ALL EXTERIOR WALLS
AND ATTIC WALLS ARE TO BE
2 x 6 @ 16" O.C. (UNO). 2 x 4 @
16" O.C. EXTERIOR WALLS
MAY BE CONSTRUCTED IN
LIEU OF 2 x 6 WALLS (UNO).
ALL INTERIOR LOAD BEARING
WALLS ARE TO BE 2 x 4 @ 16"
O.C. (UNO) AND NON-LOAD
BEARING INTERIOR WALLS
ARE TO BE 2 x 4 @ 24" O.C.
(UNO).

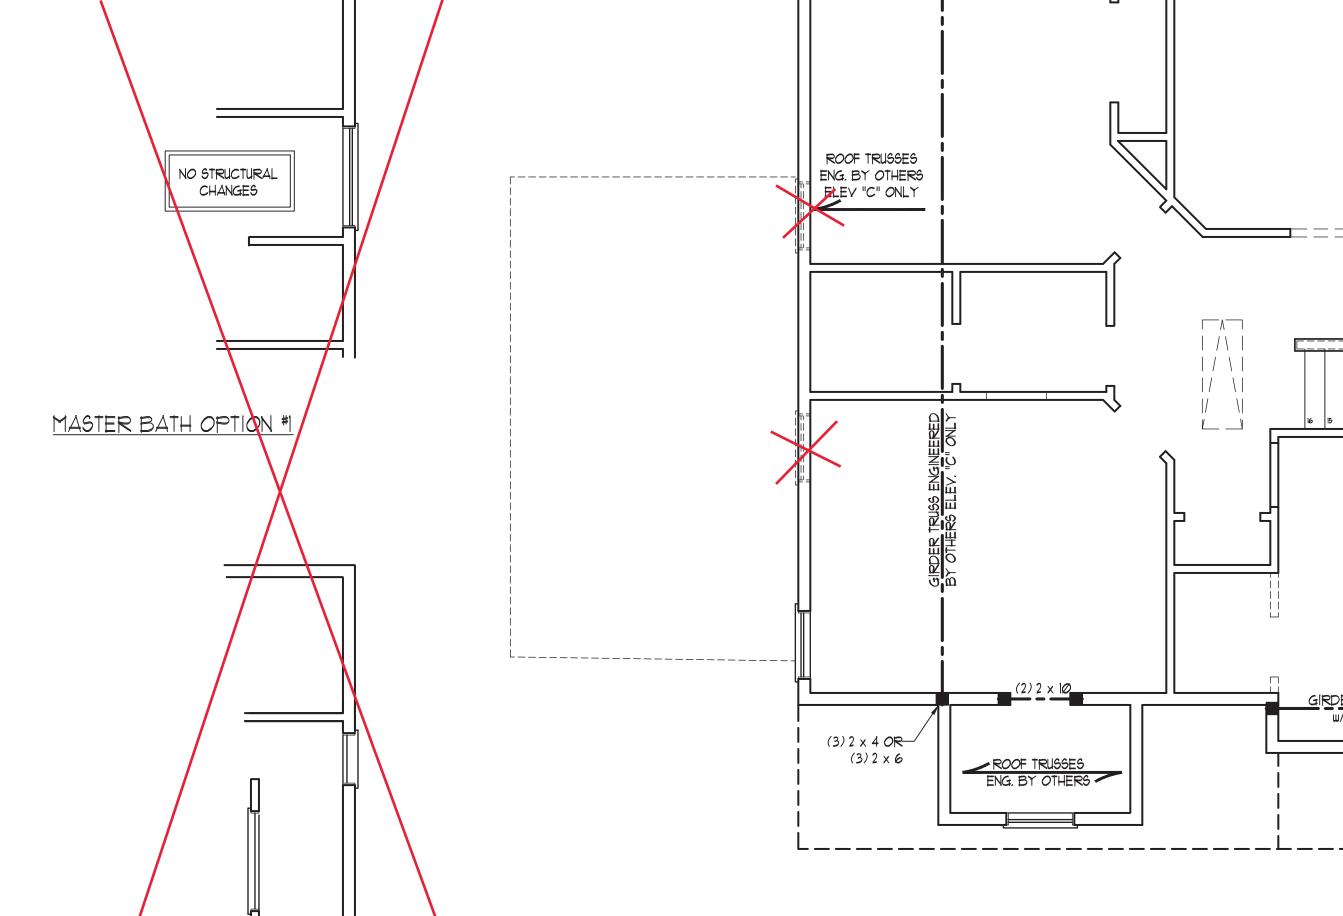


NO STRUCTURAL

CHANGES

BATHROOM #4 OPTION

 $(2) 2 \times 10^{\circ}$

r------

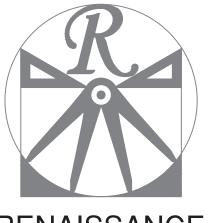

RENAISSANCE

RESIDENTIAL DESIGN, INC.
WILMINGTON, NC 28401
(919) 649-4128

WWW.RRDCAROLINA.COM

"The art of transforming your vision into reality."

RENAISSANCE RESIDENTIAL DESIGN, INC.

RESERVES THE RIGHT TO MAKE

MODIFICATIONS TO FLOOR PLANS,

DIMENSIONS, MATERIALS, AND

THESE DRAWINGS ARE FOR THE PURPOSE OF CONVEYING AN ARCHITECTURAL CONCEPT ONLY.

RENAISSANCE RESIDENTIAL DESIGN, INC. HEREBY EXPRESSLY RESERVES ITS COMMON LAW COPYRIGHT AND OTHER PROPERTY RIGHTS IN THESE PLANS. THESE PLANS AND DRAWINGS ARE NOT TO BE REPRODUCED, CHANGED, OR COPIED IN ANY FORM OR MANNER WITHOUT FIRST OBTAINING THE EXPRESS

WRITTEN CONSENT OF RENAISSANCE RESIDENTIAL DESIGN, INC. NOR ARE

THEY TO BE ASSIGNED TO ANY THIRD

SPECIFICATIONS WITHOUT NOTICE.

PARTY WITHOUT FIRST OBTAINING SAID WRITTEN PERMISSION AND CONSENT.

J.S.THOMPSON
ENGINEERING, INC
606 WADE AVE., SUITE 104
RALEIGH, NC 27605

PHONE: (919) 789-9919

FAX: (919) 789-9921 N.C. CERTIFICATE NO.: C-1733



PRICES, PROMOTIONS, INCENTIVES, FEATURES, OPTIONS, FLOOR PLANS, ELEVATIONS, DESIGNS, MATERIALS AND DIMENSIONS ARE SUBJECT TO CHANGE WITHOUT NOTICE. SQUARE FOOTAGE AND DIMENSIONS ARE ESTIMATED AND MAY ARY IN ACTUAL CONSTRUCTION. ACTUAL POSITION OF HOUSE ON LOT WILL BE DETERMINED BY THE SITE PLAN AND PLOT UAN. FLOOR PLANS AND ELEVATION RENDERINGS ARE ARTIST CONCEPTIONS. FLOOR PLANS ARE THE COPYRIGHTED PROPERTY OF A&G RESIDENTIAL. ANY USE, REPRODUCTION, ADAPTATION, OR DISPLAY OF THE PLANS IS STRICTLY PROHIBITED. SEE NEW HOME SALES CONSULTANT FOR CHARLE OF THE PLANS IS STRICTLY PROHIBITED. SEE NEW HOME SALES CONSULTANT FOR

A&G RESIDENTIAL PICKENS DRIVE LEFT

DATE: MAY 3, 2022

SCALE: 1/4"=1'-0"


DRAWN BY: WG
ENGINEERED BY: JAG

REVIEWED BY: MGS

ATTIC FLOOR FRAMING PLAN

S-3

5/17/2022

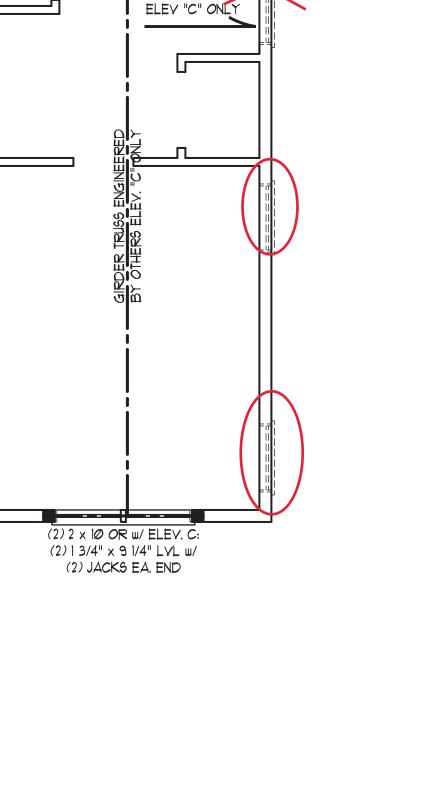


 $(3) 2 \times 4 OR$ (3) 2 × 6

ROOF TRUSSES

ENG. BY OTHERS



2x4 WALLS

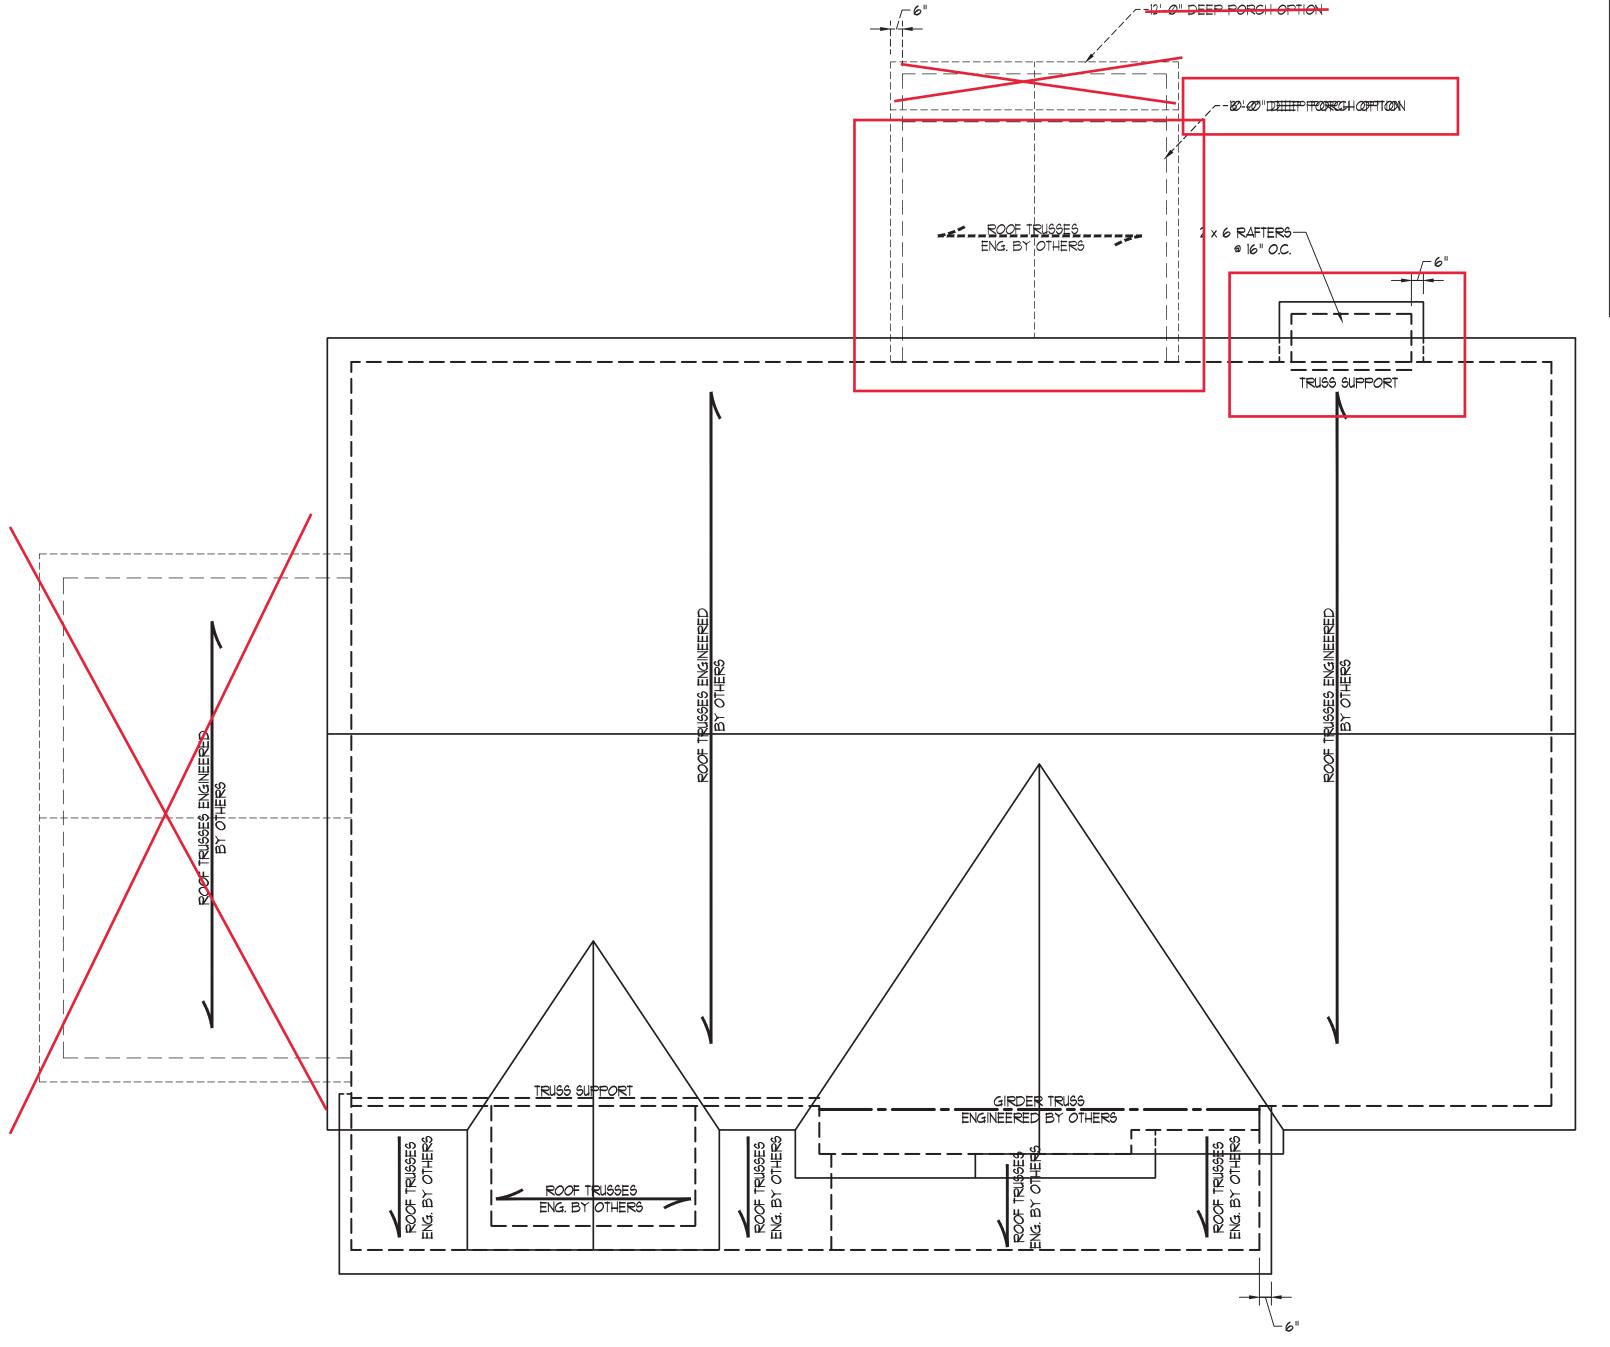

STRUCTURAL NOTES:

- ALL FRAMING LUMBER TO BE *2 SPF (UNO). CIRCLES DENOTE (3) 2 x 4 POSTS
- CIRCLES DENOTE (3) 2 x 4 POSTS FOR ROOF SUPPORT.
 FRAME DORMER WALLS ON TOP
- OF DOUBLE OR TRIPLE RAFTERS.

 4. HIP SPLICES ARE TO BE SPACED
 A MIN. OF 8'-0". FASTEN
 MEMBERS WITH THREE ROWS OF
- 12d NAILS @ 16" O.C. (TYP.)

 5. STICK FRAME OVER-FRAMED
 ROOF SECTIONS W/ 2 x 8 RIDGES,
 2 x 6 RAFTERS @ 16" O.C. AND
 FLAT 2 x 10 VALLEYS OR USE
 VALLEY TRUSSES.
- 6. FASTEN FLAT VALLEYS TO
 RAFTERS OR TRUSSES WITH
 SIMPSON H2.5A HURRICANE TIES @
 32" O.C. MAX. PASS HURRICANE
 TIES THROUGH NOTCH IN ROOF
 SHEATHING. EACH RAFTER IS TO
 BE FASTENED TO THE FLAT
 VALLEY WITH A MIN. OF (6) 12d
 TOE NAILS.
- 1. REFER TO SECTION R802.II OF THE 2018 NCRC FOR REQUIRED UPLIFT RESISTANCE AT RAFTERS AND TRUSSES.
- 8. REFER TO NOTES AND DETAIL SHEETS FOR ADDITIONAL STRUCTURAL INFORMATION.

LEGEND		
CONT	CONTINUOUS	
XR	EXTRA RAFTER	
DR	DOUBLE RAFTER	
TR	TRIPLE RAFTER	
EA	EACH	
oc	ON CENTER	
SPF	SPRUCE PINE FIR	
SYP	SOUTHERN YELLOW PINE	
TYP	TYPICAL	
UNO	UNLESS NOTED OTHERWISE	



RENAISSANCE

RESIDENTIAL DESIGN, INC.
WILMINGTON, NC 28401
(919) 649-4128

WWW.RRDCAROLINA.COM
"The art of transforming your vision into reality."

RENAISSANCE RESIDENTIAL DESIGN, INC.
RESERVES THE RIGHT TO MAKE
MODIFICATIONS TO FLOOR PLANS,
DIMENSIONS, MATERIALS, AND
SPECIFICATIONS WITHOUT NOTICE.
THESE DRAWINGS ARE FOR THE
PURPOSE OF CONVEYING AN
ARCHITECTURAL CONCEPT ONLY.

RENAISSANCE RESIDENTIAL DESIGN, INC. HEREBY EXPRESSLY RESERVES ITS COMMON LAW COPYRIGHT AND OTHER PROPERTY RIGHTS IN THESE PLANS. THESE PLANS AND DRAWINGS ARE NOT TO BE REPRODUCED, CHANGED, OR COPIED IN ANY FORM OR MANNER WITHOUT FIRST OBTAINING THE EXPRESS WRITTEN CONSENT OF RENAISSANCE RESIDENTIAL DESIGN, INC. NOR ARE THEY TO BE ASSIGNED TO ANY THIRD PARTY WITHOUT FIRST OBTAINING SAID WRITTEN PERMISSION AND CONSENT.

J.S.THOMPSON ENGINEERING, INC 606 WADE AVE., SUITE 104 RALEIGH, NC 27605 PHONE: (919) 789-9919 FAX: (919) 789-9921 N.C. CERTIFICATE NO.: C-1733



FLOOR PLANS, ELEVATIONS, DESIGNS, MATERIALS AND DIMENSIONS ARE SUBJECT TO CHANGE WITHOUT NOTICE. JARE FOOTAGE AND DIMENSIONS ARE ESTIMATED AND MAY BY IN ACTUAL CONSTRUCTION. ACTUAL POSITION OF HOUSE IN LOT WILL BE DETERMINED BY THE SITE PLAN AND PLOT AN FLOOR PLANS AND ELEVATION RENDERINGS ARE ARTIST CONCEPTIONS. FLOOR PLANS ARE THE COPYRIGHTED AOPERTY OF A&G RESIDENTIAL. ANY USE, REPRODUCTION, ADAPTATION, OR DISPLAY OF THE PLANS IS STRICTLY ADAPTATION, OR DISPLAY OF THE PLANS IS STRICTLY PROHIBITED. SEE NEW HOME SALES CONSULTANT FOR CURRENT DETAILS. COPYRIGHT © 2021 A&G RESIDENTIAL

A&G RESIDENTIAL PICKENS DRIVE LEFT

DATE: MAY 3, 2022

REV.:

SCALE: 1/4"=1'-0"

DRAWN BY: WG


ENGINEERED BY: JAG


REVIEWED BY: MGS
ROOF PLAN

ELEVATIONS A&B

ELEVATION A & B



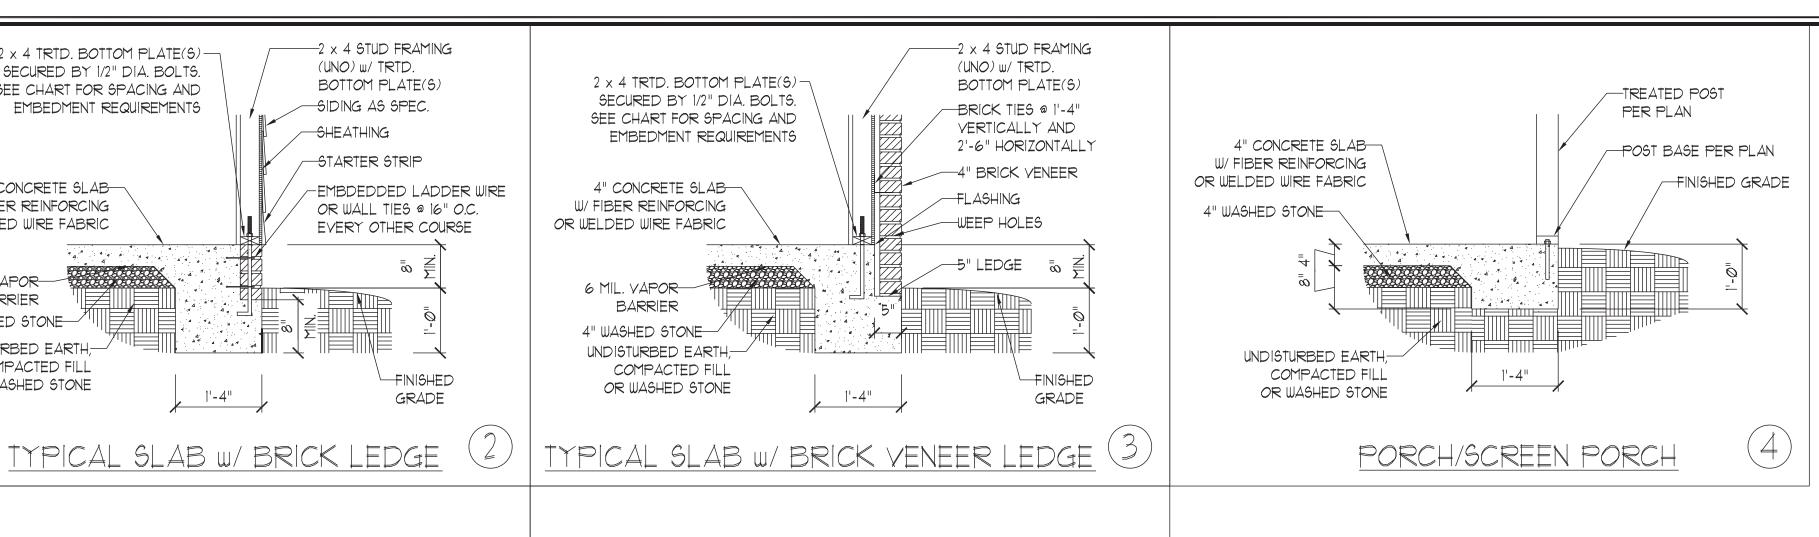

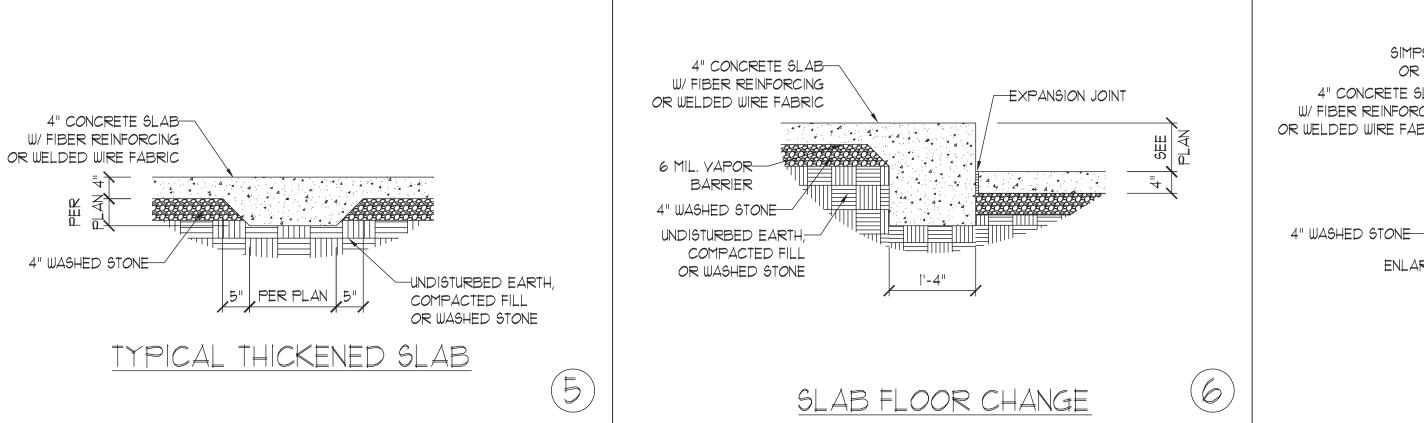

2 x 4 TRTD. BOTTOM PLATE(S) -

EMBEDMENT REQUIREMENTS

SECURED BY 1/2" DIA. BOLTS.

SEE CHART FOR SPACING AND

4" CONCRETE SLAB

W/ FIBER REINFORCING

OR WELDED WIRE FABRIC

6 MIL. VAPOR-

BARRIER

4" WASHED STONE

UNDISTURBED EARTH,-

COMPACTED FILL OR WASHED STONE

2 x 4 TRTD. BOTTOM PLATE(S)

SECURED BY 1/2" DIA. BOLTS.

EMBEDMENT REQUIREMENTS

1'-4"

SEE CHART FOR SPACING AND

4" CONCRETE SLAB

6 MIL. VAPOR

W/ FIBER REINFORCING

OR WELDED WIRE FABRIC

BARRIER

4" WASHED STONE

UNDISTURBED EARTH,

COMPACTED FILL

OR WASHED STONE

-2 × 4 STUD FRAMING

BOTTOM PLATE(S)

(UNO) w/ TRTD.

-SIDING AS SPEC.

-STARTER STRIP

-EXTERIOR WALL:

SIDING AS SPEC.

STARTER STRIP

 -2×4 TRTD. BOTTOM PLATE(5)

EMBEDMENT REQUIREMENTS

SECURED BY 1/2" DIA. BOLTS. SEE CHART FOR SPACING AND

SHEATHING

1'-4"

GARAGE CURB

STEP IN GARAGE

2 x 4 STUD FRAMING (UNO)

w/ TRTD. BOTTOM PLATE(S)

FINISHED GRADE

WELDED WIRE FABRIC

FINISHED

GRADE

-SHEATHING

1'-4"

TYPICAL SLAB

2 x 4 TRTD. BOTTOM PLATE(6) -

SECURED BY 1/2" DIA. BOLTS.

SEE CHART FOR SPACING AND

4" CONCRETE SLAB

W/ FIBER REINFORCING

OR WELDED WIRE FABRIC

6 MIL. VAPOR-

BARRIER

4" WASHED STONE

UNDISTURBED EARTH,

COMPACTED FILL

2 x 4 TRTD. BOTTOM PLATE(S)-

SECURED BY 1/2" DIA. BOLTS.

SEE CHART FOR SPACING AND

4" CONCRETE SLAB

W/ FIBER REINFORCING

OR WELDED WIRE FABRIC

6 MIL. VAPOR— BARRIER

4" WASHED STONE-

UNDISTURBED EARTH

COMPACTED FILL OR WASHED STONE

2 x 4 STUD FRAMING (UNO) W/ TRTD.

BOTTOM PLATE(S)

4" CONCRETE-SLAB W/ FIBER REINFORCING

4" WASHED STONE-


UNDISTURBED EARTH,-

COMPACTED FILL
OR WASHED STONE


EMBEDMENT REQUIREMENTS

OR WASHED STONE

EMBEDMENT REQUIREMENTS

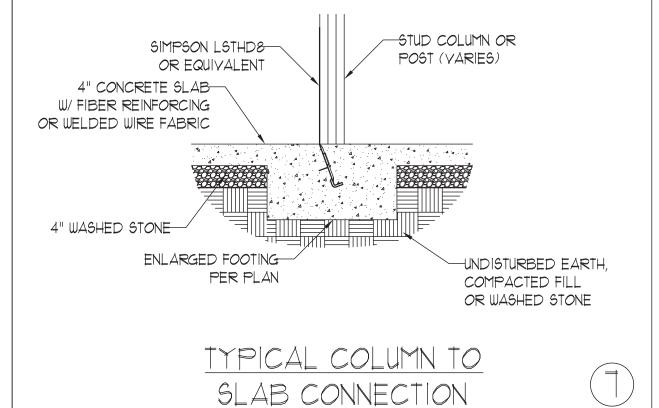

 -2×4 STUD FRAMING (UNO) W/ TRTD. BOTTOM PLATE(S) BRICK TIES @ 1'-4" VERTICALLY AND 2'-6" HORIZONTALLY 4" BRICK VENEER FLASHING -WEEP HOLES ∕−5" LEDGE -FINISHED GRADE

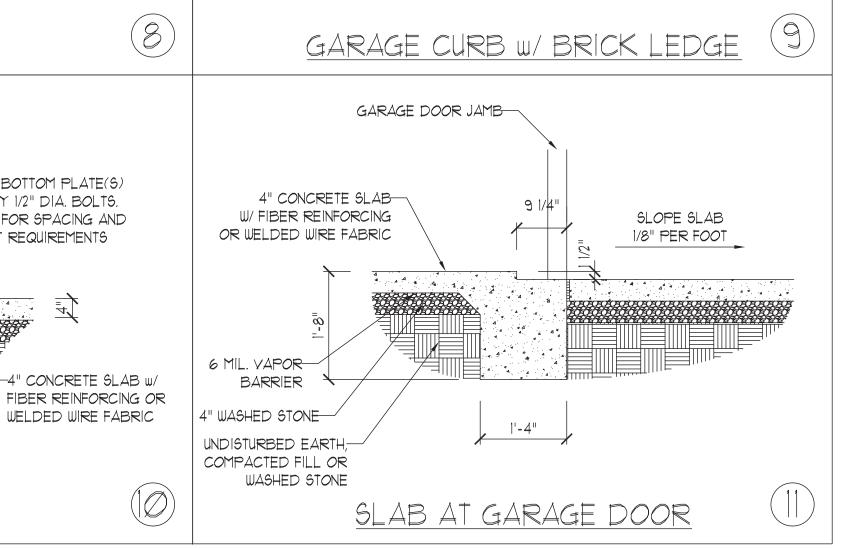

1'-4"

	Z:\CAD Drawings\JST-ENG CAD\A&G Residential\Details\Alternative monoslab turned down detail_2-22.dwg, 2/8/2022 9:48:49 AM, Cra	aig Amos
	THE SLAB FOUNDATION CONSTRUCTED IN THIS	Z O Z
HOUSE SLAB	METHOD WILL PROVIDE THE REQUIRED SUPPORT FOR ALL APPLIED LOADS. - EXPANSION JOINT - GARAGE SLAB	J.S.THOMPS ENGINEERING, 1013 WARE ASSESSED AND ENGINEERS
SEE DETAIL (10) ON MONOLITHIC SLAB DETAILS FOR WALL ANCHORAGE, SUBGRADE, AND VAPOR BARRIER REQUIREMENTS.	4 8	DETAIL
		ALTERNATIVE MONOLITHIC SLAB DETAIL A & G RESIDENTIAL
	BAT GARAGE / HOUSE	ALTERNATIVE A 6
FOUNDATION WALLS BETWEEN GARAGE AND HOUSE MAY BE CONSTRUCTED IN THIS ALTERNATIVE TURNED DOWN METHOD I.L.O. DETAIL IN APPROVED	SEAL 33736 VGINEELO MARKET OF THE PARTY OF	DATE PROBLEMY ALVEST SCALE AND FOR THE SCALE AND FOR THE SCALE AND FOR THE SCALE AND T
PLAN SET ENGINEERED BY J.S. THOMPSON ENGINEERING, INC.	2/8/2022	FOUNDATION DETAIL

5/17/2022

	ANCHOR SPACING AND EMBEDMENT		
WIND ZONE	120 MPH	130 MPH	
SPACING	6'-0" O.C. INSTALL MIN. (2) ANCHORS PER PLATE SECTION AND (1) ANCHOR WITHIN 12" OF CORNERS	4'-0" O.C. INSTALL MIN. (2) ANCHORS PER PLATE SECTION AND (1) ANCHOR WITHIN 12" OF CORNERS	
EMBEDMENT	7"	15" INTO MASONRY 7" INTO CONCRETE	

NOTE: THREADED ROD WITH EPOXY, SIMPSON TITEN HD, OR APPROVED ANCHORS SPACED AS REQUIRED TO PROVIDE EQUIVALENT ANCHORAGE TO 1/2" DIAMETER ANCHOR BOLTS MAY BE USED IN LIEU OF 1/2" ANCHOR BOLTS.

This sealed page is to be used in conjunction with a full plan set engineered by J.S. Thompson Engineering, Inc. only. Use of this individual sealed page within architectural pages or shop drawings by others is a punishable offense under N.C. Statute § 89C-23

SLAB ETAIL MONOLITHIC FOUNDATION D

DATE: NOVEMBER 1, 2018 SCALE: NTS DRAWN BY: JST ENGINEERED BY: JST

> FOUNDATION DETAILS

ES

DRAWN BY: JST

DATE: MAY 18, 2020

SCALE: 1/4" = 1'-0"

ENGINEERED BY: JST

BRACED WALL NOTES AND DETAILS AND PF DETAIL

GENERAL WALL BRACING NOTES

WALL BRACING DESIGNED IN ACCORDANCE WITH CHAPTER 6 OF THE 2018 NC RESIDENTIAL BUILDING CODE (NCRC). TABLES AND FIGURES REFERENCED ARE FROM THE 2018 NCRC. SEE THIS SHEET FOR GENERAL DETAILS. REFER TO THE 2018 NCRC FOR ADDITIONAL INFORMATION AS NEEDED BRACED EXTERIOR WALLS SUPPORTING ROOF TRUSSES AND RAFTERS, INCLUDING STORIES BELOW THE TOP FLOOR, HAVE

AND SHEAR FORCES IN ACCORDANCE WITH ACCEPTED ENGINEERED PRACTICE. SEE STRUCTURAL SHEETS FOR BRACED WALL LOCATIONS, DIMENSIONS, HOLD DOWN TYPE AND LOCATIONS, BRACED WALL LINE KEY WITH WALL DESIGN SUMMARY OF REQUIRED/PROVIDED TOTALS FOR EACH WALL LINE AND ANY SPECIAL NOTES OR REQUIREMENTS.

BEEN DESIGNED PER R602.3.5 (3). WALL SHEATHING AND FASTENERS HAVE BEEN DESIGNED TO RESIST COMBINED UPLIFT


5. ALL EXTERIOR WALLS ARE TO BE SHEATHED WITH CS-WSP IN ACCORDANCE WITH SECTION R602.10.3 UNLESS NOTED


6. ALL EXTERIOR AND INTERIOR WALLS TO HAVE 1/2" GYPSUM INSTALLED. WHEN NOT USING METHOD "GB", GYPSUM TO BE FASTENED PER TABLE R102.3.5. METHOD GB TO BE FASTENED PER TABLE R602.10.1


CS-WSP REFERS TO THE "CONTINUOUS SHEATHING - WOOD STRUCTURAL PANELS" WALL BRACING METHOD. 1/16" OSB SHEATHING IS TO BE INSTALLED ON ALL EXTERIOR WALLS ATTACHED W/6d COMMON NAILS OR 8d (2 1/2" LONG x Ø.113" DIAMETER) NAILS SPACED 6" O.C. ALONG PANEL EDGES AND 12" O.C. IN THE FIELD (U.N.O.,


GB REFERS TO THE "GYPSUM BOARD" WALL BRACING METHOD. 1/2" (MIN.) GYPSUM WALL BOARD IS TO BE INSTALLED ON BOTH SIDES OF THE BRACED WALL FASTENED WITH 1 1/4" SCREWS OR 1 5/8" NAILS SPACED 1" O.C. ALONG PANEL EDGES INCLUDING TOP AND BOTTOM PLATES AND INTERMEDIATE SUPPORTS (U.N.O.). VERIFY ALL FASTENER OPTIONS FOR 1/2" AND 5/8" GYPSUM PRIOR TO CONSTRUCTION. FOR INTERIOR FASTENER OPTIONS SEE TABLE R7/02.3.5. FOR EXTERIOR FASTENER OPTIONS SEE TABLE R602.3(1). EXTERIOR GB TO BE INSTALLED VERTICALLY.


REQUIRED BRACED WALL LENGTH FOR EACH SIDE OF THE CIRCUMSCRIBED RECTANGLE ARE INTERPOLATED PER TABLE R602. 10.3. METHOD CS-WSP CONTRIBUTES ITS ACTUAL LENGTH, METHOD GB CONTRIBUTES .5 ITS ACTUAL LENGTH, AND METHOD PF CONTRIBUTES 1.5 TIMES ITS ACTUAL LENGTH.

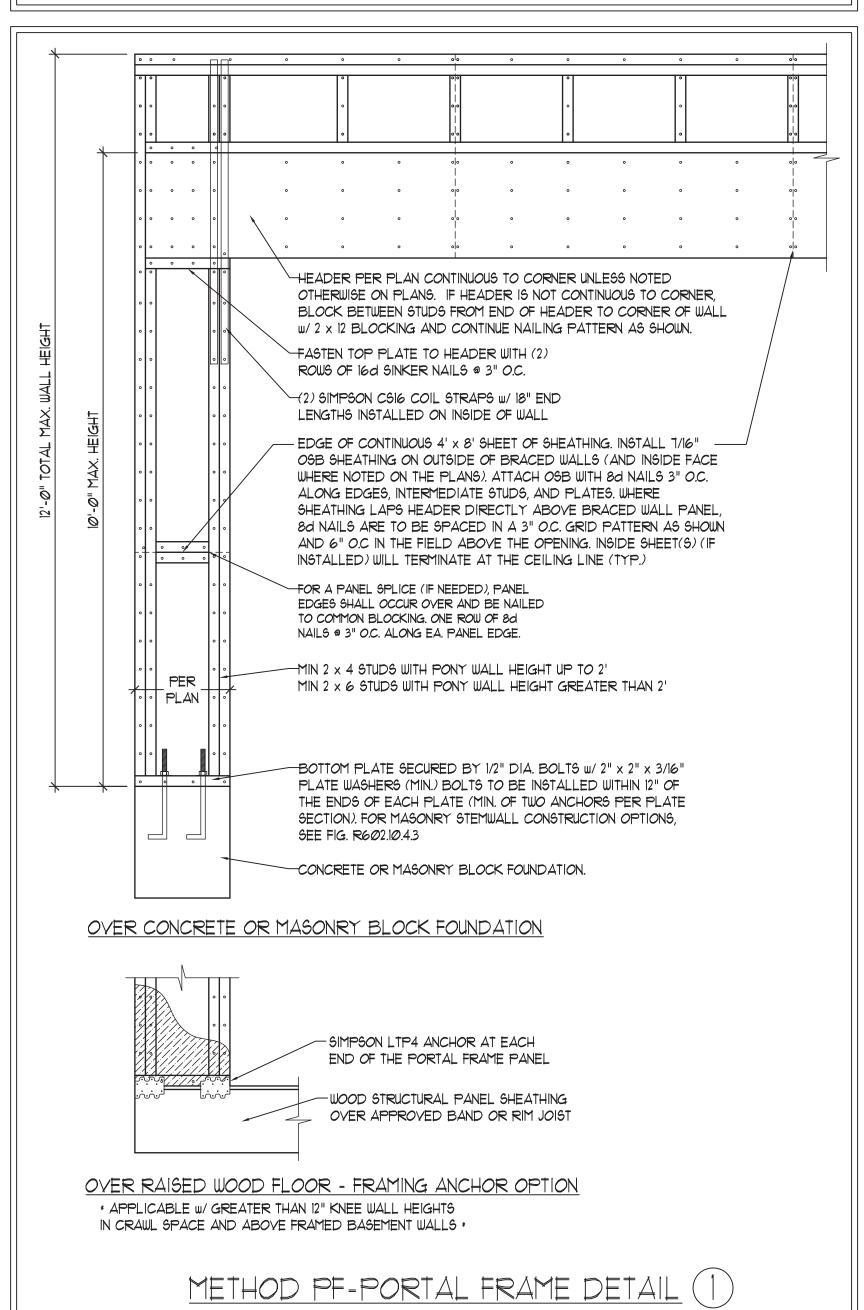


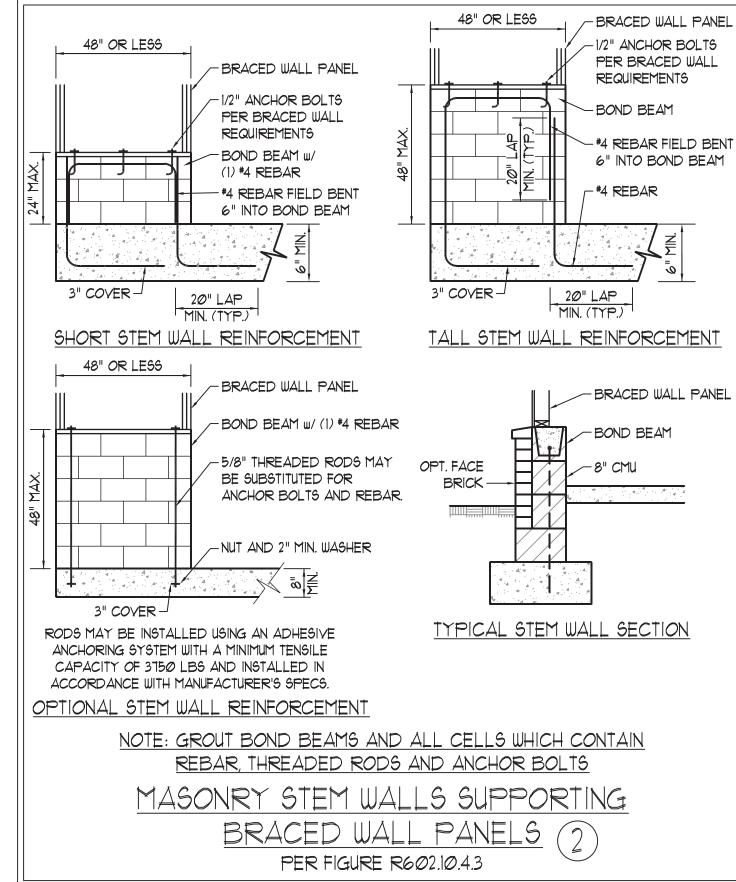

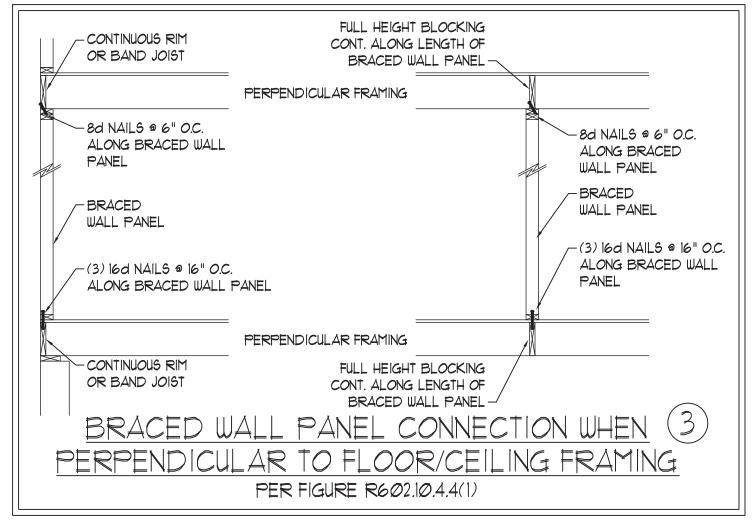

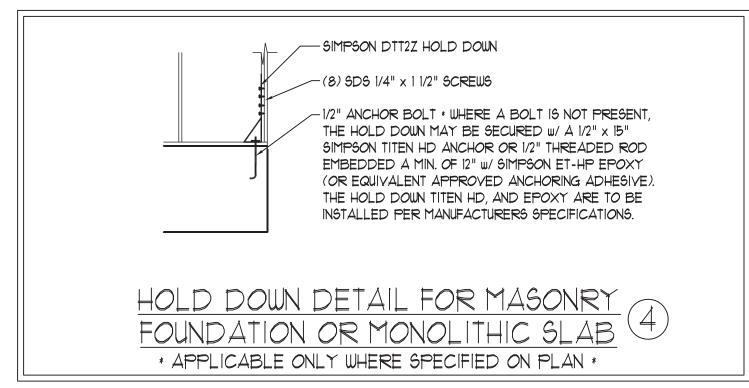

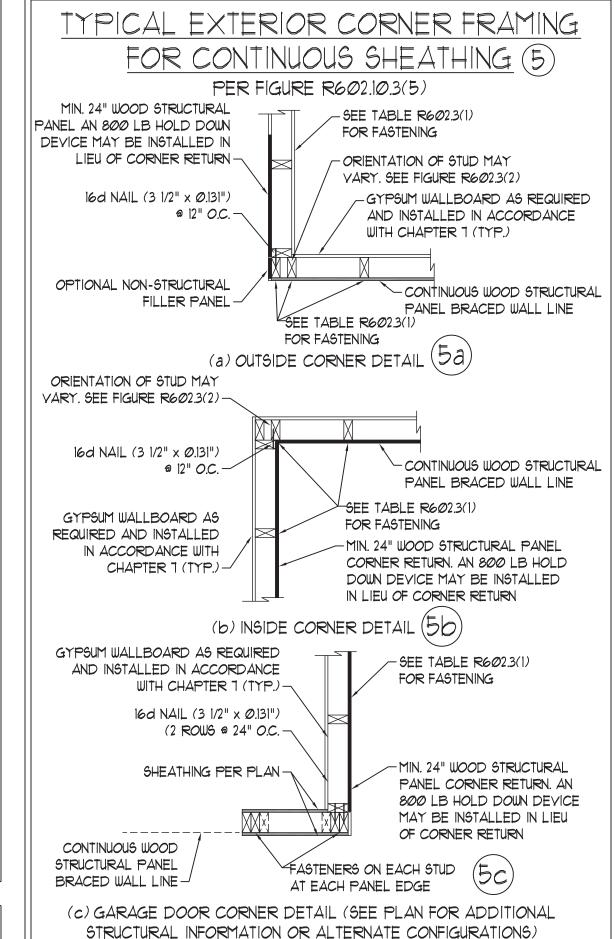

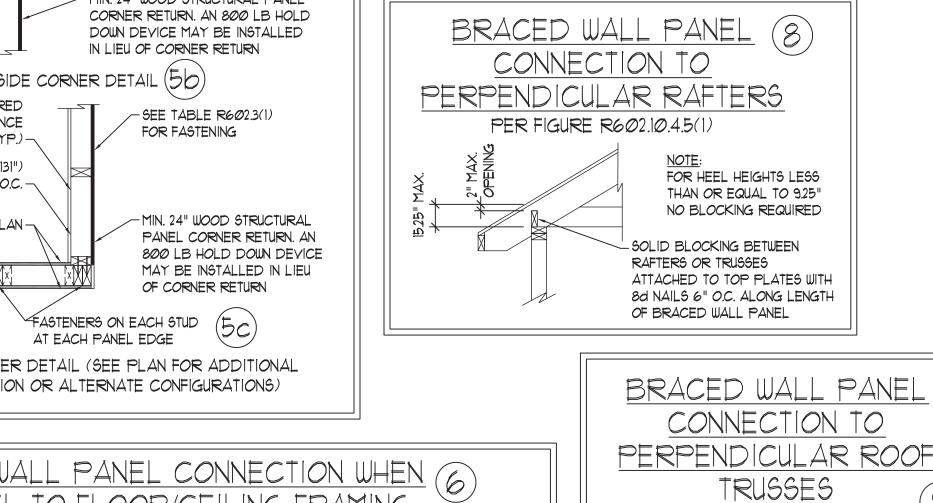

KING STUDS BETWEEN GARAGE

VERTICAL STRAPS PER

PORTAL FRAME DETAIL-

HEADERS PER PLAN-

 \pm pony wall per

PORTAL FRAME

-GARAGE HEADER

PER PLAN

(2) 5'-LONG SIMPSON CSI6

HEADERS TOGETHER

HEADERS PER PLAN

BETWEEN GARAGE DOOR HEADERS

(REFERENCE PORTAL FRAME DETAIL FOR ALL OTHER PORTAI

FRAME INFORMATION)

- JACK STUDS SUPPORTING

STRAPS TOP AND BOTTOM ON

INSIDE FACE OF BEAM TO TIE

PER FIGURE R602.10.4.5(3)

6'-0" MAX.

2 x BLOCKING

NAILING PER

SEAL

33736


5/17/2022


TABLE

R602.3(1)

GRADE AND

DETAIL

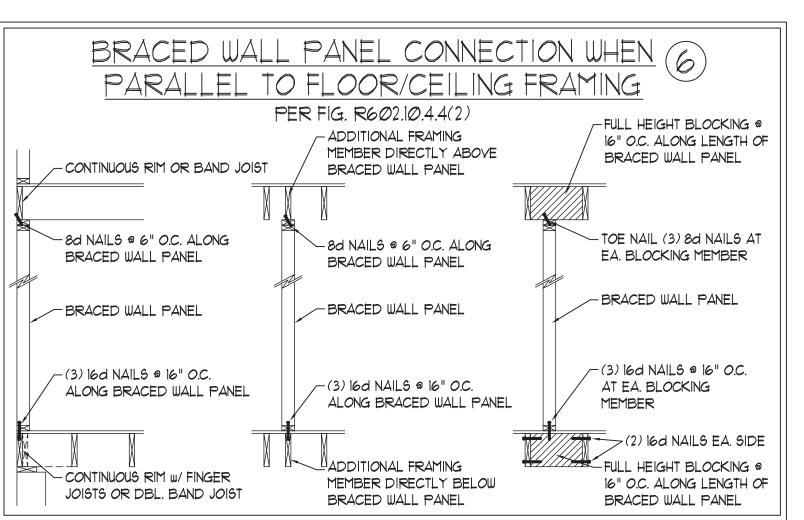

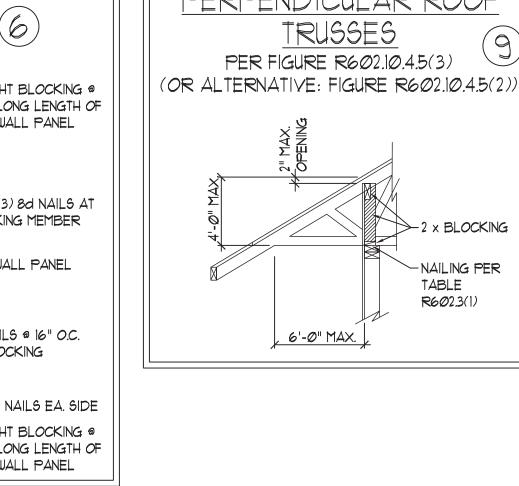

This sealed page is to be used in conjunction with a full plan set engineered by J.S. Thompson Engineering, Inc. only. Use of this individual sealed page within architectural pages or shop drawings by others is a punishable offense under N.C. Statute § 89C-23

GENERAL NOTES

- ENGINEER'S SEAL APPLIES ONLY TO STRUCTURAL COMPONENTS INCLUDING ROOF RAFTERS, HIPS, VALLEYS, RIDGES, FLOORS, WALLS, BEAMS, HEADERS, COLUMNS, CANTILEVERS, OFFSET LOAD BEARING WALLS, PIERS, GIRDER SYSTEM AND FOOTING. ENGINEER'S SEAL DOES NOT CERTIFY DIMENSIONAL ACCURACY OF ARCHITECTURAL LAYOUT INCLUDING ROOF. ENGINEER'S SEAL DOES NOT APPLY TO 1-JOIST OR FLOOR/ROOF TRUSS LAYOUT DESIGN AND ACCURACY.
- 2. ALL CONSTRUCTION SHALL CONFORM TO THE LATEST REQUIREMENTS OF THE NORTH CAROLINA RESIDENTIAL CODE (NCRC), 2018 EDITION, PLUS ALL LOCAL CODES AND REGULATIONS. THE STRUCTURAL ENGINEER IS NOT RESPONSIBLE FOR, AND WILL NOT HAVE CONTROL OF, CONSTRUCTION MEANS, METHODS, TECHNIQUES, SEQUENCES OR PROCEDURES, OR SAFETY PRECAUTIONS AND PROGRAMS IN CONNECTION WITH THE CONSTRUCTION WORK. NOR WILL THE ENGINEER BE RESPONSIBLE FOR THE CONTRACTORS FAILURE TO CARRY OUT THE CONSTRUCTION WORK IN ACCORDANCE WITH THE CONTRACT DOCUMENTS.
- 3. STRUCTURAL DESIGN BASED ON THE PROVISIONS OF THE NCRC, 2018 EDITION (R301.4 R301.7)

DESIGN CRITERIA:	LIVE LOAD (PSF)	DEAD LOAD (PSF)	DEFLECTION (IN)
ATTIC WITH LIMITED STORAGE	20	10	L/240 (L/360 w/ BRITTLE FINISHES)
ATTIC WITHOUT STORAGE	10	10	L/36Ø
DECK5	40	10	L/360
EXTERIOR BALCONIES	40	10	L/360
FIRE ESCAPES	40	10	L/360
HANDRAILS/GUARDRAILS	200 LB OR 50 (PLF)	10	L/360
PASSENGER VEHICLE GARAGE	50	10	L/360
ROOMS OTHER THAN SLEEPING ROOM	40	10	L/360
SLEEPING ROOMS	3Ø	10	L/360
STAIRS	40	10	L/360
WIND LOAD	(BASED ON TABLE R3Ø1.2(4) WIND ZONE AND EXPOSURE)		
GROUND SNOW LOAD: Pg	20 (PSF)		

- I-JOIST SYSTEMS DESIGNED WITH 12 PSF DEAD LOAD AND DEFLECTION (IN) OF L/480 - FLOOR TRUSS SYSTEMS DESIGNED WITH 15 PSF DEAD LOAD

- 4. FOR 115 AND 120 MPH WIND ZONES, FOUNDATION ANCHORAGE 15 TO COMPLY WITH SECTION R403.1.6 OF THE NCRC, 2018 EDITION. FOR 130 MPH, 140 MPH, AND 150 MPH WIND ZONES, FOUNDATION ANCHORAGE IS TO COMPLY WITH SECTION 4504 OF THE NCRC, 2018 EDITION.
- 5. ENERGY EFFICIENCY COMPLIANCE AND INSULATION VALUES OF THE BUILDING TO BE IN ACCORDANCE WITH CHAPTER II OF THE NCRC, 2018 EDITION.

FOOTING AND FOUNDATION NOTES

- 1. FOUNDATION DESIGN BASED ON A MINIMUM ALLOWABLE BEARING CAPACITY OF 2000 PSF. CONTACT GEOTECHNICAL ENGINEER IF BEARING CAPACITY IS NOT ACHIEVED.
- 2. FOR ALL CONCRETE SLABS AND FOOTINGS, THE AREA WITHIN THE PERIMETER OF THE BUILDING ENVELOPE SHALL HAVE ALL VEGETATION, TOP SOIL AND FOREIGN MATERIAL REMOVED. FILL MATERIAL SHALL BE FREE OF VEGETATION AND FOREIGN MATERIAL. THE FILL SHALL BE COMPACTED TO ASSURE UNIFORM SUPPORT OF THE SLAB, AND EXCEPT WHERE APPROVED, THE FILL DEPTHS SHALL NOT EXCEED 24" FOR CLEAN SAND OR GRAVEL. A 4" THICK BASED COURSE CONSISTING OF CLEAN GRADED SAND OR GRAVEL SHALL BE PLACED. A BASE COURSE IS NOT REQUIRED WHERE A CONCRETE SLAB IS INSTALLED ON WELL-DRAINED OR SAND-GRAVEL MIXTURE SOILS CLASSIFIED AS GROUP I, ACCORDING TO THE UNITED SOIL CLASSIFICATION SYSTEM IN ACCORDANCE WITH TABLE R405.1 OF THE NCRC, 2018 EDITION.
- 3. PROPERLY DEWATER EXCAVATION PRIOR TO POURING CONCRETE WHEN BOTTOM OF CONCRETE SLAB IS AT OR BELOW WATER TABLE. IF APPLICABLE, 3/4" - 1" DEEP CONTROL JOINTS ARE TO BE SAWED WITHIN 4 TO 12 HOURS OF CONCRETE FINISHING AND WALL LOCATIONS HAVE BEEN MARKED. ADJUST WHERE NECESSARY.
- 4. CONCRETE SHALL CONFORM TO SECTION R402.2 OF THE NCRC, 2018 EDITION, CONCRETE REINFORCING STEEL TO BE ASTM A615 GRADE 60. WELDED WIRE FABRIC TO BE ASTM A185. MAINTAIN A MINIMUM CONCRETE COVER AROUND REINFORCING STEEL OF 3" IN FOOTINGS AND 1 1/2" IN SLABS. FOR POURED CONCRETE WALLS, CONCRETE COVER FOR REINFORCING STEEL MEASURED FROM THE INSIDE FACE OF THE WALL SHALL NOT BE LESS THAN 3/4". CONCRETE COVER FOR REINFORCING STEEL MEASURED FROM THE OUTSIDE FACE OF THE WALL SHALL NOT BE LESS THAN 1 1/2" FOR #5 BARS OR SMALLER, AND NOT LESS THAN 2" FOR #6 BARS OR LARGER.
- 5. MASONRY UNITS TO CONFORM TO ACE 530/ASCE 5/TMS 402. MORTAR SHALL COMFORM TO ASTM C270.
- 6. THE UNSUPPORTED HEIGHT OF MASONRY PIERS SHALL NOT EXCEED FOUR TIMES THEIR LEAST DIMENSION FOR UNFILLED HOLLOW CONCRETE MASONRY UNITS AND TEN TIMES THEIR LEAST DIMENSION FOR SOLID OR SOLID FILLED PIERS. PERS MAY BE FILLED SOLID WITH CONCRETE OR TYPE M OR 5 MORTAR PIERS AND WALLS SHALL BE CAPPED WITH 8" OF SOLID MASONRY
- 1. THE CENTER OF EACH OF THE PIERS SHALL BEAR IN THE MIDDLE THIRD OF IT'S RESPECTIVE FOOTING. EACH GIRDER SHALL BEAR IN THE MIDDLE THIRD OF THE PIERS.
- 8. ALL CONCRETE AND MASONRY FOUNDATION WALLS ARE TO BE CONSTRUCTED IN ACCORDANCE WITH THE PROVISIONS OF SECTION R404 OF THE NCRC, 2018 EDITION OR IN ACCORDANCE WITH ACI 318, ACI 332, NCMA TR68-A OR ACE 530/ASCE 5/TMS 402. MASONRY FOUNDATION WALLS ARE TO BE REINFORCED PER TABLE R404.1.1(1), R404.1.1(2), R404.1.1(3), OR R404.1.1(4) OF THE NCRC, 2018 EDITION. CONCRETE FOUNDATION WALLS ARE TO BE REINFORCED PER TABLE R404.1.1(5) OF THE NCRC, 2018 EDITION. STEP CONCRETE FOUNDATION WALLS TO 2 x 6 FRAMED WALLS AT 16" O.C. WHERE GRADE PERMITS (UNO).

This sealed page is to be used in conjunction with a full plan set engineered by J.S. Thompson Engineering, Inc. only. Use of this individual sealed page within architectural pages or shop drawings by others is a punishable offense under N.C. Statute § 89C-23

FRAMING NOTES

- 1. ALL FRAMING LUMBER SHALL BE #2 SPF MINIMUM (Fb = 875 PS1, Fv = 375 PS1, E = 1600000 PS1) UNLESS NOTED OTHERWISE (UNO). ALL TREATED LUMBER SHALL BE #2 SYP MINIMUM (Fb = 975 PSI, Fv = 175 PSI, E = 1600000 PSI) UNLESS NOTED OTHERWISE (UNO).
- LAMINATED VENEER LUMBER (LVL) SHALL HAVE THE FOLLOWING MINIMUM PROPERTIES: Fb =2600 PSI, Fv = 285 PSI, E = 1900000 PSI. LAMINATED STRAND LUMBER (LSL) SHALL HAVE THE FOLLOWING MINIMUM PROPERTIES: Fb = 2325 PSI, Fv = 310 PSI, E = 1550000 PSI, PARALLEL STRAND LUMBER (PSL) UP TO 1" DEPTH SHALL HAVE THE FOLLOWING MINIMUM PROPERTIES: Fc = 2500 PSI, E = 1800000 PSI. PARALLEL STRAND LUMBER (PSL) MORE THAN 1" DEPTH SHALL HAVE THE FOLLOWING MINIMUM PROPERTIES: Fc = 2900 PSI, E = 20000000 PSI. INSTALL ALL CONNECTIONS PER MANUFACTURER'S SPECIFICATIONS.
- 3. STRUCTURAL STEEL SHALL CONFORM TO THE FOLLOWING ASTM SPECIFICATIONS

W AND WT SHAPES: ASTM A992 CHANNELS AND ANGLES: ASTM A36 ASTM A36 PLATES AND BARS: HOLLOW STRUCTURAL SECTIONS: ASTM A500 GRADE B ASTM A53, GRADE B, TYPE E OR S E. STEEL PIPE:

4. STEEL BEAMS SHALL BE SUPPORTED AT EACH END WITH A MINIMUM BEARING LENGTH OF 3 1/2" AND FULL FLANGE WIDTH (UNO). PROVIDE SOLID BEARING FROM BEAM SUPPORT TO FOUNDATION. BEAMS SHALL BE ATTACHED AT THE BOTTOM FLANGE TO EACH SUPPORT AS FOLLOWS (UNO):

A. WOOD FRAMING (2) 1/2" DIA. x 4" LONG LAG SCREWS B. CONCRETE (2) 1/2" DIA. x 4" WEDGE ANCHORS C. MASONRY (FULLY GROUTED) (2) 1/2" DIA. x 4" LONG SIMPSON TITEN HD ANCHORS

LATERAL SUPPORT IS CONSIDERED ADEQUATE PROVIDING THE JOISTS ARE TOE NAILED TO THE 2x NAILER ON TOP OF THE STEEL BEAM, AND THE 2x NAILER IS SECURED TO THE TOP OF THE STEEL BEAM w/ (2) ROWS OF SELF TAPPING SCREWS @ 16" O.C. OR (2) ROWS OF 1/2" DIAMETER BOLTS @ 16" O.C. IF 1/2" BOLTS ARE USED TO FASTEN THE NAILER, THE STEEL BEAM SHALL BE FABRICATED W/ (2) ROWS OF 9/16" DIAMETER HOLES @ 16" O.C.

- 5. SQUARES DENOTE POINT LOADS WHICH REQUIRE SOLID BLOCKING TO GIRDER OR FOUNDATION, SHADED SQUARES DENOTE POINT LOADS FROM ABOVE WHICH REQUIRE SOLID BLOCKING TO SUPPORTING MEMBER BELOW.
- 6. ALL LOAD BEARING HEADERS TO CONFORM TO TABLE R602.7(1) AND R602.7(2) OF THE NCRC, 2018 EDITION OR BE (2) 2 x 6 WITH (1) JACK AND (1) KING STUD EACH END (UNO), WHICHEVER IS GREATER ALL HEADERS TO BE SECURED TO EACH JACK STUD WITH (4) 8d NAILS. ALL BEAMS TO BE SUPPORTED WITH (2) STUDS AT EACH BEARING POINT (UNO). INSTALL KING STUDS PER SECTION R602.7.5 OF THE NORTH CAROLINA RESIDENTIAL CODE, 2018 EDITION.
- 1. ALL BEAMS, HEADERS, OR GIRDER TRUSSES PARALLEL TO WALL ARE TO BEAR FULLY ON (1) JACK OR (2) STUDS MINIMUM OR THE NUMBER OF JACKS OR STUDS NOTED. ALL BEAMS OR GIRDER TRUSSES PERPENDICULAR TO WALL AND SUPPORTED BY (3) STUDS OR LESS ARE TO HAVE 1 1/2" MINIMUM BEARING (UNO). ALL BEAMS OR GIRDER TRUSSES PERPENDICULAR TO WALL AND SUPPORTED BY MORE THAN (3) STUDS OR OTHER NOTED COLUMN ARE TO BEAR FULLY ON SUPPORT COLUMN FOR ENTIRE WALL DEPTH (UNO). BEAM ENDS THAT BUTT INTO ONE ANOTHER ARE TO EACH BEAR EQUAL LENGTHS (UNO).
- 8. FLITCH BEAMS SHALL BE BOLTED TOGETHER USING 1/2" DIAMETER BOLTS (ASTM A3ØT) WITH WASHERS PLACED AT THREADED END OF BOLT. BOLTS SHALL BE SPACED AT 24" CENTERS (MAXIMUM), AND STAGGERED AT TOP AND BOTTOM OF BEAM (2" EDGE DISTANCE), WITH (2) BOLTS LOCATED AT 6" FROM EACH END (UNO).
- 9. ALL 1-JOIST OR TRUSS LAYOUTS ARE TO BE IN COMPLIANCE WITH THE OVERALL DESIGN SPECIFIED ON THE PLANS. ALL DEVIATIONS ARE TO BE BROUGHT TO THE ATTENTION OF THE ENGINEER OF RECORD PRIOR TO INSTALLATION.
- 10. BRACED WALL PANELS SHALL BE CONSTRUCTED ACCORDING TO THE NORTH CAROLINA RESIDENTIAL CODE 2018 EDITION WALL BRACING CRITERIA. THE AMOUNT, LENGTH, AND LOCATION OF BRACING SHALL COMPLY WITH ALL APPLICABLE TABLES IN SECTION R602.10.
- 11. PROVIDE DOUBLE JOIST UNDER ALL WALLS PARALLEL TO FLOOR JOISTS. PROVIDE SUPPORT UNDER ALL WALLS PARALLEL TO FLOOR TRUSSES OR 1-JOISTS PER MANUFACTURER'S SPECIFICATIONS. INSTALL BLOCKING BETWEEN JOISTS OR TRUSSES FOR POINT LOAD SUPPORT FOR ALL POINT LOADS ALONG OFFSET LOAD LINES.
- 12. FOR ALL HEADERS SUPPORTING BRICK VENEER THAT ARE LESS THAN 8'-0" IN LENGTH, REST A 6" x 4" x 5/16" STEEL ANGLE WITH 6" MINIMUM EMBEDMENT AT SIDES FOR BRICK SUPPORT (UN.O.). FOR ALL HEADERS 8'-Ø" AND GREATER IN LENGTH, BOLT A 6" x 4" x 5/16" STEEL ANGLE TO HEADER WITH 1/2" LAG. SCREWS AT 12" O.C. STAGGERED FOR BRICK SUPPORT. FOR ALL BRICK SUPPORT AT ROOF LINES, BOLT A 6" x 4" x 5/16" STEEL ANGLE TO (2) 2 x 10 BLOCKING INSTALLED w/ (4) 12d NAILS EA. PLY BETWEEN WALL STUDS WITH (2) ROWS OF 1/2" LAG SCREWS AT 12" O.C. STAGGERED AND IN ACCORDANCE WITH SECTION RT103.8.2.1 OF THE NCRC, 2018 EDITION.
- 13. FOR STICK FRAMED ROOFS: CIRCLES DENOTE (3) 2 x 4 POSTS FOR ROOF MEMBER SUPPORT. HIP SPLICES ARE TO BE SPACED A MINIMUM OF 8'-0". FASTEN MEMBERS WITH THREE ROWS OF 12d NAILS AT 16" O.C. FRAME DORMER WALLS ON TOP OF DOUBLE OR TRIPLE RAFTERS AS SHOWN (UNO).
- 14. FOR TRUSSED ROOFS: FRAME DORMER WALLS ON TOP OF 2 x 4 LADDER FRAMING AT 24" O.C. BETWEEN ADJACENT ROOF TRUSSES. STICK FRAME OVER-FRAMED ROOF SECTIONS WITH 2 x 8 RIDGES, 2 x 6 RAFTERS AT 16" O.C. AND FLAT 2 x 10 YALLEYS (UNO).
- 15. ALL 4 x 4 AND 6 x 6 POSTS TO BE INSTALLED WITH 100 LB CAPACITY UPLIFT CONNECTORS TOP AND BOTTOM (UNO.) POSTS MAY BE SECURED USING ONE SIMPSON HE OR LTS12 UPLIFT CONNECTOR FASTENED TO THE BAND AT THE BOTTOM AND THE BEAM AT THE TOP OF EACH POST. ONE 16" SECTION OF SIMPSON CS16 COIL STRAPPING WITH (8) 8d HDG NAILS AT EACH END MAY BE USED IN LIEU OF EACH TWIST STRAP IF DESIRED. FOR MASONRY OR CONCRETE FOUNDATION USE SIMPSON POST BASE.



DATE: OCTOBER 29, 2018

SCALE: 1/4" = 1'-0"

DRAWN BY: JES

ENGINEERED BY: JST

STRUCTURAL NOTES

33736 5/17/2022