DATE:

SHEET:


A-1



FRONT ELEVATION

Scale: 1/4" = 1'0"

9'0" CEILING HEIGHT FIRST FLOOR 7'6" Header Height 1st Floor 8'0" CEILING HEIGHT SECOND FLOOR 7'0" Header height 2nd Floor FRAME WINDOWS TO HEADER HEIGHT

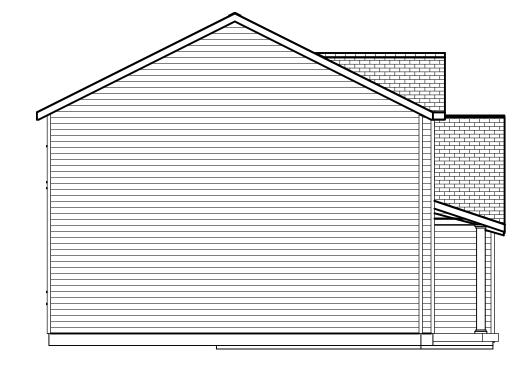

LEFT ELEVATION

Scale: 1/8" = 1'0"




REAR ELEVATION

Scale: 1/8" = 1'0"



RIGHT ELEVATION

Scale: 1/8" = 1'0"

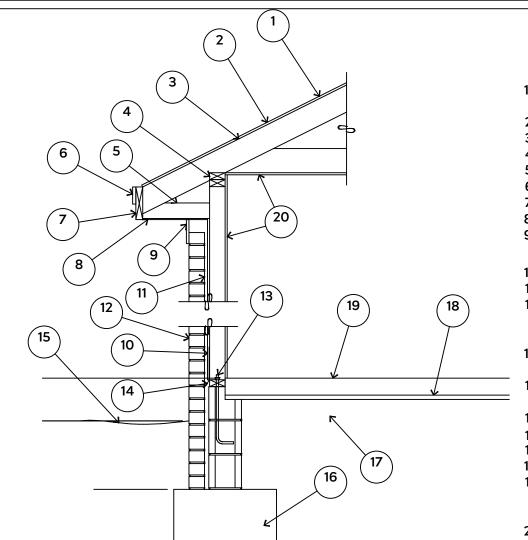

1. 15# FELT UNDERLAYMENT UNDER COMPOSITION SHINGLES.

2. ROOF DECKING.

3. 2 X RAFTERS / ENGINEERED TRUSSES

DOUBLE TOP PLATE. 2 X 4 RETURN.

3/4" FASCIA OR PVC TRIM COIL

2 X FASCIA

1/4" PLYWOOD OR VINYL SOFFIT

1X FREIZE BOARD (TO BE USED WITH **BRICK VENEERS)**

10. INSULATION BOARD OR HOUSE WRAP

11. AIR SPACE.

12 BRICK WITH BRICK TIES PER MANUFACTURER'S SPECIFICATIONS.

13. 1/2" X 12" ANCHOR BOLTS, 6'-0" O.C., 12" FROM CORNERS.

14. FLASHING WITH WEEP HOLES @ 48" O.C.

15. FINISHED GRADE.

16. FOOTING

17. COMPACTED EARTH FILL.

18. 6 MIL VAPOR BARRIER

19. 4" CONCRETE SLAB, 3,000 P.S.I. WITH 6" X 6" 10 GA. X 10 GA. WELDED WIRE FABRIC.

20. 1/2" GYPSUM BOARD.

FOUNDATION NOTES:

ALL FOOTINGS SHALL BEAR ON ORIGINAL UNDISTURBED SOIL THE 28 DAY COMPRESSIVE STRENGTH OF ALL **FOOTINGS IS 3000 PSI**

PROVIDE WATER PROOFING AND PERIMTER DRAINS AS REQUIRED

FOOTING WIDTHS ARE BASED ON A LOAD **BEARING SOIL CAPACITY OF 2000 PSI**

PROVIDE 6 MIL POLY VAPOR BARRIER TO COVER GROUND IN CRAWL SPACE AND GROUND UNDER POURED CONCRETE

ALL ANCHOR BOLTS TO BE 1/2" X 12" LONG. ANCHOR BOLTS SHALL BE SPACED AT A MAXIMUM OF 6' ON CENTER AND NO MORE THEN 1' FROM EACH CORNER

INTERIOR WALL -P.T. SILL PLATE 4" CONCRETE SLAB ON 6 MIL VAPOR BARRIER 1/2" DIA. (MIN. 7" EMBEDMENT) ON 4" MIN. COMPACTED BASE ANCHOR BOLTS @ 6' O.C.

GENERAL FRAMING NOTES:

ALL LUMBER IN CONTACT WITH CONCRETE OR MASONRY SHALLE BE PRESSURE TREATED

FRAMING LUMBER SHALL BE SYP #2 GRADE AND / OR SPRUCE PINE FIR #1 AND / OR KILN DRIED

WHERE PRE-ENGINEERED JOISTS AND TRUSSES ARE USED, MANUFACTURER SHALL PROVIDE DRAWINGS / SCHEMATICS, WHICH SHALL BEAR OF A N.C. **ENGINEER**

STUDS AND JOISTS SHALL NOT BE CUT TO INSTALL PLUMBING OR WIRING WITHOUT ADDING METAL OR WOOD SIDE PANELS TO STRENGTHEN MEMBER TO ITS ORIGINAL CAPACITY

NAIL MULTIPLE MEMBERS WITH 2 ROWS OF 16d NAILS STAGGERED 32" O.C. AND USE 3 X 16d NAILS 2" IN AT EACH END.

NAIL FLOOR JOISTS TO SILL PLATE WITH WITH 8d TOE NAILS


ALL EXPOSED FRAMING ON PORCHES OR DECKS SHALL BE PRESSURE TREATED

PROVIDE WATERPROOFING AND DRAINS AS REQUIRED

ALL FRAMING TO BE 16" O.C. WALL FRAMING DIMENSIONS ARE BASED ON 2X4 OR 2X6 EXTERIOR WALLS AND 2X4 INTERIOR WALLS. DOULBE / TRIPLE JACK STUDS AS NECESSARY UNDER HEADERS AS REQUIRED

LVL'S TO BE SIZED BY OTHERS (TRUSS MANUFACTURER)

EXTERIOR WALL SECTION

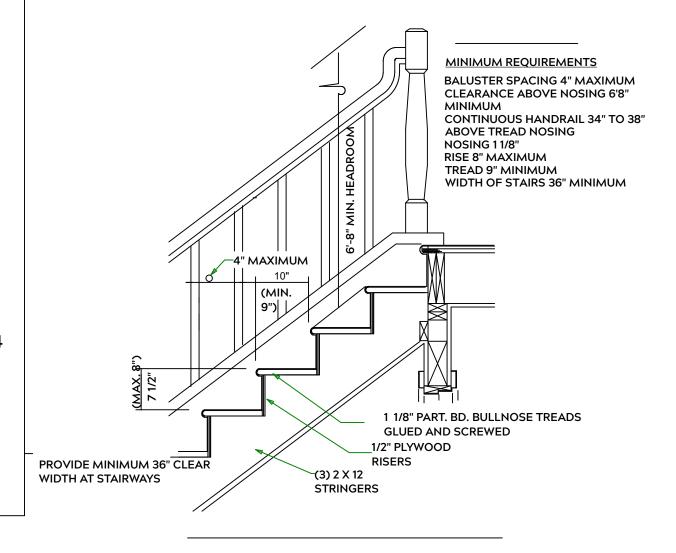

STAIR DETAIL

PLAN: Roark 2.0

SHEETS

Lot 1

PROJECT ADDRESS Liberty Meadows Lot

ecision Custom Ho Raeford, NC recisionCustomHo

DATE:

7/19/22

SCALE: 1/4" = 1'

SHEET:


A-3

LUG FOOTING



1st FLOOR

PROJECT ADDRESS: Liberty Meadows Lot 1

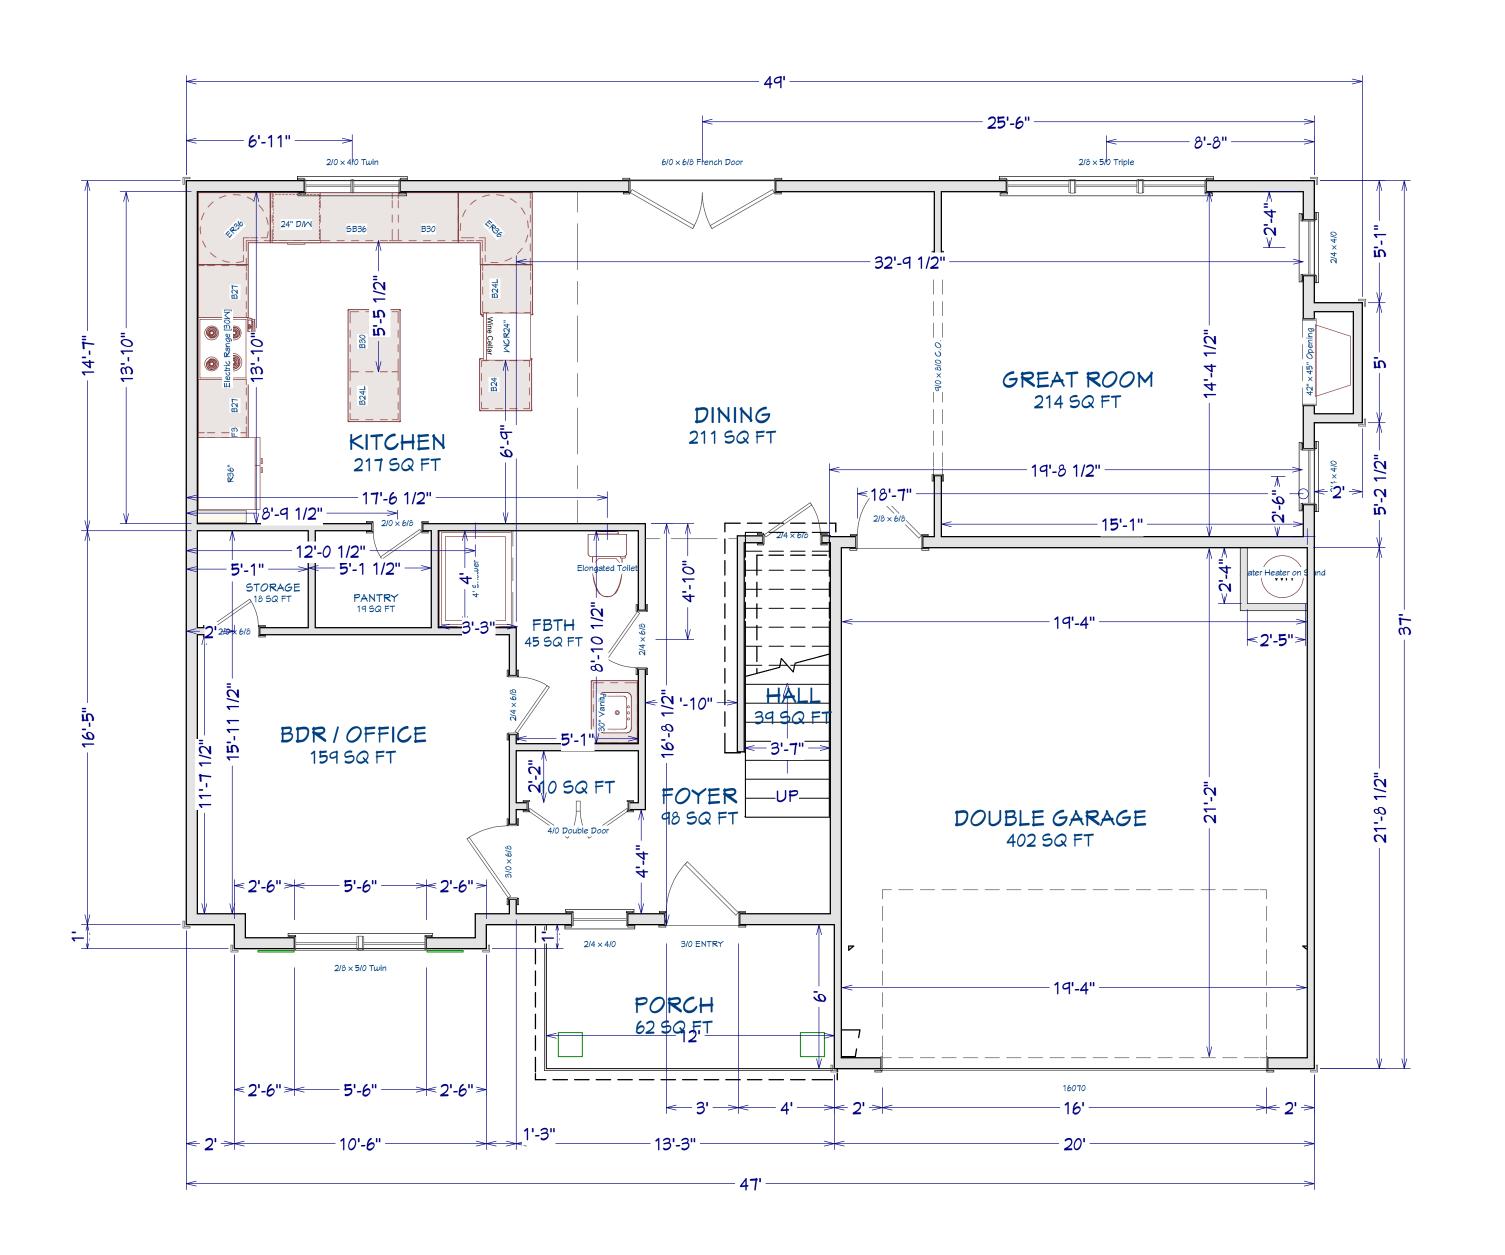

AREA SCHEDULE	
NAME	AREA
1st FLOOR AREA	1,185 SF
2nd FLOOR AREA	1305 SF
GARAGE	418 SF
FRONT PORCH	75 SF
REAR PORCH	120 SF
TOTAL HEATED	2490 SF
TOTAL UNDER ROOF	3103 SF

<u>1st Floor</u> Scale: 1/4" = 1'0" DATE:

Precision Custom Horn Raeford, NC n@PrecisionCustomHom

DESIGNED BY:


7/19/22


SCALE:

1/4" = 1'

SHEET:

A-4

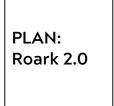

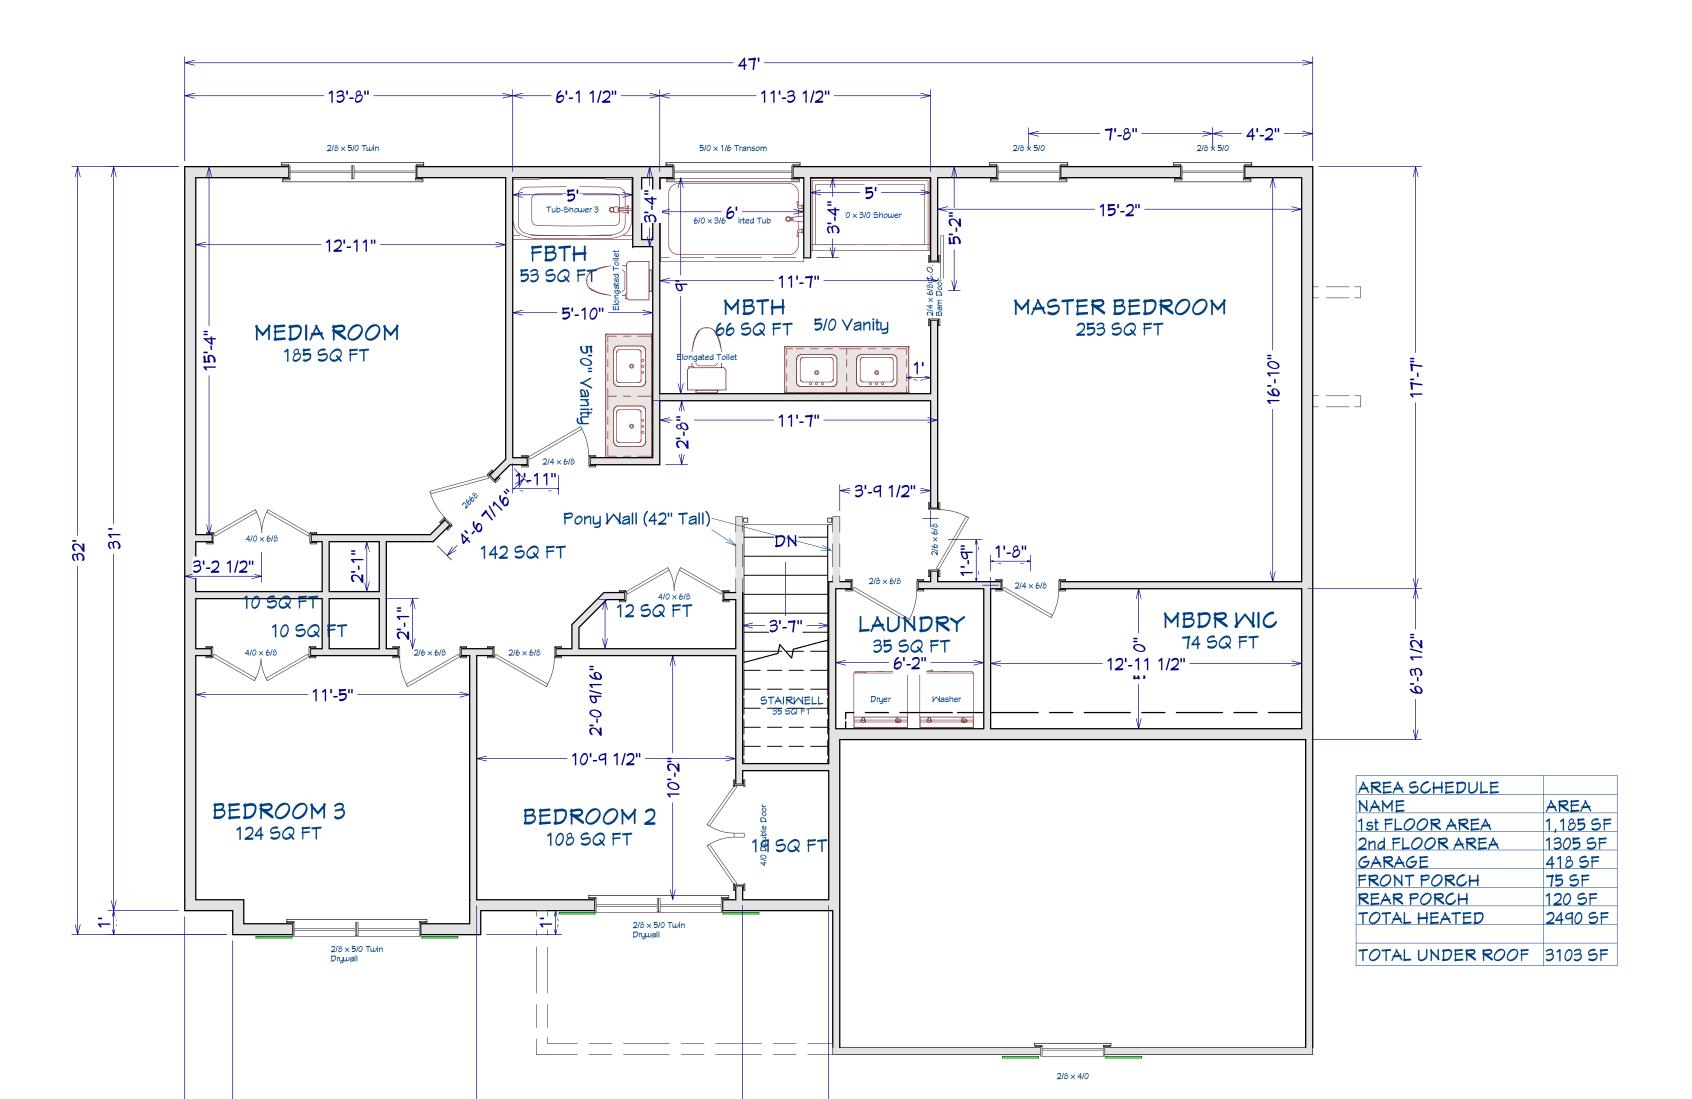

<u>2nd Floor</u> Scale: 1/4" = 1'0"

10'-2"

2nd FLOOR

SHEET TITLE:

PROJECT ADDRESS: Liberty Meadows Lot 1

> Precision Custom Homes Raeford, NC n@PrecisionCustomHomesNC.com

DATE:

7/19/22

SCALE:

SHEET:

1/4" = 1'

A-5