REVISION LOG

REVISION:001

ADJUST OPTION SQUARE FOOTAGES TO ACCURATELY SHOW THE DIFFERENCES FROM THE BASE PLAN SQUARE FOOTAGE TOTALS.

REVISION:002

RELOCATE FRONT DOOR TO ALIGN W/ GARAGE WALL. ADJUST FOUNDATION AND OPTIONS

- ACCORDINGLY.

 2. ADD WALL & DOOR AT FOYER FOR OPTIONAL SMART DOOR DELIVERY CENTER.

 3. NOTE DOOR INTO MAIN HOUSE W/ OPTIONAL SMART DOOR DELIVERY CENTER TO BE 3068 3/4
- LICATION & LICATE BED #4 CLOSET DOOR 5'-0" FROM EXTERIOR WALL.

 5. CHANGE DOOR WIDTH FROM 2/6 TO 2/4 BATH #3, BED #3 CLOSET, BATH #2, BED #2
- CLOSET AND OPT. BED #5.

 6. FUP PANTRY SHELVES, DELETE DOOR ACCESSED FROM DROP ZONE & ADD 2/4 DOOR ACCESSED FROM MESSY XITCHEN.

 7. DIMENSION TO CENTER OF TRIPLE WINDOWS ONLY.

- 8. MAKE ALL STUD POCKETS 4 1/2".
 9. ADD NOTE AT FIREPLACE FOR A "42"X39" R.O." FOR FIREBOX.
 10. RELOCATE WALL UNDER STAR & NOTE @ 56" WALL HT (V.LF.).
 11. ADD GOUMENT KTICHEN, ALTERNATE KITCHEN AND ALTERNATE GOURMET KITCHEN OPTIONS.
 12. DELETE 2ND WINDOW NEAREST TO CORNER @ POCKET OFFICE OPTION.
 13. DELETE OPTIONAL PANTRY DOOR LOCATION.
 14. CHANGE SIDELOAD GRAGE FRONT WINDOWS FROM 5/0 HT TO 6/0 HT.
 15. ADD 8" DEEP CHASE BEHIND 2ND FL LINEN CLOSET @ HALL.
 16. RELOCATE WATER HEATER AT SIDELOAD GRARGE UNDER NEW LINEN CLOSET CHASE.
 17. DECREASE DEPTH OF CHASE BEHIND OWNERS BATH WATER CLOSET TO 10" TO INCREASE WATER CLOSET DEPTH TO 6"-1". 18. MOVE OWERS VANITY WALL UP TO ALLOW ROOM IN LAUNDRY FOR CHASE ● LINEN, OPT 30"
 CAB W/ OPT L.T. AND WASHER/DRYER.

 19. ADD PULL DOWN STAIR IN LAUNDRY. NOTE "25 1/2" X 54 1/2" R.O."
- 20. ADD 18"X24" CHASE IN OWNERS WIC CLOSET @ SHOWER WALL.

- 21. MAKE BATH#2 VANITY 60".
 22. MAKE WC @ BED#2 5"-4" DEEP, ADDING 3" TO BATH #2.
 23. MOVE BATH#2 TOILET, TUB AND WINDOW 3" TOWARD FRONT OF HOUSE.
 24. MAKE WINDOW IN BED #2 CLOSET TEMPERED.

REVISION:003 DATE: 2/4/2022

- DIMENSION TRIPLE STUD POCKETS
- DIMENSION IRPLE STUD POCKETS
 RELOCATE ISLAND PER REDUNES.
 REMOVE WINDOW IN MESSY KITCHEN
 FULL HEIGHT WALL AT END OF CABINETS ON GARAGE ADJACENT WALL.
 REMOVE UNDER-COUNTER SIDE WALLS IN ISLAND.
 SHOW AND CALL OUT DROP ZONE BENCH AS 18" DEEP.

- VERFY CASED OPENINGS ARE 3/0X6/8 ON 1ST FLOOR. ELIMINATE ALT KITCHEN MATCH BASE PLAN LOCATION FOR WATER HEATER IN SIDE LOAD GARAGE. 3/4 LITE ENTRY DOOR.

- 11. OREATE SHOWER OPTION WITH 18" SEAT.
 12. RESIZE STANDARD SHOWER TO 60X30. EXTEND FULL HEIGHT WALL AT STANDARD SHOWER.
 13. ADD 2X6 WALL JUST INSIDE EXTERIOR WALL FOR OPT. SUPER SHOWER W/ OPT. 2ND FLOOR.

- 13. AU 2.06 WAL USS INSUE EXTENSION WALL FOR O'T. SUPER STUDIES BY O'T. 2ND FLOUR.

 14. ALL LINEN CALLED OUT SA (4) SHELVES.

 15. POCKET DOORS CHANCE TO STANDARD 2/4 IN OWNER'S WIC TO LAUNDRY.

 16. EXTEND REAR PORCH 6" SO BEAM BEARS ON CAFE WALL.

 17. CHANGE COLUMINS TIO 6X6 P.T. WITH 1X WRAP FOR TRADITIONAL ELEVATION.

 18. CHANGE REAR PORCH COLUMINS TIO 6X6 P.T. POST, NO WRAP.

 19. CHANGE BRITY DOOR TO 3/4 LITE

 20. EXTEND PORCH SLAB 4" AT FRONT AND EXTEND AROUND CORNER 20" TO SUPPORT STONE WENEER.
- 21. REMOVED HALF WALLS AT KITCHEN ISLAND AND UPDATED PER CABINET PROVIDER
 22. CHANGED THE BASE OWNER'S BATH WINDOW TO 4010
 24. CHANGED THE OWNER'S BATH OPTION SHOWER W/18" SEAT WINDOW TO 4010
- 24. CHANGED THE OWNER'S BATH OPTION SUPER SHOWER WINDOWS TO (2)3010
- 24. CHANGED THE OWNER'S BATH OPTION SUPER SHOWER WINDOWS TO (2)3010
 25. CHANGED THE OPTION 2ND FLOOR OWNER'S BATH WINDOW TO 4010
 26. CHANGED THE OPTION 2ND FLOOR OWNER'S BATH OPTION SUPER SHOWER WINDOWS TO (2)3010
 27. CHANGED ZND FLOOR WINDOW OVER PORCH TO BE 2040 ALL ELEVATIONS
 28. UPDATED THE WINDOW HEADER AT THE STAIR LANDING TO BE 8'-10" ABOVE LANDING
 29. RE-CENTERED GEORGIAN PORCH TO BE CENTERED ON THE WINDOW ABOVE
 30. ADDED AN EXTENDED PORCH OPTION TO THE TRADITIONAL ELEVATION ONLY

REVISION:004

DATE: 3/30/2022

- CHANGED 2ND FLOOR WINDOW OVER PORCH TO BE 2040 ALL ELEVATIONS UPDATED THE WINDOW HEADER AT THE STAIL ANDING TO BE 8"-10" ABOVE LANDING CHANGED STYLE OF ECRGIAN PORCH TO BE CENTERED ON THE WINDOW ABOVE CHANGED STYLE OF ECORGIAN COLUMNS FROM ROUND TO SQUARE ADDED AN EXTENDED PORCH OPTION TO THE TRADITIONAL ELEVATION ONLY ADDED ELECTRICAL PLAN SHETS

Lot 4 DC - 4557 Old US 421 Lillington Selma Georgian - RH Garage

NC



PLAN 4 The Selma - RH 'GEORGIAN'

AR	CHITECTURAL DRAWINGS
Sheet No.	Sheet Description
0.0	Cover Sheet
1.1	Slab Foundation
1.1.1	Slab Foundation Options
1.2	Crawl Foundation
1.2.1	Crawl Foundation Options
2.1	First Floor Plan
2.1.1	First Floor Plan Options
2.2	Second Floor Plan
2.2.1	Second Floor Plan Options
2.4	Covered Patio Plans & Elevations (Slab)
2.4.1	Covered Patio Plans & Elevations (Crawl)
2.5	Side Load Garage Elevations (Slab)
2.5.1	Side Load Garage Elevations (Crawl)
3.1	Front & Rear Elevations (Slab)
3.1.1	Front & Rear Elevations (Crawl)
3.2	Side Elevations (Slab)
3.2.1	Side Elevations (Crawl)
3.3	Roof Plan
5.1	First Floor Electrical
5.1.1	First Floor Options Electrical
5.2	Second Floor Electrical
5.2.1	Second Floor Options Electrical

DESIGN CRITERIA:

THIS PLAN IS TO BE BUILT IN CONFORMANCE WITH THE 2018 NORTH CAROLINA STATE BUILDING CODE: RESIDENTIAL CODE

DIMENSIONS SHALL GOVERN OVER SCALE, AND CODE SHALL

SQUARE FOOTAGE									
	'GEORGIAN'	ELEVATION							
	UNHEATED	HEATED							
FIRST FLOOR	0	1194							
SECOND FLOOR	0	1450							
FRONT PORCH	59	0							
REAR PATIO/DECK	208	0							
2 CAR GARAGE	415	0							
SUBTOTALS	682	2644							
TOTAL UNDER ROOF	33:	26							
O	PTIONS								
	UNHEATED S.F.	HEATED S.F.							
POCKET OFFICE	0	+64							
FIREPLACE BUMPOUT	0 +34								
COVERED PATIO/DECK	210 0								
		·							



DATE	11/22/2021	12/08/2021	2/4/2022	3/30/2022				-
DESCRIPTION	REFER TO COVER SHEET	-	-					
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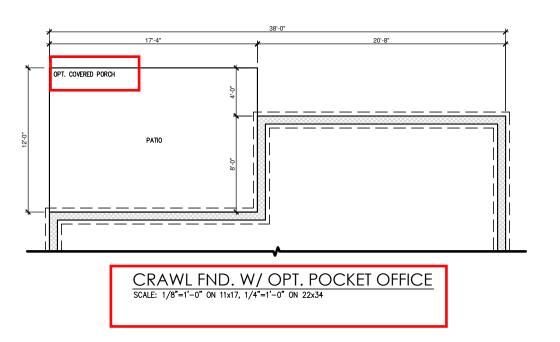
RH - THE SELMA Cover Sheet 'Georgian' 4


> South Designs ISSUE DATE: 07/01/2021

PLAN

URRENT REVISION DATE

1/8" = 1'-0"



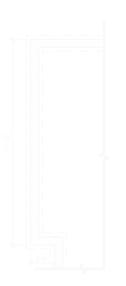

CRAWL FND. W/ OPT. BUMPOUT FIREPLACE

DATE	11/22/2021	12/08/2021	2/4/2022	3/30/2022				
DESCRIPTION	REFER TO COVER SHEET	****	-		-			
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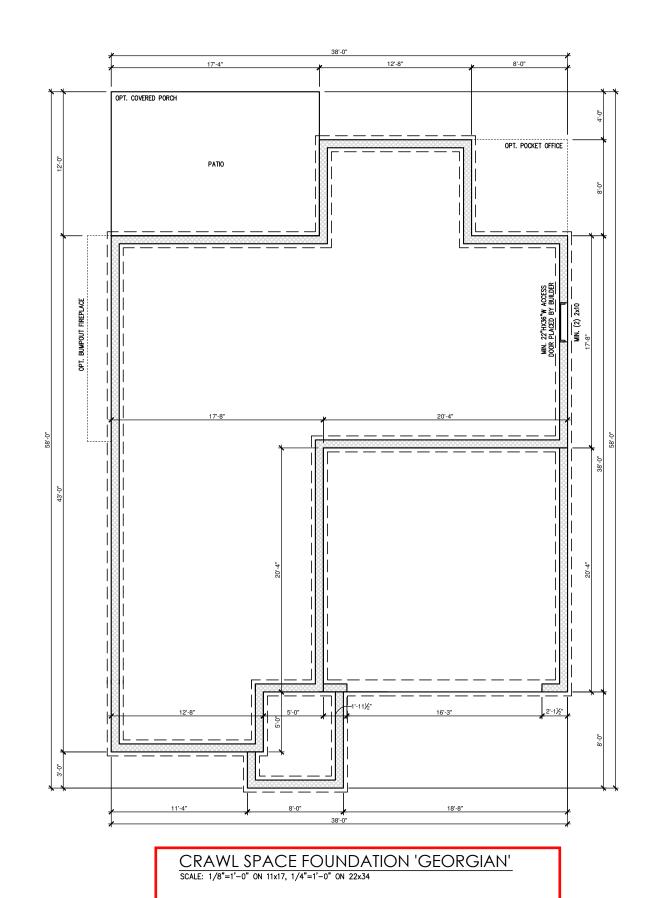
PLAN 4 - THE SELMA - RH SINGLE FAMILY Crawl Foundation Options 'Georgian'

DRAWN BY: South Designs

ISSUE DATE: 07/01/2021

CURRENT REVISION DATE:
---SCALE:
1/8" = 1'-0"

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PLAN 4 - THE SELMA - RH SINGLE FAMILY Crawl Foundation 'Georgian'


DRAWN BY: South Designs

ISSUE DATE: 07/01/2021

CURRENT REVISION DATE: SCALE: 1/8" = 1'-0"

General Floor Plan Notes shall apply unless noted otherwise on plan.

- Wall Heights: Typically 9'-1 1/2" at first floor and 8'-1 1/2" at second floor and attics U.N.O. All walls are constructed using a double top plate. Splices at Double Top Plate do not need to occur at Vertical Studs but must be at least 24" apart from Joint in other Top Plate layer. Special wall heights are noted on plans where they occur.
- Wall Thickness is typically 3 1/2". 2x6 frame shall be used at walls that back up to plumbing fixtures.
 Walls greater than 10' high shall be framed with 2x6 framing or greater and will be noted as a special condition where it occurs on plan.
- Typical header height shall be 6'-11" AFF at First Floor, and 6'-11" AFF at Second Floor U.N.O. on elevation drawings. Windows at front elevation may be higher at the first floor.
- Jacks: Openings up to 3'-4" wide shall have (1) 2x4 jack stud SPF on each side. Openings greater than 3'-4" wide shall have (2) 2x4 jack studs SPF on each side.
- Soffits, Coffered Ceilings, Trey Ceilings and other significant ceiling plan elements are shown on the floor plans and are denoted as single dashed lines. Unless specifically call out as included, Kitchens do not include soffits over wall cabinetry.
- Door & Window Frames, where occurring near corners, shall be a minimum of 4 1/2" from corner. Except for walk-in closets with doors near a corner, doors at closets shall be centered on closet.
- Windows: Shall have at least (1) window in each sleeping room, that meets egress. Shall be provided with tempered glass at hazardous glazing areas. False windows shall be installed with obscure glazing.
- Closets for clothing or coat storage shall be equipped with 1 rod/shelf. Closets for linen shall have 4 open equal shelves. Closets for pantries shall have 4 equal wood shelves, painted.
- Stair treads shall be a min of 9" deep, risers shall be a maximum of 8 1/4", unless noted otherwise, per the current North Carolina Residential Code
- 10. Handrails and Guards at stairs shall be 34" above the finished surface of the ramp surface of the stair. Handrails at landings and overlooks of multilevel spaces shall be 38" above finished floor. Guards (pickets or balusters) shall be spaced with no more than 4" between guards.
- Attic Access shall be provided at all attic area with a height greater than 30°. Minimum clear attic access shall be 20° x 30°. Pull down stairs and access doors in knee walls meeting minimum criteria are also acceptable.
- 12. Garage Door to Living Space shall be 2'-8" x 6'-8" minimum size and shall be 20 minute fire rated and weather sealed.
- 13. Garage Walls, as a minimum, shall be separated from living space by installing 1/2" gypsum board on the garage side of the wall. With habitable space above, the inside of all garage walls require 1/2" GWB supporting 5/8" type X GWB on ceiling.

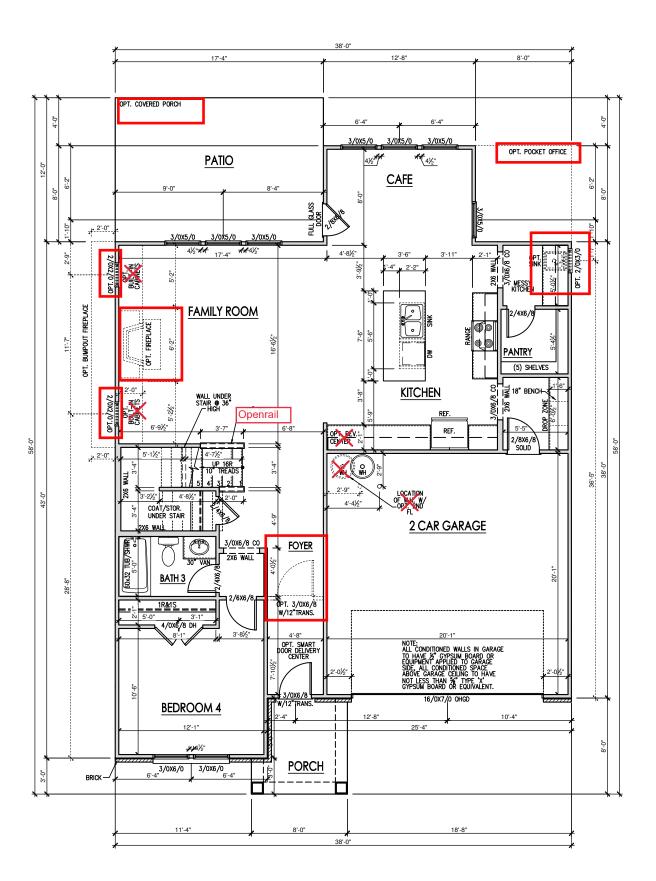

FIRST FLOOR PLAN 'GEORGIAN' SCALE: 1/8"=1'-0" ON 11x17, 1/4"=1'-0" ON 22x34 NEW SHOME

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PLAN 4 - THE SELMA SINGLE FAMILY First Floor Plan 'Georgian'

RH

DRAWN BY: South Designs

ISSUE DATE: 07/01/2021


SCALE:

CURRENT REVISION DATE:


1/8" = 1'-0"
SHEET

General Floor Plan Notes shall apply unless noted otherwise on plan.


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OPT. INTERIOR FIREPLACE
SCALE: 1/8"=1'-0" ON 11x17, 1/4"=1'-0" ON 22x34

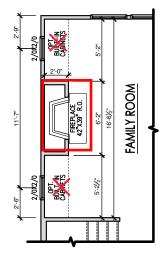



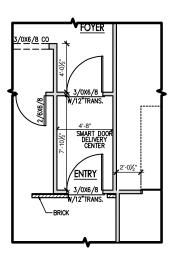

OPT. POCKET OFFICE SCALE: 1/8"=1'-0" ON 11x17, 1/4"=1'-0" ON 22x34

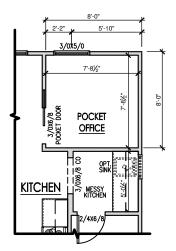

REV.# DESCRIPTION DATE 1 REFER TO COVER SHEET 11/22/2021 2 REFER TO COVER SHEET 12/08/2021 3 REFER TO COVER SHEET 2 A4/2022 5 — — 6 — — 7 — — 8 — — 7 — — 8 — — 1 — —
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PLAN 4 - THE SELMA - RH SINGLE FAMILY First Floor Plan Options

DRAWN BY: South Designs


ISSUE DATE: 07/01/2021 CURRENT REVISION DATE:

SCALE: 1/8" = 1'-0"

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SECOND FLOOR PLAN 'GEORGIAN'

SCALE: 1/8"=1'-0" ON 11x17, 1/4"=1'-0" ON 22x34

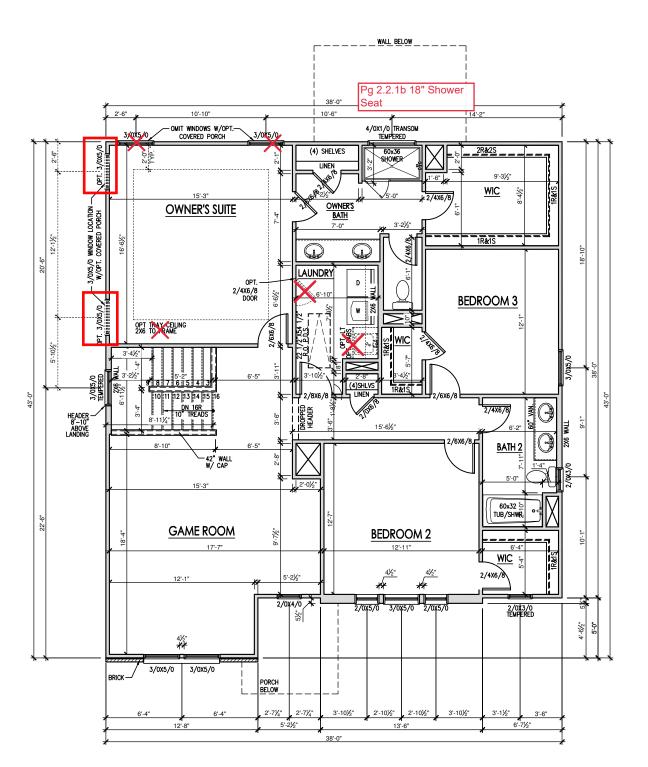

DATE	11/22/2021	12/08/2021	2/4/2022	3/30/2022				1
DESCRIPTION	REFER TO COVER SHEET		-		-			
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PLAN 4 - THE SELMA - SINGLE FAMILY
Second Floor Plan 'Georgian'

RH

DRAWN BY: South Designs


ISSUE DATE: 07/01/2021

CURRENT REVISION DATE:

SCALE: 1/8" = 1'-0"

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DATE	11/22/2021	12/08/2021	2/4/2022	3/30/2022			-	1
DESCRIPTION	REFER TO COVER SHEET	-	-					
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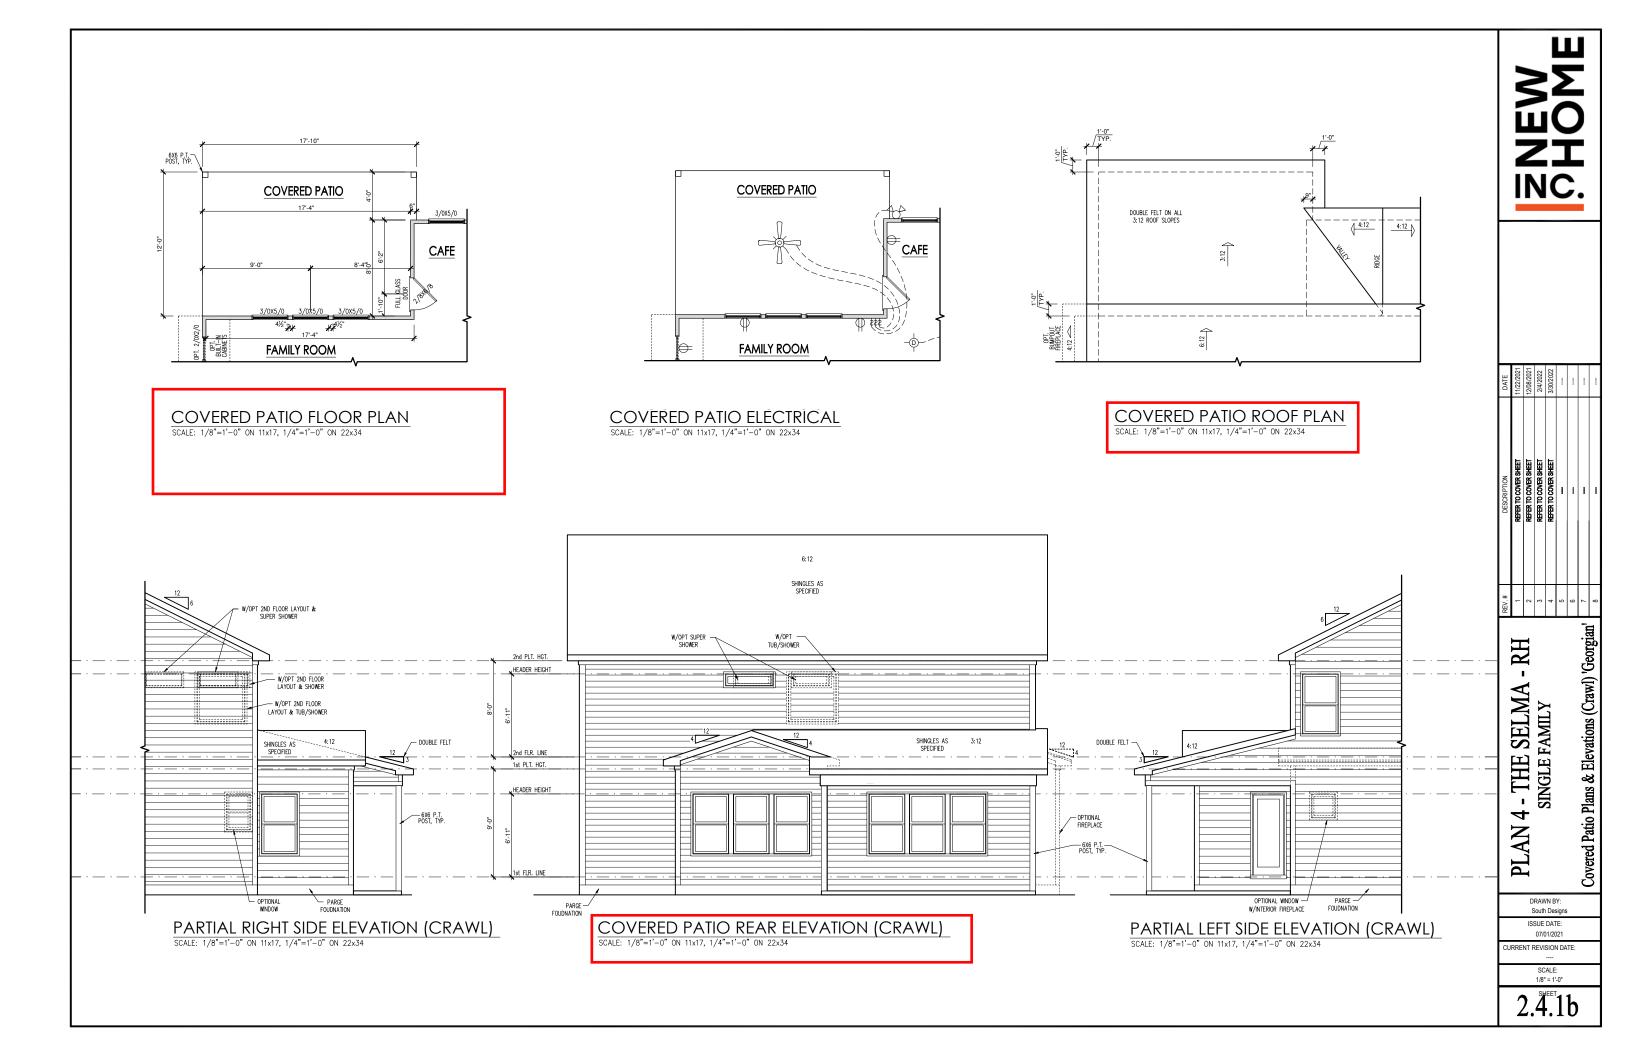
PLAN 4 - THE SELMA - RH SINGLE FAMILY Second Floor Plan Options

> DRAWN BY: South Designs

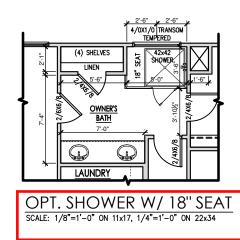ISSUE DATE: 07/01/2021

CURRENT REVISION DATE:

scale: 1/8" = 1'-0" 2.2.1b




General Elevation Notes


General Elevation Notes shall apply unless noted otherwise on plan.

- shingles with slopes as noted on plan.
- Ridge Vent shall be provided and installed on all ridges greater than 6' in length per manufacturer's specifications.
- 3. Soffit Vent shall be continuous soffit vent
- House Wrap, "tyvek" or approved equal shall be installed over entire exterior wall per manufacture specifications and recommendations.
- Flashing shall be provided above all door and window openings, above finish wall material changes and at wall surfaces where lower roof areas abut vertical wall surfaces.
- Porch Railings shall be provided at all porch walking surfaces greater than 30" above adjacent finished grade. It shall be 36" high with guards spaced no more than 4" apart. Consult community specifications for material.
- 7. Finish Wall Material shall be as noted on elevation
- Brick Veneer, if included on elevation shall be fied to wall surface with galvanized corrugated metal fies at a rate of 24" oc hotizontally and 16" oc vertically so that no more than 2.67st of brick is supported by (1) that no more than 2.67sf of brick is supported by (1) tie. Space between face of wall and back face of brick shall be limited to a maximum of 1". Flashing shall be provided behind brick above all wall openings and at base of brick wall. Flashing shall be a minimum of 6-mil poly or other corrosion resistant material and shall be installed so that if laps under the house wrap material a minimum of 2". Weepholes shall be provided at a rate of 48" oc and shall in the belies than 3/16" in diameter and shall be located immediately above flashing. located immediately above flashing.
- Brick Veneer Support Lintels shall be provided if brick veneer is included on elevation. Lintels shall be provided as listed in the following schedule and shall have a minimum bearing length of 6". Masonry Lintels shall be provided so that deflection is limited to L/600.

Angle Opening Size 3-1/2" x 3-1/2" x 5/16"

up to 4'-0" 4'-1" to 5'-6" 5'-7" to 6'-6" 6'-7" to 8'-4" 8'-5" to 16'-4" 4" x 3-1/2" x 5/16" LLV 5" x 3-1/2" x 5/16" LLV 6" x 3-1/2" x 5/16" LLV 7" x 4" x 3/8" LLV

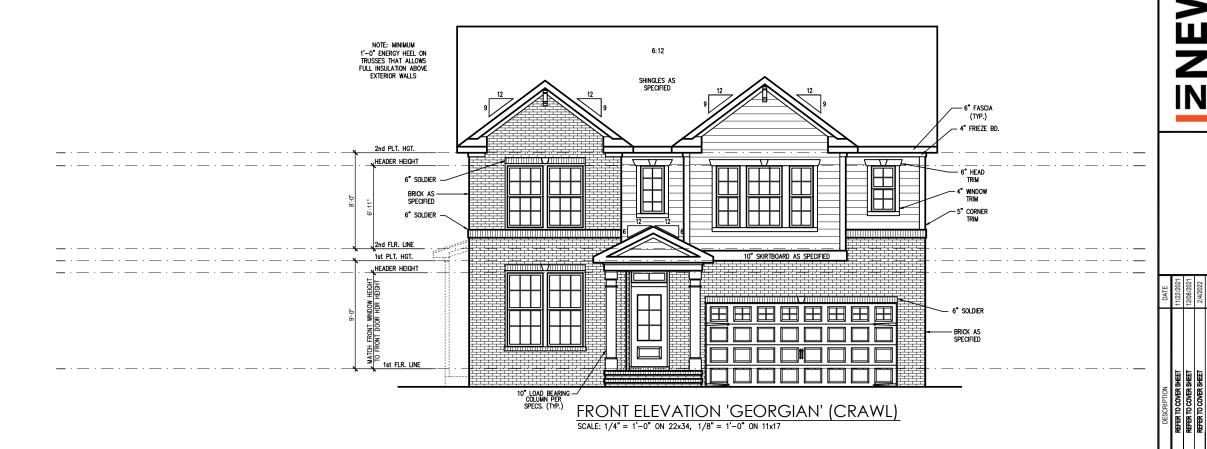

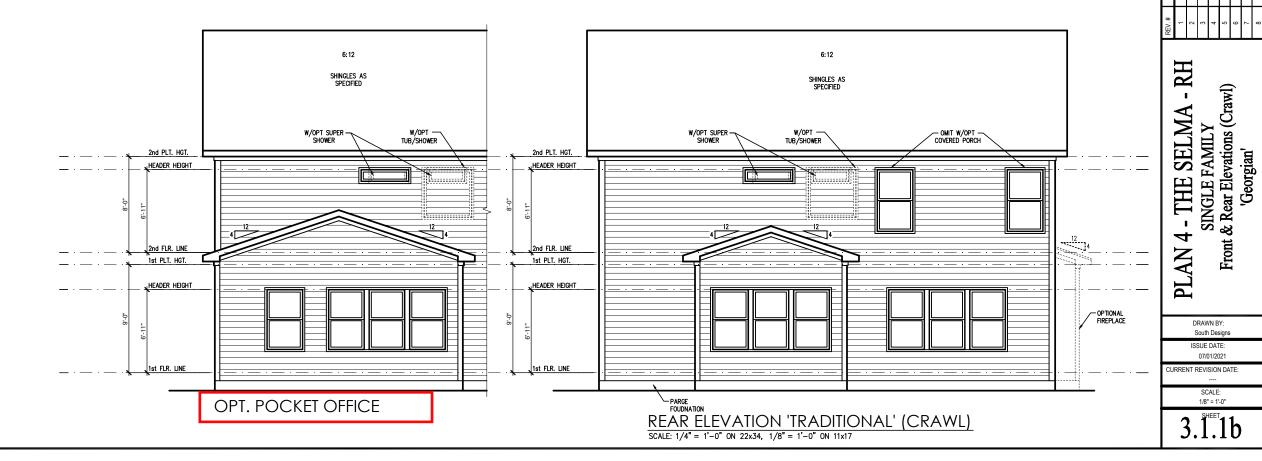

General Elevation Notes


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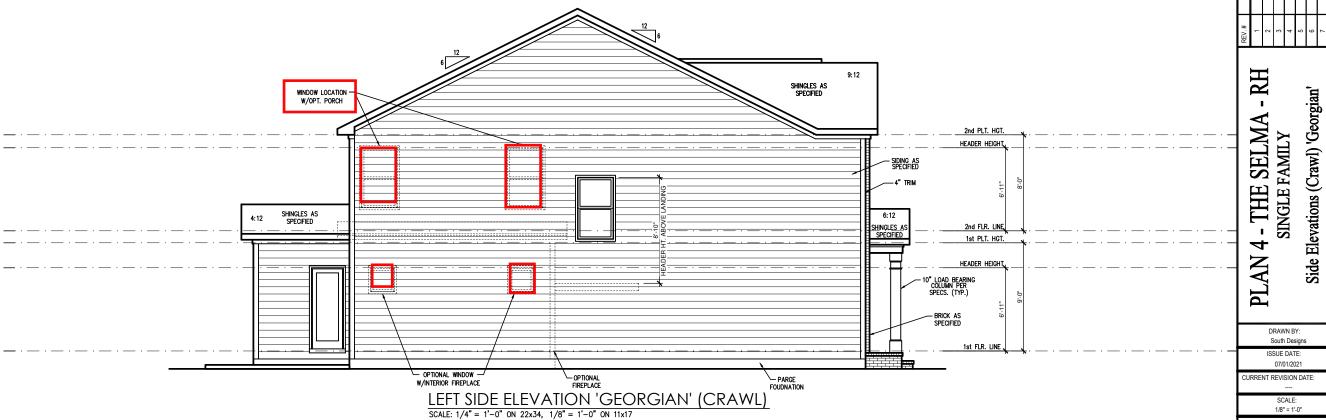
- Roof shall be finished with architectural composition shingles with slopes as noted on plan.
- Ridge Vent shall be provided and installed on all ridges greater than 6' in length per manufacturer's specifications.
- 3. Soffit Vent shall be continuous soffit vent
- House Wrap, "tyvek" or approved equal shall be installed over entire exterior wall per manufacturer's specifications and recommendations.
- Flashing shall be provided above all door and window openings, above finish wall material changes and at wall surfaces where lower roof areas abut vertical wall surfaces.
- Porch Railings shall be provided at all porch walking surfaces greater than 30" above adjacent finished grade. It shall be 36" high with guards spaced no more than 4" apart. Consult community
- Finish Wall Material shall be as noted on elevation drawings.
- 8. Brick Veneer, if included on elevation shall be tied to wall surface with galvanized corrugated metal ties at a rate of 24° oc horizontally and 16° oc vertically so that no more than 2.67sf of brick is supported by (1) tie. Space between face of wall and back face of brick shall be limited to a maximum of 1°. Risshing shall be provided behind brick above all wall openings and at base of brick wall. Risshing shall be provided behind brick above all wall openings and at base of brick wall. Risshing shall be a minimum of 6-mil poly or other corrosion resistant material and shall be installed so that it laps under the house wrap material a minimum of 2°. Weepholes shall be provided at a rate of 48° oc and shall not be less than 316° in diameter and shall be located immediately above flashing.
- Brick Veneer Support Lintels shall be provided if brick veneer is included on elevation. Lintels shall be provided as listed in the following schedule and shall have a minimum bearing length of 6". Masonry Lintels shall be provided so that deflection is limited to L/600.


Masonry Opening Lintel Schedule

Opening Size	Ang
--------------	-----

up to 4'-0" 3-1/2" x 3-1/2" x 5/16" 4'-1" to 5'-6" 4" x 3-1/2" x 5/16" LLV 5'-7" to 6'-6" 5" x 3-1/2" x 5/16" LLV 6'-7" to 8'-5" to 16'-4" 7" x 4" x 3/8" LLV



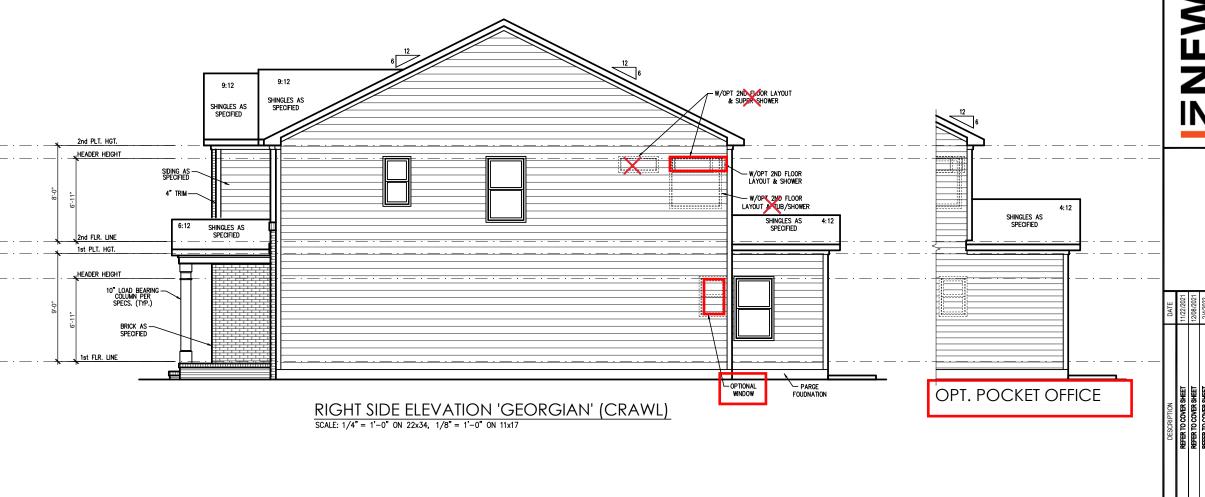

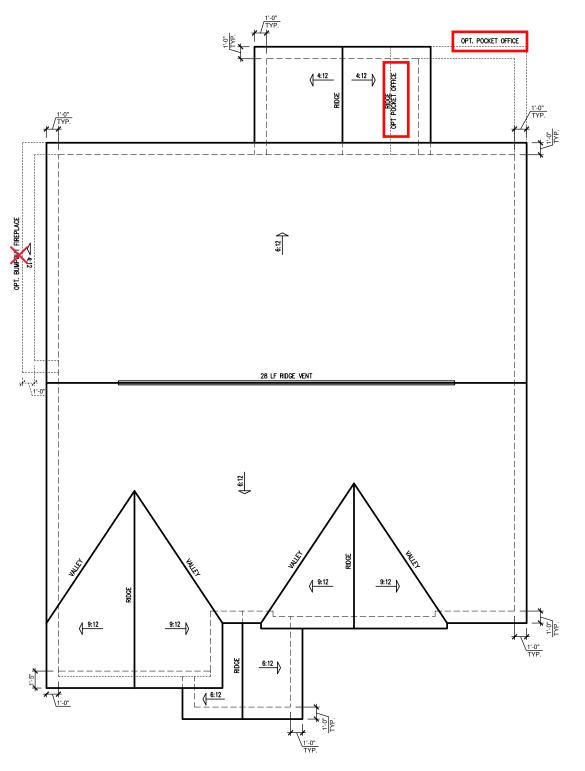

 $\frac{\text{'GEORGIAN' ELEVATION ROOF PLAN}}{\text{SCALE: }1/4" = 1'-0" \text{ on }22x34, \ 1/8" = 1'-0" \text{ on }11x17}$

	ATTIC VENT SCHEDULE													
	'GEORGIAN' ELEVATION													
MAIN	MAIN HOUSE SQ FTG 1512 AT / NEAR RIDGE AT / NEAR EAVE													
VENT TYPE	SQ. REQL	SQ. FT. SQ. FT		PERCENT OF TOTAL	POT LARGE (SQ. FT. EACH)	POT SMALL (SQ. FT. EACH)	RIDGE VENT (SQ. FT. PER LF)	EAVE VENT (SQ. IN. EACH)	CONT. VENT (SQ. IN. PER LF)					
VENTTILE	RAN		SUPPLIED	SUPPLIED 0.4236 0.2778 0.125 0.1944		0.1944	0.0625							
RIDGE VENT	2.02	2.52	3.25	50.98	0	0	26.00							
SOFFIT VENTS	3.02	2.52	3.13	49.02	0 50.00									
TOTAL (MIN)	5.04 5.04 6.38 100.00 POT VENTS MAY BE REQUIRED IF THERE IS INSUFFICIENT RIDGE AVAILABLE													

* SCHEDULE HAS BEEN CALCULATED ASSUMING EAVE VENTILATION AT 50-60% OF TOTAL AND RIDGE AT 40-50% OF TOTAL REQUIRED VENTILATION

 REV.#
 DESCRIPTION
 DATE

 1
 REPRITO COVER SHEET
 1/122/2021

 2
 REPRITO COVER SHEET
 1/208/2021

 3
 REFRITO COVER SHEET
 2/4/2022

 5
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 6
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 7
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 —

 8
 —
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PLAN 4 - THE SELMA - RH SINGLE FAMILY Roof Plan 'Georgian'

DRAWN BY: South Designs

ISSUE DATE: 07/01/2021

CURRENT REVISION DATE:
---SCALE:
1/8" = 1'-0"

3.3b

MOOD I-JOISTS

(SHALL BE ONE OF THE FOLLOWING):

TJI 210 BY TRUS JOIST

- LPI 20 PLUS BY LP
- BCI 5000s I.8 BY BC
- ALL WOOD I-JOISTS SHALL BE INSTALLED ACCORDING TO MANUFACTURER'S SPECIFICATIONS.
- INSTALL SQUASH BLOCKS, WEB STIFFENERS, ETC.
 AS REQUIRED BY AND ACCORDING TO THE I-JOIST MANUFACTURER'S SPECIFICATIONS AND
- HANGERS FOR I-JOISTS ARE THE RESPONSIBILITY OF THE I-JOIST SUPPLIER.
- FLOOR TRUSSES BY THE MANUFACTURER MAY BE SUBSTITUTED FOR I-JOISTS.

TRUSS SYSTEM REQUIREMENTS

NC (2018 NCRC): Wind: 115-120 mph

- I. TRUSS SYSTEM LAYOUTS (PLACEMENT PLANS) SHALL BE DESIGNED IN ACCORDANCE WITH SEALED STRUCTURAL PLANS. ANY NEED TO CHANGE TRUSSES SHALL BE COORDINATED WITH SOUTHERN ENGINEERS
- 2. TRUSS SCHEMATICS (PROFILES) SHALL BE PREPARED AND SEALED BY TRUSS MANUFACTURER.
- ALL TRUSSES SHALL BE DESIGNED FOR BEARING ON SPF #2 OR #3 PLATES OR LEDGERS (UNO).
- ALL REQUIRED ANCHORS FOR TRUSSES DUE TO UPLIFT OR BEARING SHALL MEET THE REQUIREMENTS AS SPECIFIED ON THE TRUSS SCHEMATICS.

FOUNDATION STRUCTURAL NOTES NC (2018 NCRC): Wind: 115-120 mph - CRAWL

(3)2xIO SYP#2 OR SPF#2 GIRDER, TYPICAL UNO. (I.)

2 CONCRETE BLOCK PIER SIZE SHALL BE: HOLLOW UP TO 32" UP TO 48" SIZE SOLID UP TO 5'-0" UP TO 9'-0" 8x16 12x16 UP TO 64" UP TO 12'-0" 24x24 UP TO 96"


WITH 30" x 30" x 10" CONCRETE FOOTING, UNO. 3> WALL FOOTING AS FOLLOWS

DEPTH: 8" - UP TO 2 STORY 10" - 3 STORY

16" - UP TO 2 STORY SIDING: 20" - 3 STORY 16" - I STORY 20" - 2 STORY 24" - 3 STORY

- FOR FOUNDATION WALL HEIGHT AND BACKFILL REQUIREMENTS, REFER TO CODE TABLE R404.I.I (I THRU 4) NOTE: ASSUMED SOIL BEARING CAPACITY = 2000 PSF. CONTRACTOR MUST VERIFY SITE CONDITIONS AND CONTACT SOILS ENGINEER IF MARGINAL OR UNSTABLE SOILS ARE ENCOUNTERED.
- 4 (4) 2xIO SPF #2 OR SYP #2 GIRDER
- (2) 1.75x9.25 LVL OR LSL GIRDER
- (6) (3) 1.75×9.25 LVL OR LSL GIRDER
- "" DESIGNATES A SIGNIFICANT POINT LOAD TO HAVE SOLID BLOCKING TO PIER. SOLID BLOCK ALL BEAM BEARING POINTS NOTED TO HAVE THREE OR MORE STUDS TO FND, TYPICAL.
- ABBREVIATIONS:
- "SJ" = SINGLE JOIST "DJ" = DOUBLE JOIST

- ADJUST SUBFLOOR THICKNESS OR JOIST SPACING AS REQ'D FOR FLOOR FINISH MATERIALS.

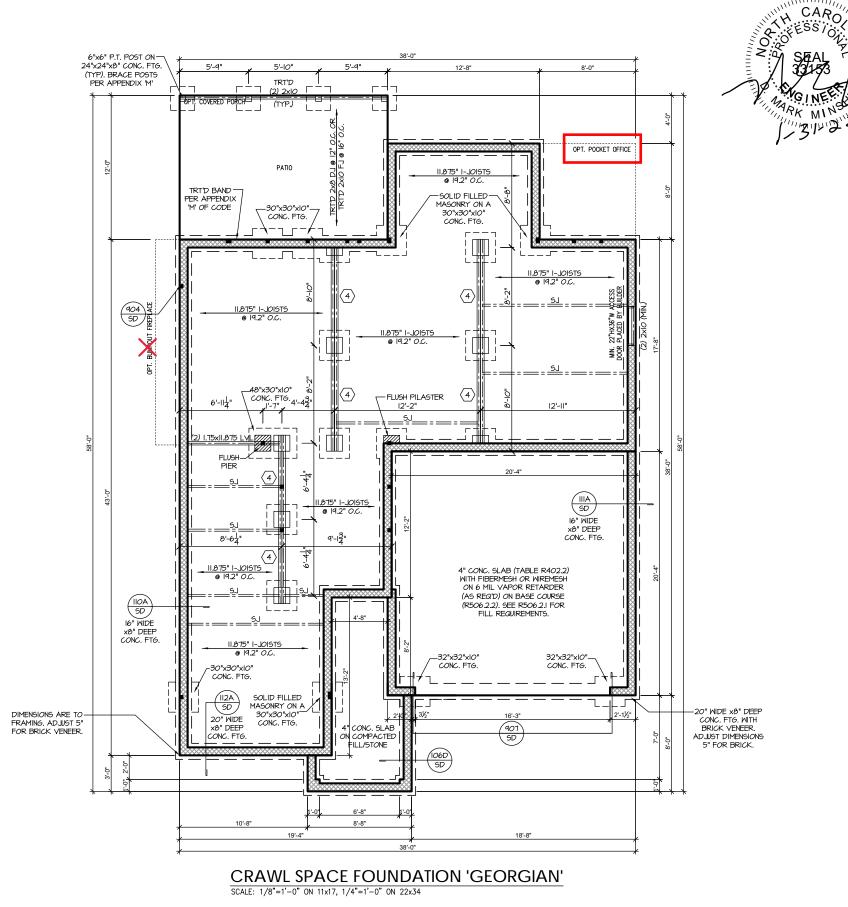


PROJECT # 21-2817-RH

P.A. 27609 Southern Engineers, F 3716 Benson Drive, Raleigh, NC 2' Phone: (919) 878-1617

SOUTH DESIGNS

RH 4 Plan

REFER TO "SD" SHEET(S) FOR STANDARD DETAILS BRACING DETAILS AND STRUCTURAL NOTES

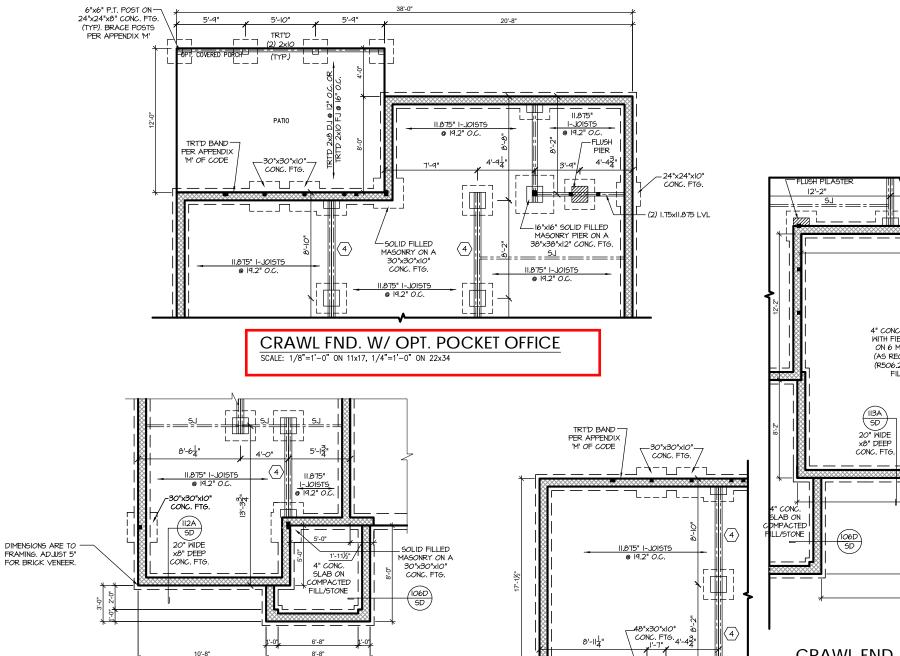

CRAWL FND. PLAN W/SMART DOOR DELIVERY

SCALE: 1/8"=1'-0" ON 11x17, 1/4"=1'-0" ON 22x34

24"x24"x10"— CONC. FTG. 4" CONC. SLAB (TABLE R402.2) WITH FIBERMESH OR WIREMESH ON 6 MIL VAPOR RETARDER (A5 REQ'D) ON BASE COURSE (R506.2.2). SEE R506.2.1 FOR FILL REQUIREMENTS. 24"×24"×IO"— 907 SD DIMENSIONS ARE TO FRAMING. ADJUST 5" FOR BRICK VENEER.

CRAWL FND. W/ OPT. SIDE LOAD GARAGE SCALE: 1/8"=1'-0" ON 11x17, 1/4"=1'-0" ON 22x34

CRAWL FND. W/ OPT. BUMPOUT FIREPLACE SCALE: 1/8"=1'-0" ON 11x17, 1/4"=1'-0" ON 22x34

GEORGIAN

STANDARD DETAILS, BRACING DETAILS AND STRUCTURAL NOTES.

REFER TO "SD" SHEET(S) FOR

SOUTH DESIGNS

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PROJECT # 21-2817-RH

> NEW HOME, INC. Plan 04-RH

- 4"x4" (6"x6") TRT'D POST (OR EQUAL).
- ATTACH TRUSSES (RAFTERS) AT PORCH WITH HURRICANE CONNECTORS
- POST CAP: SIMPSON AC4-MAX (AC6-MAX)
- POST CAP AT CORNER: (2) SIMPSON LCE4 (MITER HEADER AT CORNER). HIGH WIND; ADD (I) SIMPSON H6
- 3. POST BASE: SIMPSON ABU44 (ABU66).
- MONO: %" ANCHOR (EMBED 7")
- CMU: 1/8" ANCHOR (EXTEND TO FOOTING HIGH WIND ONLY)
- POST BASE: WOOD FOUNDATION: (2) SIMPSON CSI6 STRAPS AT POSTS, EXTEND 12" ONTO EACH POST (UPPER AND
- NOTE: EQUIVALENT POST CAP AND BASE ACCEPTABLE.

HEADER/BEAM & COLUMN NOTES

- ALL EXTERIOR AND LOAD BEARING HEADERS SHALL BE MIN. (2)2x6 (4" WALL) OR (3)2x6 (6" WALL) WITH (1) SUPPORT STUD, UNLESS NOTED OTHERWISE.
- 2. THE NUMBER SHOWN AT BEAM AND HEADER SUPPORTS INDICATES THE NUMBER OF SUPPORT STUDS REQUIRED IN STUD POCKET OR COLUMN. THE NUMBER OF KING STUDS AT EACH END OF HEADERS IN EXTERIOR WALLS SHALL BE ACCORDING TO ITEM "d" IN TABLE R602.3(5) OR AS BELOW PER NCDOI COMMENTARY "KING STUDS AT WALL OPENINGS" REVISED 1-9-2020:
- UP TO 3' SPAN: (I) KING STUD
- OVER 3' UP TO 6' SPAN: (2) KING STUDS
- OVER 6' UP TO 9' SPAN: (3) KING STUDS OVER 9' UP TO 12' SPAN: (4) KING STUDS
- OVER 12' UP TO 15' SPAN: (5) KING STUDS

FRAMING NOTES

NC (2018 NCRC): Wind: 115-120 mph

- BRACING METHOD AND TYPE: CONTINUOUSLY SHEATHED WSP: CS-WSP. NOTE THAT THE WALL BRACING AMOUNT PROVIDED ON THE PLANS (DETAILS AND SPECIFICATIONS) IS GREATER THAN THE AMOUNT OF WALL BRACING REQUIRED BY SECTION R602.10 OF THE CODE. SEE NOTES BELOW FOR DETAILS AND SPECIFICATIONS FOR
- 2. EXTERIOR WALL SHEATHING: WALLS SHALL BE BRACED BY SHEATHING WALLS ON ALL STORIES WITH WOOD STRUCTURAL PANEL SHEATHING (WSP) (EXPOSURE B. 1/16" EXPOSURE C. 15/32") SHEATHING SHALL BE ATTACHED WITH 8d NAILS AT A 6"/12" NAILING PATTERN (6" OC AT PANEL EDGES AND 12" OC AT INTERMEDIATE SUPPORTS). INSTALL BLOCKING AT ALL PANEL EDGES.
- 3. WSP SHEATHING SHALL EXTEND TO THE UPPERMOST DOUBLE BEARING PLATE. BLOCK AT ROOF PER SECTION R602.IO.4.5 AND ATTACH BRACED WALLS PER CODE. WSP SHEATHING BETWEEN FLOORS SHALL BE SPLICED ALONG CONTINUOUS BAND OR THE WSP SHEATHING MAY BE SPLICED ACROSS STUDS (CONTINUOUS ACROSS FLOOR SYSTEM) WITH BLOCKING AT PANEL EDGES. (MINIMUM 12" BEYOND FLOOR BREAK) OR OTHER APPROVED METHOD.
- 4. "HD" = HOLDOWN: HOLD-DOWN DEVICE (NOTED AS "HD" ON PLANS) SHALL BE AN 800 POUND CAPACITY ASSEMBLY AS NOTED ON PLANS, SEE DETAILS FOR HD ASSEMBLY.
- **GROUND/FIRST FLOOR: USE "HD HOLD-DOWN DETAIL" ON SD SHEET (OR EQUIV.)
- STUD (OR HEADER) AND ATTACH EACH END W (7) 8d NAILS.
- 5. INTERIOR BRACED WALL: (NOTED AS "IBW" ON PLANS) ATTACH I/2" GYPSUM BOARD (GB) ON EACH SIDE OF WALL WITH A MIN. OF 5d COOLER NAILS OR #6 SCREWS @ 7" O.C. ALONG THE EDGES AND AT INTERMEDIATE SUPPORTS.
- 6. INTERIOR BRACED WALL-WOOD STRUCTURAL PANEL: (NOTED AS "<u>IBM-MSP</u>" ON PLANS). ATTACH ONE SIDE WITH 7/6" MSP SHEATHING WITH 8d NAILS AT A 6"/12" NAILING PATTERN (6" OC AT PANEL EDGES AND 12" OC AT INTERMEDIATE SUPPORTS). INSTALL BLOCKING AT ALL PANEL EDGES. ATTACH GB OVER WSP AS REQUIRED, ATTACH OPPOSITE SIDE WITH 1/2" 6B WITH A MIN. OF 5d COOLER NAILS OR #6 SCREMS @ 7" OC ALONG THE EDGES AND AT INTERMEDIATE SUPPORTS

MOOD 1-JOISTS (SHALL BE ONE OF THE FOLLOWING):

- TJI 210 BY TRUS JOIST LPI 20 PLUS BY LP
- BCI 5000s L8 BY BC

HEAVY I- JOISTS

(SHALL BE ONE OF THE FOLLOWING OR EQUAL):

• TJI 360 BY TRUS JOIST


- I PI 42 PI I/S BY I P
- ALL WOOD I-JOISTS SHALL BE INSTALLED ACCORDING TO MANUFACTURER'S SPECIFICATIONS.
- INSTALL SQUASH BLOCKS, WEB STIFFENERS, ETC. AS REQUIRED BY AND ACCORDING TO THE I-JOIST MANUFACTURER'S SPECIFICATIONS AND
- HANGERS FOR I-JOISTS ARE THE RESPONSIBILITY OF THE I-JOIST SUPPLIER.
- FLOOR TRUSSES BY THE MANUFACTURER MAY BE SUBSTITUTED FOR I-JOISTS.

TRUSS SYSTEM REQUIREMENTS

NC (2018 NCRC): Wind: 115-120 mph

- TRUSS SYSTEM LAYOUTS (PLACEMENT PLANS) SHALL BE DESIGNED IN ACCORDANCE WITH SEALED STRUCTURAL PLANS. ANY NEED TO CHANGE TRUSSES SHALL BE COORDINATED WITH SOUTHERN ENGINEERS.
- TRUSS SCHEMATICS (PROFILES) SHALL BE PREPARED AND SEALED BY TRUSS MANUFACTURER.
- ALL TRUSSES SHALL BE DESIGNED FOR BEARING ON SPF #2 OR #3 PLATES OR LEDGERS (UNO).
- ALL REQUIRED ANCHORS FOR TRUSSES DUE TO UPLIFT OR BEARING SHALL MEET THE REQUIREMENTS AS SPECIFIED ON THE TRUSS SCHEMATICS.

LANDING LEVEL.

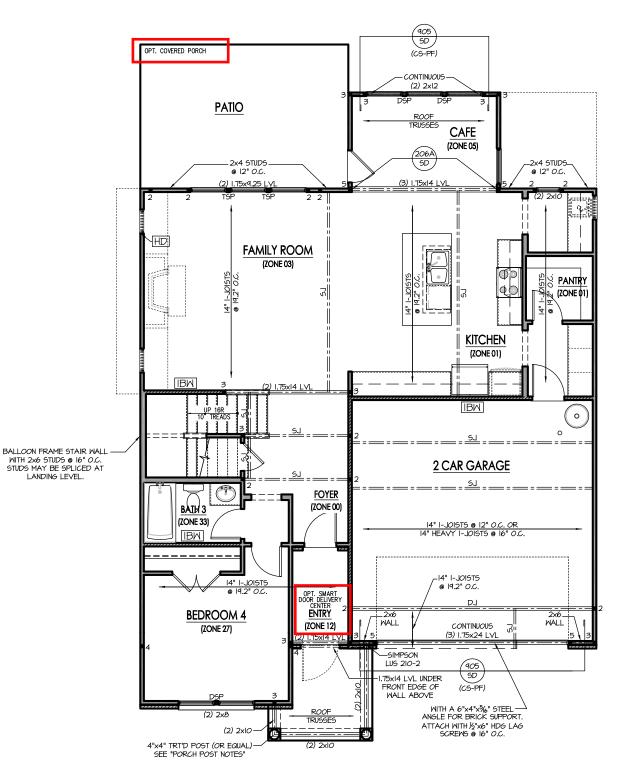

CARO

PROJECT #

21-2817-RH

to be brought to t Failure to do so w

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Southern Engi 3716 Benson Drive, Ral Phone: (919) 8

DESIGNS

SOUTH

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Plan


www.southernengineers.com

AD JUST GARAGE SLAB ELEVATION TO PROVIDE ADEQUATE CLEARANCE A GARAGE DOOR HEADER.


FIRST FLOOR PLAN 'GEORGIAN' SCALE: 1/8"=1'-0" ON 11x17, 1/4"=1'-0" ON 22x34

> REFER TO "SD" SHEET(S) FOR STANDARD DETAILS BRACING DETAILS AND STRUCTURAL NOTES.


NEW HOME,

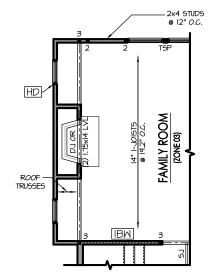


OPT. BUMPOUT FIREPLACE SCALE: 1/8"=1'-0" ON 11x17, 1/4"=1'-0" ON 22x34

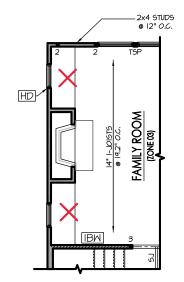


OPT. INTERIOR FIREPLACE SCALE: 1/8"=1'-0" ON 11x17, 1/4"=1'-0" ON 22x34

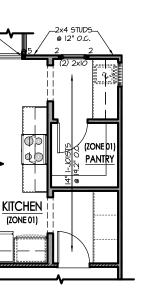

OPT. PANTRY DOOR LOCATION
SCALE: 1/8"=1'-0" ON 11x17, 1/4"=1'-0" ON 22x34

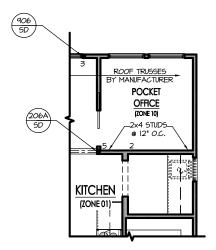

OPT. POCKET OFFICE SCALE: 1/8"=1'-0" ON 11x17, 1/4"=1'-0" ON 22x34

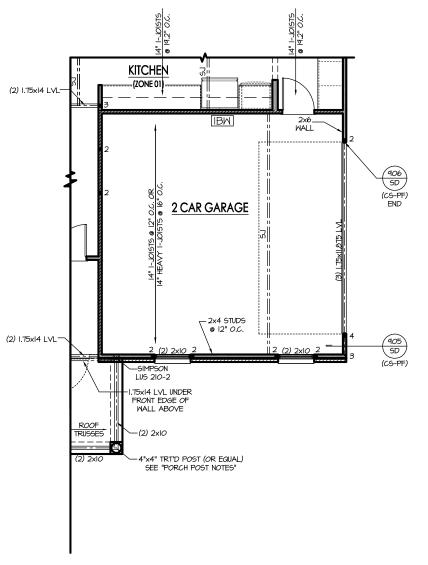

OPT. SIDE LOAD GARAGE SCALE: 1/8"=1'-0" ON 11x17, 1/4"=1'-0" ON 22x34

Ist FLOOR OPTIONS

REFER TO "SD" SHEET(S) FOR STANDARD DETAILS, BRACING DETAILS AND STRUCTURAL NOTES.

PROJECT # 21-2817-RH

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3716 Benson Drive, Raleigh, NC 27609
Phone: (919) 878-1617
License: C-4772

SOUTH DESIGNS

NEW HOME, INC. Plan 04-RH

TRUSS SYSTEM REQUIREMENTS

NC (2018 NCRC): Wind: 115-120 mph

- I. TRUSS SYSTEM LAYOUTS (PLACEMENT PLANS) SHALL BE DESIGNED IN ACCORDANCE WITH SEALED STRUCTURAL PLANS, ANY NEED TO CHANGE TRUSSES SHALL BE COORDINATED WITH SOUTHERN ENGINEERS.
- TRUSS SCHEMATICS (PROFILES) SHALL BE PREPARED
 AND SEALED BY TRUSS MANUFACTURER.
- 3. ALL TRUSSES SHALL BE DESIGNED FOR BEARING ON SPF #2 OR #3 PLATES OR LEDGERS (UNO).
- 4. ALL REQUIRED ANCHORS FOR TRUSSES DUE TO UPLIFT OR BEARING SHALL MEET THE REQUIREMENTS AS SPECIFIED ON THE TRUSS SCHEMATICS.

HEADER/BEAM & COLUMN NOTES


- I. ALL EXTERIOR AND LOAD BEARING HEADERS SHALL BE MIN. (2)2x6 (4" WALL) OR (3)2x6 (6" WALL) WITH (I) SUPPORT STUD, UNLESS NOTED OTHERWISE.
- 2. THE NUMBER SHOWN AT BEAM AND HEADER SUPPORTS INDICATES THE NUMBER OF SUPPORT STUDS REQUIRED IN STUD POCKET OR COLUMN. THE NUMBER OF KING STUDS AT EACH END OF HEADERS IN EXTERIOR WALLS SHALL BE ACCORDING TO ITEM "d" IN TABLE R602.3(5) OR AS BELOW PER NODI COMMENTARY "KING STUDS AT WALL OPENINGS" REVISED 14-2020.
- •• UP TO 3' SPAN: (I) KING STUD
- OVER 3' UP TO 6' SPAN: (2) KING STUDS
- OVER 6' UP TO 4' SPAN: (3) KING STUDS
 OVER 9' UP TO 12' SPAN: (4) KING STUDS
- OVER 12' UP TO 15' SPAN: (5) KING STUDS

FRAMING NOTES

NC (2018 NCRC): Wind: 115-120 mph

- BRACING METHOD AND TYPE: CONTINUOUSLY SHEATHED MSP: CS-MSP. NOTE THAT THE WALL BRACING AMOUNT PROVIDED ON THE PLANS (DETAILS AND SPECIFICATIONS) IS GREATER THAN THE AMOUNT OF WALL BRACING REQUIRED BY SECTION R602.10 OF THE CODE: SEE NOTES BELOW FOR DETAILS AND SPECIFICATIONS FOR WALL BRACING AND WALL IF RAMING.
- 2. EXTERIOR WALL SHEATHING: WALLS SHALL BE BRACED BY SHEATHING WALLS ON ALL STORIES WITH WOOD STRUCTURAL PANEL SHEATHING (WEP) (EXPOSURE B: TI/6", EXPOSURE G: 15/32"), SHEATHING SHALL BE ATTACHED WITH BO NAILS AT A 6"/12" NAILING PATTERN (6" OC AT PANEL EDGES AND 12" OC AT INTERMEDIATE SUPPORTS), INSTALL BLOCKING AT ALL PANEL EDGES.
- 3. MSP SHEATHING SHALL EXTEND TO THE UPPERMOST DOUBLE BEARING PLATE. BLOCK AT ROOF PER SECTION R602/10.4.5 AND ATTACH BRACED WALLS PER CODE. MSP SHEATHING BETWEEN FLOORS SHALL BE SPLICED ALONG CONTINUOUS BAND OR THE MSP SHEATHING MAY BE SPLICED ACROSS STUDS (CONTINUOUS ACROSS FLOOR SYSTEM) WITH BLOCKING AT PANEL EDGES. (MINIMUM 12" BEYOND FLOOR BREAK) OR OTHER APPROVED METHOD.
- "HD" = HOLDONN: HOLD-POWN DEVICE (NOTED AS "HD" ON PLANS) SHALL BE AN 800 POUND CAPACITY ASSEMBLY AS NOTED ON PLANS, SEE DETAILS FOR HD ASSEMBLY.
- **GROUND/FIRST FLOOR: USE "HD HOLD-DOWN DETAIL" ON SD SHEET (OR EQUIV.)
- ***UPPER FLOORS: ATTACH BASE OF KING STUD WITH A SIMPSON C522 STRAP DOWN ACROSS THE BAND AND DOWN TO A STUD BELOW OR HEADER BELOW. EXTEND STRAP T" MIN ALONG EACH STUD (OR HEADER) AND ATTACH EACH END W (1) 80 NAILS.
- 5. INTERIOR BRACED WALL: (NOTED AS "IBW" ON PLANS) ATTACH I/2" GYPSUM BOARD (GB) ON EACH SIDE OF WALL WITH A MIN. OF 5d COOLER NAILS OR *6 SCREMS @ 7" O.C. ALONG THE EDGES AND AT INTERMEDIATE SUPPORTS.
- 6. INTERIOR BRACED WALL-WOOD STRUCTURAL PANEL; (NOTED AS "IBN-WSP" ON PLANS). ATTACH ONE SIDE WITH ½" WSP SHEATHING WITH & NAILS AT A 6"/12" NAILING PATTERN (6" OC AT PANEL EDGES AND 12" OC AT INTERMEDIATE SUPPORTS). INSTALL BLOCKING AT ALL PANEL EDGES. ATTACH GB OVER WSP AS REQUIRED. ATTACH OPPOSITE SIDE WITH 1/2" GB WITH A MIN. OF 5d COOLER NAILS OR ¾6 SCREWS ⊚ 7" OC ALONG THE EDGES AND AT INTERMEDIATE SUPPORTS.



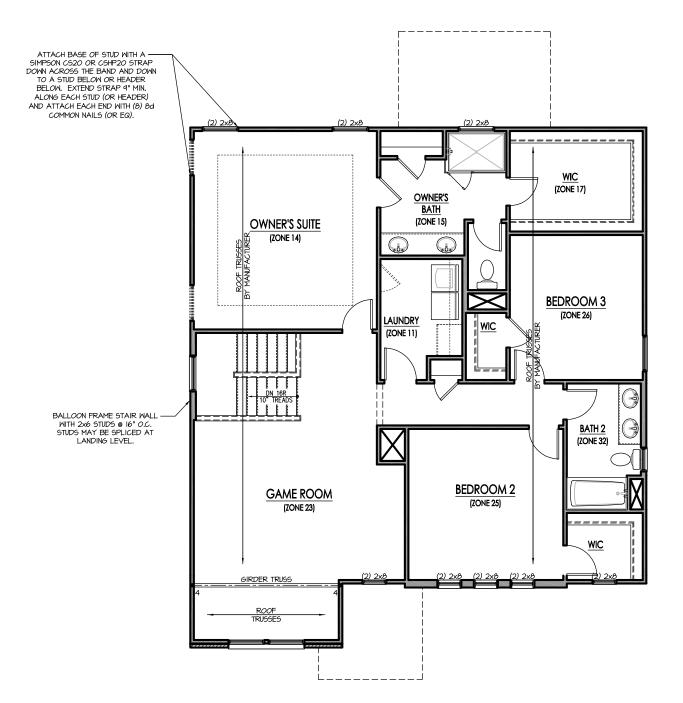

SECOND FLOOR PLAN 'GEORGIAN'
SCALE: 1/8"=1'-0" ON 11x17, 1/4"=1'-0" ON 22x34

PROJECT # 21-2817-RH

Engineers. Failure to do so will one year from date of seal.

Seat does not include construction means, method sequences, procedures or safety precautions.

Any deviations or discrepancies on plans are to be immediate attention of Southern Engineers. Failur void Southern Engineers. Failur Seal is valid for projects permitted one year from d

Southern Engineers, P.A. 3716 Benson Drive, Raleigh, NC 27609 Phone: (919) 878-1617

SOUTH DESIGNS

Plan 04-RH
NEW HOME, INC.

REFER TO "SD" SHEET(S) FOR STANDARD DETAILS, BRACING DETAILS AND STRUCTURAL NOTES.


	ATTIC VENT SCHEDULE														
	'GEORGIAN' ELEVATION														
MAIN HOUSE SQ FTG 1512 AT / NEAR RIDGE AT / NEAR EAV								AR EAVE							
VENT TYPE	SQ. REQL		SQ. FT.			PERCENT OF TOTAL	POT LARGE (SQ. FT. EACH)	POT SMALL (SQ. FT. EACH)	RIDGE VENT (SQ. FT. PER LF)	EAVE VENT (SQ. IN. EACH)	CONT. VENT (SQ. IN. PER LF)				
	RAN	IGE	SUPPLIED	SUPPLIED	0.4236	0.2778	0.125	0.1944	0.0625						
RIDGE VENT	2.02	2.52	3.25	50.98	0	0	26.00								
SOFFIT VENTS	3.02	2.52	3.13	49.02	0 50.00										
TOTAL (MIN)	5.04	5.04	6.38	100.00	POT VENTS MAY BE REQUIRED IF THERE IS INSUFFICIENT RIDGE AVAILABLE										

^{*} SCHEDULE HAS BEEN CALCULATED ASSUMING EAVE VENTILATION AT 50-60% OF TOTAL AND RIDGE AT 40-50% OF TOTAL REQUIRED VENTILATION

TRUSS SYSTEM REQUIREMENTS NC (2018 NCRC): Wind: 115-120 mph

- TRUSS SYSTEM LAYOUTS (PLACEMENT PLANS) SHALL BE DESIGNED IN ACCORDANCE WITH SEALED STRUCTURAL PLANS, ANY NEED TO CHANGE TRUSSES SHALL BE COORDINATED WITH SOUTHERN
- TRUSS SCHEMATICS (PROFILES) SHALL BE
 PREPARED AND SEALED BY TRUSS MANUFACTURER.
- ALL TRUSSES SHALL BE DESIGNED FOR BEARING ON SPF #2 OR #3 PLATES OR LEDGERS (UNO).
- ALL REQUIRED ANCHORS FOR TRUSSES DUE TO UPLIFT OR BEARING SHALL MEET THE REQUIREMENTS AS SPECIFIED ON THE TRUSS



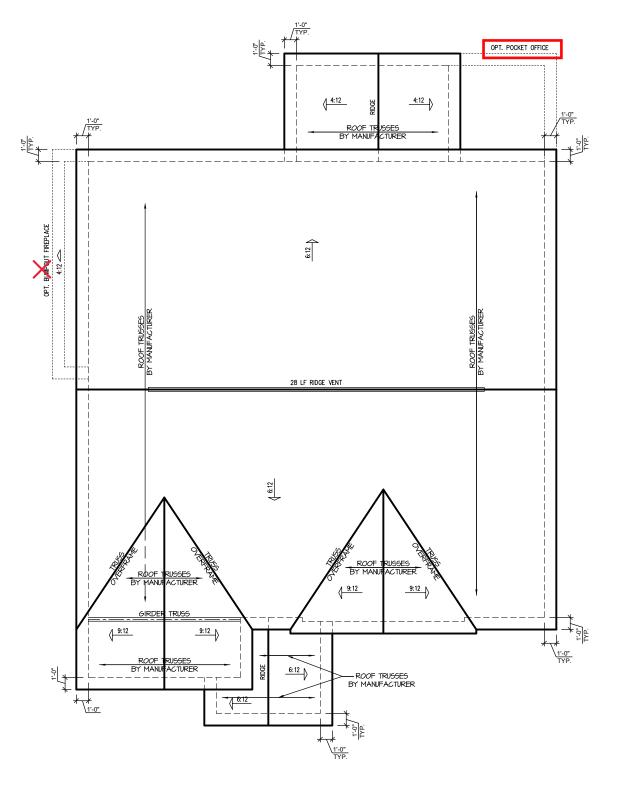

'GEORGIAN' ELEVATION ROOF PLAN SCALE: 1/4" = 1'-0" ON 22x34, 1/8" = 1'-0" ON 11x17


PROJECT # 21-2817-RH


Southern Engineers, P.A. 3716 Benson Drive, Raleigh, NC 27609 Phone: (919) 878-1617


SOUTH DESIGNS


NEW HOME, INC. Plan 04-RH

REFER TO "SD" SHEET(S) FOR STANDARD DETAILS, BRACING DETAILS AND STRUCTURAL NOTES.

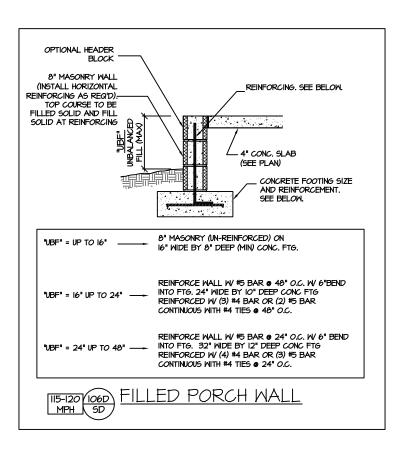


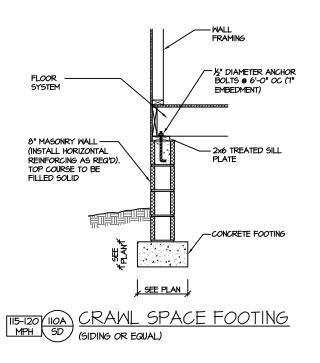

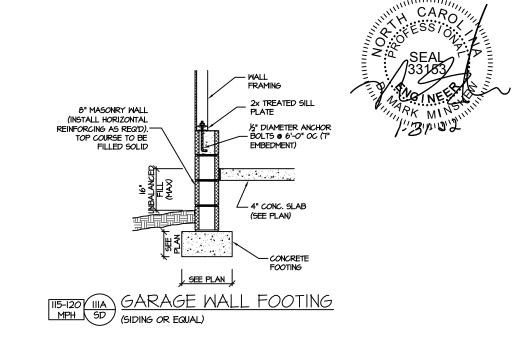

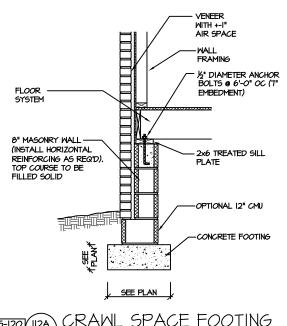




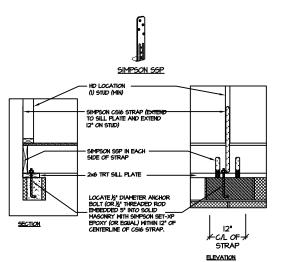

BRACED WALL END CONDITION " HD" HOLD-DOWN DETAIL

NOTE: SIMPSON DTT-IZ IS ACCEPTABLE ALTERNATE NOTE: ALTERNATE HD HOLD-DOWN DEVICES OR SYSTEMS MAY BE USED TO MEET THE CODE REQUIRED 800 LB CAPACITY IN LIEU OF THE ABOVE DETAIL.

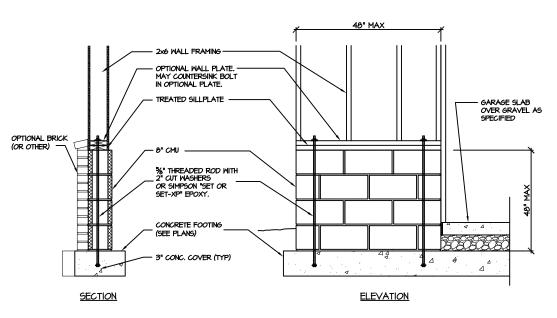

GARAGE 'WING WALL' REINFORCING PER IRC FIGURE R602.IO.4.3

CRAWL SPACE FOUNDATION

PROJECT # 21-2817

Engineers seal applies only to Structural components on this document.

Seal does not include construction means, methods, techniques, sequences, procedures or safety precautions.

Any deviations or discrepancies on plans are to be brought to the immediate attention of Southern Engineers. Failure to do so will void Southern Engineers. Failure to do so will void Southern Engineers liability.

Seal is valid for projects permitted one year from date of seal. Use of these plans constitutes approval of terms & conditions as defined in the customer agreement.


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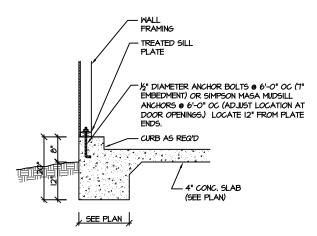
SOUTH DESIGNS

NEW HOME, INC. 8 PLAN


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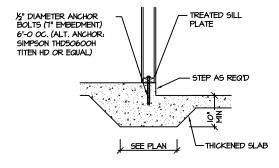







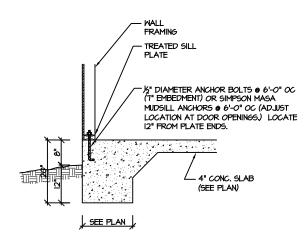




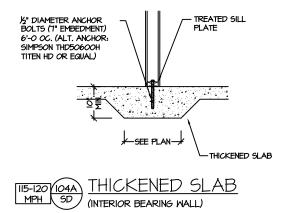



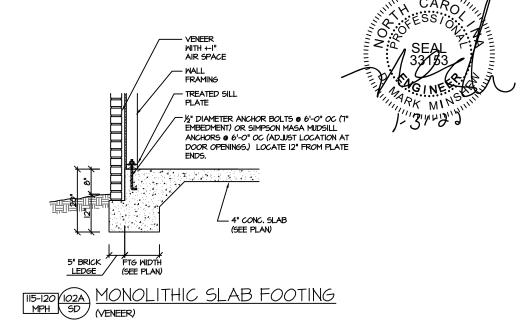

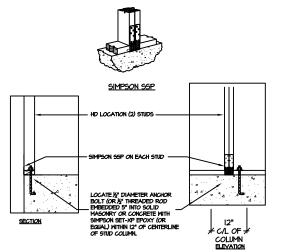

BRACED WALL END CONDITION "HD"
HOLD-DOWN DETAIL

NOTE: SIMPSON DTT-IZ IS ACCEPTABLE ALTERNATE
NOTE: ALTERNATE HD HOLD-DOWN DEVICES OR SYSTEMS MAY
BE USED TO MEET THE CODE REQUIRED 800 LB CAPACITY IN
LIEU OF THE ABOVE DETAIL.

SLAB FOUNDATION

PROJECT # 21-2817

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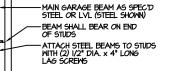
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SOUTH DESIGNS


PLAN 04
NEW HOME, INC.


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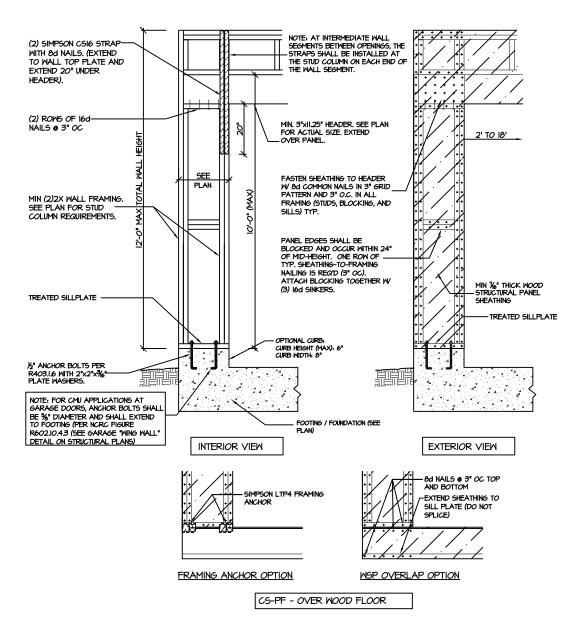


NUMBER OF STUDS SPEC'D (SEE PLANS) INCLUDES ALL

(204A)TYP. GARAGE BEAM BEARING



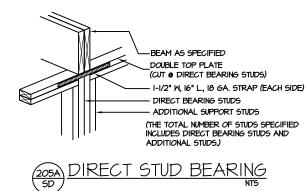

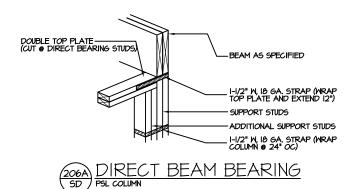

CS-PF: CONTINUOUS PORTAL FRAME CONSTRUCTION DETAIL AND APPLICATION BASED ON NORG FIGURE R602.IO.I - PORTAL FRAME CONSTRUCTION

STRUCTURAL NOTES NC (2018 NCRC): Wind: 115-120 mph

- ENGINEER'S SEAL APPLIES ONLY TO STRUCTURAL COMPONENTS INCLUDING ROOF RAFTERS, HIPS, VALLEY'S, RIDGES, FLOORS, WALLS, BEAMS AND HEADERS, COLUMNS, CANTILEYERS, OFFSET LOAD BEARING WALLS, PIER & GIRDER SYSTEM, FOOTING, AND PILING SYSTEM. ENGINEER'S SEAL DOES NOT CERTIFY DIMENSIONAL ACCURACY OR ARCHITECTURAL LATOUT INCLUDING ROOF SYSTEM. ALL REQUIREMENTS FOR PROFESSIONAL CERTIFICATION SHALL BE PROVIDED BY THE APPROPRIATE PROFESSIONAL. SOUTHERN ENGINEERS, P.A. CERTIFIES ONLY THE STRUCTURAL COMPONENTS AS SPECIFICALLY STATED.
- ALL CONSTRUCTION SHALL CONFORM TO THE LATEST REQUIREMENTS OF THE 2018 NC RESIDENTIAL CODE, PLUS ALL LOCAL CODES AND REGULATIONS. THE STRUCTURAL ENGINEER IS NOT RESPONSIBLE FOR, AND WILL NOT HAVE CONTROL OF, CONSTRUCTION MEANS, METHODS, TECHNIQUES, SEQUENCES OR PROCEDURES, OR FOR SAFETY PRECAUTIONS AND PROGRAMS IN CONNECTION WITH THE CONSTRUCTION WORK, NOR WILL THE ENGINEER BE RESPONSIBLE FOR THE CONTRACTOR'S FAILURE TO CARRY OUT THE CONSTRUCTION WORK IN ACCORDANCE WITH THE CONTRACT DOCUMENTS, "CONSTRUCTION REVIEW" SERVICES ARE NOT PART OF OUR CONTRACT, ALL MEMBERS SHALL BE FRAMED ANCHORED, TIED AND BRACED IN ACCORDANCE WITH GOOD CONSTRUCTION PRACTICE AND THE BUILDING CODE.
- DESIGN LOADS (LISTED AS: LIVE LOAD, DEAD LOAD, DEFLECTION) ROOMS OTHER THAN SLEEPING ROOMS: (40 PSF, IO PSF, L/360)
- SLEEPING ROOMS: (30 PSF, IO PSF, L/360)
- ATTIC WITH PERMANENT STAIR: (40 PSF, IO PSF, L/360) ATTIC WITHOUT PERMANENT STAIR: (20 PSF, IO PSF, L/360)
 ATTIC WITHOUT STORAGE: (10 PSF, IO PSF, L/240)
- STAIRS: (40 PSF, IO PSF, L/360)
- EXTERIOR BALCONIES: (60 PSF, 10 PSF, L/360) DECKS: (40 PSF, 10 PSF, L/360)
- GUARDRAILS AND HANDRAILS: (200 LBS
- PASSSENGER VEHICLE GARAGES: (50 PSF, IO PSF, L/360) FIRE ESCAPES: (40 PSF, IO PSF, L/360)
- SNOW: (20 PSF)
- 4. WALLS SHALL BE BRACED BY SHEATHING WALLS ON ALL STORIES WITH WOOD STRUCTURAL PANELS. SEE FRAMING NOTES FOR THICKNESS AND NAILING REQUIREMENTS
- 5. SEE APPENDIX M (DCA6) FOR EXTERIOR DECK REQUIREMENTS INCLUDING ATTACHMENTS FOR LATERAL LOADS.
- 6. CONCRETE SHALL HAVE A MINIMUM 28 DAY STRENGTH OF 3000 PSI AND A MAXIMUM SLUMP OF 5 INCHES UNLESS NOTED OTHERWISE (UNO). AIR ENTRAINED PER TABLE 402.2. ALL CONCRETE SHALL BE PROPORTIONED, MIXED, HANDLED, SAMPLED, TESTED, AND PLACED IN ACCORDANCE WITH ACI STANDARDS. ALL SAMPLES FOR PUMPING SHALL BE TAKEN FROM THE EXIT END OF THE PUMP, CONTROL JOINTS IN SLABS SHALL BE SPACED ON A GRID OF +30 TIMES THE DEPTH (D). CONTROL JOINTS SHALL BE SAWCUT TO A DEPTH OF 1/D, (I.E. 4" CONCRETE SLABS SHALL HAVE 1/4" DEEP CONTROL JOINTS SANCUT IN SLAB ON A +-10'-0" x +-10'-0" GRID).
- ALLOWABLE SOIL BEARING PRESSURE ASSUMED TO BE 2000 PSF. THE CONTRACTOR MUST CONTACT A GEOTECHNICAL ENGINEER AND THE STRUCTURAL ENGINEER IF UNGATISFACTORY SUBSURFACE CONDITIONS ARE ENCOUNTERED. THE SURFACE AREA ADJACENT TO THE FOUNDATION WALL SHALL BE PROVIDED WITH ADEQUATE DRAINAGE, AND SHALL BE GRADED SO AS TO DRAIN SURFACE WATER AWAY FROM FOUNDATION WALLS.
- 8. ALL FRAMING LUMBER SHALL BE SPF #2 (Fb = 875 PSI) UNLESS NOTED OTHERWISE (UNO). ALL TREATED LUMBER SHALL BE SYP # 2. PLATE MATERIAL MAY BE SPF # 3 OR SYP #3 (Fc(perp) =
- 9. L.V.L. SHALL BE LAMINATED VENEER LUMBER: Fb=2600 PSI, Fv=285 PSI, E=I.9xI0 PSI. P.S.L. SHALL BE PARALLEL STRAND LUMBER: Fb=2400 PSI, Fv=240 PSI, E=2.0xl0 PSI. L.S.L. SHALL BE LAMINATED STRAND LUMBER: Fb=2250 PSI, Fv=400 PSI, E=1.55xl0 PSI. INSTALL ALL CONNECTIONS PER MANUFACTURERS INSTRUCTIONS.
- IO. ALL ROOF TRUSS AND I-JOIST LAYOUTS SHALL BE PREPARED IN ACCORDANCE WITH THE SEALED STRUCTURAL DRAWINGS. TRUSSES AND I-JOISTS SHALL BE INSTALLED ACCORDING TO THE MANUFACTURE'S SPECIFICATIONS. ANY CHANGE IN TRUSS OR I-JOIST LAYOUT SHALL BE COORDINATED WITH SOUTHERN ENGINEERS.
- ALL STRUCTURAL STEEL SHALL BE ASTM A-36. STEEL BEAMS SHALL BE SUPPORTED AT EACH END WITH A MINIMUM BEARING LENGTH OF 3 1/2" INCHES AND FULL FLANGE WIDTH, PROVIDE SOLID BEARING FROM BEAM SUPPORT TO FOUNDATION. BEAMS SHALL BE ATTACHED TO EACH SUPPORT WITH TWO LAG SCREWS (1/2" DIAMETER x 4" LONG). LATERAL SUPPORT IS CONSIDERED ADEQUATE PROVIDING THE JOIST ARE TOE NAILED TO THE SOLE PLATE. AND SOLE PLATE IS NAILED OR BOLTED TO THE BEAM FLANGE @ 48" O.C. ALL STEEL TUBING SHALL BE ASTM A500.
- 12. REBAR SHALL BE DEFORMED STEEL, ASTM615, GRADE 60. LAP ALL REBAR SPLICES 30 BAR
- FLITCH BEAMS SHALL BE BOLTED TOGETHER USING (2) ROWS OF I/2" DIAMETER BOLTS (ASTM A325) WITH WASHERS PLACED UNDER THE THREADED END OF BOLT. BOLTS SHALL BE SPACED AT 24" O.C. (MAX), AND STAGGERED AT THE TOP AND BOTTOM OF BEAM (2" EDGE DISTANCE), WITH 2 BOLTS LOCATED AT 6" FROM EACH END.
- I4. BRICK LINTELS (WHEN REQUIRED) SHALL BE 3 I/2"x3 I/2"x1/4" STEEL ANGLE FOR UP TO 6'-0" SPAN AND 6"x4"x5/16" STEEL ANGLE WITH 6" LEG VERTICAL FOR SPANS UP TO 9'-0". SEE PLANS FOR SPANS OVER 4'-O". SEE ALSO SECTION R703.8.3 LINTELS.

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> **DESIGNS** SOUTH

> > NEW HOME, INC.

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