#### **REVISION LOG**

REVISION:001

ADJUST OPTION SQUARE FOOTAGES TO ACCURATELY SHOW THE DIFFERENCES FROM THE BASE PLAN SQUARE FOOTAGE TOTALS.

- ADJUST OPTION SQUARE FOOTAGES TO ACCURATELY SHOW THE DIFFERENCES FROM THE BASE PLAN SQUARE FOOTAGE TOTALS.

  EXTENDED TRIM AT GARAGE DOOR DOWN TO BASE AND CUT STONE BACK ADJUSTED KITCHEN ISLAND
  RESIZED THE FIREPLACE OPTION
  RELOCATED THE WINDOW IN THE MESSY KITCHEN TO BEHIND THE OPT. SINK CHANGED MESSY KITCHEN WINDOW TO OPTIONAL

- 6. CHANGED MESSY KITCHEN WINDOW TO OPTIONAL
  7. ADDED CHASE TO OWNER'S WIC
  8. ADDED DIMS TO 0. BATH VANITY FOR CLARIFICATION
  9. REMOVED OPT. DOOR TO LOFT
  10. ADDED CHASE TO LOFT IMC
  11. RELOCATED LINEN IN THE 0. BATH OPTIONS
  12. REMOVED THE OPT. SUPER SHOWER (ZERO ENTRY)
  13. FLIPPED SWART DOOR DELIVERY DOOR HANDING
  14. CHANGED ALL UNEN CLOSETS TO HAVE ONLY 4 SHELVES
  15. CHANGED ALL UNEN CLOSETS TO HAVE ONLY 4 SHELVES
  16. UPDATED OPTIONAL SO. FTG. CHART
  17. REMOVED HALF WALLS AT KITCHEN ISLAND AND UPDATED PER CABINET PROVIDER
  18. EXTEND PORCH SLAB 4" AT FRONT AND EXTEND AROUND CORNER 20" TO SUPPORT STONE VENEER
  19. EXTEND PORCH SLAB 4" AROUND THE PERMIETER AT THE "CRAFTSMAN" ELEVATION

REVISION:003 DATE: 3/30/2022

- EXTEND PORCH SLAB 4" AROUND THE PERIMETER AT THE 'CRAFTSMAN' ELEVATION ADDED A COLUMN DETAIL FOR CLARITY ON THE 'CRAFTSMAN' ELEVATION ADDED A SEPARATE OPTION FOR THE POCKET OFFICE WITH THE SMART DELIVERY DOOR ADDED RECEIVED. ALL ALL SHEETS.

2 DC - 4491 Old US 421 Lillington Holly English Country - LH Garage

### PLAN 2 The Holly - LH

### **'ENGLISH COUNTRY' ELEVATION**

# NC.



Α	RCHITECTURAL DRAWINGS
Sheet No.	Sheet Description
0.0	Cover Sheet
1.1	Foundation (Slab)
1.1.1	Foundation Options (Slab)
1.2	Foundation (Crawl)
1.2.1	Foundation Options (Crawl)
2.1	First Floor Plan
2.1.1	First Floor Plan Options
2.2	Second Floor Plan
2.2.1	Second Floor Plan Options
2.4	Covered Patio Plans & Elevations (Slab)
2.4.1	Covered Patio Plans & Elevations (Crawl)
2.5	Covered Patio Cafe Plans & Elevations (Slab)
2.5.1	Covered Patio Cafe Plans & Elevations (Crawl)
2.6	Extended Cafe Plans & Elevations (Slab)
2.6.1	Extended Cafe Plans & Elevations (Crawl)
3.1	Front & Rear Elevations (Slab)
3.1.1	Front & Rear Elevations (Crawl)
3.2	Side Elevations (Slab)
3.2.1	Side Elevations (Crawl)
3.3	Roof Plan
5.1	First Floor Electrical
5.1.1	First Floor Options Electrical
5.2	Second Floor Electrical
5.2.1	Second Floor Options Electrical

#### **DESIGN CRITERIA:**

THIS PLAN IS TO BE BUILT IN CONFORMANCE WITH THE 2018 NORTH CAROLINA STATE BUILDING CODE: RESIDENTIAL CODE

DIMENSIONS SHALL GOVERN OVER SCALE, AND CODE SHALL

SQUARE FOOTAGE									
	ENGLISH (	COUNTRY							
	UNHEATED	HEATED							
FIRST FLOOR	0	872							
SECOND FLOOR	0	1337							
FRONT PORCH	127	0							
2 CAR GARAGE	437	0							
PATIO	160	0							
SUBTOTALS	724	2209							
TOTAL UNDER ROOF	29	33							
OI	PTIONS								
	UNHEATED S.F.	HEATED S.F.							
EXTENDED PATIO	+148	0							
COVERED PATIO	160	0							
EXTENDED CAFE	0	+152							
REAR POCKET OFFICE	0	+60							
FRONT POCKET OFFICE	0	+39							
FRONT PORCH W/	142	•							
FRONT POCKET OFFICE	142 0								
FRONT POCKET OFFICE	CE 0 +61								
W/ SMART DOOR									




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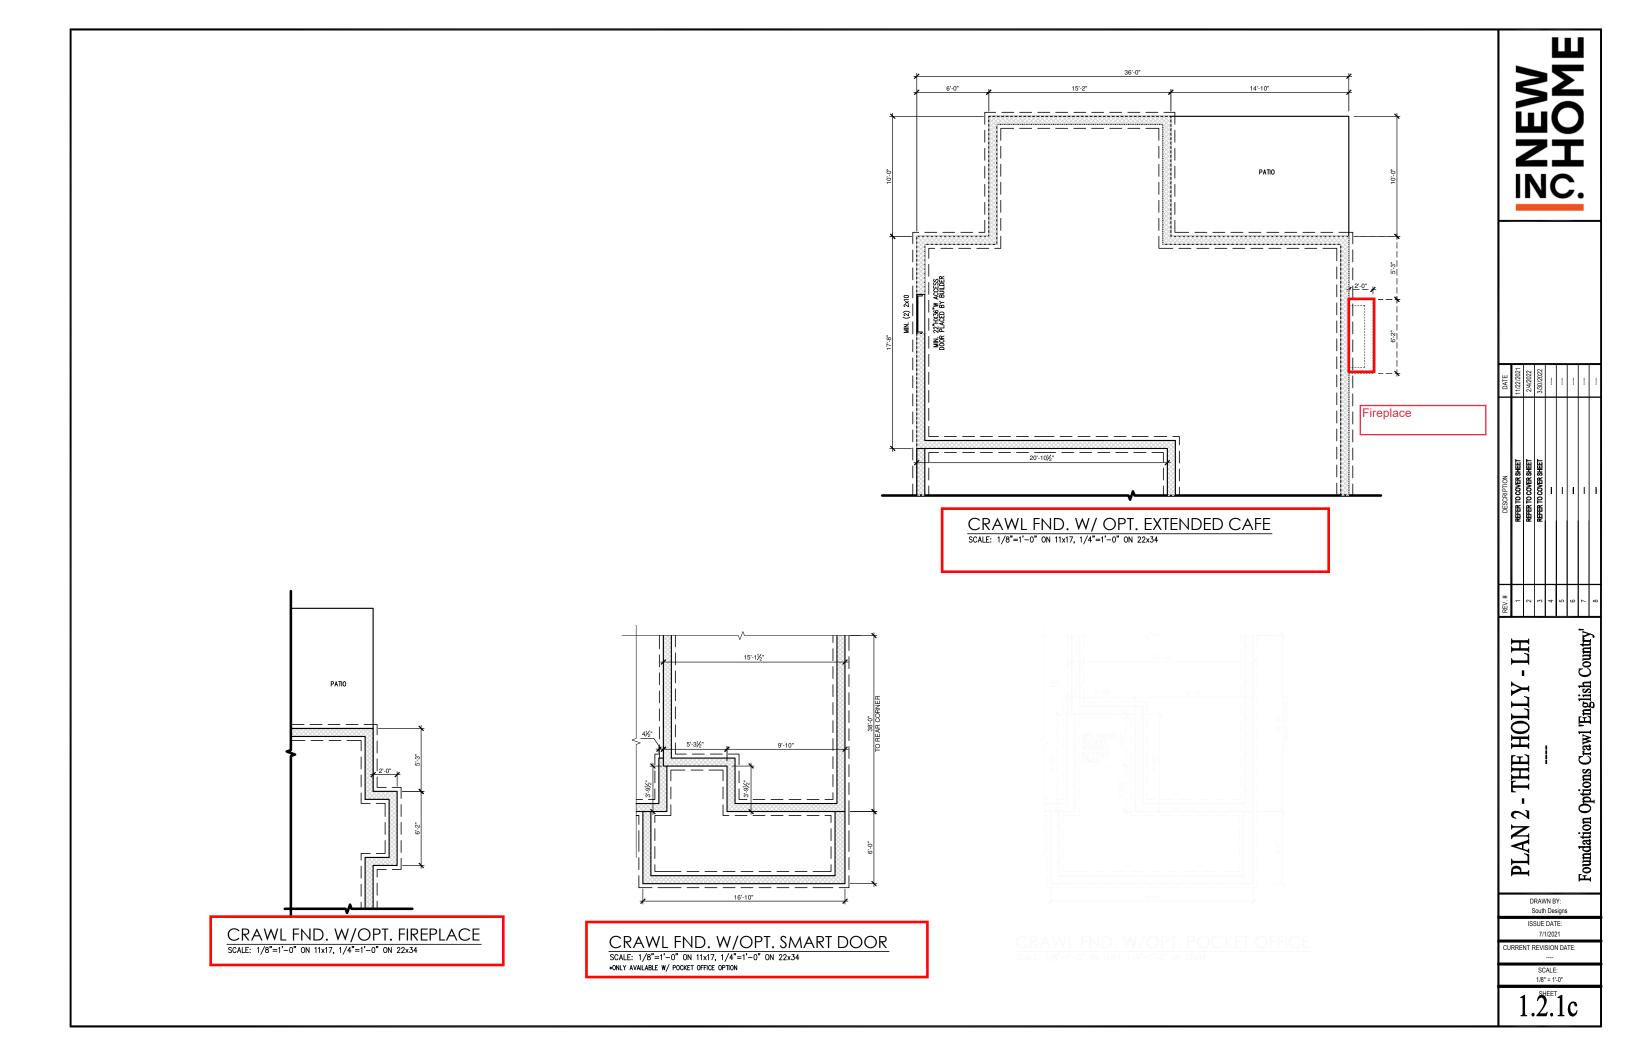
Cover Sheet 'English Country - THE HOLLY PLAN 2.

South Designs ISSUE DATE: 7/1/2021 URRENT REVISION DATE

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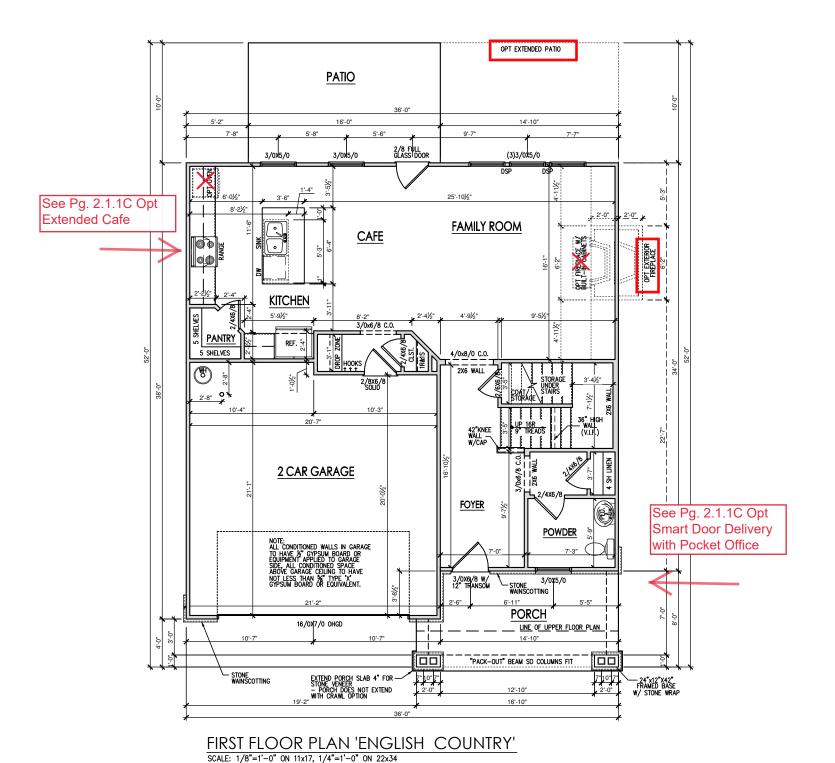
1/8" = 1'-0"



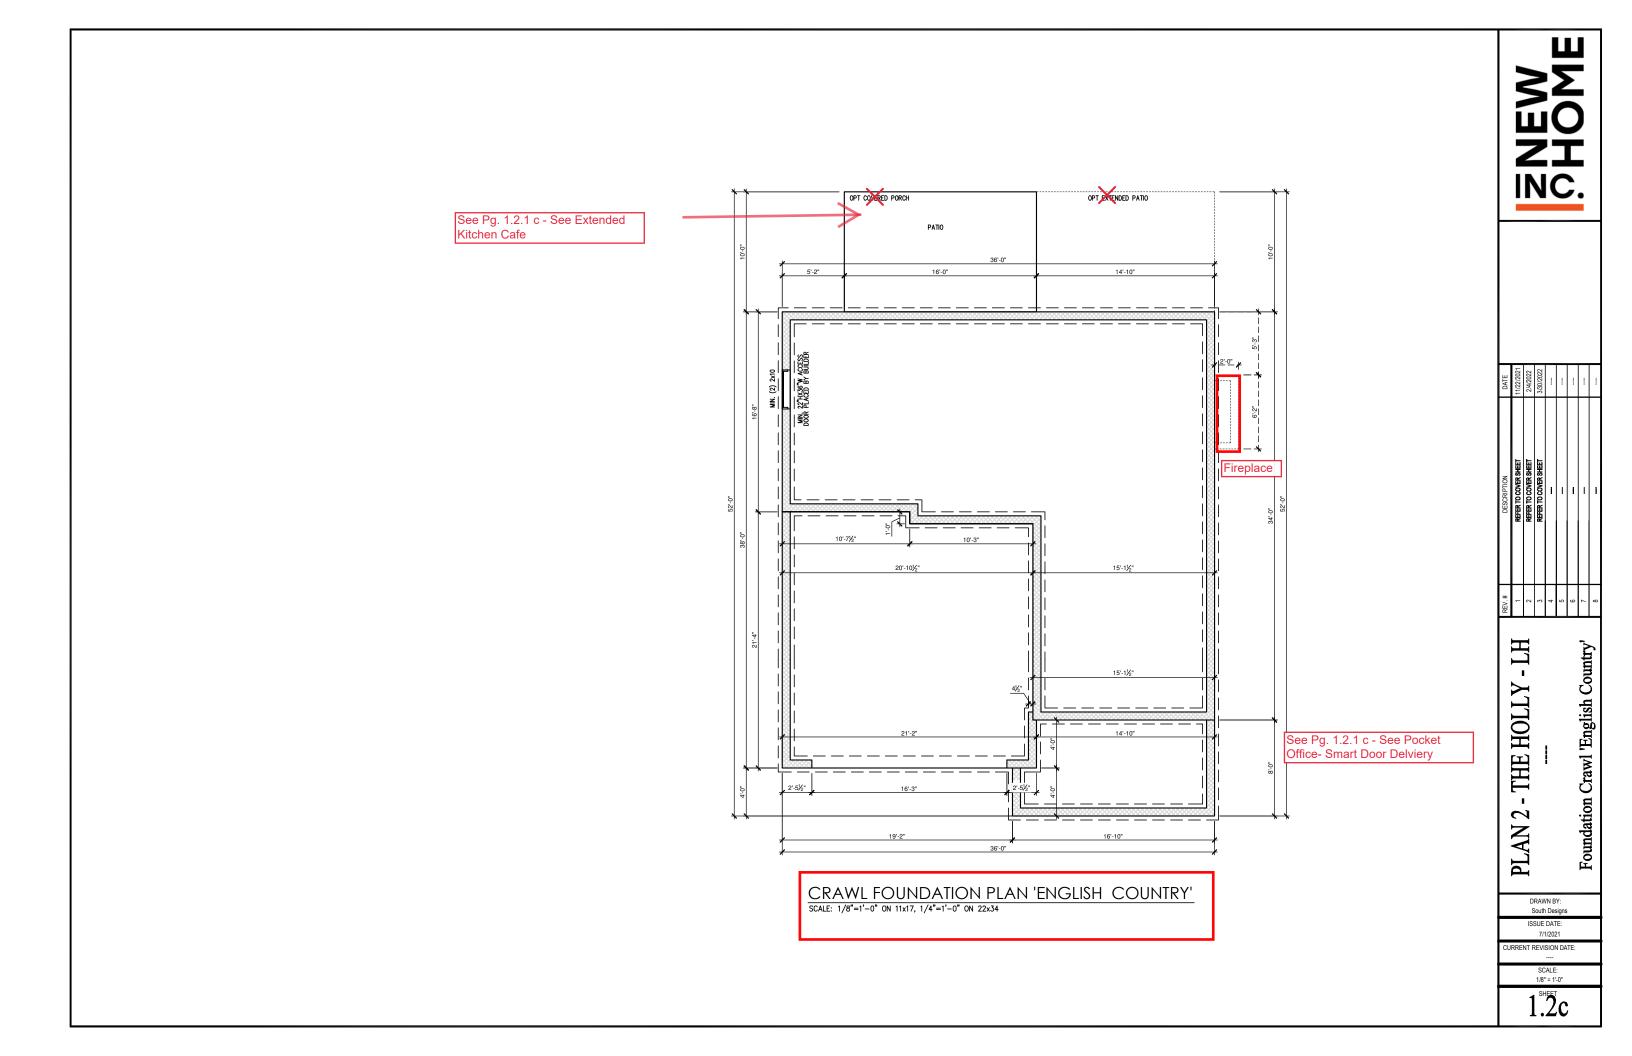

General Floor Plan Notes shall apply unless noted otherwise on plan.

- Wall Heights: Typically 9'-1 1/2" at first floor and 8'-1 1/2" at second floor and attics U.N.O. All walls are constructed using a double top plate. Splices at Double Top Plate do not need to occur at Vertical Studs but must be at least 24" apart from Joint in other Top Plate layer. Special wall heights are noted on plans where they occur.
- Wall Thickness is typically 3 1/2". 2x6 frame shall be used at walls that back up to plumbing fixtures.
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- Jacks: Openings up to 3'-4" wide shall have (1) 2x4 jack stud SPF on each side. Openings greater than 3'-4" wide shall have (2) 2x4 jack studs SPF on each side.
- Soffits, Coffered Ceilings, Trey Ceilings and other significant ceiling plan elements are shown on the floor plans and are denoted as single dashed lines. Unless specifically call out as included, Kitchens do not include soffits over wall cabinetry.
- Door & Window Frames, where occurring near corners, shall be a minimum of 4 1/2" from corner. Except for walk-in closets with doors near a corner, doors at closets shall be centered on closet.
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- Stair treads shall be a min of 9" deep, risers shall be a maximum of 8 1/4", unless noted otherwise, per the current North Carolina Residential Code
- 10. Handrails and Guards at stairs shall be 34" above the finished surface of the ramp surface of the stair. Handrails at landings and overlooks of multilevel spaces shall be 36" above finished floor. Guards (pickets or balusters) shall be spaced with no more than 4" between guards.
- Attic Access shall be provided at all attic area with a height greater than 30°. Minimum clear attic access shall be 20° x 30°. Pull down stairs and access doors in knee walls meeting minimum criteria are also acceptable.
- 12. Garage Door to Living Space shall be 2'-8" x 6'-8" minimum size and shall be 20 minute fire rated and weather sealed.
- 13. Garage Walls, as a minimum, shall be separated from living space by installing 1/2" gypsum board on the garage side of the wall. With habitable space above, the inside of all garage walls require 1/2" GWB supporting 5/8" type X GWB on ceiling.



NEW PHOME

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PLAN 2 - THE HOLLY

Plan 'English Country'

First Floor

DRAWN BY: South Designs


ISSUE DATE: 7/1/2021


CURRENT REVISION DATE:
---SCALE:
1/8" = 1'-0"

2.1c

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THE HOLLY - LH
--1 Options 'English Country'

DRAWN BY:
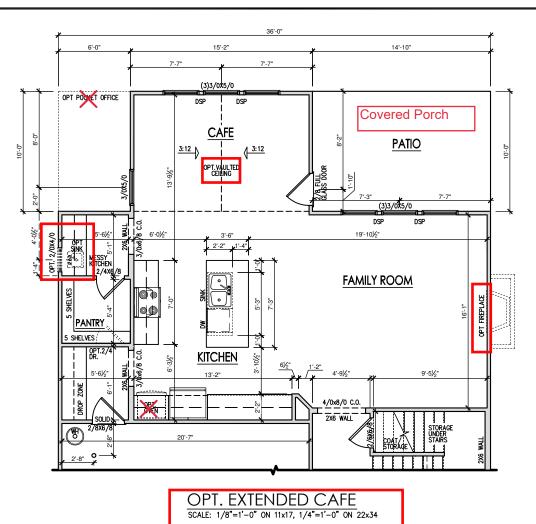
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First Floor Plan

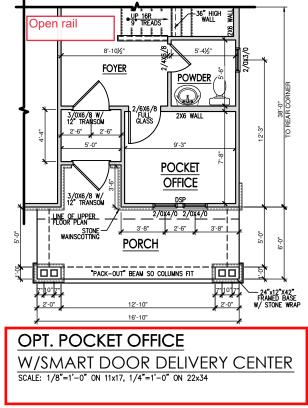
South Designs
ISSUE DATE:
7/1/2021

CURRENT REVISION DATE:
---SCALE:
1/8" = 1'-0"

2.1.1c

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SCALE: 1/8"=1'-0" ON 11x17, 1/4"=1'-0" ON 22x34

NEW SHOME

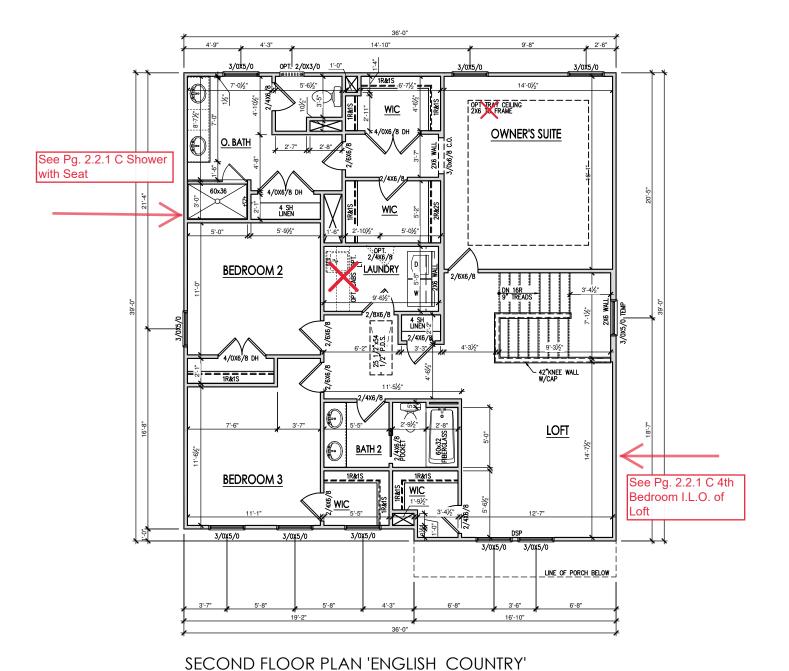PLAN 2 - THE HOLLY ---- Country

Plan 'English

Second Floor

DRAWN BY: South Designs

ISSUE DATE:


7/1/2021 CURRENT REVISION DATE:

> SCALE: 1/8" = 1'-0"

2.2c

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OPT. BEDROOM 4 ILO LOFT SCALE: 1/8"=1'-0" ON 11x17, 1/4"=1'-0" ON 22x34

16'-10"

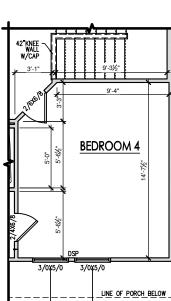


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- THE HOLLY ~ **PLAN**  Second Floor Plan Options 'English Country'

South Designs

ISSUE DATE: 7/1/2021

CURRENT REVISION DATE: SCALE: 1/8" = 1'-0"

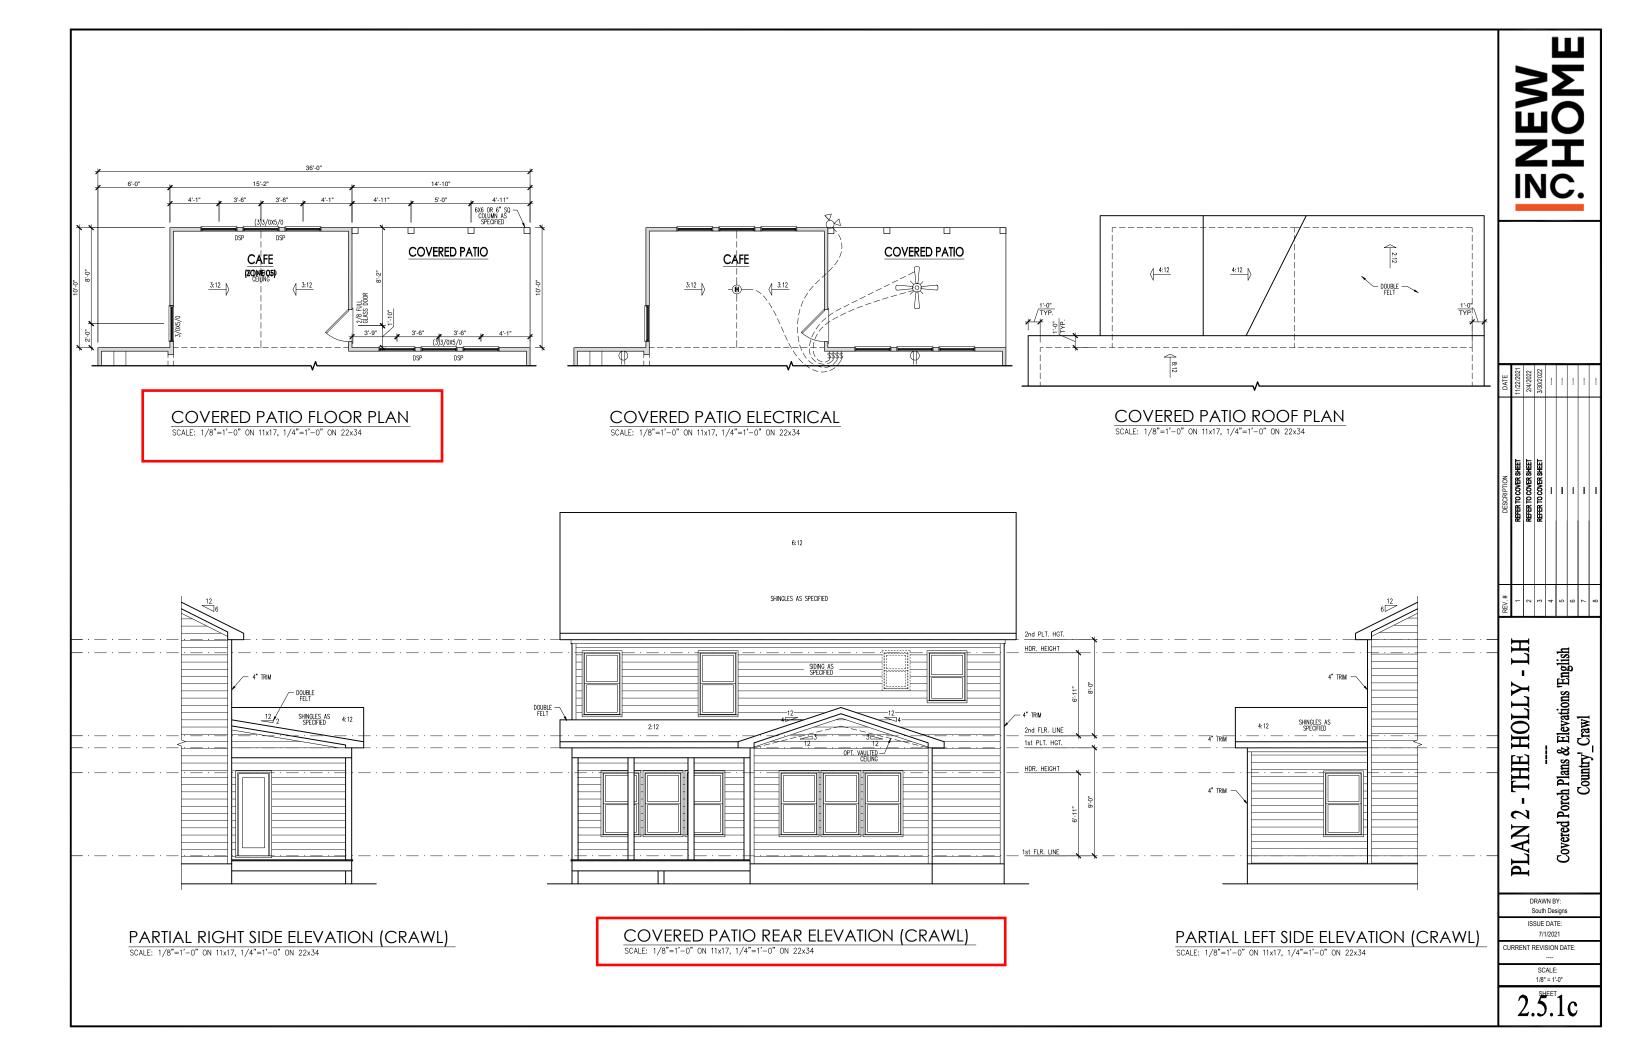

#### **General Elevation Notes**

General Elevation Notes shall apply unless noted otherwise on plan.


- Roof shall be finished with architectural composition shingles with slopes as noted on plan.
- Ridge Vent shall be provided and installed on all ridges greater than 6' in length per manufacturer's specifications.
- 3. Soffit Vent shall be continuous soffit vent
- House Wrap, "tyvek" or approved equal shall be installed over entire exterior wall per manufacturer's specifications and recommendations.
- Flashing shall be provided above all door and window openings, above finish wall material changes and at wall surfaces where lower roof areas abut vertical wall surfaces.
- Porch Railings shall be provided at all porch walking surfaces greater than 30" above adjacent finished grade. It shall be 36" high with guards spaced no more than 4" apart. Consult community specifications for material.
- Finish Wall Material shall be as noted on elevation drawings.
- 8. Brick Veneer, if included on elevation shall be fled to wall surface with galvanized corrugated metal fles at a rate of 24" oc horizontally and 16" oc vertically so that no more than 2.67sf of brick is supported by (1) fle. Space between face of wall and back face of brick shall be limited to a maximum of 1". Flashing shall be provided behind brick above all wall openings and at base of brick wall. Rashing shall be a minimum of 6-mil poly or other corrosion resistant material and shall be installed so that it laps under the house wrap material a minimum of 2".


  Weepholes shall be provided at a rate of 48" oc and shall not be less than 3/16" in diameter and shall be located immediately above flashing.
- Brick Veneer Support Lintels shall be provided if brick veneer is included on elevation. Lintels shall be provided as listed in the following schedule and shall have a minimum bearing length of 6". Masonry Lintels shall be provided so that deflection is limited to L/600.

Masonry Opening Lintel Schedule

ning Size Ang

		-		_
u	p to	4'-0"		3-1/2" x 3-1/2" x 5/1
4	1'-1"	to	5'-6"	4" x 3-1/2" x 5/16" LL
5	5'-7"	to	6'-6"	5" x 3-1/2" x 5/16" LL
6	5'-7"	to	8'-4"	6" x 3-1/2" x 5/16" LL
9	2'-5"	to.	14'-4"	7" ~ 4" ~ 3/9" !!\/

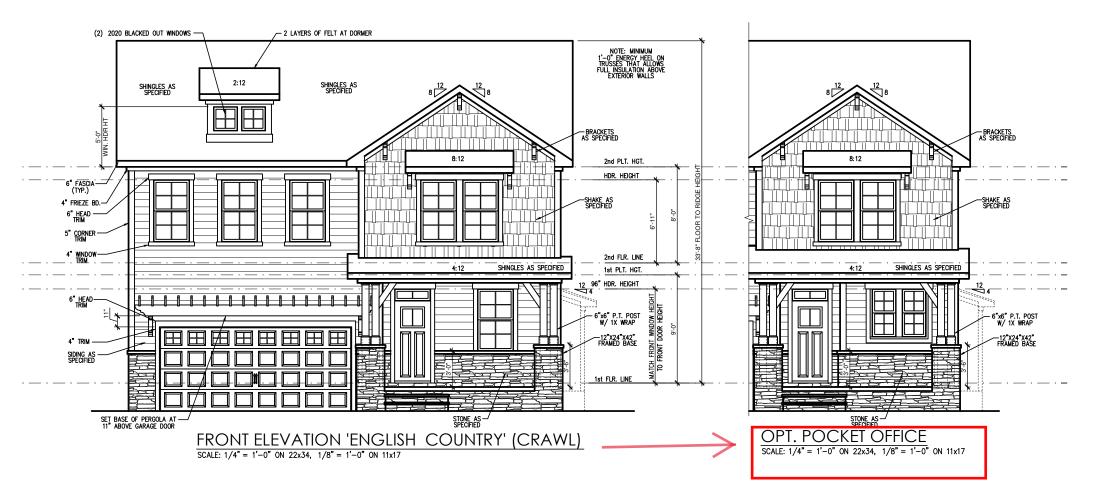

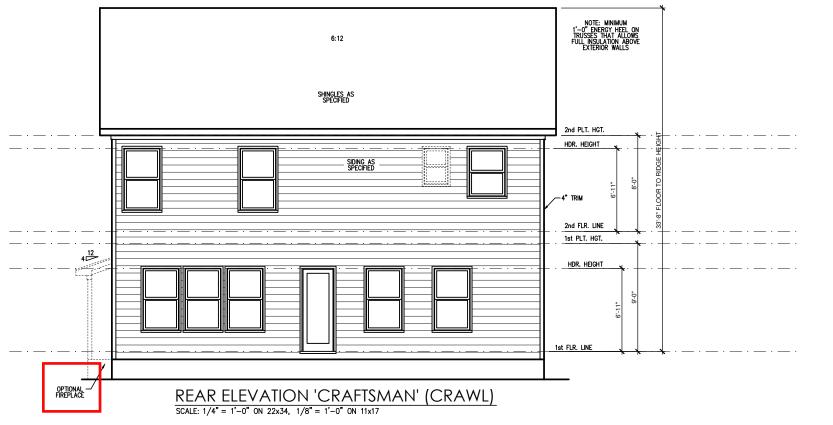



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PLAN 2 - THE HOLLY
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Front & Rear Elevations 'English Country'\_Craw

DRAWN BY: South Designs

7/1/2021 CURRENT REVISION DATE:

> SCALE: 1/8" = 1'-0"


#### **General Elevation Notes**


General Elevation Notes shall apply unless noted otherwise on plan.

- Roof shall be finished with architectural composition shingles with slopes as noted on plan.
- Ridge Vent shall be provided and installed on all ridges greater than 6' in length per manufacturer's specifications.
- 3. Soffit Vent shall be continuous soffit vent
- House Wrap, "tyvek" or approved equal shall be installed over entire exterior wall per manufacturer's specifications and recommendations.
- Flashing shall be provided above all door and window openings, above finish wall material changes and at wall surfaces where lower roof areas abut vertical wall surfaces.
- Porch Railings shall be provided at all porch walking surfaces greater than 30" above adjacent finished grade. It shall be 36" high with guards spaced no more than 4" apart. Consult community
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Masonry Openina Lintel Schedule

	-		•
up to	4'-0'		3-1/2" x 3-1/2" x 5/16"
4'-1"	to	5'-6"	4" x 3-1/2" x 5/16" LLV
5'-7"	to	6'-6"	5" x 3-1/2" x 5/16" LLV
6'-7"	to	8'-4"	6" x 3-1/2" x 5/16" LLV
8'-5"	to	16'-4"	7" x 4" x 3/8" LLV



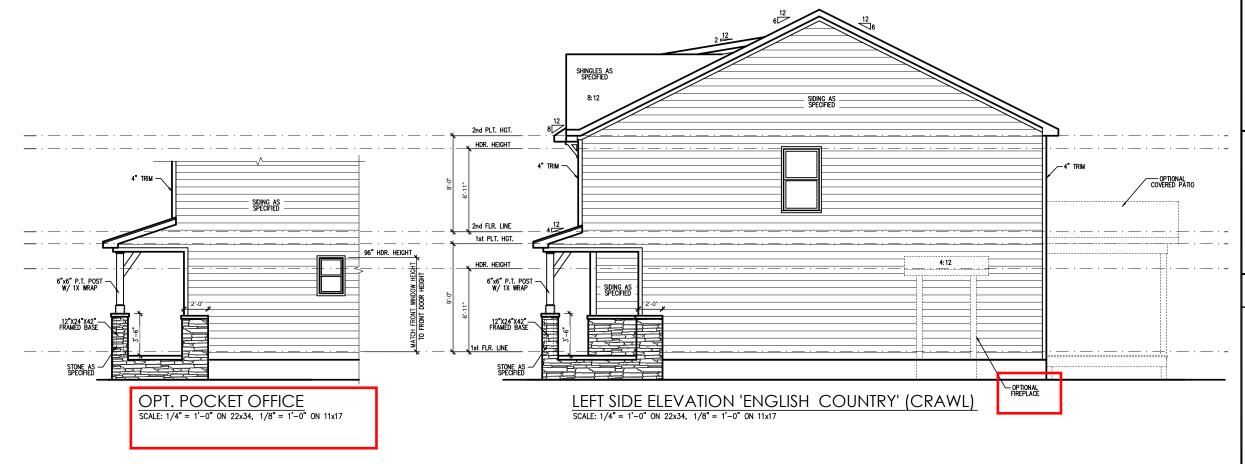


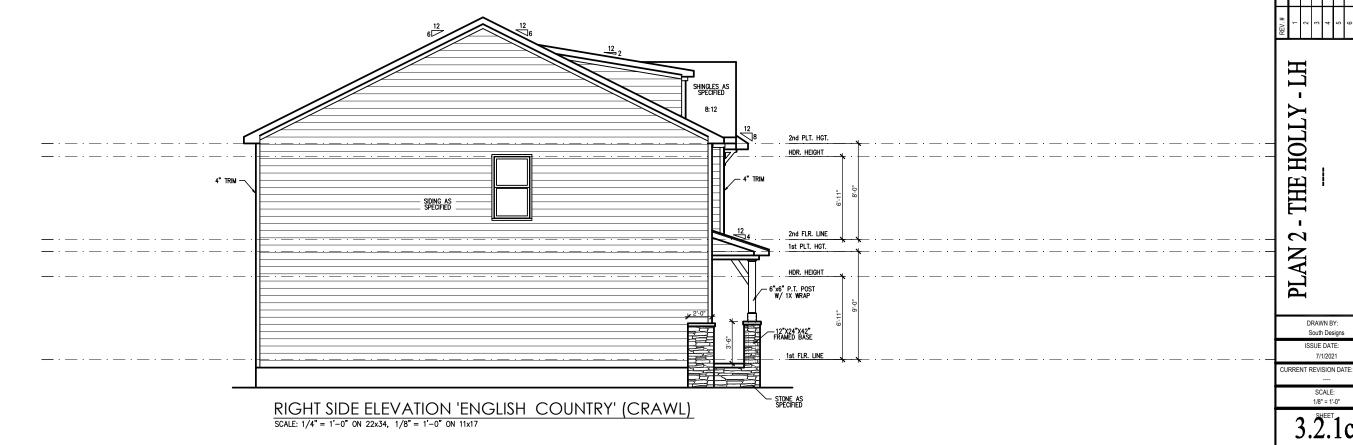Crawl

Side Elevations 'English Country'

				ATTIC '	VENT S	CHEDU	LE				
				EN	GLISH CO	UNTRY					
MAIN	HOUSI	Ē	SQ FTG	1393	AT / NEAR RIDGE			AT / NEAR EAVE			
VENT TYPE	SQ. FT.				PECILIPED SQ. FI.		POT LARGE (SQ. FT. EACH)	POT SMALL (SQ. FT. EACH)	RIDGE VENT (SQ. FT. PER LF)	EAVE VENT (SQ. IN. EACH)	CONT. VEN
*ENTTH E		NGE	SUPPLIED	OF TOTAL SUPPLIED	0.4236	0.2778	0.125	0.1944	0.0625		
RIDGE VENT	1.86	2.32	3.00	44.44	0	0	24.00				
SOFFIT VENTS	2.79	2.32	3.75	55.56				0	60.00		
TOTAL (MIN)	OTAL (MIN) 4.64 4.64 6.75 100.00 POT VENTS MAY BE REQUIRED IF THERE IS INSUFFICIENT RIDGE AVAILABLE										
SCHEDITE HAS	DEEN C	I CHILATE	D ACCUMING	AVE VENTUA	TON AT 50_60%	OF TOTAL AND E	DIDGE AT AD-50%	OF TOTAL PROLL	IDEN VENTILAT		

schedule has been calculated assuming eave ventilation at 50–60% of total and ridge at 40–50% of total required ventilatio

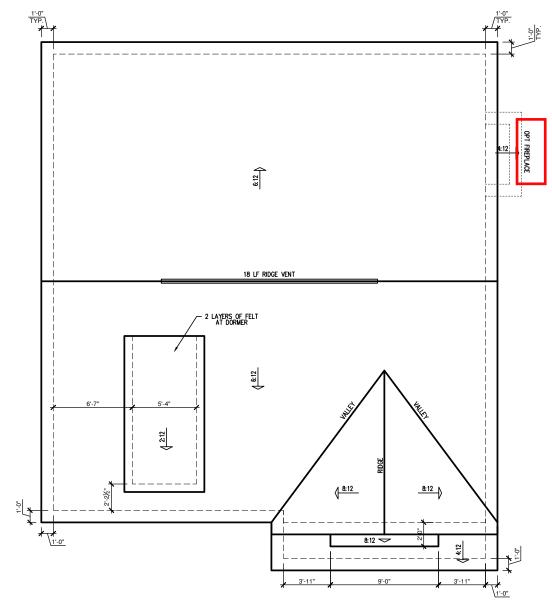

ENGLISH COUNTRY ROOF PLAN SCALE: 1/4" = 1'-0" ON 22x34, 1/8" = 1'-0" ON 11x17

DATE	1/22/2021	2/4/2022	3/30/2022	!		!	!	-			
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PLAN 2 - THE HOLLY - LH ---

Roof Plan 'English Country'

DRAWN BY: South Designs ISSUE DATE:

ISSUE DATE:
7/1/2021
CURRENT REVISION DATE:

SCALE: 1/8" = 1'-0"

3.3c

- WOOD "I" JOISTS (SHALL BE ONE OF THE FOLLOWING):
- TJI 210 BY TRUS JOIST LPI 20 PLUS BY LP
- BCI 5000s I.8 BY BC
- ALL WOOD "I"JOISTS SHALL BE INSTALLED ACCORDING TO MANUFACTURER'S SPECIFICATIONS.
- INSTALL SQUASH BLOCKS, WEB STIFFENERS, ETC. AS REQUIRED BY AND ACCORDING TO THE I-JOIST MANUFACTURER'S SPECIFICATIONS
- HANGERS FOR I-JOISTS ARE THE RESPONSIBILITY OF THE I-JOIST SUPPLIER.
- FLOOR TRUSSES BY MANUFACTURER MAY BE SUBSTITUTED FOR I-JOISTS.

#### TRUSS SYSTEM REQUIREMENTS NC (2018 NCRC): Wind: 115-120 mph

- TRUSS SYSTEM LAYOUTS (PLACEMENT PLANS)
  SHALL BE DESIGNED IN ACCORDANCE WITH SEALED STRUCTURAL PLANS. ANY NEED TO CHANGE TRUSSES SHALL BE COORDINATED WITH SOUTHERN
- TRUSS SCHEMATICS (PROFILES) SHALL BE 2. PREPARED AND SEALED BY TRUSS MANUFACTURER.
- ALL TRUSSES SHALL BE DESIGNED FOR BEARING ON SPF #2 OR #3 PLATES OR LEDGERS (UNO).
- ALL REQUIRED ANCHORS FOR TRUSSES DUE TO UPLIET OR BEARING SHALL MEET THE REQUIREMENTS AS SPECIFIED ON THE TRUSS SCHEMATICS.


#### FOUNDATION STRUCTURAL NOTES NC (2018 NCRC): Wind: 115-120 mph - CRAWL

- $\langle I. \rangle$ (3)2xIO SYP#2 OR SPF#2 GIRDER, TYPICAL UNO.
- 2 CONCRETE BLOCK PIER SIZE SHALL BE: <u>SIZE</u> 8x16 HOLLOW UP TO 32" <u>SOLID</u> UP TO 5'-0" 12x16 UP TO 48" UP TO 9'-0" UP TO 64" UP TO 12'-0" 16x16
- UP TO 96" WITH 30" x 30" x 10" CONCRETE FOOTING, UNO.
- 3 WALL FOOTING AS FOLLOWS
  DEPTH: 8" - UP TO 2 STORY 10" - 3 STORY MIDTH:

16" - UP TO 2 STORY SIDING: 20" - 3 STORY 16" - I STORY BRICK: 20" - 2 STORY 24" - 3 STORY

- FOR FOUNDATION WALL HEIGHT AND BACKFILL REQUIREMENTS, REFER TO CODE TABLE R404.I.I (I THRU 4) NOTE: ASSUMED SOIL BEARING CAPACITY = 2000 PSE CONTRACTOR MUST VERIEY SITE CONDITIONS AND CONTACT SOILS ENGINEER IF MARGINAL OR UNSTABLE SOILS ARE ENCOUNTERED.
- (4) 2xIO SPF #2 OR SYP #2 GIRDER
- (5) (2) 1.75x9.25 LVL OR LSL GIRDER
- (3) 1.75x4.25 LVL OR LSL GIRDER
- "■" DESIGNATES A SIGNIFICANT POINT LOAD TO HAVE SOLID BLOCKING TO PIER, SOLID BLOCK ALL BEAM BEARING POINTS NOTED TO HAVE THREE OR MORE STUDS TO FND, TYPICAL
- ABBREVIATIONS:
- "SJ" = SINGLE JOIST "DJ" = DOUBLE JOIST
- "TJ" = TRIPLE JOIST
- 9. ADJUST SUBFLOOR THICKNESS OR JOIST SPACING AS REQ'D FOR FLOOR FINISH MATERIALS.



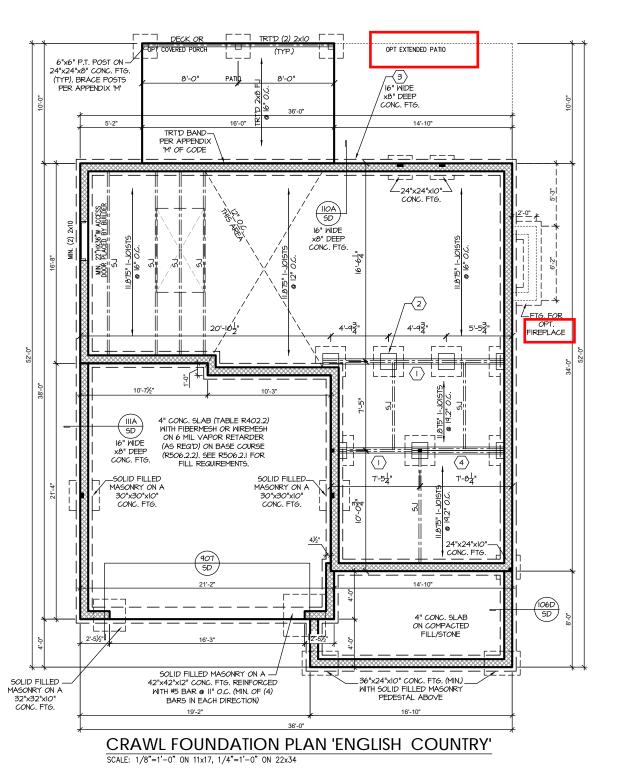

SOUTH DESIGNS

PROJECT #

21-2816-LH

ons. s are to be brought to the ers. Failure to do so will

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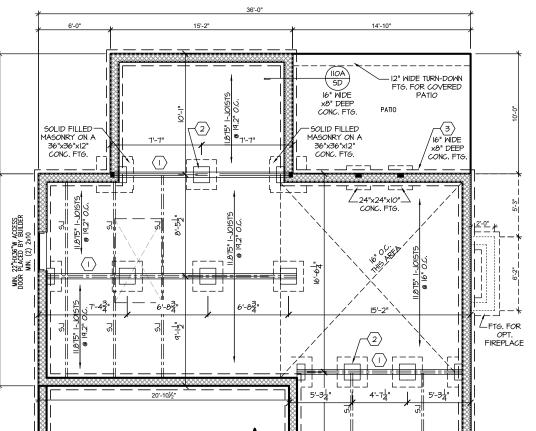
Southern Engineers, F 3716 Benson Drive, Raleigh, NC 27 Phone: (919) 878-1617

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 $\sim$ Plan


REFER TO "SD" SHEET(S) FOR STANDARD DETAILS, BRACING DETAILS AND STRUCTURAL NOTES.

S-1.





CRAWL FND. W/ OPT. EXTENDED CAFE SCALE: 1/8"=1'-0" ON 11x17, 1/4"=1'-0" ON 22x34

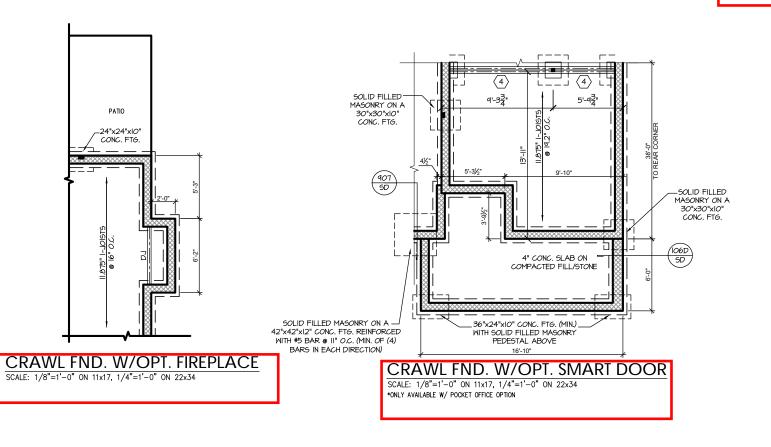

Engineers seal appues only to succession decounent.

document.

Seal does not include construction means, methods, techniques, sequences, procedures or safety precautions.

Any deviations or discrepancies on plans are to be brought to the immediate attention of Southern Engineers. Failure to do so will void Southern Engineers. Failure to do so will void Southern Engineers liability.

Seal is valid for projects permitted one year from date of seal.

Use of these plans constitutes approval of terms & conditions as defined in the customer agreement. P.A. 27609 Southern Engineers, P 3716 Benson Drive, Raleigh, NC 27 Phone: (919) 878-1617

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S-1.2

REFER TO "SD" SHEET(S) FOR STANDARD DETAILS, BRACING DETAILS AND STRUCTURAL NOTES.

- PORCH POST NOTES:

  4x4 (6x6) TRT'D POST (OR EQUAL).
- ATTACH TRUSSES (RAFTERS) AT PORCH WITH HURRICANE CONNECTORS.
- POST CAP: SIMPSON AC4-MAX (AC6-MAX)
  POST CAP AT CORNER: (2) SIMPSON LCE4 (MITER HEADER AT CORNER). HIGH WIND, ADD (I)
- SIMPSON H6. 3. POST BASE: SIMPSON ABU44 (ABU66).
- MONO: 5/6" ANCHOR (EMBED 7")
  CMU: 5/6" ANCHOR (EXTEND TO FOOTING
- HIGH WIND ONLY) POST BASE: WOOD FOUNDATION: (2) SIMPSON CSI6 STRAPS AT POSTS EXTEND 12" ONTO EACH POST (UPPER AND LOWER) OR TO GIRDER.
- NOTE: EQUIVALENT POST CAP AND BASE ACCEPTABLE.

#### HEADER/BEAM & COLUMN NOTES

- ALL EXTERIOR AND LOAD BEARING HEADERS SHALL BE MIN. (2)2x6 (4" WALL) OR (3)2x6 (6" WALL) WITH (I) SUPPORT STUD, UNLESS NOTED
- 2. THE NUMBER SHOWN AT BEAM AND HEADER SUPPORTS INDICATES THE NUMBER OF SUPPORT STUDS REQUIRED IN STUD POCKET OR COLUMN. THE NUMBER OF KING STUDS AT EACH END OF HEADERS IN EXTERIOR WALLS SHALL BE ACCORDING TO ITEM "d" IN TABLE R602.3(5) OR AS BELOW PER NODOL COMMENTARY "KING STUDS AT WALL OPENINGS" REVISED I-9-2020:
  UP TO 3' SPAN: (I) KING STUD
- OVER 3' UP TO 6' SPAN: (2) KING STUDS
- OVER 6' UP TO 9' SPAN: (3) KING STUDS
- OVER 9' UP TO 12' SPAN: (4) KING STUDS OVER 12' UP TO 15' SPAN: (5) KING STUDS

#### WOOD "I" JOISTS

- (SHALL BE ONE OF THE FOLLOWING) TJI 210 BY TRUS JOIST
- LPI 20 PLUS BY LP
- BCI 5000s I.8 BY BC
- ALL WOOD "I"JOISTS SHALL BE INSTALLED ACCORDING TO MANUFACTURER'S SPECIFICATIONS.
- INSTALL SQUASH BLOCKS, WEB STIFFENERS, ETC. AS REQUIRED BY AND ACCORDING TO THE I-JOIST MANUFACTURER'S SPECIFICATIONS
- HANGERS FOR I-JOISTS ARE THE RESPONSIBILITY OF THE I-JOIST SUPPLIER.
- FLOOR TRUSSES BY MANUFACTURER MAY BE SUBSTITUTED FOR I-JOISTS.

#### TRUSS SYSTEM REQUIREMENTS NC (2018 NCRC): Wind: 115-120 mph


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- TRUSS SCHEMATICS (PROFILES) SHALL BE PREPARED AND SEALED BY TRUSS MANUFACTURER.
- ALL TRUSSES SHALL BE DESIGNED FOR BEARING ON SPF #2 OR #3 PLATES OR LEDGERS (UNO).
- ALL REQUIRED ANCHORS FOR TRUSSES DUE TO UPLIFT OR BEARING SHALL MEET THE REQUIREMENTS AS SPECIFIED ON THE TRUSS

#### FRAMING NOTES

NC (2018 NCRC): Wind: 115-120 mph

- BRACING METHOD AND TYPE: CONTINUOUSLY SHEATHED WSP: C5-WSP. NOTE THAT THE WALL BRACING AMOUNT PROVIDED ON THE PLANS NOTE THAT THE WALL DRAWING AMOUNT PROVIDED ON THE FLAND (DETAILS AND SPECIFICATIONS) IS GREATER THAN THE AMOUNT OF WALL BRACING REQUIRED BY SECTION R602.10 OF THE CODE. SEE NOTES BELOW FOR DETAILS AND SPECIFICATIONS FOR WALL BRACING AND WALL FRAMING.
- 2. EXTERIOR WALL SHEATHING: WALLS SHALL BE BRACED BY SHEATHING WALLS ON ALL STORIES WITH WOOD STRUCTURAL PANEL SHEATHING (WSP) (EXPOSURE B: 7/16". EXPOSURE C: 15/32"). SHEATHING SHALL BE ATTACHED WITH 8d NAILS AT A 6"/12" NAILING PATTERN (6" OC AT PANEL EDGES AND 12" OC AT INTERMEDIATE SUPPORTS). INSTALL BLOCKING AT ALL PANEL EDGES.
- 3. WSP SHEATHING SHALL EXTEND TO THE UPPERMOST DOUBLE BEARING PLATE, BLOCK AT ROOF PER SECTION R602.IO.4.5 AND ATTACH BRACED WALLS PER CODE, WEP SHEATHING BETWEEN FLOORS SHALL BE SPLICED ALONG CONTINUOUS BAND OR THE WSP SHEATHING MAY BE SPLICED ACROSS STUDS (CONTINUOUS ACROSS FLOOR SYSTEM) WITH BLOCKING AT PANEL EDGES. (MINIMUM 12" BEYOND FLOOR BREAK) OR OTHER APPROVED METHOD.
- 4. "HD" = HOLDOWN: HOLD-DOWN DEVICE (NOTED AS "HD" ON PLANS)
  SHALL BE AN 800 POUND CAPACITY ASSEMBLY AS NOTED ON PLANS,
  SEE DETAILS FOR HD ASSEMBLY.
- \*\*GROUND/FIRST FLOOR: USE "HD HOLD-DOWN DETAIL" ON SD SHEET
- \*\*UPPER FLOORS: ATTACH BASE OF KING STUD WITH A SIMPSON C522
  STRAP DOWN ACROSS THE BAND AND DOWN TO A STUD BELOW OR
  HEADER BELOW. EXTEND STRAP TI MIN ALONG EACH STUD (OR HEADER) AND ATTACH EACH END W/ (7) 8d NAILS.
- 5. INTERIOR BRACED WALL: (NOTED AS "IBW" ON PLANS) ATTACH I/2" GYPSUM BOARD (GB) ON EACH SIDE OF WALL WITH A MIN. OF 5d COOLER NAILS OR #6 SCREWS ® 7" O.C. ALONG THE EDGES AND AT INTERMEDIATE SUPPORTS.
- 6. INTERIOR BRACED WALL-WOOD STRUCTURAL PANEL: (NOTED AS "IBM-MSP" ON PLANS). ATTACH ONE SIDE WITH %" MSP SHEATHING WITH 80 NAIL 15 AT A 6"7.0" MAIL 11.5 ATTACH (") WITH 80 NAILS AT A 6"/12" NAILING PATTERN (6" OC AT PANEL EDGES AND 12" OC AT INTERMEDIATE SUPPORTS). INSTALL BLOCKING AT ALL PANEL EDGES. ATTACH GB OVER WSP AS REQUIRED. ATTACH OPPOSITE SIDE WITH I/2" GB WITH A MIN. OF 5d COOLER NAILS OR #6 SCREMS @ 7" OC ALONG THE EDGES AND AT INTERMEDIATE

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#### FIRST FLOOR PLAN 'ENGLISH COUNTRY'

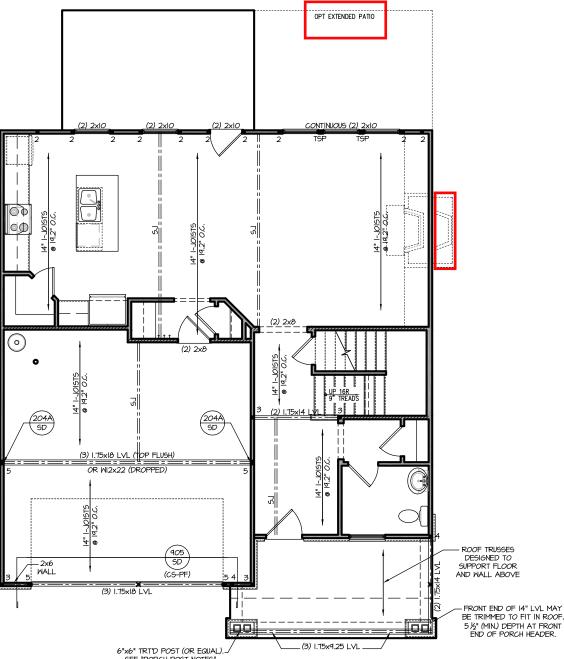SCALE: 1/8"=1'-0" ON 11x17, 1/4"=1'-0" ON 22x34

PROJECT # 21-2816-LH

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Southern Engi 3716 Benson Drive, Ral Phone: (919) 8

**DESIGNS** 

SOUTHI

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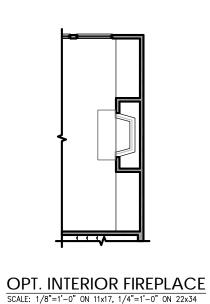
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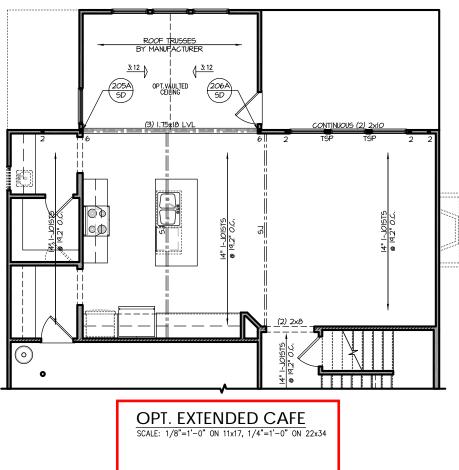
Plan

REFER TO "SD" SHEET(S) FOR STANDARD DETAILS BRACING DETAILS AND STRUCTURAL NOTES. www.southernengineers.com



205A SD







6"x6" TRT'D POST (OR EQUAL). J SEE "PORCH POST NOTES"

ROOF TRUSSES
DESIGNED TO SUPPORT
PORTION OF FLOOR AND
WALL ABOVE OPT. POCKET OFFICE SCALE: 1/8"=1'-0" ON 11x17, 1/4"=1'-0" ON 22x34

REFER TO "SD" SHEET(S) FOR STANDARD DETAILS, BRACING DETAILS AND STRUCTURAL NOTES.

PROJECT # 21-2816-LH

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SOUTH DESIGNS

The Holly NEW HOME, INC. 2

Plan

#### TRUSS SYSTEM REQUIREMENTS

NC (2018 NCRC): Wind: 115-120 mph

- TRUSS SYSTEM LAYOUTS (PLACEMENT PLANS) SHALL BE DESIGNED IN ACCORDANCE WITH SEALED STRUCTURAL PLANS, ANY NEED TO CHANGE TRUSSES SHALL BE COORDINATED WITH SOUTHERN
- 2. TRUSS SCHEMATICS (PROFILES) SHALL BE PREPARED AND SEALED BY TRUSS MANUFACTURER.
- ALL TRUSSES SHALL BE DESIGNED FOR BEARING ON SPF #2 OR #3 PLATES OR LEDGERS (UNO).
- ALL REQUIRED ANCHORS FOR TRUSSES DUE TO UPLIFT OR BEARING SHALL MEET THE REQUIREMENTS AS SPECIFIED ON THE TRUSS

#### HEADER/BEAM & COLUMN NOTES

- ALL EXTERIOR AND LOAD BEARING HEADERS SHALL BE MIN. (2)2x6 (4" WALL) OR (3)2x6 (6" WALL) WITH (I) SUPPORT STUD, UNLESS NOTED
- 2. THE NUMBER SHOWN AT BEAM AND HEADER SUPPORTS INDICATES THE NUMBER OF SUPPORT STUDS REQUIRED IN STUD POCKET OR COLUMN. THE NUMBER OF KING STUDS AT EACH END OF HEADERS IN EXTERIOR WALLS SHALL BE ACCORDING TO ITEM "d" IN TABLE R602.3(5) OR AS BELOW PER NCDOI COMMENTARY "KING STUDS AT WALL OPENINGS" REVISED I-9-2020:
  UP TO 3' SPAN: (I) KING STUD
- OVER 3' UP TO 6' SPAN: (2) KING STUDS
- OVER 6' UP TO 9' SPAN: (3) KING STUDS
- OVER 9' UP TO 12' SPAN: (4) KING STUDS OVER 12' UP TO 15' SPAN: (5) KING STUDS


FRAMING NOTES NC (2018 NCRC): Wind: 115-120 mph

- BRACING METHOD AND TYPE: CONTINUOUSLY SHEATHED WSP: C5-WSP. NOTE THAT THE WALL BRACING AMOUNT PROVIDED ON THE PLANS (DETAILS AND SPECIFICATIONS) IS GREATER THAN THE AMOUNT OF WALL BRACING REQUIRED BY SECTION R602.10 OF THE CODE. SEE NOTES BELOW FOR DETAILS AND SPECIFICATIONS FOR WALL BRACING AND WALL FRAMING.
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- 3. WSP SHEATHING SHALL EXTEND TO THE UPPERMOST DOUBLE BEARING PLATE, BLOCK AT ROOF PER SECTION R60210.4.5 AND ATTACH BRACED WALLS PER CODE, WSP SHEATHING BETWEEN FLOORS SHALL BE SPLICED ALONG CONTINUOUS BAND OR THE WSP SHEATHING MAY BE SPLICED ACROSS STUDS (CONTINUOUS ACROSS FLOOR SYSTEM) WITH BLOCKING AT PANEL EDGES. (MINIMUM 12" BEYOND FLOOR BREAK) OR OTHER APPROVED METHOD.
- 4. "HD" = HOLDOWN: HOLD-DOWN DEVICE (NOTED AS "HD" ON PLANS)
  SHALL BE AN 800 POUND CAPACITY ASSEMBLY AS NOTED ON PLANS.
  SEE DETAILS FOR HD ASSEMBLY.
- \*\*GROUND/FIRST FLOOR: USE "HD HOLD-DOWN DETAIL" ON SD SHEET
- (OR EQUIV)

  "UPPER FLOORS, ATTACH BASE OF KING STUD WITH A SIMPSON C522

  STRAP DOWN ACROSS THE BAND AND DOWN TO A STUD BELOW OR
  HEADER BELOW, EXTEND STRAP 7" MIN ALONG EACH STUD (OR
  HEADER) AND ATTACH EACH END W (1) BA NAILS.
- 5. INTERIOR BRACED WALL: (NOTED AS "IBW" ON PLANS) ATTACH I/2" GYPSUM BOARD (GB) ON EACH SIDE OF WALL WITH A MIN. OF 5d COOLER NAILS OR #6 SCREWS @ 7" O.C. ALONG THE EDGES AND AT INTERMEDIATE SUPPORTS.
- 6. INTERIOR BRACED WALL-WOOD STRUCTURAL PANEL: (NOTED AS "IBM-MSP" ON PLANS). ATTACH ONE SIDE MITH 16" MSP SHEATHING WITH 16" NAIL 5 AT A 6"12" MAIL 11 MSP SHEATHING MITH 16" NAIL 5 AT A 6"12" MAIL 15 AT WITH 8d NAILS AT A 6"/12" NAILING PATTERN (6" OC AT PANEL EDGES AND 12" OC AT INTERMEDIATE SUPPORTS). INSTALL BLOCKING AT ALL PANEL EDGES. ATTACH GB OVER WSP AS REQUIRED. ATTACH OPPOSITE SIDE WITH I/2" GB WITH A MIN. OF 5d COOLER NAILS OR #6 SCREMS @ 7" OC ALONG THE EDGES AND AT INTERMEDIATE



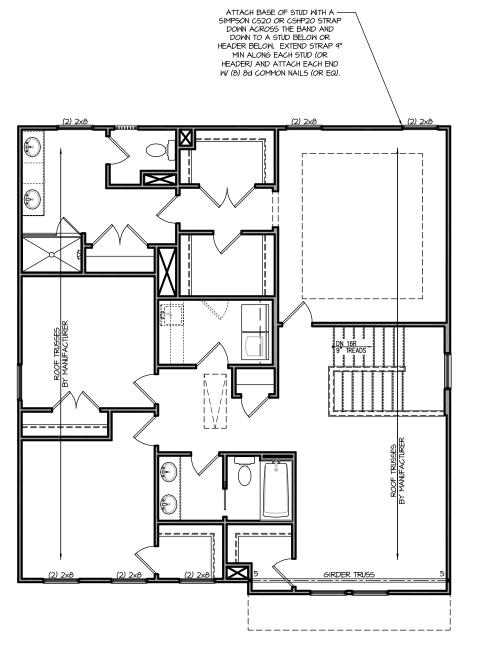

SECOND FLOOR PLAN 'ENGLISH COUNTRY' SCALE: 1/8"=1'-0" ON 11x17, 1/4"=1'-0" ON 22x34

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PROJECT #

21-2816-LH


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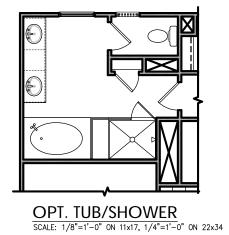
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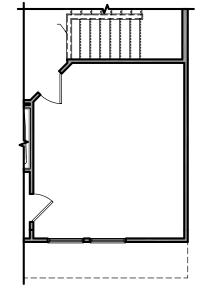
Plan

REFER TO "SD" SHEET(S) FOR STANDARD DETAILS, BRACING DETAILS AND STRUCTURAL NOTES.







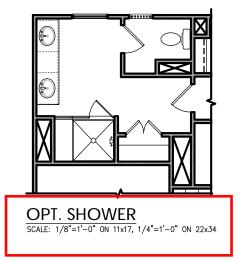

OPT. BEDROOM 4 ILO LOFT SCALE: 1/8"=1'-0" ON 11x17, 1/4"=1'-0" ON 22x34



NO STRUCTURAL CHANGES FROM BASE PLAN

SOUTH DESIGNS

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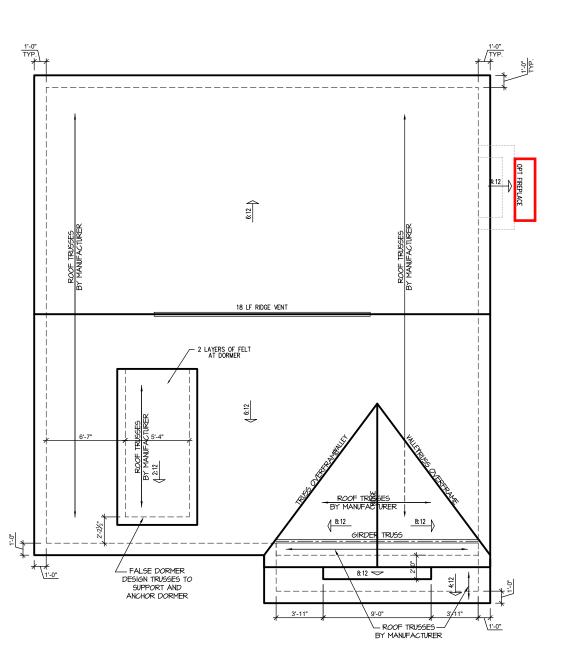
The Holly 7

NEW HOME, INC. Plan

#### TRUSS SYSTEM REQUIREMENTS NC (2018 NCRC): Wind: 115-120 mph

- TRUSS SYSTEM LAYOUTS (PLACEMENT PLANS)
  SHALL BE DESIGNED IN ACCORDANCE WITH SEALED
  STRUCTURAL PLANS, ANY NEED TO CHANGE
  TRUSSES SHALL BE COORDINATED WITH SOUTHERN
  ENGINEERS.
- TRUSS SCHEMATICS (PROFILES) SHALL BE PREPARED AND SEALED BY TRUSS MANUFACTURER.
- ALL TRUSSES SHALL BE DESIGNED FOR BEARING ON SPF #2 OR #3 PLATES OR LEDGERS (UNO).
- ALL REQUIRED ANCHORS FOR TRUSSES DUE TO UPLIFT OR BEARING SHALL MEET THE REQUIREMENTS AS SPECIFIED ON THE TRUSS

	ATTIC VENT SCHEDULE										
ENGLISH COUNTRY											
MAIN HOUSE SQ FTG 1393 AT / NEAR RIDGE AT / NEAR EA								AR EAVE			
VENT TYPE	SQ. FT.				SQ. FT.	PERCENT OF TOTAL	POT LARGE (SQ. FT. EACH)	POT SMALL (SQ. FT. EACH)	RIDGE VENT (SQ. FT. PER LF)	EAVE VENT (SQ. IN. EACH)	CONT. VENT (SQ. IN. PER LF)
VEIVITIE	RAN		SUPPLIED	SUPPLIED	0.4236	0.2778	0.125	0.1944	0.0625		
RIDGE VENT	1.86	2.32	3.00	44.44	0	0	24.00				
SOFFII VENIS	2.79	2.32	3.75	55.56	0 60.00						
TOTAL (MIN)	4.64	4.64	6.75	100.00			RE IS INSUFFICIENT RIE				



ROOF PLAN 'ENGLISH COUNTRY'
SCALE: 1/8"=1'-0" ON 11x17, 1/4"=1'-0" ON 22x34

21-2816-LH

PROJECT #

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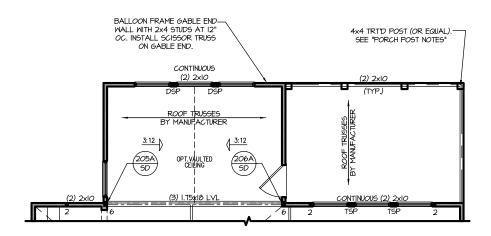
SOUTH DESIGNS

The Holly

Plan

REFER TO "SD" SHEET(S) FOR STANDARD DETAILS, BRACING DETAILS AND STRUCTURAL NOTES.






COVERED PATIO FLOOR PLAN
SCALE: 1/8"=1'-0" ON 11x17, 1/4"=1'-0" ON 22x34

COVERED PATIO ELECTRICAL SCALE: 1/8"=1'-0" ON 11x17, 1/4"=1'-0" ON 22x34

2:12

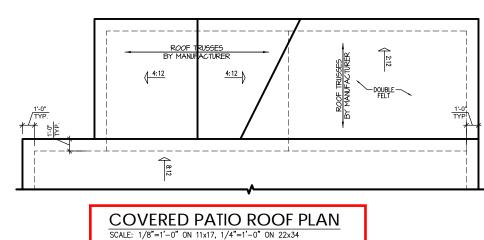

SHINGLES AS SPECIFIED

PARTIAL RIGHT SIDE ELEVATION (SLAB) SCALE: 1/8"=1'-0" ON 11x17, 1/4"=1'-0" ON 22x34

**COVERED PATIO REAR ELEVATION (SLAB)** SCALE: 1/8"=1'-0" ON 11x17, 1/4"=1'-0" ON 22x34

6:12

SHINGLES AS SPECIFIED

SIDING AS SPECIFIED

2nd PLT. HGT. HDR. HEIGHT

2nd FLR. LINE

1st PLT. HGT. HDR. HEIGHT

1st FLR. LINE

PARTIAL LEFT SIDE ELEVATION (SLAB) SCALE: 1/8"=1'-0" ON 11x17, 1/4"=1'-0" ON 22x34

4" TRIM —

SHINGLES AS SPECIFIED

4" TRIM →


REFER TO "SD" SHEET(S) FOR STANDARD DETAILS, BRACING DETAILS AND STRUCTURAL NOTES.


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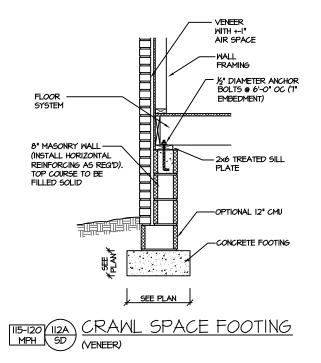
PROJECT # 21-2816-LH


SOUTH DESIGNS

Plan



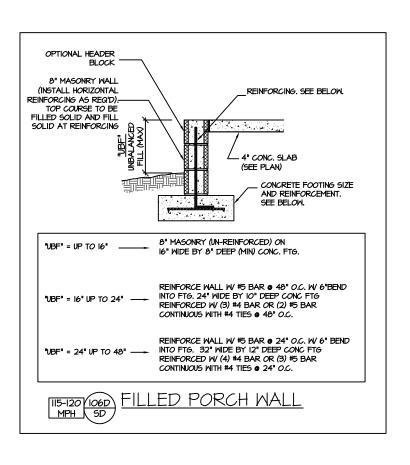

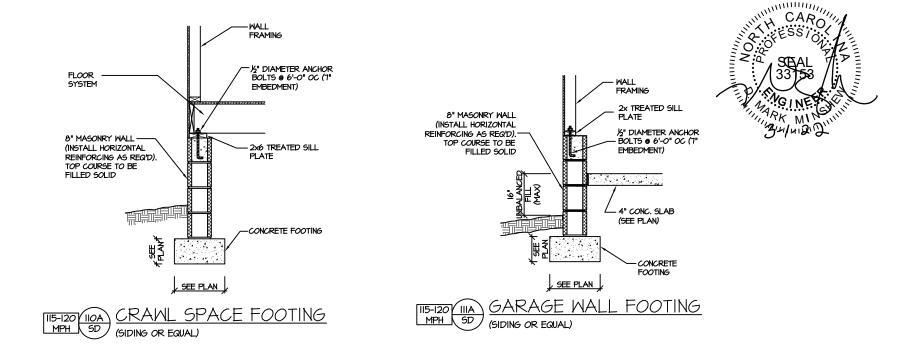

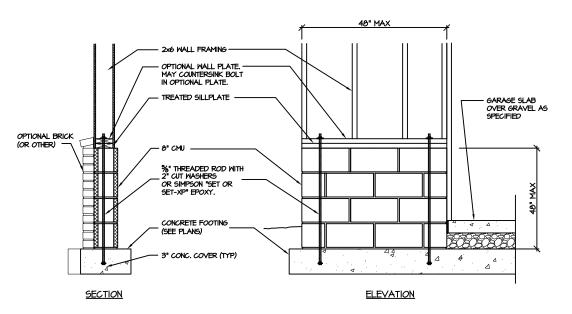

GARAGE 'WING WALL' REINFORCING PER IRC FIGURE R602.IO.4.3

CRAWL SPACE FOUNDATION

PROJECT # 21-2816

not include construction means, methods, techniques, procedures or safety precautions. ions or discrepancies on plans are to be brought to the attention of Southern Engineers. Failure to do so will me Engineer's liability.


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SOUTH DESIGNS


HOLLY THE HOME, 1  $\sim$ PLAN


SD


MONOLITHIC SLAB FOOTING (SIDING OR EQUAL)



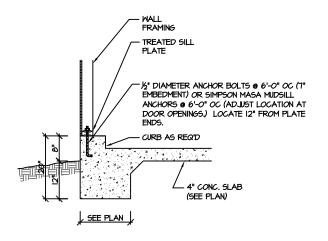

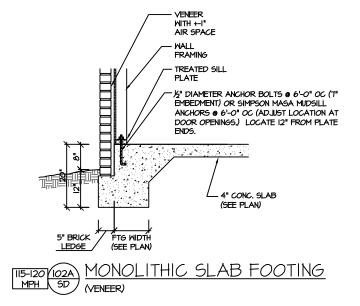

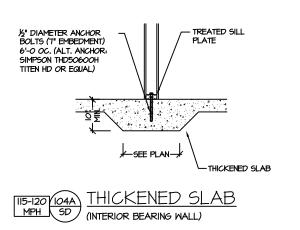

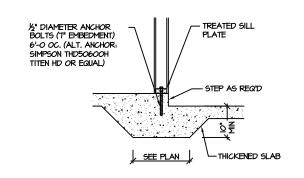

THICKENED SLAB @ GARAGE | II5-I20 | IO5A | SD | (INTERIOR GARAGE WALL)

SLAB FOUNDATION

PROJECT # 21-2816

**P.A.** 27609


Southern Engineers, P. 3716 Benson Drive, Raleigh, NC 276 Phone: (919) 878-1617 License: C-4772 www.southernengineers.com

SOUTH DESIGNS


THE HOLLY NEW HOME, INC. 2 PLAN

SD


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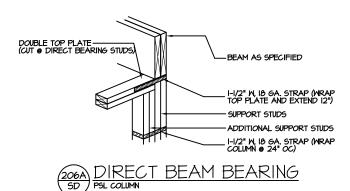


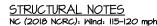
- ENGINEER'S SEAL APPLIES ONLY TO STRUCTURAL COMPONENTS INCLUDING ROOF RAFTERS, HIPS, VALLEYS, RIDGES, FLOORS, WALLS, BEAMS AND HEADERS, COLUMNS, CANTILEVERS, OFFSET LOAD BEARING WALLS, PIER & GIRDER SYSTEM, FOOTING, AND PILING SYSTEM. ENGINEER'S SEAL DOES NOT CERTIFY DIMENSIONAL ACCURACY OR ARCHITECTURAL LAYOUT INCLUDING ROOF SYSTEM. ALL REQUIREMENTS FOR PROFESSIONAL CERTIFICATION SHALL BE PROVIDED BY THE APPROPRIATE PROFESSIONAL. SOUTHERN ENGINEERS, P.A. CERTIFIES ONLY THE STRUCTURAL COMPONENTS AS SPECIFICALLY STATED.
- ALL CONSTRUCTION SHALL CONFORM TO THE LATEST REQUIREMENTS OF THE 2018 NC RESIDENTIAL CODE, PLUS ALL LOCAL CODES AND REGULATIONS. THE STRUCTURAL ENGINEER IS NOT RESPONSIBLE FOR, AND WILL NOT HAVE CONTROL OF, CONSTRUCTION MEANS, METHODS, TECHNIQUES, SEQUENCES OR PROCEDURES, OR FOR SAFETY PRECAUTIONS AND PROGRAMS IN CONNECTION WITH THE CONSTRUCTION WORK, NOR WILL THE ENGINEER BE RESPONSIBLE FOR THE CONTRACTOR'S FAILURE TO CARRY OUT THE CONSTRUCTION WORK IN ACCORDANCE WITH THE CONTRACT DOCUMENTS, "CONSTRUCTION REVIEW" SERVICES ARE NOT PART OF OUR CONTRACT, ALL MEMBERS SHALL BE FRAMED ANCHORED, TIED AND BRACED IN ACCORDANCE WITH GOOD CONSTRUCTION PRACTICE AND THE BUILDING CODE.
- DESIGN LOADS (LISTED AS: LIVE LOAD, DEAD LOAD, DEFLECTION) ROOMS OTHER THAN SLEEPING ROOMS: (40 PSF, IO PSF, L/360)
- SLEEPING ROOMS: (30 PSF, IO PSF, L/360)
- ATTIC WITH PERMANENT STAIR: (40 PSF, IO PSF, L/360)
- ATTIC WITHOUT PERMANENT STAIR: (20 PSF, IO PSF, L/360)
  ATTIC WITHOUT STORAGE: (10 PSF, IO PSF, L/240)
- STAIRS: (40 PSF, IO PSF, L/360)
- EXTERIOR BALCONIES: (60 PSF, 10 PSF, L/360) DECKS: (40 PSF, 10 PSF, L/360)
- GUARDRAILS AND HANDRAILS: (200 LBS PASSSENGER VEHICLE GARAGES: (50 PSF, IO PSF, L/360)
- FIRE ESCAPES: (40 PSF, IO PSF, L/360)
- SNOW: (20 PSF)
- 4. WALLS SHALL BE BRACED BY SHEATHING WALLS ON ALL STORIES WITH WOOD STRUCTURAL PANELS. SEE FRAMING NOTES FOR THICKNESS AND NAILING REQUIREMENTS
- 5. SEE APPENDIX M (DCA6) FOR EXTERIOR DECK REQUIREMENTS INCLUDING ATTACHMENTS FOR LATERAL LOADS.
- 6. CONCRETE SHALL HAVE A MINIMUM 28 DAY STRENGTH OF 3000 PSI AND A MAXIMUM SLUMP OF 5 INCHES UNLESS NOTED OTHERWISE (UNO). AIR ENTRAINED PER TABLE 402.2. ALL CONCRETE SHALL BE PROPORTIONED, MIXED, HANDLED, SAMPLED, TESTED, AND PLACED IN ACCORDANCE WITH ACI STANDARDS. ALL SAMPLES FOR PUMPING SHALL BE TAKEN FROM THE EXIT END OF THE PUMP, CONTROL JOINTS IN SLABS SHALL BE SPACED ON A GRID OF +30 TIMES THE DEPTH (D). CONTROL JOINTS SHALL BE SAWCUT TO A DEPTH OF 1/D, (I.E. 4" CONCRETE SLABS SHALL HAVE 1/4" DEEP CONTROL JOINTS SANCUT IN SLAB ON A +-10'-0" x +-10'-0" GRID).
- ALLOWABLE SOIL BEARING PRESSURE ASSUMED TO BE 2000 PSF. THE CONTRACTOR MUST CONTACT A GEOTECHNICAL ENGINEER AND THE STRUCTURAL ENGINEER IF UNGATISFACTORY SUBSURFACE CONDITIONS ARE ENCOUNTERED. THE SURFACE AREA ADJACENT TO THE FOUNDATION WALL SHALL BE PROVIDED WITH ADEQUATE DRAINAGE, AND SHALL BE GRADED SO AS TO DRAIN SURFACE WATER AWAY FROM FOUNDATION WALLS.
- 8. ALL FRAMING LUMBER SHALL BE SPF #2 (Fb = 875 PSI) UNLESS NOTED OTHERWISE (UNO). ALL TREATED LUMBER SHALL BE SYP # 2. PLATE MATERIAL MAY BE SPF # 3 OR SYP #3 (Fc(perp) =
- 9. L.V.L. SHALL BE LAMINATED VENEER LUMBER: Fb=2600 PSI, Fv=285 PSI, E=I.9xI0 PSI. P.S.L. SHALL BE PARALLEL STRAND LUMBER: Fb=2400 PSI, Fv=240 PSI, E=2.0xl0 PSI. L.S.L. SHALL BE LAMINATED STRAND LUMBER: Fb=2250 PSI, Fv=400 PSI, E=1.55xl0 PSI. INSTALL ALL CONNECTIONS PER MANUFACTURERS INSTRUCTIONS.
- IO. ALL ROOF TRUSS AND I-JOIST LAYOUTS SHALL BE PREPARED IN ACCORDANCE WITH THE SEALED STRUCTURAL DRAWINGS. TRUSSES AND I-JOISTS SHALL BE INSTALLED ACCORDING TO THE MANUFACTURE'S SPECIFICATIONS. ANY CHANGE IN TRUSS OR I-JOIST LAYOUT SHALL BE COORDINATED WITH SOUTHERN ENGINEERS.
- ALL STRUCTURAL STEEL SHALL BE ASTM A-36. STEEL BEAMS SHALL BE SUPPORTED AT EACH END WITH A MINIMUM BEARING LENGTH OF 3 1/2" INCHES AND FULL FLANGE WIDTH, PROVIDE SOLID BEARING FROM BEAM SUPPORT TO FOUNDATION. BEAMS SHALL BE ATTACHED TO EACH SUPPORT WITH TWO LAG SCREWS (1/2" DIAMETER x 4" LONG). LATERAL SUPPORT IS CONSIDERED ADEQUATE PROVIDING THE JOIST ARE TOE NAILED TO THE SOLE PLATE. AND SOLE PLATE IS NAILED OR BOLTED TO THE BEAM FLANGE @ 48" O.C. ALL STEEL TUBING SHALL BE ASTM A500.
- 12. REBAR SHALL BE DEFORMED STEEL, ASTM615, GRADE 60. LAP ALL REBAR SPLICES 30 BAR
- FLITCH BEAMS SHALL BE BOLTED TOGETHER USING (2) ROWS OF I/2" DIAMETER BOLTS (ASTM A325) WITH WASHERS PLACED UNDER THE THREADED END OF BOLT. BOLTS SHALL BE SPACED AT 24" O.C. (MAX), AND STAGGERED AT THE TOP AND BOTTOM OF BEAM (2" EDGE DISTANCE), WITH 2 BOLTS LOCATED AT 6" FROM EACH END.
- I4. BRICK LINTELS (WHEN REQUIRED) SHALL BE 3 I/2"x3 I/2"x1/4" STEEL ANGLE FOR UP TO 6'-0" SPAN AND 6"x4"x5/16" STEEL ANGLE WITH 6" LEG VERTICAL FOR SPANS UP TO 9'-0". SEE PLANS FOR SPANS OVER 4'-O". SEE ALSO SECTION R703.8.3 LINTELS.



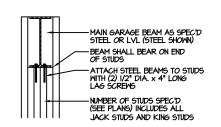



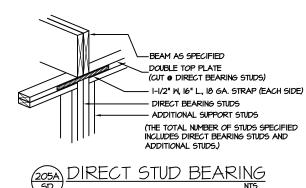

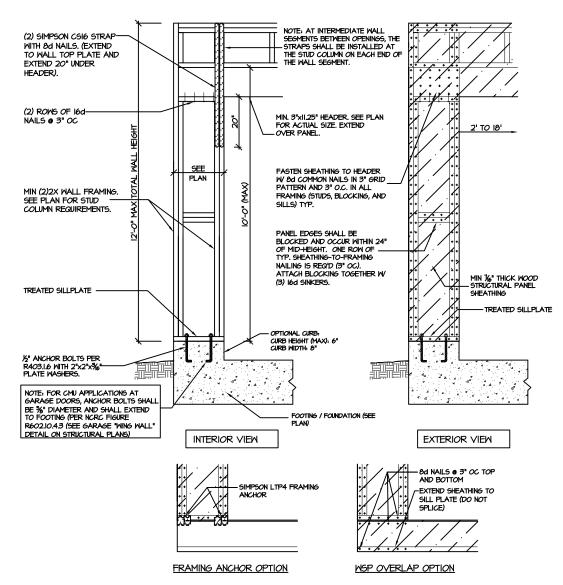

CS-PF - OVER WOOD FLOOR

CS-PF: CONTINUOUS PORTAL FRAME CONSTRUCTION DETAIL AND APPLICATION BASED ON NORC FIGURE R602.IO.I - PORTAL FRAME CONSTRUCTION

PROJECT # 21-2816

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