

ATTIC VENTILATION

```
2233 = 7.44 sq. ft. REQD.
300
* ( ) -
          BASE, / VENTS =
* ( ) -
           BASE, / VENTS =
* (84') - RIDGE VENT @ 9 sq.in./ft. = 5.25 SQ. FT.
                 TOTAL' = 5.25 SQ. FT.
```

** PROVIDE CONTINUOUS SOFFIT VENT SUUROUND TO EQUAL OR EXCEED 3.72 SQ. FT. *** (OPT.) PROVIDE THEMOSTATICALLY CONTROLLED POWER VENT TO EQUAL OR EXCEED 3.72 SQ. FT.

CODE INFORMATION

```
* ZONE: (CHECK ONE)
  ZONE 7SCREEN
   ZONE 8
   ZONE
```

* GLAZING U-FACTOR * R-VALUES CEILING R-38

FLOOR BSMNT, WALL SLAB PERIMETER CRAWL SPACE WALL

MEAN ROOF HEIGHT 30'-3" WALL AND ROOF CLADDING DESIGN VALUE:

(MEAN ROOF HGT. 30 ft. OR LESS) CRAWL SPACE WALL +18.0, -24.1

ROOF PITCH 0/12 TO 2.25/12 +10.0, -45.4 ROOF PITCH 2.25/12 TO 7/12 +10.4,-34.8 ROOF PITCH 7/12 TO 12/12 +16.5,-21.0 EXPOSURE ADJUSTMENT

ALL DIMENSIONS, SITE

CONDITIONS & CODES ARE TO

BE VERIFIED BEFORE CONSTR.

BEGINS. ONCE CONSTR. HAS

BEGUN MURPHY GARNOW

DESIGN CONSTR. HAS DESIGN GROUP, INC. WILL NOT ASSUME ANY LIABILITY FOR ANY EXPENSES ASSOCIATED

WITH ERRORS & OMMISIONS.

MURPHY GARNOW DESIGN GROUP

CARY, NORTH CAROLINA 27511 9) 481-9115 FAX; (919) 481-69

Q

DRAWN BY: TWG

₹

FILE NAME: **HH-2-2604** REVISIONS | TWG | LOT

12-14-20 TWG PLAN 1-1-21 TWG PLAN 12-22-21 TWG REV.


© COPYRIGHT 2022 MURPHY GARNOW DESIGN GROUP, INC. ALL RIGHTS RESERVED




HOUSE NUMBER:

PAGE NUMBER:

THESE PLANS MEET THE REQUIREMENTS OF THE INTERNATIONAL RESIDENTIAL CODE '2015' AND THE NORTH CAROLINA RESIDENTIAL CODE '2018' EDITION.

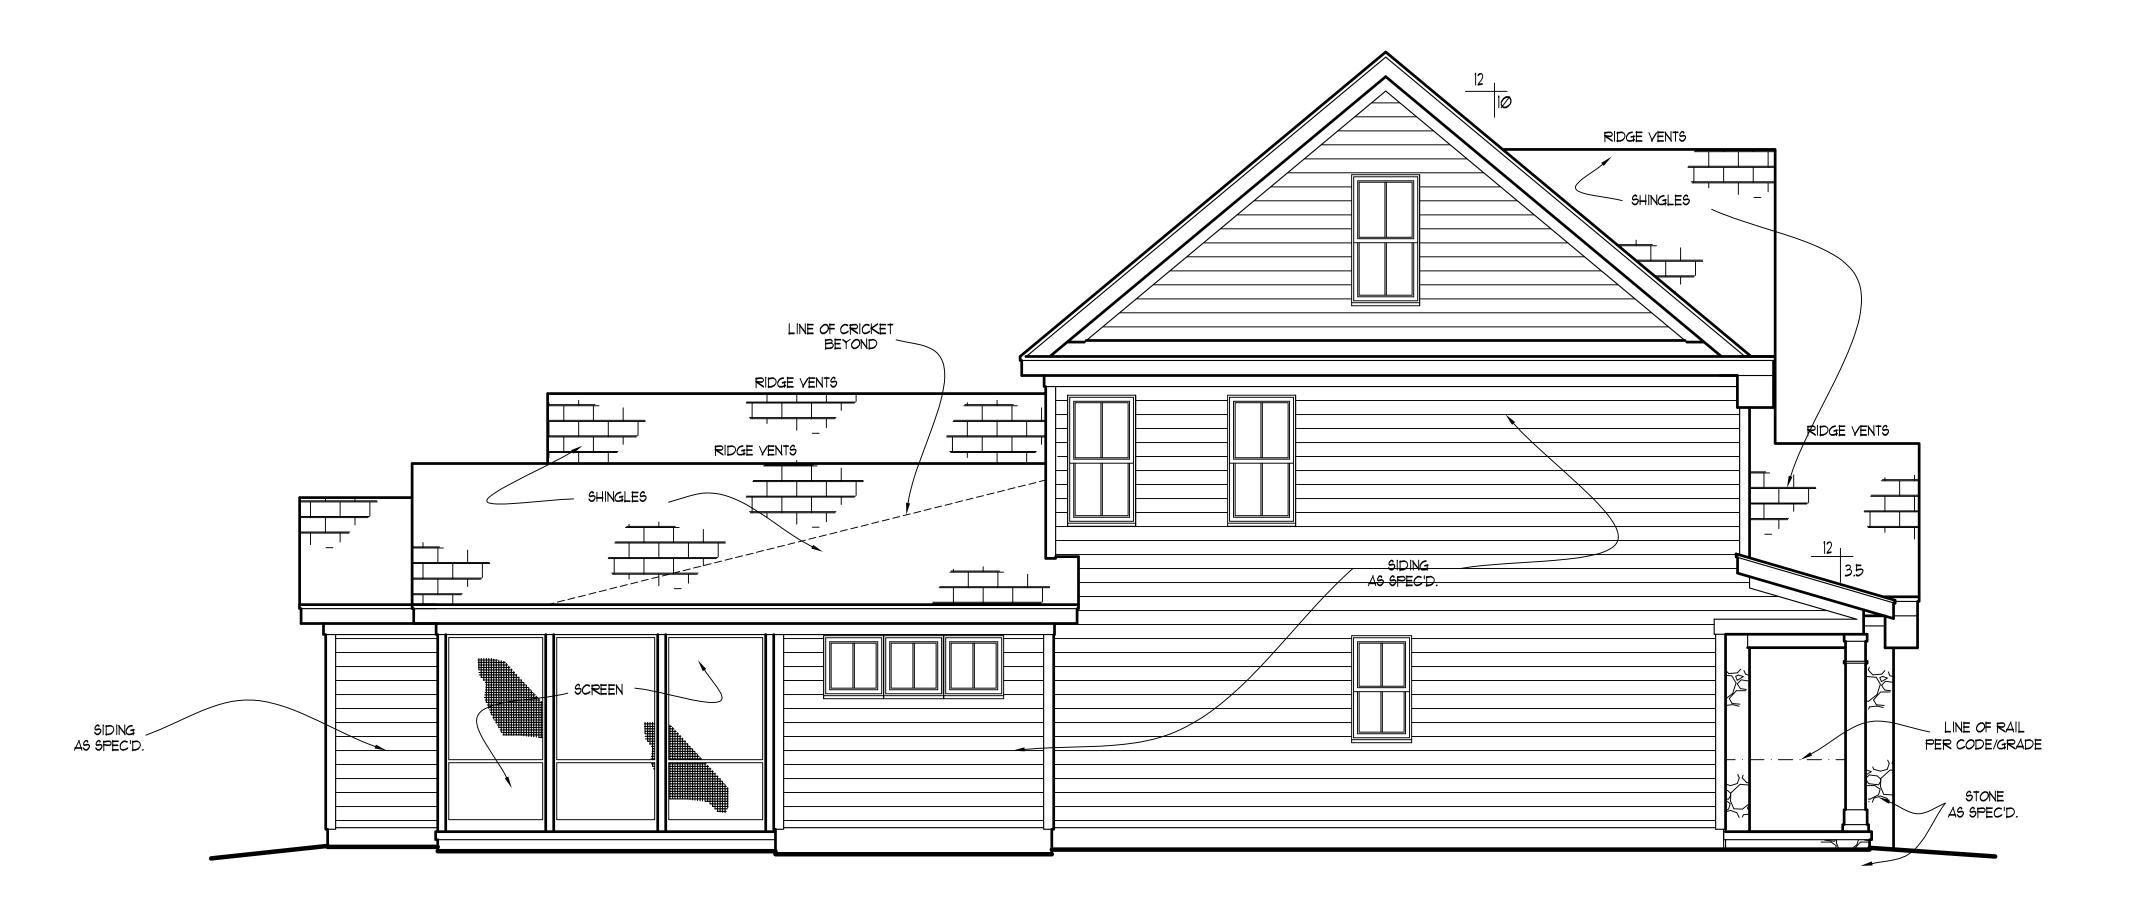

LEFT ELEVATION SCALE: -----1/4" = 1'-0"

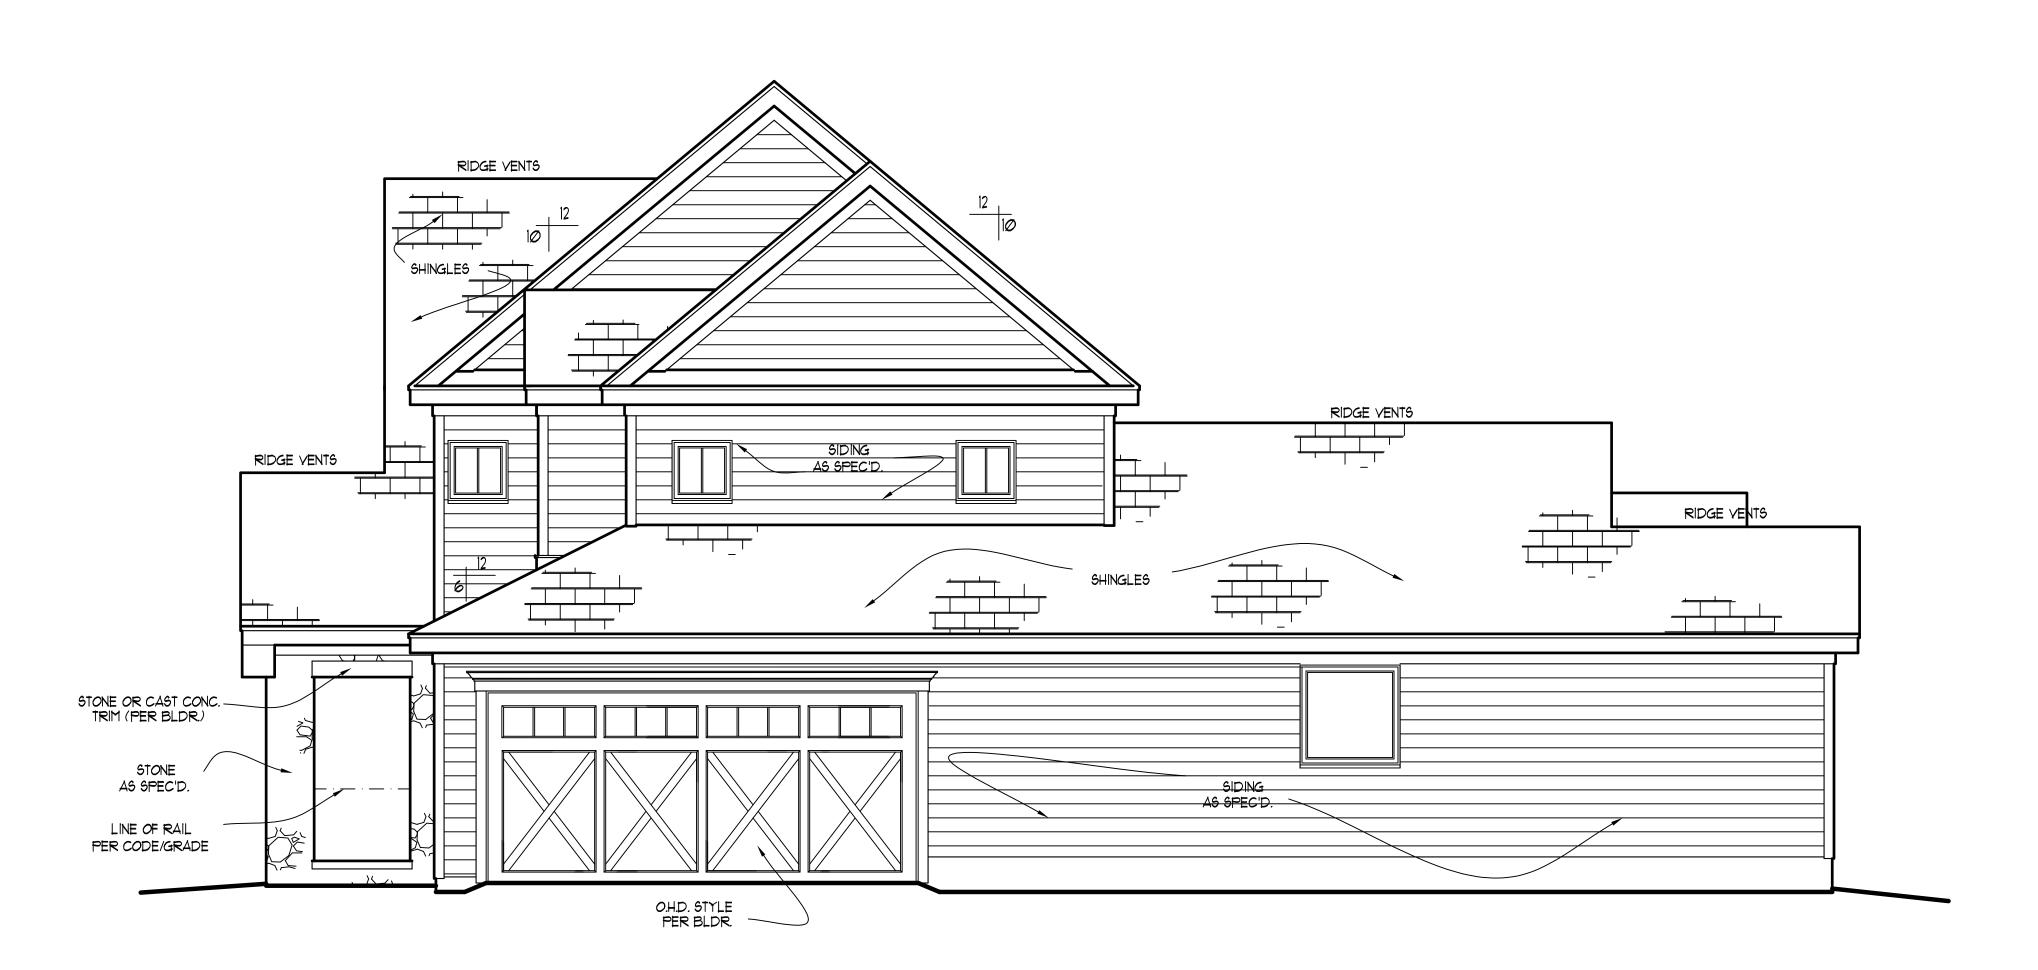

RIGHT ELEVATION SCALE: -----1/4" = 1'-0"

MURPHY GARNOW DESIGN GROUP, INC. HEREBY EXPRESSLY RESERVES ITS COPYRIGHT AND OTHER PROPERTY RIGHTS TO THESE PLANS. THESE PLANS ARE TO BE USED FOR THE CONSTRUCTION OF (ONE) RESIDENCE ONLY, ANY OTHER USE, CHANGE AND/OR REPRODUCTION IN ANY FORM WILL RENDER THESE PLANS FRAUDULENT.

ALL DIMENSIONS, SITE
CONDITIONS & CODES ARE TO
BE VERIFIED BEFORE CONSTR.
BEGINS. ONCE CONSTR. HAS
BEGUN MURPHY GARNOW
DESIGN GROUP, INC. WILL NOT
ASSUME ANY LIABILITY FOR
ANY EXPENSES ASSOCIATED
WITH ERRORS & OMMISIONS.

MURPHY GARNOW DESIGN GROUP, INC

日の下語の HALCYON

FILE NAME: **HH-2-2604**

REVISIONS 6-15-22 TWG LOT 12-14-20 TWG: PLAN 1-1-21 TWG: PLAN 12-22-21 TWG: REV.


© COPYRIGHT 2022 MURPHY GARNOW DESIGN GROUP, INC. ALL RIGHTS RESERVED



HOUSE NUMBER:

PAGE NUMBER:

THESE PLANS MEET THE REQUIREMENTS OF THE INTERNATIONAL RESIDENTIAL CODE '2015' AND THE NORTH CAROLINA RESIDENTIAL CODE '2018' EDITION.

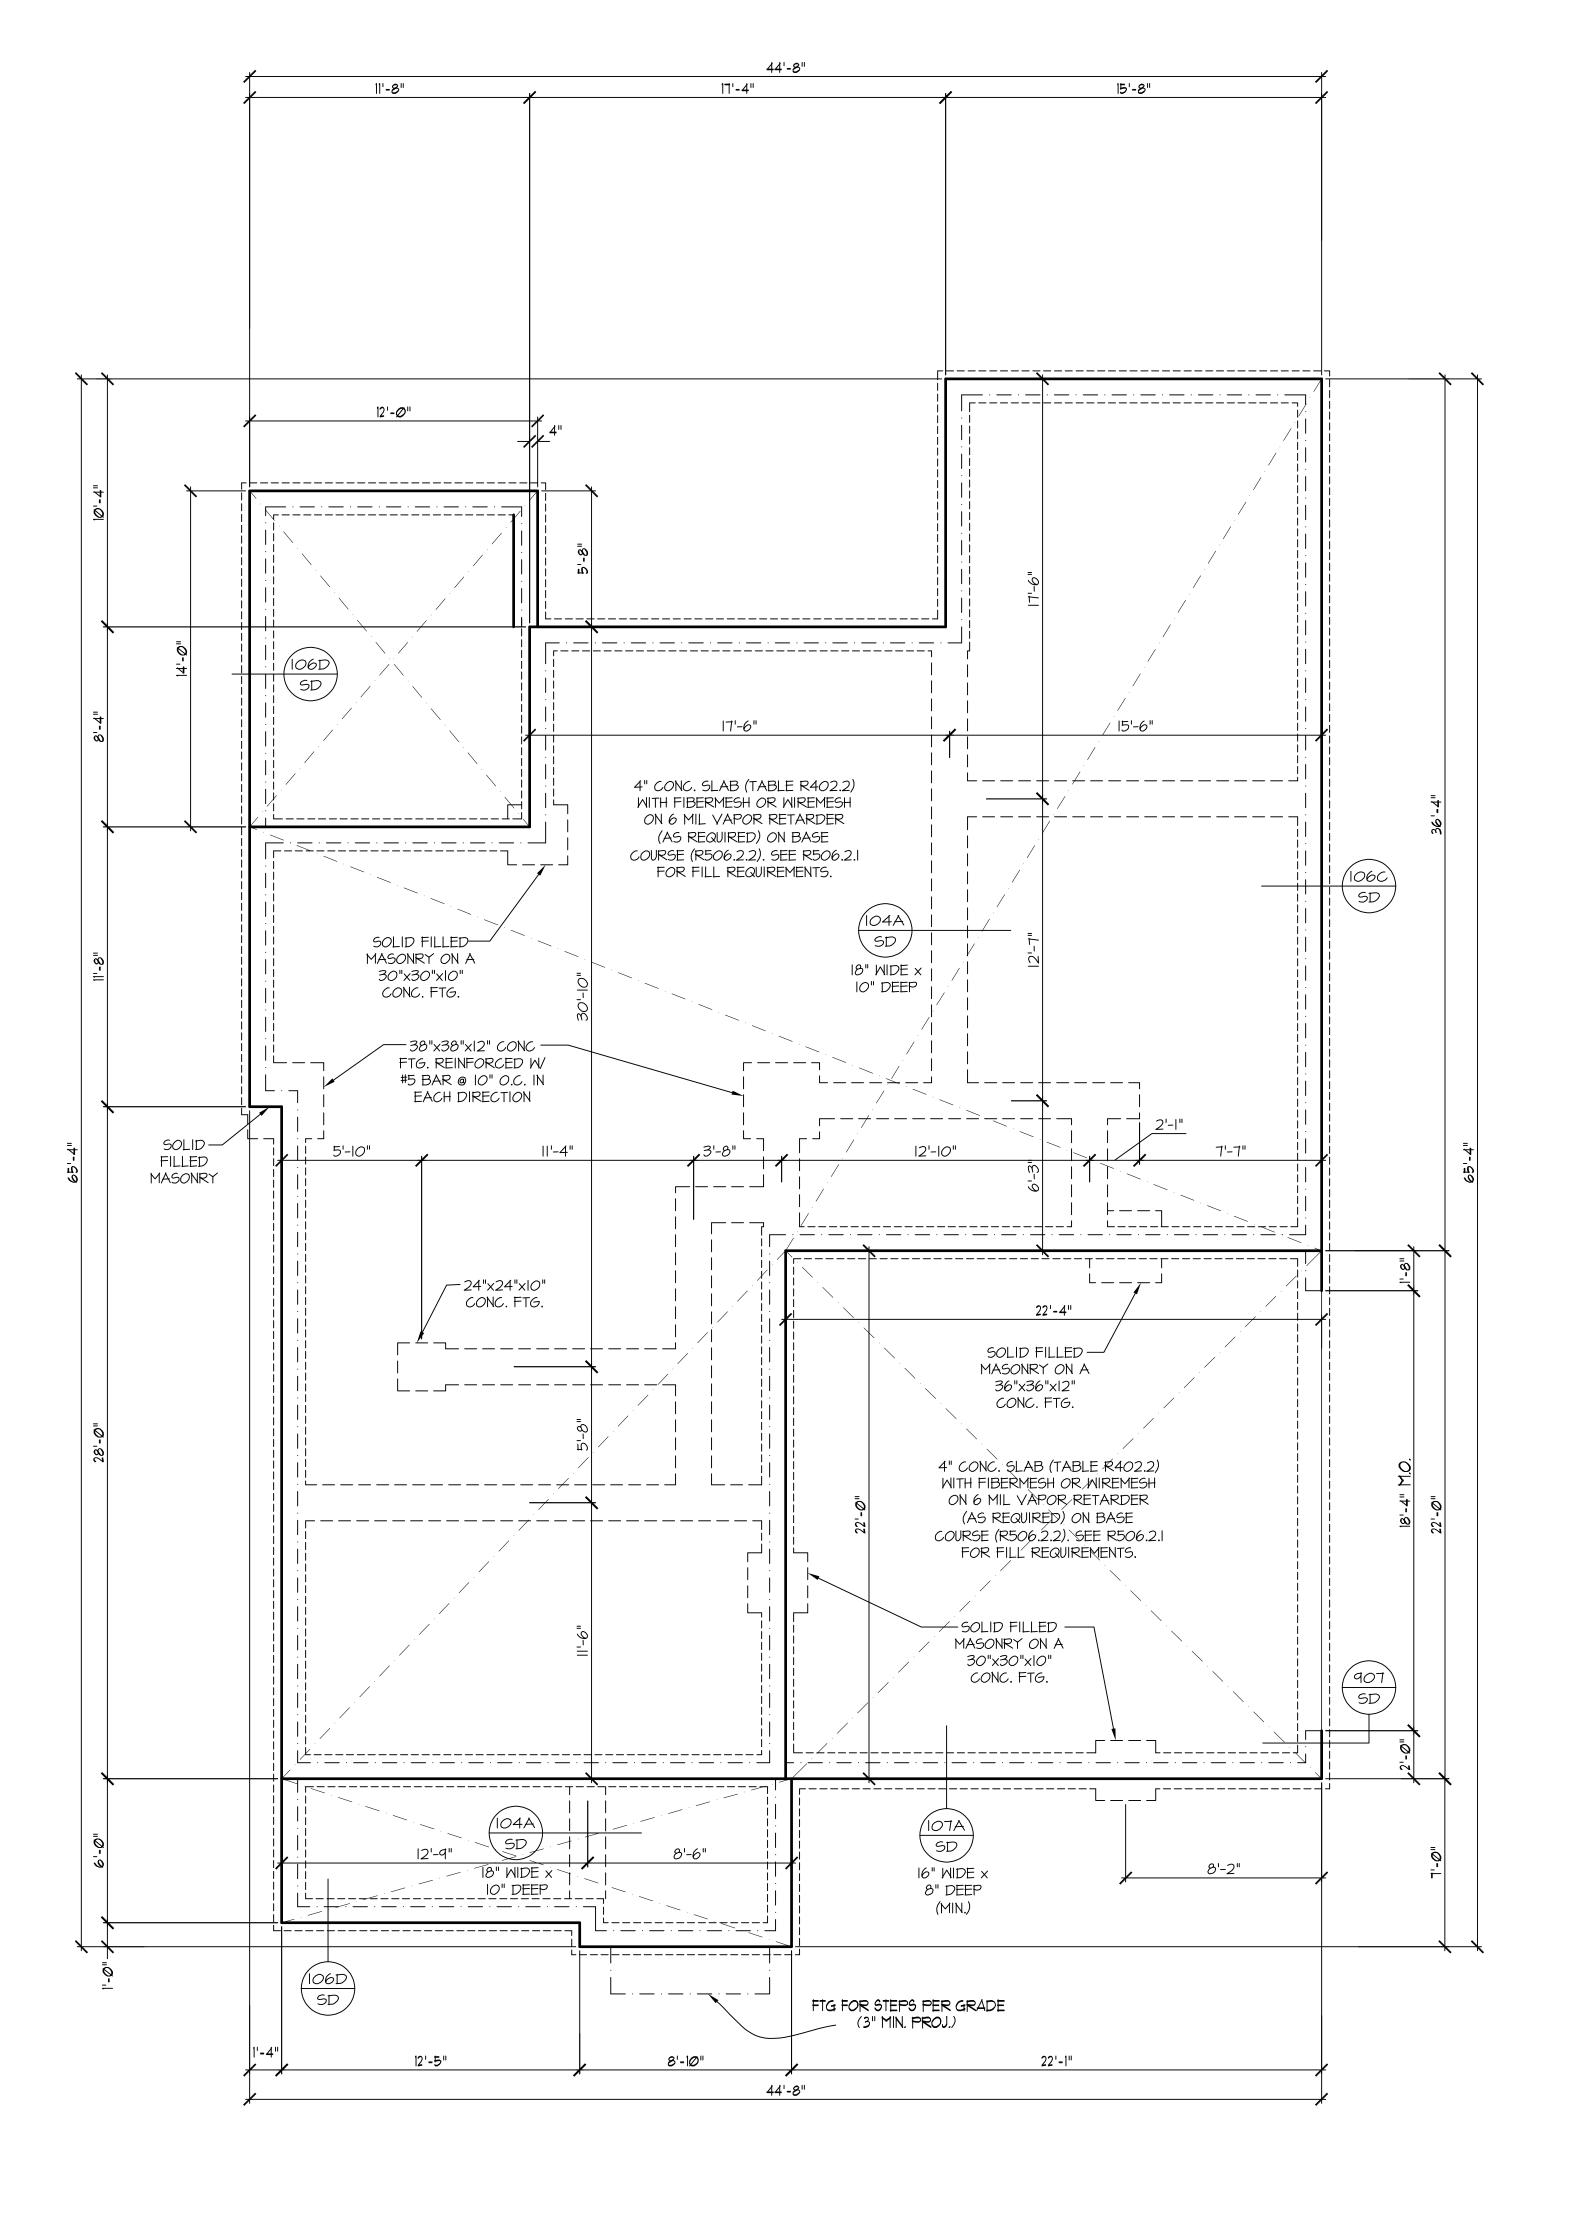

FND. VENTILATION

<u>1680 = 11.2 SQ. FT. REQUIRED*</u>

1680 = 1.12 SQ. FT. REQUIRED*

WITH APPROVED VAPOR RETARDER MATERIAL AND OPENINGS PLACED FOR CROSS VENTILATION

* ONE VENTILATION OPENING SHALL BE WITHIN 3 FEET OF EACH CORNER OF THE BUILDING

NOTE: ASSUMED SOIL BEARING CAPACITY = 2000 PSF CONTRACTOR MUST VERIFY SITE CONDITIONS AND CONTACT SOILS ENGINEER IF MARGINAL OR UNSTABLE SOILS ARE ENCOUNTERED

GARNOWI

MURPHY

ALL DIMENSIONS, SITE

CONDITIONS & CODES ARE TO BE VERIFIED BEFORE CONSTR.

BEGINS. ONCE CONSTR. HAS

BEGUN MURPHY GARNOW

DESIGN GROUP, INC. WILL NOT ASSUME ANY LIABILITY FOR

ANY EXPENSES ASSOCIATED

WITH ERRORS & OMMISIONS.

Q

DRAWN BY: TWG


FILE NAME: **HH-2-2604**

REVISIONS | TWG | LOT 12-14-20 TWG PLAN 1-1-21 TWG PLAN 12-22-21 TWG REV.

© COPYRIGHT 2022 MURPHY GARNOW DESIGN GROUP, INC. ALL RIGHTS RESERVED

HOUSE NAME:

HOUSE NUMBER:

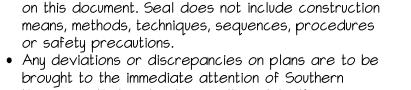

Engineers. Failure to do so will void Southern Engineer's liability.

• Engineers seal applies only to structural components

• Seal is valid for a project permitted within one year from date of seal. Use of these plans constitutes approval of terms

and conditions as defined in the customer agreement.

STEM WALL

REFER TO "SD" SHEET(S) FOR STANDARD DETAILS, BRACING

DETAILS AND STRUCTURAL NOTES.

STRUCTURAL DESIGN BY:

PROJECT #: 22-1573


SOUTHERN ENGINEERS, P.A.

3716 BENSON DRIVE RALEIGH, NC 27609

LICENSE: C-4772, PHONE: 919-878-1617

FOUNDATION PLAN SCALE: ----- 1/4"=1'-0"

THESE PLANS MEET THE REQUIREMENTS OF THE NORTH CAROLINA RESIDENTIAL CODE '2018' EDITION.

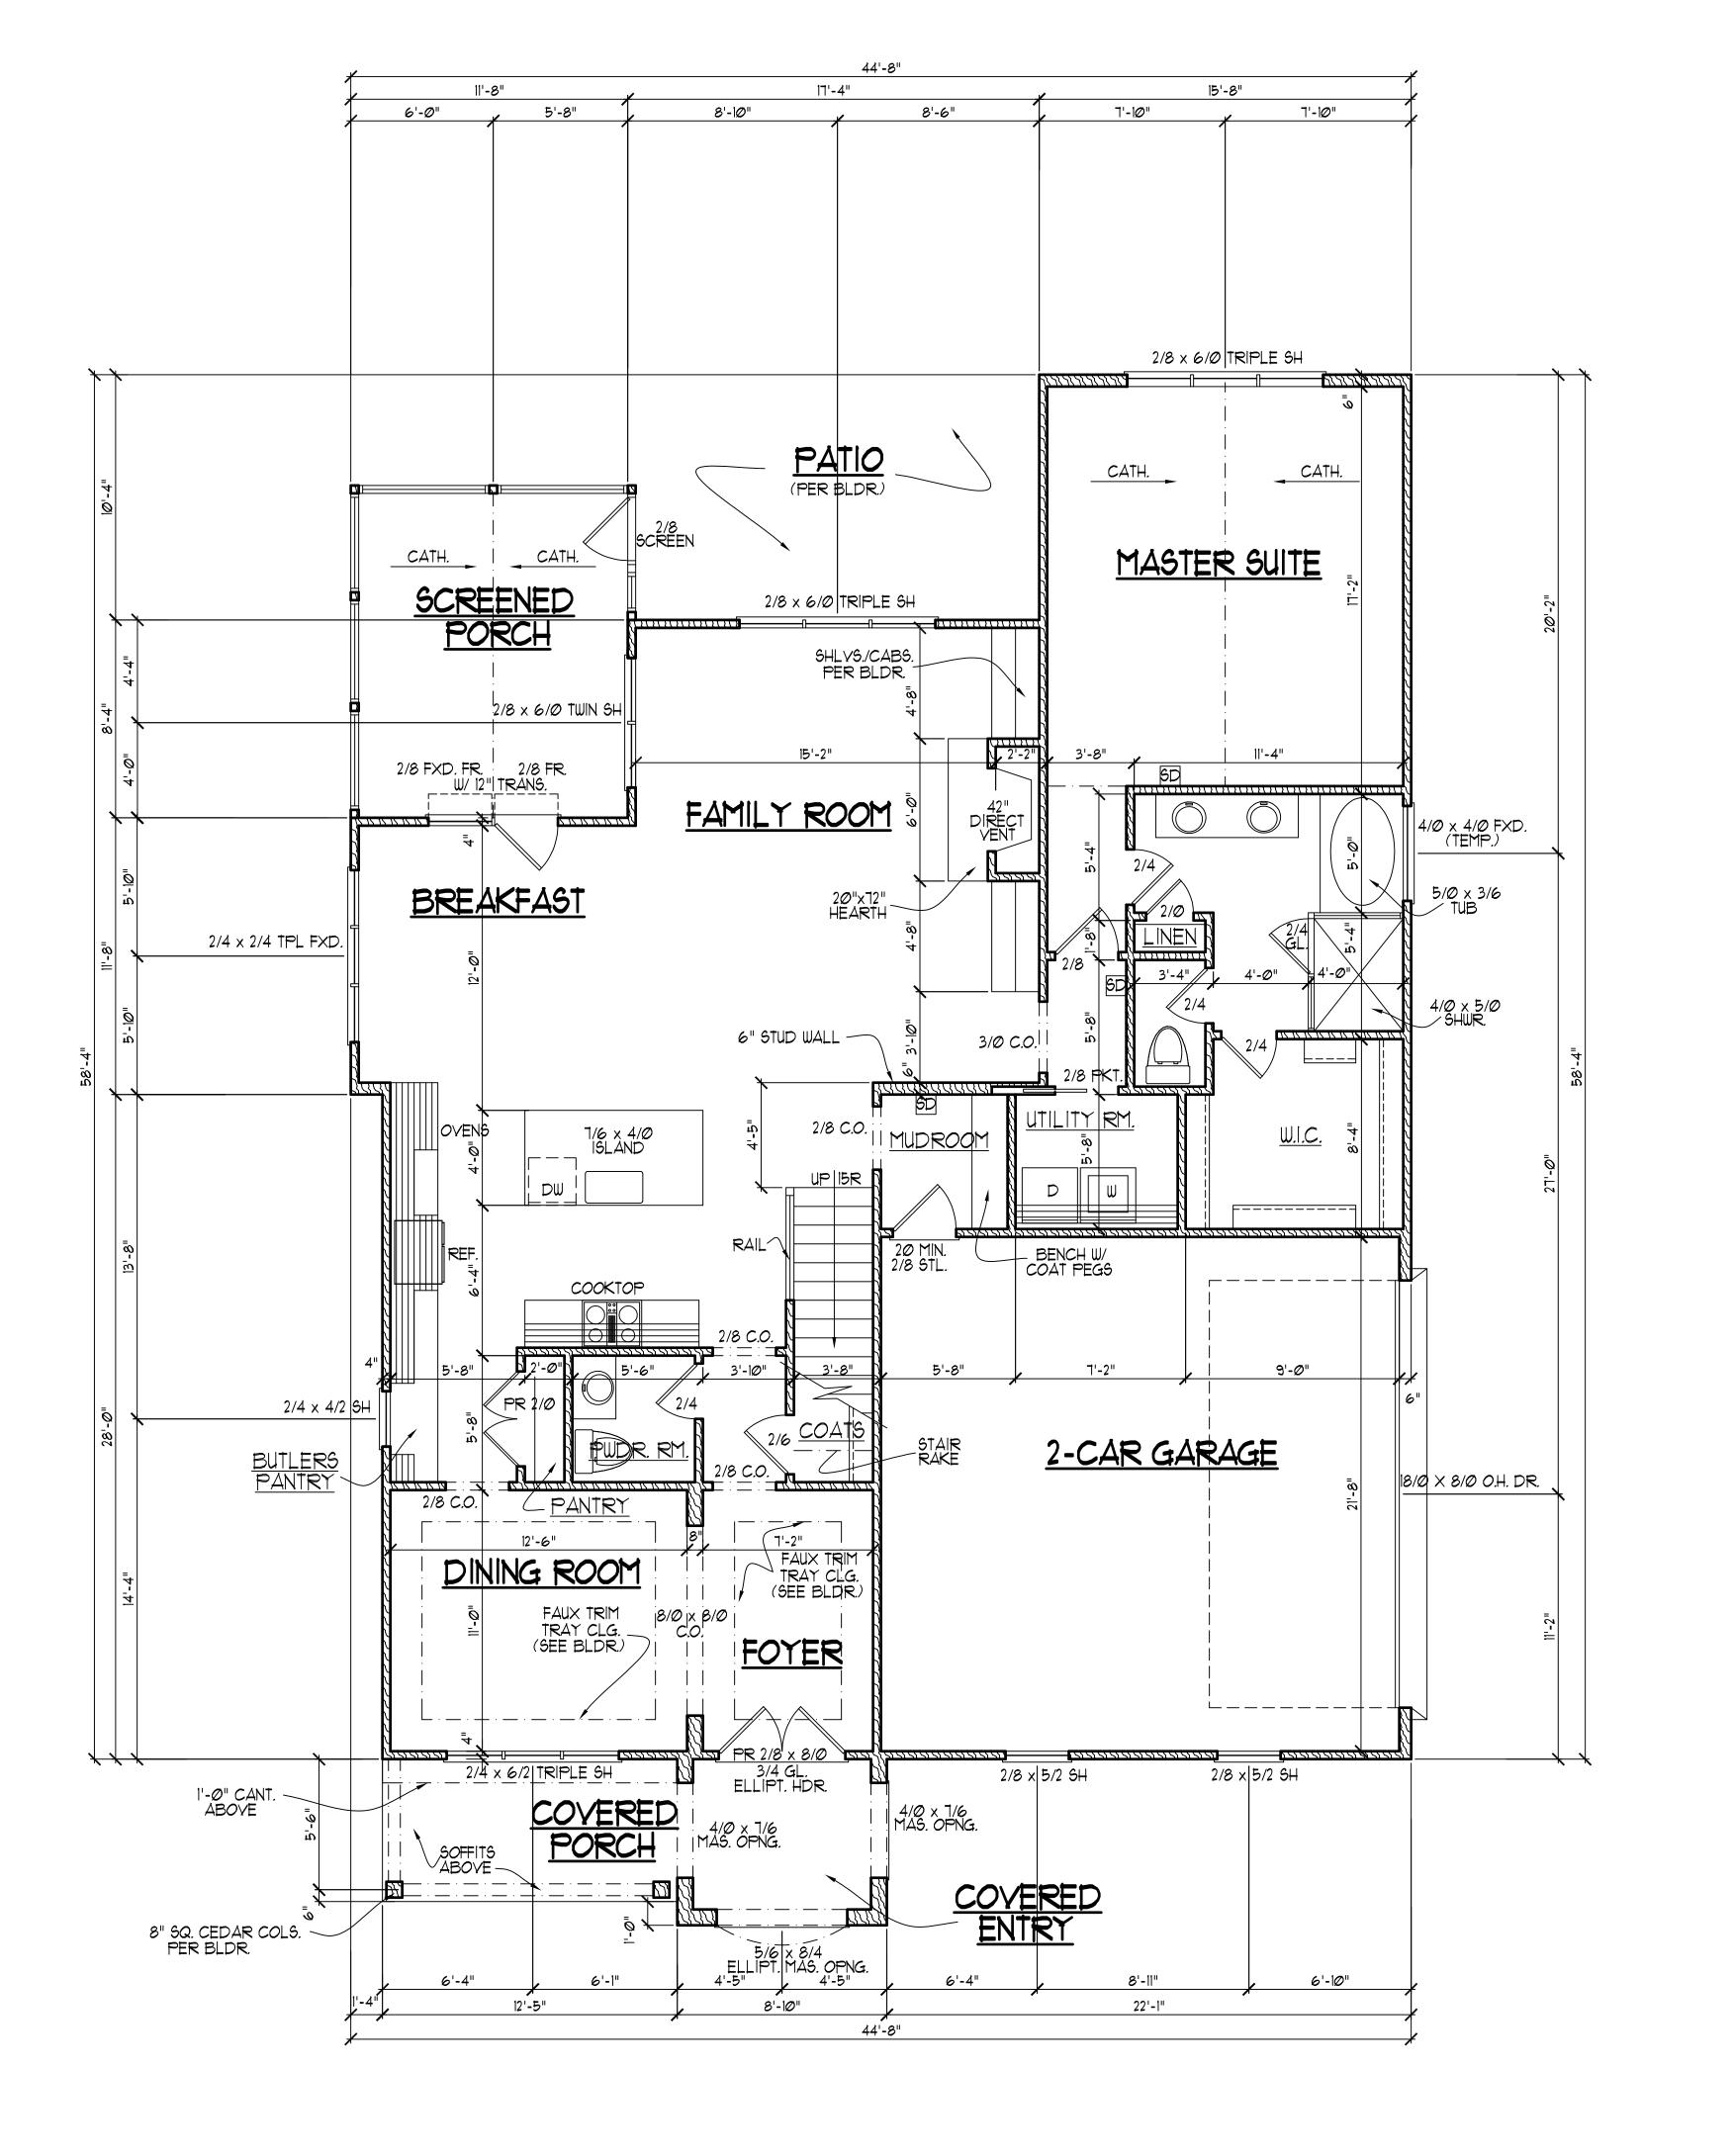

FIRST FLOOR NOTES:

- 1) 9'-0" CLG. HGT. (TYP.) U.N.O. 2) SET WINDOWS @ 7'-10" A.F.F. (TYP.) U.N.O.
- 3) STAIRS: UP 15 RISERS @ 8" (+ -) (TYP.) U.N.O.
- 4) PROVIDE 5/8" TYPE 'X' GYPSUM @ GARAGE CEILING ADJACENT TO HTD. SPACES PROVIDE 1/2" GYPSUM @ GARAGE
- WALLSADJACENT TO HTD. SPACES 5) ALL WALLS FIGURED AT 4" WIDTHS FOR FOR STUDS, 9" WIDTHS FOR STUD/BRICK
- (TYP.) U.N.O. 6) VERIFY ROUGH OPNG'S, SPECS. FOR CODE REQUIREMENTS WITH WINDOW MANUF.
- 1) SD = SMOKE DETECTOR

SQUARE FOOTAGE		
	HTD.	UNHTD.
* BSMNT.		
* FIRST FLR.	1680	492
* SECOND FLR.	924	283
* ATTIC (3rd, FLR.)		579
TOTAL	26Ø4	1354
MISC.		
*		
* COVERED ENTRY		62
* COVERED PORCH		75
* SCREENED PORC	H	165

WNDW. FALL PROTECTION NOTES:

SEE CODE SECTIONS R612 THRU R612.4 FOR WINDOW FALL PROTECTION DEVICE REQUIREMENTS IF WINDOW SILL IS LESS THAN 24" ABV. FLR. WITH A 6'-0" OR GREATER DISTANCE TO A SURFACE OUTSIDE AND BELOW THE WINDOW.

ALL DIMENSIONS, SITE

CONDITIONS & CODES ARE TO

BE VERIFIED BEFORE CONSTR.

BEGINS. ONCE CONSTR. HAS

BEGUN MURPHY GARNOW

DESIGN CONSTR. HAS DESIGN GROUP, INC. WILL NOT ASSUME ANY LIABILITY FOR ANY EXPENSES ASSOCIATED

WITH ERRORS & OMMISIONS.

GARNOW PESIGN GROUP

MURPHY

∑ ∑ Q

PRINCE LOT

DRAWN BY: TWG

FILE NAME: **HH-2-2604**

REVISIONS 6-15-22 TWG LOT 12-14-20 TWG PLAN 1-1-21 TWG PLAN 12-22-21 TWG REY.

© COPYRIGHT 2022 MURPHY GARNOW DESIGN GROUP, INC. ALL RIGHTS RESERVED




HOUSE NUMBER:

PAGE NUMBER:

THESE PLANS MEET THE REQUIREMENTS OF THE INTERNATIONAL RESIDENTIAL CODE '2015' AND THE NORTH CAROLINA RESIDENTIAL CODE '2018' EDITION.

FIRST FLOOR PLAN SCALE: -----1/4" = 1'-0"

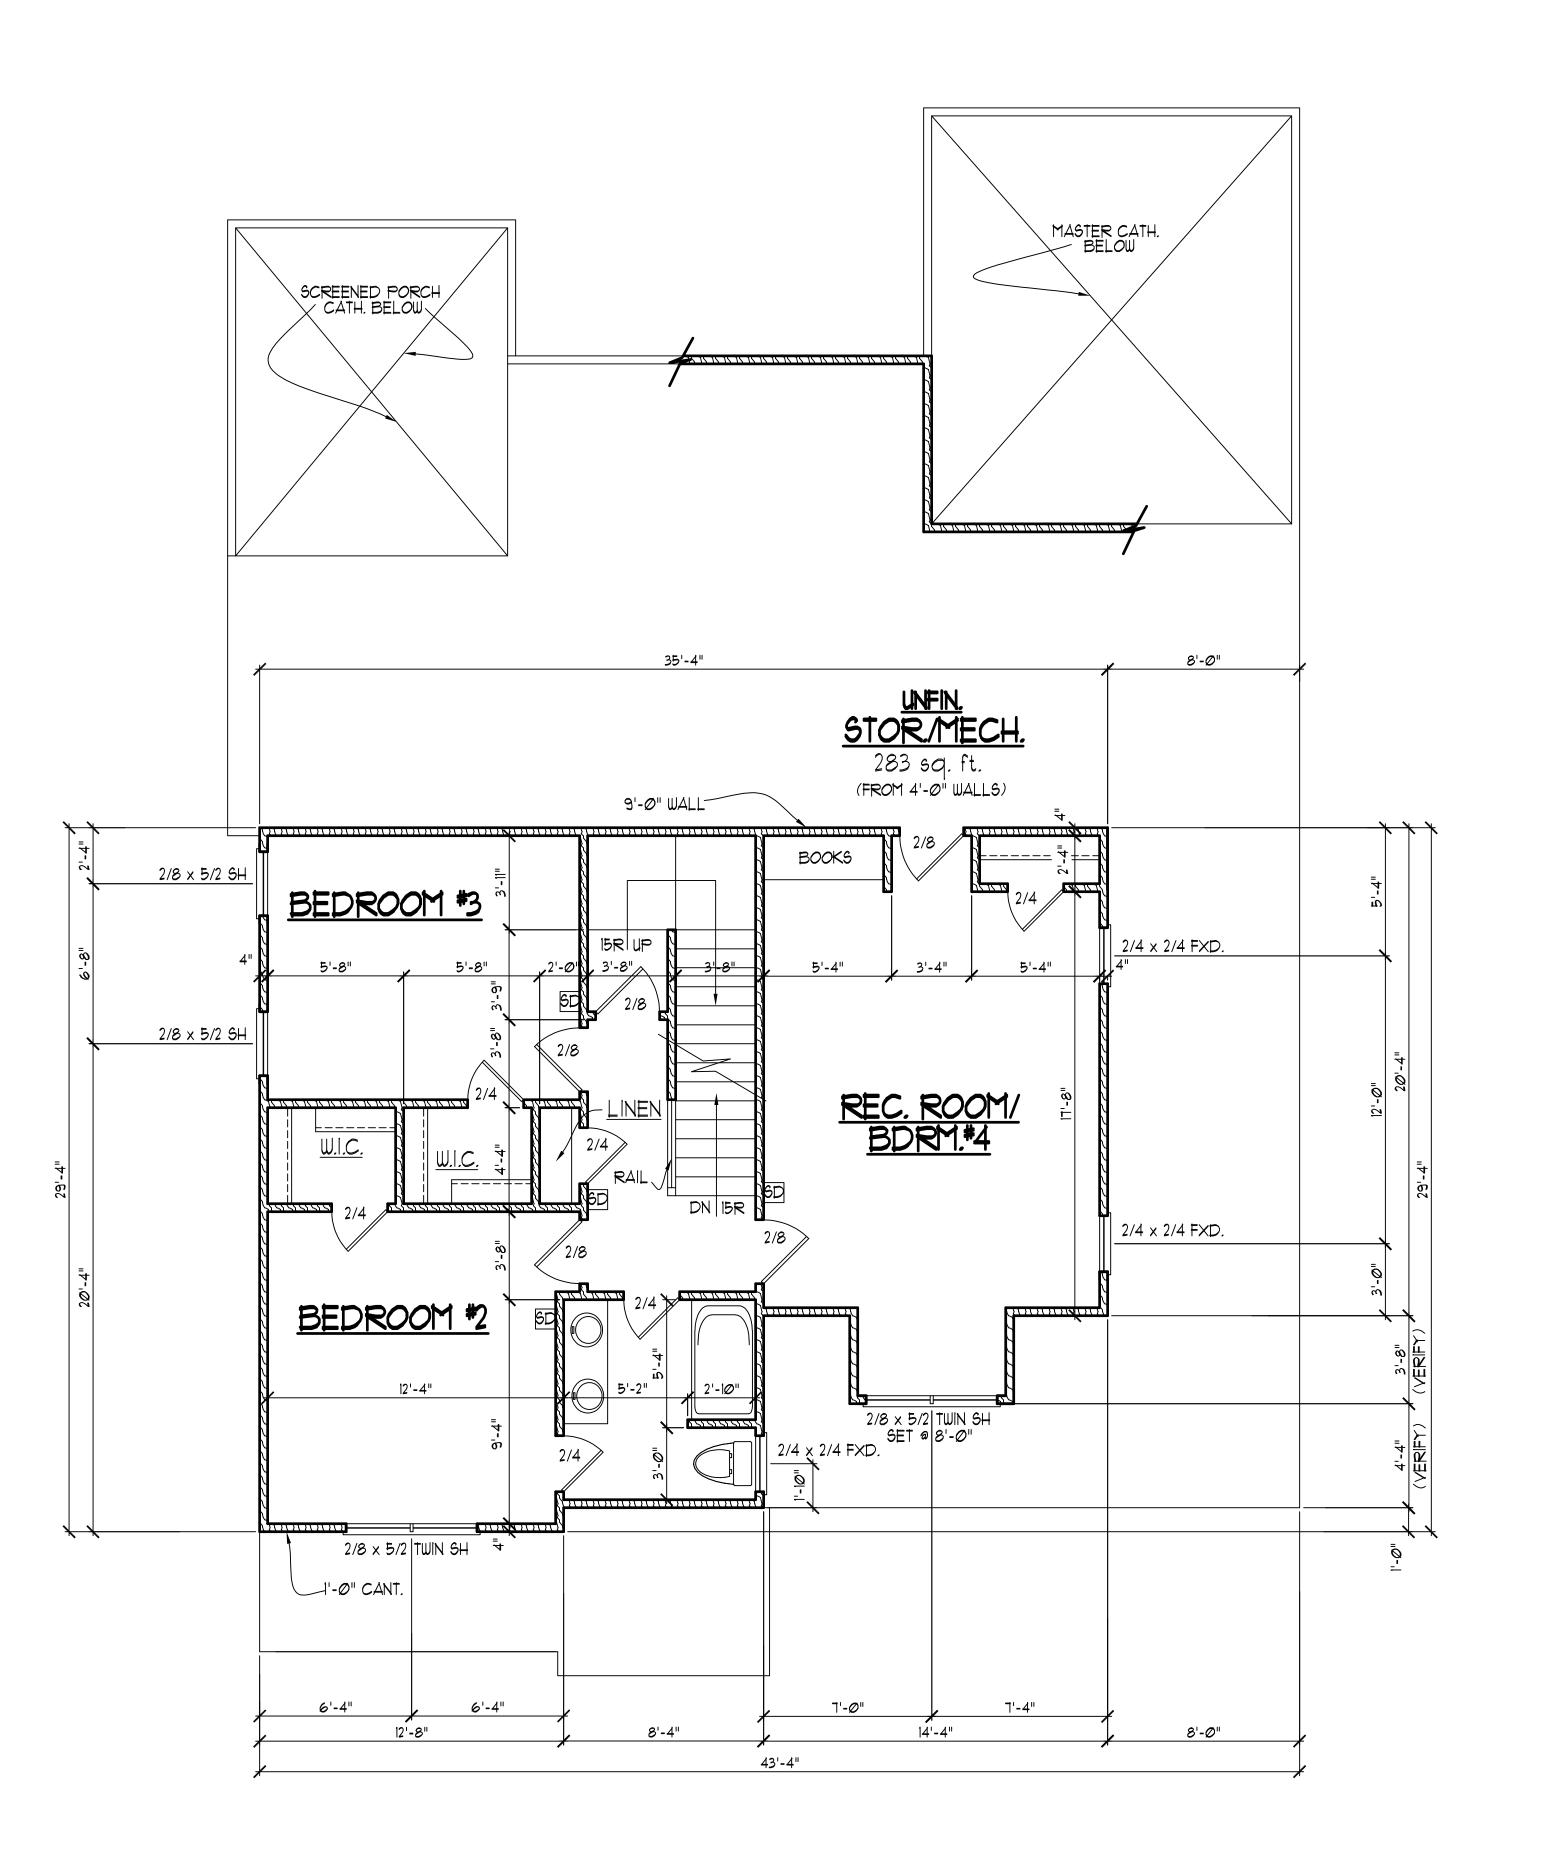

SECOND FLOOR NOTES:

1) 9'-0" CLG. HGT. (TYP.) U.N.O.

- 2) SET WINDOWS @ 7'-4' A.F.F. (TYP.) U.N.O. 3) STAIRS: UP 15 RISERS @ 8" (+ -)
- (TYP.) U.N.O.
- 4) ALL WALLS FIGURED AT 4" WIDTHS FOR FOR STUDS, 9" WIDTHS FOR STUD/BRICK (TYP.) U.N.O.
- 5) VERIFY ROUGH OPNG'S,,SPECS. FOR CODE REQUIREMENTS WITH WINDOW MANUF. 6) SD = SMOKE DETECTOR

MURPHY GARNOW DESIGN GROUP

ALL DIMENSIONS, SITE
CONDITIONS & CODES ARE TO
BE VERIFIED BEFORE CONSTR.
BEGINS. ONCE CONSTR. HAS
BEGUN MURPHY GARNOW

DESIGN GROUP, INC. WILL NOT ASSUME ANY LIABILITY FOR ANY EXPENSES ASSOCIATED

WITH ERRORS & OMMISIONS.

HALCYON

FILE NAME: HH-2-2604

REVISIONS 6-15-22 TWG LOT 12-14-20 TWG PLAN 7-7-21 TWG PLAN 12-22-21 TWG REY.

© COPYRIGHT 2022 MURPHY GARNOW DESIGN GROUP, INC. ALL RIGHTS RESERVED




HOUSE NUMBER:

PAGE NUMBER:

SECOND FLOOR PLAN SCALE: -----1/4" = 1'-0"

THESE PLANS MEET THE REQUIREMENTS OF THE INTERNATIONAL RESIDENTIAL CODE '2015' AND THE NORTH CAROLINA RESIDENTIAL CODE '2018' EDITION.

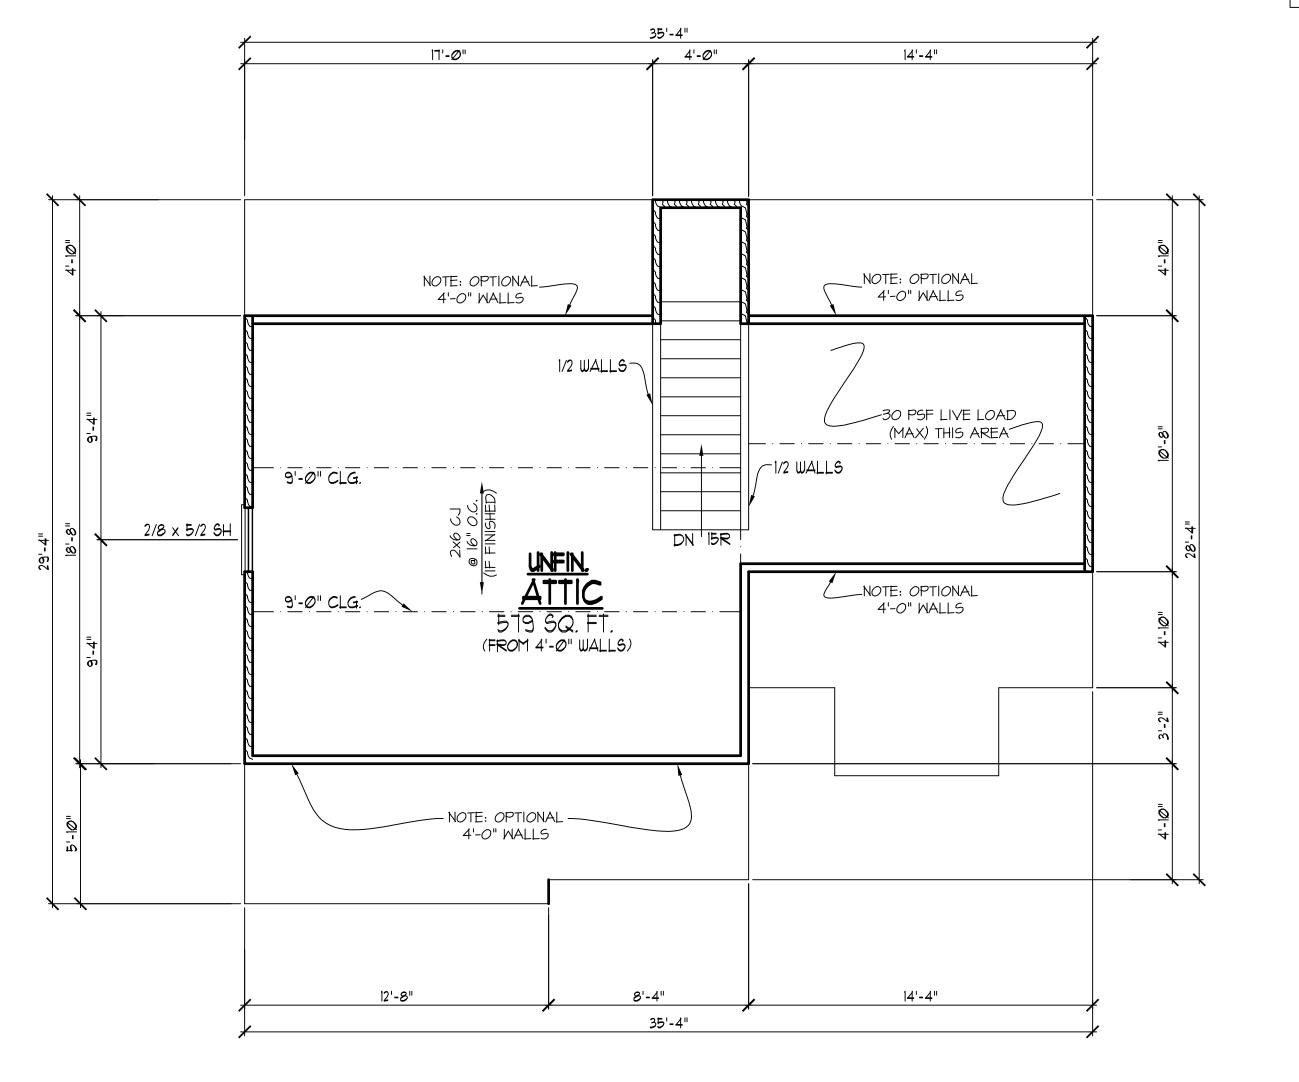

ATTIC FLOOR PLAN

1) 9'-0" CLG. HGT. (TYP.) U.N.O. 2) SET WINDOWS @ 7'-4" A.F.F. (TYP.) U.N.O.

3) ALL WALLS FIGURED AT 4" WIDTHS FOR FOR STUDS, 9" WIDTHS FOR STUD/BRICK (TYP.) U.N.O.

4) VERIFY ROUGH OPNG'S, SPECS. FOR CODE REQUIREMENTS WITH WINDOW MANUF. 5) SD = SMOKE DETECTOR

HEADER/BEAM & COLUMN NOTES

- ALL EXTERIOR AND LOAD BEARING HEADERS SHALL BE MIN. (2)2x6 (4" WALL) OR (3)2x6 (6" WALL) WITH (I) SUPPORT STUD, UNLESS NOTED
- THE NUMBER SHOWN AT BEAM AND HEADER SUPPORTS INDICATES THE NUMBER OF SUPPORT STUDS REQUIRED IN STUD POCKET OR COLUMN. THE NUMBER OF KING STUDS AT EACH END OF HEADERS IN EXTERIOR WALLS SHALL BE ACCORDING TO ITEM "d" IN TABLE R602.3(5) OR AS BELOW PER NCDOI COMMENTARY "KING STUDS AT WALL OPENINGS" REVISED 1-9-2020:
- •• UP TO 3' SPAN: (I) KING STUD •• OVER 3' UP TO 6' SPAN: (2) KING STUDS
- •• OVER 6' UP TO 9' SPAN: (3) KING STUDS • OVER 9' UP TO 12' SPAN: (4) KING STUDS
- OVER 12' UP TO 15' SPAN: (5) KING STUDS

FRAMING NOTE: ALL DIMENSIONAL LUMBER ON THIS SHEET MAY BE SPF #2 OR SYP #2, UNLESS SPECIFICALLY NOTED OTHERWISE.

- BRACING METHOD AND TYPE: CONTINUOUSLY SHEATHED WSP: CS-WSP. NOTE THAT THE WALL BRACING AMOUNT PROVIDED ON THE PLANS (DETAILS AND SPECIFICATIONS) IS GREATER THAN THE AMOUNT OF WALL BRACING REQUIRED BY THE CODE. SEE NOTES BELOW FOR DETAILS AND SPECIFICATIONS FOR WALL BRACING AND WALL
- 2. EXTERIOR WALL SHEATHING: WALLS SHALL BE BRACED BY SHEATHING WALLS ON ALL STORIES WITH WOOD STRUCTURAL PANEL SHEATHING (WSP) (EXPOSURE B: 1/16". EXPOSURE C: 15/32"). SHEATHING SHALL BE ATTACHED WITH 8d NAILS AT A 6"/12" NAILING PATTERN (6" OC AT PANEL EDGES AND 12" OC AT INTERMEDIATE SUPPORTS). INSTALL BLOCKING AT ALL PANEL EDGES.
- MSP SHEATHING BETWEEN FLOORS SHALL BE SPLICED ALONG CONTINUOUS BAND OR THE WSP SHEATHING MAY BE SPLICED ACROSS STUDS (CONTINUOUS ACROSS FLOOR SYSTEM) WITH BLOCKING AT PANEL EDGES. (MINIMUM 12" BEYOND FLOOR BREAK) OR OTHER APPROVED METHOD.
- 4. "HD" = HOLDOWN: HOLD-DOWN DEVICE (NOTED AS "HD" ON PLANS) SHALL BE AN 800 POUND CAPACITY ASSEMBLY AS NOTED ON PLANS.
- **GROUND/FIRST FLOOR: USE "HD HOLD-DOWN DETAIL" ON SD SHEET (OR EQUIV.)
- STRAP DOWN ACROSS THE BAND AND DOWN TO A STUD BELOW OR HEADER BELOW. EXTEND STRAP 7" MIN ALONG EACH STUD (OR HEADER) AND ATTACH EACH END W/ (7) 8d NAILS.
- 5. INTERIOR BRACED WALL: (NOTED AS "IBW" ON PLANS) ATTACH I/2" GYPSUM BOARD (GB) ON EACH SIDE OF WALL WITH A MIN. OF 5d INTERMEDIATE SUPPORTS.
- "IBW-WSP" ON PLANS). ATTACH ONE SIDE WITH 1/6" WSP SHEATHING WITH 8d NAILS AT A 6"/12" NAILING PATTERN (6" OC AT PANEL EDGES PANEL EDGES. ATTACH GB OVER WSP AS REQUIRED. ATTACH SCREWS @ 7" OC ALONG THE EDGES AND AT INTERMEDIATE

FRAMING NOTES

NC (2018 NCRC): Wind: 115-120 mph

- 3. WSP SHEATHING SHALL EXTEND TO THE UPPERMOST DOUBLE BEARING PLATE. BLOCK AT ROOF AND ATTACH BRACED WALLS PER CODE.
- SEE DETAILS FOR HD ASSEMBLY.
- **UPPER FLOORS: ATTACH BASE OF KING STUD WITH A SIMPSON CS22
- COOLER NAILS OR #6 SCREWS @ 7" O.C. ALONG THE EDGES AND AT
- 6. INTERIOR BRACED WALL-WOOD STRUCTURAL PANEL: (NOTED AS AND 12" OC AT INTERMEDIATE SUPPORTS). INSTALL BLOCKING AT ALL OPPOSITE SIDE WITH I/2" GB WITH A MIN. OF 5d COOLER NAILS OR #6

REFER TO "SD" SHEET(S) FOR STANDARD DETAILS, BRACING DETAILS AND STRUCTURAL NOTES.



STRUCTURAL DESIGN BY: SOUTHERN ENGINEERS, P.A. 3716 BENSON DRIVE RALEIGH, NC 27609 LICENSE: C-4772, PHONE: 919-878-1617 PROJECT #: 22-1573

- Engineers seal applies only to structural components on this document. Seal does not include construction means, methods, techniques, sequences, procedures
- or safety precautions. Any deviations or discrepancies on plans are to be brought to the immediate attention of Southern Engineers. Failure to do so will void Southern Engineer's liability.
- Seal is valid for a project permitted within one year from date of seal.
- Use of these plans constitutes approval of terms and conditions as defined in the customer agreement.

THIRD FLR./ ATTIC PLAN SCALE: -----1/4" = 1'-0"

> THESE PLANS MEET THE REQUIREMENTS OF THE NORTH CAROLINA RESIDENTIAL CODE '2018' EDITION.

ALL DIMENSIONS, SITE CONDITIONS & CODES ARE TO BE VERIFIED BEFORE CONSTR. BEGINS. ONCE CONSTR. HAS BEGUN MURPHY GARNOW DESIGN GROUP, INC. WILL NOT ASSUME ANY LIABILITY FOR ANY EXPENSES ASSOCIATED WITH ERRORS & OMMISIONS.

aroup, GARNOWI

MURPHY

FAX; (919)

Q

 \triangleleft

DRAWN BY: TWG

FILE NAME: **HH-2-2604** REVISIONS 6-15-22 TWG LOT 12-14-20 TWG PLAN 1-1-21 TWG PLAN

12-22-21 TWG REV. © COPYRIGHT 2022

MURPHY GARNOW DESIGN GROUP, INC. ALL RIGHTS RESERVED

HOUSE NAME:

HOUSE NUMBER:

POST TO BASE WITH A POST CAP OR METAL

STRAP(S) OR BRACKET(S), AND/OR A POST BASE.

NOTE

MURPHY GARNOW DESIGN GROUP, INC.
HEREBY EXPRESSLY RESERVES ITS COPYRIGHT AND
OTHER PROPERTY RIGHTS TO THESE PLANS. THESE
PLANS ARE TO BE USED FOR THE CONSTRUCTION OF
(ONE) RESIDENCE ONLY, ANY OTHER USE, CHANGE
AND/OR REPRODUCTION IN ANY FORM WILL RENDER
THESE PLANS FRAUDULENT.

FRAMING NOTES

NC (2018 NCRC): Wind: 115-120 mph

- I. BRACING METHOD AND TYPE: CONTINUOUSLY SHEATHED WSP: CS-WSP. NOTE THAT THE WALL BRACING AMOUNT PROVIDED ON THE PLANS (DETAILS AND SPECIFICATIONS) IS GREATER THAN THE AMOUNT OF WALL BRACING REQUIRED BY THE CODE. SEE NOTES BELOW FOR DETAILS AND SPECIFICATIONS FOR WALL BRACING AND WALL FRAMING.
- 2. EXTERIOR WALL SHEATHING: WALLS SHALL BE BRACED BY SHEATHING WALLS ON ALL STORIES WITH WOOD STRUCTURAL PANEL SHEATHING (MSP) (EXPOSURE B: 7/16". EXPOSURE C: 15/32"). SHEATHING SHALL BE ATTACHED WITH & NAILS AT A 6"/12" NAILING PATTERN (6" OC AT PANEL EDGES AND 12" OC AT INTERMEDIATE SUPPORTS). INSTALL BLOCKING AT ALL PANEL EDGES.
- 3. WSP SHEATHING SHALL EXTEND TO THE UPPERMOST DOUBLE BEARING PLATE. BLOCK AT ROOF AND ATTACH BRACED WALLS PER CODE. WSP SHEATHING BETWEEN FLOORS SHALL BE SPLICED ALONG CONTINUOUS BAND OR THE WSP SHEATHING MAY BE SPLICED ACROSS STUDS (CONTINUOUS ACROSS FLOOR SYSTEM) WITH BLOCKING AT PANEL EDGES. (MINIMUM 12" BEYOND FLOOR BREAK) OR OTHER APPROVED METHOD.
- 4. "HD" = HOLDOWN: HOLD-DOWN DEVICE (NOTED AS "HD" ON PLANS)
 SHALL BE AN 800 POUND CAPACITY ASSEMBLY AS NOTED ON PLANS.
 SEE DETAILS FOR HD ASSEMBLY.

 **GROUND/EIRST ELOOP: LIGE "HD HOLD-DOWN DETAIL" ON SD SHEET
- **GROUND/FIRST FLOOR: USE "HD HOLD-DOWN DETAIL" ON SD SHEET (OR EQUIV.)
- **UPPER FLOORS: ATTACH BASE OF KING STUD WITH A SIMPSON CS22
 STRAP DOWN ACROSS THE BAND AND DOWN TO A STUD BELOW OR
 HEADER BELOW. EXTEND STRAP 7" MIN ALONG EACH STUD (OR
 HEADER) AND ATTACH EACH END W (7) 8d NAILS.
- 5. INTERIOR BRACED WALL: (NOTED AS "IBW" ON PLANS) ATTACH I/2" GYPSUM BOARD (GB) ON EACH SIDE OF WALL WITH A MIN. OF 5d COOLER NAILS OR #6 SCREWS @ 7" O.C. ALONG THE EDGES AND AT INTERMEDIATE SUPPORTS.
- 6. INTERIOR BRACED WALL-WOOD STRUCTURAL PANEL: (NOTED AS "IBW-WSP" ON PLANS). ATTACH ONE SIDE WITH 1/6" WSP SHEATHING WITH 8d NAILS AT A 6"/12" NAILING PATTERN (6" OC AT PANEL EDGES AND 12" OC AT INTERMEDIATE SUPPORTS). INSTALL BLOCKING AT ALL PANEL EDGES. ATTACH GB OVER WSP AS REQUIRED. ATTACH OPPOSITE SIDE WITH 1/2" GB WITH A MIN. OF 5d COOLER NAILS OR #6 SCREWS @ 7" OC ALONG THE EDGES AND AT INTERMEDIATE GURPORTS.


TRUSS SYSTEM REQUIREMENTS
NC (2018 NCRC): Wind: 115-120 mph

- TRUSS SYSTEM LAYOUTS (PLACEMENT PLANS)
 SHALL BE DESIGNED IN ACCORDANCE WITH SEALED
 STRUCTURAL PLANS. ANY NEED TO CHANGE
 TRUSSES SHALL BE COORDINATED WITH SOUTHERN
 ENGINEERS.
- TRUSS SCHEMATICS (PROFILES) SHALL BE
 PREPARED AND SEALED BY TRUSS MANUFACTURER.
- 3. ALL TRUSSES SHALL BE DESIGNED FOR BEARING ON SPF #2 OR #3 PLATES OR LEDGERS (UNO).
- 4. ALL REQUIRED ANCHORS FOR TRUSSES DUE TO UPLIFT OR BEARING SHALL MEET THE REQUIREMENTS AS SPECIFIED ON THE TRUSS SCHEMATICS.
- 5. INSTALL TRUSS BELOW PARALLEL PARTITION WALLS OR BLOCK BETWEEN TRUSSES (BY TRUSS SUPPLIER)

- HEADER/BEAM & COLUMN NOTES
- I. ALL EXTERIOR AND LOAD BEARING HEADERS SHALL BE MIN. (2)2x6 (4" WALL) OR (3)2x6 (6" WALL) WITH (I) SUPPORT STUD, UNLESS NOTED OTHERWISE.
- 2. THE NUMBER SHOWN AT BEAM AND HEADER SUPPORTS INDICATES THE NUMBER OF SUPPORT STUDS REQUIRED IN STUD POCKET OR COLUMN. THE NUMBER OF KING STUDS AT EACH END OF HEADERS IN EXTERIOR WALLS SHALL BE ACCORDING TO ITEM "d" IN TABLE R602.3(5) OR AS BELOW PER NCDOI COMMENTARY "KING STUDS AT WALL OPENINGS" REVISED I-9-2020:
- UP TO 3' SPAN: (1) KING STUD
 OVER 3' UP TO 6' SPAN: (2) KING STUDS
 OVER 6' UP TO 9' SPAN: (3) KING STUDS
- OVER 6' UP TO 9' SPAN: (3) KING STUDS OVER 9' UP TO 12' SPAN: (4) KING STUDS OVER 12' UP TO 15' SPAN: (5) KING STUDS

FRAMING NOTE: ALL DIMENSIONAL LUMBER ON THIS SHEET MAY BE SPF #2 OR SYP #2, UNLESS SPECIFICALLY NOTED OTHERWISE.

REFER TO "SD" SHEET(S) FOR STANDARD DETAILS, BRACING DETAILS AND STRUCTURAL NOTES.

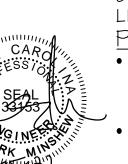

STRUCTURAL DESIGN BY:
SOUTHERN ENGINEERS, P.A.
3716 BENSON DRIVE RALEIGH, NC 27609
LICENSE: C-4772, PHONE: 919-878-1617
PROJECT #: 22-1573

- Engineers seal applies only to structural components on this document. Seal does not include construction means, methods, techniques, sequences, procedures or safety precautions.
- or safety precautions.

 Any deviations or discrepancies on plans are to be brought to the immediate attention of Southern Engineers. Failure to do so will void Southern
- Engineer's liability.Seal is valid for a project permitted within one year from date of seal.
- Use of these plans constitutes approval of terms and conditions as defined in the customer agreement.

FIRST FLOOR CEILING STRUCTURAL PLAN 9'-0" CLG. HGT.

THESE PLANS MEET THE REQUIREMENTS OF THE NORTH CAROLINA RESIDENTIAL CODE '2018' EDITION.

ALL DIMENSIONS, SITE
CONDITIONS & CODES ARE TO
BE VERIFIED BEFORE CONSTR.
BEGINS. ONCE CONSTR. HAS
BEGUN MURPHY GARNOW
DESIGN GROUP, INC. WILL NOT
ASSUME ANY LIABILITY FOR
ANY EXPENSES ASSOCIATED
WITH ERRORS & OMMISIONS.

BES ASSOCIA RS & OMMISIO

CARNOW DESIGN GROUP
1140-300 KILDAIRE FARM ROAD
CARY, NORTH CAROLINA 27511

MURPHY

ON HOMES JCE PLACE

DRAWN BY: TWG DATE: 12-2-14 FILE NAME: HH-2-2604

REVISIONS 6-15-22 TWG LOT 12-14-20 TWG PLAN

7-7-21 TWG PLAN

12-22-21 TWG REY.

© COPYRIGHT 2022 MURPHY GARNOW DESIGN GROUP, INC. ALL RIGHTS RESERVED


HOUSE NAME:

BELL

HOUSE NUMBER:

PAGE NUMBER:

7 0 = 0

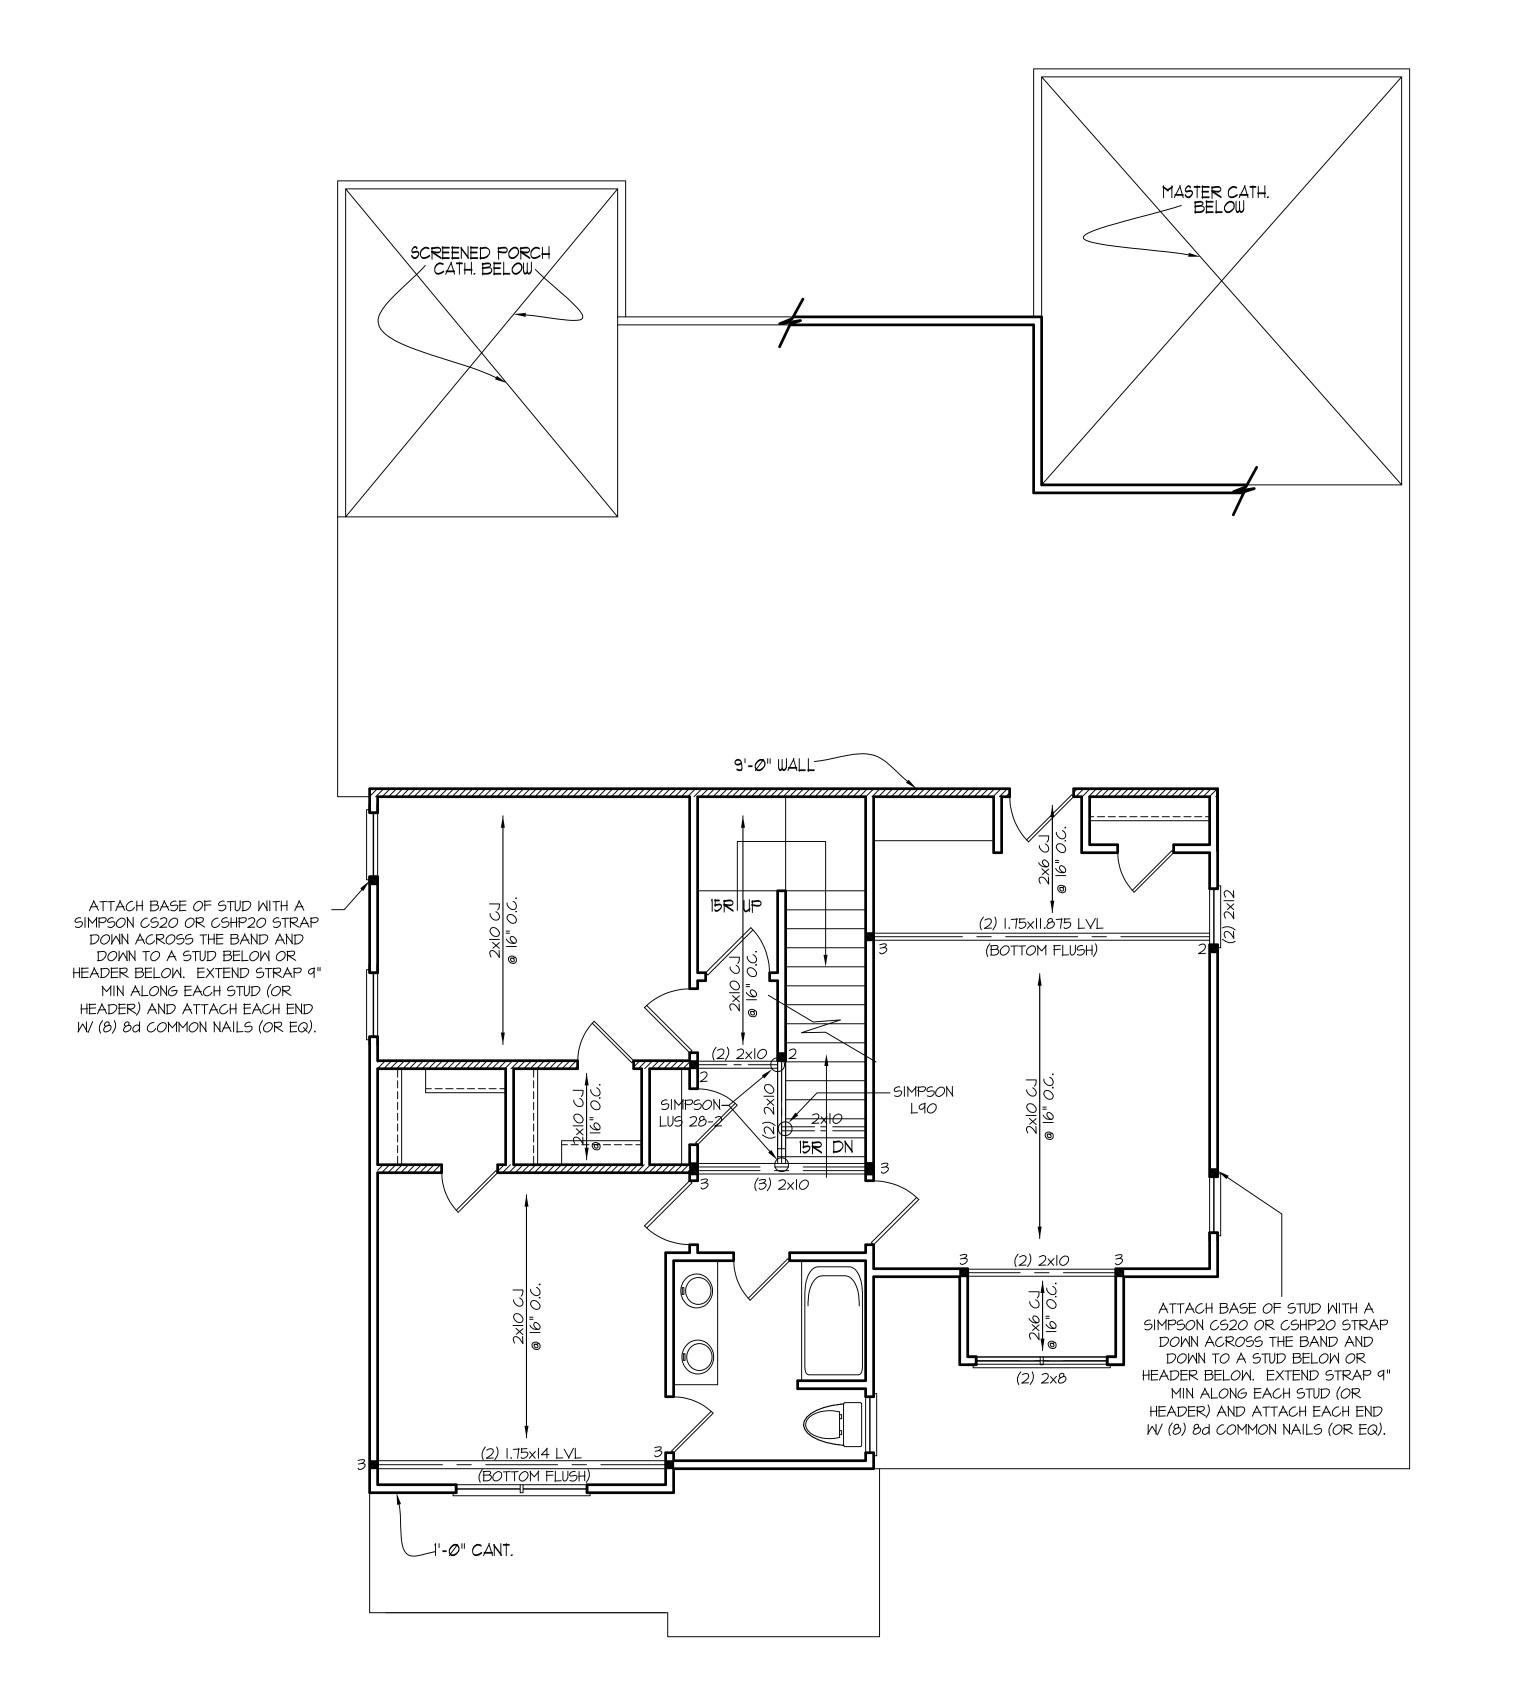

FRAMING NOTES NC (2018 NCRC): Wind: 115-120 mph

- I. BRACING METHOD AND TYPE: CONTINUOUSLY SHEATHED WSP: CS-WSP. NOTE THAT THE WALL BRACING AMOUNT PROVIDED ON THE PLANS (DETAILS AND SPECIFICATIONS) IS GREATER THAN THE AMOUNT OF WALL BRACING REQUIRED BY THE CODE. SEE NOTES BELOW FOR DETAILS AND SPECIFICATIONS FOR WALL BRACING AND WALL
- 2. EXTERIOR WALL SHEATHING: WALLS SHALL BE BRACED BY SHEATHING WALLS ON ALL STORIES WITH WOOD STRUCTURAL PANEL SHEATHING (MSP) (EXPOSURE B: 7/16". EXPOSURE C: 15/32"). SHEATHING SHALL BE ATTACHED WITH 8d NAILS AT A 6"/12" NAILING PATTERN (6" OC AT PANEL EDGES AND 12" OC AT INTERMEDIATE SUPPORTS). INSTALL BLOCKING AT ALL PANEL EDGES.
- 3. WSP SHEATHING SHALL EXTEND TO THE UPPERMOST DOUBLE BEARING PLATE. BLOCK AT ROOF AND ATTACH BRACED WALLS PER CODE. MSP SHEATHING BETWEEN FLOORS SHALL BE SPLICED ALONG CONTINUOUS BAND OR THE WSP SHEATHING MAY BE SPLICED ACROSS STUDS (CONTINUOUS ACROSS FLOOR SYSTEM) WITH BLOCKING AT PANEL EDGES. (MINIMUM 12" BEYOND FLOOR BREAK) OR OTHER APPROVED METHOD.
- 4. "HD" = HOLDOWN: HOLD-DOWN DEVICE (NOTED AS "HD" ON PLANS) SHALL BE AN 800 POUND CAPACITY ASSEMBLY AS NOTED ON PLANS. SEE DETAILS FOR HD ASSEMBLY.
- **GROUND/FIRST FLOOR: USE "HD HOLD-DOWN DETAIL" ON SD SHEET (OR EQUIV.)
- **UPPER FLOORS: ATTACH BASE OF KING STUD WITH A SIMPSON CS22 STRAP DOWN ACROSS THE BAND AND DOWN TO A STUD BELOW OR HEADER BELOW. EXTEND STRAP 7" MIN ALONG EACH STUD (OR HEADER) AND ATTACH EACH END W/ (7) 8d NAILS.
- 5. INTERIOR BRACED WALL: (NOTED AS "IBW" ON PLANS) ATTACH I/2" GYPSUM BOARD (GB) ON EACH SIDE OF WALL WITH A MIN. OF 5d COOLER NAILS OR #6 SCREWS @ 7" O.C. ALONG THE EDGES AND AT INTERMEDIATE SUPPORTS.
- 6. INTERIOR BRACED WALL-WOOD STRUCTURAL PANEL: (NOTED AS "IBW-WSP" ON PLANS). ATTACH ONE SIDE WITH %" WSP SHEATHING WITH 8d NAILS AT A 6"/12" NAILING PATTERN (6" OC AT PANEL EDGES AND 12" OC AT INTERMEDIATE SUPPORTS). INSTALL BLOCKING AT ALL PANEL EDGES. ATTACH GB OVER WSP AS REQUIRED. ATTACH OPPOSITE SIDE WITH I/2" GB WITH A MIN. OF 5d COOLER NAILS OR #6 SCREWS @ 7" OC ALONG THE EDGES AND AT INTERMEDIATE

HEADER/BEAM & COLUMN NOTES

- ALL EXTERIOR AND LOAD BEARING HEADERS SHALL BE MIN. (2)2x6 (4" WALL) OR (3)2x6 (6" WALL) WITH (I) SUPPORT STUD, UNLESS NOTED OTHERWISE.
- 2. THE NUMBER SHOWN AT BEAM AND HEADER SUPPORTS INDICATES THE NUMBER OF SUPPORT STUDS REQUIRED IN STUD POCKET OR COLUMN. THE NUMBER OF KING STUDS AT EACH END OF HEADERS IN EXTERIOR WALLS SHALL BE ACCORDING TO ITEM "d" IN TABLE R602.3(5) OR AS BELOW PER NCDOI COMMENTARY "KING STUDS AT WALL OPENINGS" REVISED 1-9-2020:
- •• UP TO 3' SPAN: (I) KING STUD OVER 3' UP TO 6' SPAN: (2) KING STUDS
- OVER 6' UP TO 9' SPAN: (3) KING STUDS
- OVER 9' UP TO 12' SPAN: (4) KING STUDS •• OVER 12' UP TO 15' SPAN: (5) KING STUDS

FRAMING NOTE: ALL DIMENSIONAL LUMBER ON THIS SHEET MAY BE SPF #2 OR SYP #2, UNLESS SPECIFICALLY NOTED OTHERWISE.

REFER TO "SD" SHEET(S) FOR STANDARD DETAILS, BRACING DETAILS AND STRUCTURAL NOTES.

STRUCTURAL DESIGN BY: SOUTHERN ENGINEERS, P.A. 3716 BENSON DRIVE RALEIGH, NC 27609 LICENSE: C-4772, PHONE: 919-878-1617 PROJECT #: 22-1573

- Engineers seal applies only to structural components on this document. Seal does not include construction means, methods, techniques, sequences, procedures or safety precautions.
- Any deviations or discrepancies on plans are to be brought to the immediate attention of Southern Engineers. Failure to do so will void Southern Engineer's liability.
- Seal is valid for a project permitted within one year from date of seal.
- Use of these plans constitutes approval of terms and conditions as defined in the customer agreement.

SECOND FLOOR CEILING STRUCTURAL PLAN SCALE: ------ 1/4" = 1'-0"

THESE PLANS MEET THE REQUIREMENTS OF THE NORTH CAROLINA RESIDENTIAL CODE '2018' EDITION.

ALL DIMENSIONS, SITE CONDITIONS & CODES ARE TO BE VERIFIED BEFORE CONSTR. BEGINS. ONCE CONSTR. HAS BEGUN MURPHY GARNOW DESIGN GROUP, INC. WILL NOT ASSUME ANY LIABILITY FOR ANY EXPENSES ASSOCIATED

WITH ERRORS & OMMISIONS.

TH CAROLINA 275 FAX; (919) 481-GARNOW

MURPHY


DRAWN BY: TWG FILE NAME: **HH-2-2604**

REVISIONS 6-15-22 TWG LOT 12-14-20 TWG PLAN 1-1-21 TWG PLAN 12-22-21 TWG REV.

© COPYRIGHT 2022 MURPHY GARNOW DESIGN GROUP, INC. ALL RIGHTS RESERVED



HOUSE NUMBER:

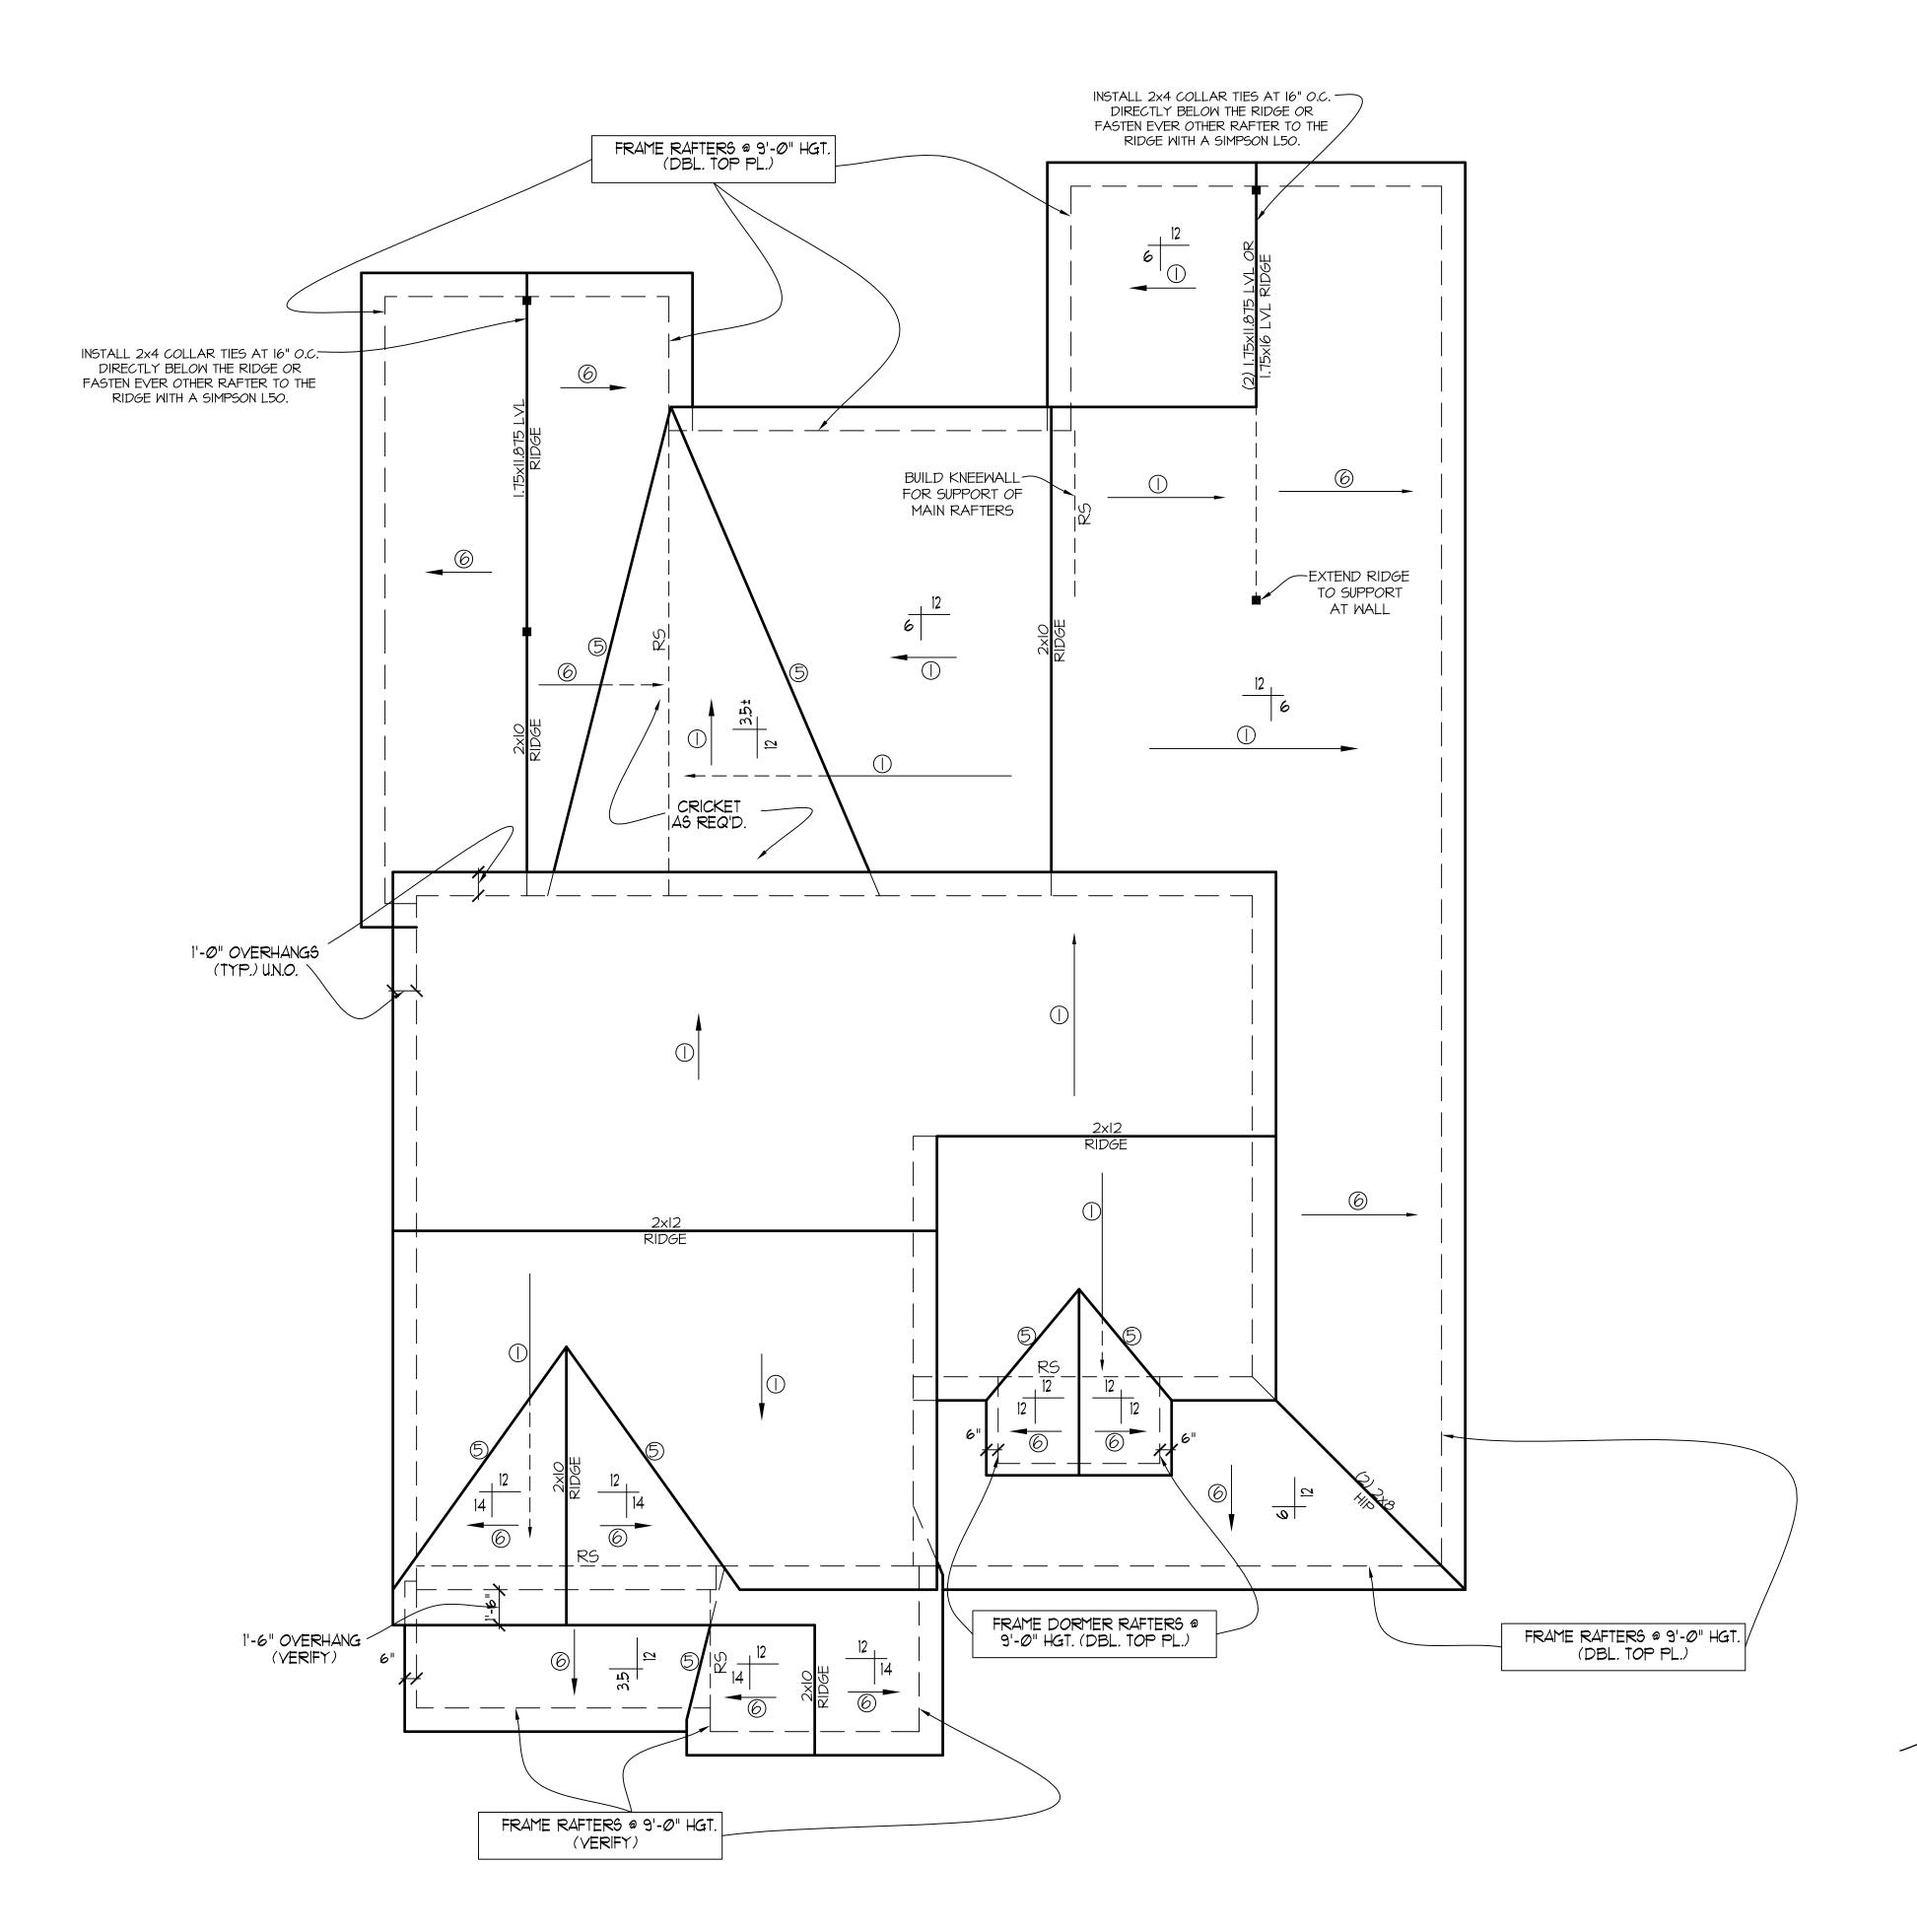

ROOF FRAMING NOTES:

- 1) ALLROOF PITCHES TO BE 10/12 (TYP.) U.N.O. 2) PROVIDE 2x4 COLLAR BEAMS EVERYOTHER RAFTER (TYP.)
- 3) PROVIDE "HURRICANE CLIPS" AT ALL VALLEYS AND OPPPOSING DBL. RAFTERS
- 4) PROVIDE DBL. HEADERS ABD TRIMMERS AT ALL ROOF OPENINGS (EX: DORMERS, SKYLIGHTS, CHIMNEYS,ETC.)
- 5) 2x8 RAFTERS @ CATH. OR YAULTED CLGS. TO BE FURRED DOWN OR USE DEEPER RAFTERS (VERIFY BRNG. HGT.) FOR PROPER INSULATION PER CODE
- 6) VERIFY ALL RAFTER BRNG. HGTS. BEFORE CONSTR. HAS BEGUN

FRAME 12/12 RAFTERS ON A 31/2"± KNEEWALL TO ALIGN SOFFITS W/ 10/12 SOFFITS. (VERIFY W/ BLDR.)

ROOF FRAMING NOTES: NC (2018 NCRC): Wind: 115-120 mph

- 1. 2x8 @ 16" O.C. WITH 2x10 RIDGE, UNO.
- (2) 2xIO OR 1.75xII.875 LVL HIP. (2) 2xIO HIPS MAY BE SPLICED WITH A MIN. 6'-O" OVERLAP AT CENTER
- (2) 2xIO OR 1.75x9.25 LVL VALLEY. DO NOT SPLICE VALLEYS
- (4) 1.75x11.875 LVL OR (2)1.75x9.25 LVL VALLEY
- (5.) FALSE FRAME VALLEY ON 2XIO FLAT PLATE
- (6) 2x6 RAFTERS @ 16" O.C. W/ 2x8 RIDGE, UNO.
- 7.) 2xIO RAFTERS @ I6" O.C. W 2xI2 RIDGE, UNO.
- (8) EXTEND RIDGE 12" BEYOND INTERSECTION
- "SR" = SINGLE RAFTER
- "DR" = DOUBLE RAFTER
- "TR" = TRIPLE RAFTER "RS" = ROOF SUPPORT
- "■" = (3) STUD OR 4x4 POST FOR ROOF SUPPORT (USE 2X6 STUDS OR 6X6 POST FOR SUPPORT OVER 10'-0" IN
- ATTACH VAULTED RAFTERS WITH HURRICANE CLIPS: SIMPSON "H-2.5A" OR EQUIVALENT. TIES TO BE INSTALLED
- ON THE OUTSIDE FACE OF FRAMING. INSTALL RAFTER TIES AND COLLAR TIES PER SECTION R802.3.1 OF THE 2018 NC RESIDENTIAL CODE.

FRAMING NOTE: ALL DIMENSIONAL LUMBER ON THIS SHEET MAY BE SPF #2 OR SYP #2, UNLESS SPECIFICALLY NOTED OTHERWISE.

> REFER TO "SD" SHEET(S) FOR STANDARD DETAILS, BRACING DETAILS AND STRUCTURAL NOTES.

STRUCTURAL DESIGN BY:

SOUTHERN ENGINEERS, P.A. 3716 BENSON DRIVE RALEIGH, NC 27609 LICENSE: C-4772, PHONE: 919-878-1617 PROJECT #: 22-1573 • Engineers seal applies only to structural components

- on this document. Seal does not include construction means, methods, techniques, sequences, procedures or safety precautions.
- Any deviations or discrepancies on plans are to be brought to the immediate attention of Southern Engineers. Failure to do so will void Southern Engineer's liability.
- Seal is valid for a project permitted within one year from date of seal.
- Use of these plans constitutes approval of terms and conditions as defined in the customer agreement.



THESE PLANS MEET THE REQUIREMENTS OF THE NORTH CAROLINA RESIDENTIAL CODE '2018' EDITION.

ALL DIMENSIONS, SITE CONDITIONS & CODES ARE TO BE VERIFIED BEFORE CONSTR. BEGINS. ONCE CONSTR. HAS BEGUN MURPHY GARNOW DESIGN GROUP, INC. WILL NOT ASSUME ANY LIABILITY FOR ANY EXPENSES ASSOCIATED

WITH ERRORS & OMMISIONS.

aroup,

DESIGN (

GARNOW

MURPHY

DRAWN BY: TWG 12-2-14

Q

 \triangleleft


FILE NAME: **HH-2-2604**

REVISIONS | TWG | LOT 12-14-20 TWG PLAN 1-1-21 TWG PLAN 12-22-21 TWG REV.


© COPYRIGHT 2022 MURPHY GARNOW DESIGN GROUP, INC. ALL RIGHTS RESERVED



HOUSE NUMBER:

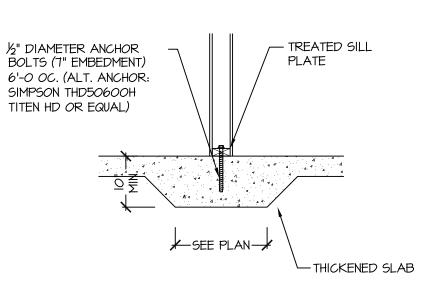

(INTERIOR BEARING WALL)

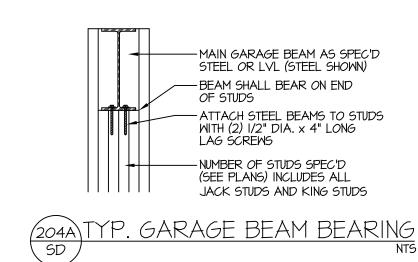

(2) SIMPSON CSI6 STRAP-

TO WALL TOP PLATE AND

MIN (2)2X WALL FRAMING.

SEE PLAN FOR STUD

COLUMN REQUIREMENTS.

TREATED SILLPLATE -

½" ANCHOR BOLTS PER

PLATE WASHERS.

R403.I.6 WITH 2"x2"x36"

NOTE: FOR CMU APPLICATIONS AT GARAGE DOORS, ANCHOR BOLTS SHALL

TO FOOTING (PER NORC FIGURE

BE %" DIAMETER AND SHALL EXTEND

R602.10.4.3 (SEE GARAGE "WING WALL" DETAIL ON STRUCTURAL PLANS)


WITH 8d NAILS. (EXTEND


EXTEND 20" UNDER


(2) ROWS OF 16d-

NAILS @ 3" OC

HEADER).

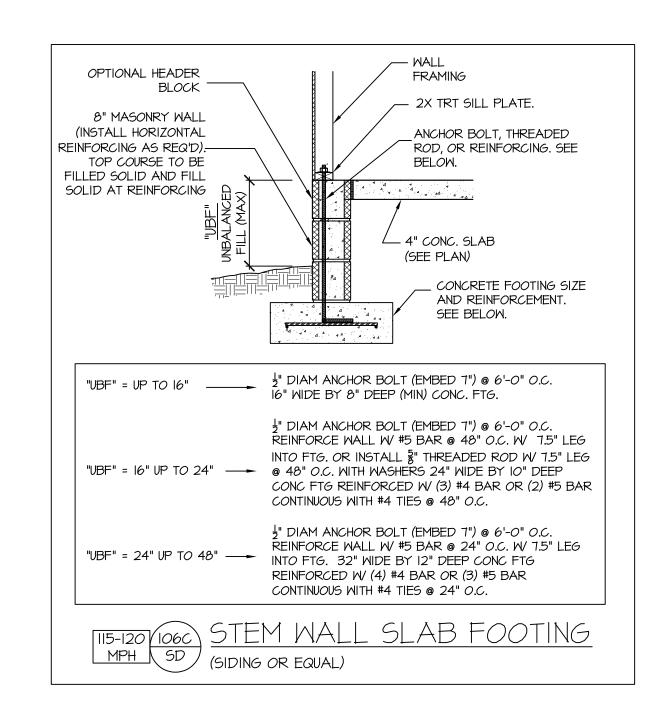

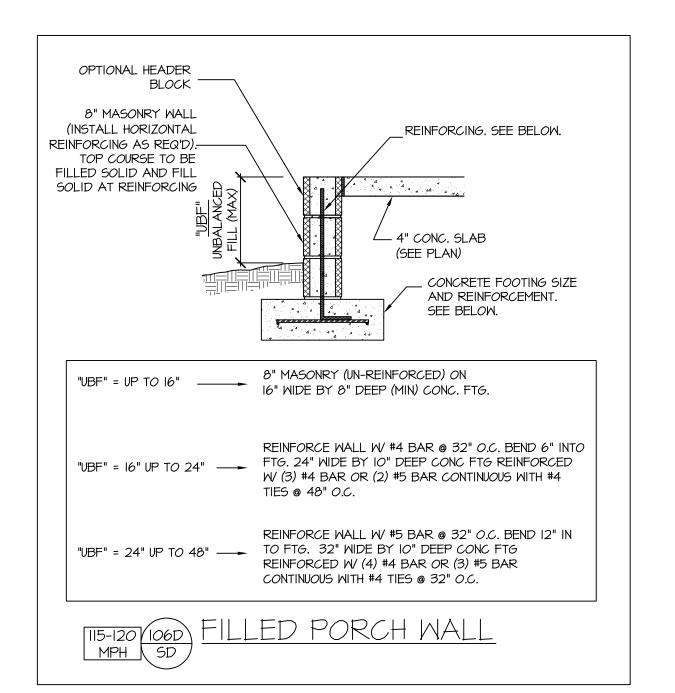

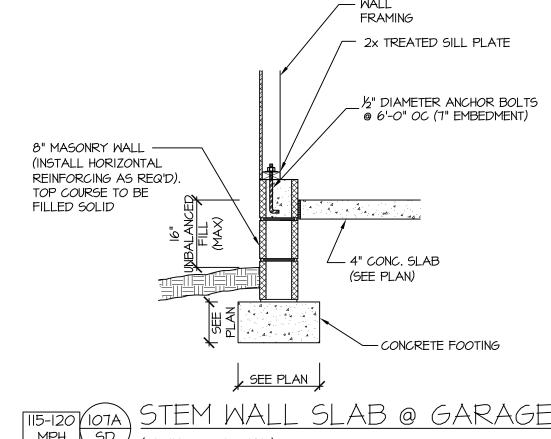


STRUCTURAL NOTES NC (2018 NCRC): Wind: 115-120 mph

I. ENGINEER'S SEAL APPLIES ONLY TO STRUCTURAL COMPONENTS INCLUDING ROOF RAFTERS, HIPS, VALLEYS, RIDGES, FLOORS, WALLS, BEAMS AND HEADERS, COLUMNS, CANTILEVERS, OFFSET LOAD BEARING WALLS, PIER & GIRDER SYSTEM, FOOTING, AND PILING SYSTEM. ENGINEER'S SEAL DOES NOT CERTIFY DIMENSIONAL ACCURACY OR ARCHITECTURAL LAYOUT INCLUDING ROOF SYSTEM. ALL REQUIREMENTS FOR PROFESSIONAL CERTIFICATION SHALL BE PROVIDED BY THE APPROPRIATE PROFESSIONAL. SOUTHERN ENGINEERS, P.A. CERTIFIES ONLY THE STRUCTURAL COMPONENTS AS SPECIFICALLY STATED.


2. ALL CONSTRUCTION SHALL CONFORM TO THE LATEST REQUIREMENTS OF THE 2018 NO RESIDENTIAL CODE, PLUS ALL LOCAL CODES AND REGULATIONS. THE STRUCTURAL ENGINEER IS NOT RESPONSIBLE FOR, AND WILL NOT HAVE CONTROL OF, CONSTRUCTION MEANS, METHODS, TECHNIQUES, SEQUENCES OR PROCEDURES, OR FOR SAFETY PRECAUTIONS AND PROGRAMS IN CONNECTION WITH THE CONSTRUCTION WORK, NOR WILL THE ENGINEER BE RESPONSIBLE FOR THE CONTRACTOR'S FAILURE TO CARRY OUT THE CONSTRUCTION WORK IN ACCORDANCE WITH THE CONTRACT DOCUMENTS. "CONSTRUCTION REVIEW" SERVICES ARE NOT PART OF OUR CONTRACT. ALL MEMBERS SHALL BE FRAMED ANCHORED, TIED AND BRACED IN ACCORDANCE WITH GOOD CONSTRUCTION PRACTICE AND THE BUILDING CODE.


- 3. DESIGN LOADS (LISTED AS: LIVE LOAD, DEAD LOAD, DEFLECTION) ROOMS OTHER THAN SLEEPING ROOMS: (40 PSF, IO PSF, L/360)
- SLEEPING ROOMS: (30 PSF, 10 PSF, L/360) ATTIC WITH PERMANENT STAIR: (40 PSF, IO PSF, L/360)
- ATTIC WITHOUT PERMANENT STAIR: (20 PSF, IO PSF, L/360)
- ATTIC WITHOUT STORAGE: (IO PSF, IO PSF, L/240) STAIRS: (40 PSF, IO PSF, L/360)
- EXTERIOR BALCONIES: (60 PSF, IO PSF, L/360)
- DECKS: (40 PSF, IO PSF, L/360) GUARDRAILS AND HANDRAILS: (200 LBS)
- PASSSENGER VEHICLE GARAGES: (50 PSF, 10 PSF, L/360) FIRE ESCAPES: (40 PSF, I0 PSF, L/360)
- SNOW: (20 PSF)
- 4. WALLS SHALL BE BRACED BY SHEATHING WALLS ON ALL STORIES WITH WOOD STRUCTURAL PANELS. SEE FRAMING NOTES FOR THICKNESS AND NAILING REQUIREMENTS.
- 5. SEE APPENDIX M (DCA6) FOR EXTERIOR DECK REQUIREMENTS INCLUDING ATTACHMENTS FOR LATERAL LOADS.
- 6. CONCRETE SHALL HAVE A MINIMUM 28 DAY STRENGTH OF 3000 PSI AND A MAXIMUM SLUMP OF 5 INCHES UNLESS NOTED OTHERWISE (UNO). AIR ENTRAINED PER TABLE 402.2. ALL CONCRETE SHALL BE PROPORTIONED, MIXED, HANDLED, SAMPLED, TESTED, AND PLACED IN ACCORDANCE WITH ACI STANDARDS. ALL SAMPLES FOR PUMPING SHALL BE TAKEN FROM THE EXIT END OF THE PUMP. CONTROL JOINTS IN SLABS SHALL BE SPACED ON A GRID OF +-30 TIMES THE DEPTH (D). CONTROL JOINTS SHALL BE SAWCUT TO A DEPTH OF I/D. (I.E. 4" CONCRETE SLABS SHALL HAVE ¼" DEEP CONTROL JOINTS SAWCUT IN SLAB ON A +-IO'-O" x +-IO'-O" GRID).
- 7. ALLOWABLE SOIL BEARING PRESSURE ASSUMED TO BE 2000 PSF. THE CONTRACTOR MUST CONTACT A GEOTECHNICAL ENGINEER AND THE STRUCTURAL ENGINEER IF UNSATISFACTORY SUBSURFACE CONDITIONS ARE ENCOUNTERED. THE SURFACE AREA ADJACENT TO THE FOUNDATION WALL SHALL BE PROVIDED WITH ADEQUATE DRAINAGE, AND SHALL BE GRADED SO AS TO DRAIN SURFACE WATER AWAY FROM FOUNDATION WALLS.
- 8. ALL FRAMING LUMBER SHALL BE SPF #2 (Fb = 875 PSI) UNLESS NOTED OTHERWISE (UNO). ALL TREATED LUMBER SHALL BE SYP # 2. PLATE MATERIAL MAY BE SPF # 3 OR SYP #3 (Fc(perp) = 425 PSI - MIN).
- 9. L.V.L. SHALL BE LAMINATED VENEER LUMBER: Fb=2600 PSI, Fv=285 PSI, E=1.9xI0 PSI. 9.I. P.S.L. SHALL BE PARALLEL STRAND LUMBER: Fb=2900 PSI, Fv=290 PSI, E=2.0x10 PSI. 9.2. L.S.L. SHALL BE LAMINATED STRAND LUMBER: Fb=2250 PSI, Fv=400 PSI, E=I.55xI0 PSI. INSTALL ALL CONNECTIONS PER MANUFACTURERS INSTRUCTIONS.
- IO. ALL ROOF TRUSS AND I-JOIST LAYOUTS SHALL BE PREPARED IN ACCORDANCE WITH THE SEALED STRUCTURAL DRAWINGS, TRUSSES AND I-JOISTS SHALL BE INSTALLED ACCORDING TO THE MANUFACTURE'S SPECIFICATIONS. ANY CHANGE IN TRUSS OR I-JOIST LAYOUT SHALL BE COORDINATED WITH SOUTHERN ENGINEERS.
- II. ALL STRUCTURAL STEEL SHALL BE ASTM A-36. STEEL BEAMS SHALL BE SUPPORTED AT EACH END WITH A MINIMUM BEARING LENGTH OF 3 I/2" INCHES AND FULL FLANGE WIDTH. PROVIDE SOLID BEARING FROM BEAM SUPPORT TO FOUNDATION. BEAMS SHALL BE ATTACHED TO EACH SUPPORT WITH TWO LAG SCREWS (1/2" DIAMETER x 4" LONG). LATERAL SUPPORT IS CONSIDERED ADEQUATE PROVIDING THE JOIST ARE TOE NAILED TO THE SOLE PLATE, AND SOLE PLATE IS NAILED OR BOLTED TO THE BEAM FLANGE @ 48" O.C. ALL STEEL TUBING SHALL BE ASTM A500.
- 12. REBAR SHALL BE DEFORMED STEEL, ASTM615, GRADE 60. LAP ALL REBAR SPLICES 30 BAR DIAMETERS.
- 13. FLITCH BEAMS SHALL BE BOLTED TOGETHER USING (2) ROWS OF 1/2" DIAMETER BOLTS (ASTM A325) WITH WASHERS PLACED UNDER THE THREADED END OF BOLT. BOLTS SHALL BE SPACED AT 24" O.C. (MAX), AND STAGGERED AT THE TOP AND BOTTOM OF BEAM (2" EDGE DISTANCE), WITH 2 BOLTS LOCATED AT 6" FROM EACH END.
- 14. BRICK LINTELS (WHEN REQUIRED) SHALL BE 3 1/2"x3 1/2"x1/4" STEEL ANGLE FOR UP TO 6'-0" SPAN AND 6"x4"x5/16" STEEL ANGLE WITH 6" LEG VERTICAL FOR SPANS UP TO 9'-0". SEE PLANS FOR SPANS OVER 9'-O". SEE ALSO SECTION R703.8.3 LINTELS.

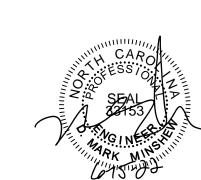


STRUCTURAL DESIGN BY: SOUTHERN ENGINEERS, P.A. 3716 BENSON DRIVE RALEIGH, NC 27609 LICENSE: C-4772, PHONE: 919-878-1617 PROJECT #: 22-1573

- Engineers seal applies only to structural components on this document. Seal does not include construction means, methods, techniques, sequences, procedures
- or safety precautions. Any deviations or discrepancies on plans are to be brought to the immediate attention of Southern Engineers. Failure to do so will void Southern Enqineer's liability.
- Seal is valid for a project permitted within one year from date of seal.
- Use of these plans constitutes approval of terms and conditions as defined in the customer agreement.

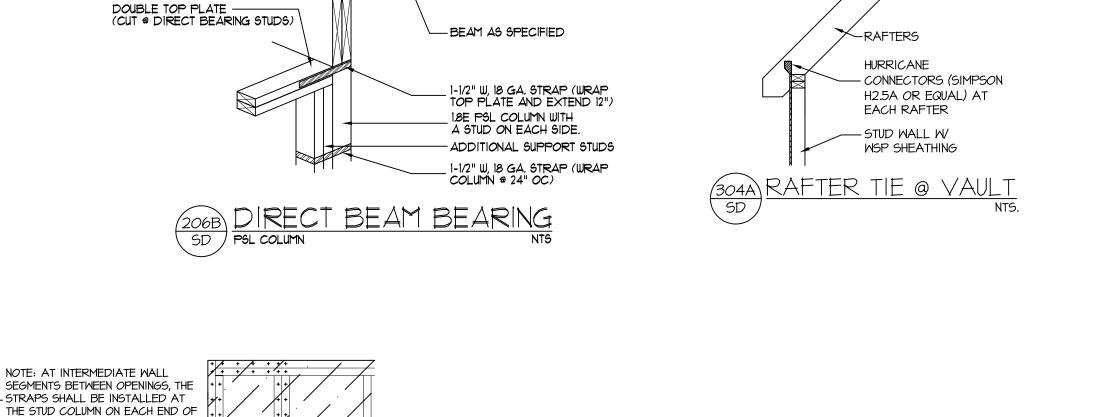

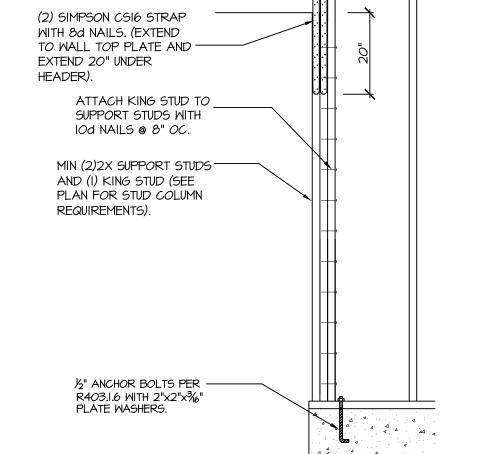

CS-PF: END CONDITION DETAIL (FOR USE WITH SINGLE CS-PF CONDITION) DETAIL AND APPLICATION BASED ON NORC FIGURE R602.10.1 - PORTAL FRAME CONSTRUCTION

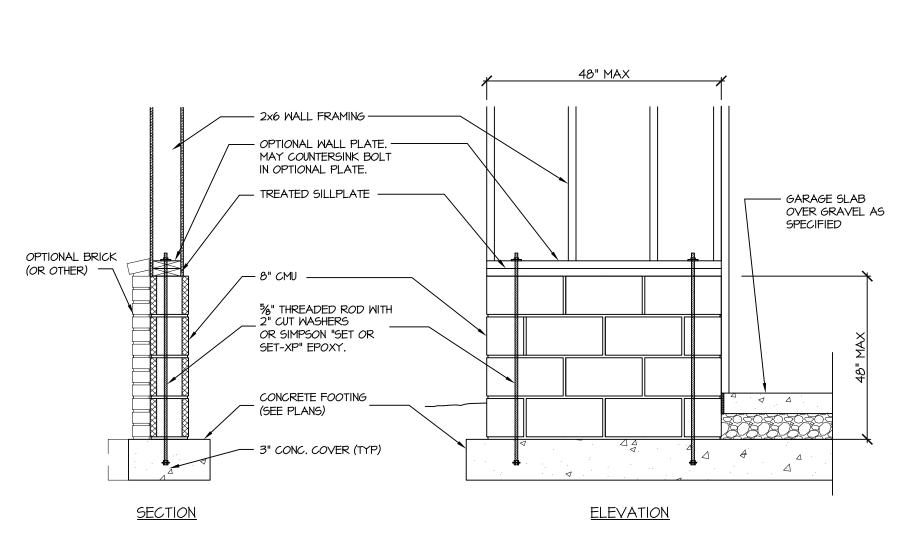

GARAGE 'WING WALL' REINFORCING PER IRC FIGURE R602.10.4.3



* 8d NAILS @ 3" OC TOP AND BOTTOM -EXTEND SHEATHING TO SILL PLATE (DO NOT SPLICE) MSP OVERLAP OPTION

EXTERIOR VIEW

MIN 1/6" THICK WOOD

- TREATED SILLPLATE

STRUCTURAL PANEL

SHEATHING

CS-PF - OVER WOOD FLOOR

THE WALL SEGMENT.

MIN. 3"xII.25" HEADER, SEE PLAN

FASTEN SHEATHING TO HEADER W/8d COMMON NAILS IN 3" GRID

PATTERN AND 3" O.C. IN ALL

PANEL EDGES SHALL BE

(3) 16d SINKERS.

CURB HEIGHT (MAX): 6"

- OPTIONAL CURB:

CURB WIDTH: 8"

INTERIOR VIEW

FRAMING ANCHOR OPTION

SIMPSON LTP4 FRAMING

ANCHOR

FRAMING (STUDS, BLOCKING, AND

BLOCKED AND OCCUR WITHIN 24"

ATTACH BLOCKING TOGETHER W

FOOTING / FOUNDATION (SEE

OF MID-HEIGHT. ONE ROW OF -

TYP. SHEATHING-TO-FRAMING NAILING IS REQ'D (3" OC).

FOR ACTUAL SIZE. EXTEND

OVER PANEL.

CS-PF: CONTINUOUS PORTAL FRAME CONSTRUCTION DETAIL AND APPLICATION BASED ON NCRC FIGURE R602.IO.I - PORTAL FRAME CONSTRUCTION

© COPYRIGHT 2022 MURPHY GARNOW DESIGN GROUP, INC. ALL RIGHTS RESERVED

DRAWN BY: **TWG**

FILE NAME: HH-2-2604

6-15-22 TWG LOT

12-14-20 TWG PLAN

7-7-21 TWG PLAN

12-22-21 TWG REY.

ALL DIMENSIONS, SITE

CONDITIONS & CODES ARE TO

BE VERIFIED BEFORE CONSTR.

BEGINS, ONCE CONSTR. HAS

BEGUN MURPHY GARNOW

DESIGN GROUP, INC. WILL NOT

ASSUME ANY LIABILITY FOR

ANY EXPENSES ASSOCIATED

WITH ERRORS & OMMISIONS.

 $\frac{\mathbb{X}}{\mathbb{X}}$

aroup,

GARNOW

MURPHY

HOUSE NAME:

HOUSE NUMBER: