House Plan Zone, LLC.

Designing Homes
HOUSE PLAN ZONE
Building Relationships

DIAMETER

ELEVATION

ENGINEER

FIRE CODE

FOUNDATION

GALVANIZED

GYPSUM

HORIZONTA

INCLUD

FREEZER

FINISH

OUND. FOUNDATION

FINISHED FLOOR LINE

HEATING, VENTILATION &

AIR CONDITIONING

DOUBLE

DISHMASHER

DOUGLAS FIR

STANDARD ABBREVIATIONS

NOT IN CONTRAC

REFRIGERATOR

RETURN AIR GRILLE

SIMPSON STRONG TIE

SOUTHERN PINE

SQUARE FOOTAGE

TO BE DETERMINED

REINFORCED

RESISTANCE RETURN AIR

SHOWER

SHOWER

PECS. SPECIFICATIONS

THICKNESS

TRANSOM

U.T.C. UNDER THE COUNTER

MATER HEATER

CONSTRUCTION MANUAL

TYPICAL

UTILITY

VAN. VANITY
VERT. VERTICAL

MASHER

MIN. MINDOM
M.M. MIRE MESH
M/ MITH
MD. MOOD
MFCM MOOD FRAME

MEIGHT

REQ'D REQUIRED

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Fax: 1-800-574-1387



SHEET INDEX:

- COVER SHEET
- 2 FOUNDATION PLAN
- 3 FLOOR PLANS
- 4 EXTERIOR VIEWS
- EXTERIOR VIEWS
- 6 SECTIONS & CABINETS
- 7 ROOF PLAN
- 8 ELECTRICAL PLANS

CODE DISCLAIMER:

1. THESE PLANS WERE DESIGNED TO MEET IRC 2015 AT THE TIME OF THEIR CREATION AND MORE SPECIFICALLY THE MINIMAL LOCAL CODES OF THE SOUTH MISSISSIPPI AREA. IT IS HIGHLY RECOMMENDED THAT THESE PLANS BE REVIEWED BY A LOCAL STRUCTURAL ENGINEER PRIOR TO CONSTRUCTION.

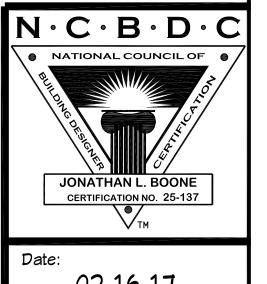
2. BEAMS AND FLOOR JOISTS ARE NOT SIZED DUE TO THE MANY GEOGRAPHIC LOCATIONS THESE PLANS ARE SOLD. THESE ITEMS SHALL BE SIZED BY A LOCAL ENGINEER OR MANUFACTURER.

3. ALL CEILING & FLOOR JOISTS (IF CONVENTIONAL FRAMING) SHOULD BE SIZED USING THE LATEST VERSION

OF THE IRC OR APPLICABLE CODES AT SITE TO MEET THE LOCAL REQUIREMENTS SUCH AS SNOW LOADS AND OTHER FACTORS. THE CEILING JOISTS SIZES LABELED (IF PRESENT) WERE SIZED USING THE 2015 IRC AT THE TIME OF THEIR CREATION. THEY MUST BE VERIFIED AND MODIFIED AS REQUIRED TO MEET THE LATEST EDITION OF THE (IRC) INTERNATIONAL RESIDENTIAL CODE.

4. ALL FOUNDATIONS AND FOOTING DETAILS SHALL BE REVIEWED AND APPROVED BY A LOCAL ENGINEER.
5. CONTRACTOR SHALL PROVIDE ALL HIGH WIND STRAPPING AND ANCHOR BOLTS AS REQUIRED BY THE LOCAL CODE REQUIREMENTS AND THE LATEST VERSION OF THE IRC.

BB-2011

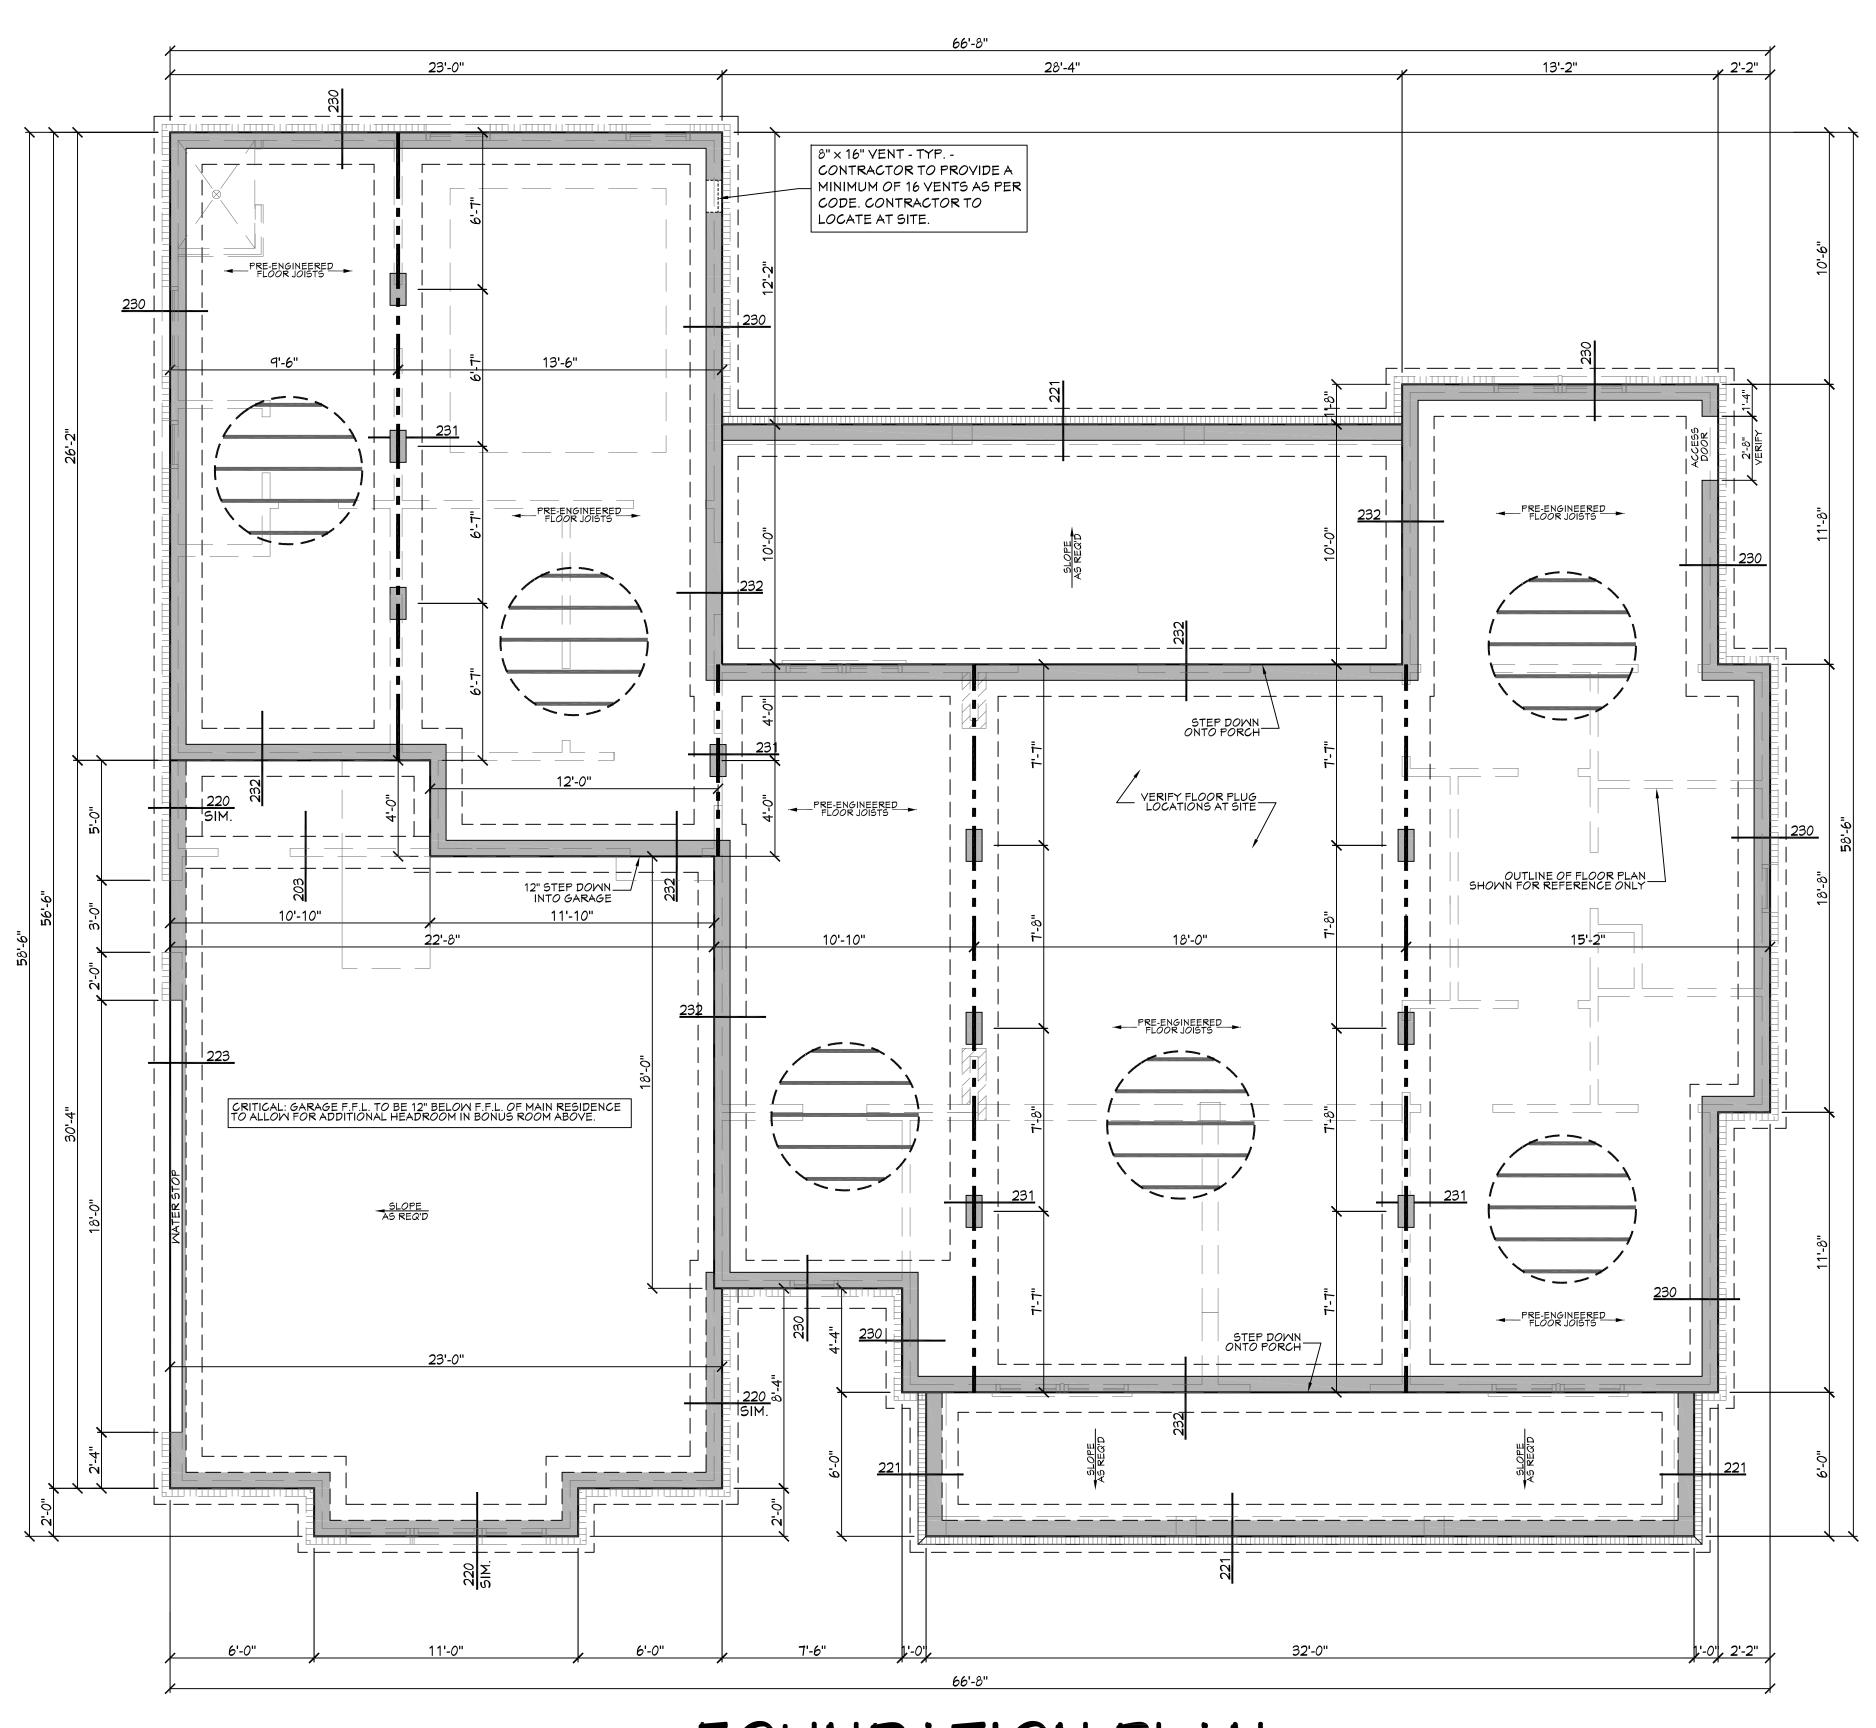


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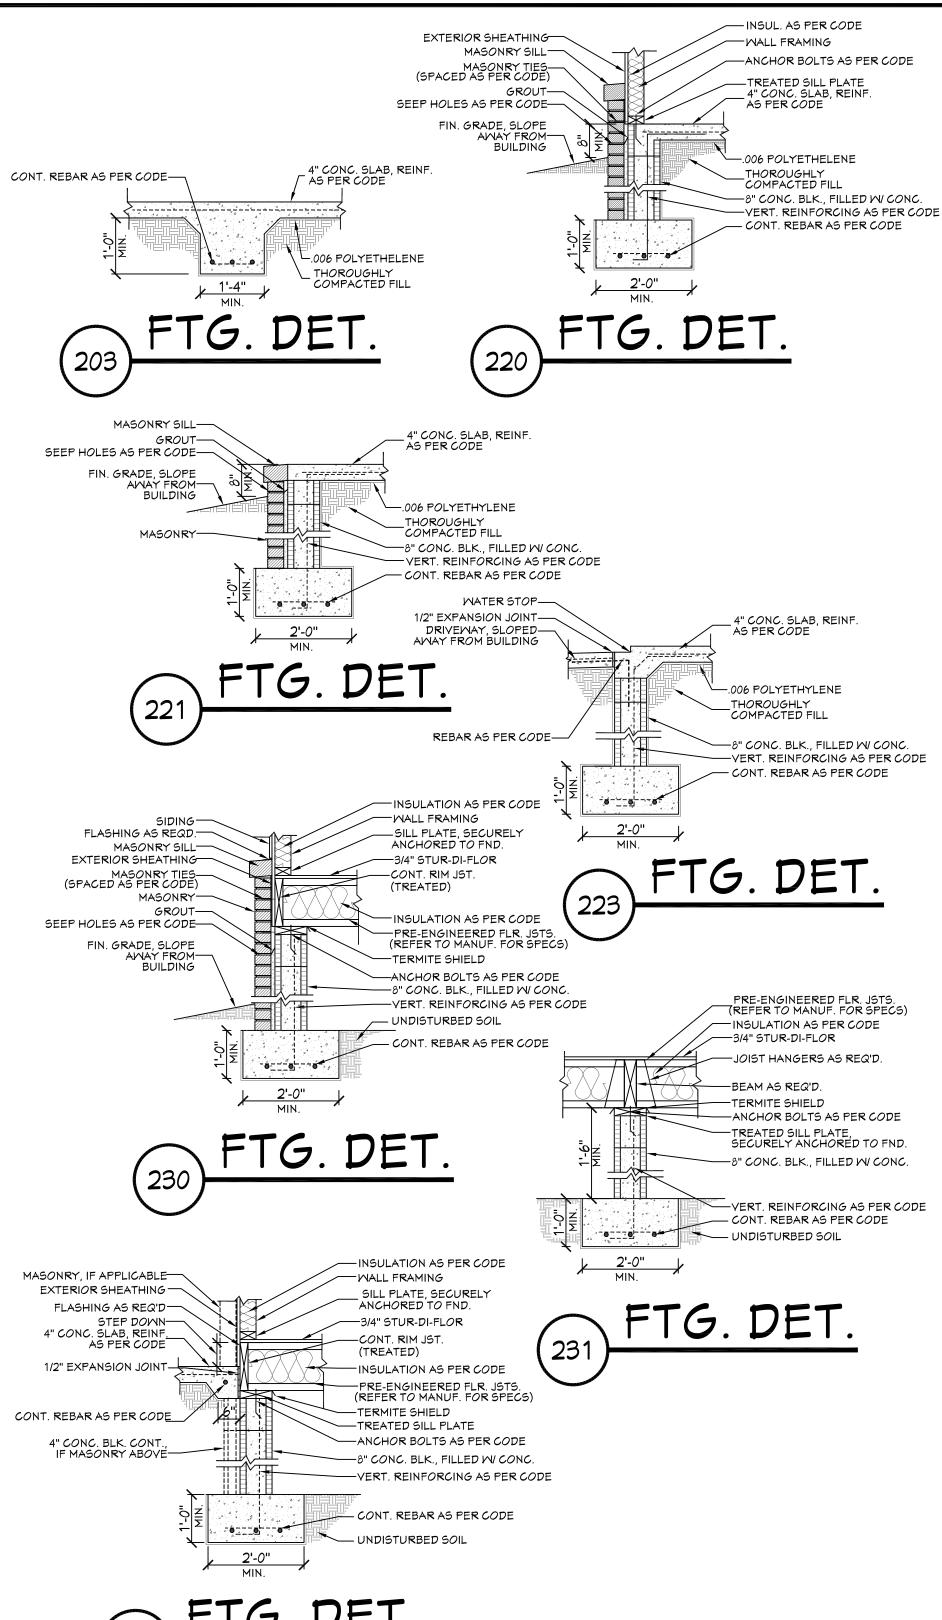
J.A.B.



FOUNDATION PLAN

SCALE------1/4" = 1'-0"

NOTE: PRE-ENGINEERED FLOOR JOISTS ARE SHOWN. REFER TO FLOOR JOIST MANUFACTURER FOR JOIST SIZING, SPACING, CROSS BRACING REQUIREMENTS, AND BEAM SIZES.



FTG. DET.

CRAMLSPACE FOUNDATION NOTES:

- 1. ALL FOOTING SIZES AND LOCATIONS TO BE VERIFIED BY A LICENSED STRUCTURAL ENGINEER.
- 2. CONTRACTOR TO ADAPT PLANS AS REQUIRED TO MEET ALL APPLICABLE CODES AT SITE.
- 3. CONTRACTOR SHALL VERIFY ALL DIMENSIONS WITH FLOOR PLAN PRIOR TO CONSTRUCTION AND MAKE ANY NECESSARY ADJUSTMENTS.
- 4. CONTRACTOR TO PROVIDE WATERPROOFING AS REQ'D
 TO MEET ALL APPLICABLE CODES AND TYPICAL BUILDING PRACTICES.
- 5. CONCRETE SLABS TO BE 4" (3000 psi MIN.), REINFORCED AS PER CODE OR AS DETERMINED BY LICENSED ENGINEER.
- 6. CONTRACTOR TO PROVIDE ADEQUATE DRAINAGE BASED ON EXISTING SITE CONDITIONS. VERIFY w/LOCAL CODES.
- 7. REFER TO FLOOR JOIST MANUFACTURER FOR JOIST SIZING AND SPACING, CROSS BRACING REQUIREMENTS, AND BEAM SIZES.
- 8. VERIFY THE QUANTITY AND LOCATION OF BRICK VENTS WITH ALL APPLICABLE CODES AT SITE.

HOUSE PLAN ZONE

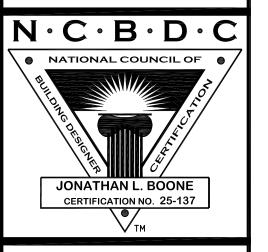
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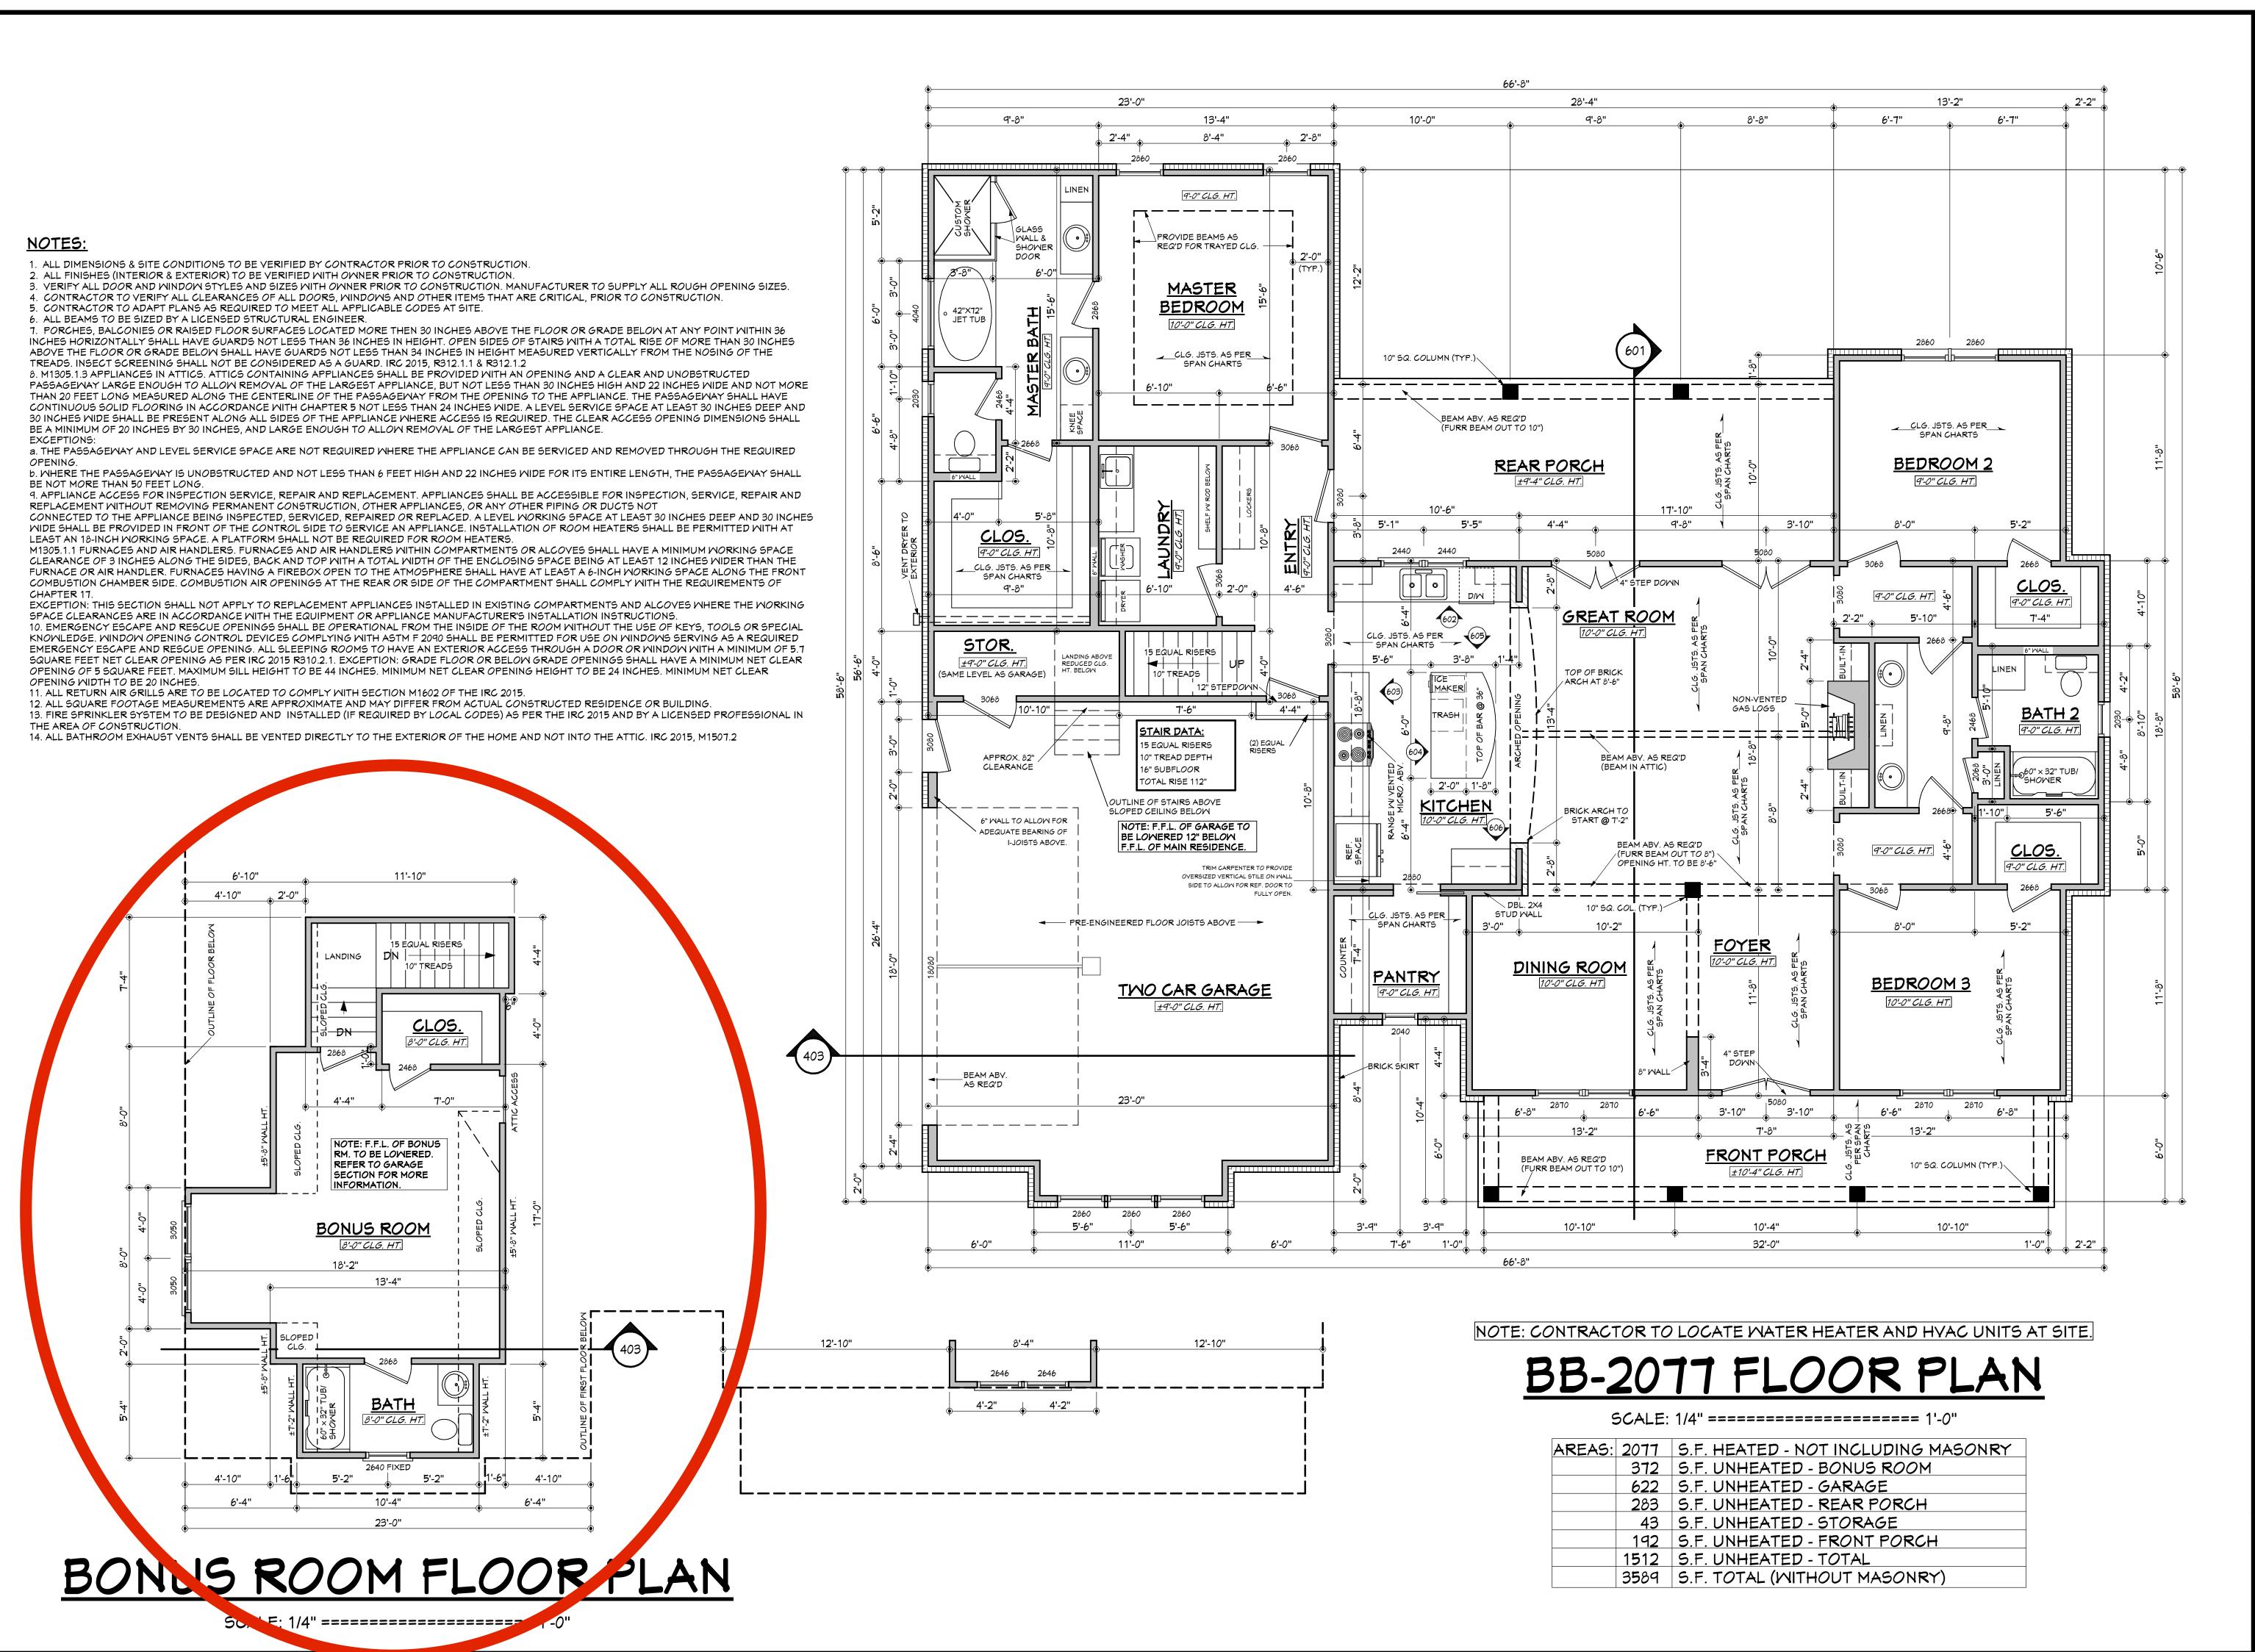


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HOUSE PLAN ZONE

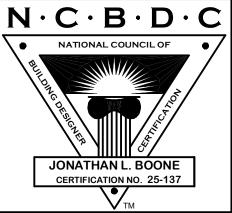
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pletion of these construction Zone, LLC. assumes no in the design. In the area of construction, mply to seismic, wind and ruction. If a foundation plan

st care and effort in the development of these plans and the completion iance in building codes and site specific conditions, House Plan Zone, including codes and site specific conditions, House Plan Zone, including the security of the second site specific conditions, House Plan Zone, in the second site specific conditions, House Plan Zone, in the second site specific conditions or deficiencies in the second sec

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Plan Zone, LLC. has exercised great care and effort in tents. However, due to the great variance in building coosibility for any damages, including structural failures res Plan Zone, LLC. highly recommends that these plans bion to your local building officials prior to construction. A pecial conditions required by local building codes. All dil

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Project Name:

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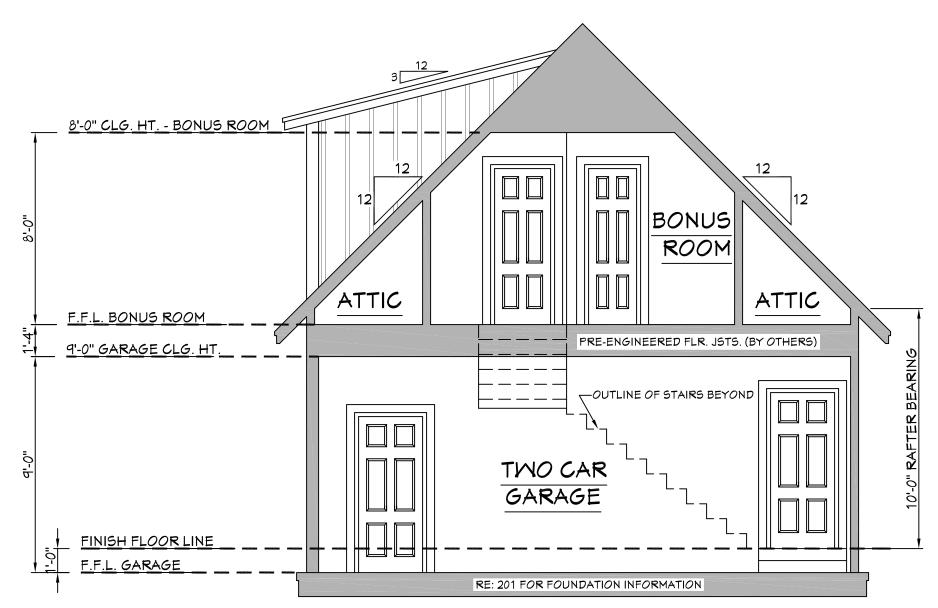
REAR VIEW

SCALE------ 1/4" = 1'-0"

EXTERIOR ELEVATION NOTES:

1. CONTRACTOR TO VERIFY ALL WINDOW AND DOOR STYLES AND SIZES WITH OWNER PRIOR TO CONSTRUCTION.

- 2. PROVIDE STEPS AND GUARD RAILS AS PER CODE BASED ON SITE CONDITIONS.
- 3. GROUND LINES SHOWN FOR REFERENCE ONLY AND VARY DEPENDING ON SITE CONDITIONS.
- 4. ALL FINISH MATERIALS TO BE VERIFIED WITH OWNER PRIOR TO CONSTRUCTION.
- 5. REFER TO TYPICAL WALL DETAIL FOR FRAMING METHODS AND OTHER MISC. INFORMATION.
- 6. CONTRACTOR TO PROVIDE ADEQUATE ROOF VENTILATION AS REQ'D BY CURRENT CODES.





HOUSE PLAN ZONE

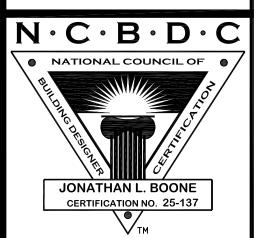
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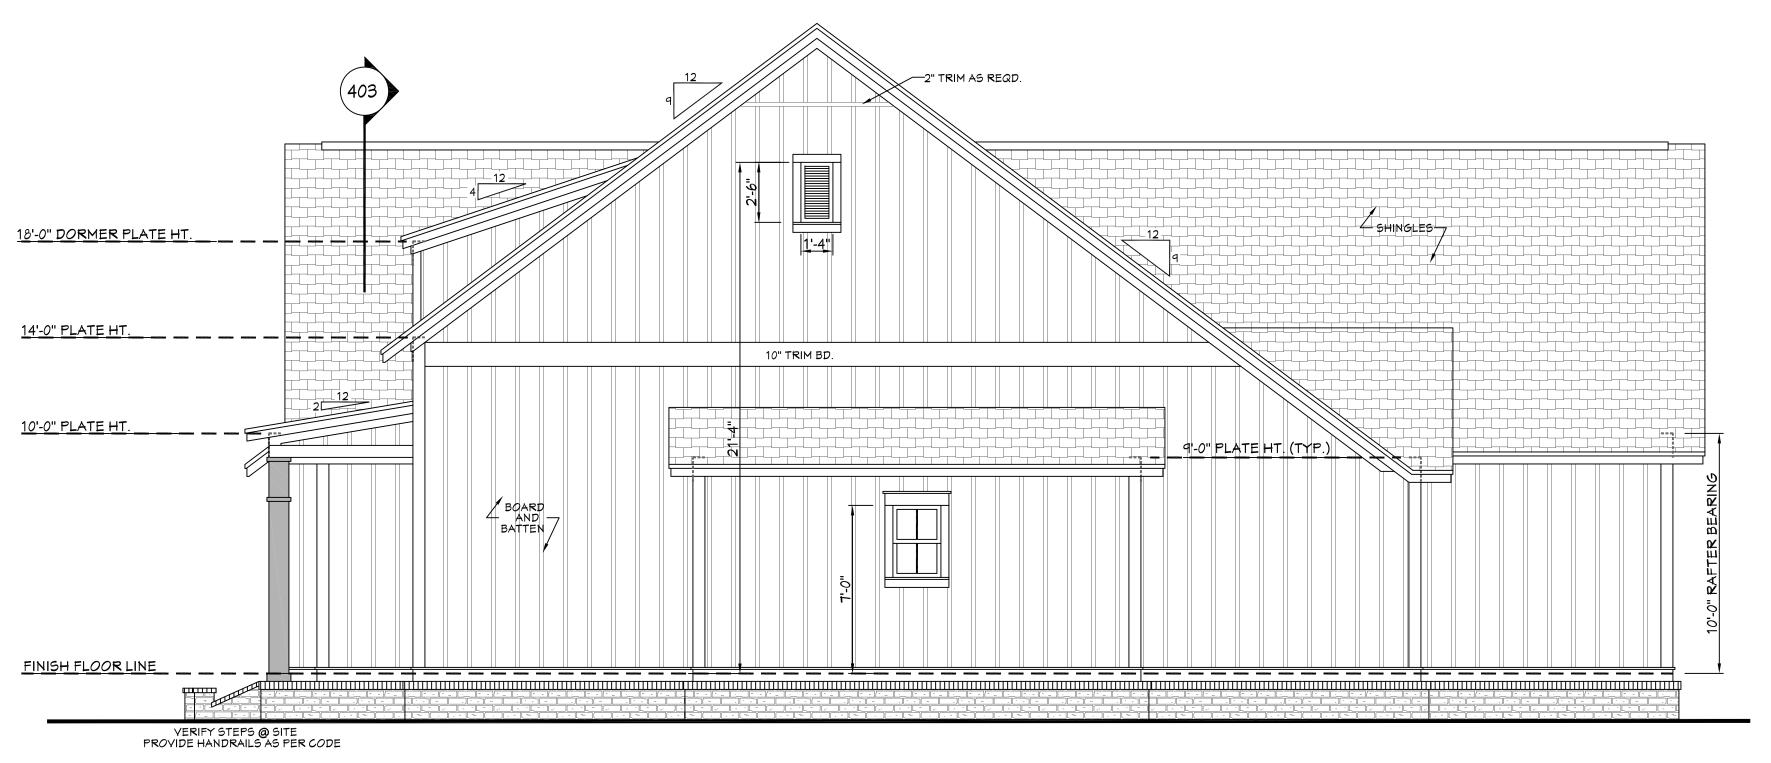
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EXTERIOR ELEVATION NOTES:

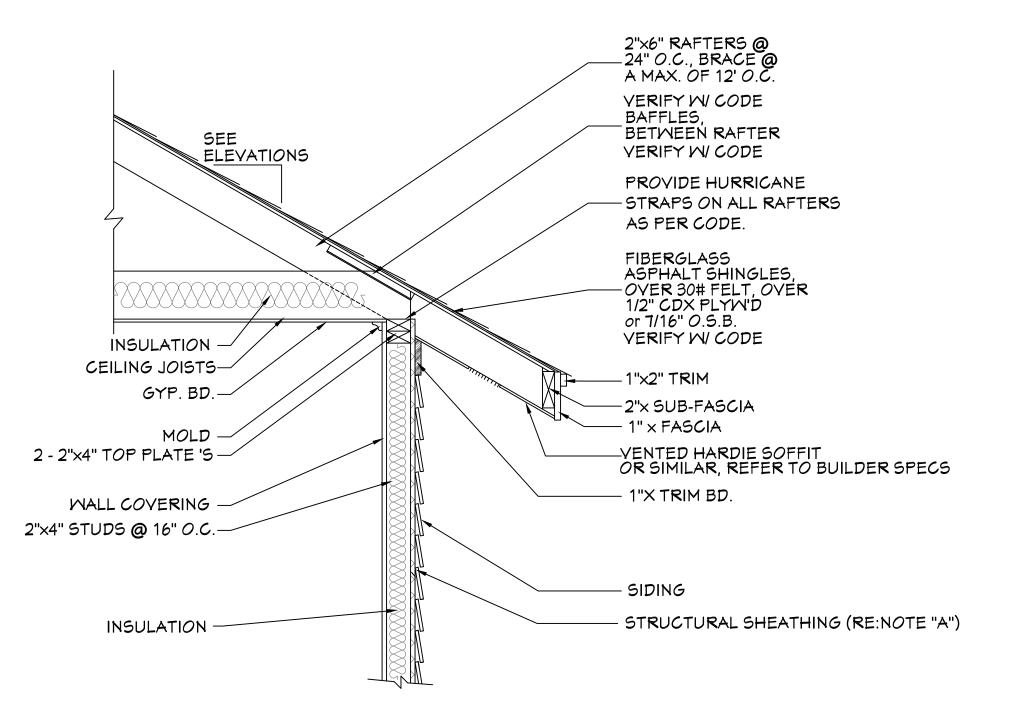
- 1. CONTRACTOR TO VERIFY ALL WINDOW AND DOOR STYLES AND SIZES WITH OWNER PRIOR TO CONSTRUCTION.
- SITE CONDITIONS.

 3. GROUND LINES SHOWN FOR REFERENCE ONLY AND VARY

2. PROVIDE STEPS AND GUARD RAILS AS PER CODE BASED ON

- DEPENDING ON SITE CONDITIONS.
- 4. ALL FINISH MATERIALS TO BE VERIFIED WITH OWNER PRIOR TO CONSTRUCTION.
 5. REFER TO TYPICAL WALL DETAIL FOR FRAMING METHODS
- AND OTHER MISC. INFORMATION.
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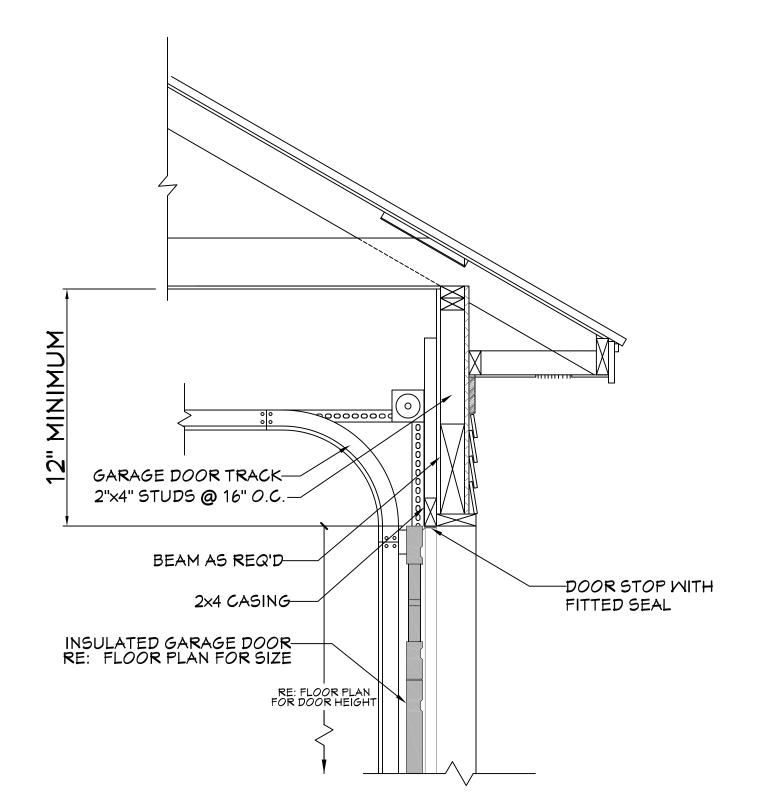




NOTE "A": PROVIDE A MINIMUM OF 7/16" STRUCTURAL WOOD PANEL ATTACHED w/ 8d COMMON OR 10d BOX NAILS AT 4" SPACING ON EDGE AND 12" IN FIFL D

NOTE "B": CORNICE DETAIL FOR REFERENCE ONLY. REFER TO BUILDER SPECS FOR ACTUAL MATERIALS.





GARAGE DOOR CLEARANCE

THE INTENT OF THIS DETAIL IS TO SHOW THE MINIMUM REQUIRED DISTANCE FROM THE TOP OF THE GARAGE DOOR OPENING TO THE CEILING OF THE GARAGE.

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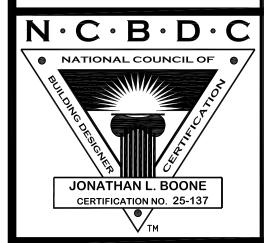
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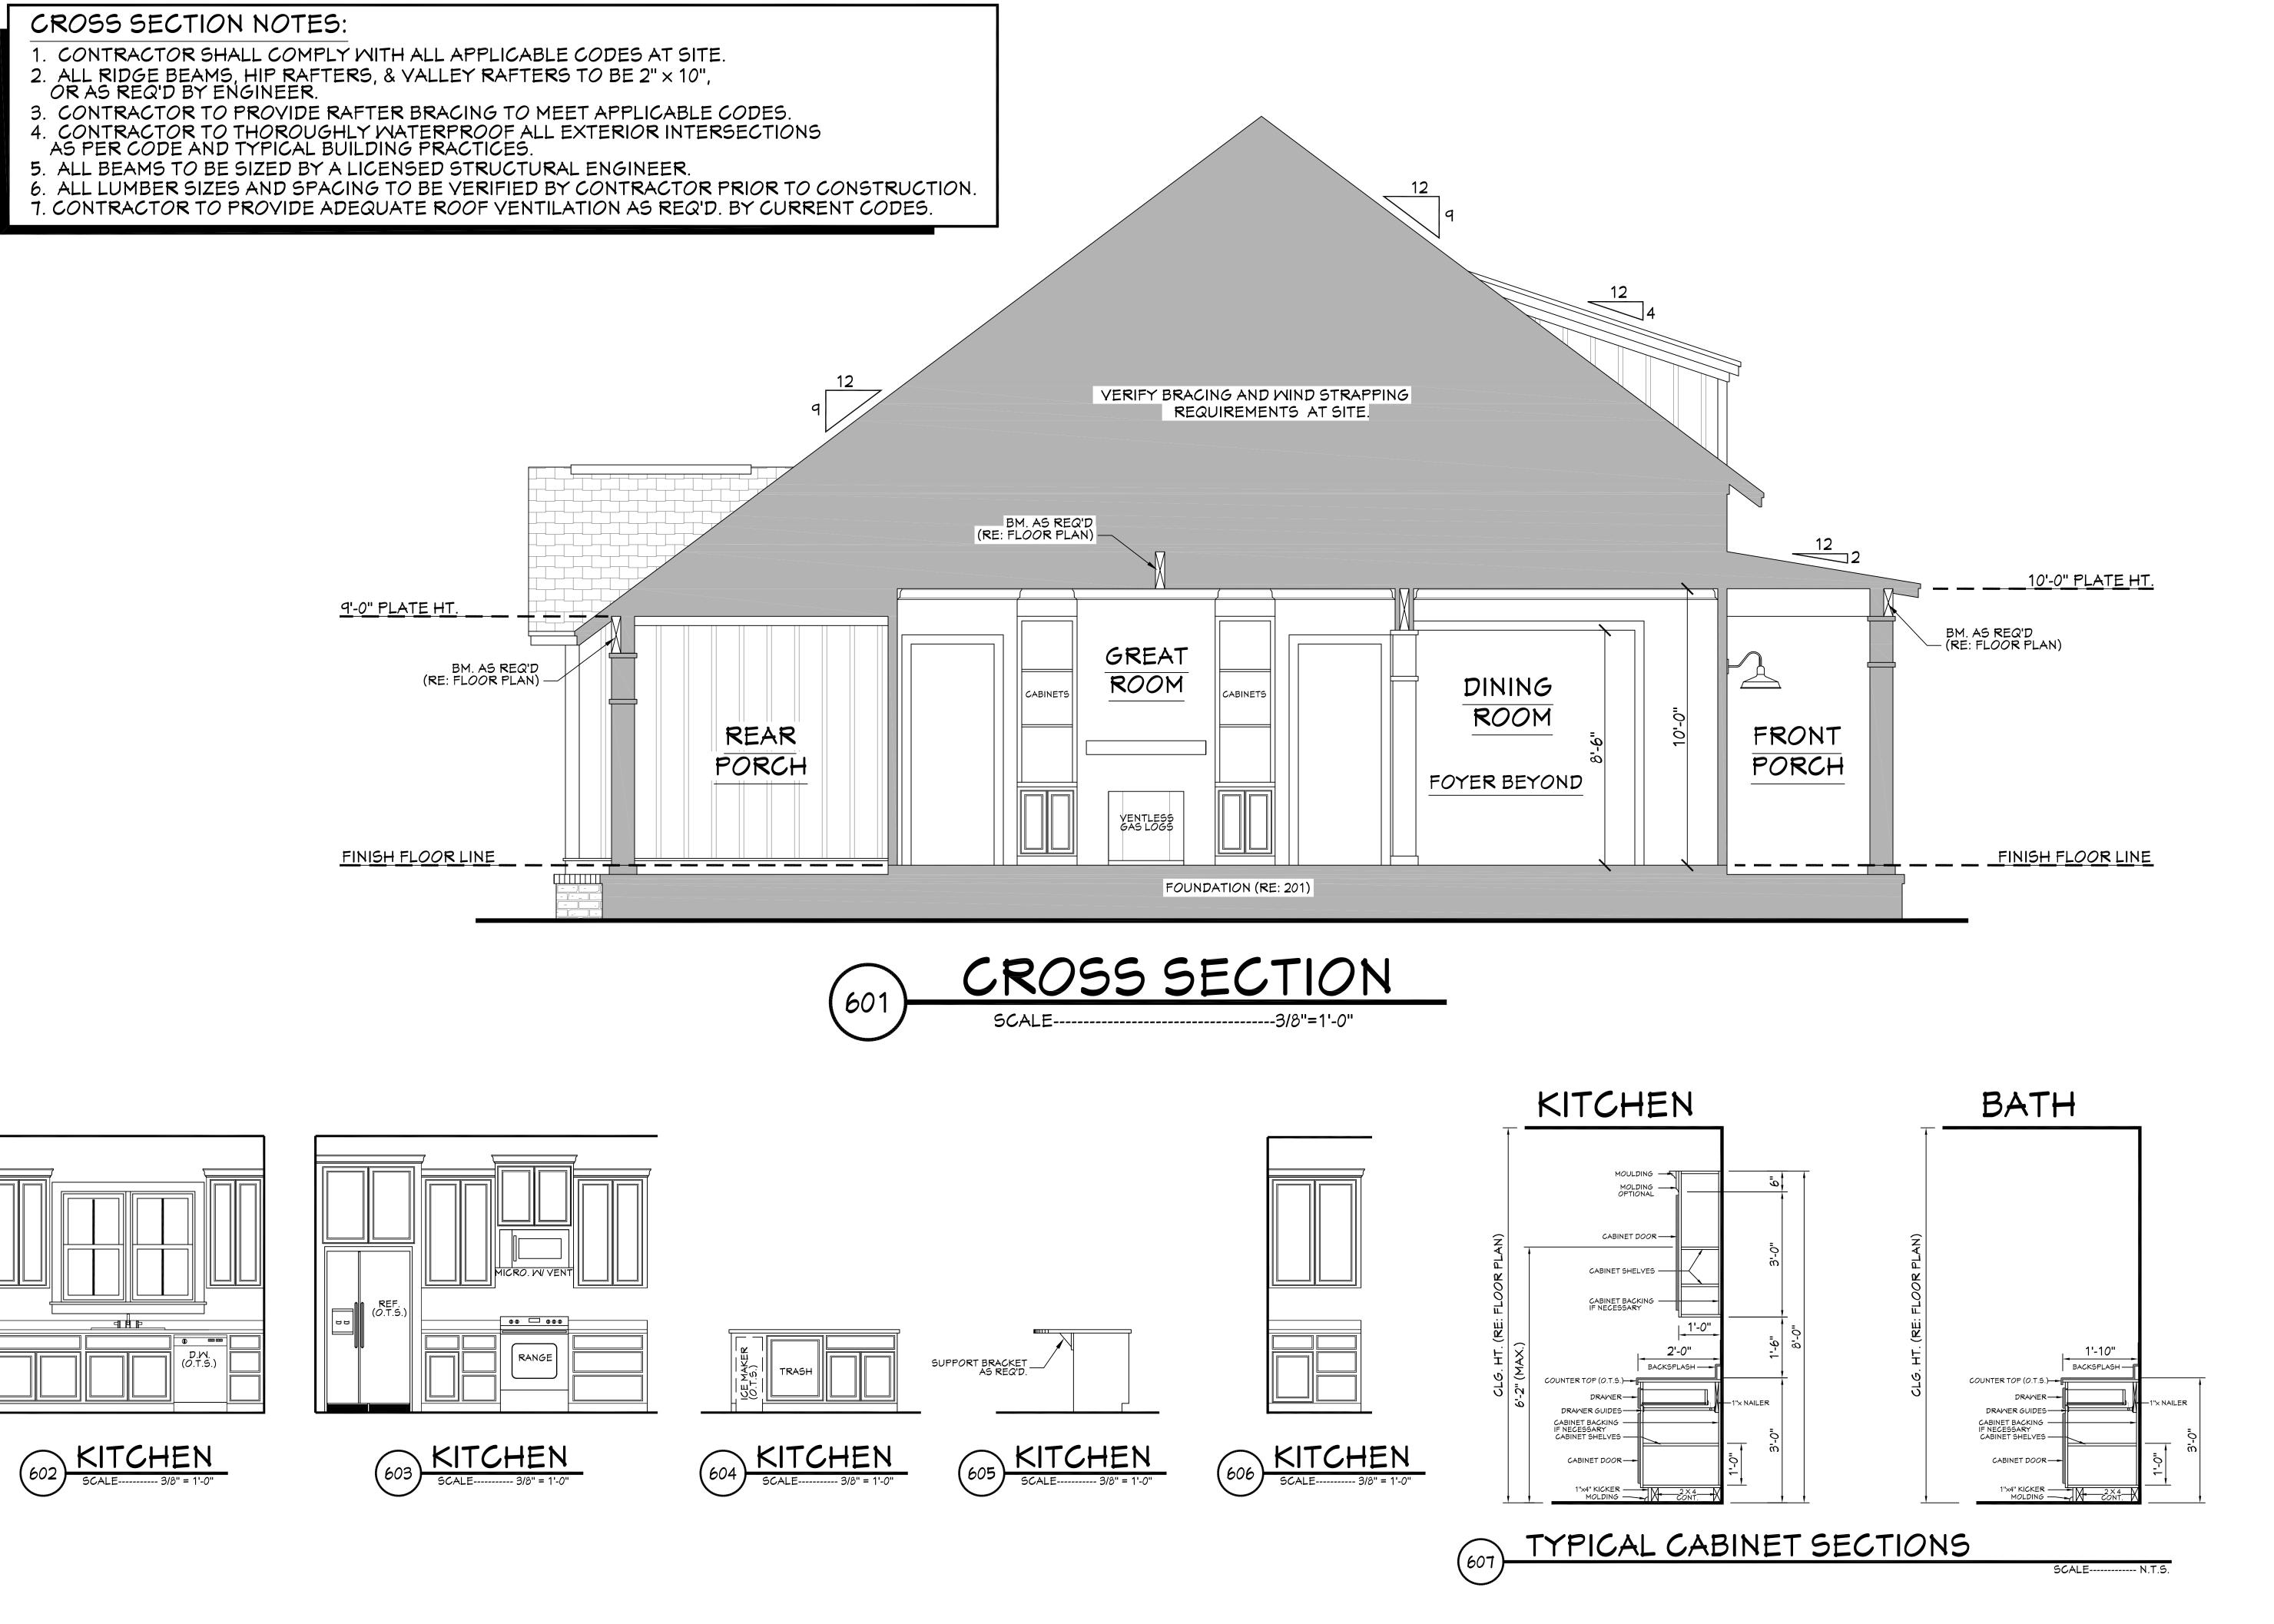
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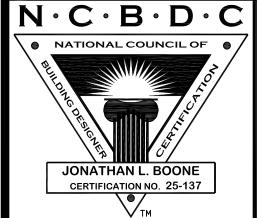
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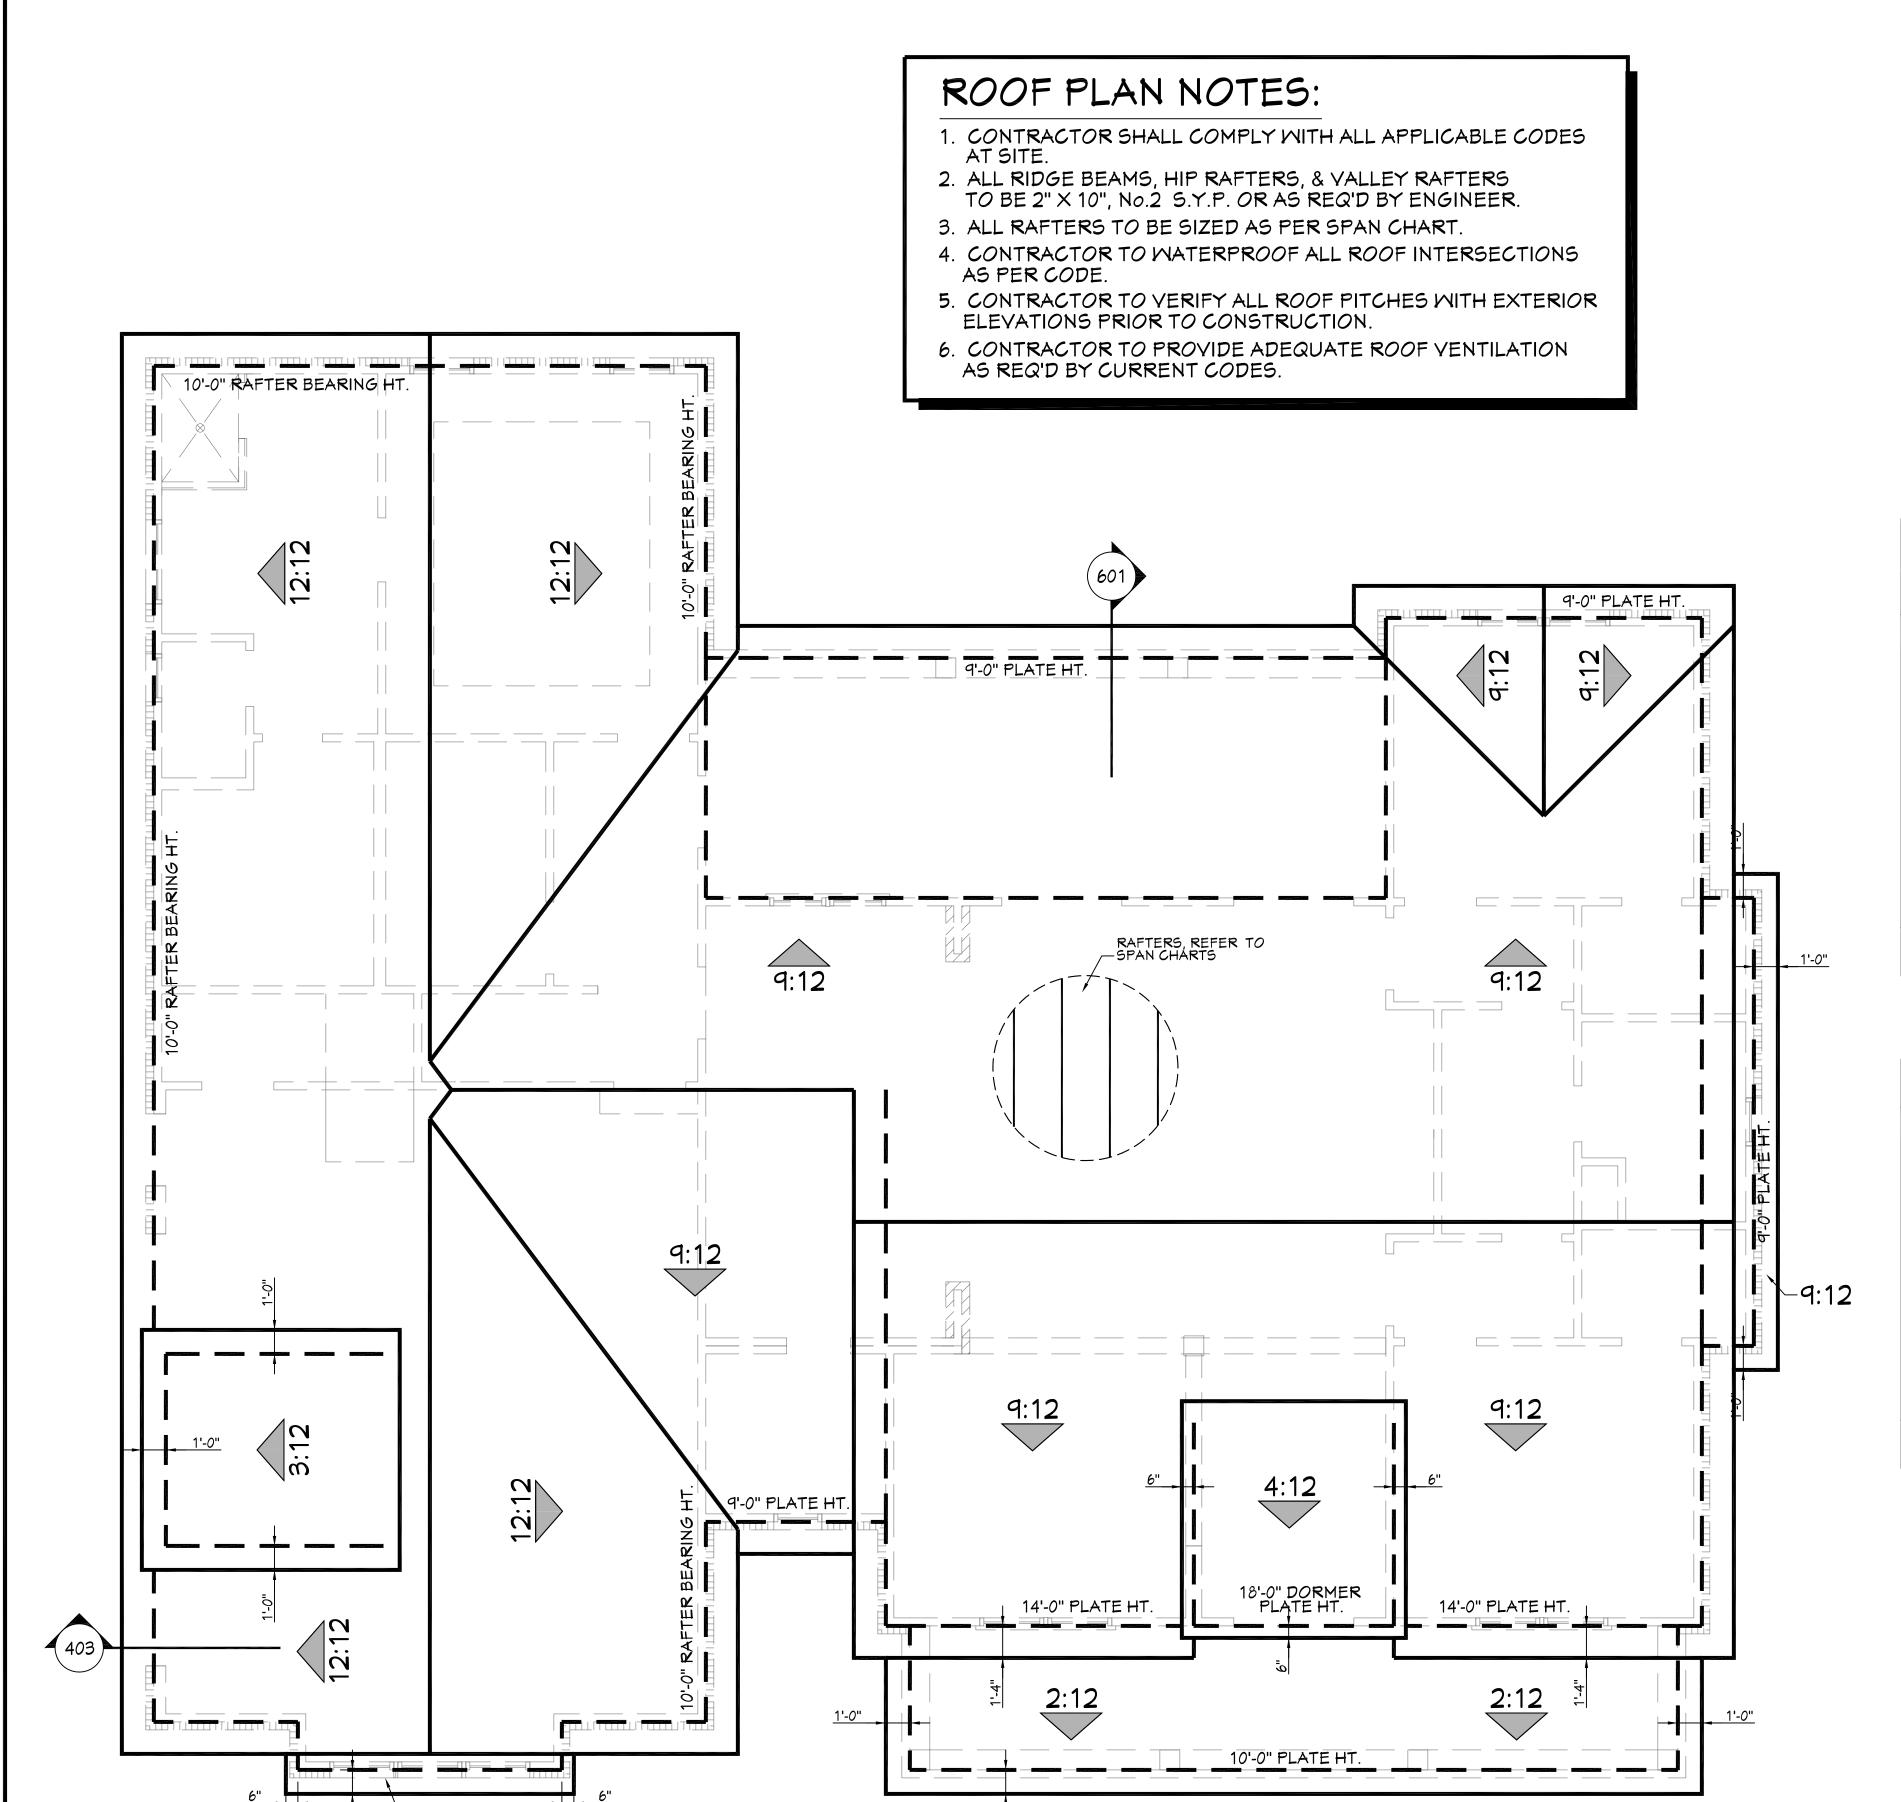
ese plans and the completion of these construction priditions, House Plan Zone, LLC. assumes no issions or deficiencies in the design.

Pre-Drawn Plan ID: BB-2011

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Drawn By: J.A.B.

SHEET NUMBER



HIP/ VALLEY COI			THEN HIP/ VALLEY RAFTER ROOF PITCH BECOMES			
RISE/ RUN	SLOPE		RISE/ RUN	SLOPE		
1/12	5°		1/17	3°		
2/12	10°	_	2/17	7°		
3/12	14°	_	3/17	10°		
4/12	18°		4/17	13°		
5/12	23°		5/17	16°		
6/12	27°		6/17	19°		
7/12	30°		7/17	22°		
8/12	34°		8/17	25°		
9/12	37°		9/17	28°		
10/12	40°		10/17	30°		
11/12	42°		11/17	33°		
12/12	45°		12/17	35°		
CONVERSION CHART FOR SIMPLE ROOFS ONLY. CHART DOES NOT APPLY FOR DUAL PITCH ROOFS.						

RAFTER LENGTH CHART				
ROOF PITCH		FACT <i>O</i> R		
3/12		1.05		
4/12		1.07		
5/12		1.10		
6/12		1.14		
7/12		1.17		
8/12		1.20		
9/12		1.25		
10/12		1.30		
11/12		1.35		
12/12		1.40		
14/12		1.54		
16/12		1.70		
	NTAL SPAN OF MEMBE PRIATE FACTOR BY RO			

RAFTER SPANS

RAFTER SPANS FOR SOUTHERN PINE SPECIES LIVE LOAD=30psf, L/\(\triangle = 180\) DEAD LOAD = 10psf

SIZE	SPACING (INCHES)	SPANS (MAXIMUM RAFTER SPANS BETWEEN BRACING) (FT IN.)
	12.0	12-11
×	16.0	11-2
ŝ	19.2	10-2
	24.0	9-2
	12.0	16-4
8	16.0	14-2
X	19.2	12-11
7	24.0	11-7
	12.0	19-5
× 10	16.0	16-10
X	19.2	15-4
7	24.0	13-9
7	12.0	22-10

NOTES

The above tables are based on the IRC 2015 TABLE R802.5.1(3)

19.2

24.0

19-10

18-1

16-2

CEILING JOIST SPANS

CEILING JOIST SPANS FOR SOUTHERN PINE SPECIES
(UNINHABITABLE ATTICS WITHOUT STORAGE, LIVE LOAD = 20psf, LA =240)
DEAD LOAD = 10psf

***IF HABITABLE ATTIC SPACE OR STORAGE IS DESIRED,
REFER TO THE INTERNATIONAL RESIDENTIAL CODE, SPAN TABLES.**

TO THE INTERNATIONAL RE	SIDENTIAL CODE, SPAN TABLES.***
SPACING (INCHES)	VISUALLY GRADED #2 SOUTHERN PINE (MAXIMUM CEILING JOIST SPANS) (FT IN.)
12.0	9-3
16.0	8-0
19.2	7-4
24.0	6-7
12.0	13-11
16.0	12-0
19.2	11-0
24.0	9-10
12.0	17-7
16.0	15-3
19.2	13-11
24.0	12-6
12.0	20-11
16.0	18-1
19.2	16-6
24.0	14-9
	SPACING (INCHES) 12.0 16.0 19.2 24.0 12.0 16.0 19.2 24.0 12.0 16.0 19.2 24.0 16.0 19.2 24.0 19.2

The above tables are based on the IRC 2015 TABLE R802.4(2)



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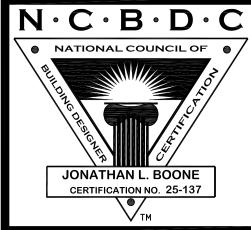
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Completion of these construction lan Zone, LLC. assumes no cies in the design.

THAN T : 2016, LLC. assumes no cies in the area of construction, occomply to seismic, wind and onstruction. If a foundation plan

ort in the development of these plans and the completed codes and site specific conditions, House Plan Zones resulting from errors, omissions or deficiencies in the

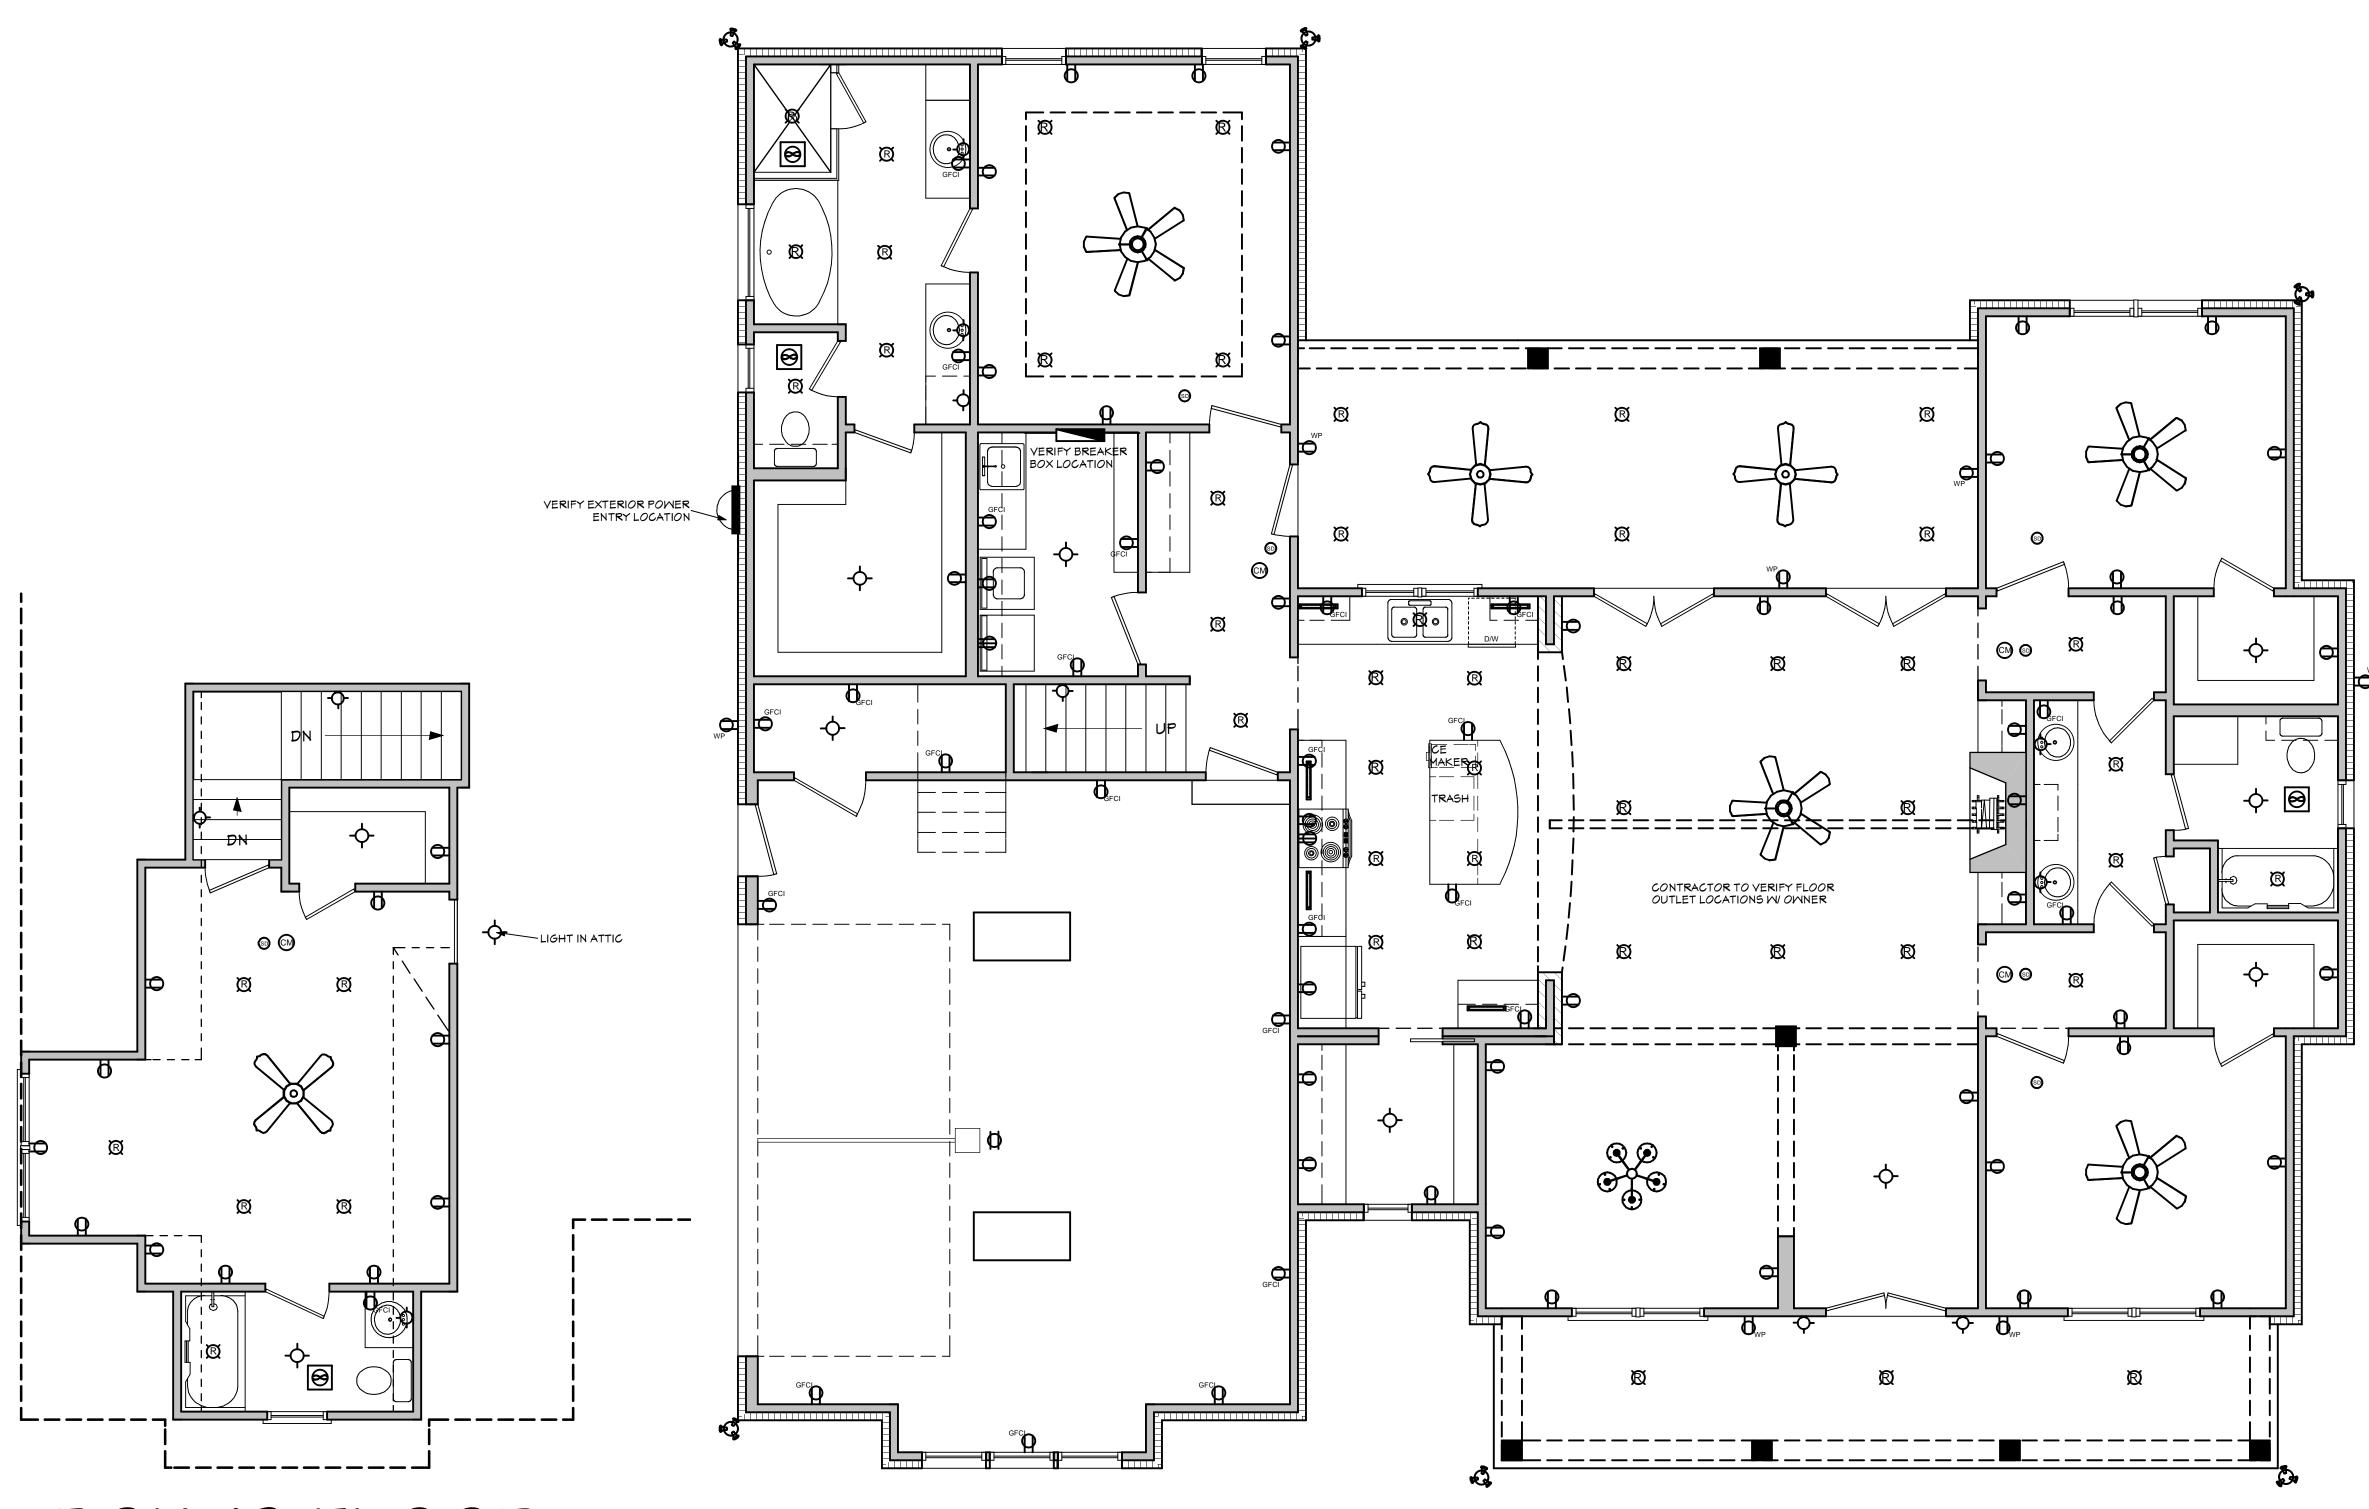
Plan Zone, LLC. has exercised great care and effort in the nts. However, due to the great variance in building code ibility for any damages, including structural failures resultan Zone, LLC. highly recommends that these plans be not by your local building officials prior to construction. Additional contraction, Additional contraction, Additional contraction, Additional contraction.

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SHEET NUMBER



BONUS FLOOR ELECTRICAL PLAN

SCALE: 1/4" ========== 1'-0"

BB-2077 ELECTRICAL PLAN

NOTE: SMITCHES AND ARCS NOT SHOWN. OWNER TO LOCATE THESE ITEMS DURING ELECTRICAL MALK-THROUGH MITH ELECTRICAL CONTRACTOR.

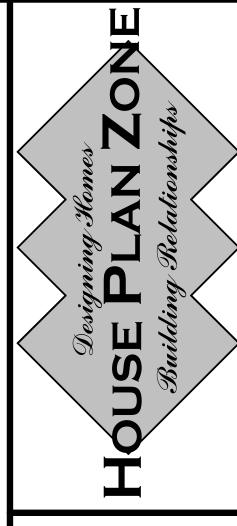
<u>E</u> I	ECTRICAL SYMBOLS LEGEND		
SYMB <i>O</i> L	DESCRIPTION		
	110 YOLT OUTLET		
GFCI	GROUND FAULT PROTECTED OUTLET	OUND FAULT PROTECTED OUTLET	
AM AM	WEATHERPROOF OUTLET		
\bigcirc	220 VOLT RECEPTACLE		
-	FLOOR OUTLET (OWNER TO LOCATE)	_	
-	CEILING HUNG FIXTURE	_	
D ₁	OVERHANG MOUNTED FLOODLIGHTS		
(4)	WALL MOUNTED FLOODLIGHTS		
	RECESSED CEILING FIXTURE	_	
	FLUORESCENT LIGHT	_	
СМ	CARBON MONOXIDE DETECTOR		
(SD)	SMOKE DETECTOR		
\$	SMITCH		
\S_3	THREE WAY SWITCH		
Q	MALL MOUNTED LIGHT		
€м	DIMMER SMITCH (OMNER TO LOCATE)		
. \$	DOOR ACTIVATED SMITCH		
WP	WEATHERPROOF OUTLET		
C5	CATS NETWORKING JACK (OWNER TO LOCAT	E)	
Z	TELEPHONE OUTLET (OWNER TO LOCATE)		
TV	TELEVISION OUTLET (OWNER TO LOCATE)		
	DOORBELL BUTTON (CONTRACTOR TO LOCATION TO	ΓE	
T	THERMOSTAT (CONTRACTOR TO LOCATE)		
8	CEILING EXHAUST FAN, VENT TO EXTERIOR		
	TV SPEAKER		
\otimes	RADIO SPEAKER		
	CEILING FAN ONLY, NO LIGHT KIT		
	CEILING FAN WITH LIGHT KIT		
*************************************	TRACK LIGHTING (OWNER TO LOCATE)		
•	WALL SCONCE (OWNER TO LOCATE)		
	CHANDELIER 1 (O.T.S.)		
	CHANDELIER 2 (O.T.S.)		
	UNDER COUNTER LIGHTING		
~	EMERGENCY LIGHTING/ EXIT SIGN	_	
AT SITE. 2. SMOKE A LOCATIONS	L NOTES: RK SHALL COMPLY WITH ALL CODES APPLICABL LARMS SHALL BE INSTALLED IN THE FOLLOWITH EACH SLEEPING ROOM, OUTSIDE EACH SLEEPING AREA IN THE IMMEDIATE VICINITY O	١	

THE BEDROOMS, ON EACH ADDITIONAL STORY OF THE DWELLING, INCLUDING BASEMENTS AND HABITABLE ATTICS. WHEN MORE THAN ONE SMOKE ALARM IS REQUIRED TO BE INSTALLED WITHIN A DWELLING THE ALARM DEVICES SHALL

INSTALLED WITHIN A DWELLING THE ALARM DEVICES SHALL BE INTERCONNECTED IS SUCH A MANNER THAT THE ACTUATION OF ONE ALARM WILL ACTIVATE ALL OF THE ALARMS IN THE UNIT. SMOKE ALARMS SHALL BE HARD WIRED WITH A BATTERY BACK UP.

3. CARBON MONOXIDE ALARMS SHALL BE INSTALLED OUTSIDE OF EACH SEPARATE SLEEPING AREA IN THE IMMEDIATE VICINITY OF THE BEDROOMS IN DWELLING UNITS WITHIN WHICH FUEL-FIRED APPLIANCES ARE INSTALLED AND IN DWELLING UNITS WITH ATTACHED GARAGES.

4. A 125 VOLT, SINGLE PHASE, 15-20 AMPERE RATED RECEPTACLE OUTLET SHALL BE INSTALLED AT AN ACCESSIBLE LOCATION FOR THE SERVICING OF HEATING. ACCESSIBLE LOCATION FOR THE SERVICING OF HEATING, AIR CONDITIONING AND REFRIGERATION EQUIPMENT. THE RECEPTACLE SHALL BE LOCATED ON THE SAME LEVEL AND WITHIN 25 FEET OF THE EQUIPMENT. THE RECEPTACLE OUTLET SHALL NOT BE CONNECTED TO THE LOAD SIDE OF THE HVAC EQUIPMENT DISCONNECTING MEANS.



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