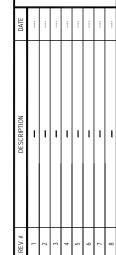
# **CYPRESS**

**ELEVATION D** 









- RH - CYPRESS - SINGLE FAMILY

0.0



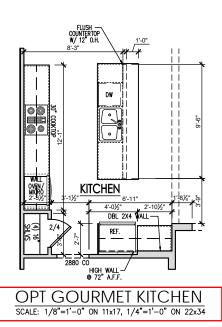
**INCLUDED OPTIONS:** 1st FLOOR **SCREENED PORCH GOURMET KITCHEN FIREPLACE TRAY @ DINING BOX OAK STAIRS OPEN STAIR RAIL** 4' OWNERS EXTENSION **OWNERS DELUXE BATH OWNERS DOOR TO PORCH** 4' GARAGE EXTENSION 2nd FLOOR **SECOND SINK @ BATH 2 BEDROOM 4** 

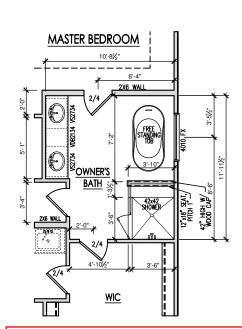
SQUARE FOOTAGE					
ELEVATION 'D'					
	UNHEATED	HEATED			
FIRST FLOOR	0	1981			
SECOND FLOOR	0	1040			
SCREENED PORCH	129	0			
FRONT PORCH	154 0				
2-CAR GARAGE	497	0			
SUBTOTAL S	780	3021			
TOTAL UNDER ROOF	3801				

**UNFINISHED STORAGE** 

OPTIONS .					
	UNHEATED	HEATED			
PT. 4FT OWNER'S EXTENSION	0	+60			
OPT. BED #4	0	216			
ONT LOAD GARAGE OPT, 4' EXTENSION	92	0			
VIEWICHED STORAGE OF	124	_			


### **PRINCE PLACE LOT 21**






OPT. DELUXE OWNER'S BATH

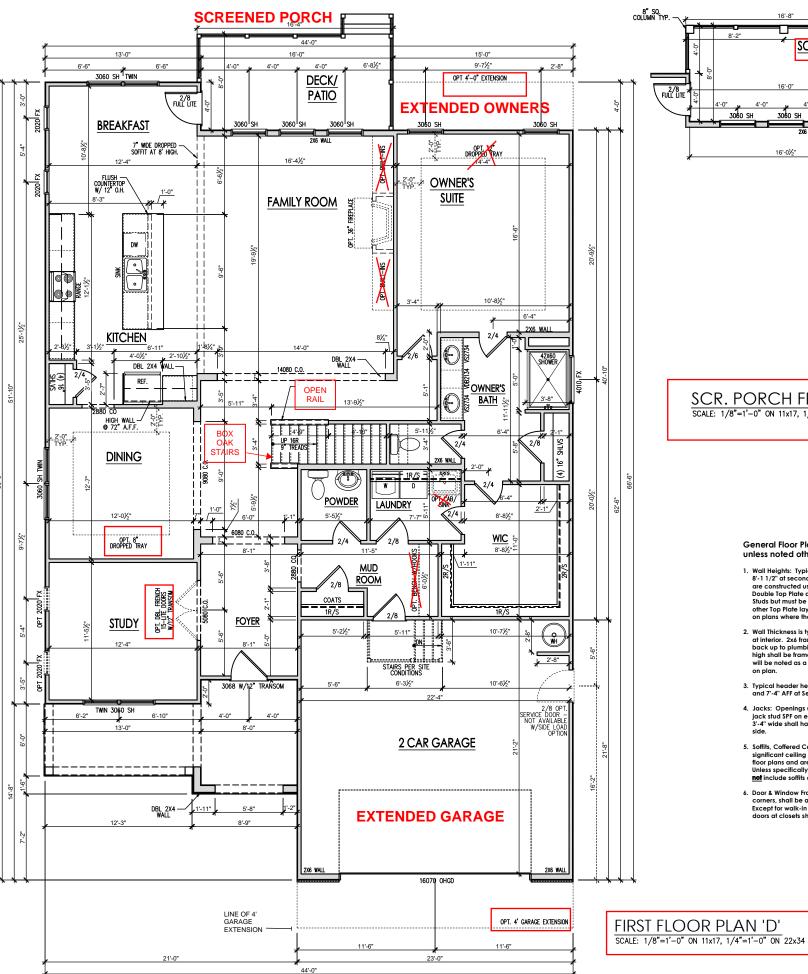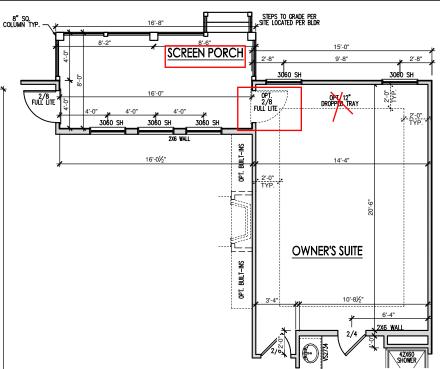SCALE: 1/8"=1'-0" ON 11x17, 1/4"=1'-0" ON 22x34





SCR. PORCH FLOOR PLAN W/ OWNER'S SUITE EXT. SCALE: 1/8"=1'-0" ON 11x17, 1/4"=1'-0" ON 22x34

#### **General Floor Plan Notes**

General Floor Plan Notes shall apply unless noted otherwise on plan.

- Wall Heights: Typically 9'-1 1/2" at first floor and 8'-1 1/2" at second floor and attics U.N.O. All walls are constructed using a double top plate. Splices at Double Top Plate do not need to occur at Vertical Studs but must be at least 24" apart from Joint in other Top Plate layer. Special wall heights are noted on plans where they occur.
- Wall Thickness is typically 4" at exterior walls, 3 1/2" at interior. 2x6 frame shall be used at walls that back up to plumbing fixtures. Walls greater than 10' high shall be framed will be x6 with 2x6 framing or greater and will be noted as a special condition where it occurs
- Typical header height shall be 8'-0" AFF at First Floor, and 7'-4" AFF at Second Floor U.N.O.
- Jacks: Openings up to 3"-4" wide shall have (1) 2x4
  jack stud SPF on each side. Openings greater than
  3"-4" wide shall have (2) 2x4 jack studs SPF on each
- Soffits, Coffered Ceilings, Trey Ceilings and other significant ceiling plan elements are shown on the floor plans and are denoted as single dashed lines. Unless specifically call out as included, Kitchens do not include soffits over wall cabinetry.
- Door & Window Frames, where occurring near corners, shall be a minimum of 4 1/2" from corner. Except for walk-in- closets with doors near a corner, doors at closets shall be centered on closet.

- Windows: Shall have at least (1) window in each sleeping room, that meets egress. Shall be provided with tempered glass at hazardous glazing areas.
   False windows shall be installed with obscure
- Closets for clothing or coat storage shall be equipped with 1 rod/shelf. Closets for linen shall have 5 open equal shelves. Closets for panties shall have 5 equal wood shelves, painted.
- Stair treads shall be a min of 9" deep, risers shall be a maximum of 8 1/4", unless noted otherwise, per the current North Carolina Residential Code
- 10.Handrails and Guards at stairs shall be 34" above the finished surface of the ramp surface of the stain Handrails at landings and overlooks of multilevel spaces shall be 38" above finished floor. Guards (pickets or ballsters) shall be spaced with no more than 4" between guards.
- 11.Attic Access shall be provided at all attic area with a height greater than 30". Minimum clear attic access shall be 20" x 30". Pull down stairs and access doors in knee walls meeting minimum criteria are also acceptable.
- 12.Garage Door to Living Space shall be 2'-8" x 6'-8" minimum size and shall be 20 minute fire rated and
- 13. Garage Walls, as a minimum, shall be separated from living space by installing 1/2" gypsum board on the garage side of the wall. With habitable space above, the inside of all garage walls require 1/2" GWB supporting 5/8" type X GWB on celling.



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RH • - CYPRESS - SINGLE FAMILY 2949

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First Floor Plan

DRAWN BY: South Designs

ISSUE DATE

06/30/2021 CURRENT REVISION DATE

SHEET

SCALE 1/8" = 1'-0"

#### **General Floor Plan Notes**

General Floor Plan Notes shall apply unless noted otherwise on plan.

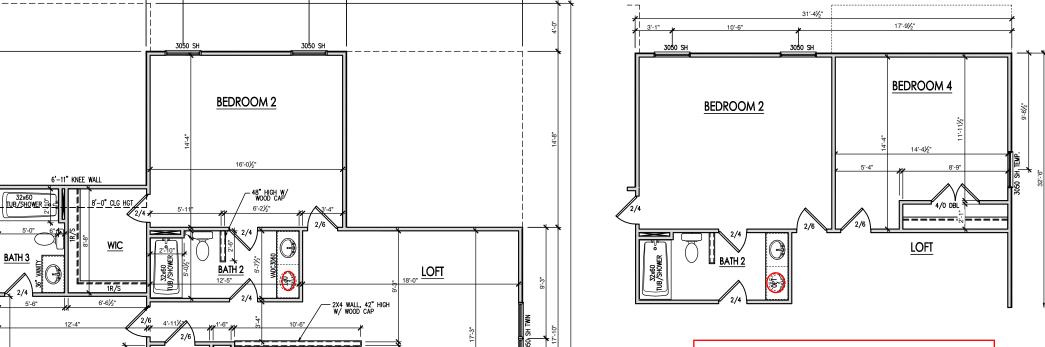
 Wall Heights: Typically 9'-1 1/2" at first floor and 8'-1 1/2" at second floor and attics U.N.O. All walls are constructed using a double top plate. Splices at Double Top Plate do not need to occur at Vertical Studs but must be at least 24" apart from Joint in other Top Plate layer. Special wall heights are noted on plans where they occur.

12'-71/5"

16'-81/2"

- Wall Thickness is typically 4" at exterior walls, 3 1/2" at interior. 2x6 frame shall be used at walls that back up to plumbing fixtures. Walls greater than 10' high shall be framed with 2x6 framing or greater and will be noted as a special condition where it occurs
- 3. Typical header height shall be 8'-0" AFF at First Floor, and 7'-4" AFF at Second Floor U.N.O.
- Jacks: Openings up to 3'-4" wide shall have (1) 2x4
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  3'-4" wide shall have (2) 2x4 jack studs SPF on each
- Sofflis, Coffered Ceilings, Trey Ceilings and other significant ceiling plan elements are shown on the floor plans and are denoted as single dashed lines. Unless specifically call out as included, Kitchens do not include soffits over wall cabinetry.
- Door & Window Frames, where occurring near corners, shall be a minimum of 4 1/2" from corner. Except for walk-in closets with doors near a corner, doors at closets shall be centered on closet.
- Windows: Shall have at least (1) window in each sleeping room, that meets egress. Shall be provided with tempered glass at hazardous glazing areas. False windows shall be installed with obscure
- Closets for clothing or coat storage shall be equipped with 1 rod/shelf. Closets for linen shall have 5 open equal shelves. Closets for pantries shall have 5 equal wood shelves, painted.
- 9. Stair treads shall be a min of 9" deep, risers shall be a maximum of 8 1/4", unless noted otherwise, per the current North Carolina Residential Code
- 10. Handrails and Guards at stairs shall be 34" above In Andrais and outers at stairs shall be 34 above the finished surface of the ramp surface of the stair. Handrails at landings and overlooks of multilevel spaces shall be 36\* above finished floor. Guards (pickets or balisters) shall be spaced with no more than 4\* between guards.
- 11. Attic Access shall be provided at all attic area with a height greater than 30". Minimum clear attic access shall be 20" x 30". Pull down stairs and access doors in knee walls meeting minimum criteria are also acceptable.
- 12. Garage Door to Living Space shall be 2'-8" x 6'-8" minimum size and shall be 20 minute fire rated and weather sealed.
- 13. Garage Walls, as a minimum, shall be separated from living space by installing 1/2" gypsum board on the garage side of the wall. With habitable space above, the inside of all garage walls require 1/2" GWB supporting 5/8" type X GWB on ceiling.

### PRINCE PLACE **LOT 21**








- RH Ū Second Floor Plan


> DRAWN BY: South Designs

ISSUE DATE 06/30/2021

SCALE:

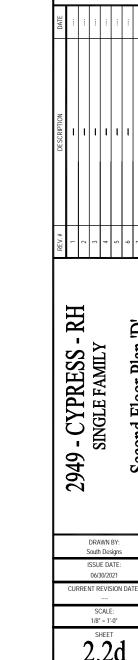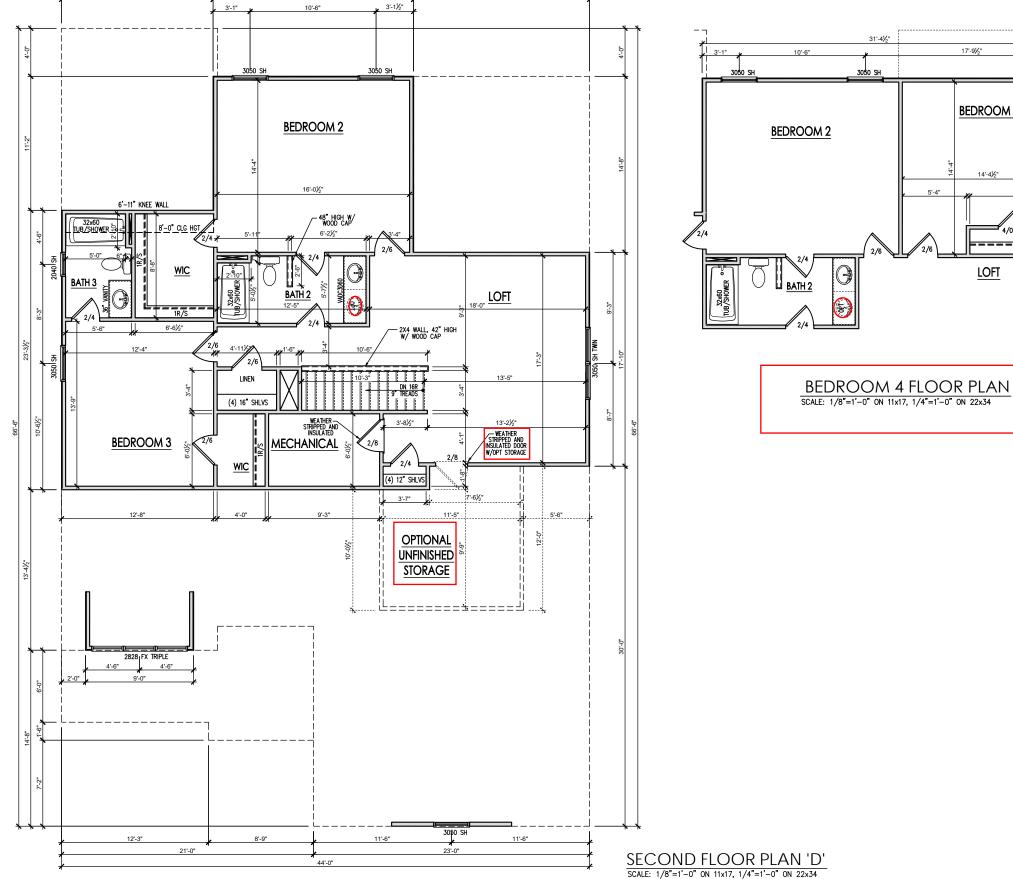SHEET 2.2d





#### **General Elevation Notes**

General Elevation Notes shall apply unless noted otherwise on plan.

- Roof shall be finished with architectural composition shingles with slopes as noted on plan.
- Ridge Vent shall be provided and installed on all ridges greater than 6' in length per manufacture's specifications.
- 3. Soffit Vent shall be continuous soffit vent
- House Wrap, "tyvek" or approved equal shall be installed over entire exterior wall per manufacturer's specifications and recommendations.
- Flashing shall be provided above all door and window openings, above finish wall material changes and at wall surfaces where lower roof areas abut vertical wall surfaces.
- Porch Railings shall be provided at all porch walking surfaces greater than 30" above adjacent finished grade. It shall be 36" high with guards spaced no more than 4" apart. Consult community specifications for material.
- Finish Wall Material shall be as noted on elevation drawings.
- 8. Brick Veneer, if included on elevation shall be fied to wall surface with galvanized corrugated metal fies at a rate of 24" oc horizontally and 16" oc vertically so that no more than 2.67sf of brick is supported by (1) fie. Space between face of wall and back face of brick shall be limited to a maximum of 1". Rashing shall be provided behind brick above all wall openings and at base of brick wall. Rashing shall be a minimum of 6-mil poly or other corrosion resistant material and shall be installed so that it laps under the house wrap material a minimum of 2".

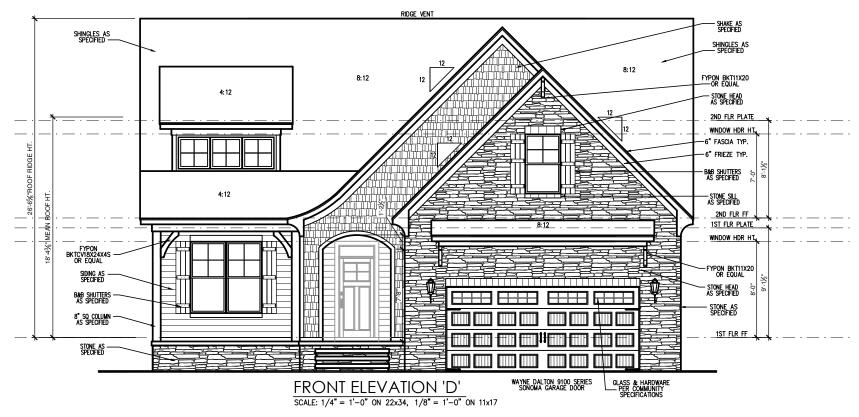
  Weepholes shall be provided at a rate of 48" oc and shall not be less than 3/16" in diameter and shall be located immediately above flashing.
- Brick Veneer Support Lintels shall be provided if brick veneer is included on elevation. Lintels shall be provided as listed in the following schedule and shall have a minimum bearing length of 6". Masonry Lintels shall be provided so that deflection is limited to L/600.

Masonry Opening Lintel Schedule

ening Size	Ar

up to 4'-0" 3-1/2" x 3-1/2" x 5/1 4'-1" to 5'-6" 4" x 3-1/2" x 5/16" LL
5'-7" to 6'-6" 5" x 3-1/2" x 5/16" LL
6'-7" to 8'-4" 6" x 3-1/2" x 5/16" LL
8'-5" to 16'-4" 7" x 4" x 3/8" LLV

### PRINCE PLACE LOT 21





REAR ELEVATION BEDROOM 4
SCALE: 1/8"=1'-0" ON 11x17, 1/4"=1'-0" ON 22x34

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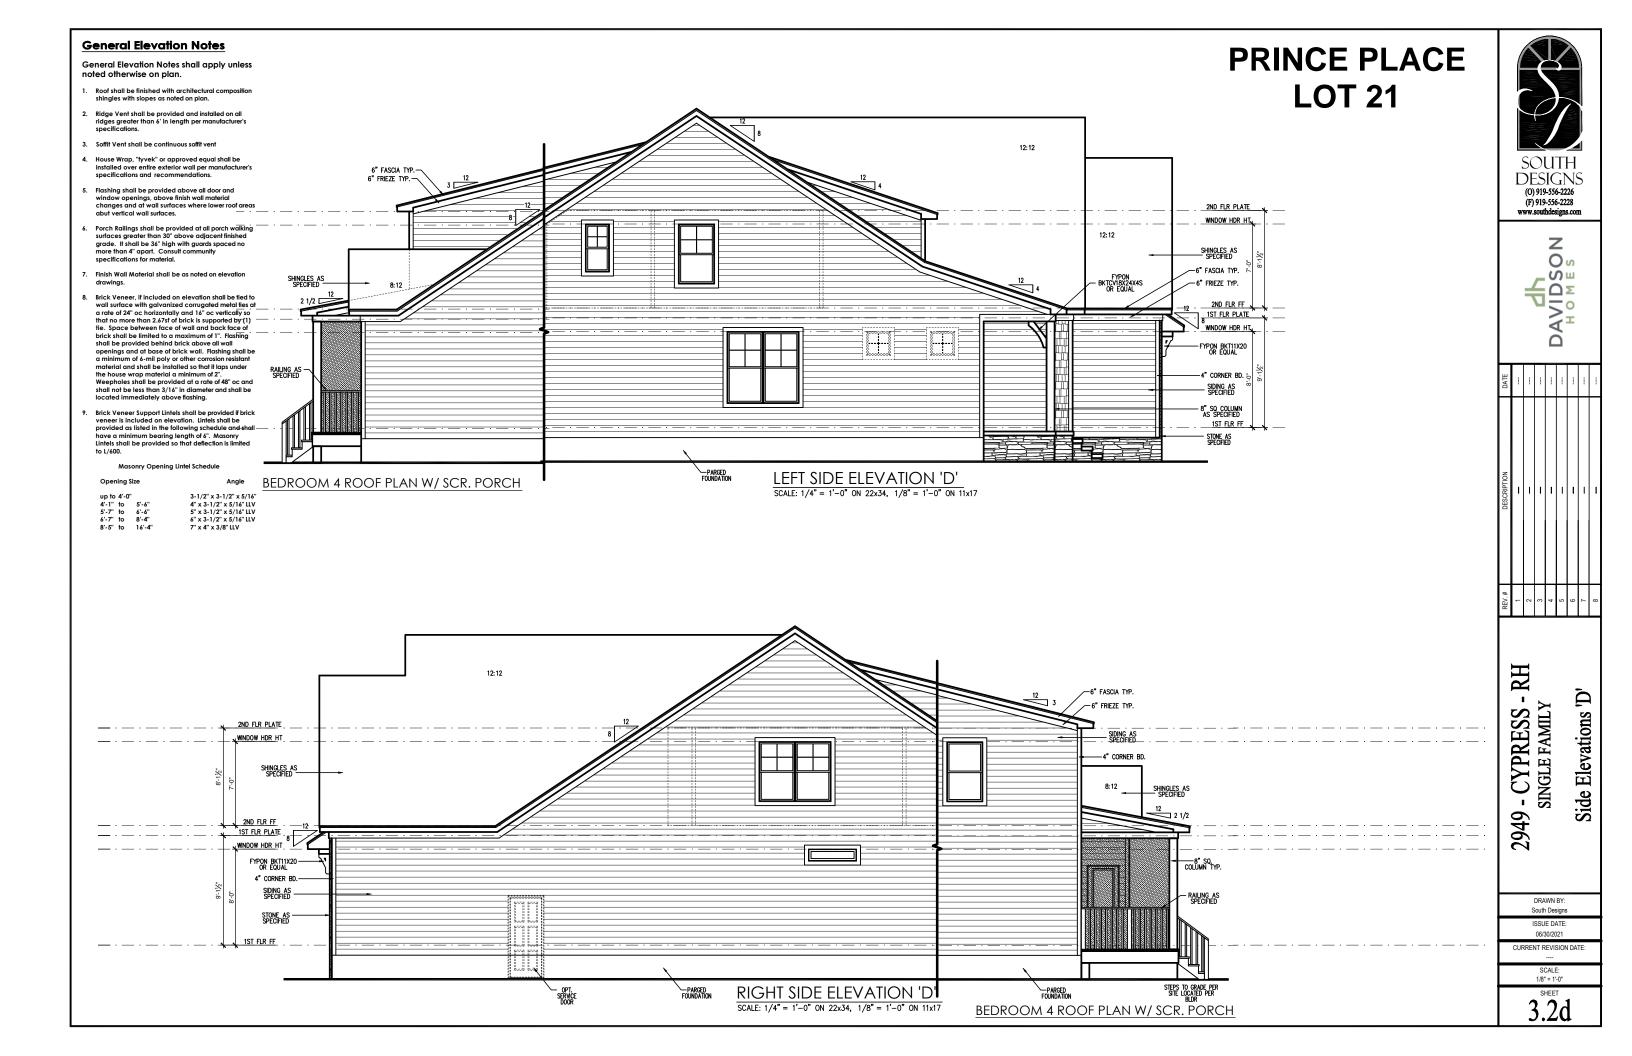
2949 - CYPRESS - RH SINGLE FAMILY Front & Rear Elevations 'D'


> DRAWN BY: South Designs

ISSUE DATE: 06/30/2021 CURRENT REVISION DATE:

SCALE: 1/8" = 1'-0"

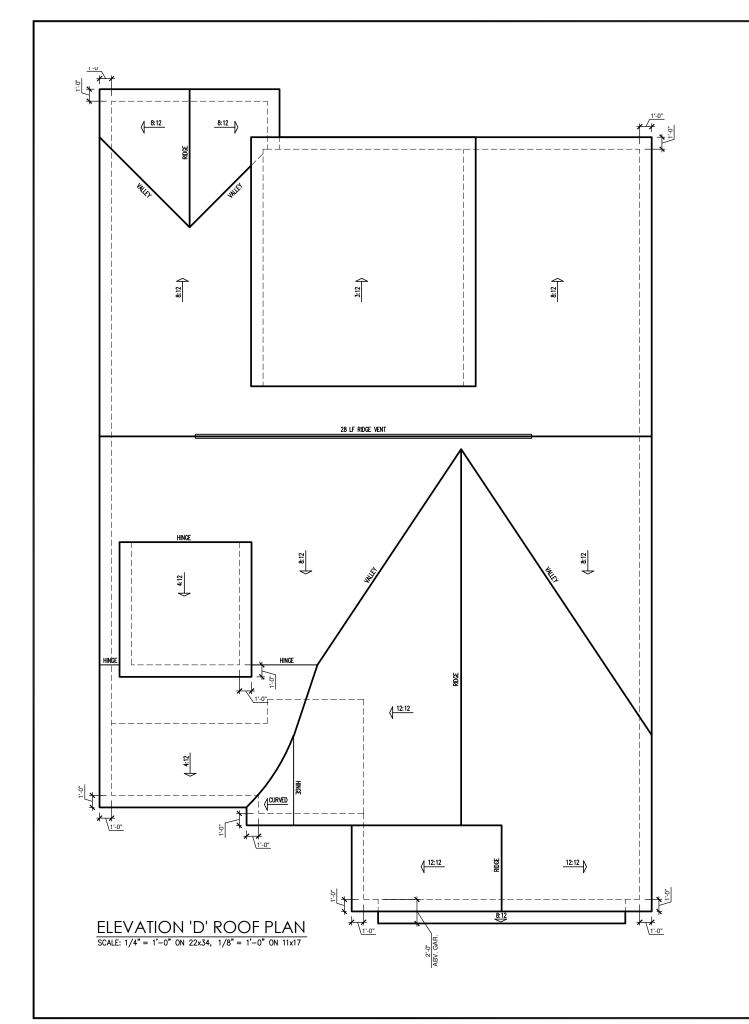
3.1d






## PRINCE PLACE LOT 21

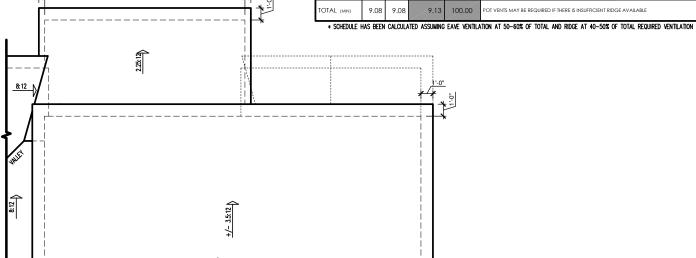	ATTIC VENT SCHEDULE									
	ELEVATION 'D'									
	MAIN HOUSE			SQ FTG	2724	AT / NEAR RIDGE		AT / NEAR EAVE		
	VENT TYPE	SQ. FT. REQUIRED	SQ. Fl.	PERCENT OF TOTAL	POT LARGE (SQ. FT. EACH)	POT SMALL (SQ. FT. EACH)	RIDGE VENT (SQ. FT. PER LF)	EAVE VENT (SQ. IN. EACH)	CONT. VENT (SQ. IN. PERLF)	
		RAN		SUPPLIED	SUPPLIED	0.4236	0.2778	0.125	0.1944	0.0625
	RIDGE VENT	3.63	4.54	3.50	38.36	0	0	28.00		
	SOFFIT VENTS	5.45	4.54	5.63	61.64				0	90.00
	TOTAL (MIN)	9.08	9.08	9.13	100.00	POT VENTS MAY BE REQUIRED IF THERE IS INSUFFICIENT RIDGE AVAILABLE				



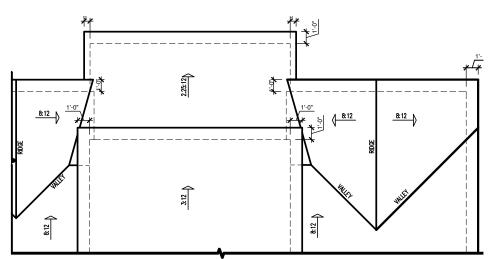
BEDROOM 4 ROOF PLAN W/ SCR. PORCH SCALE: 1/8"=1'-0" ON 11x17, 1/4"=1'-0" ON 22x34



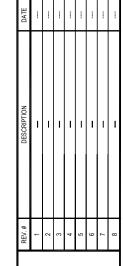SCR. PORCH ROOF PLAN W/ OWNER'S SUITE EXT.
SCALE: 1/8"=1'-0" ON 11x17, 1/4"=1'-0" ON 22x34



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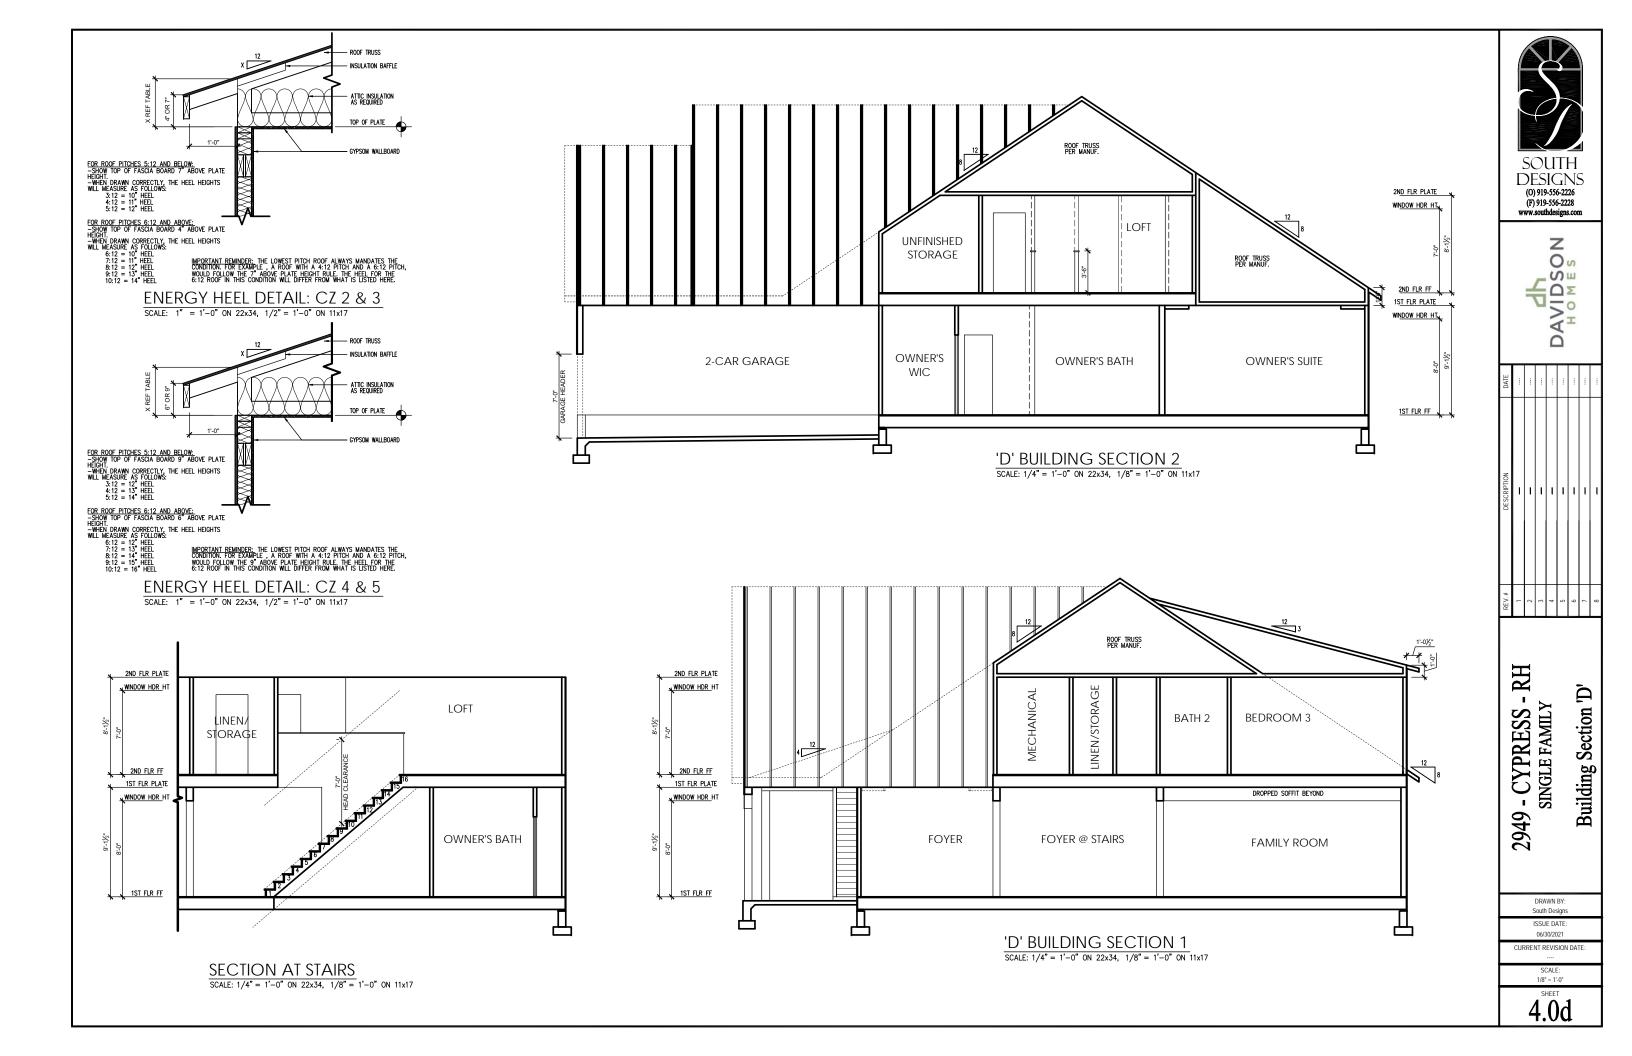
2949 - CYPRESS - RH SINGLE FAMILY Roof Plan 'D'


> DRAWN BY: South Designs

ISSUE DATE: 06/30/2021

CURRENT REVISION DATE:

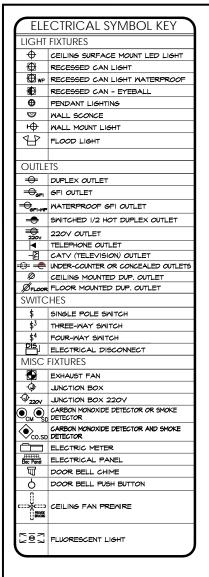3.3d






#### **General Power and Lighting:**


General Power and Lighting Notes shall apply unless noted otherwise on plans.

All work shall be installed per the current NC Residential Building Code, and the National Electric Code. Alarm devices shall meet NFPA 72.


- Smoke Alarms Shall be provided as a minimum of (1) per floor, including basements (if applicable), (1) in each sleep room, and (1) outside each sleeping area, within the immediate vicinity of sleeping rooms. When more than one alarm is required, the alarm devices shall be interconnected in such a manner that the activation of one alarm will activate all of the alarms. Smoke alarms shall be hard wired to permanent power and shall have batter back-ups.
- Switches For lighting, fans, etc. shall be installed at heights illustrated on this page and shall be located a minimum of 4 1/2" from door openings to allow for the proper installation of door casings. Switches, thermostats, security pads, and other similar devices shall be grouped together and installed thoughtfully for convenience of use and to avoid placement within centers of wall areas.

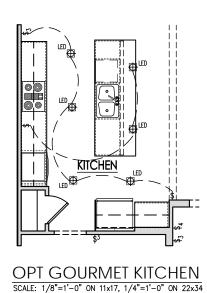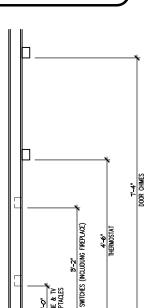Note:
This plan is a diagram showing approximate locations of convenience outlets based on requirements found in the NC Residential Code and N.E.C. Actual positions may vary from what is shown on plan.






**ELECTRICAL BOX HEIGHTS** 

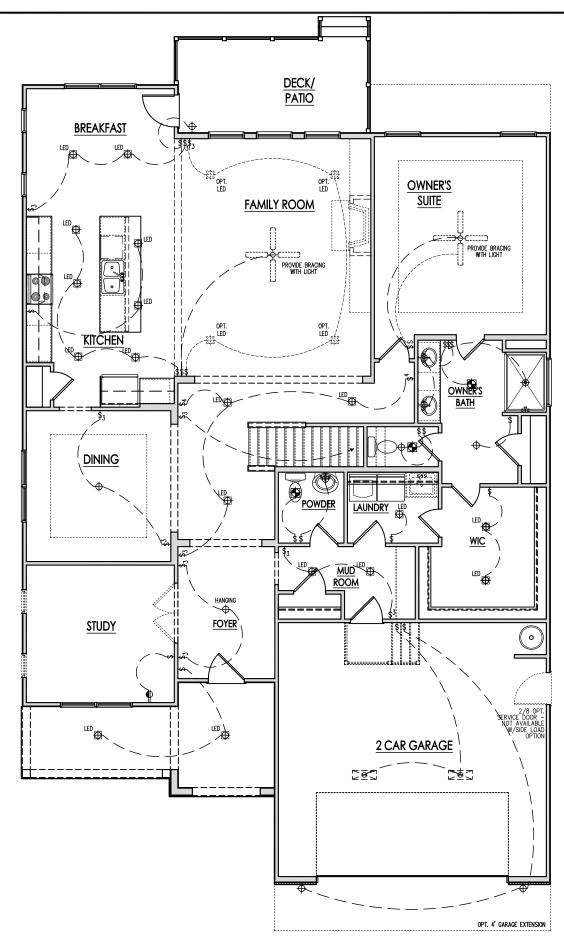




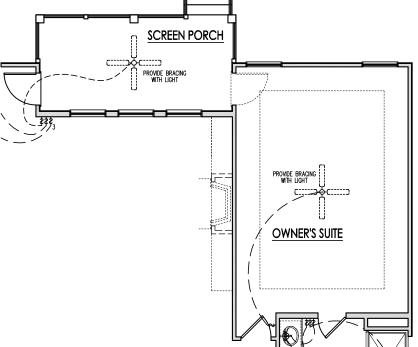

SCR. PORCH ELECTRICAL W/ OWNER'S SUITE EXT.

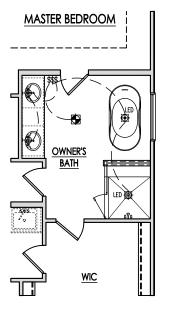SCALE: 1/8"=1'-0" ON 11x17, 1/4"=1'-0" ON 22x34



OPT. DELUXE OWNER'S BATH
SCALE: 1/8"=1'-0" ON 11x17, 1/4"=1'-0" ON 22x34



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2949 - CYPRESS - RH SINGLE FAMILY First Floor Electrical 'D'

> DRAWN BY: South Designs

ISSUE DATE: 06/30/2021

06/30/2021 CURRENT REVISION DATE

SCALE: 1/8" = 1'-0"

5.1d

FIRST FLOOR ELECTRICAL PLAN

SCALE: 1/8"=1'-0" ON 11x17, 1/4"=1'-0" ON 22x34

#### ELECTRICAL SYMBOL KEY LIGHT FIXTURES CEILING SURFACE MOUNT LED LIGHT RECESSED CAN LIGHT RECESSED CAN LIGHT WATERPROOF RECESSED CAN - EYEBALL ◆ PENDANT LIGHTING ₩ALL SCONCE ₩ WALL MOUNT LIGHT FLOOD LIGHT OUTLETS DUPLEX OUTLET € GFI OUTLET SFI-WP WATERPROOF GFI OUTLET SMITCHED 1/2 HOT DUPLEX OUTLET 220V OUTLET TELEPHONE OUTLET → CATY (TELEVISION) OUTLET ==== UNDER-COUNTER OR CONCEALED OUTLETS Ø CEILING MOUNTED DUP. OUTLET BFLOOR FLOOR MOUNTED DUP. OUTLET **SWITCHES** \$ SINGLE POLE SWITCH \$3 THREE-MAY SMITCH \$4 FOUR-MAY SMITCH ELECTRICAL DISCONNECT MISC FIXTURES EXHAUST FAN UNCTION BOX DINCTION BOX 220V CARBON MONOXIDE DETECTOR OR SMOKE CO.SD CARBON MONOXIDE DETECTOR AND SMOKE DETECTOR ELECTRIC METER ELECTRICAL PANEL DOOR BELL CHIME DOOR BELL PUSH BUTTON CEILING FAN PREMIRE ₽ FLUORESCENT LIGHT

#### **General Power and Lighting:**


General Power and Lighting Notes shall apply unless noted otherwise on plans.


All work shall be installed per the current NC Residential Building Code, and the National Electric Code. Alarm devices shall meet NFPA 72.

- Smoke Alarms Shall be provided as a minimum of (1)
  per floor, including basements (if applicable), (1) in each
  sleep room, and (1) outside each sleeping area, within
  the immediate vicinity of sleeping rooms. When more
  than one alarm is required, the alarm devices shall be
  interconnected in such a manner that the activation of
  one alarm will activate all of the alarms. Smoke alarms
  shall be hard wired to permanent power and shall have
  batter back-ups.
- Switches For lighting, fans, etc. shall be installed at heights illustrated on this page and shall be located a minimum of 4 1/2" from door openings to allow for the proper installation of door casings. Switches, thermostats, security pads, and other similar devices shall be grouped together and installed thoughtfully for convenience of use and to avoid placement within centers of wall areas.

#### Note

This plan is a diagram showing approximate locations of convenience outlets based on requirements found in the NC Residential Code and N.E.C. Actual positions may vary from what is shown on plan.

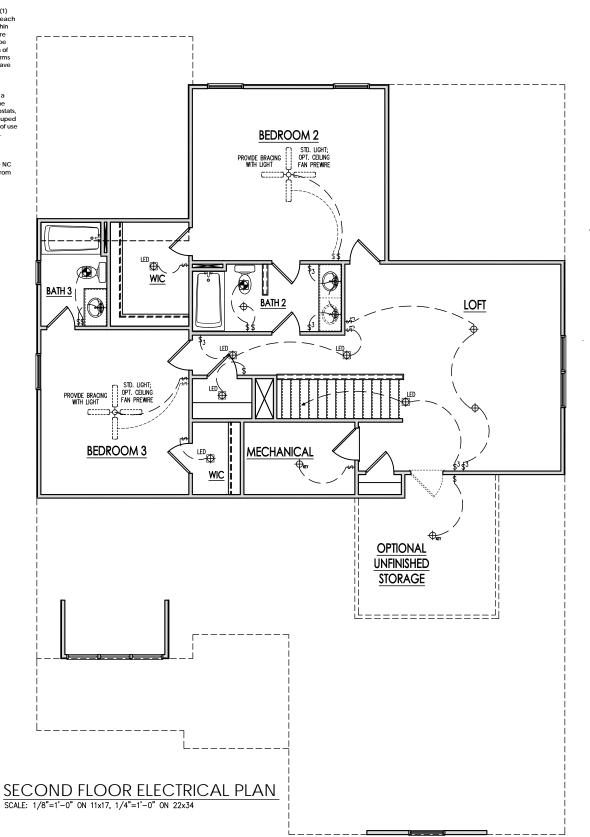

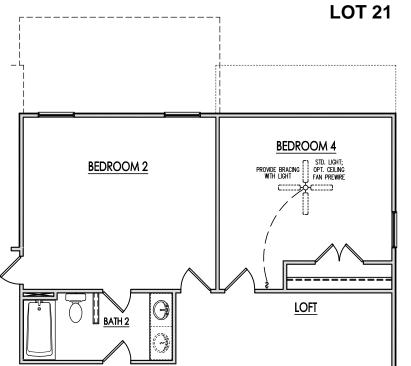

BEDROOM 4 ELECTICAL W/ SCR. PORCH SCALE: 1/8"=1'-0" ON 11x17, 1/4"=1'-0" ON 22x34



**PRINCE PLACE** 





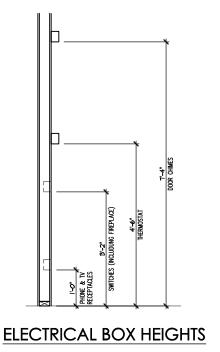
2949 - CYPRESS - RH SINGLE FAMILY Second Floor Electrical 'D'

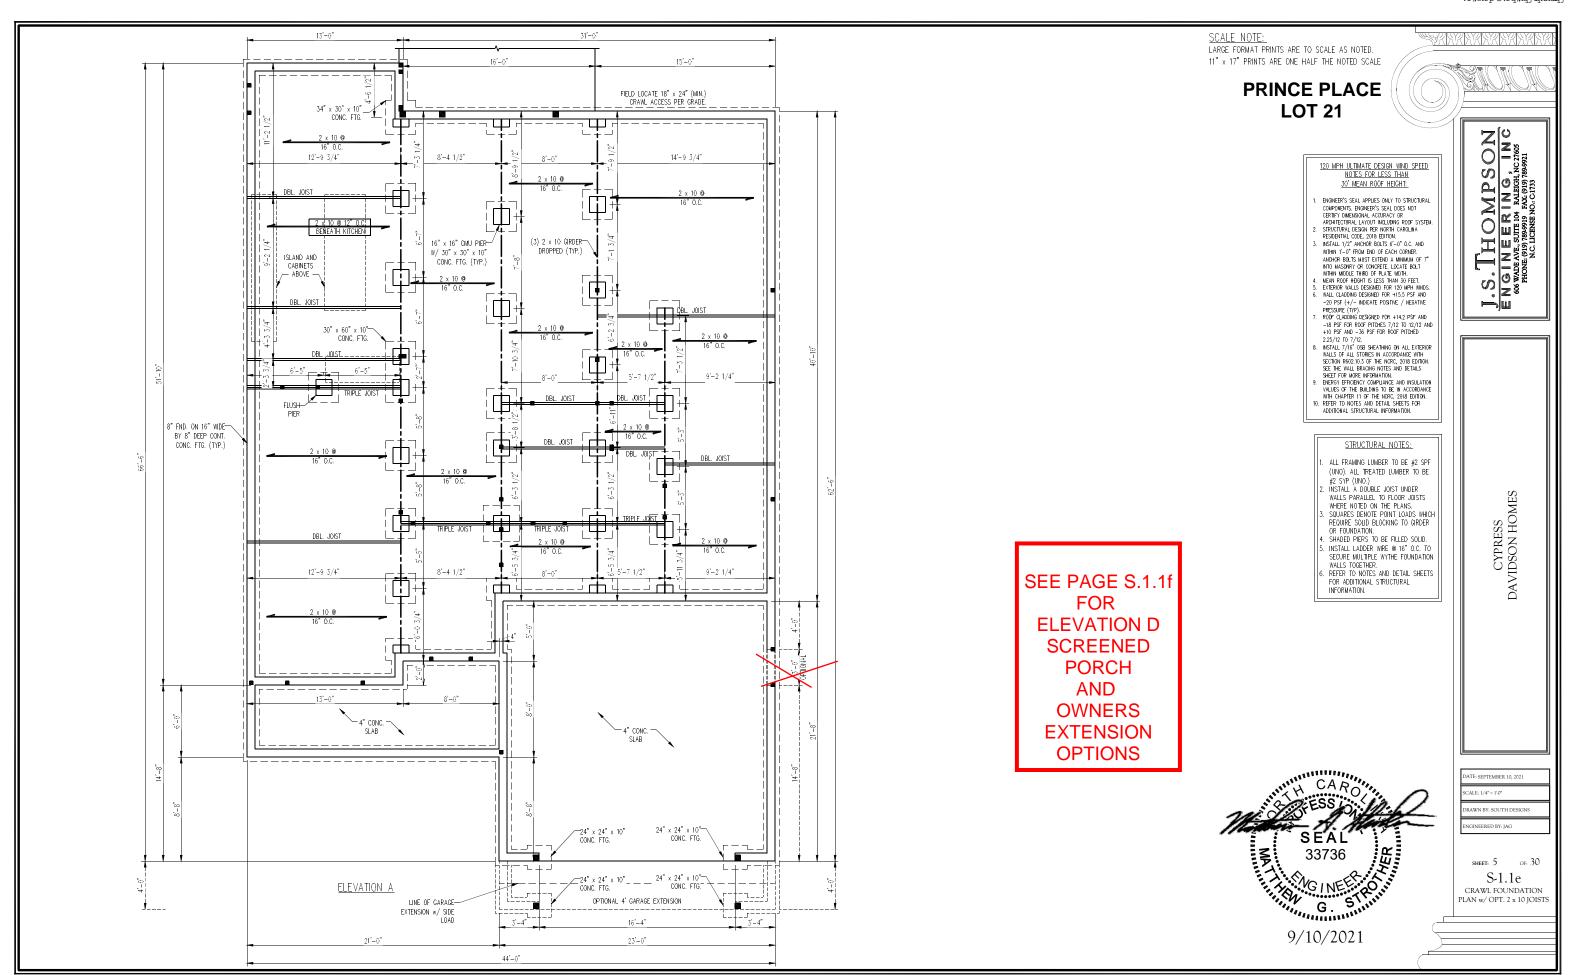
DRAWN BY: South Designs

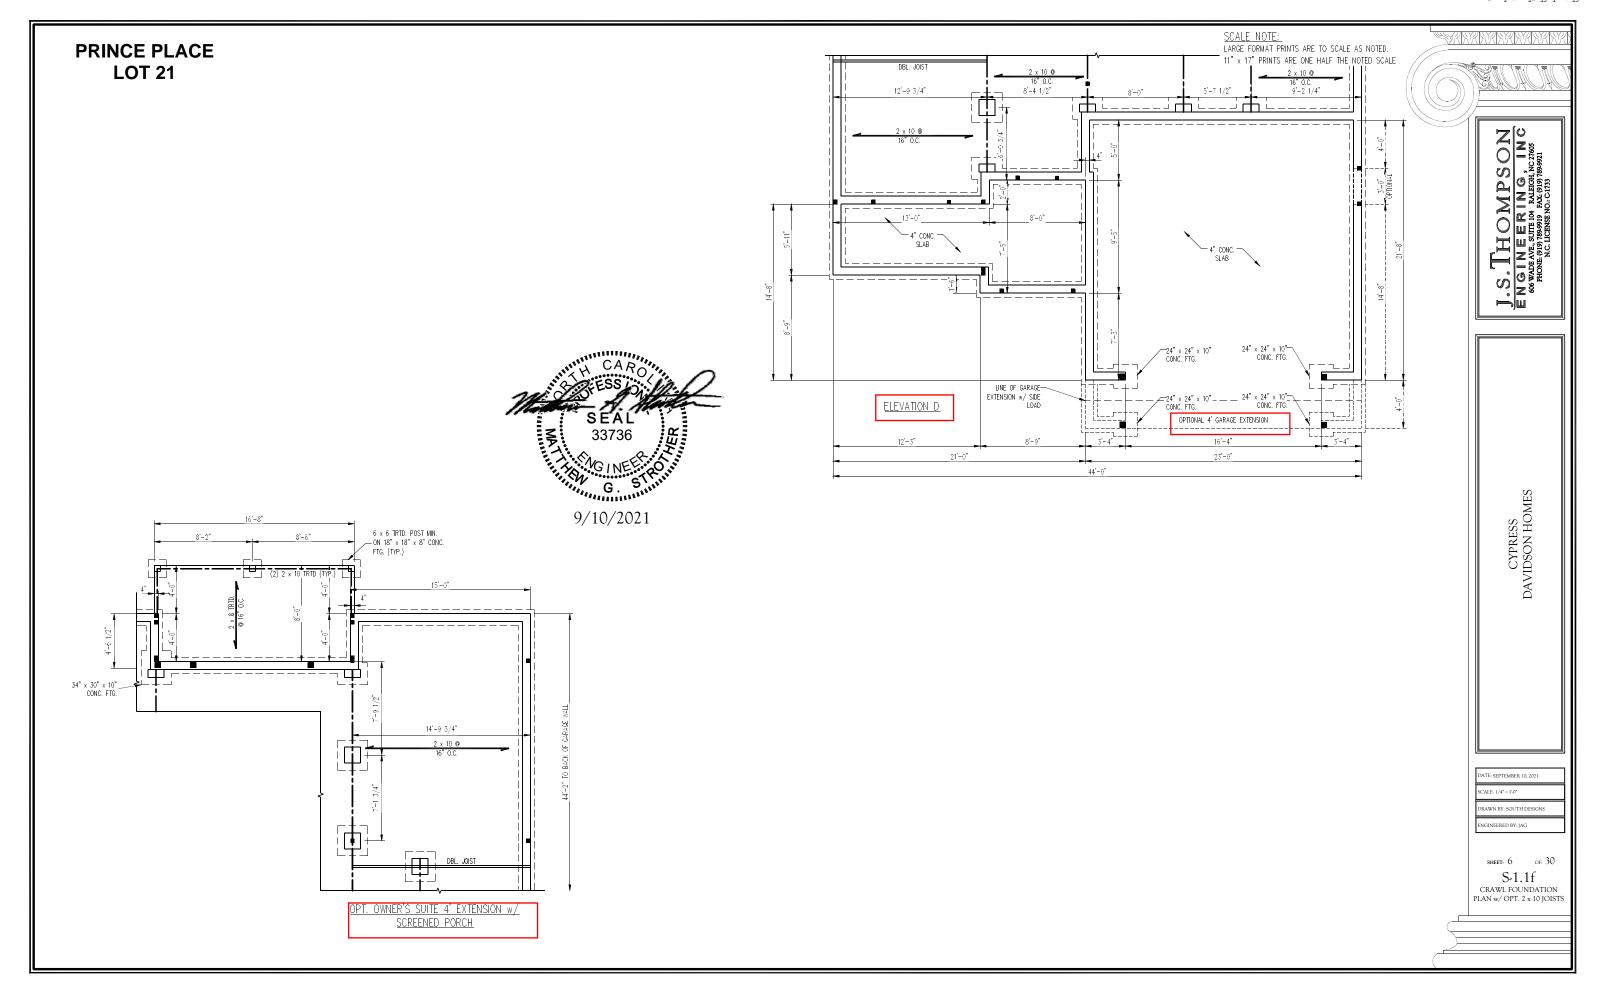
ISSUE DATE: 06/30/2021

CURRENT REVISION DATE
....
SCALE:

1/8" = 1'-0"
SHEET
5.2d







NOTE: BCI 5000s-1.8 JOISTS MAY BE USED IN LIEU OF TJI 210 JOISTS AT THE DEPTH AND SPACING INDICATED ON THE PLANS. BRACED WALL DESIGN NOTES: BRACED WALL DESIGN PER SECTION R602.10 OF THE NCRC 2018 EDITION.

CS-WSP REFERS TO "CONTINUOUS SHEATHING — WOOD STRUCTURAL PANELS" CONTRACTOR IS TO INSTALL 7/16" OSB ON ALL EXTERIOR WALLS ATTACHED w/ 8d NAILS SPACED 6" O.C. ALONG PANEL EDGES AND 12" OC. IN THE FIELD.

"GB REFERS TO "GYPSUM BOARD" CONTRACTOR IS TO INSTALL 1/2" (MIN.) GYPSUM WALL BOARD WHERE MOTED ON THE PLANS, FASTEN GB WITH 11/4"
SCREWS OR 1 5/8" NAILS SPACED 7" O.C. ALONG
PANEL EDGES AND IN THE FIELD INCLUDING TOP AND
BOTTOM PLATES.
BRACED WALL DESIGN APPLIED IN WIND ZONES UP TO 130 MPH. FOR HIGH WIND ZONES, BRACE WALLS ARE TO BE CONSTRUCTED IN ACCORDANCE WITH CHAPTER 45 OF THE NORC 2018 EDITION. SEE NOTES AND DETAIL SHEETS FOR ADDITIONAL BRACED WALL INFORMATION. BRACED WALL DESIGN RECTANGLE A SIDE 1A (FRONT LOAD)
METHOD: CS-WSP/GB TOTAL REQUIRED LENGTH: 22.3' TOTAL PROVIDED LENGTH: 25.92' METHOD: CS-WSP/GB TOTAL REQUIRED LENGTH: 22.3' TOTAL PROVIDED LENGTH: 24.40'

#### STRUCTURAL NOTES:

SIDE 3A (SIDE LOAD) METHOD: CS-WSP

SIDE 4A METHOD: CS-WSP

TOTAL REQUIRED LENGTH: 11.48'


TOTAL PROVIDED LENGTH: 43.92'

TOTAL REQUIRED LENGTH: 11.48'
TOTAL PROVIDED LENGTH: 56.5'

- ALL FRAMING LUMBER TO BE SPF #2 (UNO). ALL TREATED LUMBER TO BE SYP #2 (UNO.)
- ALL LOAD BEARING HEADERS TO BE (2) 2 x
- 10 (UNO). PROVIDE AN EXTRA JOIST UNDER WALLS PARALLEL TO FLOOR JOISTS WHERE NOTED ON THE PLANS.
- WINDOW AND DOOR HEADERS TO BE SUPPORTED w/ (1) JACK STUD AND (1) KING STUD EA. END (UNO.). SEE TABLE R602.7.5 FOR ADDITIONAL KING STUD REQUIREMENTS.
  SQUARES DENOTE POINT LOADS WHICH
- REQUIRE SOLID BLOCKING TO GIRDER OR FOUNDATION. ALL SQUARES TO BE (2) COMIT SOUTS
- ALL 4 x 4 POSTS SHALL BE ANCHORED TO SLABS w/ SIMPSON ABU44 POST BASES (OR EQUAL) AND 6 x 6 POSTS w/ ABU66 POST BASES (OR EQUAL) (UNO). ALL 4 x 4 AND 6 x 6 POSTS TO BE INSTALLED WITH 700 LB CAPACITY UPLIFT CONNECTORS AT TOP (UNO.) REFER TO NOTES AND DETAIL SHEETS FOR
- ADDITIONAL STRUCTURAL INFORMATION.

TABLE R602.7.5 MINIMUM NUMBER OF FULL HEIGHT STUDS AT EACH END OF HEADERS IN EXTERIOR WALLS

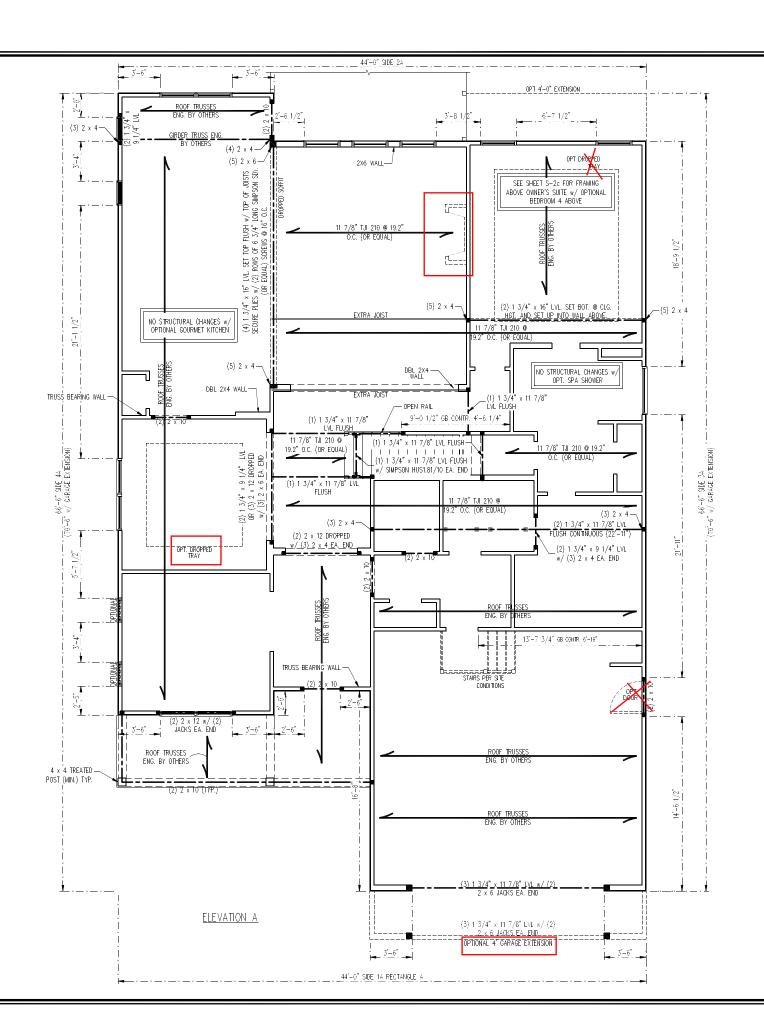ALL ENGLISHED OF THEMBERS IN EXTENSIVE WILLS					
HEADER SPAN (FEET)	MAXIMUM STUD SPACING (INCHES) (PER TABLE R602.3(5)				
	16	24			
UP TO 3'	1	1			
4'	2	1			
8'	3	2			
12'	5	3			
16'	6	4			



SCALE NOTE: LARGE FORMAT PRINTS ARE TO SCALE AS NOTED. 11" x 17" PRINTS ARE ONE HALF THE NOTED SCALE

> **PRINCE PLACE LOT 21**

SON 1. INC 184, NC 27605 

SEE PAGE S.2b **FOR ELEVATION D DELUXE BATH SCREENED PORCH** AND **OWNERS EXTENSION OPTIONS** 

G.

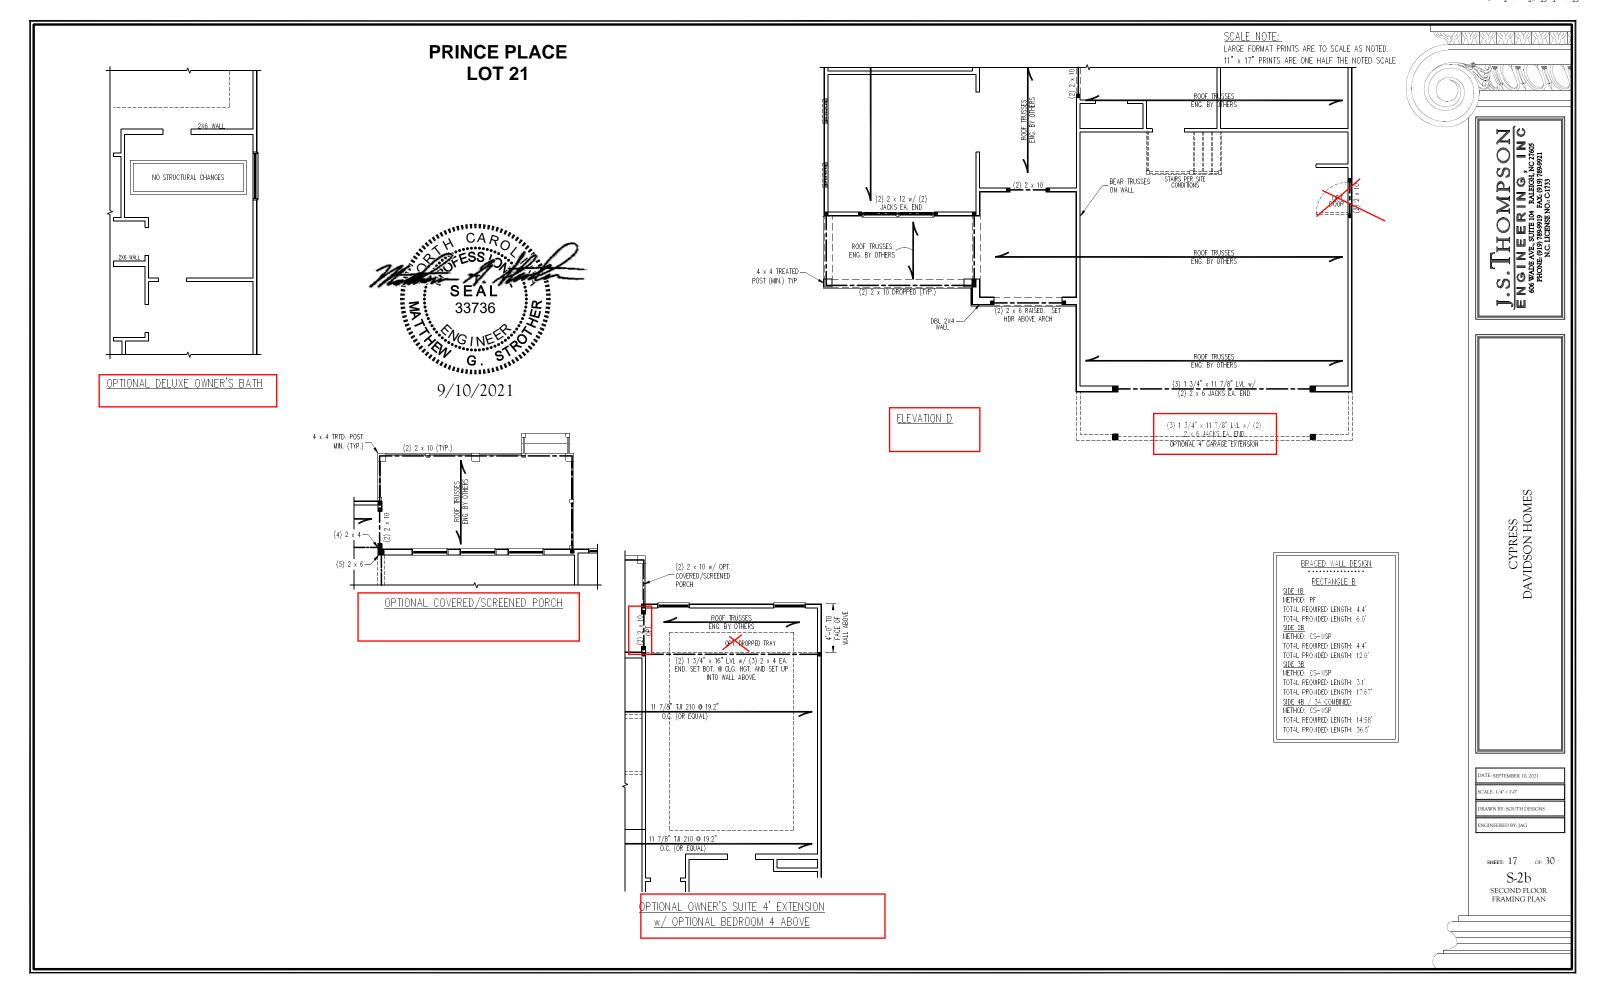
9/10/2021

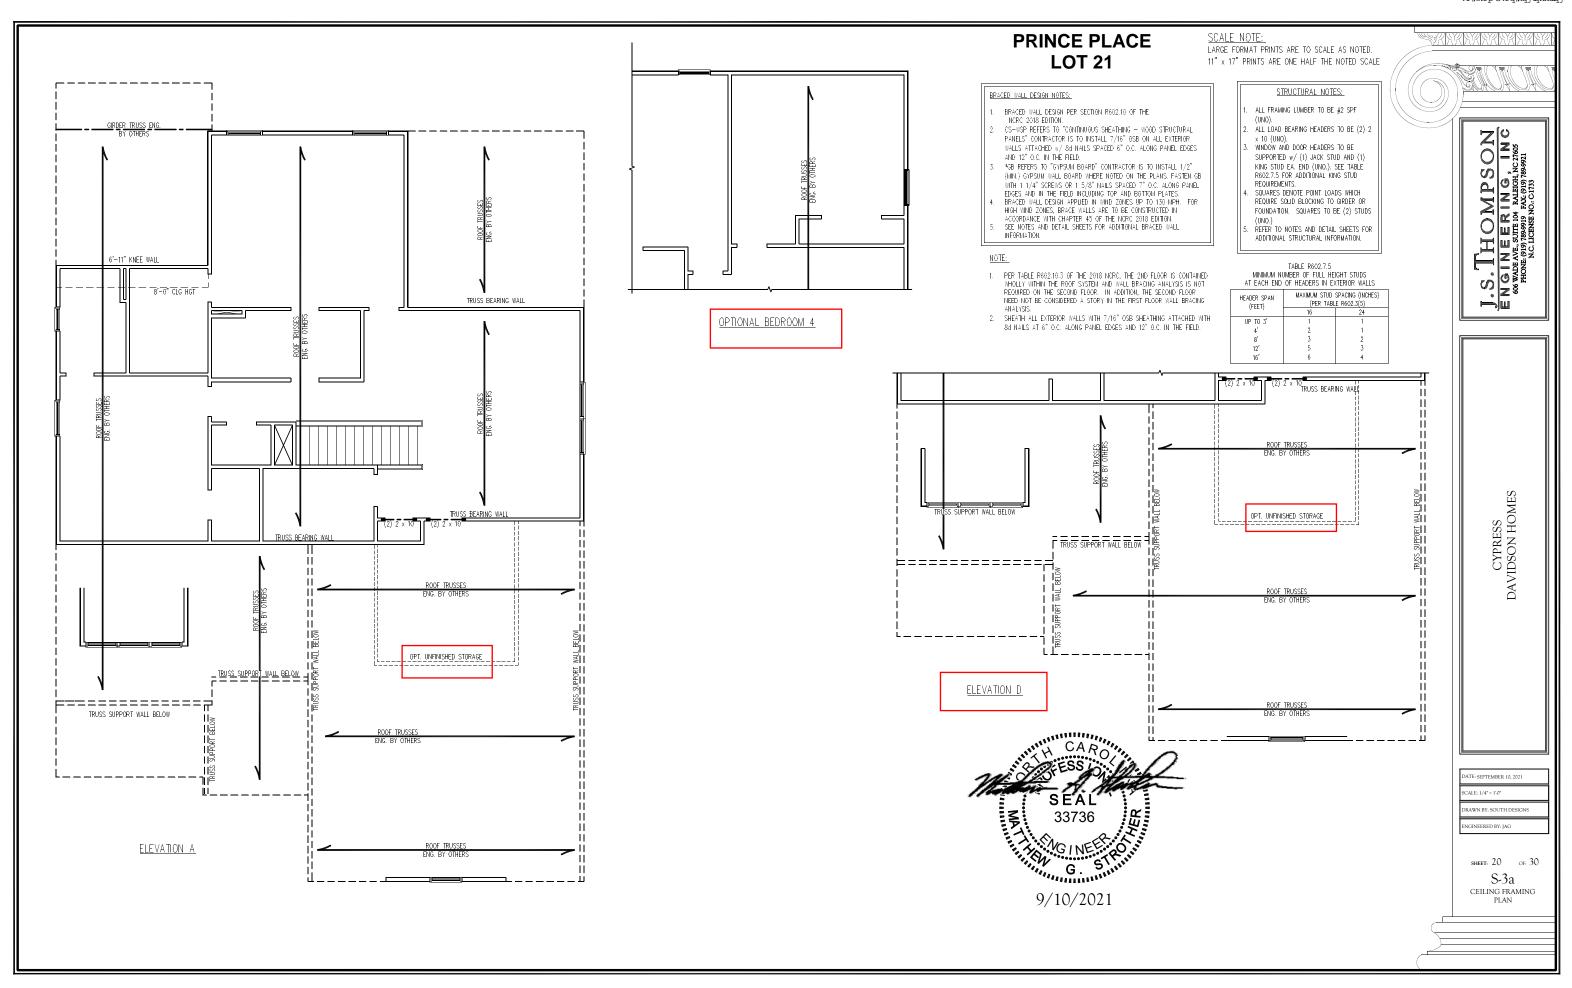
CYPRESS DAVIDSON HOMES

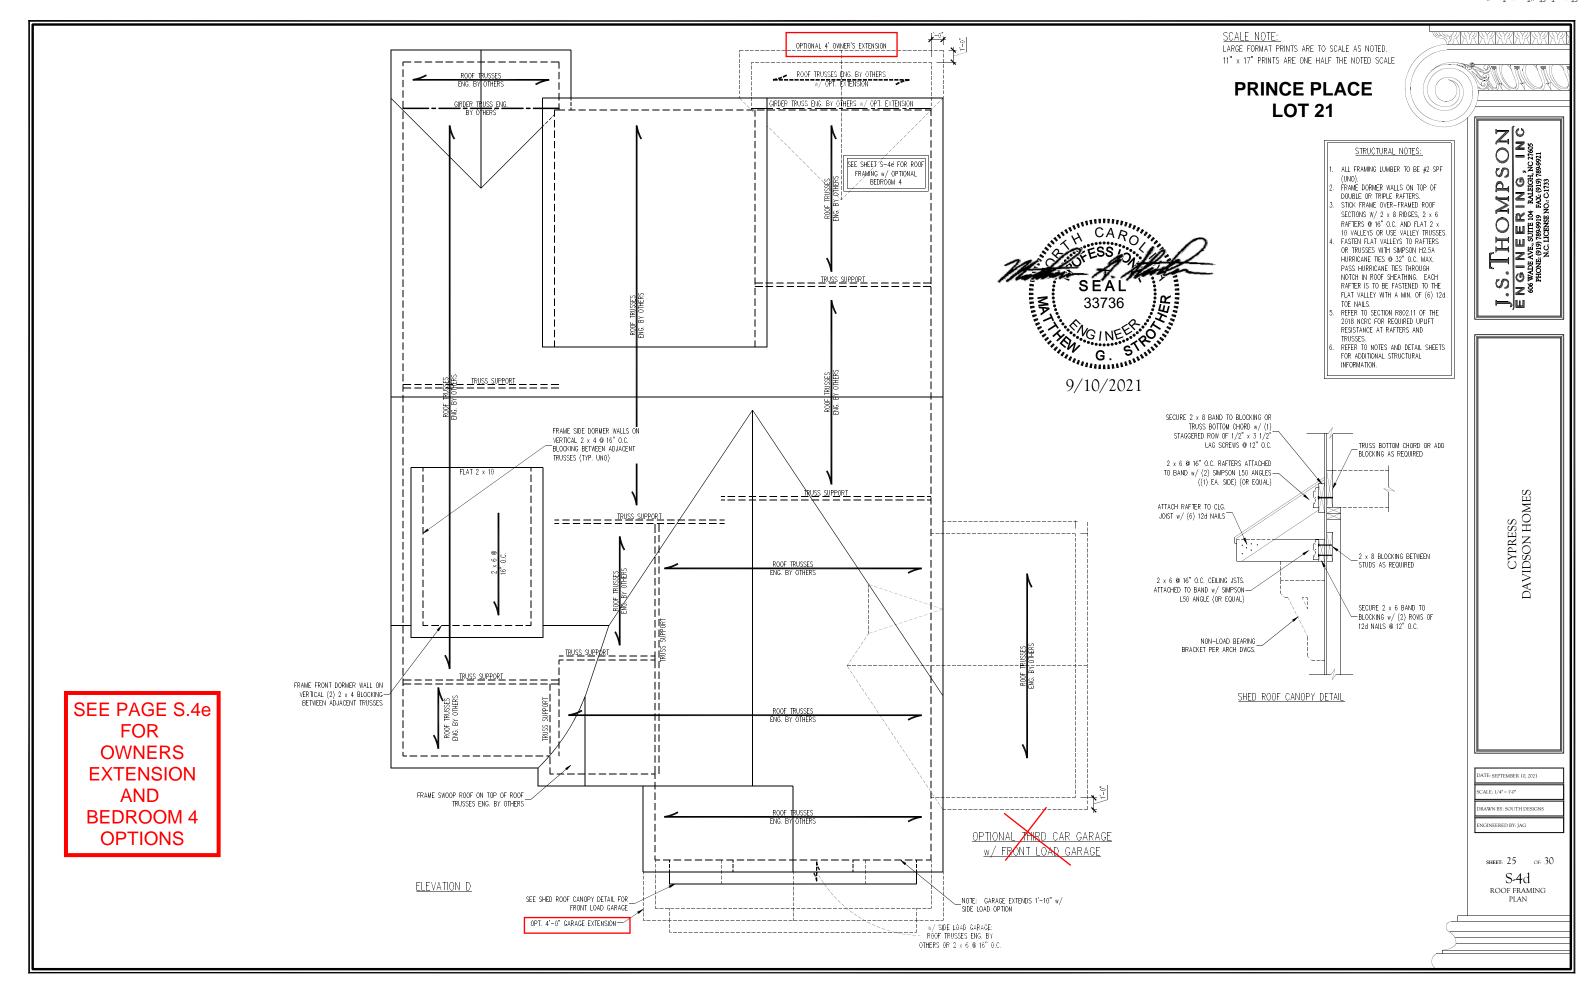
ATE: SEPTEMBER 10, 2021 CALE: 1/4" = 150"

DRAWN BY: SOUTH DESIGN:

SHEET: 16 OF: 30 S-2a SECOND FLOOR FRAMING PLAN










SCALE NOTE: LARGE FORMAT PRINTS ARE TO SCALE AS NOTED. 11" x 17" PRINTS ARE ONE HALF THE NOTED SCALE **PRINCE PLACE LOT 21** OPTIONAL COVERED/SCREENED PORCH TRUSS SUPPORT OPTIONAL BEDROOM 4 OPT. COVERED/SCREENED PORCH w/ 4'-0" OWNER'S SUITE EXTENSION DRAWN BY: SOUTH DESIGNS SHEET: 26 OF: 30 S-4e ROOF FRAMING PLAN 9/10/2021


### GENERAL WALL BRACING NOTES:

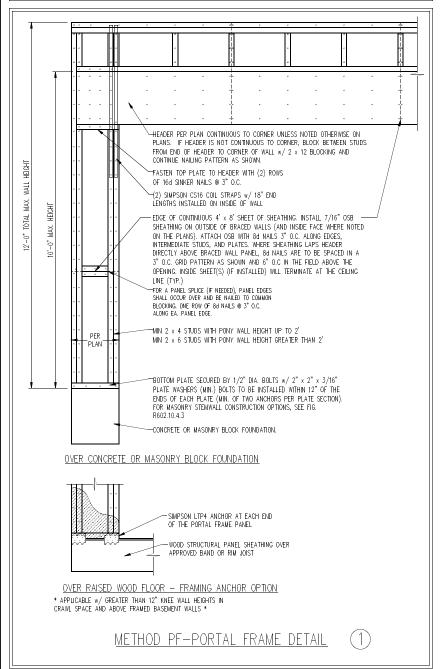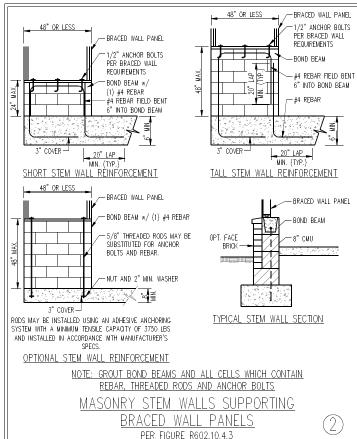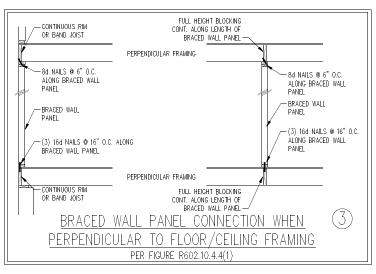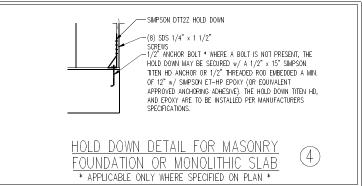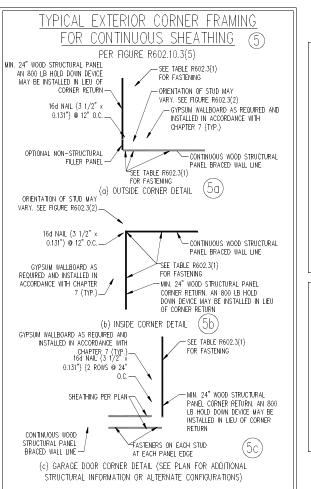
- 1. WALL BRACING DESIGNED IN ACCORDANCE WITH CHAPTER 6 OF THE 2018 NC RESIDENTIAL BUILDING CODE (NCRC). TABLES AND FIGURES REFERENCED ARE FROM THE 2018 NCRC.
- SEE THIS SHEET FOR GENERAL DETAILS. REFER TO THE 2018 NCRC FOR ADDITIONAL INFORMATION AS NEEDED BRACED EXTERIOR WALLS SUPPORTING ROOF TRUSSES AND RAFTERS, INCLUDING STORIES BELOW THE TOP FLOOR, HAVE BEEN DESIGNED
- PER R602.3.5 (3). WALL SHEATHING AND FASTENERS HAVE BEEN DESIGNED TO RESIST COMBINED UPLIFT AND SHEAR FORCES IN ACCORDANCE WITH ACCEPTED ENGINEERED PRACTICE SEE STRUCTURAL SHEETS FOR BRACED WALL LOCATIONS, DIMENSIONS, HOLD DOWN TYPE AND LOCATIONS, BRACED WALL LINE KEY WITH
- WALL DESIGN SUMMARY OF REQUIRED/PROVIDED TOTALS FOR EACH WALL LINE AND ANY SPECIAL NOTES OR REQUIREMENTS. ALL EXTERIOR WALLS ARE TO BE SHEATHED WITH CS-WSP IN ACCORDANCE WITH SECTION R602.10.3 UNLESS NOTED OTHERWISE.
- ALL EXTERIOR AND INTERIOR WALLS TO HAVE 1/2" GYPSUM INSTALLED. WHEN NOT USING METHOD "GB", GYPSUM TO BE FASTENED PER TABLE R702.3.5. METHOD GB TO BE FASTENED PER TABLE R602.10.1
- CS-WSP REFERS TO THE "CONTINUOUS SHEATHING WOOD STRUCTURAL PANELS" WALL BRACING METHOD. 7/16" OSB SHEATHING IS TO BE INSTALLED ON ALL EXTERIOR WALLS ATTACHED w/ 6d COMMON NAILS OR 8d (2 1/2" LONG x 0.113" DIAMETER) NAILS SPACED 6" O.C. ALONG PANEL EDGES AND 12" O.C. IN THE FIELD (U.N.O.).
- GB REFERS TO THE "GYPSUM BOARD" WALL BRACING METHOD. 1/2" (MIN.) GYPSUM WALL BOARD IS TO BE INSTALLED ON BOTH SIDES OF THE BRACED WALL FASTENED WITH 1 1/4" SCREWS OR 1 5/8" NAILS SPACED 7" O.C. ALONG PANEL EDGES INCLUDING TOP AND BOTTOM PLATES AND INTERMEDIATE SUPPORTS (U.N.O.). VERIFY ALL FASTENER OPTIONS FOR 1/2" AND 5/8" GYPSUM PRIOR TO CONSTRUCTION. FOR INTERIOR FASTENER OPTIONS SEE TABLE R702.3.5. FOR EXTERIOR FASTENER OPTIONS SEE TABLE R602.3(1). EXTERIOR GB TO BE
- REQUIRED BRACED WALL LENGTH FOR EACH SIDE OF THE CIRCUMSCRIBED RECTANGLE ARE INTERPOLATED PER TABLE R602, 10.3, METHOD CS-WSP CONTRIBUTES ITS ACTUAL LENGTH, METHOD GB CONTRIBUTES .5 ITS ACTUAL LENGTH, AND METHOD PF CONTRIBUTES 1.5 TIMES ITS ACTUAL LENGTH.

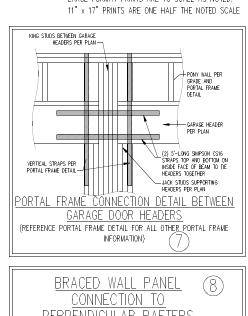


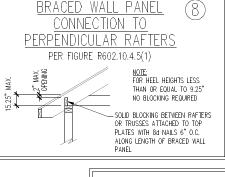


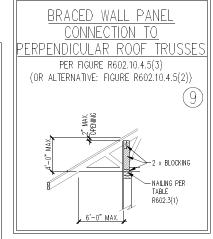














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D-3 WALL BRACING NOTES AND DETAILS

FULL HEIGHT BLOCKING @ 16" O.C. ALONG LENGTH OF BRACED WALL PANEL G.

9/10/202

LARGE FORMAT PRINTS ARE TO SCALE AS NOTED.

SCALE NOTE:

BRACED WALL PANEL CONNECTION WHEN PARALLEL TO FLOOR/CFILING FRAMING

(2) 16d NAILS EA. SIDE

PER FIG. R602.10.4.4(2) — ADDITIONAL FRAMING MEMBER - FULL HEIGHT BLOCKING @ 16" O.C. ALONG LENGTH OF DIRECTLY ABOVE BRACED WALL PANEL BRACED WALL PANEL - CONTINUOUS RIM OR BAND JOIST -8d NAILS @ 6" O.C. ALONG - TOE NAIL (3) 8d NAILS AT -8d NAILS @ 6" O.C. ALONG BRACED WALL PANEL EA BLOCKING MEMBER BRACED WALL PANEL - BRACED WALL PANEL -BRACED WALL PANEL -BRACED WALL PANEL -(3) 16d NAILS @ 16" O.C. AT EA. BLOCKING MEMBER

-{3} 16d NAILS @ 16" O.C. ALONG —(3) 16d NAILS @ 16" O.C. ALONG BRACED WALL PANEL BRACED WALL PANEL

CONTINUOUS RIM w/ FINGER

ADDITIONAL FRAMING MEMBER DIRECTLY BELOW BRACED

JOISTS OR DBL. BAND JOIST

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#### GENERAL NOTES

- ENGINEER'S SEAL APPLIES ONLY TO STRUCTURAL COMPONENTS INCLUDING ROOF RAFTERS, HIPS, VALLEYS, RIDGES, FLOORS, WALLS, BEAMS, HEADERS, COLUMNS, CANTILEVERS, OFFSET LOAD BEARING WALLS, PIERS, GIRDER SYSTEM AND FOOTING. ENGINEER'S SEAL DOES NOT CERTIFY DIMENSIONAL ACCURACY OF ARCHITECTURAL LAYOUT INCLUDING ROOF. ENGINEER'S SEAL DOES NOT APPLY TO I-JOIST OR FLOOR/ROOF TRUSS LAYOUT DESIGN AND ACCURACY.
- ALL CONSTRUCTION SHALL CONFORM TO THE LATEST REQUIREMENTS OF THE NORTH CAROLINA RESIDENTIAL CODE (NCRC), 2018 EDITION, PLUS ALL LOCAL CODES AND REGULATIONS. THE STRUCTURAL ENGINEER IS NOT RESPONSIBLE FOR, AND WILL NOT HAVE CONTROL OF, CONSTRUCTION MEANS, METHODS, TECHNIQUES, SEQUENCES OR PROCEDURES, OR SAFETY PRECAUTIONS AND PROGRAMS IN CONNECTION WITH THE CONSTRUCTION WORK. NOR WILL THE ENGINEER BE RESPONSIBLE FOR THE CONTRACTORS FAILURE TO CARRY OUT THE CONSTRUCTION WORK IN ACCORDANCE WITH THE CONTRACT DOCUMENTS.
- 3. STRUCTURAL DESIGN BASED ON THE PROVISIONS OF THE NCRC, 2018 EDITION (R301.4 R301.7)

DESIGN CRITERIA:	LIVE LOAD (PSF)	DEAD LOAD (PSF)	DEFLECTION (IN)	
ATTIC WITH LIMITED STORAGE	20	10	L/240 (L/360 w/ BRITTLE FINISHES)	
ATTIC WITHOUT STORAGE	10	10	L/360	
DECKS	40	10	L/360	
EXTERIOR BALCONIES	40	10	L/360	
FIRE ESCAPES	40	10	L/360	
HANDRAILS/GUARDRAILS	200 LB OR 50 (PLF)	10	L/360	
PASSENGER VEHICLE GARAGE	50	10	L/360	
ROOMS OTHER THAN SLEEPING ROOM	40	10	L/360	
SLEEPING ROOMS	30	10	L/360	
STAIRS	40	10	L/360	
WIND LOAD	(BASED ON TABLE R301.2(4) WIND ZONE AND EXPOSURE)			
GROUND SNOW LOAD: Pg	20 (PSF)			

- I-JOIST SYSTEMS DESIGNED WITH 12 PSF DEAD LOAD AND DEFLECTION (IN) OF L/480
- FLOOR TRUSS SYSTEMS DESIGNED WITH 15 PSF DEAD LOAD
- FOR 115 AND 120 MPH WIND ZONES, FOUNDATION ANCHORAGE IS TO COMPLY WITH SECTION R403.1.6 OF THE NCRC, 2018 EDITION. FOR 130 MPH, 140 MPH, AND 150 MPH WIND ZONES, FOUNDATION ANCHORAGE IS TO COMPLY WITH SECTION 4504 OF THE NCRC, 2018 EDITION.
- 5. ENERGY EFFICIENCY COMPLIANCE AND INSULATION VALUES OF THE BUILDING TO BE IN ACCORDANCE WITH CHAPTER 11 OF THE NCRC, 2018 EDITION.

#### FOOTING AND FOUNDATION NOTES

- 1. FOUNDATION DESIGN BASED ON A MINIMUM ALLOWABLE BEARING CAPACITY OF 2000 PSF. CONTACT GEOTECHNICAL ENGINEER IF BEARING CAPACITY IS NOT
- 2. FOR ALL CONCRETE SLABS AND FOOTINGS, THE AREA WITHIN THE PERIMETER OF THE BUILDING ENVELOPE SHALL HAVE ALL VEGETATION, TOP SOIL AND FOREIGN MATERIAL REMOVED. FILL MATERIAL SHALL BE FREE OF VEGETATION AND FOREIGN MATERIAL. THE FILL SHALL BE COMPACTED TO ASSURE UNIFORM SUPPORT OF THE SLAB, AND EXCEPT WHERE APPROVED, THE FILL DEPTHS SHALL NOT EXCEED 24" FOR CLEAN SAND OR GRAVEL. A 4" THICK BASED COURSE CONSISTING OF CLEAN GRADED SAND OR GRAVEL SHALL BE PLACED. A BASE COURSE IS NOT REQUIRED WHERE A CONCRETE SLAB IS INSTALLED ON WELL-DRAINED OR SAND-GRAVEL MIXTURE SOILS CLASSIFIED AS GROUP 1. ACCORDING TO THE UNITED SOIL CLASSIFICATION SYSTEM IN ACCORDANCE WITH TABLE R405.1 OF THE NCRC 2018 FDITION
- 3. PROPERLY DEWATER EXCAVATION PRIOR TO POURING CONCRETE WHEN BOTTOM OF CONCRETE SLAB IS AT OR BELOW WATER TABLE. IF APPLICABLE, 3/4" 1" DEEP CONTROL JOINTS ARE TO BE SAWED WITHIN 4 TO 12 HOURS OF CONCRETE FINISHING AND WALL LOCATIONS HAVE BEEN MARKED. ADJUST WHERE
- 4. CONCRETE SHALL CONFORM TO SECTION R402.2 OF THE NCRC, 2018 EDITION. CONCRETE REINFORCING STEEL TO BE ASTM A615 GRADE 60. WELDED WIRE FABRIC TO BE ASTM A185. MAINTAIN A MINIMUM CONCRETE COVER AROUND REINFORCING STEEL OF 3" IN FOOTINGS AND 1 1/2" IN SLABS. FOR POURED CONCRETE WALLS, CONCRETE COVER FOR REINFORCING STEEL MEASURED FROM THE INSIDE FACE OF THE WALL SHALL NOT BE LESS THAN 3/4". CONCRETE COVER FOR REINFORCING STEEL MEASURED FROM THE OUTSIDE FACE OF THE WALL SHALL NOT BE LESS THAN 1 1/2" FOR #5 BARS OR SMALLER, AND NOT LESS THAN 2" FOR #6 BARS OR LARGER.
- 5. MASONRY UNITS TO CONFORM TO ACE 530/ASCE 5/TMS 402. MORTAR SHALL CONFORM TO ASTM C270.
- 6. THE UNSUPPORTED HEIGHT OF MASONRY PIERS SHALL NOT EXCEED FOUR TIMES THEIR LEAST DIMENSION FOR UNFILLED HOLLOW CONCRETE MASONRY UNITS AND TEN TIMES THEIR LEAST DIMENSION FOR SOLID OR SOLID FILLED PIERS. PERS MAY BE FILLED SOLID WITH CONCRETE OR TYPE M OR S MORTAR. PIERS AND WALLS SHALL BE CAPPED WITH 8" OF SOLID MASONRY
- 7. THE CENTER OF EACH OF THE PIERS SHALL BEAR IN THE MIDDLE THIRD OF ITS RESPECTIVE FOOTING. EACH GIRDER SHALL BEAR IN THE MIDDLE THIRD OF THE
- 8. ALL CONCRETE AND MASONRY FOUNDATION WALLS ARE TO BE CONSTRUCTED IN ACCORDANCE WITH THE PROVISIONS OF SECTION R404 OF THE NCRC. 2018 EDITION OR IN ACCORDANCE WITH ACI 318, ACI 332, NCMA TR68-A OR ACE 530/ASCE 5/TMS 402. MASONRY FOUNDATION WALLS ARE TO BE REINFORCED PER TABLE R404.1.1(1), R404.1.1(2), R404.1.1(3), OR R404.1.1(4) OF THE NCRC, 2018 EDITION, CONCRETE FOUNDATION WALLS ARE TO BE REINFORCED PER TABLE R404.1.1(5) OF THE NCRC, 2018 EDITION. STEP CONCRETE FOUNDATION WALLS TO 2 x 6 FRAMED WALLS AT 16" O.C. WHERE GRADE PERMITS (UNO).

#### FRAMING NOTES

- 1. ALL FRAMING LUMBER SHALL BE #2 SPF MINIMUM (Fb = 875 PSI, Fv = 375 PSI, E = 1600000 PSI) UNLESS NOTED OTHERWISE (UNO). ALL TREATED LUMBER SHALL BE #2 SYP MINIMUM (Fb = 975 PSI, Fv =175 PSI, E = 1600000 PSI) UNLESS NOTED OTHERWISE (UNO).
- 2. LAMINATED VENEER LUMBER (LVL) SHALL HAVE THE FOLLOWING MINIMUM PROPERTIES: Fb =2600 PSI, Fv = 285 PSI, E = 1900000 PSI. LAMINATED STRAND LUMBER (LSL) SHALL HAVE THE FOLLOWING MINIMUM PROPERTIES: Fb = 2325 PSI, Fv = 310 PSI, E = 1550000 PSI. PARALLEL STRAND LUMBER (PSL) UP TO 7" DEPTH SHALL HAVE THE FOLLOWING MINIMUM PROPERTIES: Fc = 2500 PSI, E =1800000 PSI, PARALLEL STRAND LUMBER (PSL) MORE THAN 7" DEPTH SHALL HAVE THE FOLLOWING MINIMUM PROPERTIES: Fc = 2900 PSI, E = 2000000 PSI. INSTALL ALL CONNECTIONS PER MANUFACTURER'S SPECIFICATIONS.
- 3. STRUCTURAL STEEL SHALL CONFORM TO THE FOLLOWING ASTM SPECIFICATIONS

W AND WT SHAPES: ASTM A992 CHANNELS AND ANGLES: ASTM A36 PLATES AND BARS: ASTM A36 HOLLOW STRUCTURAL SECTIONS: ASTM A500 GRADE B

ASTM A53, GRADE B, TYPE E OR S STEEL PIPE:

4. STEEL BEAMS SHALL BE SUPPORTED AT EACH END WITH A MINIMUM BEARING LENGTH OF 3 1/2" AND FULL FLANGE WIDTH (UNO). PROVIDE SOLID BEARING FROM BEAM SUPPORT TO FOUNDATION. BEAMS SHALL BE ATTACHED AT THE BOTTOM FLANGE TO EACH SUPPORT AS FOLLOWS (UNO):

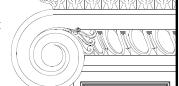
(2) 1/2" DIA. x 4" LONG LAG SCREWS A. WOOD FRAMING (2) 1/2" DIA. x 4" WEDGE ANCHORS (2) 1/2" DIA. x 4" LONG SIMPSON TITEN HD ANCHORS C. MASONRY (FULLY GROUTED)

LATERAL SUPPORT IS CONSIDERED ADEQUATE PROVIDING THE JOISTS ARE TOE NAILED TO THE 2x NAILER ON TOP OF THE STEEL BEAM, AND THE 2x NAILER IS SECURED TO THE TOP OF THE STEEL BEAM w/ (2) ROWS OF SELF TAPPING SCREWS @ 16" O.C. OR (2) ROWS OF 1/2" DIAMETER BOLTS @ 16" O.C. IF 1/2" BOLTS ARE USED TO FASTEN THE NAILER, THE STEEL BEAM SHALL BE FABRICATED w/ (2) ROWS OF 9/16" DIAMETER HOLES @ 16" O.C.

- 5. SQUARES DENOTE POINT LOADS WHICH REQUIRE SOLID BLOCKING TO GIRDER OR FOUNDATION, SHADED SQUARES DENOTE POINT LOADS FROM ABOVE WHICH REQUIRE SOLID BLOCKING TO SUPPORTING MEMBER BELOW.
- 6. ALL LOAD BEARING HEADERS TO CONFORM TO TABLE R602.7(1) AND R602.7(2) OF THE NCRC, 2018 EDITION OR BE (2) 2 x 6 WITH (1) JACK AND (1) KING STUD EACH END (UNO), WHICHEVER IS GREATER ALL HEADERS TO BE SECURED TO EACH JACK STUD WITH (4) 8d NAILS. ALL BEAMS TO BE SUPPORTED WITH (2) STUDS AT EACH BEARING POINT (UNO). INSTALL KING STUDS PER SECTION R602.7.5 OF THE NORTH CAROLINA RESIDENTIAL CODE, 2018 EDITION.
- 7. ALL BEAMS, HEADERS, OR GIRDER TRUSSES PARALLEL TO WALL ARE TO BEAR FULLY ON (1) JACK OR (2) STUDS MINIMUM OR THE NUMBER OF JACKS OR STUDS NOTED. ALL BEAMS OR GIRDER TRUSSES PERPENDICULAR TO WALL AND SUPPORTED BY (3) STUDS OR LESS ARE TO HAVE 1 1/2" MINIMUM BEARING (UNO). ALL BEAMS OR GIRDER TRUSSES PERPENDICULAR TO WALL AND SUPPORTED BY MORE THAN (3) STUDS OR OTHER NOTED COLUMN ARE TO BEAR FULLY ON SUPPORT COLUMN FOR ENTIRE WALL DEPTH (UNO). BEAM ENDS THAT BUTT INTO ONE ANOTHER ARE TO EACH BEAR EQUAL LENGTHS (UNO).
- 8. FLITCH BEAMS SHALL BE BOLTED TOGETHER USING 1/2" DIAMETER BOLTS (ASTM A307) WITH WASHERS PLACED AT THREADED END OF BOLT. BOLTS SHALL BE SPACED AT 24" CENTERS (MAXIMUM), AND STAGGERED AT TOP AND BOTTOM OF BEAM (2" EDGE DISTANCE), WITH (2) BOLTS LOCATED AT 6" FROM EACH END
- 9. ALL I-JOIST OR TRUSS LAYOUTS ARE TO BE IN COMPLIANCE WITH THE OVERALL DESIGN SPECIFIED ON THE PLANS. ALL DEVIATIONS ARE TO BE BROUGHT TO THE ATTENTION OF THE ENGINEER OF RECORD PRIOR TO INSTALLATION.
- 10. BRACED WALL PANELS SHALL BE CONSTRUCTED ACCORDING TO THE NORTH CAROLINA RESIDENTIAL CODE 2018 EDITION WALL BRACING CRITERIA. THE AMOUNT, LENGTH, AND LOCATION OF BRACING SHALL COMPLY WITH ALL APPLICABLE TABLES IN SECTION R602.10.
- 11. PROVIDE DOUBLE JOIST UNDER ALL WALLS PARALLEL TO FLOOR JOISTS. PROVIDE SUPPORT UNDER ALL WALLS PARALLEL TO FLOOR TRUSSES OR I-JOISTS PER MANUFACTURER'S SPECIFICATIONS. INSTALL BLOCKING BETWEEN JOISTS OR TRUSSES FOR POINT LOAD SUPPORT FOR ALL POINT LOADS ALONG OFFSET LOAD
- 12. FOR ALL HEADERS SUPPORTING BRICK VENEER THAT ARE LESS THAN 8'-0" IN LENGTH, REST A 6" x 4" x 5/16" STEEL ANGLE WITH 6" MINIMUM EMBEDMENT AT SIDES FOR BRICK SUPPORT (U.N.O). FOR ALL HEADERS 8'-0" AND GREATER IN LENGTH, BOLT A 6" x 4" x 5/16" STEEL ANGLE TO HEADER WITH 1/2" LAG SCREWS AT 12" O.C. STAGGERED FOR BRICK SUPPORT. FOR ALL BRICK SUPPORT AT ROOF LINES, BOLT A 6" x 4" x 5/16" STEEL ANGLE TO (2) 2 x 10 BLOCKING INSTALLED w/ (4) 12d NAILS EA. PLY BETWEEN WALL STUDS WITH (2) ROWS OF 1/2" LAG SCREWS AT 12" O.C. STAGGERED AND IN ACCORDANCE WITH SECTION R703.8.2.1 OF THE NCRC, 2018 EDITION.
- 13. FOR STICK FRAMED ROOFS: CIRCLES DENOTE (3) 2 x 4 POSTS FOR ROOF MEMBER SUPPORT. HIP SPLICES ARE TO BE SPACED A MINIMUM OF 8'-0". FASTEN MEMBERS WITH THREE ROWS OF 12d NAILS AT 16" O.C. FRAME DORMER WALLS ON TOP OF DOUBLE OR TRIPLE RAFTERS AS SHOWN (UNO).
- 14. FOR TRUSSED ROOFS: FRAME DORMER WALLS ON TOP OF 2 x 4 LADDER FRAMING AT 24" O.C. BETWEEN ADJACENT ROOF TRUSSES. STICK FRAME OVER-FRAMED ROOF SECTIONS WITH 2 x 8 RIDGES, 2 x 6 RAFTERS AT 16" O.C. AND FLAT 2 x 10 VALLEYS (UNO).
- 15. ALL 4 x 4 AND 6 x 6 POSTS TO BE INSTALLED WITH 700 LB CAPACITY UPLIFT CONNECTORS TOP AND BOTTOM (UNO.) POSTS MAY BE SECURED USING ONE SIMPSON H6 OR LTS12 UPLIFT CONNECTOR FASTENED TO THE BAND AT THE BOTTOM AND THE BEAM AT THE TOP OF EACH POST. ONE 16" SECTION OF SIMPSON CS16 COIL STRAPPING WITH (8) 8d HDG NAILS AT EACH END MAY BE USED IN LIEU OF EACH TWIST STRAP IF DESIRED. FOR MASONRY OR CONCRETE FOUNDATION USE SIMPSON POST BASE.

SCALE NOTE:

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