GENERAL NOTES:

- 1. IT IS THE CONTRACTORS RESPONSIBILITY TO VERIFY THAT ALL DIMENSIONS, ROOF PITCHES, AND SQUARE FOOTAGE ARE CORRECT PRIOR TO CONSTRUCTION. K&A HOME DESIGNS, INC. IS NOT RESPONSIBLE FOR ANY DIMENSIONING, ROOF PITCH, OR SQUARE FOOTAGE ERRORS ONCE CONSTRUCTION BEGINS.
- 2. ALL WALLS SHOWN ON THE FLOOR PLANS ARE DRAWN AT 4" UNLESS NOTED OTHERWISE.
- 3. ALL ANGLED WALL SHOWN ON THE PLANS ARE 45 DEGREES UNLESS NOTED OTHERWISE.
- 4. STUD WALL DESIGN SHALL CONFORM TO ALL NORTH CAROLINA STATE BUILDING CODE REQUIREMENTS.
- 5. DO NOT SCALE PLANS. DRAWING SCALE MAY BE DISTORTED DUE TO COPIER IMPERFECTIONS.
- 6. ALL CONSTRUCTION SHALL BE IN ACCORDANCE WITH NORTH CAROLINA STATE BUILDING CODE, 2018 EDITION.

SQUARE FOOTAGE

HEATED SQUARE FOOTAGE		OTAGE	UNHEATED SQUARE FOOTAGE		
	FIRST FLOOR=	1414	GARAGE =		N/A
	SECOND FLOOR=	N/A	FRONT PORC	H=	92
	THIRD FLOOR=	N/A	SCREEN PORC	H=	N/A
	BASEMENT=	N/A	DECK =		N/A
			STORAGE=	=	N/A

TOTALHEATED = 1414TOTAL UNHEATED = 92

CRAWL SPACE VENTILATION CALCULATIONS

-VENT LOCATIONS MAY VARY FROM THOSE SHOWN ON THE PLAN BUT SHOULD BE PLACED TO PROVIDE ADEQUATE VENTILATION AT ALL POINTS TO PREVENT DEAD AIR POCKETS.

-100% VAPOR BARRIER MUST BE PROVIDED WITH 12" MIN. LAP JOINTS.

-THE TOTAL AREA OF VENTILATION OPENINGS MAY BE REDUCED TO 1/1500AS LONG AS REQUIRED OPENINGS ARE PLACED SO AS TO PROVIDE CROSS-VENTILATION OF THE SPACE. THE INSTALLATION OF OPERABLE LOUVERS SHALL NOT BE PROHIBITED. (COMPLY WITH NC CODE MIN. WITH REGARD TO VENT PLACEMENT FROM CORNERS)

1414 SQ. FT. OF CRAWL SPACE/1500

SQ. FT. OF REQUIRED VENTILATION

VENTS AT 0.45 SQ. FT. NET FREE PROVIDED BY: 3 VENTILATION EACH= 1.35 SQ. FT. OF VENTILATION

**FOUNDATION DRAINAGE- WATERPROOFING PER SECTIONS 405 & 406.

ATTIC VENTILATION CALCULATIONS

- CALCULATIONS SHOWN BELOW ARE BASED ON VENTILATORS USED AT LEAST 3 FT. ABOVE THE CORNICE VENTS WITH THE BALANCE OF VENTIALTION PROVIDED BE EAVE VENTS.
- CATHEDRAL CEILINGS SHALL HAVE A MIN. 1" CLEARANCE BETWEEN THE BOTTOM OF THE ROOF DECK AND THE INSULATION.

SQ. FT. OF ATTIC/300= EACH OF INLET AND OUTLET REQUIRED.

*WALL AND ROOF CLADDING DESIGN VALUES

- WALL CLADDING IS DESIGNED FOR A 24.1 SQ. FT. OR GREATER POSITIVE AND NEGATIVE PRESSURE.
- ROOF VALUES BOTH POSITVE AND NEGATIVE SHALL BE AS FOLLOWS:

 $45.5\,LBS.$ PER SQ. FT. FOR ROOF PITCHES OF 0/12 TO 2.25/12

 $34.8\,LBS.$ PER SQ. FT. FOR ROOF PITCHES OF 2.25/12 TO 7/12


21 LBS. PER SQ. FT. FOR ROOF PITCHES OF 7/12 TO 12/12


** MEAN ROOF HEIGHT 30' OR LESS




FRONT ELEVATION

1/4" = 1'-0"

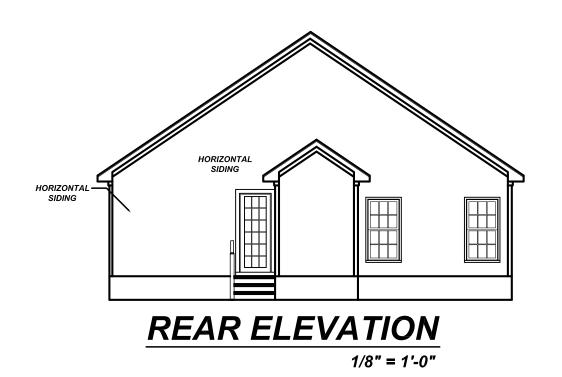

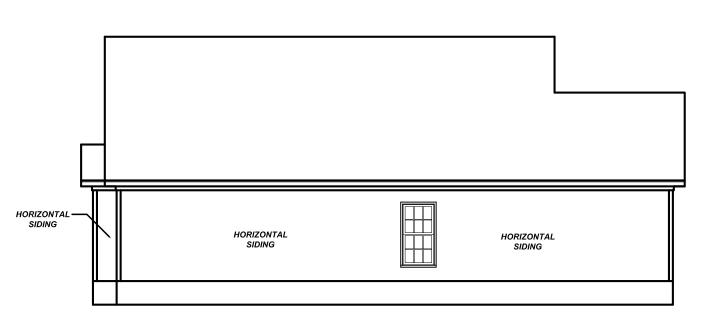



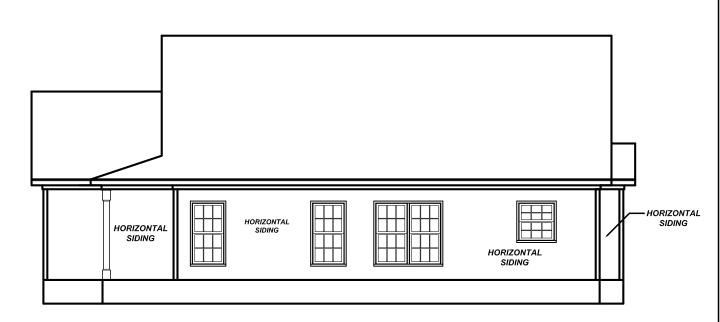

RIGHT ELEVATION

19-047 1-27-21 KBB REFER TO ELEV.

Remarks

9101 Ten-Ter Raleigh, NC 2 Office: (919) (

KMB Building, LLC 5609 Stewart Rd. Raleigh, NC 27603

ELEVATIONS

Sheet Number

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SECOND FLOOR=	N/A	FRONT PORCH=	92	
THIRD FLOOR=	N/A	SCREEN PORCH=	N/A	
BASEMENT=	N/A	DECK =	N/A	
		STORAGE =	N/A	

TOTAL HEATED = 1414 TOTAL UNHEATED = 92

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1414 SQ. FT. OF CRAWL SPACE/1500

.94 SQ. FT. OF REQUIRED VENTILATION

PROVIDED BY: 3 VENTS AT 0.45 SQ. FT. NET FREE

VENTILATION EACH= 1.35 SQ. FT. OF VENTILATION

**FOUNDATION DRAINAGE- WATERPROOFING PER SECTIONS 405 & 406.

ATTIC VENTILATION CALCULATIONS

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- CATHEDRAL CEILINGS SHALL HAVE A MIN. 1" CLEARANCE BETWEEN THE BOTTOM OF THE ROOF DECK AND THE INSULATION.

1522 SQ. FT. OF ATTIC/300= 5.07 EACH OF INLET AND OUTLET REQUIRED.

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34.8 LBS. PER SQ. FT. FOR ROOF PITCHES OF 2.25/12 TO 7/12


21 LBS. PER SQ. FT. FOR ROOF PITCHES OF 7/12 TO 12/12


** MEAN ROOF HEIGHT 30' OR LESS




FRONT ELEVATION 'B'

1/4" = 1'-0"

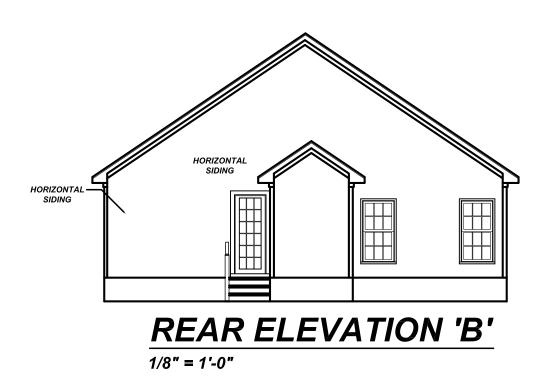

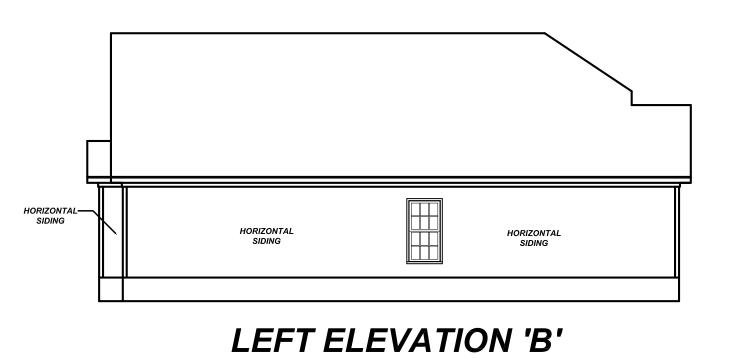

1/8" = 1'-0"

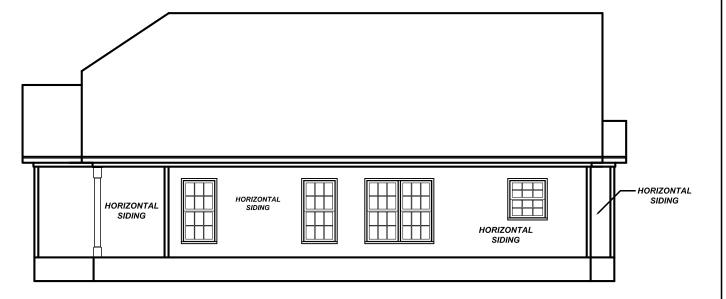

RIGHT ELEVATION 'B'

1/8" = 1'-0"

Project#:
19-047

Date:
1-27-21

Drawn/Design By:
KBB

Scale:
REFER TO ELEV.

9101 Ten-Ten Rd. Raleigh, NC 27603 Office: (919) 302-069

EAHOME DESIGNIA

The Cedar

KMB Building, LLC 5609 Stewart Rd. Raleigh, NC 27603

ELEVATIONS

Sheet Number

1

of 4

<u>Project#:</u> 19-047

Date: 1-27-21

Drawn/Design By:

Scale: 1/4" = 1'-0"


REVISIONS No. Date: Remarks



KMB Building, LLC 5609 Stewart Rd. Raleigh, NC 27603

FOUNDATION

Sheet Number

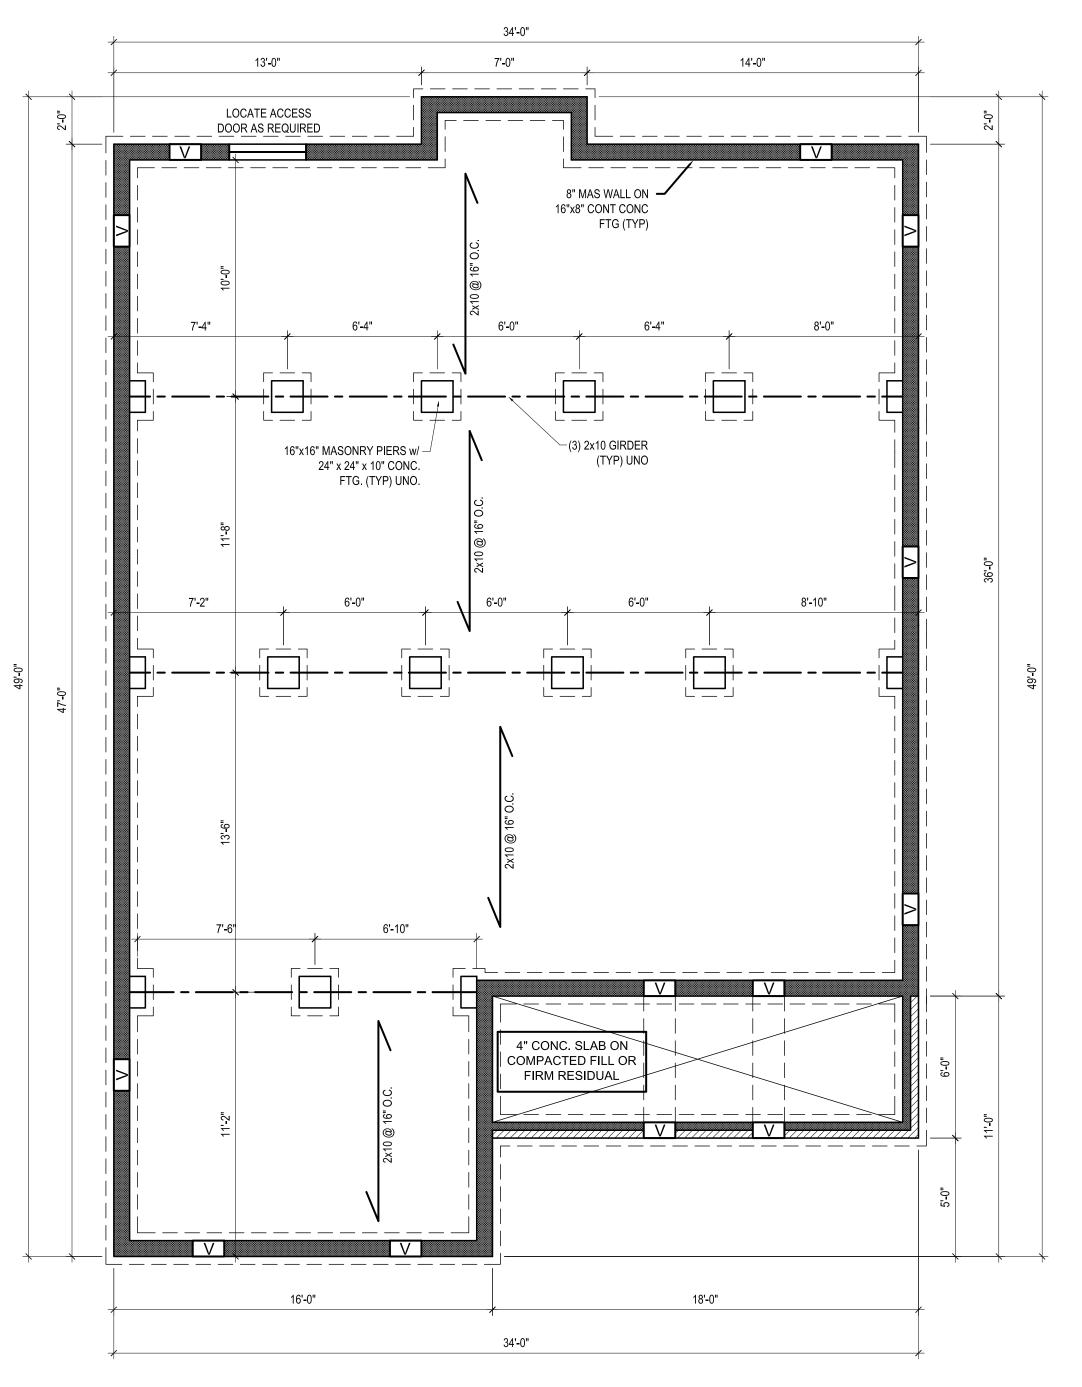

FOUNDATION PLAN

1/4" = 1'-0"

Structural Engineering by: Mark E. Jones, PE 6425 Glen Dean Court

O32702
2-16-22
2-16-22
2-NGINEER E JOHENNING

Raleigh, NC 27603 Phone: (919) 395-5618

*Engineers seal applies only to structural components on this document. Seal does not include construction means, methods, techniques, sequences, procures or safety precautions. *Any deviations or discrepancies on plans are to be brought to the immediate attention of Mark E. Jones, PE. Failure to do so will void Mark E. Jones, PE liability. Structural analysis based on 2018 North Carolina Residential Code.

Project No. 21-144

<u>Project #:</u> 19**-**047

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FIRST FLOOR

Sheet Number

include construction means, methods, techniques, sequences, procures or safety precautions. *Any deviations or discrepancies on plans are to be brought to the immediate attention of Mark E. Jones, PE. Failure to do so will void Mark E. Jones, PE liability. Structural analysis based on 2018 North Carolina Residential Code.

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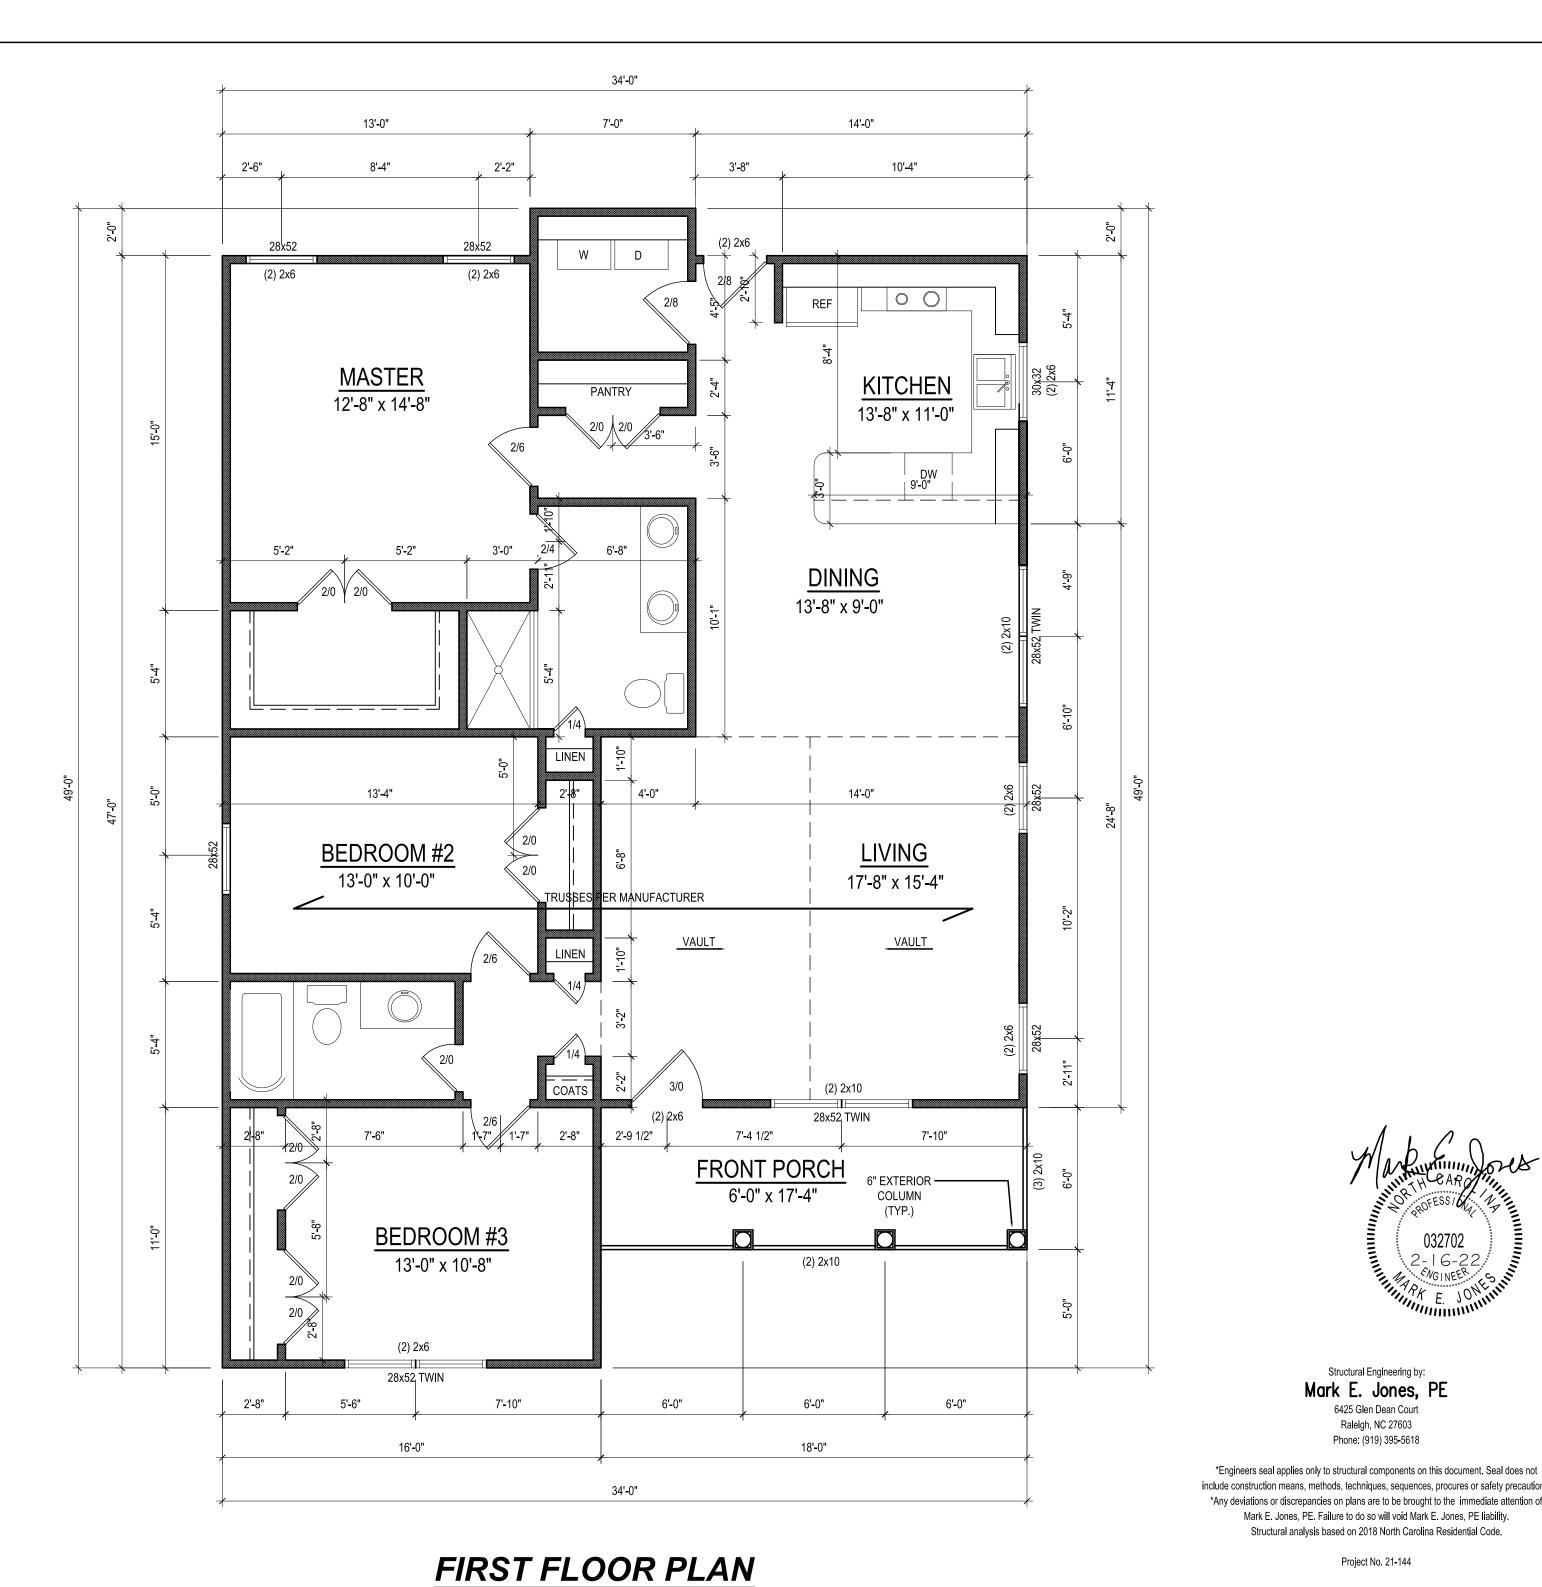
Structural Engineering by:

Mark E. Jones, PE


6425 Glen Dean Court Raleigh, NC 27603 Phone: (919) 395-5618

Project No. 21-144

3



CEILING HT. = 9'-0"

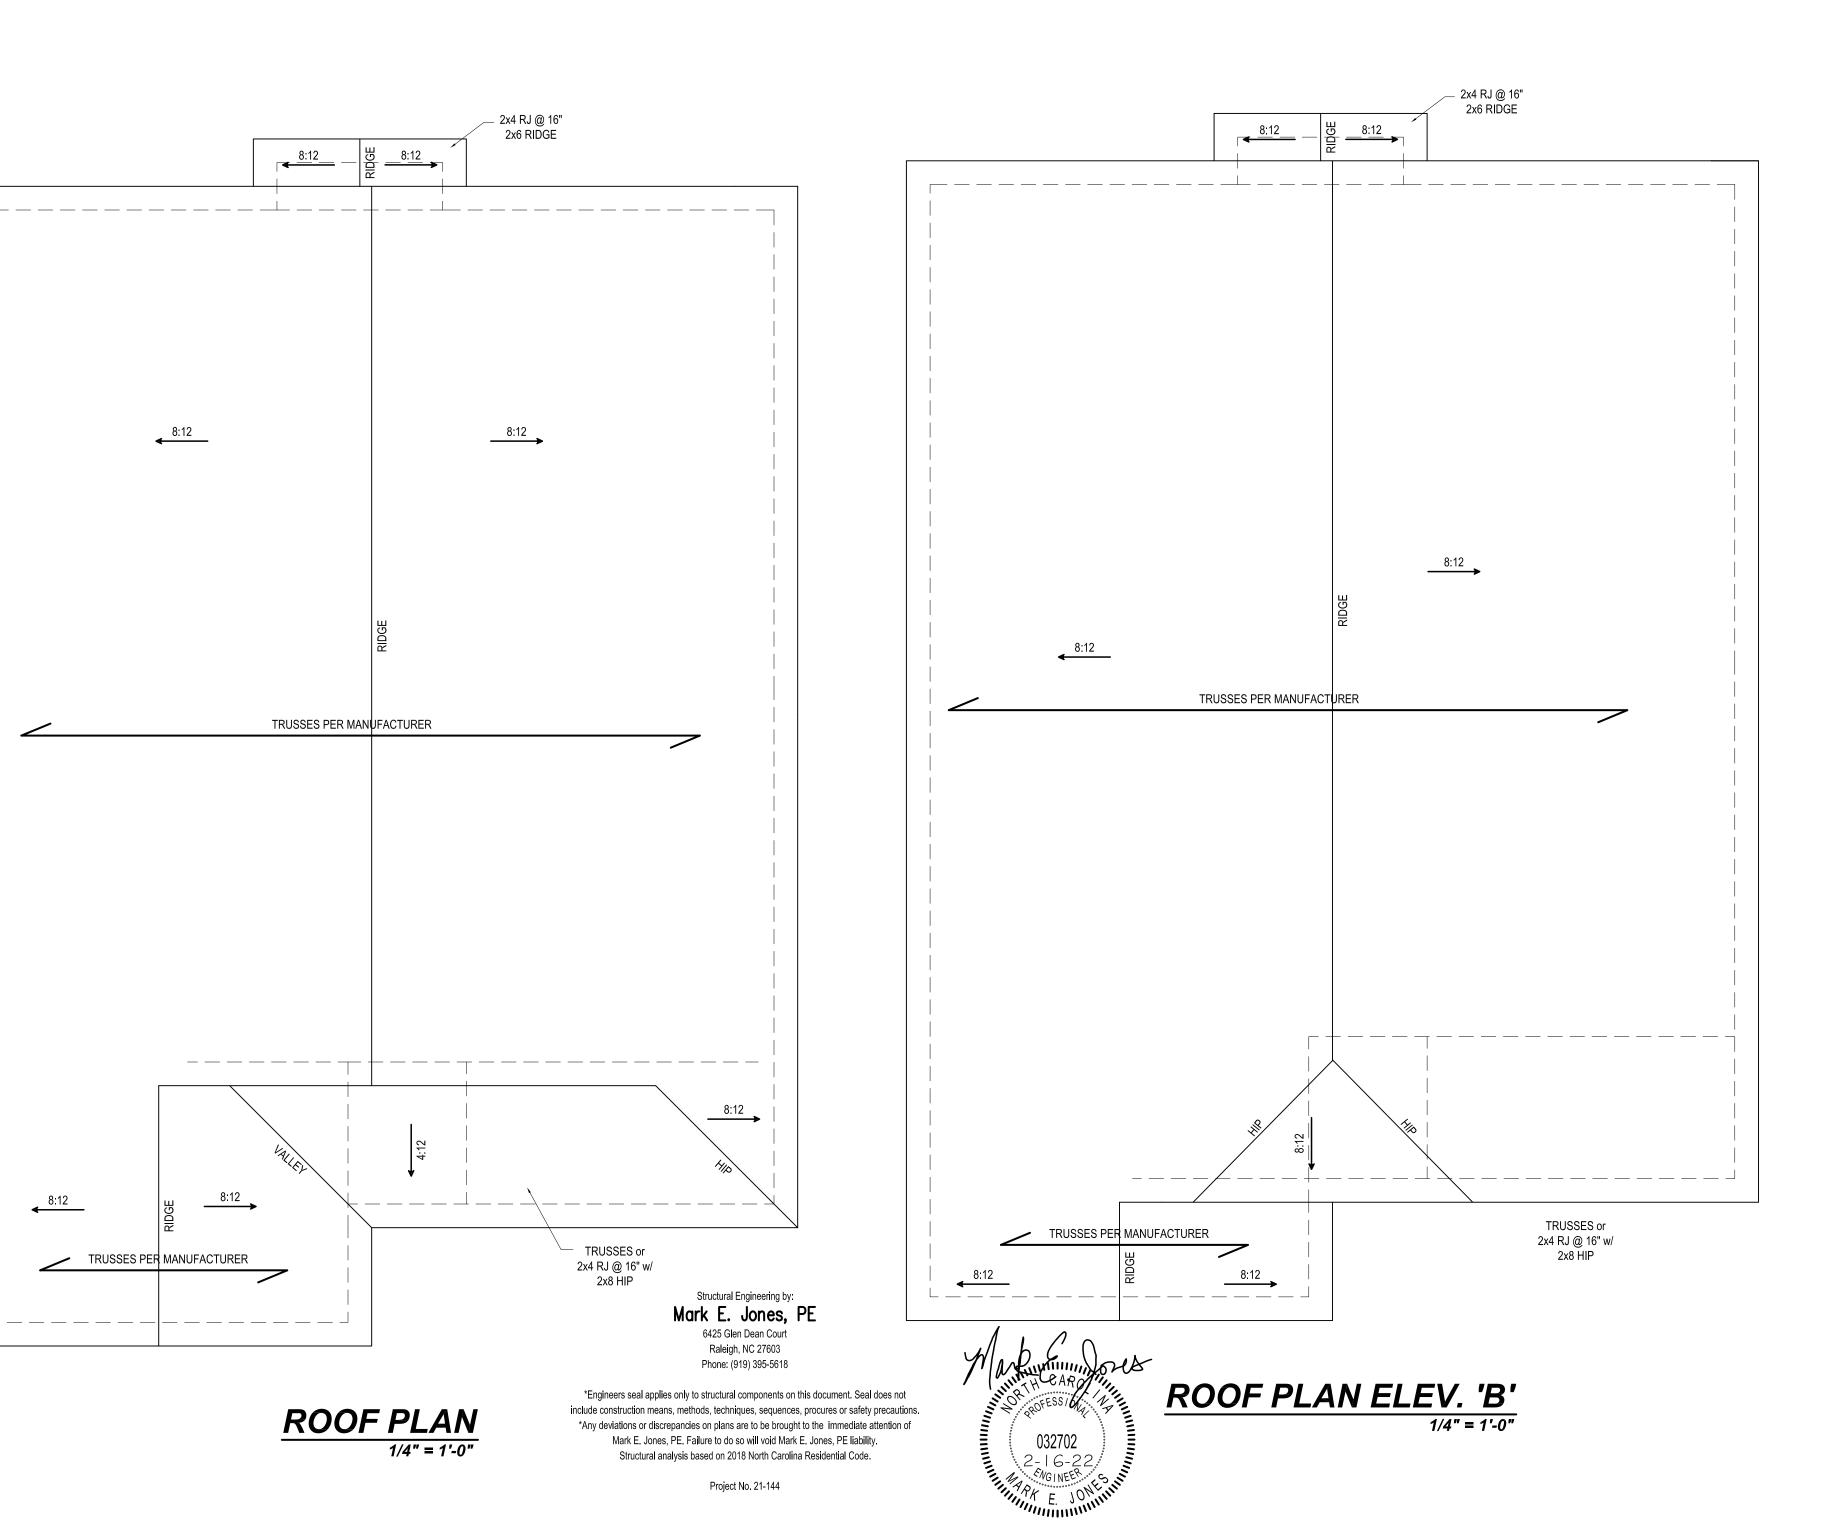

<u>Project #:</u> 19-047 Date: 1-27-21 Drawn/Design By:

KBB

Scale:

1/4" = 1'-0"

	REVISIONS			
<u>No.</u>	Date:	Remarks		
1				
2				
3				
4				
-400				

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Website: www.KandAHomeDesigns.com

The Cedar (Master Left)

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ROOF LAYOUT

Sheet Number