
Harnett County Department of Public Health

Improvement Permit

PROPERTY LOCATION: SR-1111 Marks RD	
ISSUED TO: SANLEE ENVIRONMENTAL LCC SUBDIVISION MARKS ZOAD LOT	# /
/	
Type of Structure: Proposed Wastewater System Type: 25% NGDUCTUN (Accepted)	
Projected Daily Flow: 480 GPD ———————————————————————————————————	
Number of bedrooms:	
Basement Tres No	
Pump Required: Yes No May be required based on final location and elevations of facilities	
Type of Water Supply: Community Public Well Distance from well feet Permit valid for:	ears
Possit conditions:	piration
LSS UPTIONS	
Authorized State Agent: Date: 3-2-2Z SEE ATTACHED SITE SK	
The issuance of this permit by the Health Department in no way guarantees the issuance of other permits. The permit holder is responsible for checking with appropriate governing bodies in meeting their requires is the subject to revocation if the site plan, plat, or the intended use changes. The Improvement Permit shall not be affected by a change in ownership of the site. This permit is subject to compliance with the site plan, plat, or the intended use changes.	quirements. This
the Laws and Rules for Sewage Treatment and Disposal and to conditions of this permit.	inc provision of
Construction Authorization	
(Required for Building Permit)	
The construction and installation requirements of Rules .1950, .1952, .1954, .1955, .1956, .1957, .1958 and .1959 are incorporated by references into this permit and shall be met. Systems shall be installed	in accordance
with the attached system layout.	
ISSUED TO: SANGE EN SCION MENTAL LLC PROPERTY LOCATION: ST. 1111 MARKS TO LOT #	4 /
Basement? Yes No Basement Fixtures? Yes No	CDD
Type of Wastewater System** 25% REDUCTUS (Accepted) Infollows Over 4 (Initial) Wastewater Flow: 480	GPD
(See note below, if applicable)	
1500 BOURTON (Aug ked) Intellepainter Drack-4	
Installation Requirements/Conditions Number of trenches	
Septic Tank Size 1000 gallons Exact length of each trench 200 feet Trench Spacing: Feet on Cen	iter
Pump Tank Sizegallons	
Maximum Trench Depth of:inches (Maximum soil cover shall not exceed	
(Trench bottoms shall be level to +/-1/4" 36" above the trench bottom)	
in all directions)	
Pump Requirements:ft. TDH vsGPMinches	below pipe
Aggregate Depth: inche:	s above pipe
Conditions: (LSS OPTION) Follow CAYOUT PROVIDED 12	inches total
Conditions: (LSS OPTION) Follow LAyort Provided Aggregate Depth: 2 inches	
WATER LINES (INCLUDING IRRIGATION) MUST BE 10FT. FROM ANY PART OF SEPTIC SYSTEM OR REPAIR AREA.	
NO UTILITIES ALLOWED IN INITIAL OR REPAIR DRAIN FIELD AREA.	
** If applicable: I understand the system type specified is different from the type specified on the application. I accept the specifications of this permit.	
Owner/Legal Representative Signature: Date:	
This Construction Authorization is subject to revocation if the site plan, plat, or the intended use changes. The Construction Authorization shall not be transferred when there is a change in ownership of the site of the construction Authorization is subject to compliance with the provisions of the laws and Rules for Sewage Treatment and Disposal and to the conditions of this permit.	
Construction Authorization is subject to compliance with the provisions of the Laws and Rules for Sewage Treatment and Disposal and to the conditions of this permit.	IL SKEICH
Authorized State Agent: Date: 3-2-22 Construction Authorization Expiration Date: 3-2-27	
Authorized State Agent: Date: Date:	
Construction Authorization Expiration Date: 3-2-27	

Harnett County Department of Public Health Site Sketch

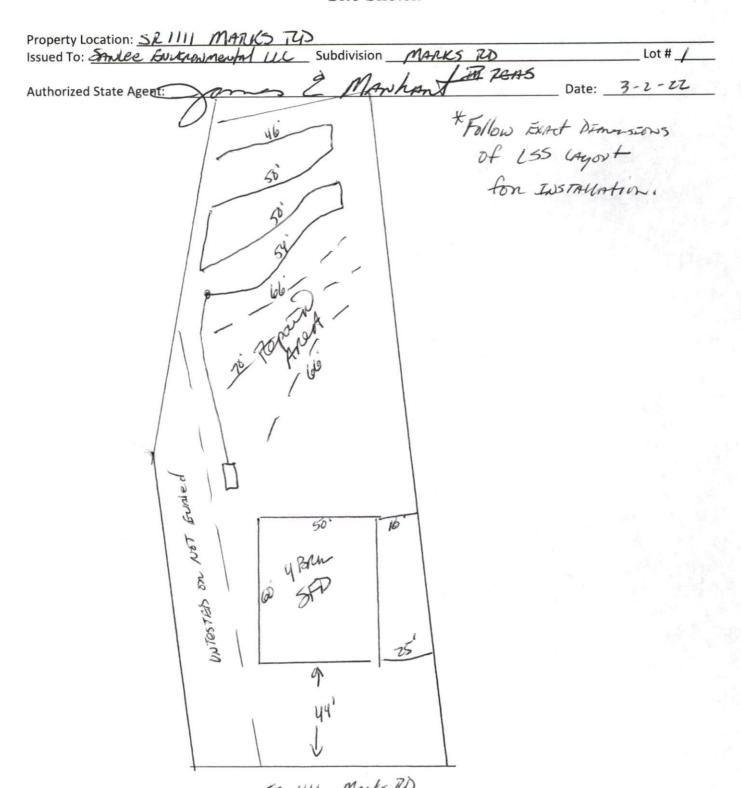

This drawing is for illustrative purposes only. System installation must meet all pertinent laws, rules, and regulations.



SL2018-114 Submission Package

Marks Road Lot 1 Cameron, NC Harnett County

Prepared For:

Carlos Llamas, Owner

Prepared By:

Sloan Griffin, SanLee Environmental, LLC

Report Date:

January 2, 2022

"The LSS Evaluation attached to this application is to be used to produce design and construction features for permitting in accordance with SL 2018-114 11.(c)."

Sloan Griffin, Legal Representative

"This LSS Evaluation is being submitted pursuant to and meets the requirements of SL 2018-114 section 11.(c)."

Sloan Griffin, LSS #1333

SanLee Environmental, LLC

Project: Ma								Date:	
Address: TB				‡	TBD		Water	Source:	Public
				Daily Flow:					Domestic
			- to g	_					
				Initi	ial Syste	<u>em</u>			
LTAR:	0.6		Tre	nch Width: _	3		Trencl	n Depth:	30"
lin. ft of Drair	nfield:	267	7			Adjus	ted ft of Dr	ainfield:	200
Septic Tank	Size:	100	0	Gallons		Pump Ta	nk Size:	NA	Gallon
istribution Me	ethod:	Seri	al	_	Specified	Product:	Infiltrat	tor Quick4 Pl	us Standard
									NIA
) Stub plumbi) Maintain all) Property Lir) Owner is res	applicables/corner	allow, else e setbacks s shall be for mainta	a pump s to septic clearly ma	system may be system comp arked prior to gging identify:	Notes e required conents o system insta	llation soil area and	d componen		NA
Pretre) Stub plumbi) Maintain all) Property Lir) Owner is res) Unapproved) Keep constr	ng out sha applicabl es/corner sponsible grading,	allow, else e setbacks s shall be for mainta filling, or	a pump s to septic clearly ma ining flag compaction	system may be system comparked prior to gging identify on of approvent off of appr	Notes e required conents o system insta ing approved ed soil may re	llation soil area and esult in perm ea during all	d componen	nt location	NA
) Stub plumbi) Maintain all) Property Lir) Owner is res) Unapproved	ng out sha applicabl nes/corner sponsible grading, uction ma	allow, else e setbacks s shall be for mainta filling, or terials and	a pump s to septic clearly ma ining flag compaction I equipme	system may be system comparked prior to gging identify on of approvent off of appr	Notes e required conents o system insta ing approved ed soil may re roved soils are	llation soil area and esult in perm ea during all	d component it revocation phases of c	nt location n construction	
) Stub plumbi) Maintain all) Property Lir) Owner is res) Unapproved) Keep constr	ng out sha applicabl nes/corner sponsible grading, uction ma	allow, else e setbacks s shall be for mainta filling, or terials and	a pump s to septic clearly ma ining flag compaction I equipme	system may be system comparked prior to gging identify on of approvent off of approvent of approvent off of approvent off of approvent off of approvent of approvent off of approvent off of approvent of approvent of approvent off of approvent of approvent of approvent of approvent off of approvent of approve	Notes e required conents o system insta ing approved ed soil may re roved soils are	llation soil area and esult in perm ea during all	d component it revocation phases of c	nt location n construction	29"
) Stub plumbi) Maintain all) Property Lir) Owner is res) Unapproved) Keep constr	ng out sha applicable nes/corner sponsible grading, uction ma	allow, else e setbacks s shall be for mainta filling, or terials and	a pump s s to septic clearly ma ining flag compaction I equipme	system may be system comparked prior to gging identify on of approvent off of approxent off width: Repart Callons	Notes e required conents o system insta ing approved ed soil may re roved soils are	llation soil area and esult in permea during all	d component it revocation phases of contract Trench ted ft of Dra	nt location n construction n Depth:	29"
) Stub plumbi) Maintain all) Property Lir) Owner is res) Unapproved) Keep constru	ng out sha applicable nes/corner sponsible grading, uction ma	allow, else e setbacks s shall be for mainta filling, or terials and	a pump s s to septic clearly ma ining flag compaction I equipme	system may be system comparked prior to gging identify on of approvent off of approxent off width: Repart Callons	Notes e required conents o system insta ing approved ed soil may re roved soils are	llation soil area and esult in perm ea during all em Adjus Pump Tar	d component revocation phases of control of the con	nt location n construction n Depth: ainfield:	29" 200


1) A pump system may not be necessary if gravity fall can be maintained

SanLee Environmental, LLC

Project: Ma	arks Road Subdivisi	on - Lot 1		Date:	12/20/2021	
Address: TB	D Marks Road, Ca	meron, NC				
County:	Harnett	PIN#	TBD	Water Source:	Public	

Layout

Line #	Flag Color	Elevation	Line Length	Primary System	Repair System
Septic Tank					
Line 1	Red		72		66
Line 2	Pink		74		70
Line 3	Purple		69		66
Line 4	Yellow		70	54	
Line 5	White		68	50	
Line 6	Green		56	50	
Line 7	Red		49	46	
			458	200	202

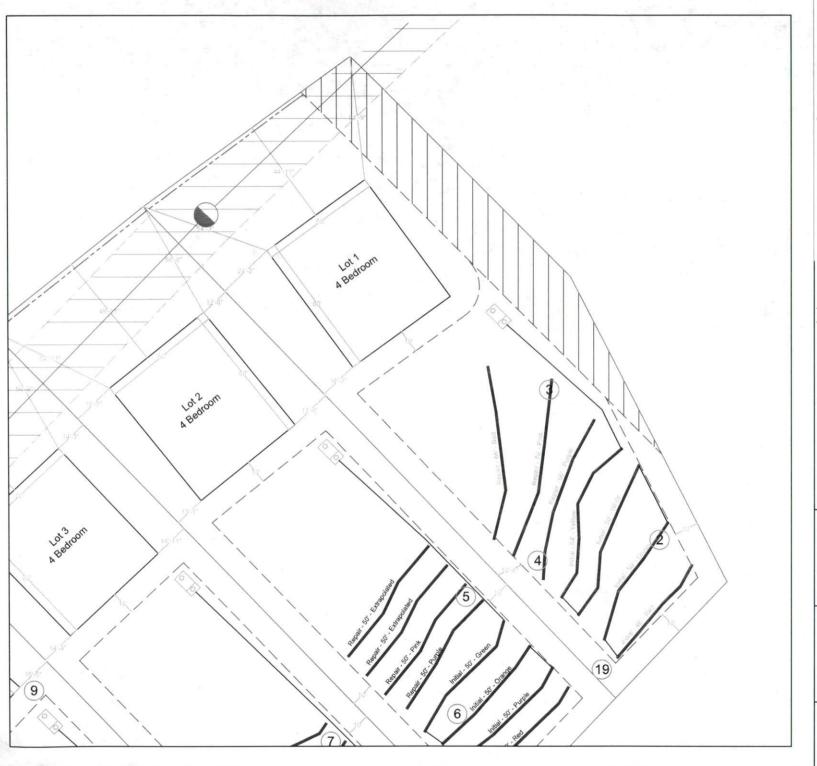



SanLee Environmental, LLC 919-842-6263


Project:
Marks Road
Subdivision
Lot 1

Date:
December 21, 2021

Drawn By: Sloan Griffin

1'' = 40'



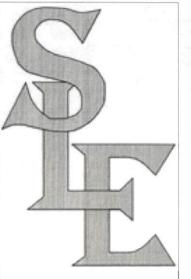


SanLee Environmental, LLC 919-842-6263

Project:
Marks Road
Subdivision
Lot 1

Date: December 21, 2021

Drawn By: Sloan Griffin

1'' = 30'

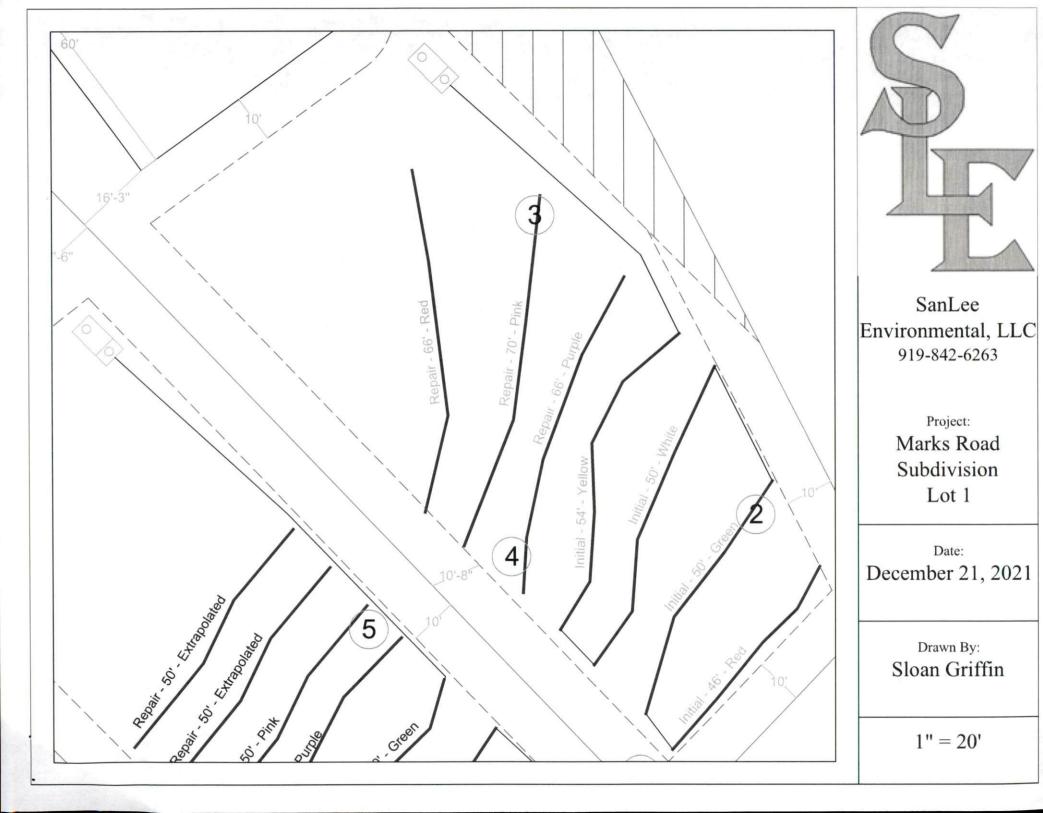

Name	Horizon 1	Horizon 2	Horizon 3	Horizon 4
WPT 19	0-14 l gr fr nsnp sexp	14-37 sl gr fr nsnp sexp	37-48 scl wsbk fr sssp sexp	
WPT 18	0-8 l gr fr nsnp sexp	8-48 sl gr fr nsnp sexp	то т	
WPT 17		7-48 LS gr fr nsnp sexp		
	0-14 l gr fr nsnp sexp	14-48 sl gr fr nsnp sexp		
	0-11 l gr fr nsnp sexp	11-48 sl gr fr nsnp sexp		
	0-10 l gr fr nsnp sexp	10-48 sl gr fr nsnp sexp		
	0-13 l gr fr nsnp sexp	13-48 sl gr fr nsnp sexp		
	0-9 l gr fr nsnp sexp	9-48 LS gr vfr nsnp sexp		
WPT 10	0-6 l gr fr nsnp sexp	6-48 sl gr fr nsnp sexp		
WPT 9	0-11 l gr fr nsnp sexp	11-35 LS gr fr nsnp sexp	35-48 sl gr fr nsnp sexp	
WPT 8	0-12 l gr fr nsnp sexp	12-48 sl gr fr nsnp sexp	response database services est trade address to the processor to	
WPT 7	0-13 l gr fr nsnp sexp	13-48 sl gr fr nsnp sexp		
WPT 6	0-8 l gr fr nsnp sexp	8-44 sl gr fr nsnp sexp	44-48 scl wsbk fr sssp sexp	
WPT 5	0-9 l gr fr nsnp sexp	9-48 sl gr fr nsnp sexp		
WPT 4	0-8 I gr fr nsnp sexp	8-48 sl gr fr nsnp sexp		
WPT 3	0-9 I gr fr nsnp sexp	9-41 sl gr fr nsnp sexp	41-48 scl wsbk fr sssp sexp	
WPT 2	0-12 l gr fr nsnp sexp	12-48 sl gr fr nsnp sexp		
WPT 1	0-13 l gr fr nsnp sexp	13-48 sl gr fr nsnp sexp		
Name	LTAR	Restrictive Layer	Slope	Soil Depth
WPT 19	0.6		3	48
WPT 18	0.7		3	48
WPT 17	0.8		3	48
WPT 16	0.7		3	48
WPT 15	0.7		3	48
WPT 14	0.7		3	48
WPT 13	0.7		3	48
WPT 12	0.8		3	48
WPT 10	0.7		2	48
WPT 9	0.7		2	48
WPT 8	0.7		2	48
WPT 7	0.7		3	48
WPT 6	0.6		3	48
WPT 5	0.7		3	48
WPT 4	0.7		3	48
WPT 3	0.7		2	41
WPT 2	0.7		3	48
WPT 1	0.6		4	48