SHINGLE ROOF

BOARD & BATTEN SIDING

HORIZONTAL SIDING-

ELEVATION NOTES: GRADE ELEVATIONS SHOWN DO NOT NECESSARILY REFER TO THIS OR ANY OTHER LOT. THEY ARE FOR DIAGRAMMATIC PURPOSES ONLY AND MAY VARY, BUILDER IS RESPONSIBLE FOR ADAPTING THIS PLAN TO SUIT THE EXISTING TOPOGRAPHY OF THE SITE. ROOF VENTILATION TO BE DETERMINED BY BUILDER AS PER CODE. ALL EGRESS OR RESCUE WINDOWS FROM SLEEPING ROOMS MUST HAVE A MIN, NET CLEAR OPENING OF 4.0 3Q FT. THE MIN NET CLEAR OPENING HEIGHT DIMENSION SHALL BE 22", THE MIN NET CLEAR OPENING WIDTH SHALL BE 20", EACH EGRESS WINDOW FROM SLEEPING ROOMS MUST HAVE A SILL HIGHT OF NO MORE THAN 44" FROM THE FLOOR, ALL WINDOW SIZES ARE NOMINAL AND ARE TO BE VERIFIED WITH MANUFACTURER FOR AVAILABILITY AND CONFORMITY

PORCHES, BALCONIES, OR RAIGED FLOOR SURFACES LOCATED MORE THAN 30" ABOVE THE FLOOR OR GRADE BELOW SHALL HAVE GUARDRAILS NOT LESS THAN 32" IN HEIGHT,

I ASSUME NO RESPONSIBILITY FOR ANY DISTANCES AFTER START OF CONSTRUCTION. CONTRACTOR/BUILDER SHALL CONSULT WITH HOME OWNER ON ALL INTERIOR AND EXTERIOR MOLDINGS, TRIMS, COLORS, FINISHES, CABINET LAYOUTS, AND MANUFACTORS BEFORE CONSTRUCTION BEGINS. ALL BEAMS AND FRAMING MEMBERS ARE SIZED BY OTHERS.

1.1 This plan has been drawn to comply with the 2018 NC Building Code

1.2 Minimum Design Loads for Building and Other Structures ASCE 7-9B

2 Roof Dead Load 115 PSF


TO STATE AND LOCAL CODE REQUIREMENTS.

- 3 Roof Live Load 20 PSF
- 4 Typical Floor Dead Load 10 PSF 5 Floor Live Loads
- 5.1 Rooms other than sleeping rooms 40 PSF
- 5.2 Sleeping Rooms 30 PSF 5.3 Stairs 40 PSF
- 5.4 Decks 40 PSF
- 5.5 Exterior Balconies 60 PSF
- 6 Wind Loads
- 6.1 Ultimate Design Wind Speeds 15 MPH
- 6.2 Wind Importance Factor, IW 1.00
- 6.3 Exposure B
- 6.4 Walls (Component and Cladding) 25 PSF
- 6.5 Roofs (Component and Cladding)
- 6.5.1 Roof Slopes 2.25/12 to 7/12 34.8 PSF 6.5.2 Roof Slopes 7/12 to 12/12 21 PSF

It is the sole responsibility of the Contractor and/or Builder to conform to all standards, provisions, requirements, methods of construction and uses of materials provided in buildings and/or structures as required by NC Uniform Building Code, Local Agencies and in accordance with good engineering practices. Verify all dimensions prior to construction.



02/16/2022

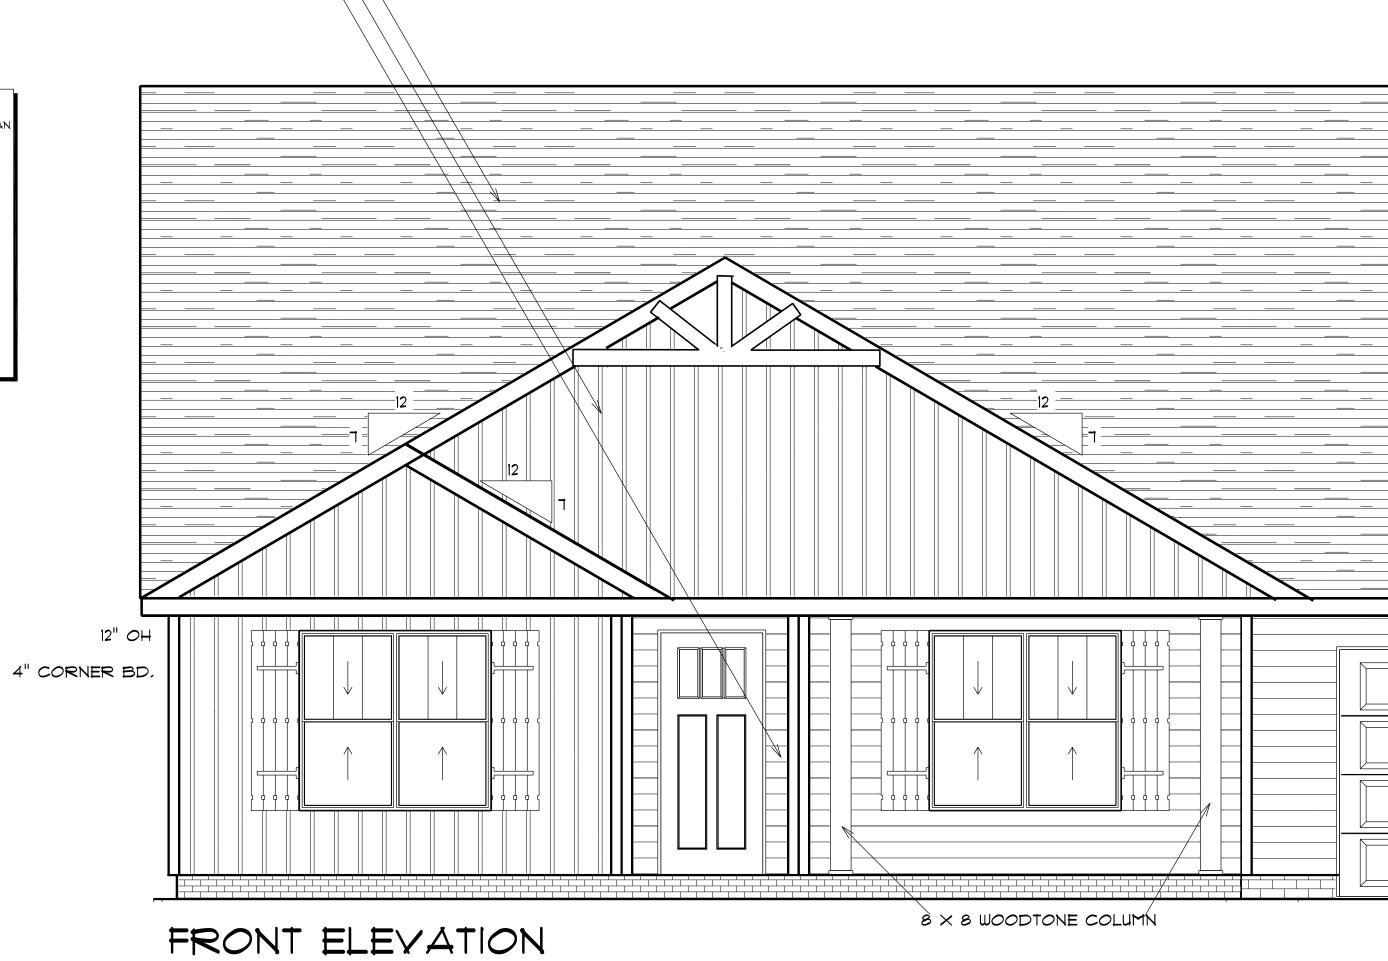



AREA SCHEDULE				
NAME	AREA			
Heated Floor Area	1717.1 sq ft.			
Garage	447.3 sq ft.			
Covered Porch	199.2 sq ft.			

Total Fenestration	Tota Exteríor
246 sq. ft.	1752
Α	bove Gra

Surrounding

With current NC Building Codes tion and verification.	PAGE #: Diane Rives Designs 6205 Mockingbird Lans 6anford, N.C. 21332 919-111-6091 golfwoman@charter.net
2 -28" X 28" R.O. 32" X 32" 6INGLE HUNG W/4" FRAMED BETWEEN 6HED ROOF 3/12 PITCH 12" OH FRAME DORMER FRONT WALL OVER MAIN FRONT WALL OF HOUSE DORMER 16 T-1/2 FT X 5 FT 3/12 ROOF PITCH W/12" OH CENTER DORMER OVER GARAGE DOOR	
	LAMO CUGTOM BUILDERS DRAWN BY: DATE: 11/23/2020
File File Area Of Ext. Wall Total Percentage of 2nd 1752 1752 52 15% 15% 15% 15%	THE YARBROUGH RIGHT GARAGE
ve Grade Walls ding Heated Space	FRONT Elevation B

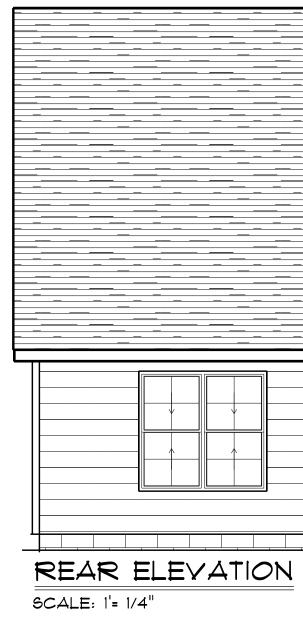

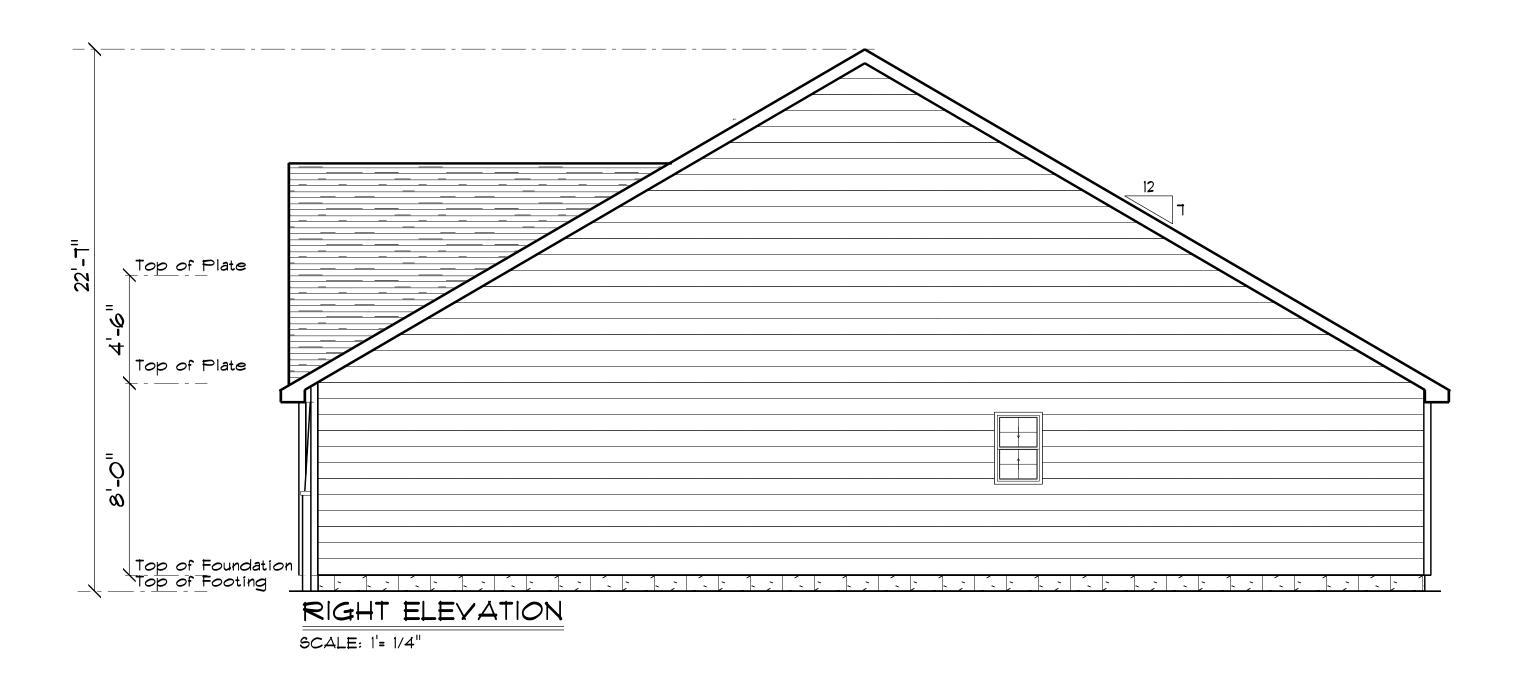




REAR ELEVATION



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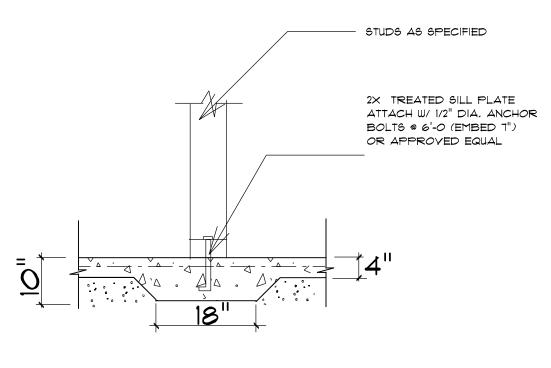
PAGE #: Diane Rivee Designs 6205 Mockingbird Lane 6205 Mockingbird Lane 319-111-6091 gofwoman@charter.net		
SCALE: 1/4"= 1'	DRAWN BY: DATE: 3/21/2020	-
	LAMCO CUBTOM BUILDERS	
THE Y ARRONAL	GARAGE RIGHT	
	SNOIT & YETE	




11
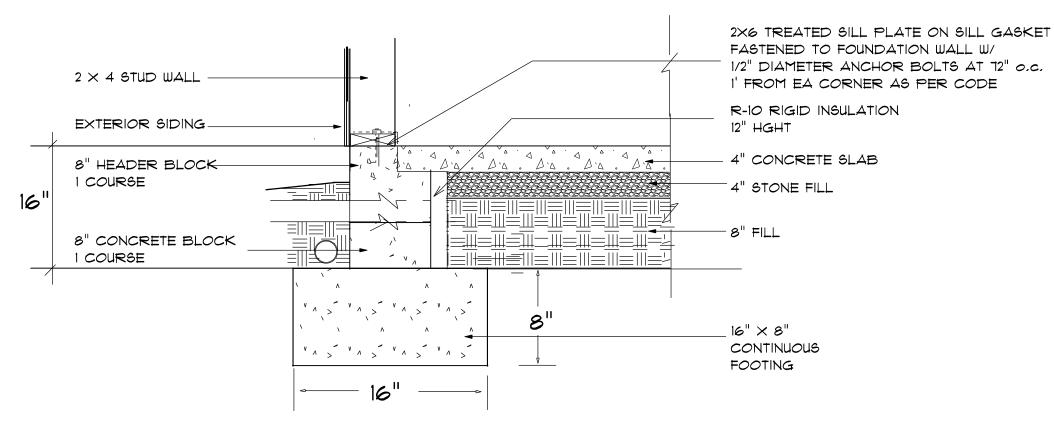
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STEM WALL FOUNDATION Detail not to scale




TYPICAL THICKENED SLAB

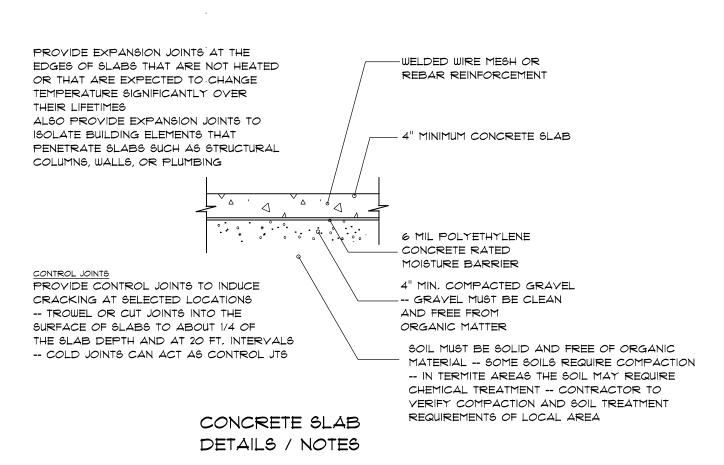

FOUNDATION NOTES: ALL FOOTINGS SHALL BEAR ON ORIGINAL UNDISTURBED SOIL. THE 28 DAY COMPRESSIVE STRENGTH OF ALL FOOTINGS IS 3000 PSI	
PROVIDE WATER PROOFING AND PERIMETER DRAINS AS REQUIRED.	
FOUNDATION CONCRETE MIX TO HAVE 1-1/2" MAX AGGREGATE SIZE, CONCRETE FILL MIX TO HAVE 1/2" MAX AGGREGATE SIZE,	
FOOTING WIDTHS ARE BASED ON A LOAD-BEARING SOIL CAPACITY OF 2000 PSI.	Te
PROVIDE 6 MIL POLY VAPOR BARRIER TO COVER GROUND SURFACE IN CRAWL SPACE	ມຣ ມີ
ALL ANCHOR BOLTS TO BE 12" LONG, 1/2" DIA. A36 UNO ANCHOR BOLTS SHALL BE SPACE AT A MAX OF 6' OC AND NO MORE THAN 1' FROM EA CORNER.	ap bu

Termite Soil Treatment: Treat entire slab area soil or crawl space surface before vapor barrier is installed and slab is poured with a state approved termiticide. Termiticide should be applied by a licensed and certified pest control professional by the state of North Carolina.

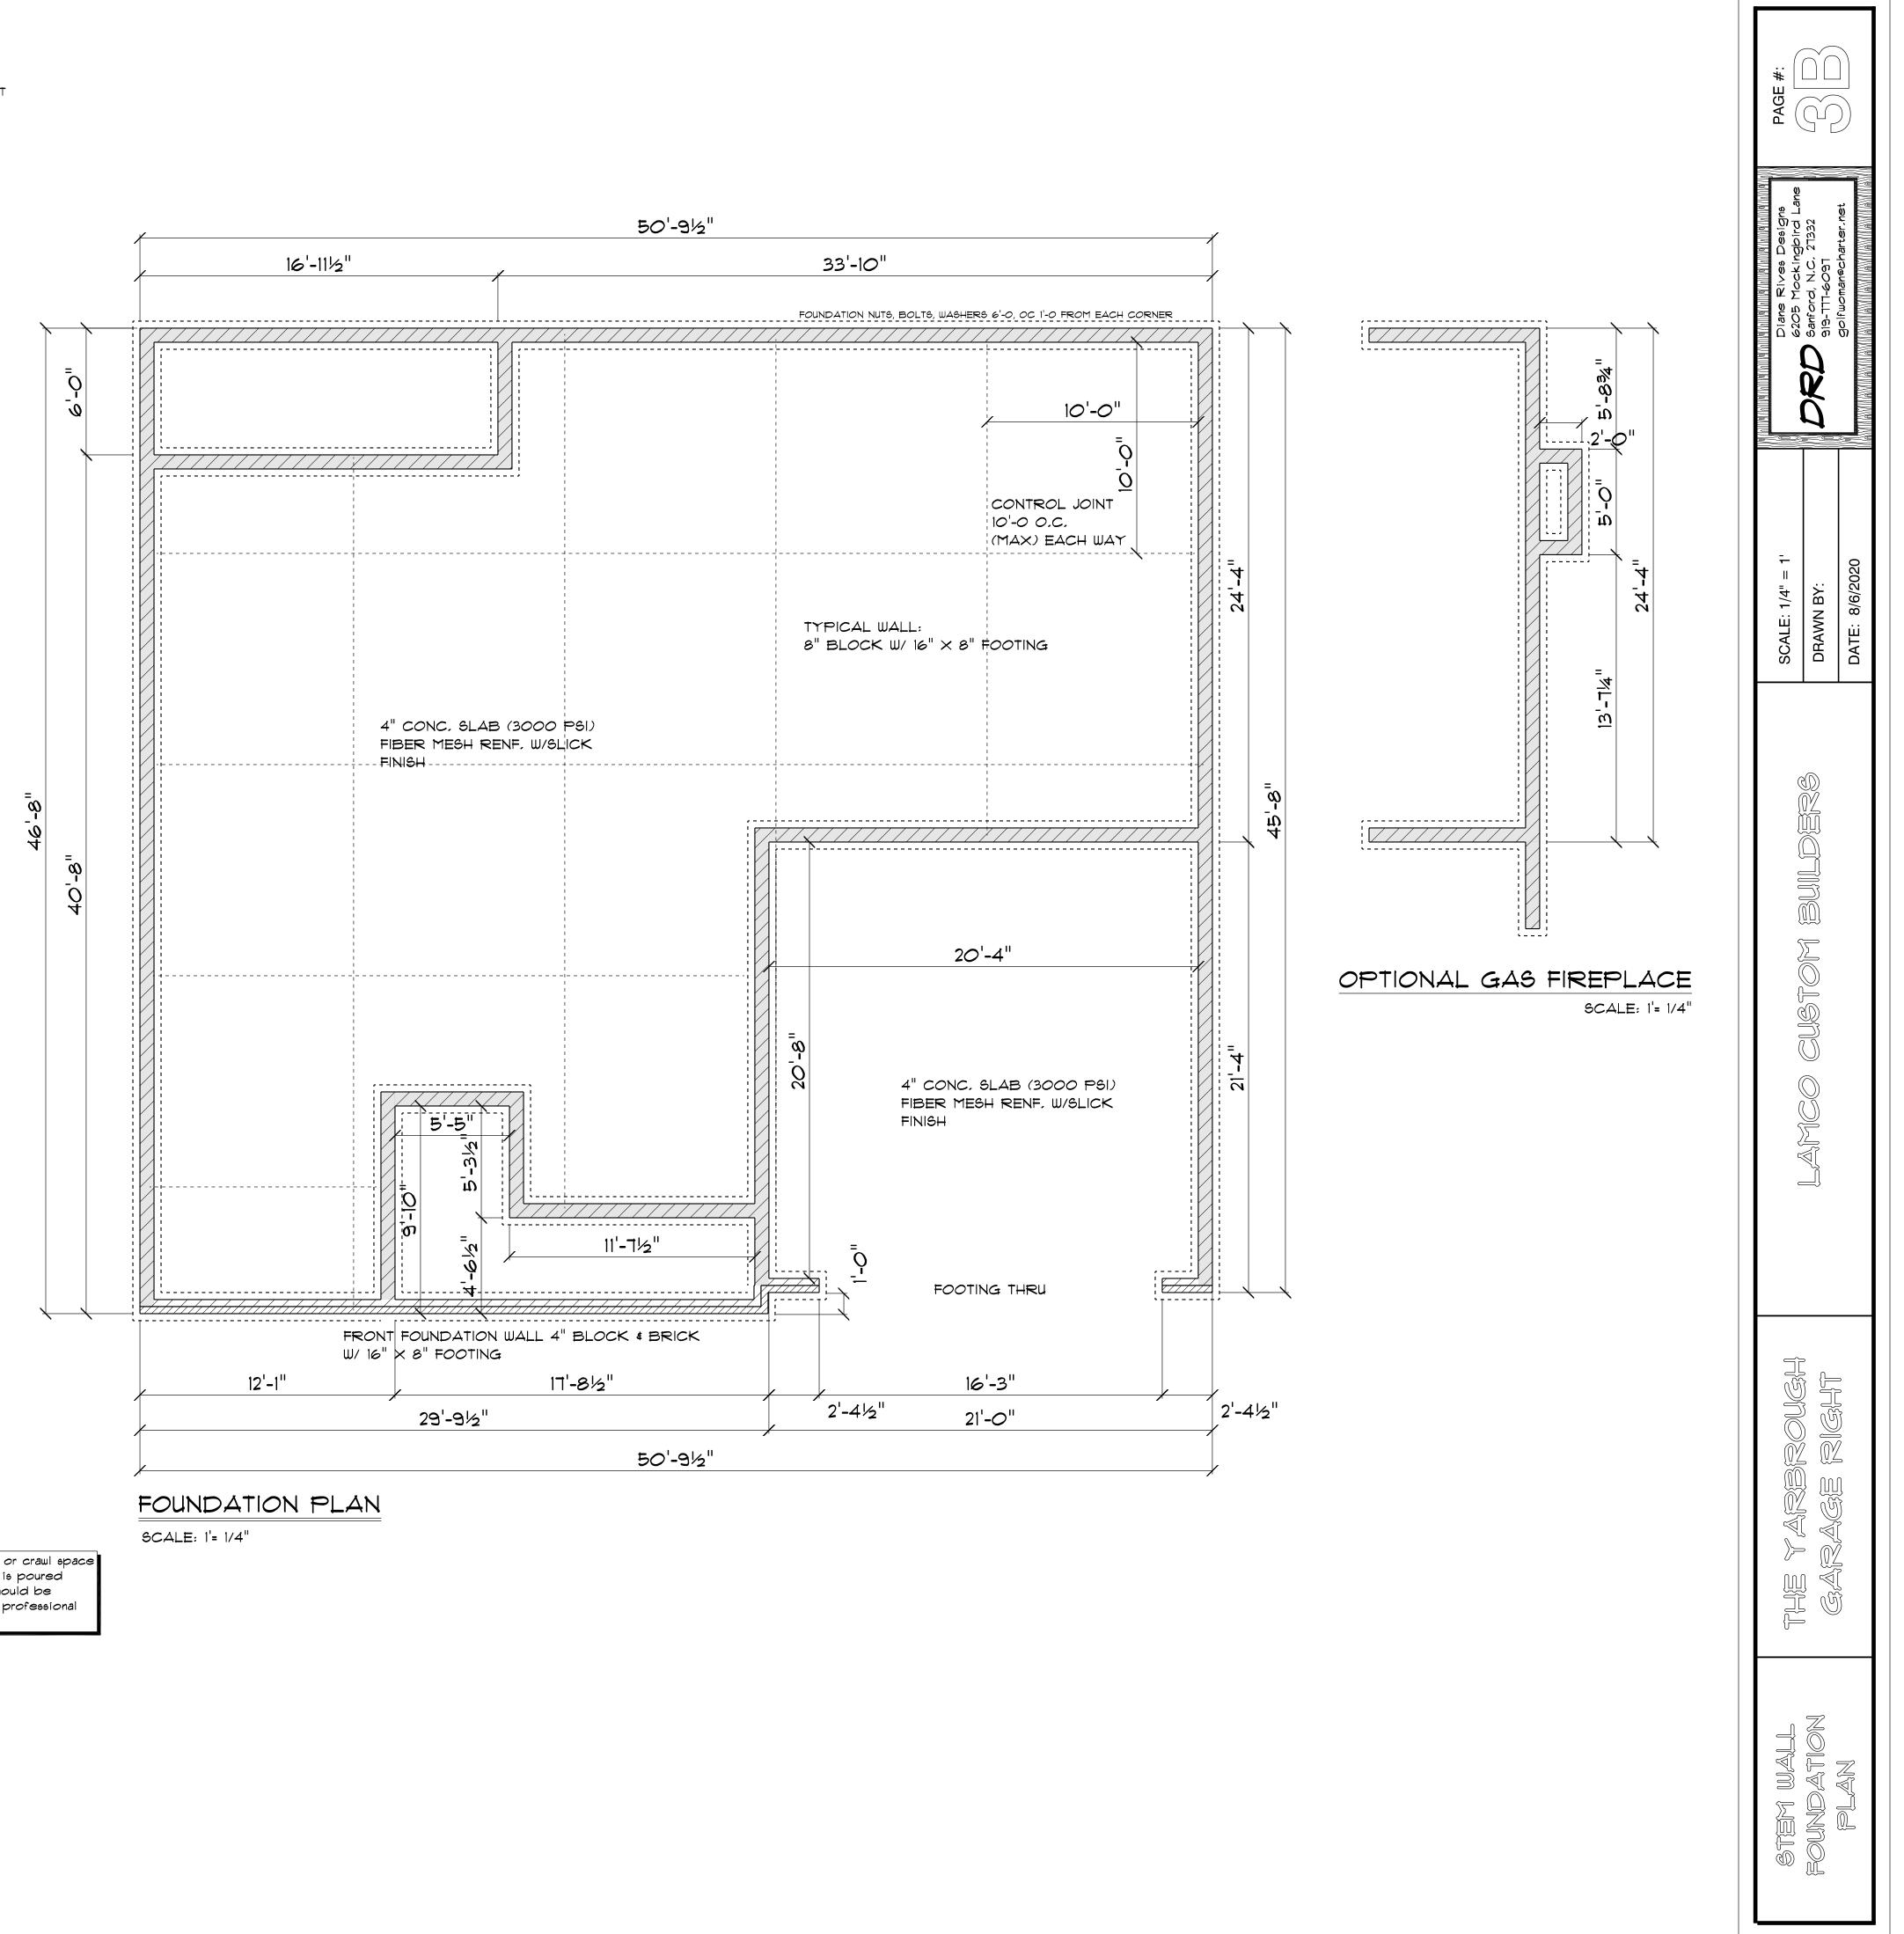

OPENING SCHEDULE			ENING SCHEDULE
SIZE		COUNT	LIBRARY NAME
2'-8" x 5'-0"		2	Window\Double Hun
2'-8" x 5'-0" Dbl		5	Window\Double Hun
2'-0" x 3'-0"		2	Window\Double Hun
4'-0" x 3'-0"		1	Window∖Double Hun

GENERAL FRAMING NOTES: ALL LUMBER IN CONTACT WITH CONCRETE OR MAGONRY SHALL BE PRESSURE TREATED FRAMING LUMBER SHALL BE SYP #2 GRADE AND/OR

SPRUCE PINE FIR *1 AND/OR *2, KILN DRIED. WHERE PRE-ENGINEERED JOISTS ARE USED, JOIST MANUFACTURER SHALL

PROVIDE SHOP DRAWINGS, WHICH BEAR SEAL OF A N.C. ENGINEER. STUDS AND JOISTS SHALL NOT BE CUT TO INSTALL PLUMBING OR WIRING WITHOUT

ADDING METAL OR WOOD SIDE PANELS TO STRENGTHEN THE MEMBER TO ITS ORIGINAL CAPACITY.

NAIL MULTIPLE MEMBERS WITH 2 ROWS OF 160 NAILS STAGGERED 32" OC AN USE 3-160 NAILS 2" IN AT EACH END. DOUBLE ALL STUDS UNDER ROOF POST DOWNS UNO.


NAIL FLOOR JOISTS TO SILL PLATE WITH 80 TOE NAILS. ALL EXPOSED FRAMING ON PORCHES AND DECKS SHALL BE PRESSURE TREATED.


PROVIDE WATERPROOFING AND DRAINS AS REQUIRED. ALL FRAMING TO BE 16" OC UNO. WALL FRAMING DIMENSIONS ARE BASED ON 2 \times 4 studs uno. Double studs under All headers.

LYL'S AND TJI'S TO BE SIZED BY OTHERS


EXTERIOR WALLS IN LIVING AREAS ARE 2 × 4

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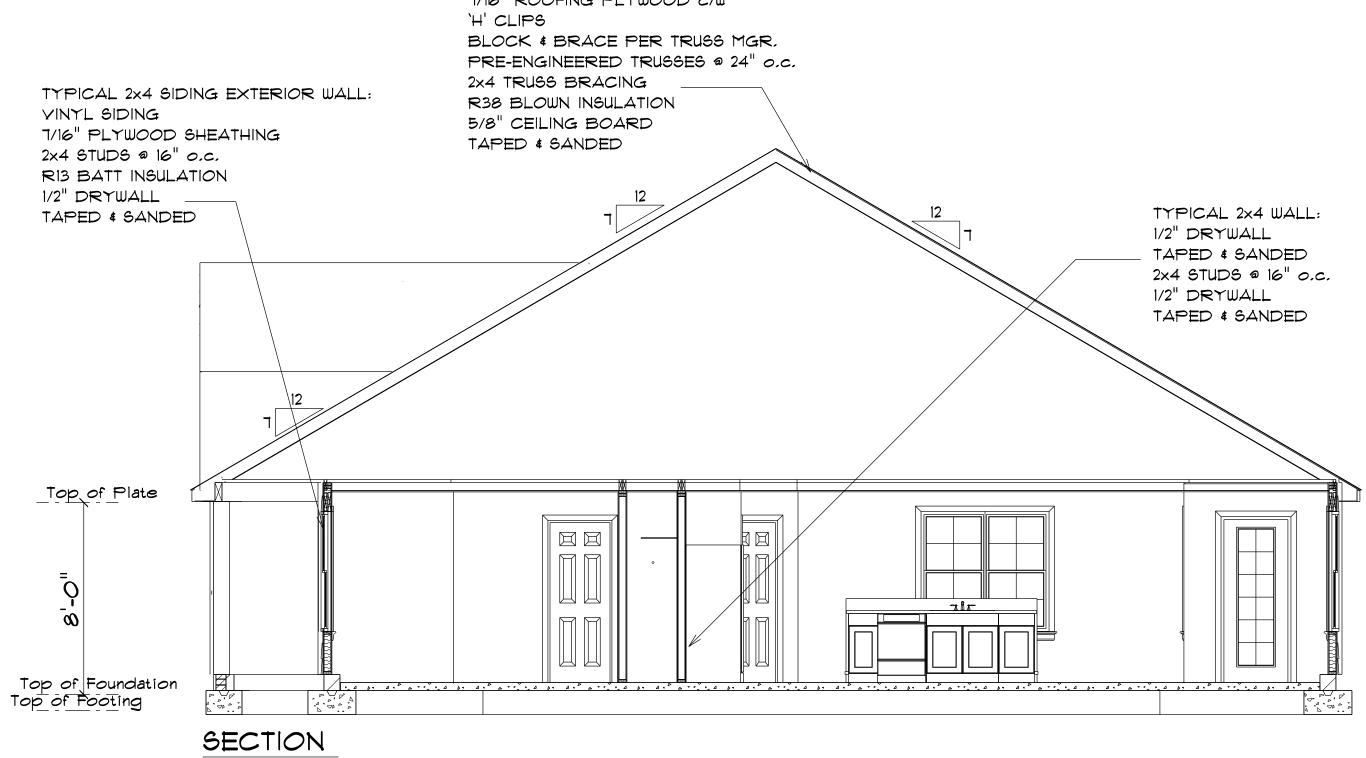
FLOOR PLAN SCALE: 1'= 1/4"

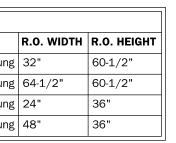

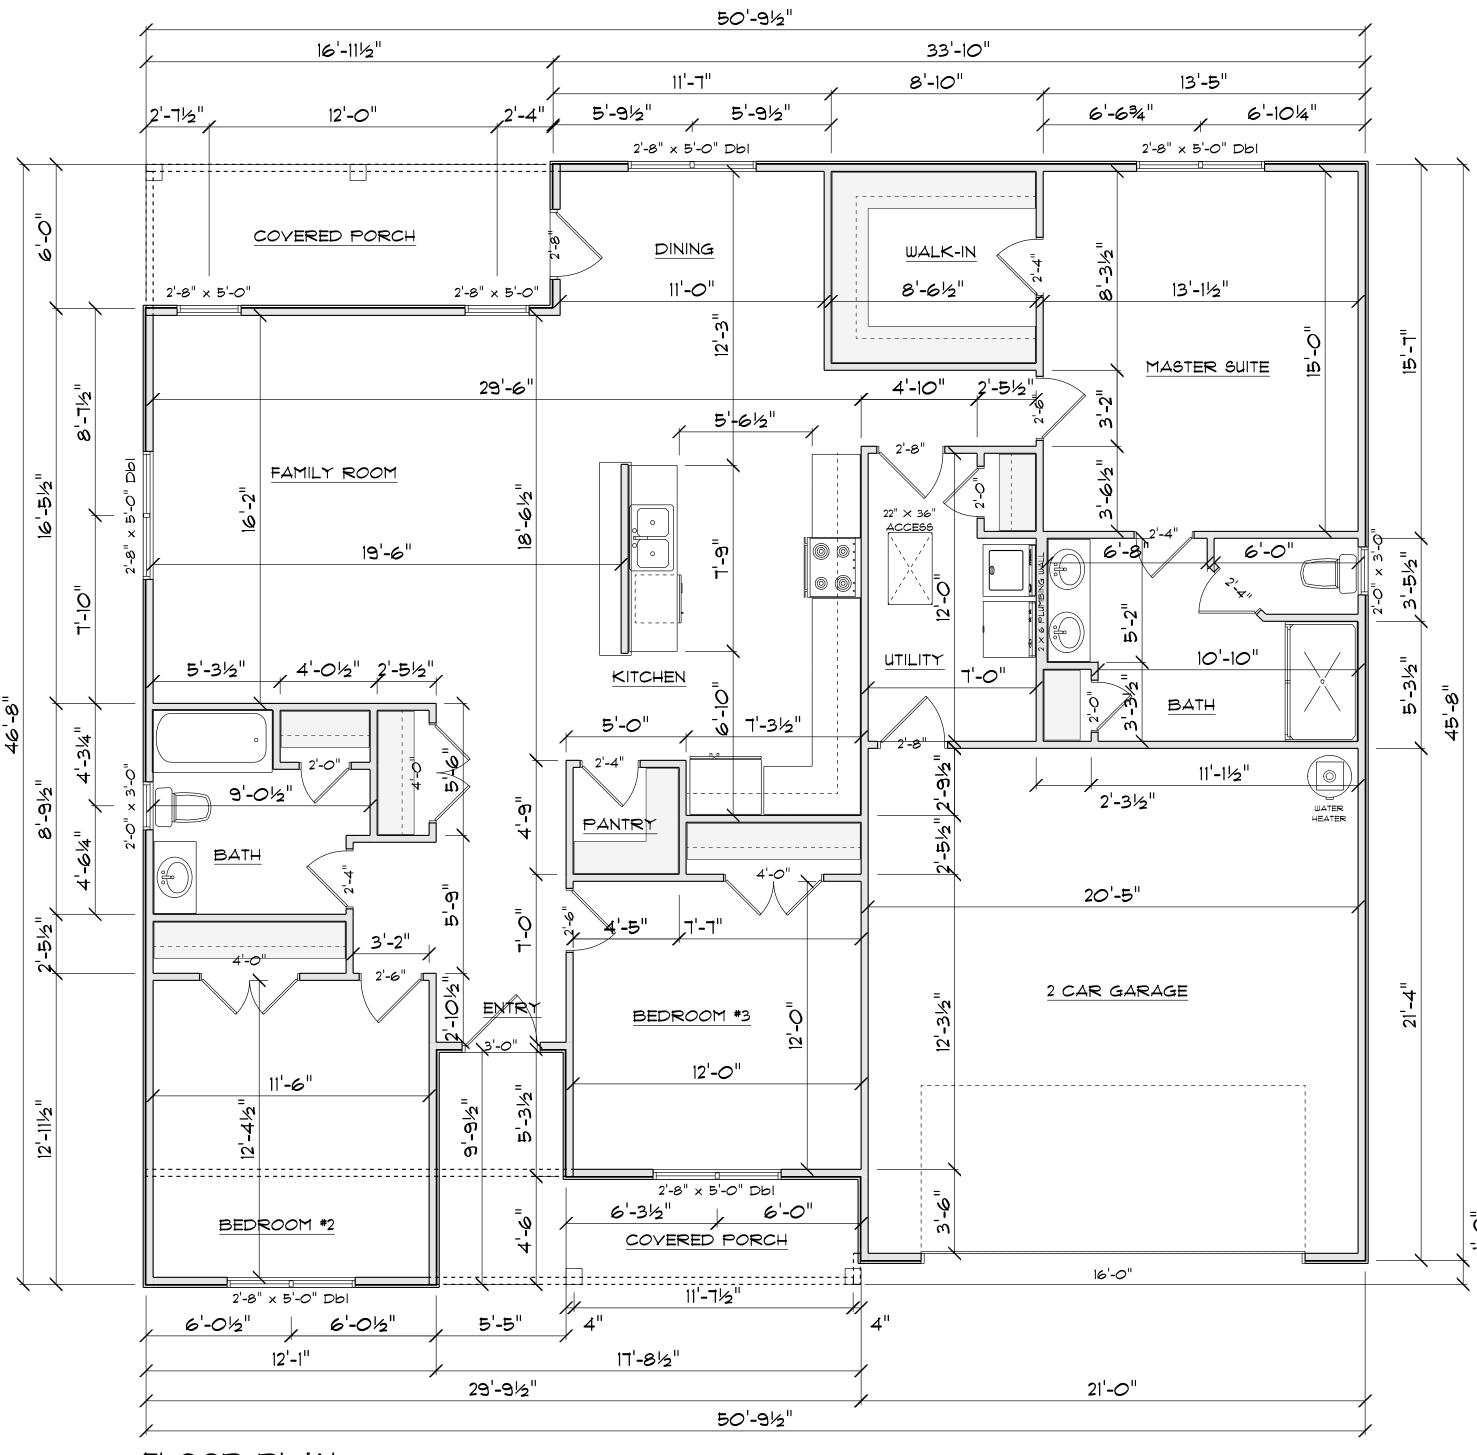SHINGLE ROOF				
ROOF SHEATHING - 7/16" (APA #24/16 MINIMUM WITH A EDGE NAILING AND 8D A FIELD NAILING	3D AT 6" O.C.			
30 LB. FELT UNDERLAYME - TYPICAL UNDER 5:12 PITO				TRUSS ROOF SYSTEM
VENTILATION CHANNEL AS	REQ'D			
			<u> </u>	
VENTILATION FRIEZE BLOCK WITH				
SCREENED VENT SHEATHING EDGE NAILING				
SHEATHING				
TYPICAL 2X4 SIDING EXTE VINYL SIDING 1/2" SHEATHING AIR BARRIER 2x4 STUDS @ 16" o.c. RIS BATT INSULATION 6 MIL POLY VAPOR BAR 1/2" GYPSUM BOARD 2X4 PT SILL PLATE ON SI FASTENED TO FOUNDATIO 1/2" DIAMETER ANCHOR E 2' FROM EACH CORNER	RIER LL GASKET N WALL W/			
2×4 STUD WALL				
EXTERIOR SIDING	8" HEADER BLOCK			
	8" CONCRETE BLOCK			
	2x4/SIDING	STEM WALL FO	DUNDATION	

not to scale

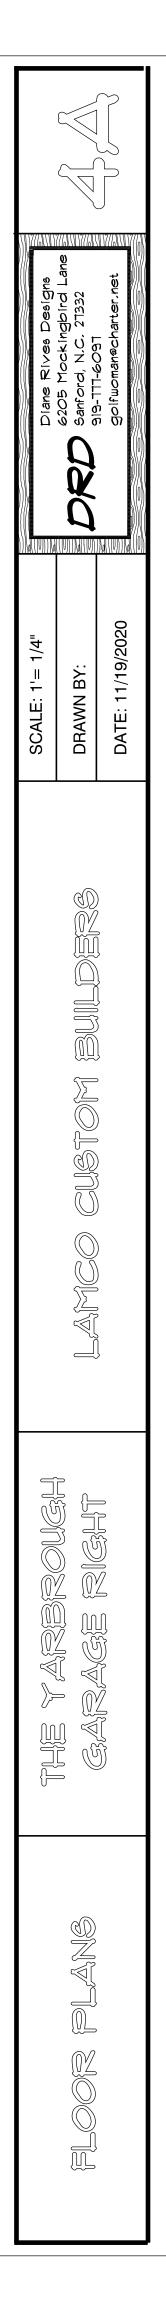TYPICAL TRUSS ROOF: SHINGLES 7/16" ROOFING PLYWOOD c/w `H' CLIPS BLOCK & BRACE PER TRUSS 1



SCALE: 1'= 1/4"

R-10 RIGID INGULATION 12" HGHT

- 4" CONCRETE SLAB - 4" STONE FILL

- 8" FILL

_ 16" × 8" CONTINUOUS FOOTING


ROOF NOTES:

TRUSSES, BRACINGS, BRIDGING AND CONNECTORS ARE TO BE DESIGNED BY THE TRUSS MANUFACTURER.

IDENTIFY LUMBER BY OFFICIAL GRADE MARKINGS.


DO NOT CUT OR REMOVE CHORDS OR OTHER TRUSS MEMBERS. DO NOT NOTCH OR DRILL TRUSS MEMBERS.

WHERE PRE-ENGINEERED ROOF TRUSSES ARE USED, TRUSS MANUFACTURER SHALL PROVIDE SHOP DRAWINGS, WHICH BEAR SEAL OF A N. C. REGISTERED ENGINEER.

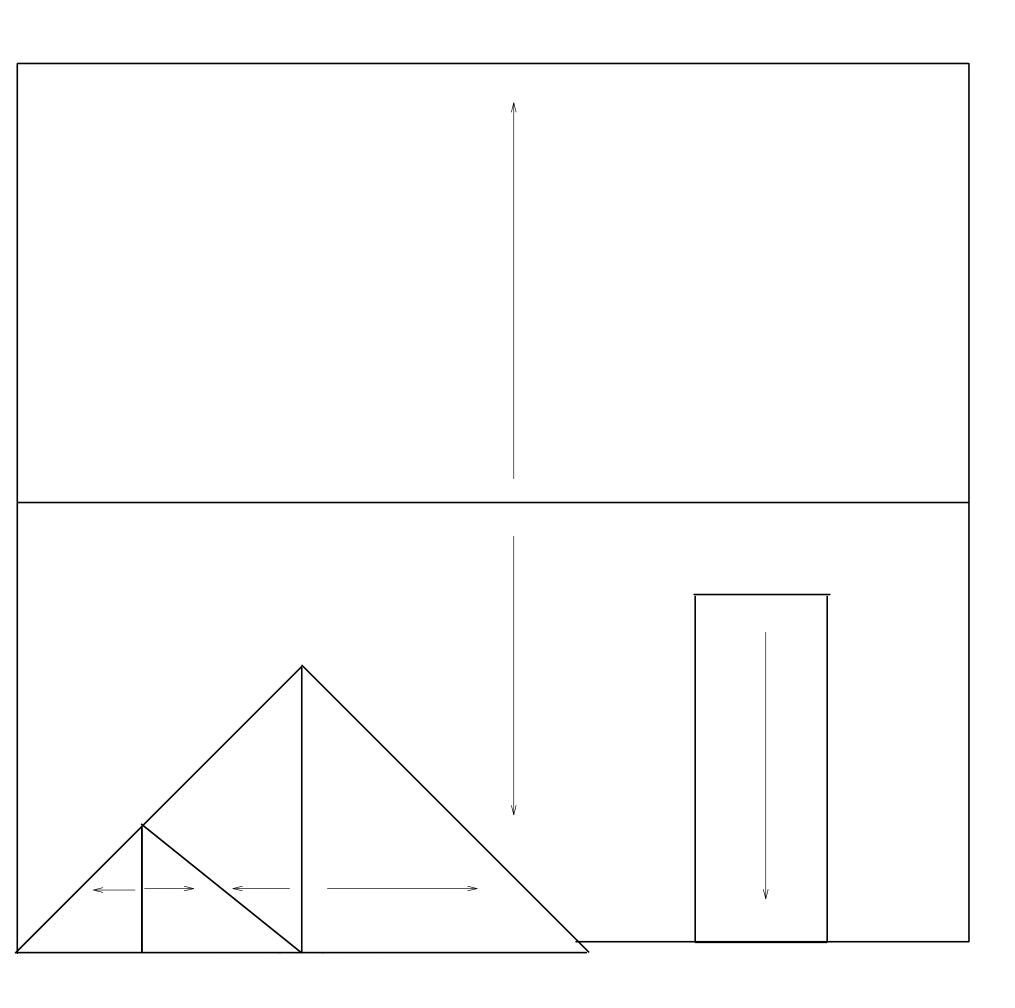



ROOF PLAN SCALE: 1'= 3/16"


12" OH ALL 7/12 PITCH 3/12 PITCH SHED DORMER

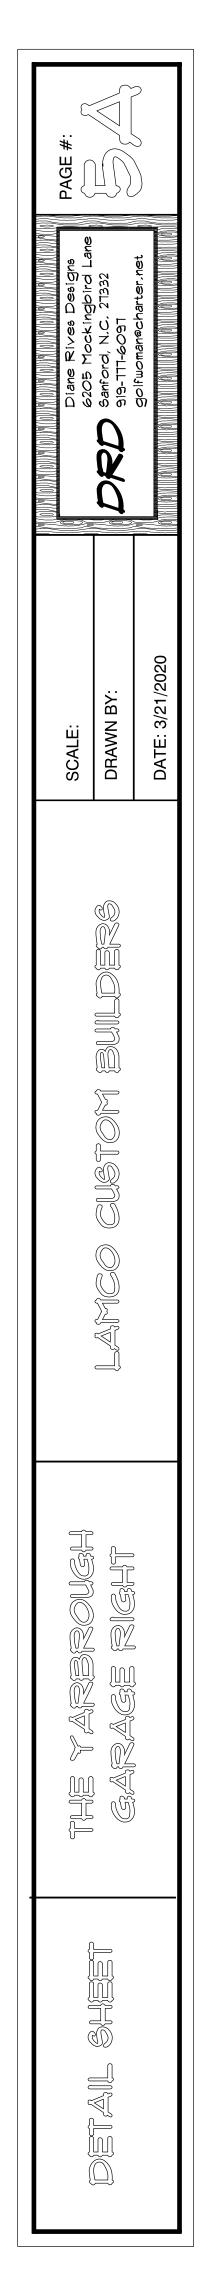

ELECTRICAL LEGEND				
ELECTRICAL	COUNT	SYMBOL		
ceiling fan 4 bladed 01	2			
foyer light	1	\bigcirc		
10" led light	2			
7" led disc	13	8		
out door over head	4			
ceiling light 19	1	Ø		
4' fluorescent light	2			
outdoor carriage light	2	P		
flood light	2	QD		
vanity light	4	<u> </u>		
over head light	2	9		

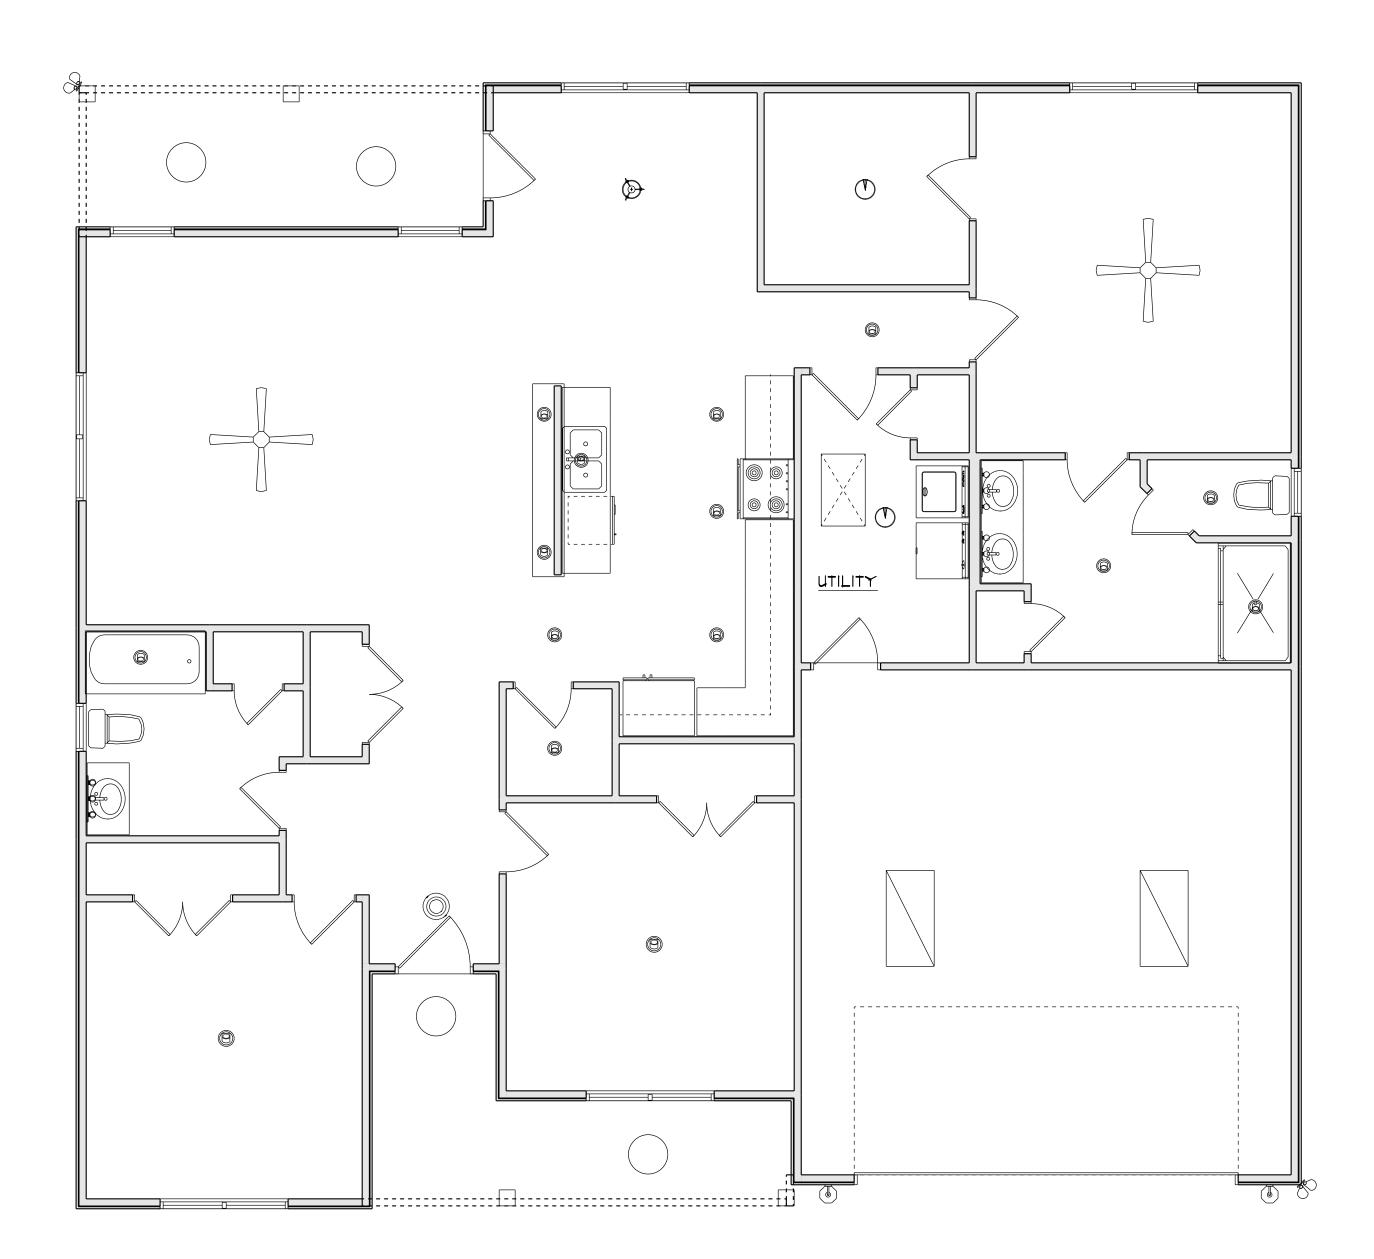

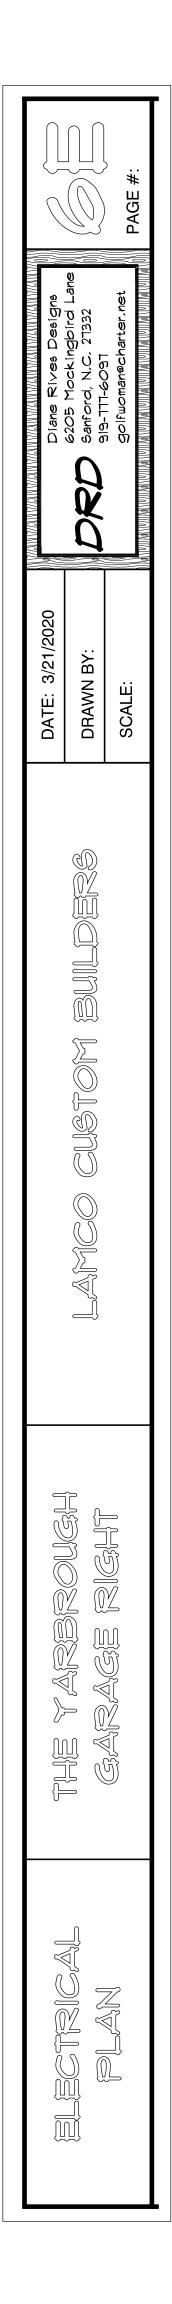

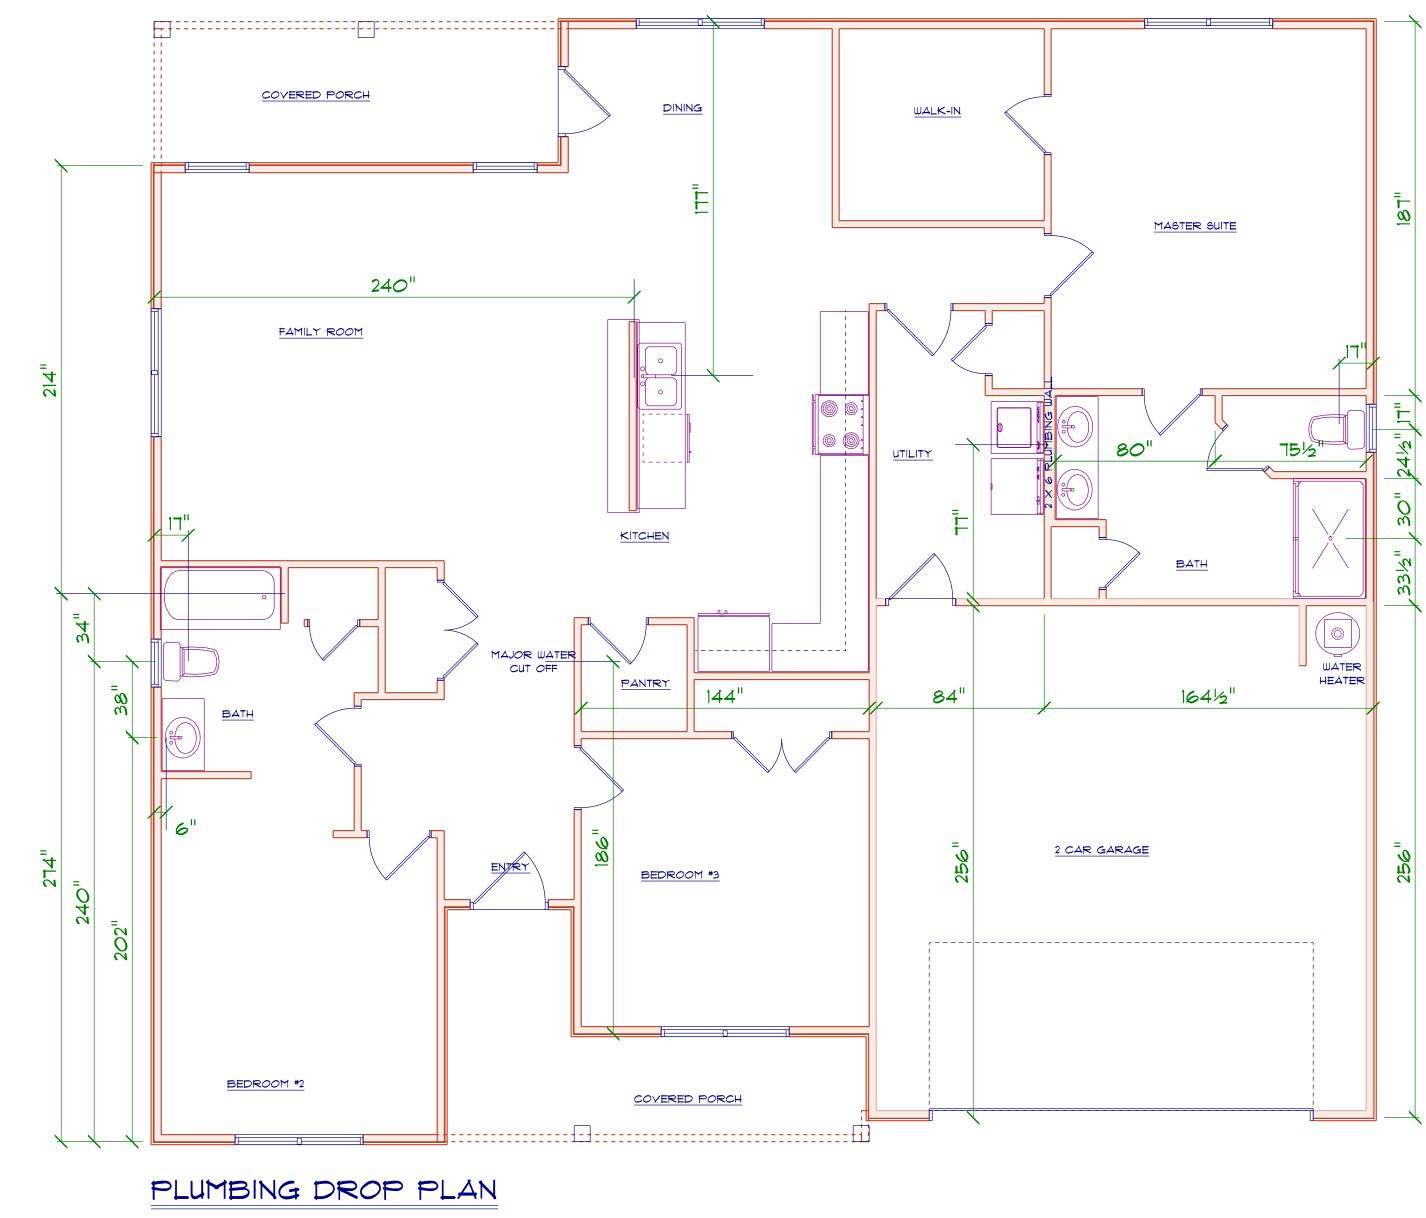

SCALE: 1'= 1/4"

