CRAWL SPACE VENTILATION CALCULATION

1768 SQ. FT. OF CRAWL SPACE DIVIDED BY 150 EQUALS 11.8 SQ. FT. OF NET FREE AREA REQUIRED. SEE SECTION R408.1 OF THE 2018 NCRC (2015 IRC).

FREE VENT AREA MAY BE REDUCED TO 1/1500 IF AN APPROVED VAPOR BARRIER IS INSTALLED OVER 100% OF THE CRAWL FLOOR AND VENTS ARE INSTALLED TO PERMIT CROSS-VENTILATION OF CRAWL SPACE.

SEE SECTION R408.1.1 OF THE 2018 NCRC.

CRAWL SPACE STRUCTURAL NOTES

- 1. ALL FRAMING LUMBER TO BE #2 SPF (UNO).
 ALL TREATED LUMBER TO BE #2 SYP (UNO).
- 2. INSTALL AN EXTRA OR DOUBLE JOIST UNDER WALLS PARALLEL TO THE FLOOR JOISTS WHERE NOTED ON THE PLANS.
- 3. SHADED PIERS TO BE FILLED SOLID.
- 4. INSTALL 1/2" ANCHOR BOLTS 6'-0" O.C. AND WITHIN 1'-0" FROM END OF EACH CORNER. (MIN (2) ANCHORS PER PLATE SECTION.) ANCHOR BOLTS MUST EXTEND A MINIMUM OF 7" INTO MASONRY OR CONCRETE. LOCATE BOLT WITHIN MIDDLE THIRD OF PLATE WIDTH.
- 5. INSTALL JOINT REINFORCEMENT @ 16" O.C. TO SECURE MULTIPLE WYTHE FOUNDATION WALLS TOGETHER.
- 6. REFER TO NOTES AND DETAIL PAGES FOR ADDITIONAL INFORMATION.

CODE NOTES: 120 MPH ULTIMATE DESIGN WIND SPEED w/ MEAN ROOF HEIGHT LESS THAN 30':


- 1. ENGINEER'S SEAL APPLIES ONLY TO
 STRUCTURAL COMPONENTS. ENGINEER'S SEAL
 DOES NOT CERTIFY DIMENSIONAL ACCURACY
 OR ARCHITECTURAL LAYOUT INCLUDING ROOF
 SYSTEM.
- 2. STRUCTURAL DESIGN PER NORTH CAROLINA RESIDENTIAL CODE, 2018 EDITION.
- MEAN ROOF HEIGHT IS LESS THAN 30 FEET.
 EXTERIOR WALLS DESIGNED FOR 120 MPH WINDS.
- 5. WALL CLADDING DESIGNED FOR +15.5 PSF AND -20 PSF (+/- INDICATE POSITIVE / NEGATIVE PRESSURE (TYP).
- 6. ROOF CLADDING DESIGNED FOR +14.2 PSF AND -18 PSF FOR ROOF PITCHES 7/12 TO 12/12 AND +10 PSF AND -36 PSF FOR ROOF PITCHED 2.25/12 TO 7/12.
- 7. ENERGY EFFICIENCY COMPLIANCE AND INSULATION VALUES OF THE BUILDING TO BE IN ACCORDANCE WITH CHAPTER 11 OF THE NCRC, 2018 EDITION.
- 8. REFER TO NOTES AND DETAIL SHEETS FOR ADDITIONAL STRUCTURAL INFORMATION.



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N.C. CERTIFICATE NUMBER: P-2212

1532 (919) N. C.

TERALYN II - GARAGE LEFT TRIANGLE HOME PROS, LLC.

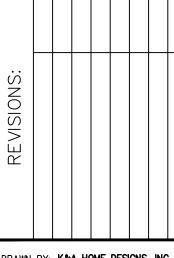

DRAWN BY: K&A HOME DESIGNS, INC.

Engineered by: J. Smith	

SCALE: 1/4" = 1'-0"

DATE: 1-26-2022

STUD COLUMNS ON FLOOR ABOVE THAT REQUIRE SOLID BLOCKING TO GIRDER OR FOUNDATION.

BEAM OR HEADER AS NOTED

<u>LEGEND</u>


THIS LINE TYPE INDICATES PLUMBING OR APPLIANCES ON THE FLOOR ABOVE TO HELP ELIMINATE FRAMING CONFLICTS WITH UTILITIES. (FOR REFERENCE ONLY, SEE ARCHITECTURAL DRAWINGS)

(UNO) UNLESS NOTED OTHERWISE

S-1

CRAWL SPACE FOUNDATION PLAN

SHEET: **1** OF: **5**

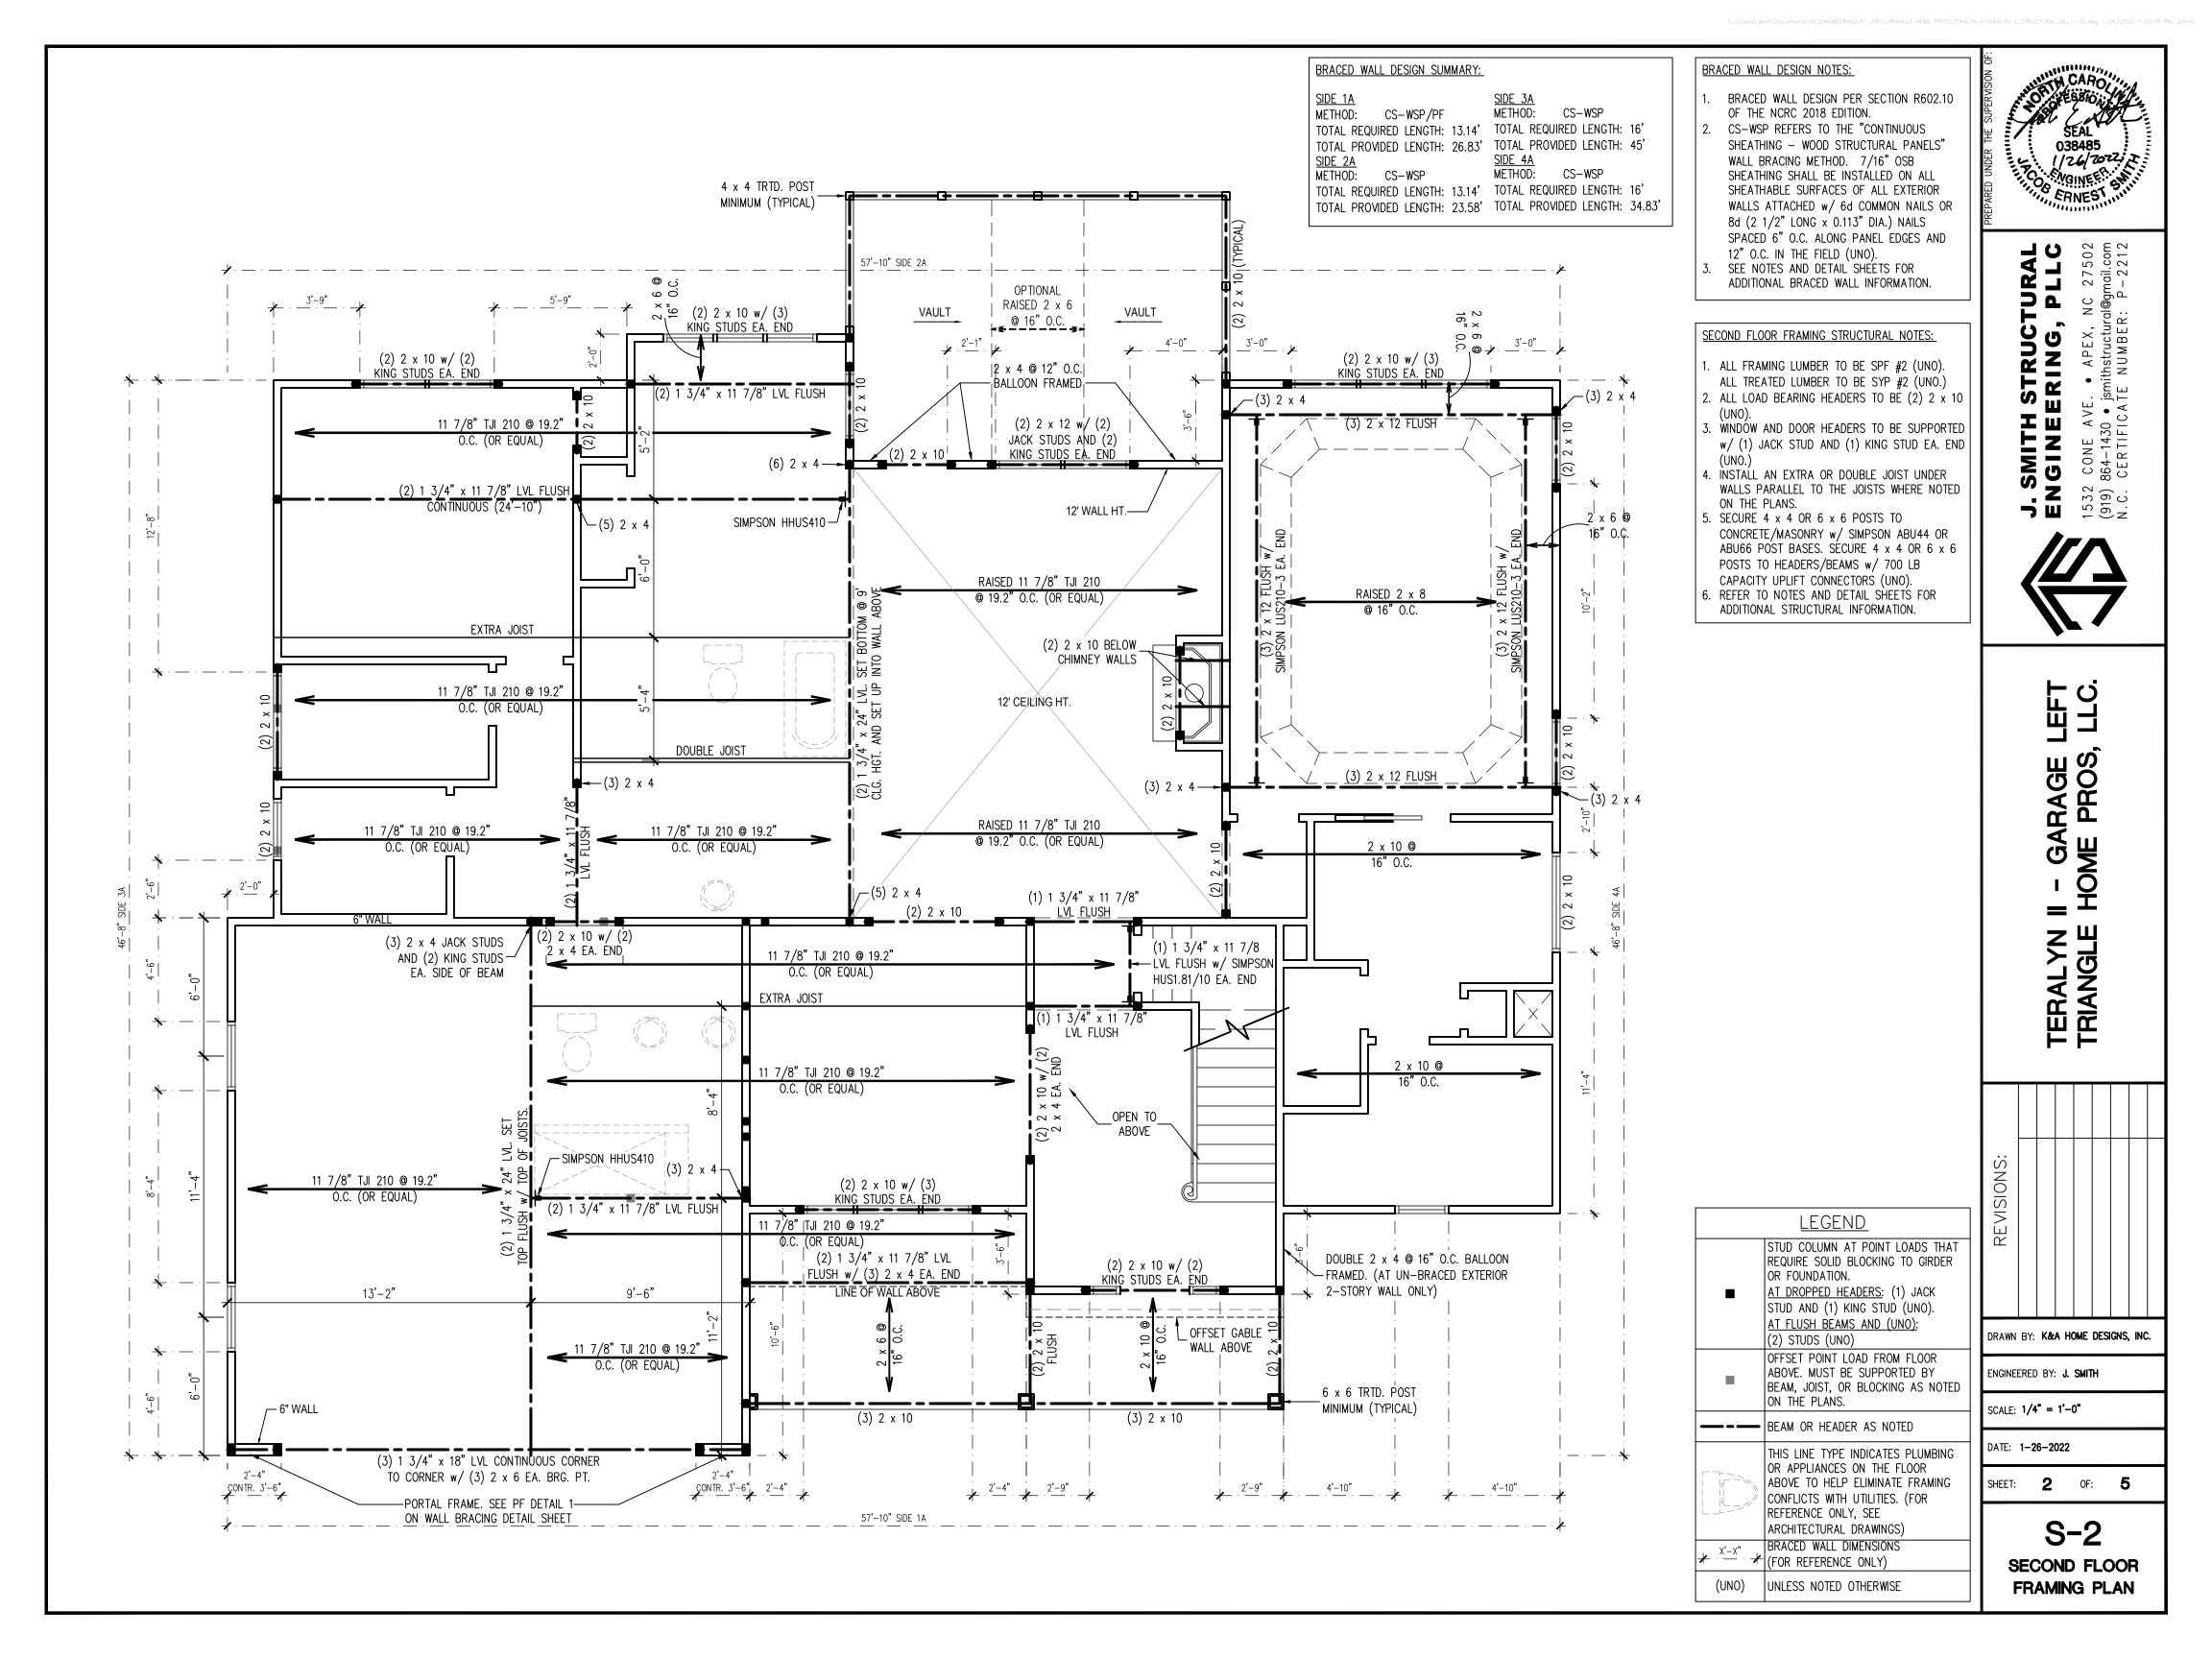

BRACED WALL DESIGN NOTES:

- BRACED WALL DESIGN PER SECTION R602.10 OF THE NCRC 2018 EDITION.
- 2. PER SECTION R602.10.3.2 OF THE 2018 NCRC, THE AMOUNT OF BRACING ON THE SECOND FLOOR EXCEEDS THE AMOUNT REQUIRED FOR THE FIRST FLOOR AND NO BRACED WALL ANALYSIS IS REQUIRED.
- CS-WSP REFERS TO THE "CONTINUOUS SHEATHING - WOOD STRUCTURAL PANELS" WALL BRACING METHOD. 7/16" OSB SHEATHING SHALL BE INSTALLED ON ALL SHEATHABLE SURFACES OF ALL EXTERIOR WALLS ATTACHED w/ 6d COMMON NAILS OR 8d (2 1/2" LONG x 0.113" DIA.) NAILS SPACED 6" O.C. ALONG PANEL EDGES AND 12" O.C. IN THE FIELD (UNO).
- SEE NOTES AND DETAIL SHEETS FOR ADDITIONAL BRACED WALL INFORMATION.

CEILING FRAMING STRUCTURAL NOTES:

- 1. ALL FRAMING LUMBER TO BE SPF #2 (UNO).
- 2. ALL LOAD BEARING HEADERS TO BE (2) 2 x 10
- (UNO.)

- ALL TREATED LUMBER TO BE SYP #2 (UNO.)
- WINDOW AND DOOR HEADERS TO BE SUPPORTED
- w/ (1) JACK STUD AND (1) KING STUD EA. END REFER TO NOTES AND DETAIL SHEETS FOR ADDITIONAL STRUCTURAL INFORMATION.





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LEFT, LLC. II - GARAGE HOME PROS, TERAL YN TRIANGLE

REVISIONS:

SCALE: 1/4" = 1'-0"

DATE: **1-26-2022**

SHEET: **3** OF: **5**

S-3 CEILING FRAMING PLAN

DRAWN BY: K&A HOME DESIGNS, INC.

ENGINEERED	BY:	J.	SM

	STUD COLUMN AT POINT LOADS THAT
	STUD COLUMN AT POINT LOADS THAT REQUIRE SOLID BLOCKING TO GIRDER
	OR FOUNDATION.
	AT DROPPED HEADERS: (1) JACK
_	STUD AND (1) KING STUD (UNO).
	AT FLUSH BEAMS AND (UNO): (2)
	STUDS (UNO)

<u>LEGEND</u>

	01000 (0110)
	BEAM OR HEADER AS NOTED
(UNO)	UNLESS NOTED OTHERWISE

- . ALL FRAMING LUMBER TO BE #2 SPF (UNO).
- 2. SHEATH ROOF w/ 7/16" OSB SHEATHING SECURED w/ 8d NAILS @ 6" O.C. ALONG EDGES AND 12" O.C. IN THE FIELD.
- 3. CIRCLES DENOTE POSTS FOR ROOF SUPPORT AS NOTED.
- 4. STICK FRAME OVER-FRAMED ROOF SECTIONS W/ 2 x 8 RIDGES, 2 x 6 RAFTERS @ 16" O.C. AND FLAT 2 x 10 VALLEYS OR USE VALLEY TRUSSES.
- 5. HIP SPLICES ARE TO BE SPACED 8'-0" O.C. MINIMUM. FASTEN MEMBERS WITH (3) ROWS OF 12d NAILS @ 16" O.C.
- 6. FASTEN FLAT VALLEYS TO RAFTERS OR TRUSSES WITH SIMPSON H2.5A HURRICANE TIES @ 32" O.C. MAX. PASS HURRICANE TIES THROUGH NOTCH IN ROOF SHEATHING IF REQUIRED. SECURE RAFTERS TO FLAT VALLEYS WITH A MIN. OF (6) 12d TOE NAILS.
- 7. INSTALL (1) SIMPSON H2.5A HURRICANE TIE (OR EQUAL) @ EA. RAFTER BEARING.
- 8. REFER TO NOTES AND DETAIL SHEETS FOR ADDITIONAL STRUCTURAL INFORMATION.

ROOF FRAMING STRUCTURAL NOTES:




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LEFT, LLC. II - GARAGE HOME PROS, TERALYN II TRIANGLE H



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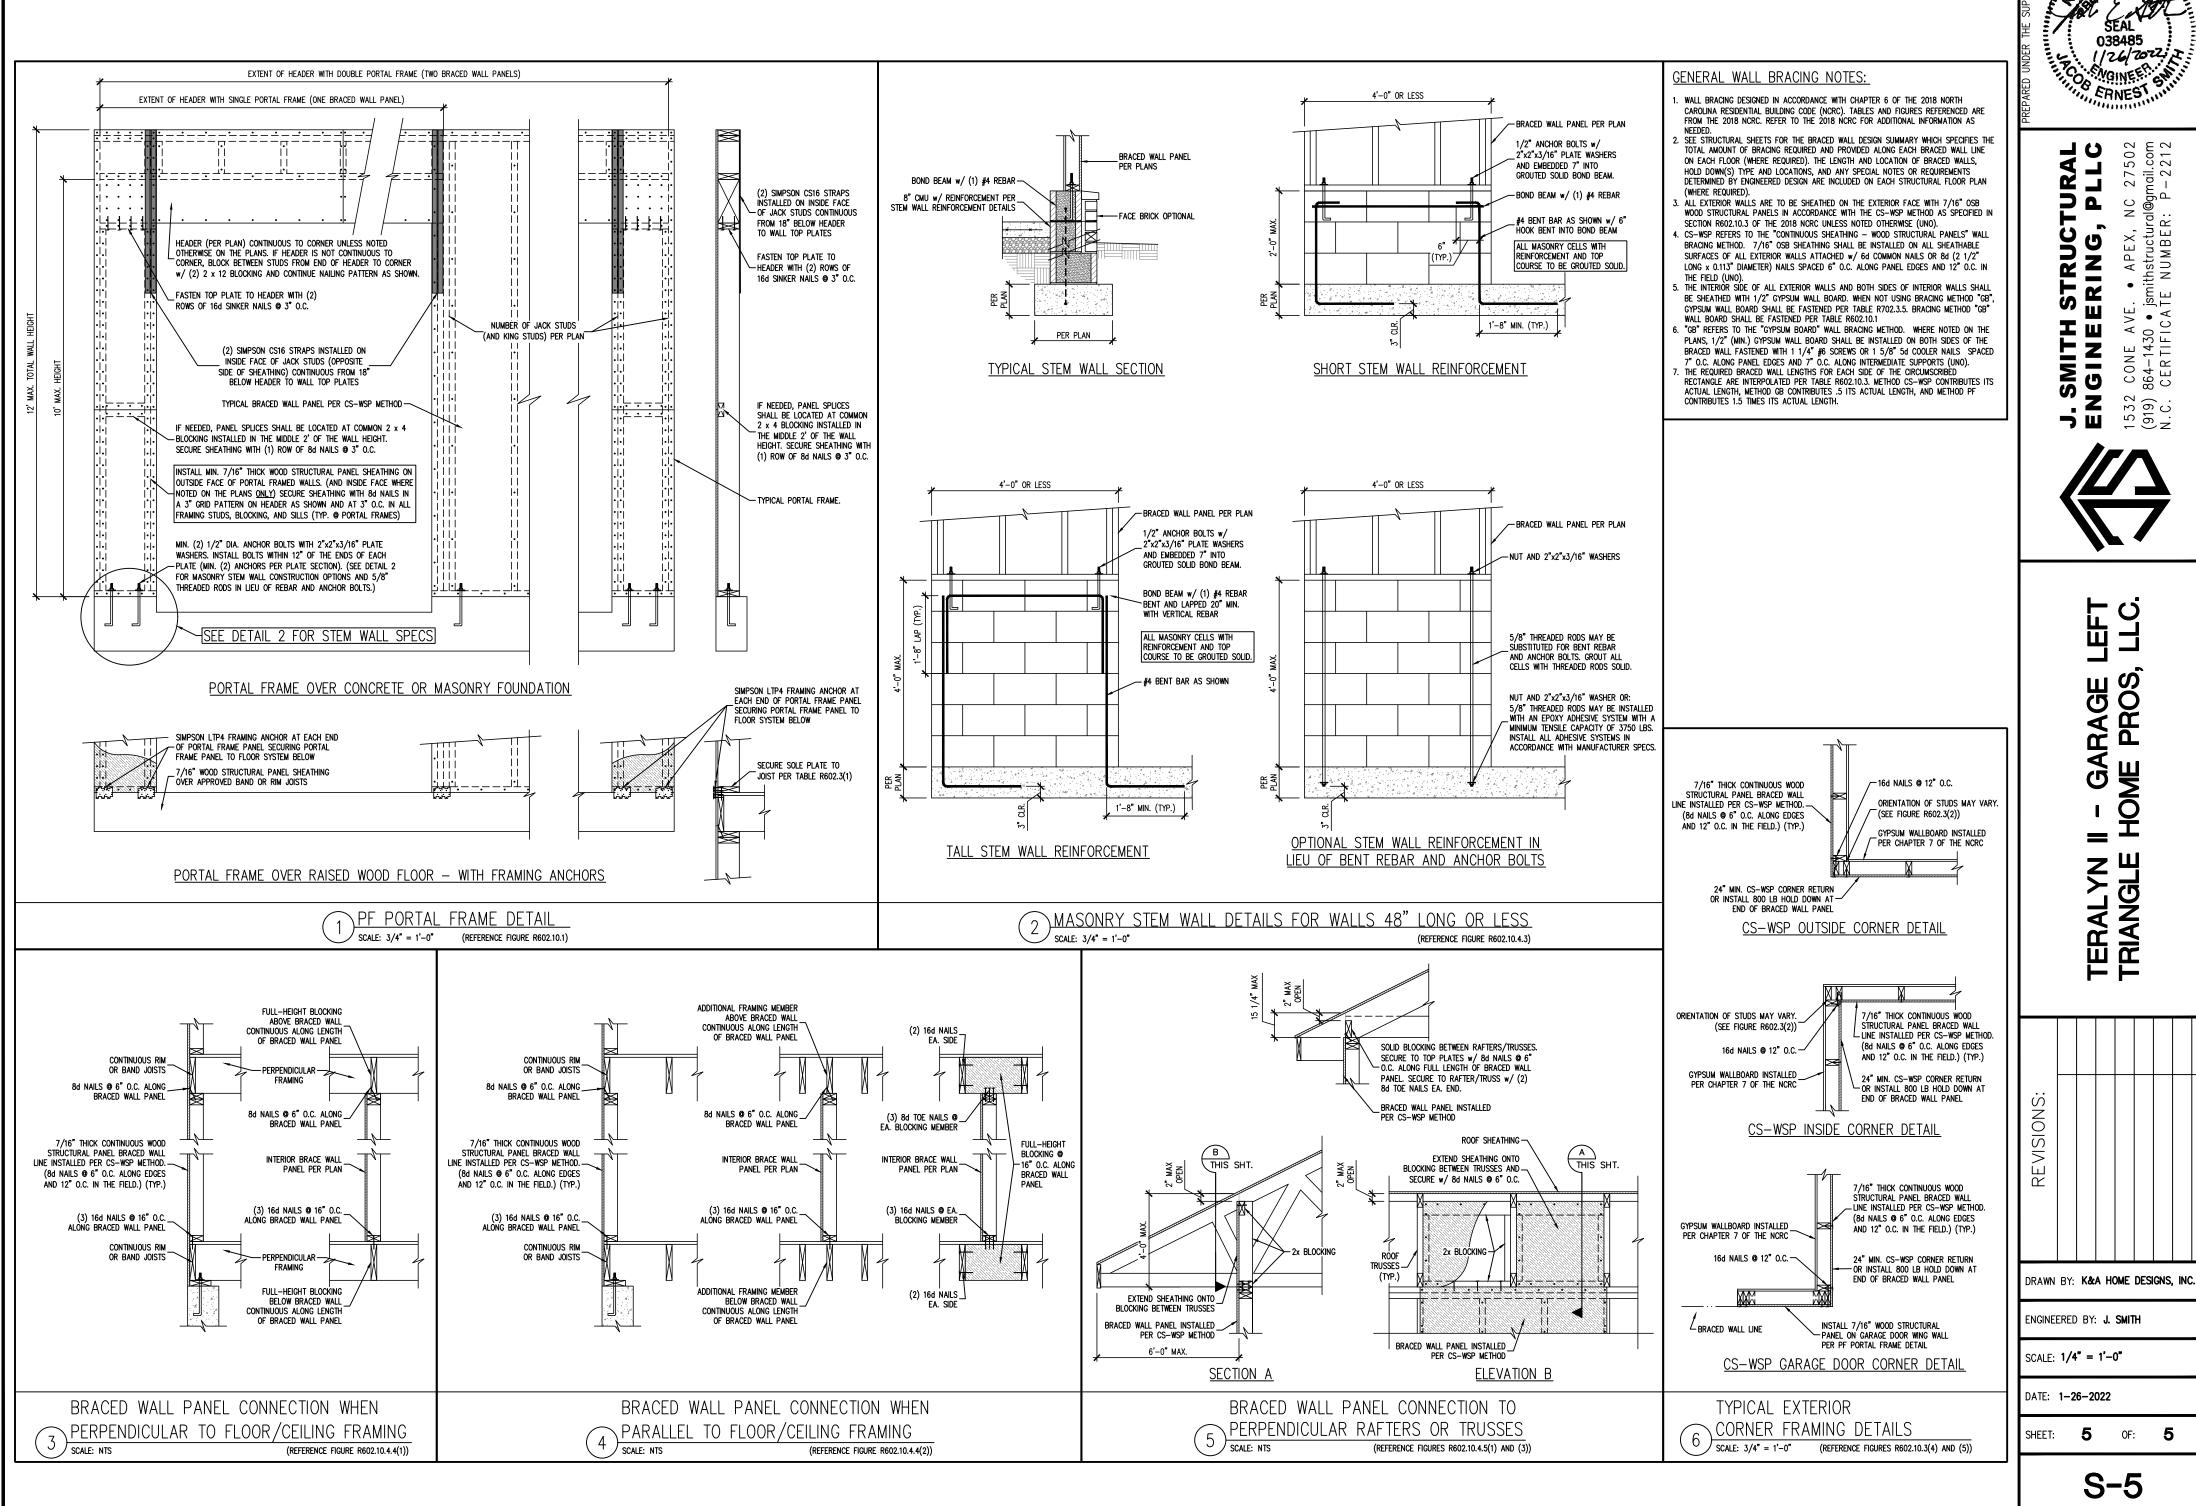
ENGINEERED BY: J. SMITH

SCALE: 1/4" = 1'-0"

DATE: **1-26-2022**

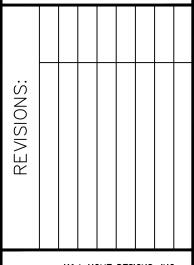SHEET: 4 OF: 5

S-4 ROOF FRAMING **PLAN**



DRAWN BY: K&A HOME DESIGNS, INC.

WALL BRACING

DETAILS AND NOTES