


C:\Users\Wade\Documents\Projects\Westan-Weaver\Magnolia\Magnolia\_GL\_6-30-20.dwg, 7/22/2020 6:47:56 AM

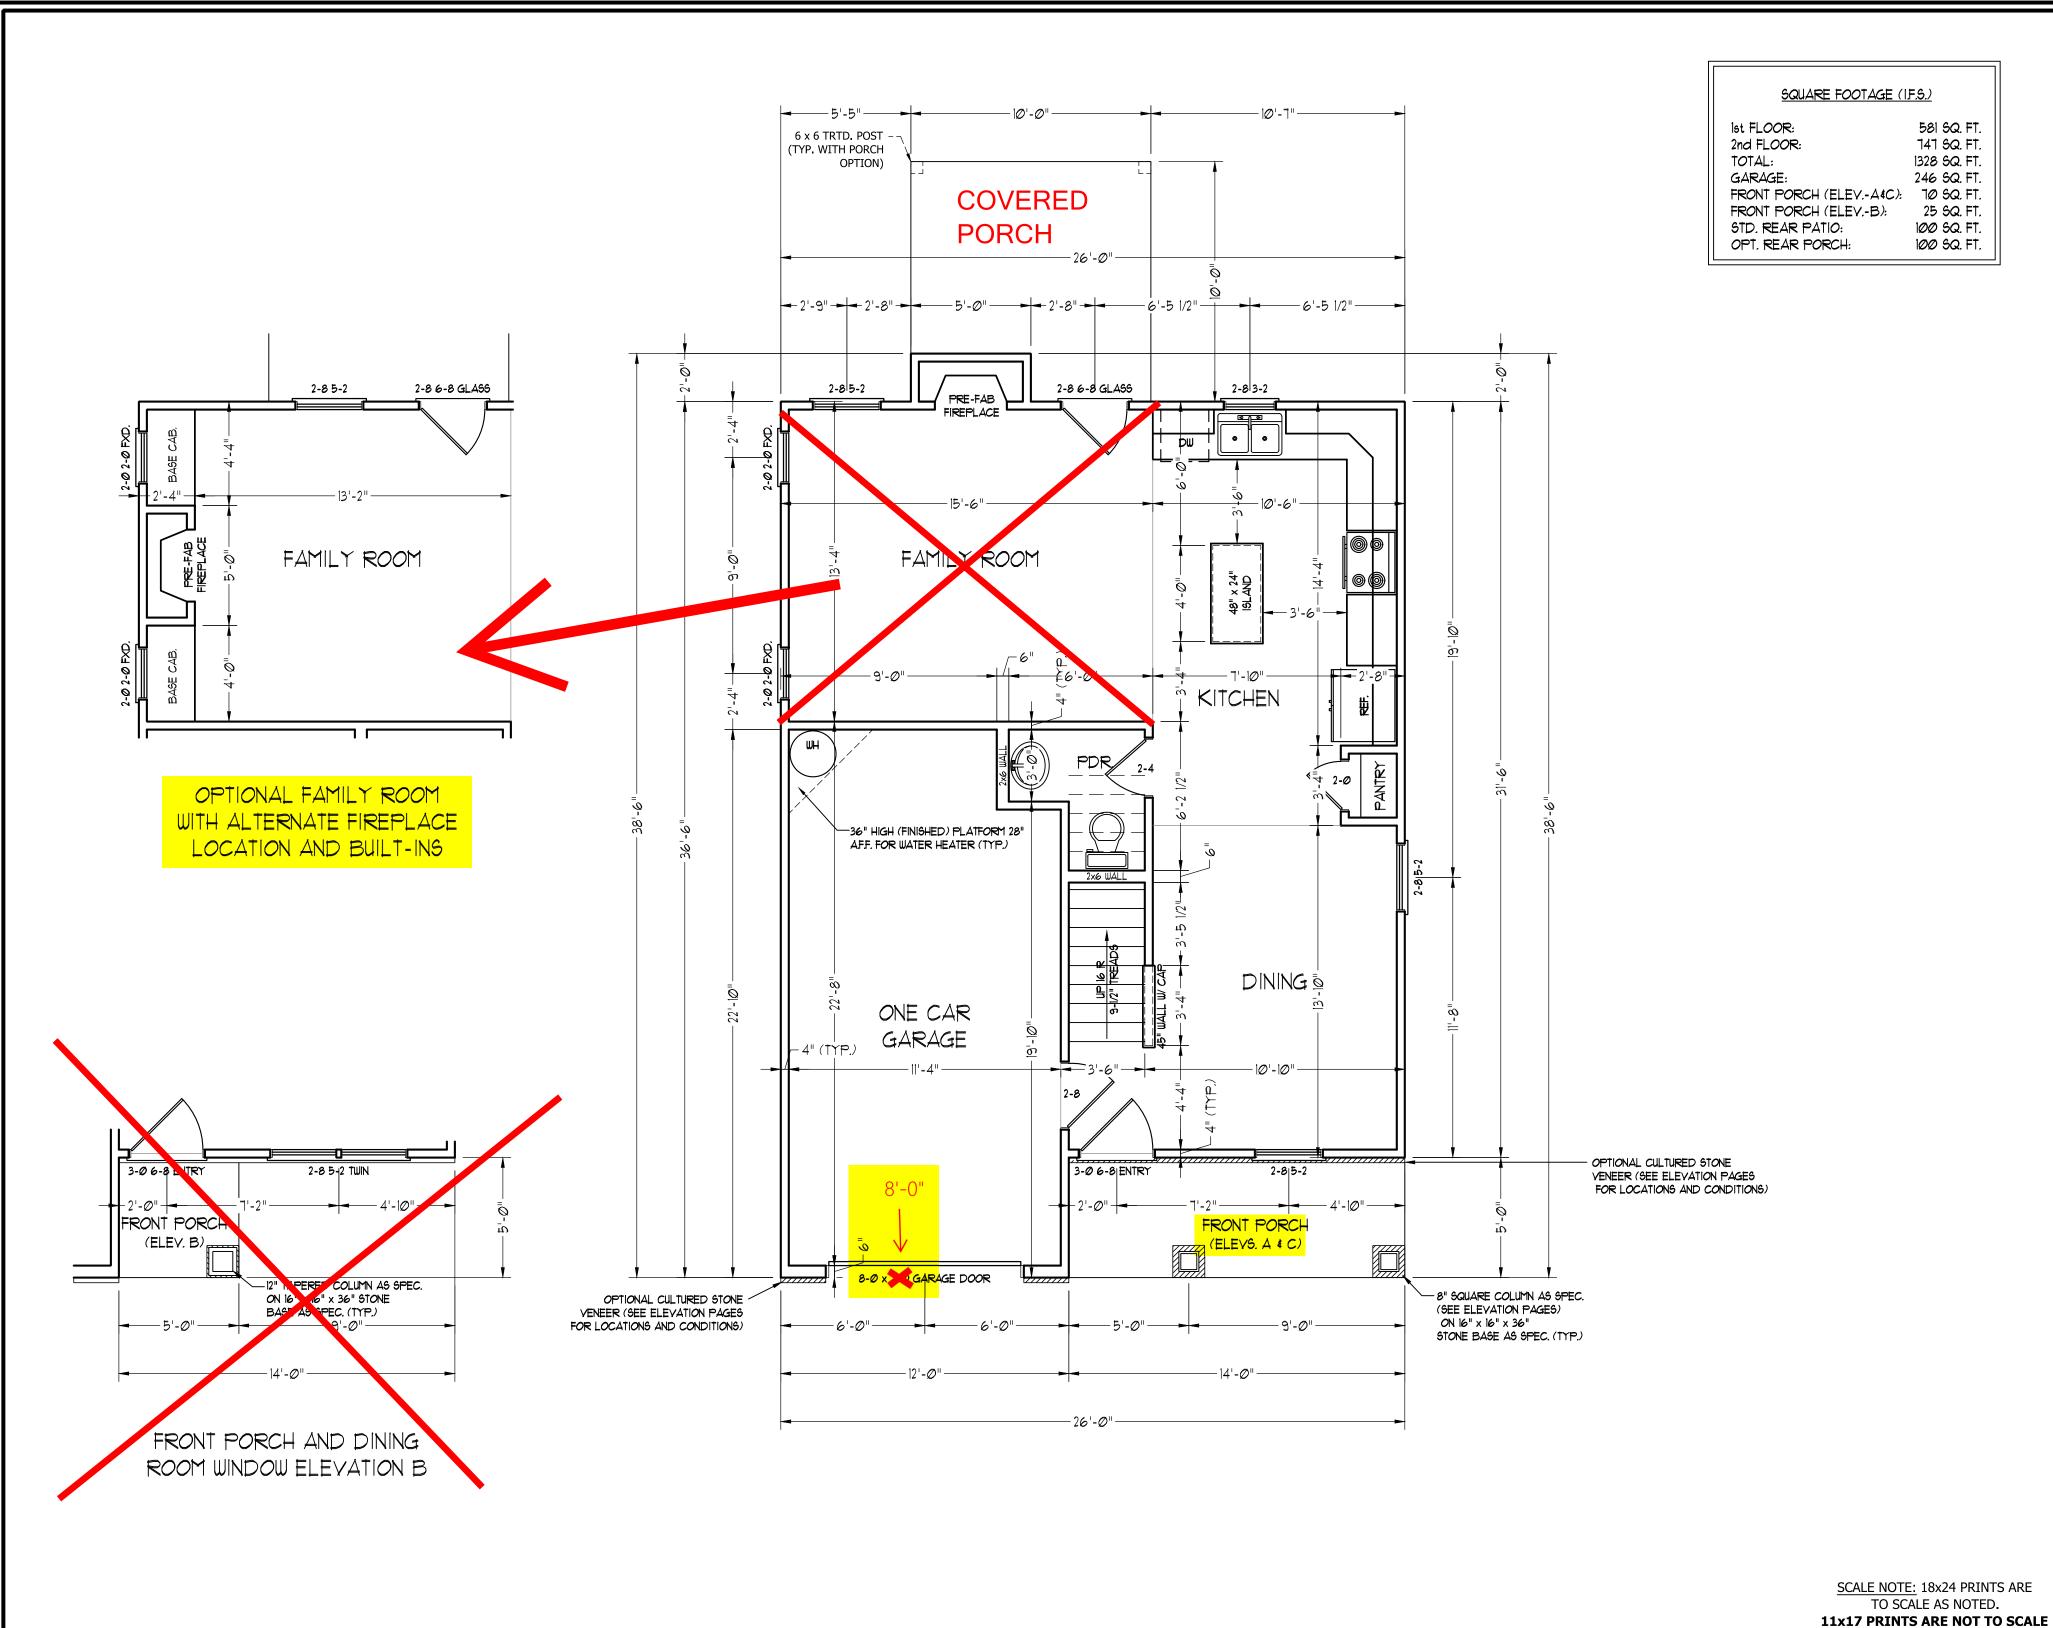

581 SQ. FT. 747 SQ. FT. 1328 SQ. FT. 246 SQ. FT. FRONT PORCH (ELEV.-A&C): 10 SQ. FT. 25 SQ. FT. 100 SQ. FT. 100 SQ. FT.



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WEAVER HOMES CAROLINA COLL MAGNOLIA DRIV

DATE: JUNE 30, 2020

REV.:

SCALE: 1/4" = 1'-0" DRAWN BY: WG


ENGINEERED BY:

REVIEWED BY:

FIRST FLOOR PLAN

A-4

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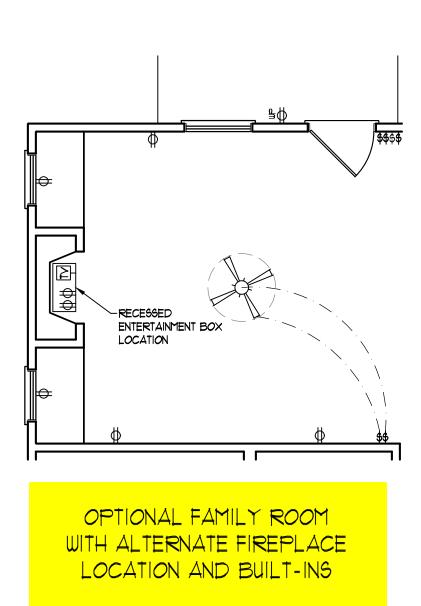
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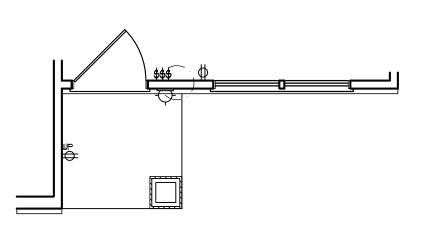
SECOND FLOOR PLAN

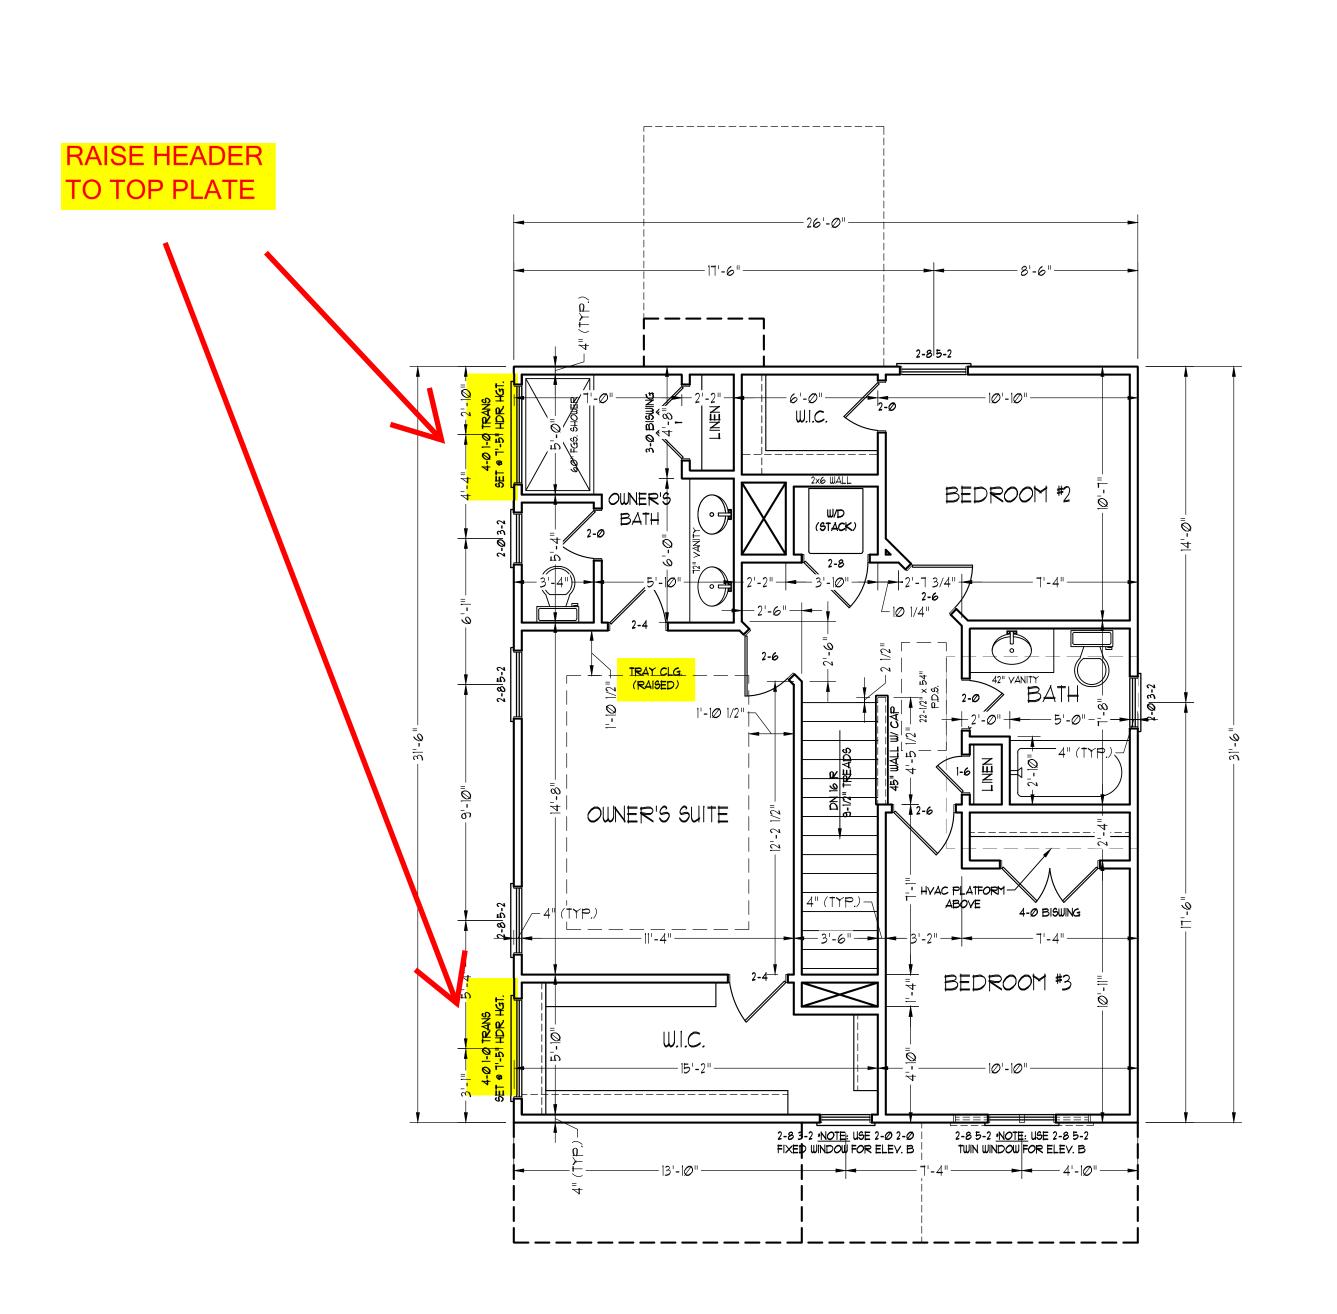A-5


SCALE NOTE: 18x24 PRINTS ARE TO SCALE AS NOTED.

11x17 PRINTS ARE NOT TO SCALE





FRONT PORCH AND DINING ROOM WINDOW ELEVATION B

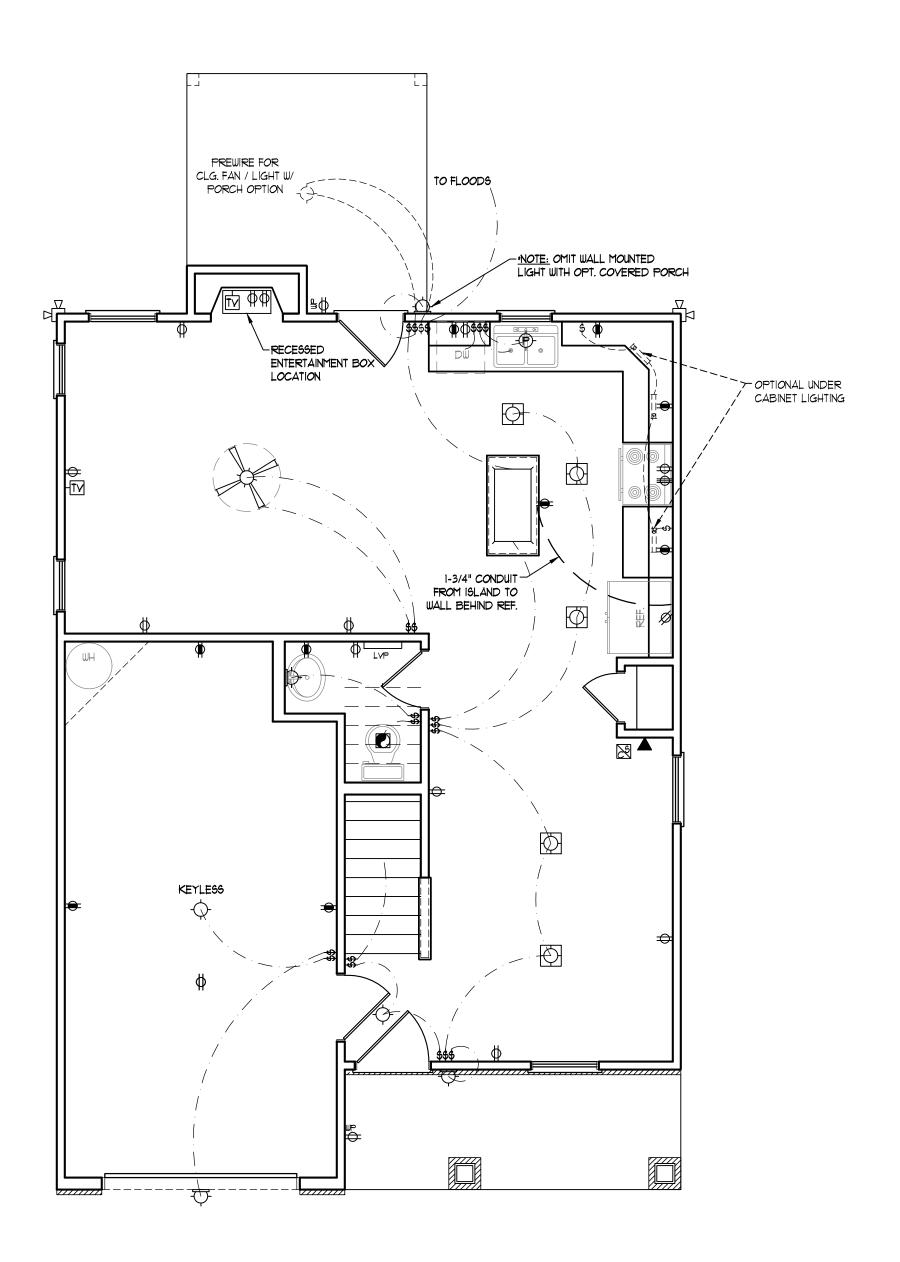

## ELECTRICAL LAYOUT NOTES:

- 1.) BLOCK AND WIRE FOR ALL CELING FANS PER PLAN.
- 2.) VANITY LIGHTS TO BE SET 90" A.F.F. (TYP.)
- 3.) ADDITIONAL EXTERIOR OUTLETS REQUIRED BY CODE TO BE LOCATED BY ELECTRICIAN.
- 4.) PLACE SWITCHES 8" (MIN.) FROM ROUGH OPENINGS.

## ELECTRICAL LEGEND

- → IIØ ∨ OUTLET
- € 110 Y GFI OUTLET
- = 110 Y SWITCHED OUTLET
- BB IIØ V BASEBOARD OUTLET
- 4-PLEX
- COUNTER OR FLOOR MOUNTED
- COUNTER OR FLOOR MOUNTED 110V GFI
- ₩EATHERPROOF
- **⇒** 220 ∨ OUTLET
- Ø 110 Y DEDICATED CIRCUIT
- # 220 Y DEDICATED CIRCUIT
- PH SPECIAL PURPOSE (240 V, ETC.)
- WALL MOUNT LIGHT
- ---- CEILING MOUNT LIGHT
- -P- PENDANT LIGHT
- RECESSED CAN LIGHT
- MINI CAN LIGHT
- EYEBALL LIGHT

FLUORESCENT LIGHT

undercabinet light

FLOOD LIGHT

DIMMER SWITCH

TELEPHONE AND DATA

SWITCH

TELEPHONE

△ DATA

TY- TY CONNECTION

TV/ DATA

CD- CONDUIT FOR COMPONENT WIRING

SPEAKER

110 V SMOKE/ CM DETECTOR

SD 110 Y SMOKE DETECTOR

EXHAUST FAN

LOW VOLTAGE PANEL

ALARM PANEL





SCALE NOTE: 18x24 PRINTS ARE TO SCALE AS NOTED. 11x17 PRINTS ARE NOT TO SCALE



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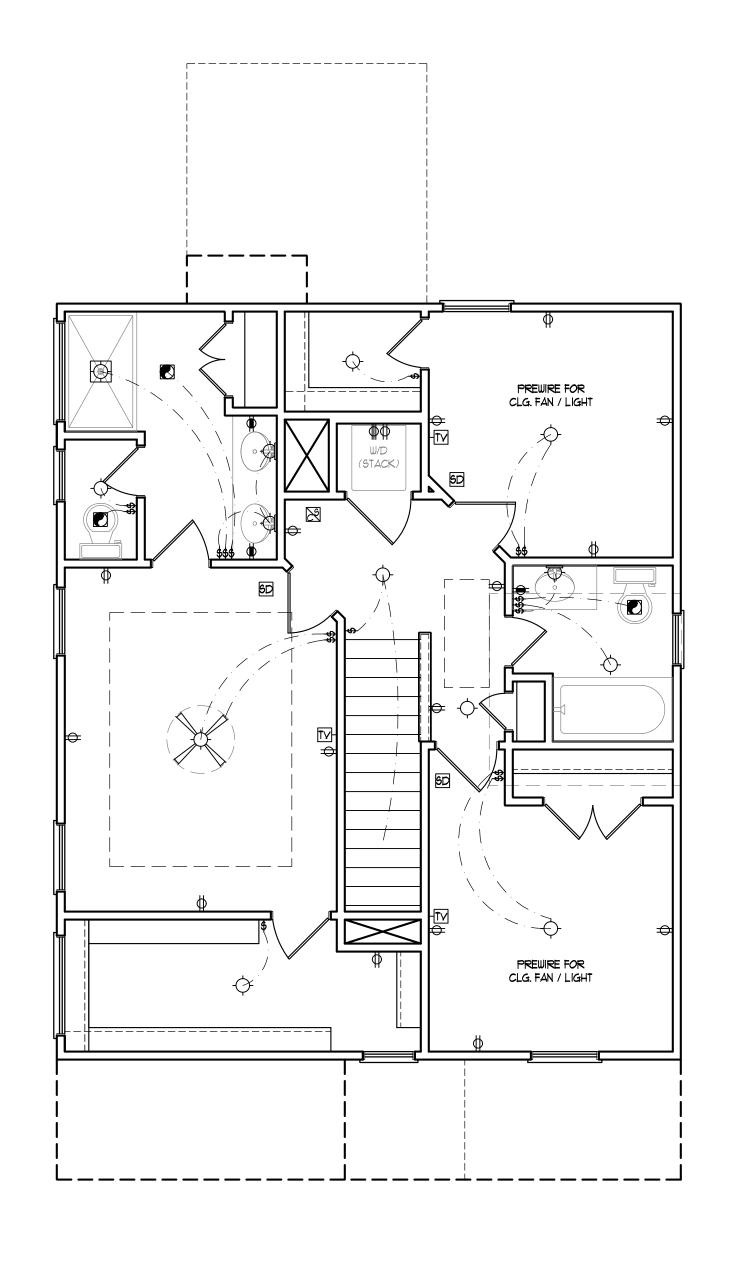
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ENGINEERED BY: REVIEWED BY:

FIRST FLOOR ELECTRICAL PLAN

E-1

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## ELECTRICAL LAYOUT NOTES:

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- 2.) VANITY LIGHTS TO BE SET @ 90" A.F.F. (TYP.)
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- € 110 Y GFI OUTLET
- → 110 V SWITCHED OUTLET
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- 4-PLEX
- COUNTER OR FLOOR MOUNTED
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- **⇒** 220 ∨ OUTLET
- 10 V DEDICATED CIRCUIT
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- WALL MOUNT LIGHT
- -P- PENDANT LIGHT
- RECESSED CAN LIGHT
- MINI CAN LIGHT
- EYEBALL LIGHT

FLUORESCENT LIGHT

undercabinet light

FLOOD LIGHT

SWITCH \$D DIMMER SWITCH

▲ TELEPHONE

 $\triangle$  data

- TELEPHONE AND DATA
- TV- TV CONNECTION
- TV/ DATA
- CD- CONDUIT FOR COMPONENT WIRING
- SPEAKER
- 110 V SMOKE/ CO DETECTOR
- SD 110 Y SMOKE DETECTOR

EXHAUST FAN



ALARM PANEL





SCALE NOTE: 18x24 PRINTS ARE TO SCALE AS NOTED. 11x17 PRINTS ARE NOT TO SCALE



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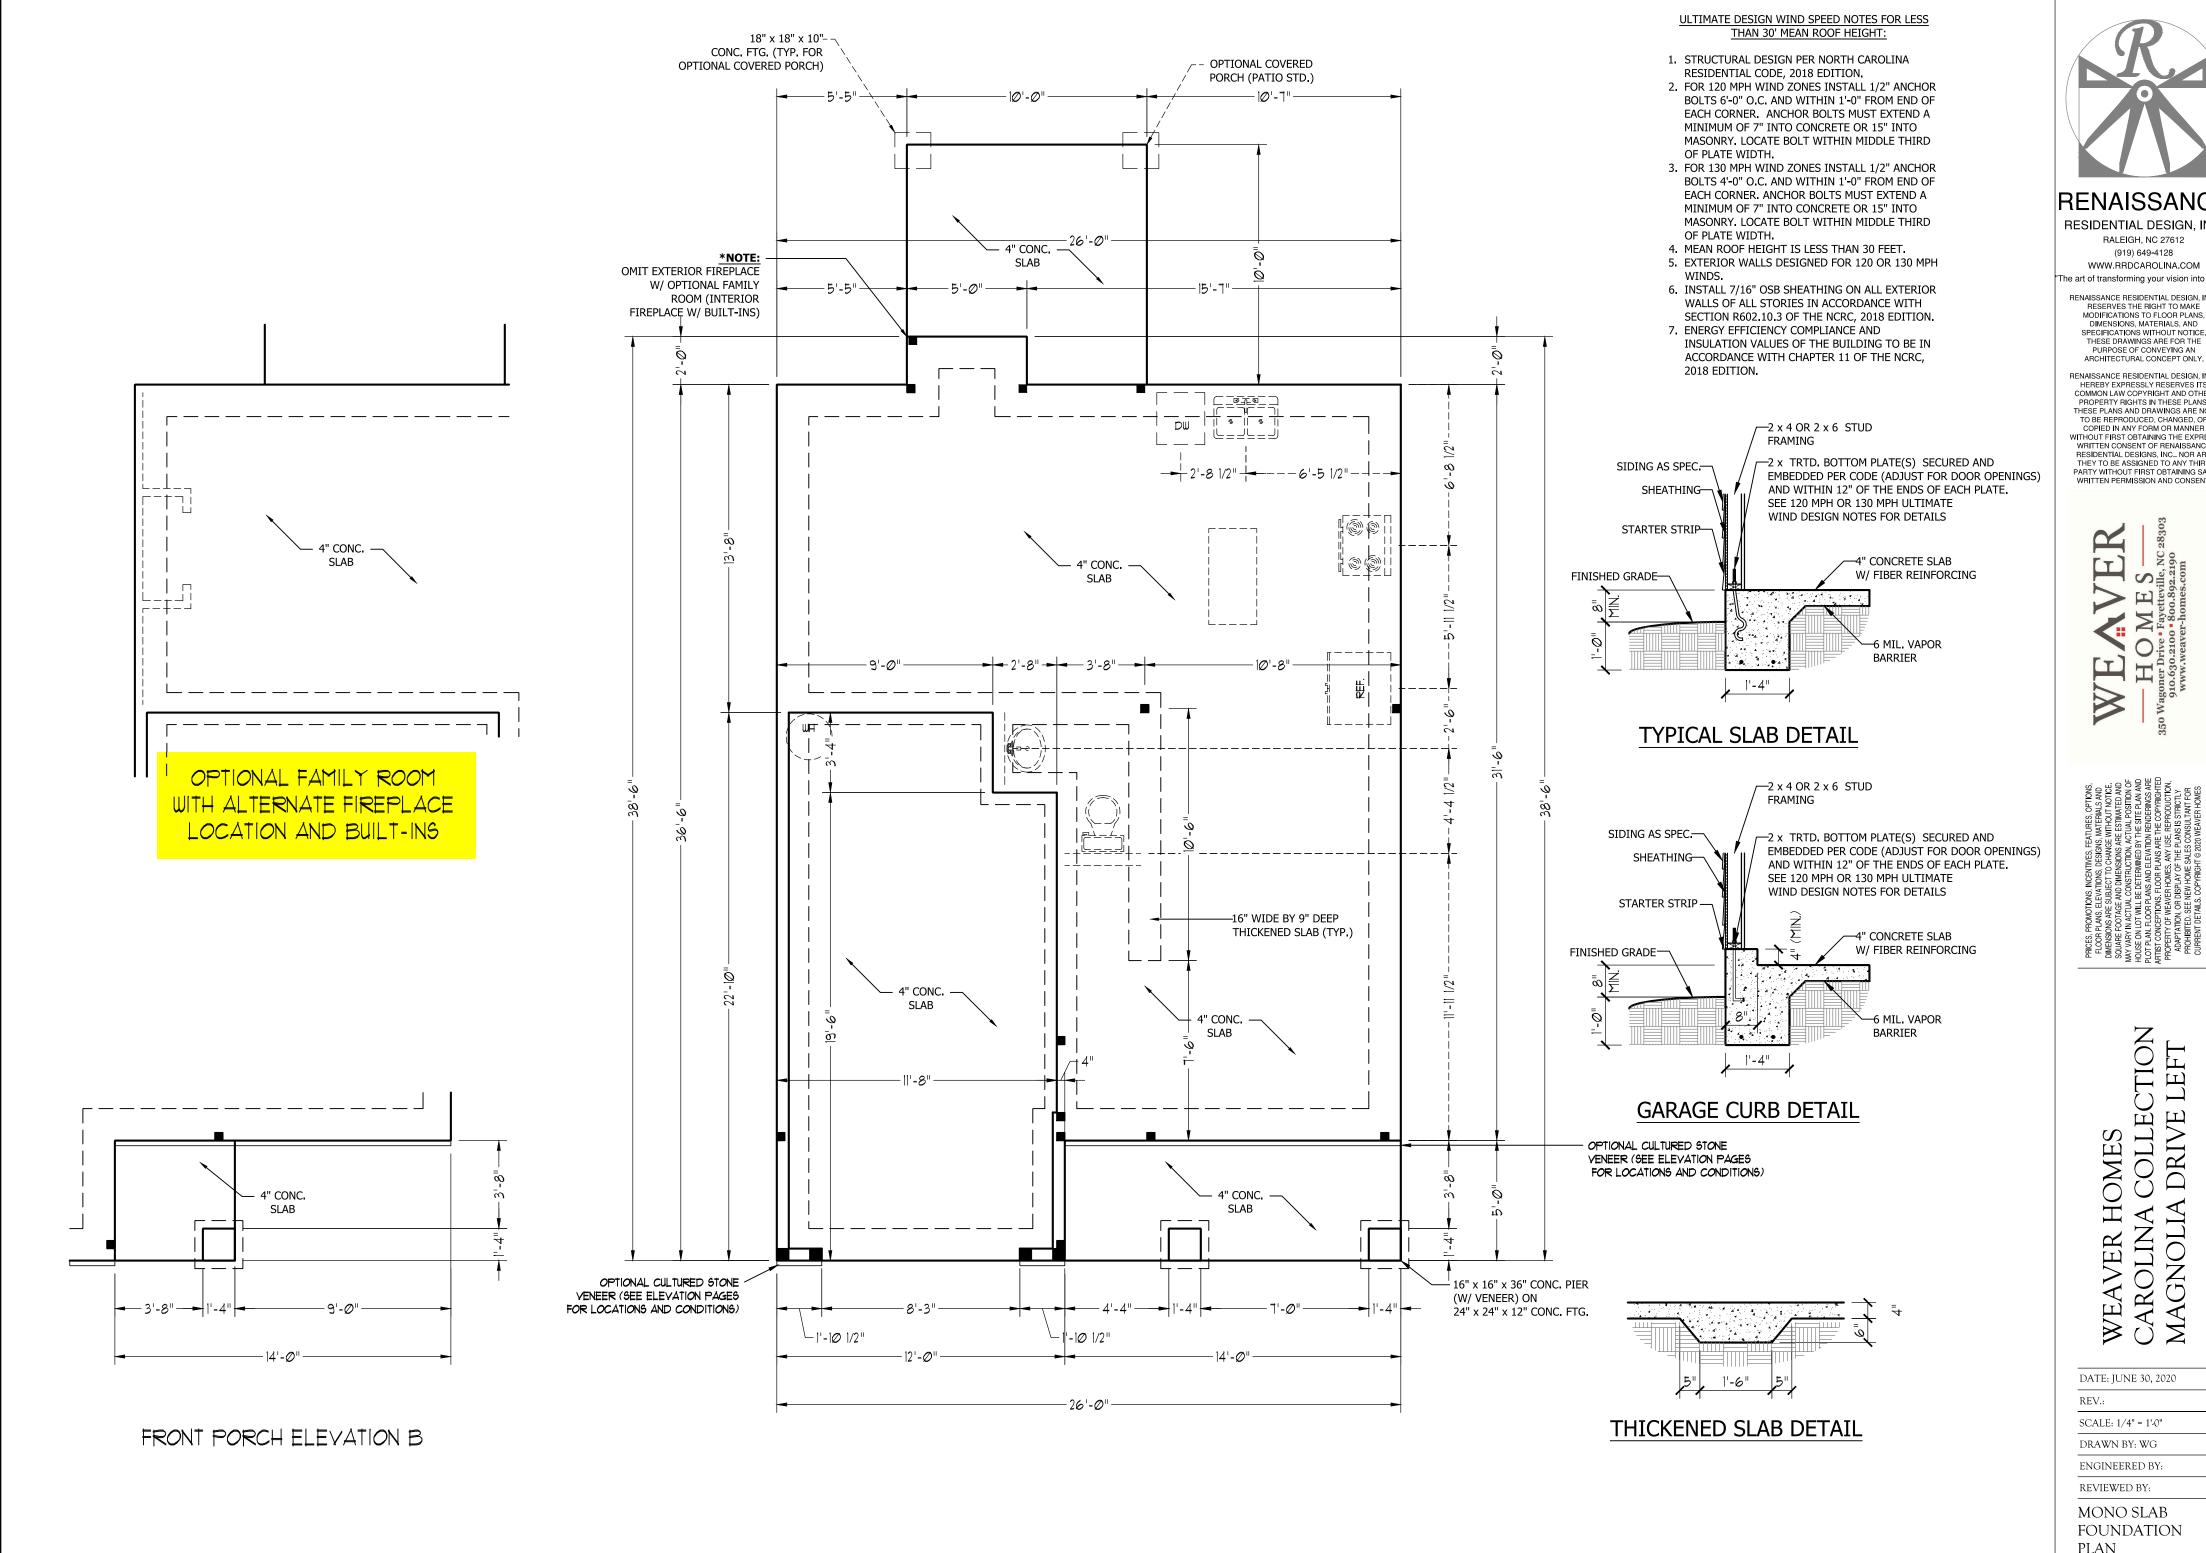
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SCALE: 1/4" = 1'-0" DRAWN BY: WG

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SECOND FLOOR ELCTRICAL PLAN

E-2



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WEAVER HOME CAROLINA COL DRI

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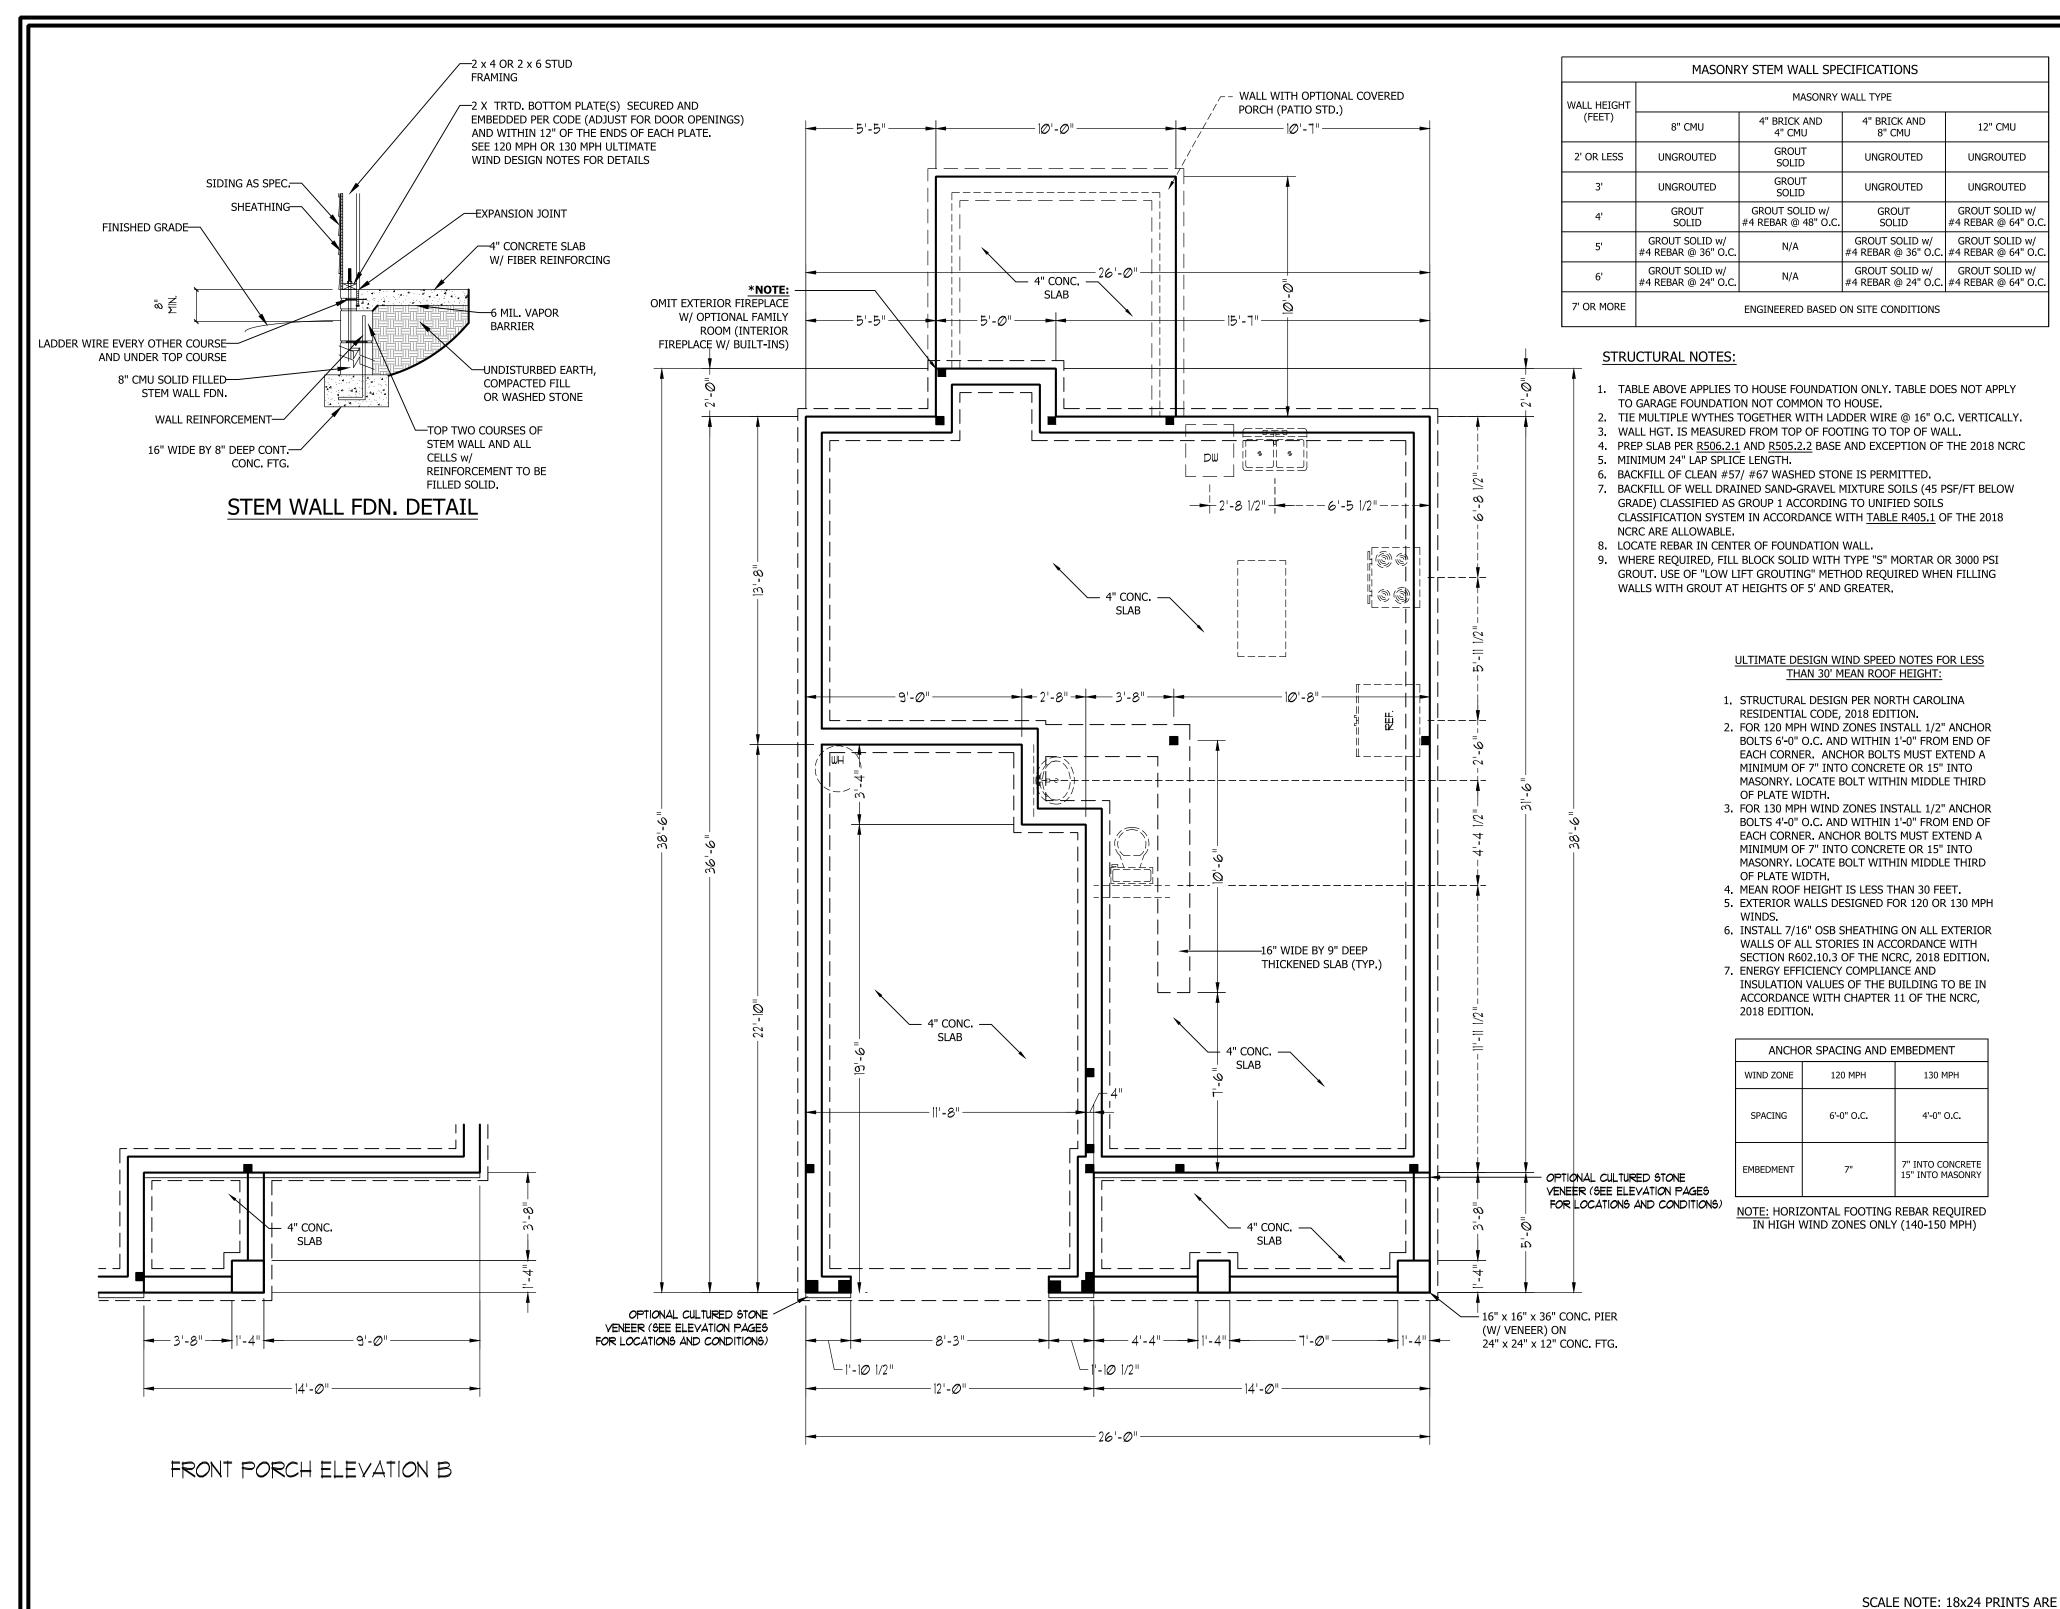
ENGINEERED BY:

REVIEWED BY:

MONO SLAB FOUNDATION PLAN

S-1

SCALE NOTE: 18x24 PRINTS ARE TO SCALE AS NOTED. 11x17 PRINTS ARE NOT TO SCALE



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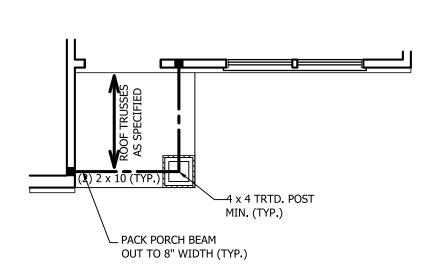
STEMWALL SLAB FOUNDATION PLAN

S-1

TO SCALE AS NOTED.

11x17 PRINTS ARE NOT TO SCALE

# OPTIONAL FAMILY ROOM WITH ALTERNATE FIREPLACE LOCATION AND BUILT-INS



FRONT PORCH AND DINING ROOM WINDOW ELEVATION B

## **STRUCTURAL NOTES:**


- 1. ALL FRAMING LUMBER TO BE SPF #2 (UNO). ALL TREATED LUMBER TO BE SYP #2
- 2. ALL LOAD BEARING HEADERS TO BE (2) 2 x 6 (UNO).
- 3. INSTALL AN EXTRA JOIST UNDER WALLS PARALLEL TO FLOOR JOISTS
- 4. WINDOW AND DOOR HEADERS TO BE SUPPORTED w/ (1) JACK STUD AND (1) KING STUD EA. END (UNO.). SEE TABLE R602.7.5 FOR ADDITIONAL KING STUD REQUIREMENTS.
- 5. SQUARES DENOTE POINT LOADS WHICH REQUIRE SOLID BLOCKING TO GIRDER OR FOUNDATION. ALL SQUARES TO BE (2) STUDS (UNO.)
- 6. ALL 4 X 4 POSTS SHALL BE ANCHORED TO SLABS W/ SIMPSON ABU44 POST BASES (OR EQUAL) AND 6 X 6 POSTS W/ ABU66 POST BASES (OR EQUAL) (UNO). ALL 4 X 4 AND 6 X 6 POSTS TO BE INSTALLED WITH 700 LB CAPACITY UPLIFT CONNECTORS
- 7. FOR FIBERGLASS, ALUMINUM, OR COLUMN ENG. BY OTHERS, SECURE TO SLAB W/ (2) METAL ANGLES USING 2" CONC. SCREWS. FASTEN ANGLES TO COLUMNS W/ 1/4" THROUGH BOLTS W/ NUTS AND WASHERS. LOCATE ANGLES ON OPPOSITE SIDES OF COLUMN. THROUGH BOLTS MUST BE INSTALLED PRIOR TO SETTING COLUMN.


## **BRACE WALL PANEL NOTES:**

**EXTERIOR WALLS:** ALL EXTERIOR WALLS TO BE SHEALTHED WITH

REQUIRED LENGTH OF BRACING: REQUIRED BRACE WALL LENGTH INTERPOLATED PER TABLE R602.10.3. METHODS CS-WSP AND CS-SFB CONTRIBUTE THIER ACTUAL LENGTH. METHOD GB CONTRIBUTES 0.5

SIDES OF INTERIOR WALLS TO HAVE 1/2" GYPSUM INSTALLED, WHEN

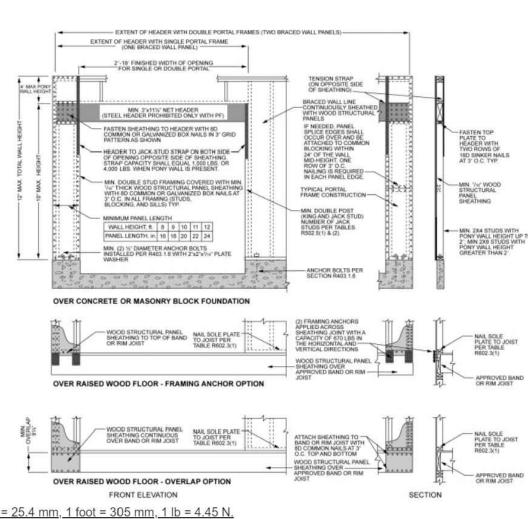

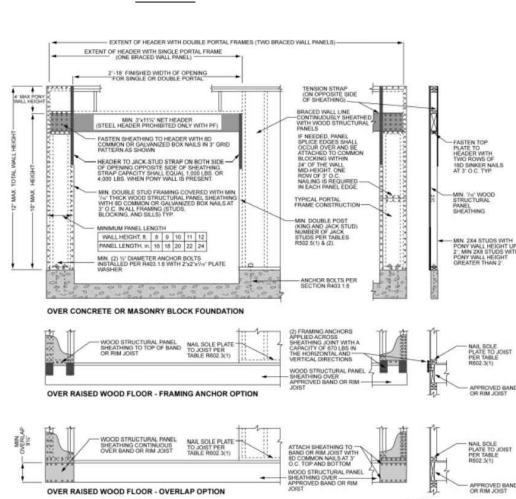



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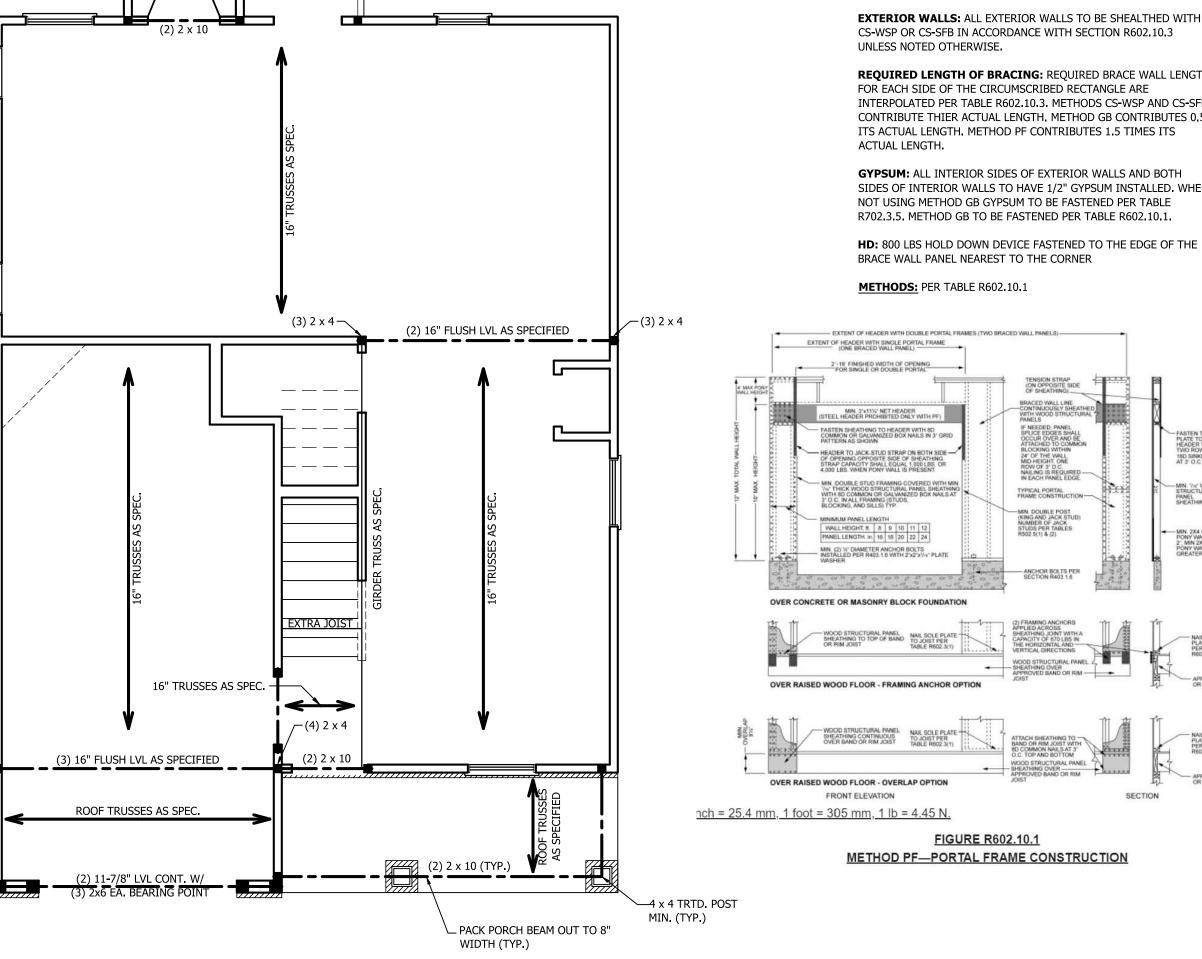
SCALE: 1/4" = 1'-0" DRAWN BY: WG

ENGINEERED BY:

REVIEWED BY:

SECOND FLOOR FRAMING PLAN

S-2



PACK PORCH BEAM OUT TO 8" WIDTH (TYP. W/ COVERED

PORCH OPTION)


(2) 2x10

6 x 6 TRTD. POST -(TYP. WITH PORCH

(4) 2 x 4 —

OPTION)

SCALE NOTE: 18x24 PRINTS ARE TO SCALE AS NOTED. 11x17 PRINTS ARE NOT TO SCALE

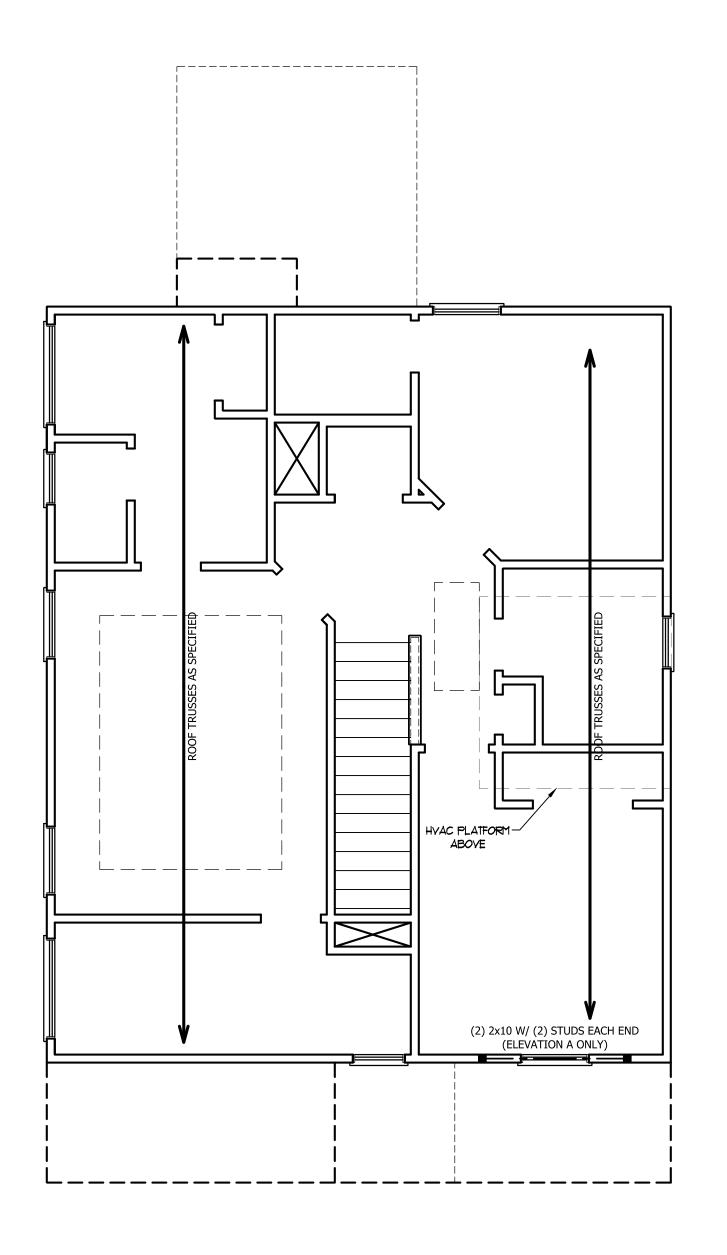

# TABLE R602.7.5 MINIMUM NUMBER OF FULL HEIGHT STUDS AT EACH END OF HEADERS IN EXTERIOR WALLS

HEADER SPAN (FEET)		SPACING (INCHES) E R602.3(5)
(. == . )	16	24
UP TO 3'	1	1
4'	2	1
8'	3	2
12'	5	3
16'	6	4
I	I	

## STRUCTURAL NOTES:

- 1. ALL FRAMING LUMBER TO BE SPF #2 (UNO). ALL TREATED LUMBER TO BE SYP #2 (UNO.)
- 2. ALL LOAD BEARING HEADERS TO BE (2) 2 x 6 (UNO).
- 3. WINDOW AND DOOR HEADERS TO BE SUPPORTED w/ (1) JACK STUD AND (1) KING STUD EA. END (UNO.). SEE TABLE R602.7.5 FOR ADDITIONAL KING STUD REQUIREMENTS.
- 4. SQUARES DENOTE POINT LOADS WHICH REQUIRE SOLID BLOCKING TO GIRDER OR FOUNDATION. ALL SQUARES TO BE (2) STUDS (UNO.)

DSP - DOUBLE STUD POCKET TSP - TRIPLE STUD POCKET



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WEAVER HOMES CAROLINA COLLECTION MAGNOLIA DRIVE LEFT

DATE: JUNE 30, 2020

REV.:

SCALE: 1/4" = 1'-0"

DRAWN BY: WG

ENGINEERED BY:

REVIEWED BY:

ATTIC FLOOR FRAMING PLAN

FRAMING P
S-3

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11x17 PRINTS ARE NOT TO SCALE


SCALE NOTE: 18x24 PRINTS ARE

## ATTIC VENT CALCULATION:


1040 SQ. FT. OF ATTIC DIVIDED BY 150 REQUIRES 6.9 SQ. FT. OF NET FREE VENTILATING AREA (MIN.).

## **STRUCTURAL NOTES:**

- 1. ALL FRAMING LUMBER TO BE #2 SPF (UNO).
- 2. HIP SPLICES ARE TO BE SPACED A MIN. OF 8'-0". FASTEN MEMBERS WITH THREE ROWS OF 12d NAILS @ 16" O.C. (TYP.)
- 3. STICK FRAME OVER-FRAMED ROOF SECTIONS W/ 2 x 8 RIDGES, 2 x 6 RAFTERS @ 16" O.C. AND FLAT 2 x 10 VALLEYS OR USE VALLEY TRUSSES.
- 4. FASTEN FLAT VALLEYS TO RAFTERS OR TRUSSES WITH SIMPSON H2.5A HURRICANE TIES @ 32" O.C. MAX. PASS HURRICANE TIES THROUGH NOTCH IN ROOF SHEATHING. EACH RAFTER IS TO BE FASTENED TO THE FLAT VALLEY WITH A MIN. OF (6) 12d TOE NAILS.
- 5. REFER TO SECTION R802.11 OF THE 2018 NCRC FOR REQUIRED UPLIFT RESISTANCE AT RAFTERS AND TRUSSES.

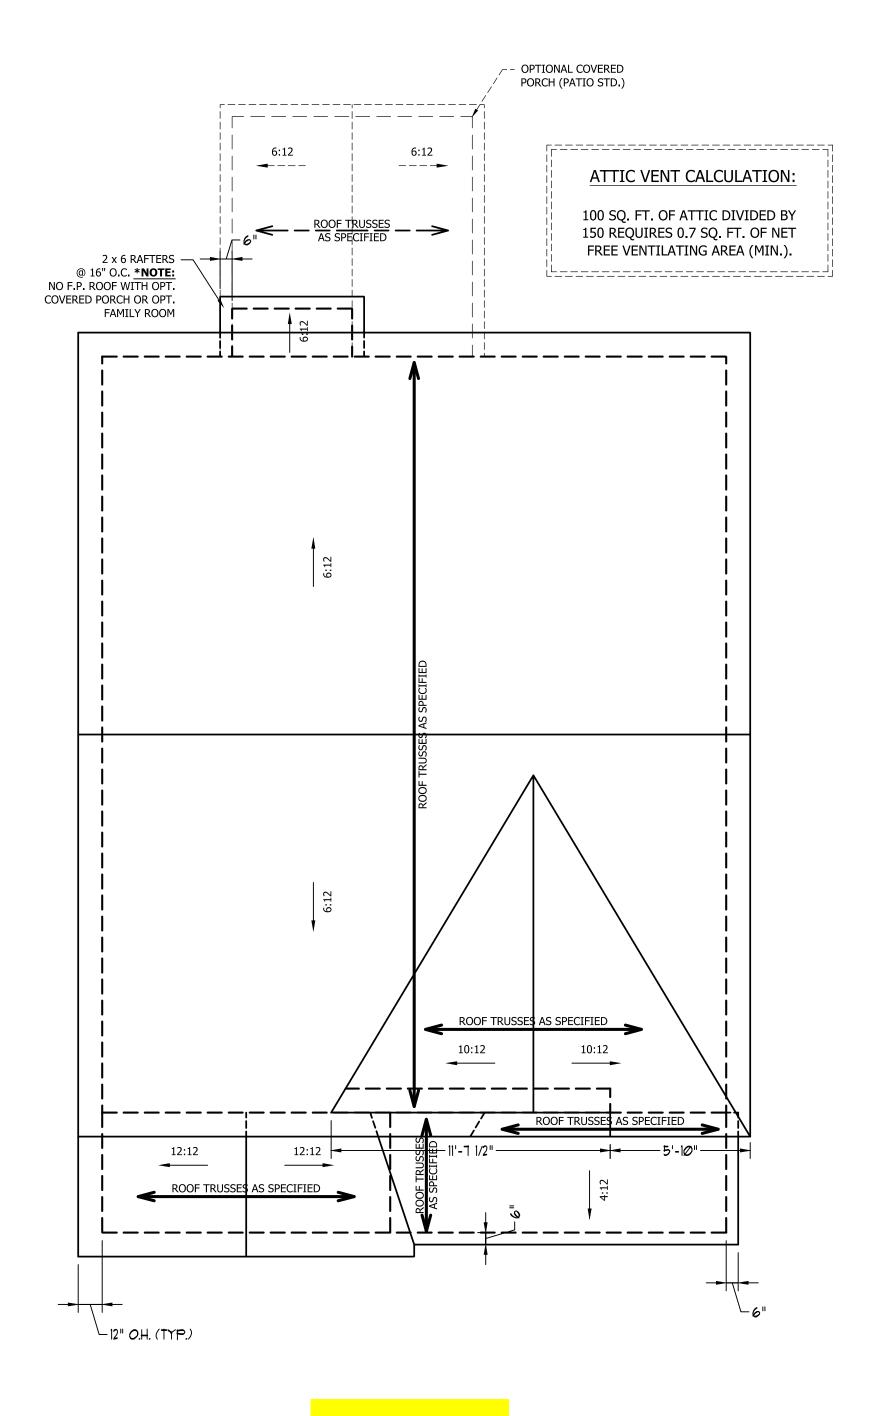

ELEVATION C

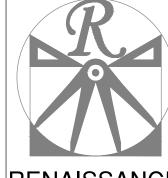

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CAROLINA COLLECTIO
MAGNOLIA DRIVE LEFT

DATE: JUNE 30, 2020

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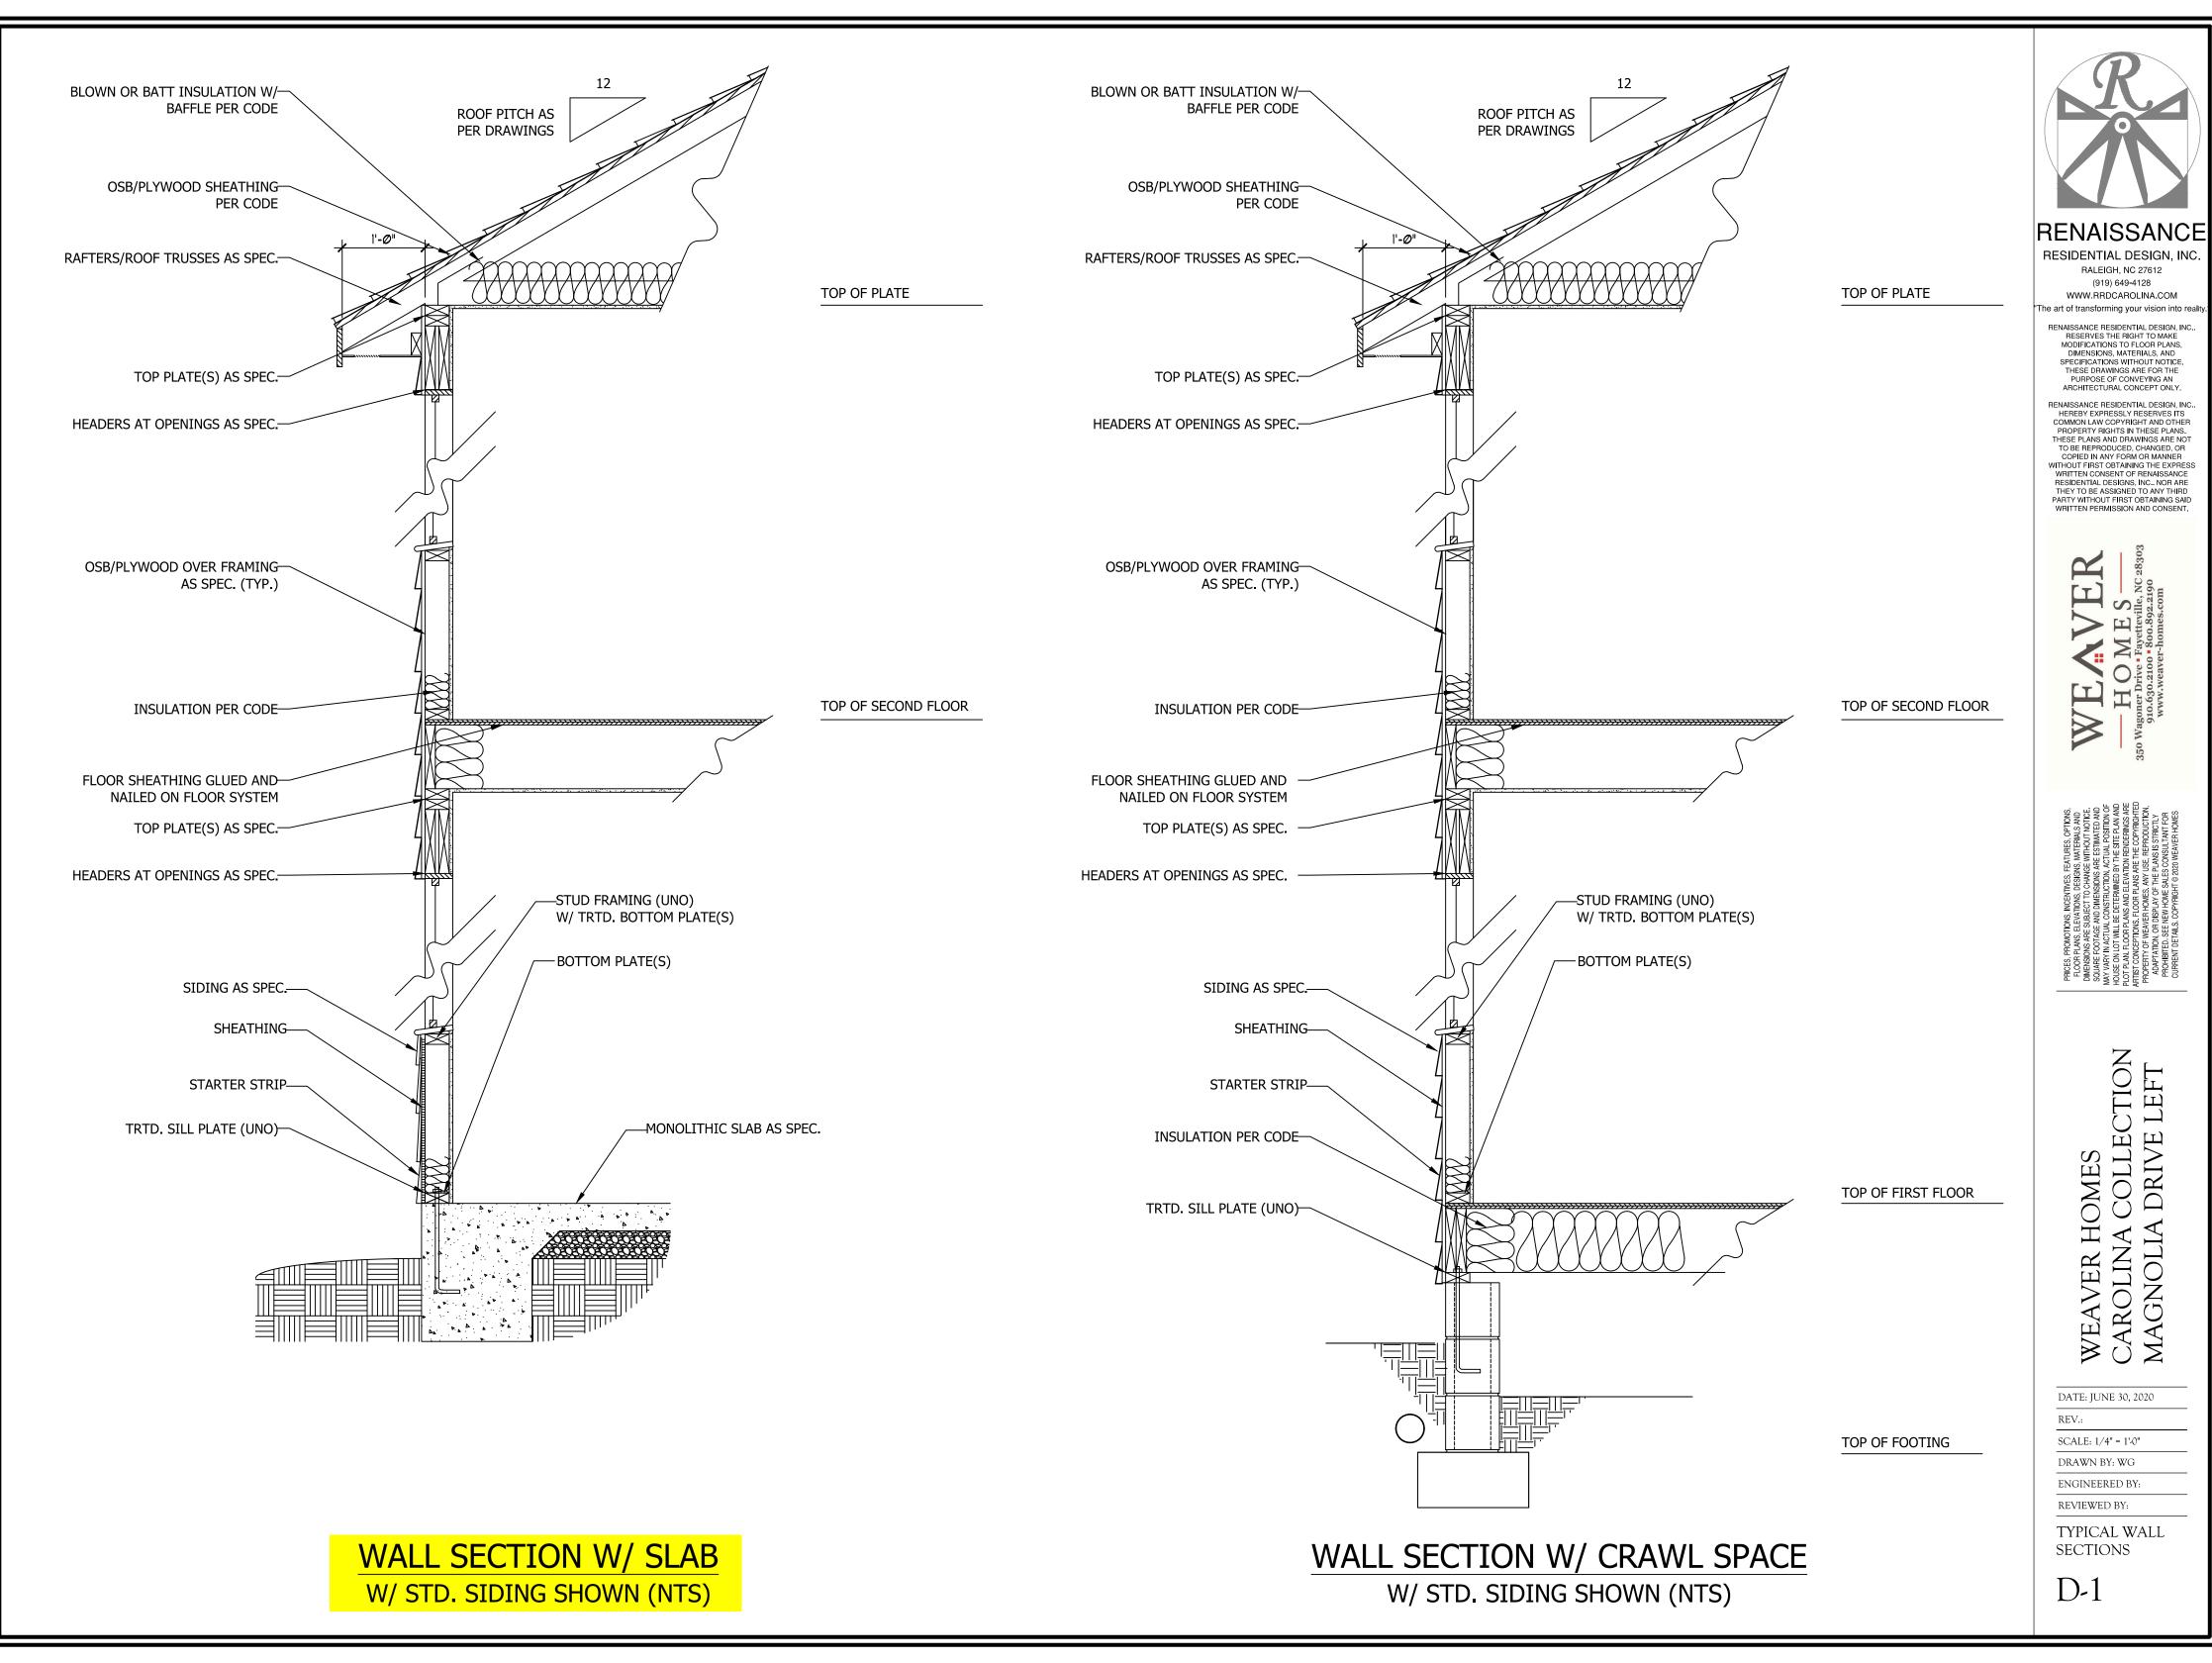
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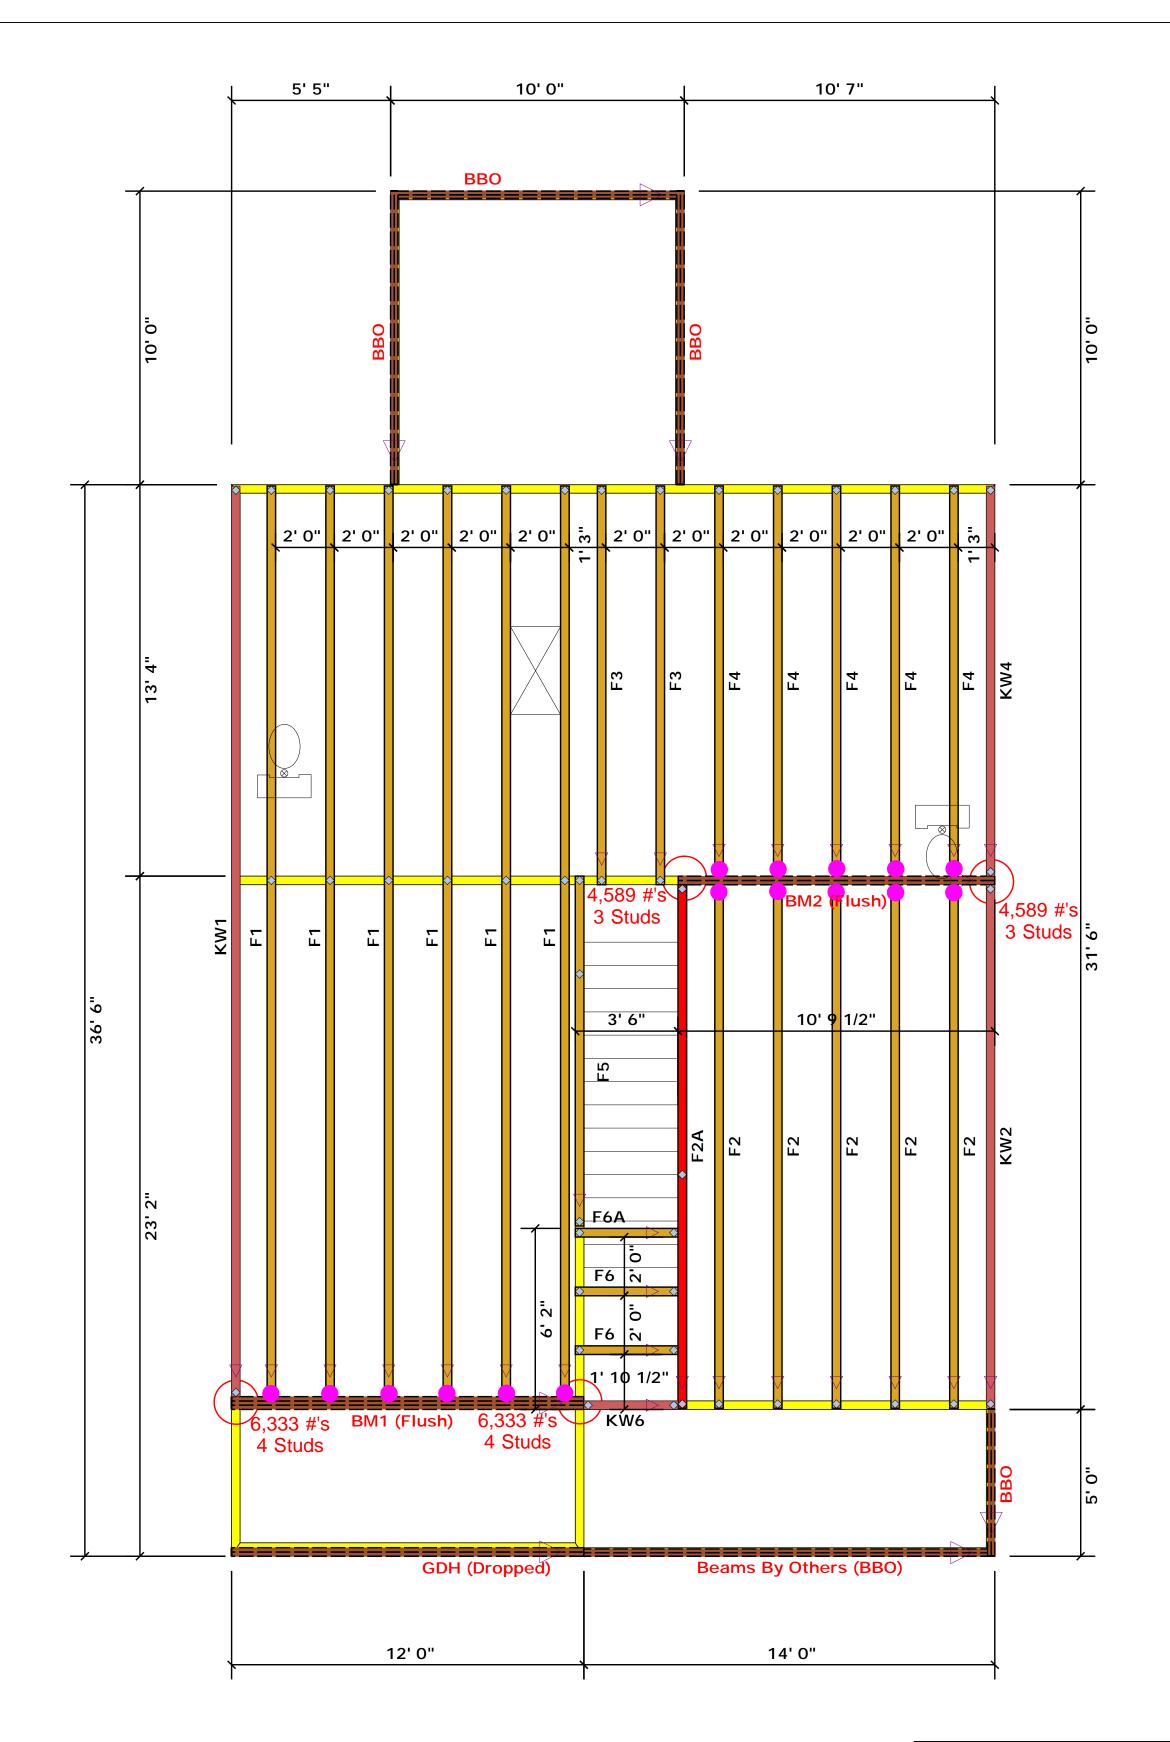
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REVIEWED BY:

ROOF PLAN ELEVATION - C

S-4





# Truss Placement Plan SCALE: NTS

▲= Denotes Left End of Truss
(Reference Engineered Truss Drawing)

= HUS410 (Qty. 16)


Products								
PlotID	Length	Product	Plies	Net Qty	Fab Type			
GDH (Dropped)	12' 0"	1-3/4"x 11-7/8" LVL Kerto-S	2	2	FF			
BM1 (Flush)	12' 0"	1-3/4"x 16" LVL Kerto-S	3	3	FF			
BM2 (Flush)	11' 0"	1-3/4"x 16" LVL Kerto-S	2	2	FF			

All Truss Reactions are Less than 3,000 lbs. Unless Noted Otherwise.

-- Denotes Reaction Greater than 3,000 lbs.
Reaction / # of Studs

LO	AD 6	HA	RT FO	ŖͿ	ACK.	STUD	5
			NIABE			**	
Mus	MC-8 C	# JAC	erando a Peadera			A CND OF	
SND REACTION (OT FO)	SQ DISTURS FOR CORN HEADER		MOTIONED DATE	ABOUT STUDS FOR CITAL STABER		END NIACTOON (01 °U)	REQUESTABLE FOR
1700	1		2550	1	1	3400	1
3400	2		5100	2		6800	2
5100	3		7650	3		10200	3
0086	4		10200	4		13600	4
8500	5		12750	5		17000	5
10200	á		15300	6			
11900	7						
13600	8						
15300	9						

					_		
(4) Mr. Hender	BUILDER	Weaver Development	CITY / CO.	Spring Lake / Harnett	THIS IS A These trus the building		
	JOB NAME	Lot 32-A Thomas Farm	ADDRESS	Bill Shaw Rd.	is responsi the overall walls, and o regarding b		
	PLAN	Magnolia Elev. C	MODEL	Floor	or online @  Bearing represcriptiv		
	SEAL DATE	Seal Date	DATE REV.	/ /	( derived fr foundation than 3000# be retained		
	QUOTE #	Quote #	DRAWN BY	Christine Shivy	specified in retained to		
	JOB #	J1221-6814	SALES REP.	Lenny Norris	Signatu		

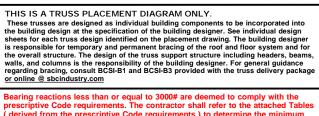


ROOF & FLOOR TRUSSES & BEAMS

pupport system for any reaction that exceeds those lables. A registered design professional shall be loort system for all reactions that exceed 15000#.

Christine Shivy

Christine Shivy

Reilly Road Industrial Park
Fayetteville, N.C. 28309
Phone: (910) 864-8787
Fax: (910) 864-4444

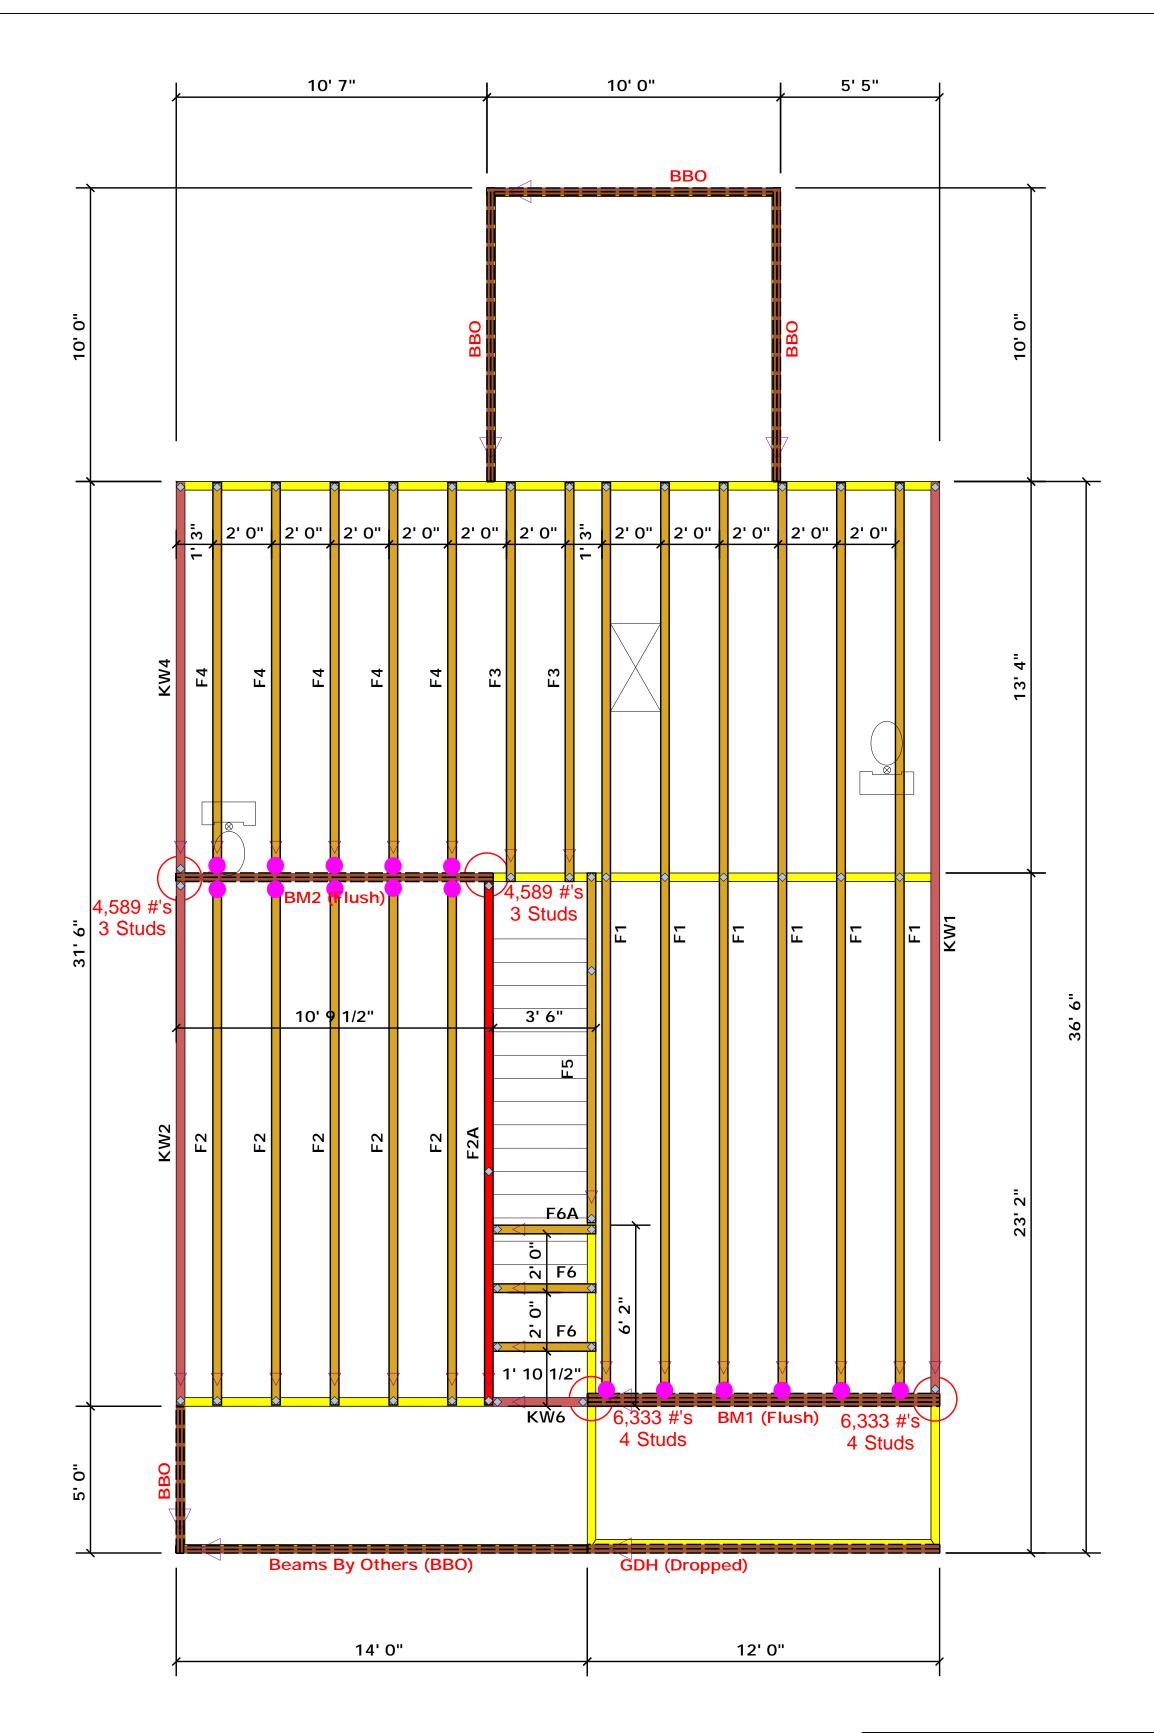

# Truss Placement Plan SCALE: NTS

▲= Denotes Left End of Truss (Reference Engineered Truss Drawing)

= HUS410 (Qty. 16)

Products								
PlotID	Length	Product	Plies	Net Qty	Fab Type			
GDH (Dropped)	12' 0"	1-3/4"x 11-7/8" LVL Kerto-S	2	2	FF			
BM1 (Flush)	12' 0"	1-3/4"x 16" LVL Kerto-S	3	3	FF			
BM2 (Flush)	11' 0"	1-3/4"x 16" LVL Kerto-S	2	2	FF			

All Truss Reactions are Less than 3,000 lbs. Unless Noted Otherwise.

-- Denotes Reaction Greater than 3,000 lbs. Reaction / # of Studs

LOAD CHART FOR JACK STUDS  MAND ON HABBE 85025() A 60)  MANUS OF JACK STUDS STORED BY CALCUS OF		(1) A (b)))	BUILDER	Weaver Development	CITY / CO.	Spring Lake / Harnett	THIS IS A TRUSS PLACEMENT DIAGRAM ONLY. These trusses are designed as individual building components to be industrially the building design at the specification of the building designer. See industrially sheets for each truss design identified on the placement drawing. The bright of the placement drawing.
50 64 64 65 65 65 65 65 65 65 65 65 65 65 65 65	PEADEWELROER	ROES Z 2 2 2 2 2 2 2 2 2 2 2 2 2 2 2 2 2 2	JOB NAME	Lot 32-A Thomas Farm	ADDRESS	Bill Shaw Rd.	is responsible for temporary and permanent bracing of the roof and floor the overall structure. The design of the truss support structure including walls, and columns is the responsibility of the building designer. For ger regarding bracing, consult BCSI-B1 and BCSI-B3 provided with the truss
	BND PEACT CIT ALC CIT ALC CIT ALC ALC CIT ALC	8 9 9 8 8 8 8 8 8 8 8 8 8 8 8 8 8 8 8 8	PLAN	Magnolia Elev. C	MODEL	Floor	or online @ sbcindustry.com  Bearing reactions less than or equal to 3000# are deemed to comprescriptive Code requirements. The contractor shall refer to the
	5100 2 7650 3	3400 1 6600 2 10200 3	SEAL DATE	Seal Date	DATE REV.	/ /	( derived from the prescriptive Code requirements ) to determine foundation size and number of wood studs required to support re than 300# but not greater than 1500#. A registered design profe be retained to design the support system for any reaction that ex
6800 4 8500 5 10200 6	10200 4 12750 5 15300 6	13600 4 17000 5	QUOTE #	Quote #	DRAWN BY	Christine Shivy	specified in the attached Tables. A registered design professional retained to design the support system for all reactions that excee
11900 7 13600 8 15300 g			JOB #	J1221-6814	SALES REP.	Lenny Norris	Signature Christine Shivy


DIAGRAM ONLY. lual building components of the building designer.

ristine Shivy

**ROOF & FLOOR TRUSSES & BEAMS** Reilly Road Industrial Park Fayetteville, N.C. 28309 Phone: (910) 864-8787

Fax: (910) 864-4444

соттесн

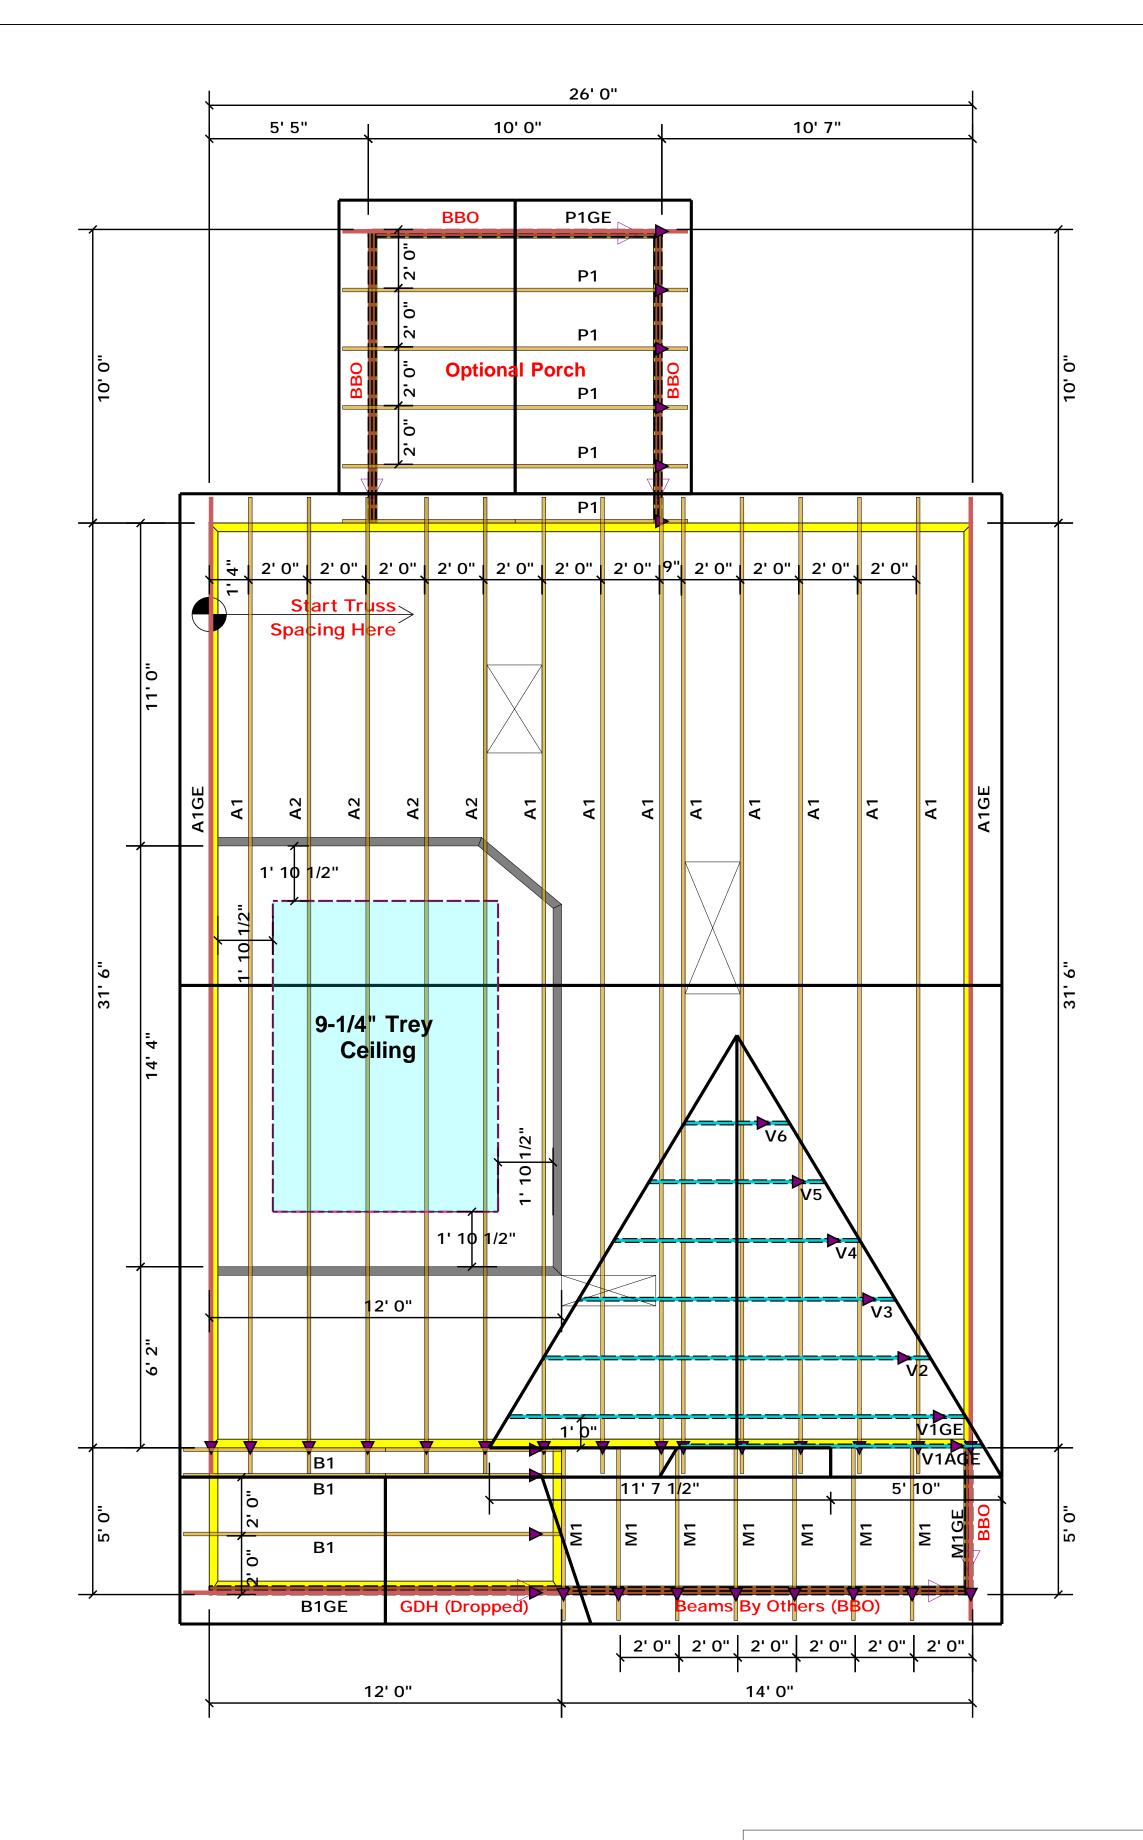

All Truss Reactions are Less than 3,000 lbs. Unless Noted Otherwise.

) -

-- Denotes Reaction Greater than 3,000 lbs.

Reaction / # of Studs

▲= Denotes Left End of Truss (Reference Engineered Truss Drawing)

LOAD CHART FOR JACK STUDS

(BASED ON LABOR (500.51) A 60)

STANCE OF JACK STUDO ALS INSIDE (A COD OF FEACURETOES)

2550 1 5100 2

7650 3

10200 4 12750 5

15300 6

3400

6600 2

10200 3

13600 4

17000 5

1700 1 3400 2

# Truss Placement Plan SCALE: NTS

		<u> </u>			
	BUILDER	Weaver Development	CITY / CO.	Spring Lake / Harnett	TH The
i i	JOB NAME	Lot 32-A Thomas Farm	ADDRESS	Bill Shaw Rd.	she is re the wal reg
334	PLAN	Magnolia Elev. C	MODEL	Roof	Bea pre
	SEAL DATE	Seal Date	DATE REV.	/ /	pre ( de fou that be
	QUOTE #	Quote #	DRAWN BY	Christine Shivy	spe reta
	JOB #	J1221-6813	SALES REP.	Lenny Norris	

THIS IS A TRUSS PLACEMENT DIAGRAM ONLY.

These trusses are designed as individual building components to be incorporated into the building design at the specification of the building designer. See individual design sheets for each truss design identified on the placement drawing. The building designer is responsible for temporary and permanent bracing of the roof and floor system and for the overall structure. The design of the truss support structure including headers, beams, walls, and columns is the responsibility of the building designer. For general guidance regarding bracing, consult BCSI-B1 and BCSI-B3 provided with the truss delivery package or online @ sbcindustry.com


Bearing reactions less than or equal to 3000# are deemed to comply with the prescriptive Code requirements. The contractor shall refer to the attached Tables ( derived from the prescriptive Code requirements ) to determine the minimum foundation size and number of wood studs required to support reactions greater than 3000# but not greater than 15000#. A registered design professional shall be retained to design the support system for any reaction that exceeds those specified in the attached Tables. A registered design professional shall be retained to design the support system for all reactions that exceed 15000#.

Christine Shivy

Christine Shivy



Phone: (910) 864-8787 Fax: (910) 864-4444

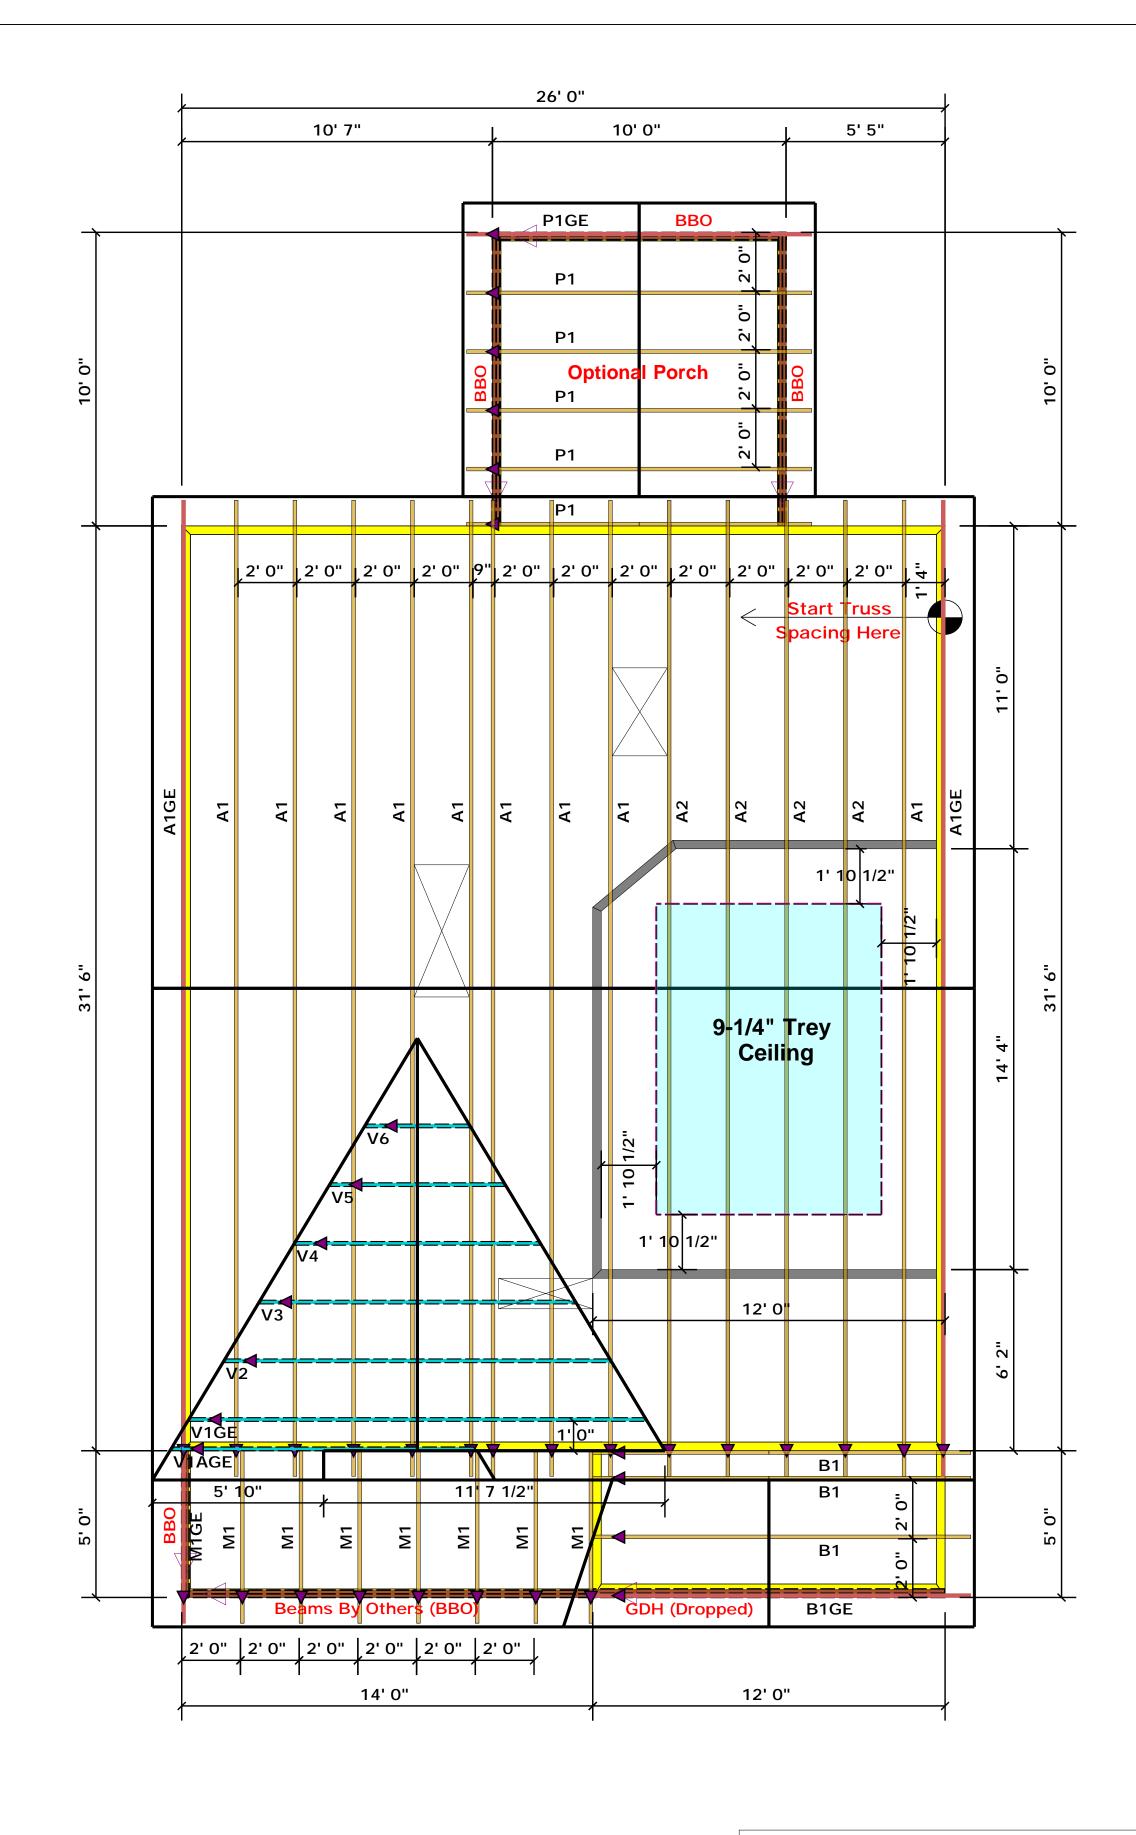

All Truss Reactions are Less than 3,000 lbs. Unless Noted Otherwise.

) -

-- Denotes Reaction Greater than 3,000 lbs.

Reaction / # of Studs

▲ = Denotes Left End of Truss

(Reference Engineered Truss Drawing)

LOAD CHART FOR JACK STUDS
(BASED ON MILES (\$00.51) A 60)
MILHAGO OF JACK STUDO ALS (BACK) OF CA CAD OF FEADER/SERGER

2550 1 5100 2

7650 3

10200 4 12750 5

15300 6

3400 !

10200 3

13600 4

17000 5

6600 2

Truss Placement Plan SCALE: NTS

Engineere	d Truss Drawing)	SCALE	E: NTS
BUILDER	Weaver Development	CITY / CO.	Spring Lake / Harnett
JOB NAME	Lot 32-A Thomas Farm	ADDRESS	Bill Shaw Rd.
PLAN	Magnolia Elev. C	MODEL	Roof
SEAL DATE	Seal Date	DATE REV.	/ /
QUOTE #	Quote #	DRAWN BY	Christine Shivy
JOB #	J1221-6813	SALES REP.	Lenny Norris

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Christine Shivy

Christine Shivy



Fax: (910) 864-4444



Client: Weaver Homes Project: Magnolia Elev. C Address: Magnolia Elev. C


Date: 12/14/2021 Input by: Christine Shivy Job Name: Magnolia Elev. C


Project #:

3-Ply - PASSED **Kerto-S LVL** 1.750" X 16.000" BM<sub>1</sub>

Level: Level

Reactions UNPATTERNED Ib (Uplift)

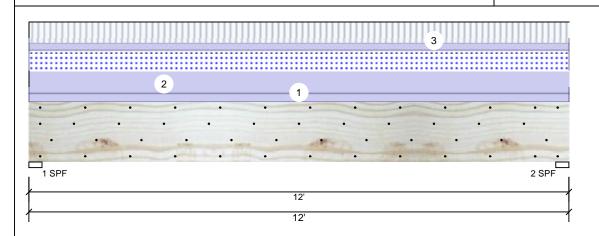

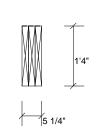

Page 1 of 1

Member Information							
Type:	Girder						
Plies:	3						
Moisture Condition:	Dry						
Deflection LL:	480						
Deflection TL:	360						
Importance:	Normal						
Temperature:	Temp <= 100°F						

Application: Floor Design Method: ASD **Building Code: IBC/IRC 2015** Load Sharing: Yes Deck: Not Checked

Brg Wind Const Live Dead Snow 1896 3448 1950 0 0 1 0 2 1896 3448 1950 0

## **Bearings** Bearing Length Cap. React D/L lb Total Ld. Case Ld. Comb. 1 - SPF 3.500" 3448 / 2885 6333 L D+0.75(L+S) D+0.75(L+S) 2 - SPF 3.500" 81% 3448 / 2885 6333 L

## **Analysis Results**

/	Analysis	Actual	Location	Allowed	Capacity	Comb.	Case
ſ	Moment	17638 ft-lb	6'	62010 ft-lb	0.284 (28%)	D+0.75(L+S)	L
ı	Jnbraced	17638 ft-lb	6'	17648 ft-lb	0.999 (100%)	D+0.75(L+S)	L
5	Shear	4524 lb	1'6 5/8"	17920 lb	0.252 (25%)	D+L	L
ı	L Defl inch	0.065 (L/2136)	6'	0.289 (L/480)	0.220 (22%)	0.75(L+S)	L
	ΓL Defl inch	0.143 (L/973)	6'	0.385 (L/360)	0.370 (37%)	D+0.75(L+S)	L

## **Design Notes**

- 1 Fasten all plies using 4 rows of 10d Box nails (.128x3") at 12" o.c. Maximum end distance not to exceed 6".
- 2 Refer to last page of calculations for fasteners required for specified loads.
- 3 Girders are designed to be supported on the bottom edge only.
- 4 Top loads must be supported equally by all plies.
- 5 Top must be laterally braced at a maximum of 10'4 7/8" o.c.
- 6 Bottom braced at bearings.
- 7 Lateral slenderness ratio based on single ply width.

ID	Load Type	Location	Trib Width	Side	Dead 0.9	Live 1	Snow 1.15	Wind 1.6	Const. 1.25	Comments	
1	Uniform			Тор	125 PLF	0 PLF	0 PLF	0 PLF	0 PLF	Exterior Wall	
2	Uniform			Тор	325 PLF	0 PLF	325 PLF	0 PLF	0 PLF	A2	
3	Uniform			Far Face	106 PLF	316 PLF	0 PLF	0 PLF	0 PLF	F1	
	Self Weight				19 PLF						

## Notes

Calculated Structured Designs is responsible only of the structural adequacy of this component based on the design criteria and loadings shown. It is the responsibility of the customer and/or the contractor to ensure the component suitability of the intended application, and to verify the dimensions and loads.

- Dry service conditions, unless noted otherwise
   LVL not to be treated with fire retardant or corrosive
- Handling & Installation
- LVL beams must not be cut or drilled Refer to manufacturer's product information regarding installation requirements, multi-ply fastening details, beam strength values, and code approvals
- approvals
  Damaged Beams must not be used
  Design assumes top edge is laterally restrained
  Provide lateral support at bearing points to avoid
  lateral displacement and rotation

6. For flat roofs provide proper drainage to prevent ponding

Metsä Wood 301 Merritt 7 Building, 2nd Floor Norwalk, CT 06851 (800) 622-5850 www.metsawood.com/us ICC-ES: ESR-3633

Manufacturer Info

Comtech, Inc. 1001 S. Reilly Road, Suite #639 Fayetteville, NC USA 28314 910-864-TRUS



This design is valid until 1/8/2023



Client: Weaver Homes Project: Magnolia Elev. C Address: Magnolia Elev. C Date: 12/14/2021 Input by: Christine Shivy

Job Name: Magnolia Elev. C

Project #:

2 - SPF 3.500"


88%


1200 / 3389

4589 I

1.750" X 16.000" **Kerto-S LVL** 2-Ply - PASSED BM<sub>2</sub>

Level: Level

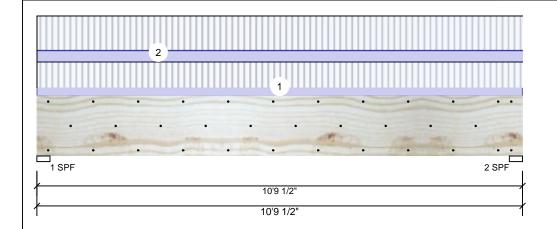

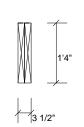

0

0

D+I

Page 1 of 1

## Member Information Reactions UNPATTERNED Ib (Uplift) Туре: Girder Application: Floor Brg Snow Wind Const Live Dead Plies: 2 Design Method: ASD 3389 1200 0 0 1 Moisture Condition: Dry **Building Code: IBC/IRC 2015** 3389 1200 O 0 2 Deflection LL: 480 Load Sharing: No Deflection TL: 360 Deck: Not Checked Importance: Normal Temperature: Temp <= 100°F **Bearings** Ld. Comb. Bearing Length Cap. React D/L lb Total Ld. Case 4589 L D+L 1 - SPF 3.500" 1200 / 3389

Analysis Results

Analysis	Actual	Location	Allowed	Capacity	Comb.	Case
Moment	11397 ft-lb	5'4 3/4"	34565 ft-lb	0.330 (33%)	D+L	L
Unbraced	11397 ft-lb	5'4 3/4"	11746 ft-lb	0.970 (97%)	D+L	L
Shear	4386 lb	1'6 5/8"	11947 lb	0.367 (37%)	D+L	L
LL Defl inch	0.085 (L/1457)	5'4 3/4"	0.259 (L/480)	0.330 (33%)	L	L
TL Defl inch	0.115 (L/1076)	5'4 3/4"	0.345 (L/360)	0.330 (33%)	D+L	L

## **Design Notes**

- 1 Fasten all plies using 3 rows of 10d Box nails (.128x3") at 12" o.c. Maximum end distance not to exceed 6".
- 2 Refer to last page of calculations for fasteners required for specified loads.
- 3 Girders are designed to be supported on the bottom edge only.
- 4 Top braced at bearings.
- 5 Bottom braced at bearings.
- 6 Lateral slenderness ratio based on single ply width.

ID	Load Type	Location	Trib Width	Side	Dead 0.9	Live 1	Snow 1.15	Wind 1.6	Const. 1.25	Comments
1	Uniform			Far Face	89 PLF	267 PLF	0 PLF	0 PLF	0 PLF	F4
2	Uniform			Near Face	121 PLF	361 PLF	0 PLF	0 PLF	0 PLF	F2
	Self Weight				12 PLF					

## Notes

Calculated Structured Designs is responsible only of the structural adequacy of this component based on the design criteria and loadings shown. It is the responsibility of the customer and/or the contractor to ensure the component suitability of the intended application, and to verify the dimensions and loads.

- Dry service conditions, unless noted otherwise
   LVL not to be treated with fire retardant or corrosive
- Handling & Installation
- LVL beams must not be cut or drilled
  Refer to manufacturer's product information
  regarding installation requirements, multi-ply
  fastening details, beam strength values, and code
  approvals
- Damaged Beams must not be used
- Design assumes top edge is laterally restrained
  Provide lateral support at bearing points to avoid
  lateral displacement and rotation

6. For flat roofs provide proper drainage to prevent ponding

Metsä Wood 301 Merritt 7 Building, 2nd Floor Norwalk, CT 06851 (800) 622-5850 www.metsawood.com/us ICC-ES: ESR-3633

Manufacturer Info

Comtech, Inc. 1001 S. Reilly Road, Suite #639 Fayetteville, NC USA 28314 910-864-TRUS



This design is valid until 1/8/2023



**GDH** 

**Kerto-S LVL** 


Client: Weaver Homes Project: Magnolia Elev. C Address: Magnolia Elev. C

Date: 12/14/2021 Input by: Christine Shivy Job Name: Magnolia Elev. C

Project #:

2-Ply - PASSED 1.750" X 11.875"

Level: Level

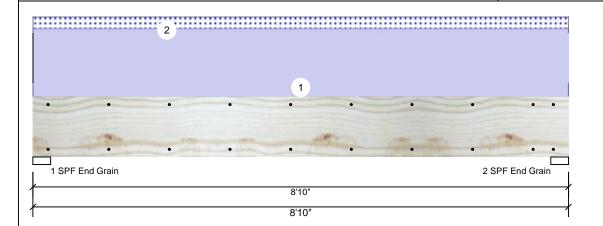


Floor

ASD

No

**IBC/IRC 2015** 

Not Checked

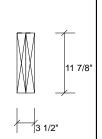

Const

D+S

1277 L

0

0

Page 1 of 1

Type:	Girder	Application:
Plies:	2	Design Method
Moisture Condition	n: Dry	Building Code:
Deflection LL:	480	Load Sharing:
Deflection TL:	360	Deck:
Importance:	Normal	
Temperature:	Temp <= 100°F	

Reactions UNPATTERNED Ib (Uplift)								
Brg	Live	Dead	Snow	Wind				
1	0	1101	177	0				
2	0	1101	177	0				

12%

	•				Grain	
Location 4'5"		Capacity 0.122 (12%)	Comb.	Case Uniform	2 - SPF End	3.500"
4'5"	10756 ft-lb	0.122 (12%)		L	Grain	
7'7 3/8"	7980 lb	0.100 (10%)	D	Uniform		
4'5 1/16"	0.209 (L/480)	0.030 (3%)	S	L		
4'5 1/16"	0.279 (L/360)	0.140 (14%)	D+S	L		

Bearings									
Bearing Length	Cap. React D/L lb	Total Ld. Case	Ld. Comb.						
1 - SPF 3.500"	12% 1101 / 177	1277 L	D+S						
End									
Grain									

1101 / 177

## TL Defl inch **Design Notes**

Analysis Results

Actual

2185 ft-lb

2536 ft-lb

(L/18257)

0.040 (L/2525)

797 lb

0.006

Analysis

Moment

Shear LL Defl inch

Unbraced

1 Fasten all plies using 2 rows of 10d Box nails (.128x3") at 12" o.c. Maximum end distance not to exceed 6".

- 2 Refer to last page of calculations for fasteners required for specified loads.
- 3 Girders are designed to be supported on the bottom edge only.
- 4 Top loads must be supported equally by all plies.
- 5 Top braced at bearings.
- 6 Bottom braced at bearings.
- 7 Lateral slenderness ratio based on single ply width.

ID	Load Type	Location	Trib Width	Side	Dead 0.9	Live 1	Snow 1.15	Wind 1.6	Const. 1.25	Comments
1	Uniform			Тор	200 PLF	0 PLF	0 PLF	0 PLF	0 PLF	Exterior Loads
2	Uniform			Тор	40 PLF	0 PLF	40 PLF	0 PLF	0 PLF	2'-0" Gable End
	Self Weight				9 PLF					

## Notes

Calculated Structured Designs is responsible only of the structural adequacy of this component based on the design criteria and loadings shown. It is the responsibility of the customer and/or the contractor to ensure the component suitability of the intended application, and to verify the dimensions and loads.

- Dry service conditions, unless noted otherwise
   LVL not to be treated with fire retardant or corrosive
- Handling & Installation
- LVL beams must not be cut or drilled
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This design is valid until 1/8/2023

6. For flat roofs provide proper drainage to prevent ponding

Manufacturer Info

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