

NOTE!

MURPHY GARNOW DESIGN GROUP, INC.
HEREBY EXPRESSLY RESERVES ITS COPYRIGHT AND
OTHER PROPERTY RIGHTS TO THESE PLANS. THESE
PLANS ARE TO BE USED FOR THE CONSTRUCTION OF
(ONE) RESIDENCE ONLY, ANY OTHER USE, CHANGE
AND/OR REPRODUCTION IN ANY FORM WILL RENDER
THESE PLANS FRAUDULENT.

ATTIC VENTILATION

```
2233 = 7.44 sq. ft. REQD.

300

*( ) - BASE, / VENTS =

*( ) - BASE, / VENTS =

* =

* =

* =

* =

* (84') - RIDGE VENT @ 9 sq.in/ft. = 5.25 SQ. FT.

TOTAL = 5.25 SQ. FT.
```

** PROVIDE CONTINUOUS SOFFIT VENT SUUROUND
TO EQUAL OR EXCEED 3.72 SQ. FT.

*** (OPT.) PROVIDE THEMOSTATICALLY CONTROLLED
POWER VENT TO EQUAL OR EXCEED 3.72 SQ. FT.

CODE INFORMATION

```
* ZONE: (CHECK ONE)

ZONE 1 SCREEN

ZONE 8

ZONE

* GLAZING U-FACTOR

* R-VALUES

CEILING R-38

WALL R-15

FLOOR R-19

BSMNT. WALL

SLAB PERIMETER

CRAWL SPACE WALL

* MEAN ROOF HEIGHT 30'-3"
```

* WALL AND ROOF CLADDING DESIGN VALUE: (MEAN ROOF HGT. 30 ft. OR LESS) CRAWL SPACE WALL

WALLS +18.0, -24.1

ROOF PITCH 0/12 TO 2.25/12 +10.0, -45.4

ROOF PITCH 2.25/12 TO 7/12 +10.4,-34.8

ROOF PITCH 7/12 TO 12/12 +16.5,-21.0

EXPOSURE ADJUSTMENT × 1.05

ALL DIMENSIONS, SITE
CONDITIONS & CODES ARE TO
BE VERIFIED BEFORE CONSTR.
BEGINS. ONCE CONSTR. HAS
BEGUN MURPHY GARNOW
DESIGN GROUP, INC. WILL NOT
ASSUME ANY LIABILITY FOR
ANY EXPENSES ASSOCIATED
WITH ERRORS & OMMISIONS.

GARNOW DESIGN GROUP,

1140-500 KILDAIKE FARM ROAD

CARY, NORTH CAROLINA 27511

(919) 481-9115 FAX; (919) 481-6970

MURPHY (

PRINCE PLACE LOT #61

9

DRAWN BY: TWG DATE: 12-2-14

FILE NAME: HH-2-2591

REVISIONS

5-3-16 TWG PLAN

1-8-19 TWG PLAN

1-1-1-21 TWG PLAN


© COPYRIGHT 2021 MURPHY GARNOW DESIGN GROUP, INC. ALL RIGHTS RESERVED




HOUSE NUMBER:

PAGE NUMBER:

THESE PLANS MEET THE REQUIREMENTS OF THE INTERNATIONA RESIDENTIAL CODE '2015' AND THE NORTH CAROLINA RESIDENTIAL CODE '2018' EDITION.

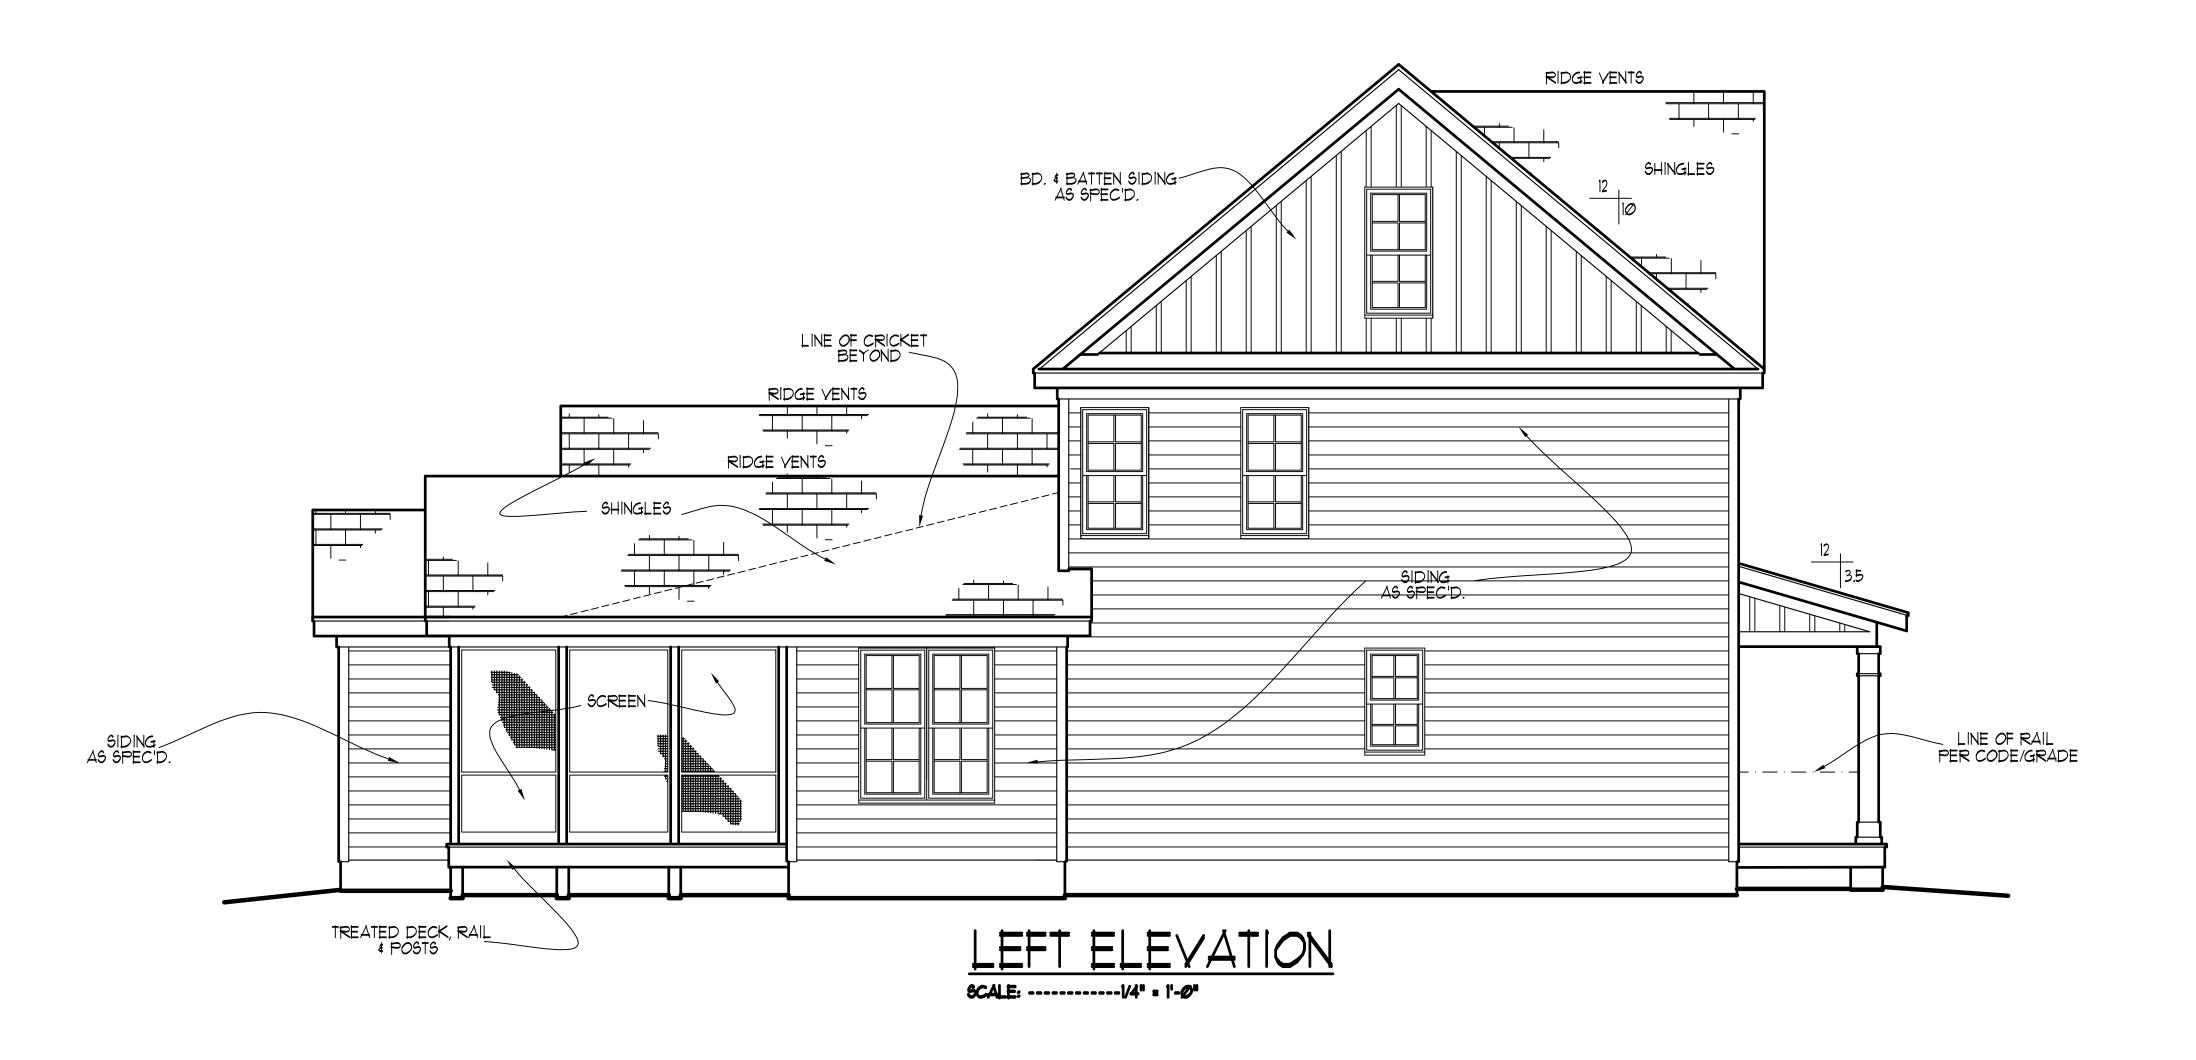

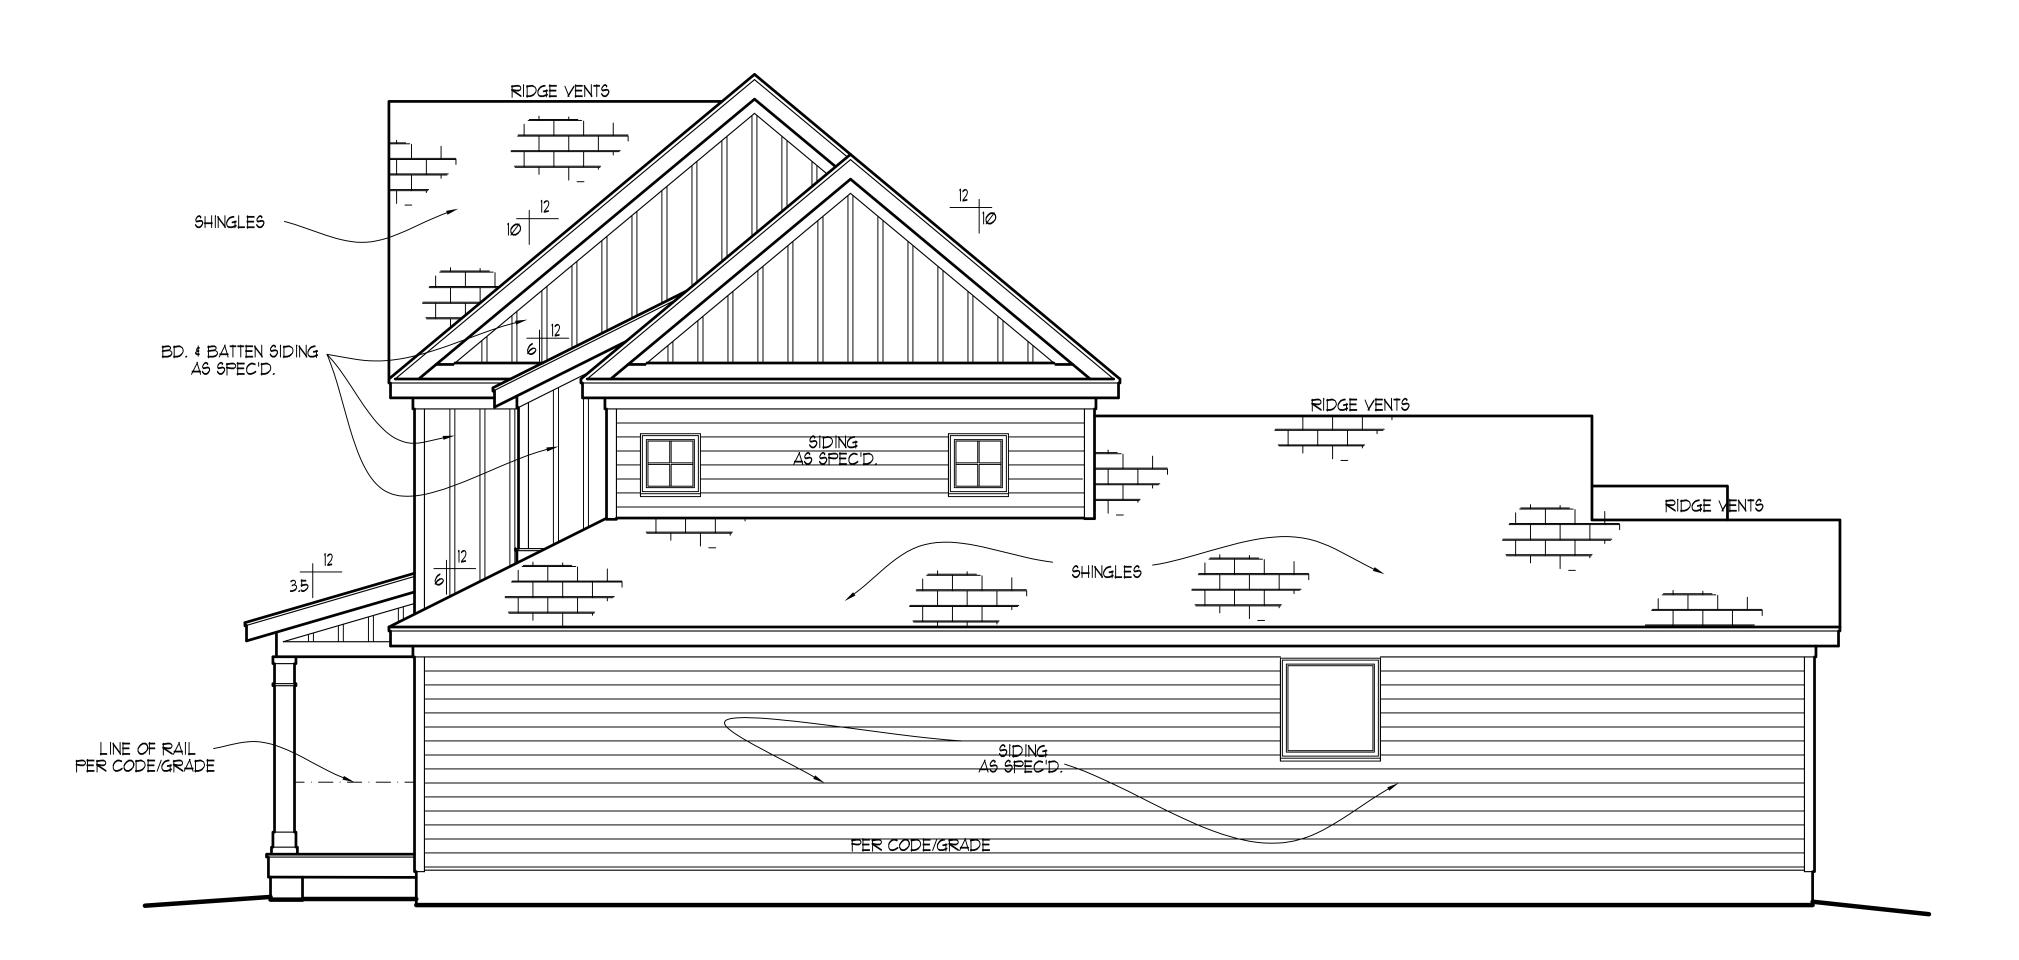

<u>NOTE</u>!

MURPHY GARNOW DESIGN GROUP, INC.
HEREBY EXPRESSLY RESERVES ITS COPYRIGHT AND
OTHER PROPERTY RIGHTS TO THESE PLANS. THESE
PLANS ARE TO BE USED FOR THE CONSTRUCTION OF
(ONE) RESIDENCE ONLY, ANY OTHER USE, CHANGE
AND/OR REPRODUCTION IN ANY FORM WILL RENDER
THESE PLANS FRAUDULENT.

ALL DIMENSIONS, SITE
CONDITIONS & CODES ARE TO
BE VERIFIED BEFORE CONSTR.
BEGINS. ONCE CONSTR. HAS
BEGUN MURPHY GARNOW
DESIGN GROUP, INC. WILL NOT
ASSUME ANY LIABILITY FOR
ANY EXPENSES ASSOCIATED
WITH ERRORS & OMMISIONS.

CORS & OMMIS

MURPHY GARNOW DESIGN GROUP, INC 1140-300 KILDAIRE FARM ROAD CARY, NORTH CAROLINA 27511

HALCYON HOMES

ORAWN BY: **TWG** Date: **12-2-14**

FILE NAME: HH-2-2591

REVISIONS

5-3-16 TWG PLAN


1-8-19 TWG PLAN

1-1-21 TWG PLAN

© COPYRIGHT 2021 MURPHY GARNOW DESIGN GROUP, INC. ALL RIGHTS RESERVED



HOUSE NUMBER:

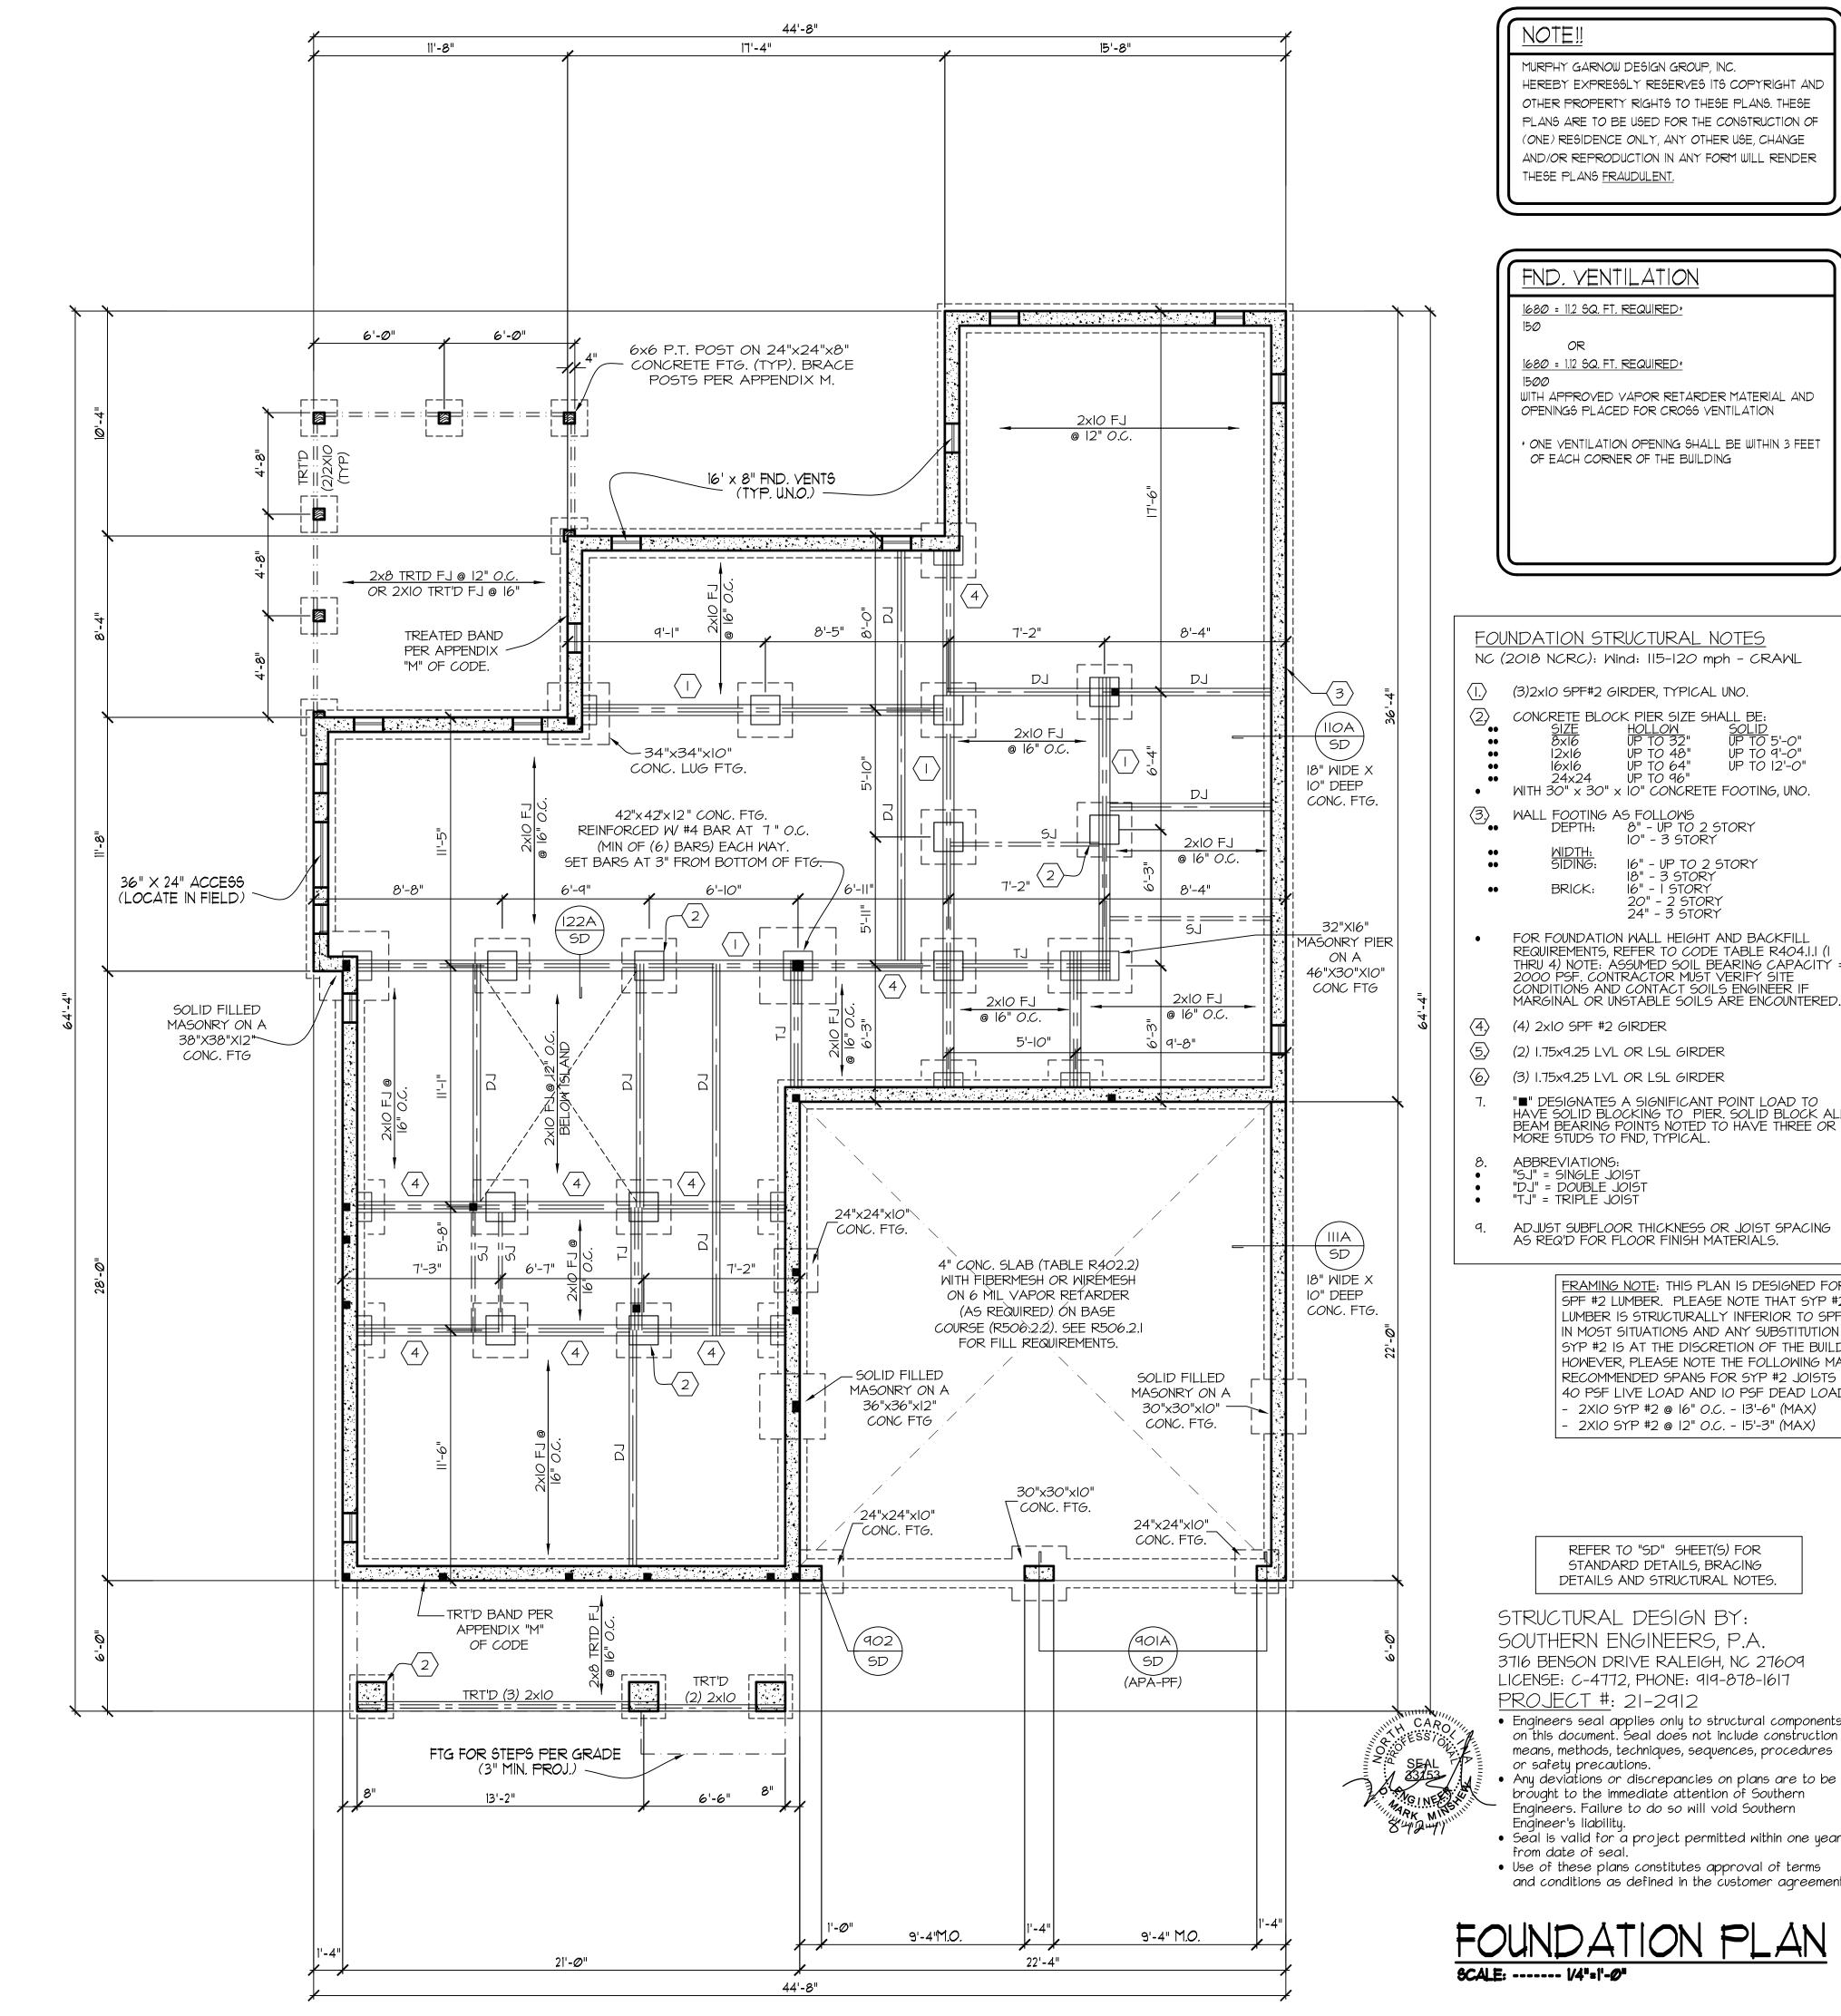

FND. VENTILATION

1680 = 11.2 SQ. FT. REQUIRED*

1680 = 1.12 SQ. FT. REQUIRED*

WITH APPROVED VAPOR RETARDER MATERIAL AND OPENINGS PLACED FOR CROSS VENTILATION

* ONE VENTILATION OPENING SHALL BE WITHIN 3 FEET OF EACH CORNER OF THE BUILDING

FOUNDATION STRUCTURAL NOTES NC (2018 NCRC): Wind: 115-120 mph - CRAWL

(3)2x10 SPF#2 GIRDER, TYPICAL UNO.

CONCRETE BLOCK PIER SIZE SHALL BE:

UP TO 48" UP TO 9'-0" UP TO 64" UP TO 12'-0" 16x16

WITH $30" \times 30" \times 10"$ CONCRETE FOOTING, UNO.

10" - 3 STORY

18" - 3 STORY BRICK: 16" - I STORY 20" - 2 STORY 24" - 3 STORY

FOR FOUNDATION WALL HEIGHT AND BACKFILL REQUIREMENTS, REFER TO CODE TABLE R404.I.I (I THRU 4) NOTE: ASSUMED SOIL BEARING CAPACITY = 2000 PSF. CONTRACTOR MUST VERIFY SITE CONDITIONS AND CONTACT SOILS ENGINEER IF

(4) 2xIO SPF #2 GIRDER

(2) 1.75x9.25 LVL OR LSL GIRDER

(3) 1.75x9.25 LVL OR LSL GIRDER

"" DESIGNATES A SIGNIFICANT POINT LOAD TO HAVE SOLID BLOCKING TO PIER. SOLID BLOCK ALL BEAM BEARING POINTS NOTED TO HAVE THREE OR MORE STUDS TO FND, TYPICAL.

ABBREVIATIONS:
"SJ" = SINGLE JOIST
"DJ" = DOUBLE JOIST
"TJ" = TRIPLE JOIST

ADJUST SUBFLOOR THICKNESS OR JOIST SPACING

FRAMING NOTE: THIS PLAN IS DESIGNED FOR SPF #2 LUMBER. PLEASE NOTE THAT SYP #2 LUMBER IS STRUCTURALLY INFERIOR TO SPF #2 IN MOST SITUATIONS AND ANY SUBSTITUTION TO SYP #2 IS AT THE DISCRETION OF THE BUILDER. HOWEVER, PLEASE NOTE THE FOLLOWING MAX RECOMMENDED SPANS FOR SYP #2 JOISTS FOR 40 PSF LIVE LOAD AND 10 PSF DEAD LOAD. - 2XIO SYP #2 @ I6" O.C. - I3'-6" (MAX)

2XIO SYP #2 @ I2" O.C. - I5'-3" (MAX)

REFER TO "SD" SHEET(S) FOR STANDARD DETAILS, BRACING DETAILS AND STRUCTURAL NOTES.

STRUCTURAL DESIGN BY: SOUTHERN ENGINEERS, P.A. 3716 BENSON DRIVE RALEIGH, NC 27609 LICENSE: C-4772, PHONE: 919-878-1617 <u>PROJECT #</u>: 21-2912

 Engineers seal applies only to structural components on this document. Seal does not include construction means, methods, techniques, sequences, procedures or safety precautions.

 Any deviations or discrepancies on plans are to be brought to the immediate attention of Southern Engineers. Failure to do so will void Southern

Enqineer's liability. Seal is valid for a project permitted within one year from date of seal.

 Use of these plans constitutes approval of terms and conditions as defined in the customer agreement.

FOUNDATION PLAN

ALL DIMENSIONS, SITE CONDITIONS & CODES ARE TO BE VERIFIED BEFORE CONSTR. BEGINS. ONCE CONSTR. HAS BEGUN MURPHY GARNOW DESIGN GROUP, INC. WILL NOT ASSUME ANY LIABILITY FOR ANY EXPENSES ASSOCIATED WITH ERRORS & OMMISIONS.

aroup, GARNOW

MURPHY

RINCE LOT

DRAWN BY: TWG


FILE NAME: **HH-2-2591**

5-3-16 TWG PLAN 1-8-19 TWG PLAN 1-1-1-21 TWG PLAN

© COPYRIGHT 2021 MURPHY GARNOW DESIGN GROUP, INC. ALL RIGHTS RESERVED

HOUSE NAME:

HOUSE NUMBER:

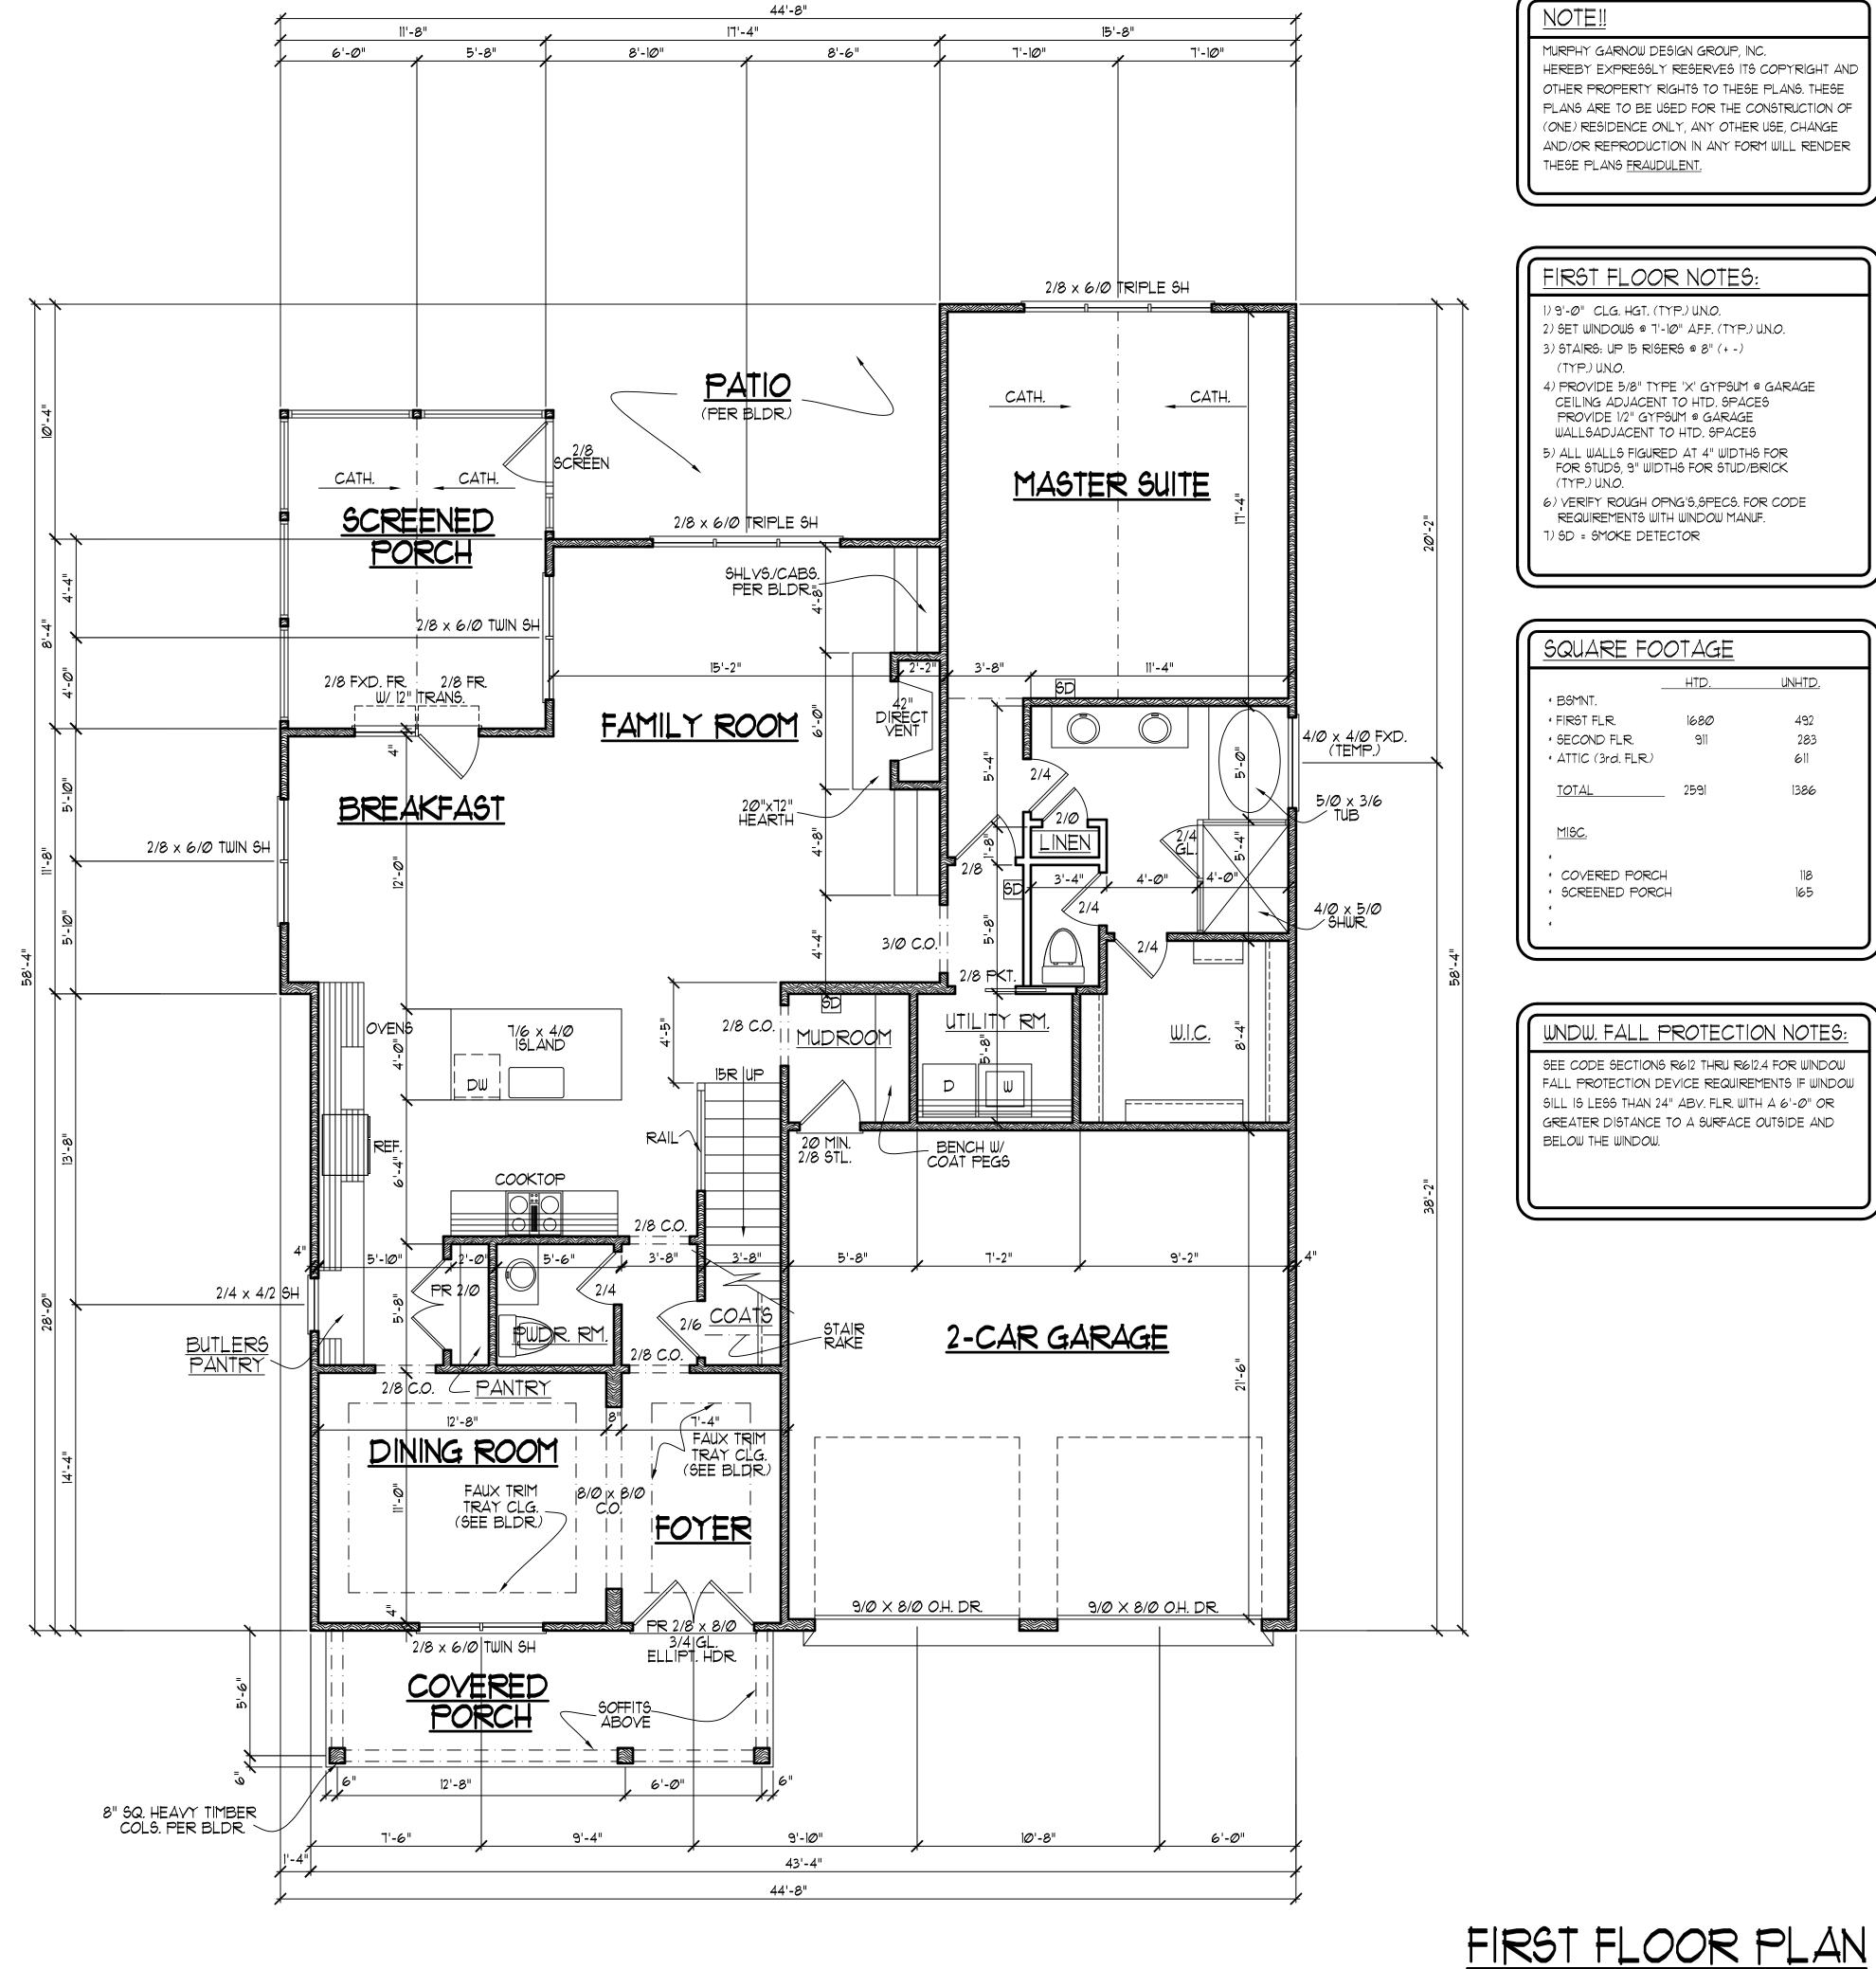

FIRST FLOOR NOTES:

- 1) 9'-0" CLG. HGT. (TYP.) U.N.O. 2) SET WINDOWS @ 7'-10" A.F.F. (TYP.) U.N.O.
- 3) STAIRS: UP 15 RISERS @ 8" (+ -)
- (TYP.) U.N.O. 4) PROVIDE 5/8" TYPE 'X' GYPSUM @ GARAGE CEILING ADJACENT TO HTD. SPACES
- PROVIDE 1/2" GYPSUM @ GARAGE WALLSADJACENT TO HTD. SPACES 5) ALL WALLS FIGURED AT 4" WIDTHS FOR FOR STUD/5, 9" WIDTHS FOR STUD/BRICK
- (TYP.) U.N.O. 6) VERIFY ROUGH OPNG'S, SPECS. FOR CODE REQUIREMENTS WITH WINDOW MANUF.

SQUARE FOOTAGE		
_	HTD.	UNHTD.
* BSMNT.		
* FIRST FLR.	1680	492
* SECOND FLR.	911	283
* ATTIC (3rd. FLR.)		611
TOTAL	2591	1386
MISC.		
*		
* COVERED PORCH		118
* SCREENED PORC *	H	165
*		

WNDW. FALL PROTECTION NOTES:

SEE CODE SECTIONS R612 THRU R612.4 FOR WINDOW FALL PROTECTION DEVICE REQUIREMENTS IF WINDOW SILL IS LESS THAN 24" ABV. FLR. WITH A 6'-0" OR GREATER DISTANCE TO A SURFACE OUTSIDE AND BELOW THE WINDOW.

Q PRINCE LOT

ALL DIMENSIONS, SITE
CONDITIONS & CODES ARE TO
BE VERIFIED BEFORE CONSTR.
BEGINS. ONCE CONSTR. HAS
BEGUN MURPHY GARNOW
DESIGN GROUP, INC. WILL NOT
ASSUME ANY LIABILITY FOR
ANY EXPENSES ASSOCIATED
WILL ERRORS & COMMISSIONS

WITH ERRORS & OMMISIONS.

 \geq

GARNOW DESIGN GROUP

MURPHY

DRAWN BY: TWG 12-2-14

FILE NAME: HH-2-2591 REVISIONS

5-3-16 TWG PLAN

1-8-19 TWG PLAN

1-1-21 TWG PLAN

© COPYRIGHT 2021 MURPHY GARNOW DESIGN GROUP, INC. ALL RIGHTS RESERVED



HOUSE NUMBER:

PAGE NUMBER:

THESE PLANS MEET THE REQUIREMENTS OF THE INTERNATIONA RESIDENTIAL CODE '2015' AND THE NORTH CAROLINA RESIDENTIAL CODE '2018' EDITION.

SCALE: -----1/4" = 1'-0"

1) 9'-0" CLG. HGT. (TYP.) U.N.O.

- 2) SET WINDOWS @ 1'-4' A.F.F. (TYP.) U.N.O.
- 3) STAIRS: UP 15 RISERS @ 8" (+ -) (TYP.) U.N.O.
- 4) ALL WALLS FIGURED AT 4" WIDTHS FOR FOR STUDS, 9" WIDTHS FOR STUD/BRICK
- (TYP.) U.N.O.
- 5) VERIFY ROUGH OPNG'S,,SPECS. FOR CODE REQUIREMENTS WITH WINDOW MANUF.
- 6) SD = SMOKE DETECTOR

SECOND FLOOR NOTES:

MURPHY GARNOW DESIGN GROUP

ALL DIMENSIONS, SITE
CONDITIONS & CODES ARE TO
BE VERIFIED BEFORE CONSTR.
BEGINS. ONCE CONSTR. HAS
BEGUN MURPHY GARNOW

DESIGN GROUP, INC. WILL NOT ASSUME ANY LIABILITY FOR ANY EXPENSES ASSOCIATED

WITH ERRORS & OMMISIONS.

CYON

DRAWN BY: TWG

FILE NAME: HH-2-2591

7-3-16 TWG PLAN
1-8-19 TWG PLAN
1-1-21 TWG PLAN

© COPYRIGHT 2021 MURPHY GARNOW DESIGN GROUP, INC. ALL RIGHTS RESERVED




HOUSE NUMBER:

PAGE NUMBER:

THESE PLANS MEET THE REQUIREMENTS OF THE INTERNATIONA RESIDENTIAL CODE '2015' AND THE NORTH CAROLINA RESIDENTIAL CODE '2018' EDITION.

SECOND FLOOR PLAN

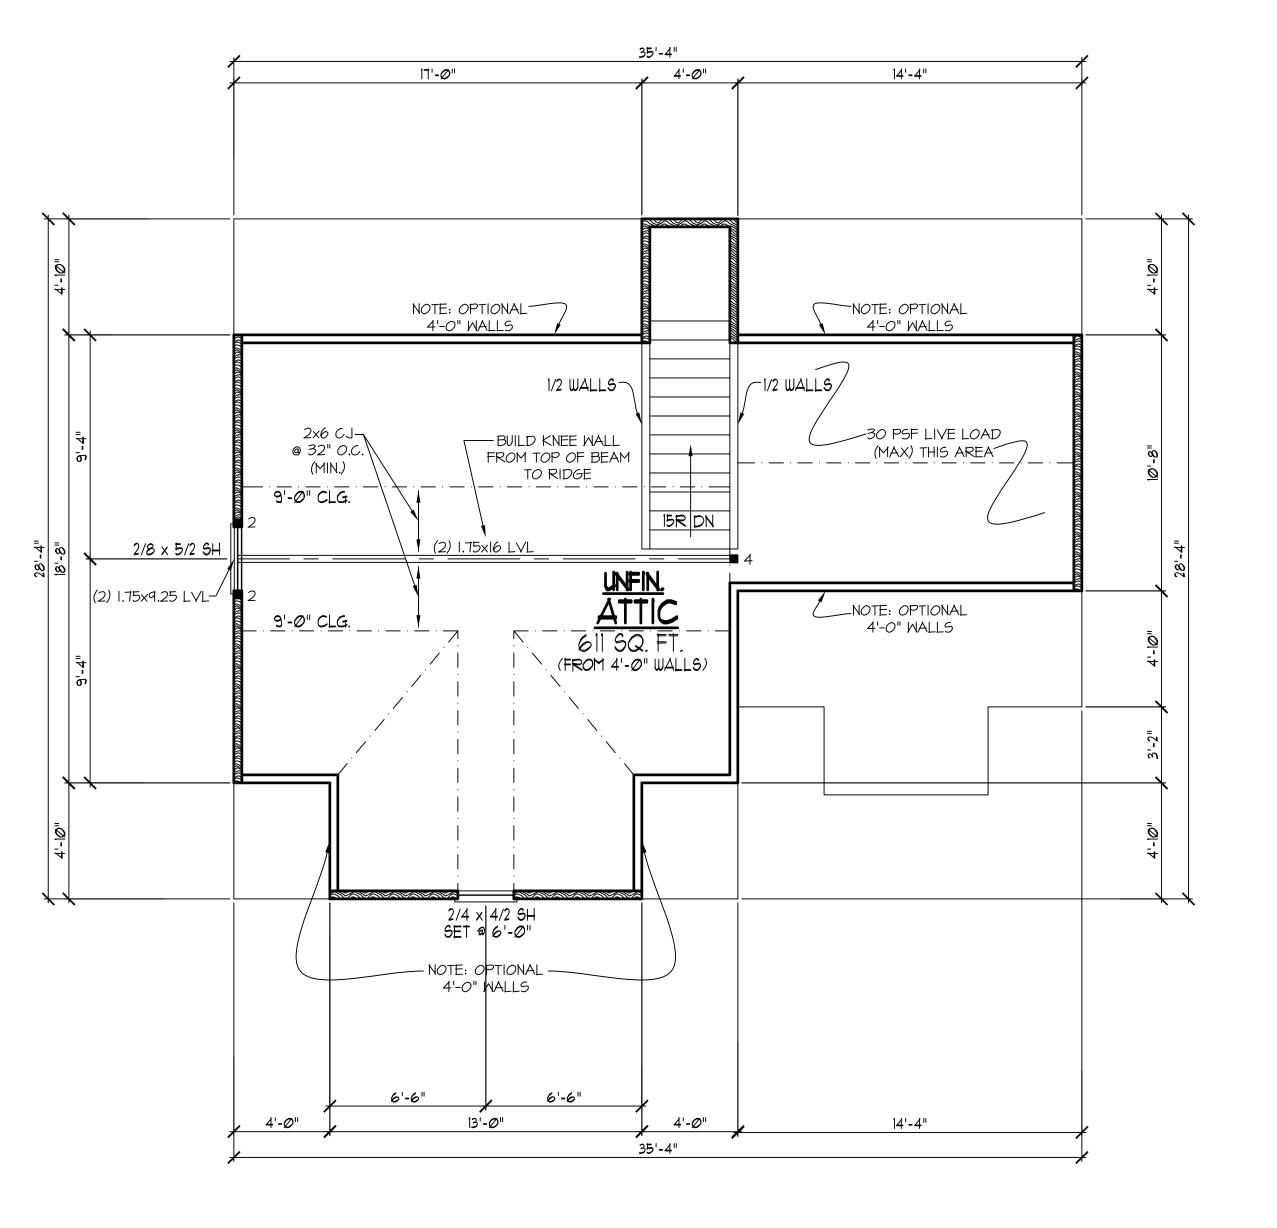

NOT

YUDDUX CADAGUA DEGL

MURPHY GARNOW DESIGN GROUP, INC.
HEREBY EXPRESSLY RESERVES ITS COPYRIGHT AND
OTHER PROPERTY RIGHTS TO THESE PLANS. THESE
PLANS ARE TO BE USED FOR THE CONSTRUCTION OF
(ONE) RESIDENCE ONLY, ANY OTHER USE, CHANGE
AND/OR REPRODUCTION IN ANY FORM WILL RENDER
THESE PLANS FRAUDULENT.

ATTIC FLOOR PLAN

5) SD = SMOKE DETECTOR

1) 9'-0" CLG. HGT. (TYP.) UN.O.

2) SET WINDOWS @ T'-4" A.F. (TYP.) UN.O.
3) ALL WALLS FIGURED AT 4" WIDTHS FOR FOR STUD/BRICK

(TYP.) U.N.O. 4) VERIFY ROUGH OPNG'S,,SPECS. FOR CODE REQUIREMENTS WITH WINDOW MANUF.

FRAMING NOTES

NC (2018 NCRC): Wind: 115-120 mph

- I. BRACING METHOD AND TYPE: CONTINUOUSLY SHEATHED WSP: CS-WSP.
 NOTE THAT THE WALL BRACING AMOUNT PROVIDED ON THE PLANS
 (DETAILS AND SPECIFICATIONS) IS GREATER THAN THE AMOUNT OF
 WALL BRACING REQUIRED BY THE CODE. SEE NOTES BELOW FOR
 DETAILS AND SPECIFICATIONS FOR WALL BRACING AND WALL
 FRAMING
- 2. EXTERIOR WALL SHEATHING: WALLS SHALL BE BRACED BY SHEATHING WALLS ON ALL STORIES WITH WOOD STRUCTURAL PANEL SHEATHING (WSP) (EXPOSURE B: 1/16". EXPOSURE C: 15/32"). SHEATHING SHALL BE ATTACHED WITH 8d NAILS AT A 6"/12" NAILING PATTERN (6" OC AT PANEL EDGES AND 12" OC AT INTERMEDIATE SUPPORTS). INSTALL BLOCKING AT ALL PANEL EDGES.
- 3. WSP SHEATHING SHALL EXTEND TO THE UPPERMOST DOUBLE BEARING PLATE. BLOCK AT ROOF AND ATTACH BRACED WALLS PER CODE. WSP SHEATHING BETWEEN FLOORS SHALL BE SPLICED ALONG CONTINUOUS BAND OR THE WSP SHEATHING MAY BE SPLICED ACROSS STUDS (CONTINUOUS ACROSS FLOOR SYSTEM) WITH BLOCKING AT PANEL EDGES. (MINIMUM 12" BEYOND FLOOR BREAK) OR OTHER APPROVED METHOD.
- 4. "HD" = HOLDOWN: HOLD-DOWN DEVICE (NOTED AS "HD" ON PLANS)
 SHALL BE AN 800 POUND CAPACITY ASSEMBLY AS NOTED ON PLANS.
 SEE DETAILS FOR HD ASSEMBLY.
- ***GROUND/FIRST FLOOR: USE "HD HOLD-DOWN DETAIL" ON SD SHEET (OR EQUIV.)
- **UPPER FLOORS: ATTACH BASE OF KING STUD WITH A SIMPSON CS22
 STRAP DOWN ACROSS THE BAND AND DOWN TO A STUD BELOW OR
 HEADER BELOW. EXTEND STRAP 7" MIN ALONG EACH STUD (OR
 HEADER) AND ATTACH EACH END W (7) 8d NAILS.
- 5. INTERIOR BRACED WALL: (NOTED AS "IBW" ON PLANS) ATTACH I/2" GYPSUM BOARD (GB) ON EACH SIDE OF WALL WITH A MIN. OF 5d COOLER NAILS OR #6 SCREWS @ 7" O.C. ALONG THE EDGES AND AT INTERMEDIATE SUPPORTS.
- 6. INTERIOR BRACED WALL-WOOD STRUCTURAL PANEL: (NOTED AS "IBW-WSP" ON PLANS). ATTACH ONE SIDE WITH 1/6" WSP SHEATHING WITH 8d NAILS AT A 6"/12" NAILING PATTERN (6" OC AT PANEL EDGES AND 12" OC AT INTERMEDIATE SUPPORTS). INSTALL BLOCKING AT ALL PANEL EDGES. ATTACH GB OVER WSP AS REQUIRED. ATTACH OPPOSITE SIDE WITH 1/2" GB WITH A MIN. OF 5d COOLER NAILS OR #6 SCREWS @ 7" OC ALONG THE EDGES AND AT INTERMEDIATE SUPPORTS.

HEADER/BEAM & COLUMN NOTES

- I. ALL EXTERIOR AND LOAD BEARING HEADERS SHALL BE MIN. (2)2x6 (4" WALL) OR (3)2x6 (6" WALL) WITH (I) SUPPORT STUD, UNLESS NOTED OTHERWISE.
- 2. THE NUMBER SHOWN AT BEAM AND HEADER SUPPORTS INDICATES THE NUMBER OF SUPPORT STUDS REQUIRED IN STUD POCKET OR COLUMN. THE NUMBER OF KING STUDS AT EACH END OF HEADERS IN EXTERIOR WALLS SHALL BE ACCORDING TO ITEM "d" IN TABLE R602.3(5) OR AS BELOW PER NCDOI COMMENTARY "KING
- STUDS AT WALL OPENINGS" REVISED 1-9-2020:

 UP TO 3' SPAN: (I) KING STUD

 OVER 3' UP TO 6' SPAN: (2) KING STUDS
- OVER 3' UP TO 6' SPAN: (2) KING STUDS
 OVER 6' UP TO 9' SPAN: (3) KING STUDS

 OVER 6' UP TO 9' SPAN: (4) KING STUDS
- OVER 9' UP TO 12' SPAN: (4) KING STUDS
 OVER 12' UP TO 15' SPAN: (5) KING STUDS

REFER TO "SD" SHEET(S) FOR STANDARD DETAILS, BRACING DETAILS AND STRUCTURAL NOTES.

STRUCTURAL DESIGN BY:
SOUTHERN ENGINEERS, P.A.
3716 BENSON DRIVE RALEIGH, NC 27609
LICENSE: C-4772, PHONE: 919-878-1617
PROJECT #: 21-2912

- CARONIA SESSIONA SESS
 - Engineers seal applies only to structural components on this document. Seal does not include construction means, methods, techniques, sequences, procedures or safety precautions.
 - Any deviations or discrepancies on plans are to be brought to the immediate attention of Southern Engineers. Failure to do so will void Southern Engineer's liability.
 - Engineer's liability.
 Seal is valid for a project permitted within one year from date of seal.
 - Use of these plans constitutes approval of terms and conditions as defined in the customer agreement.

THESE PLANS MEET THE REQUIREMENTS OF THE NORTH CAROLINA RESIDENTIAL CODE '2018' EDITION.

ALL DIMENSIONS, SITE
CONDITIONS & CODES ARE TO
BE VERIFIED BEFORE CONSTR.
BEGINS. ONCE CONSTR. HAS
BEGIN MURPHY GARNOW
DESIGN GROUP, INC. WILL NOT
ASSUME ANY LIABILITY FOR
ANY EXPENSES ASSOCIATED
WITH ERRORS & OMMISIONS.

ES ASSOCIA S & OMMISIO

0

aroup,

GARNOW DESIGN

MURPHY

1, NORTH CAROLINA 27511 11-9115 FAX; (919) 481-6970

CARY, NORTH CA (919) 481-9115 FAX

PRINCE PLACE LOT #67

DRAWN BY: TWG

Q

DATE: 12-2-14

FILE NAME: HH-2-2591

REVISIONS

5-3-16 TWG PLAN

1-8-19 TWG PLAN

1-1-21 TWG PLAN


© COPYRIGHT 2021
MURPHY GARNOW DESIGN
GROUP, INC.
ALL RIGHTS RESERVED

ALL RIGHTS RESERVED

HOUSE NAME:

HOUSE NAME:

HOUSE NUMBER:

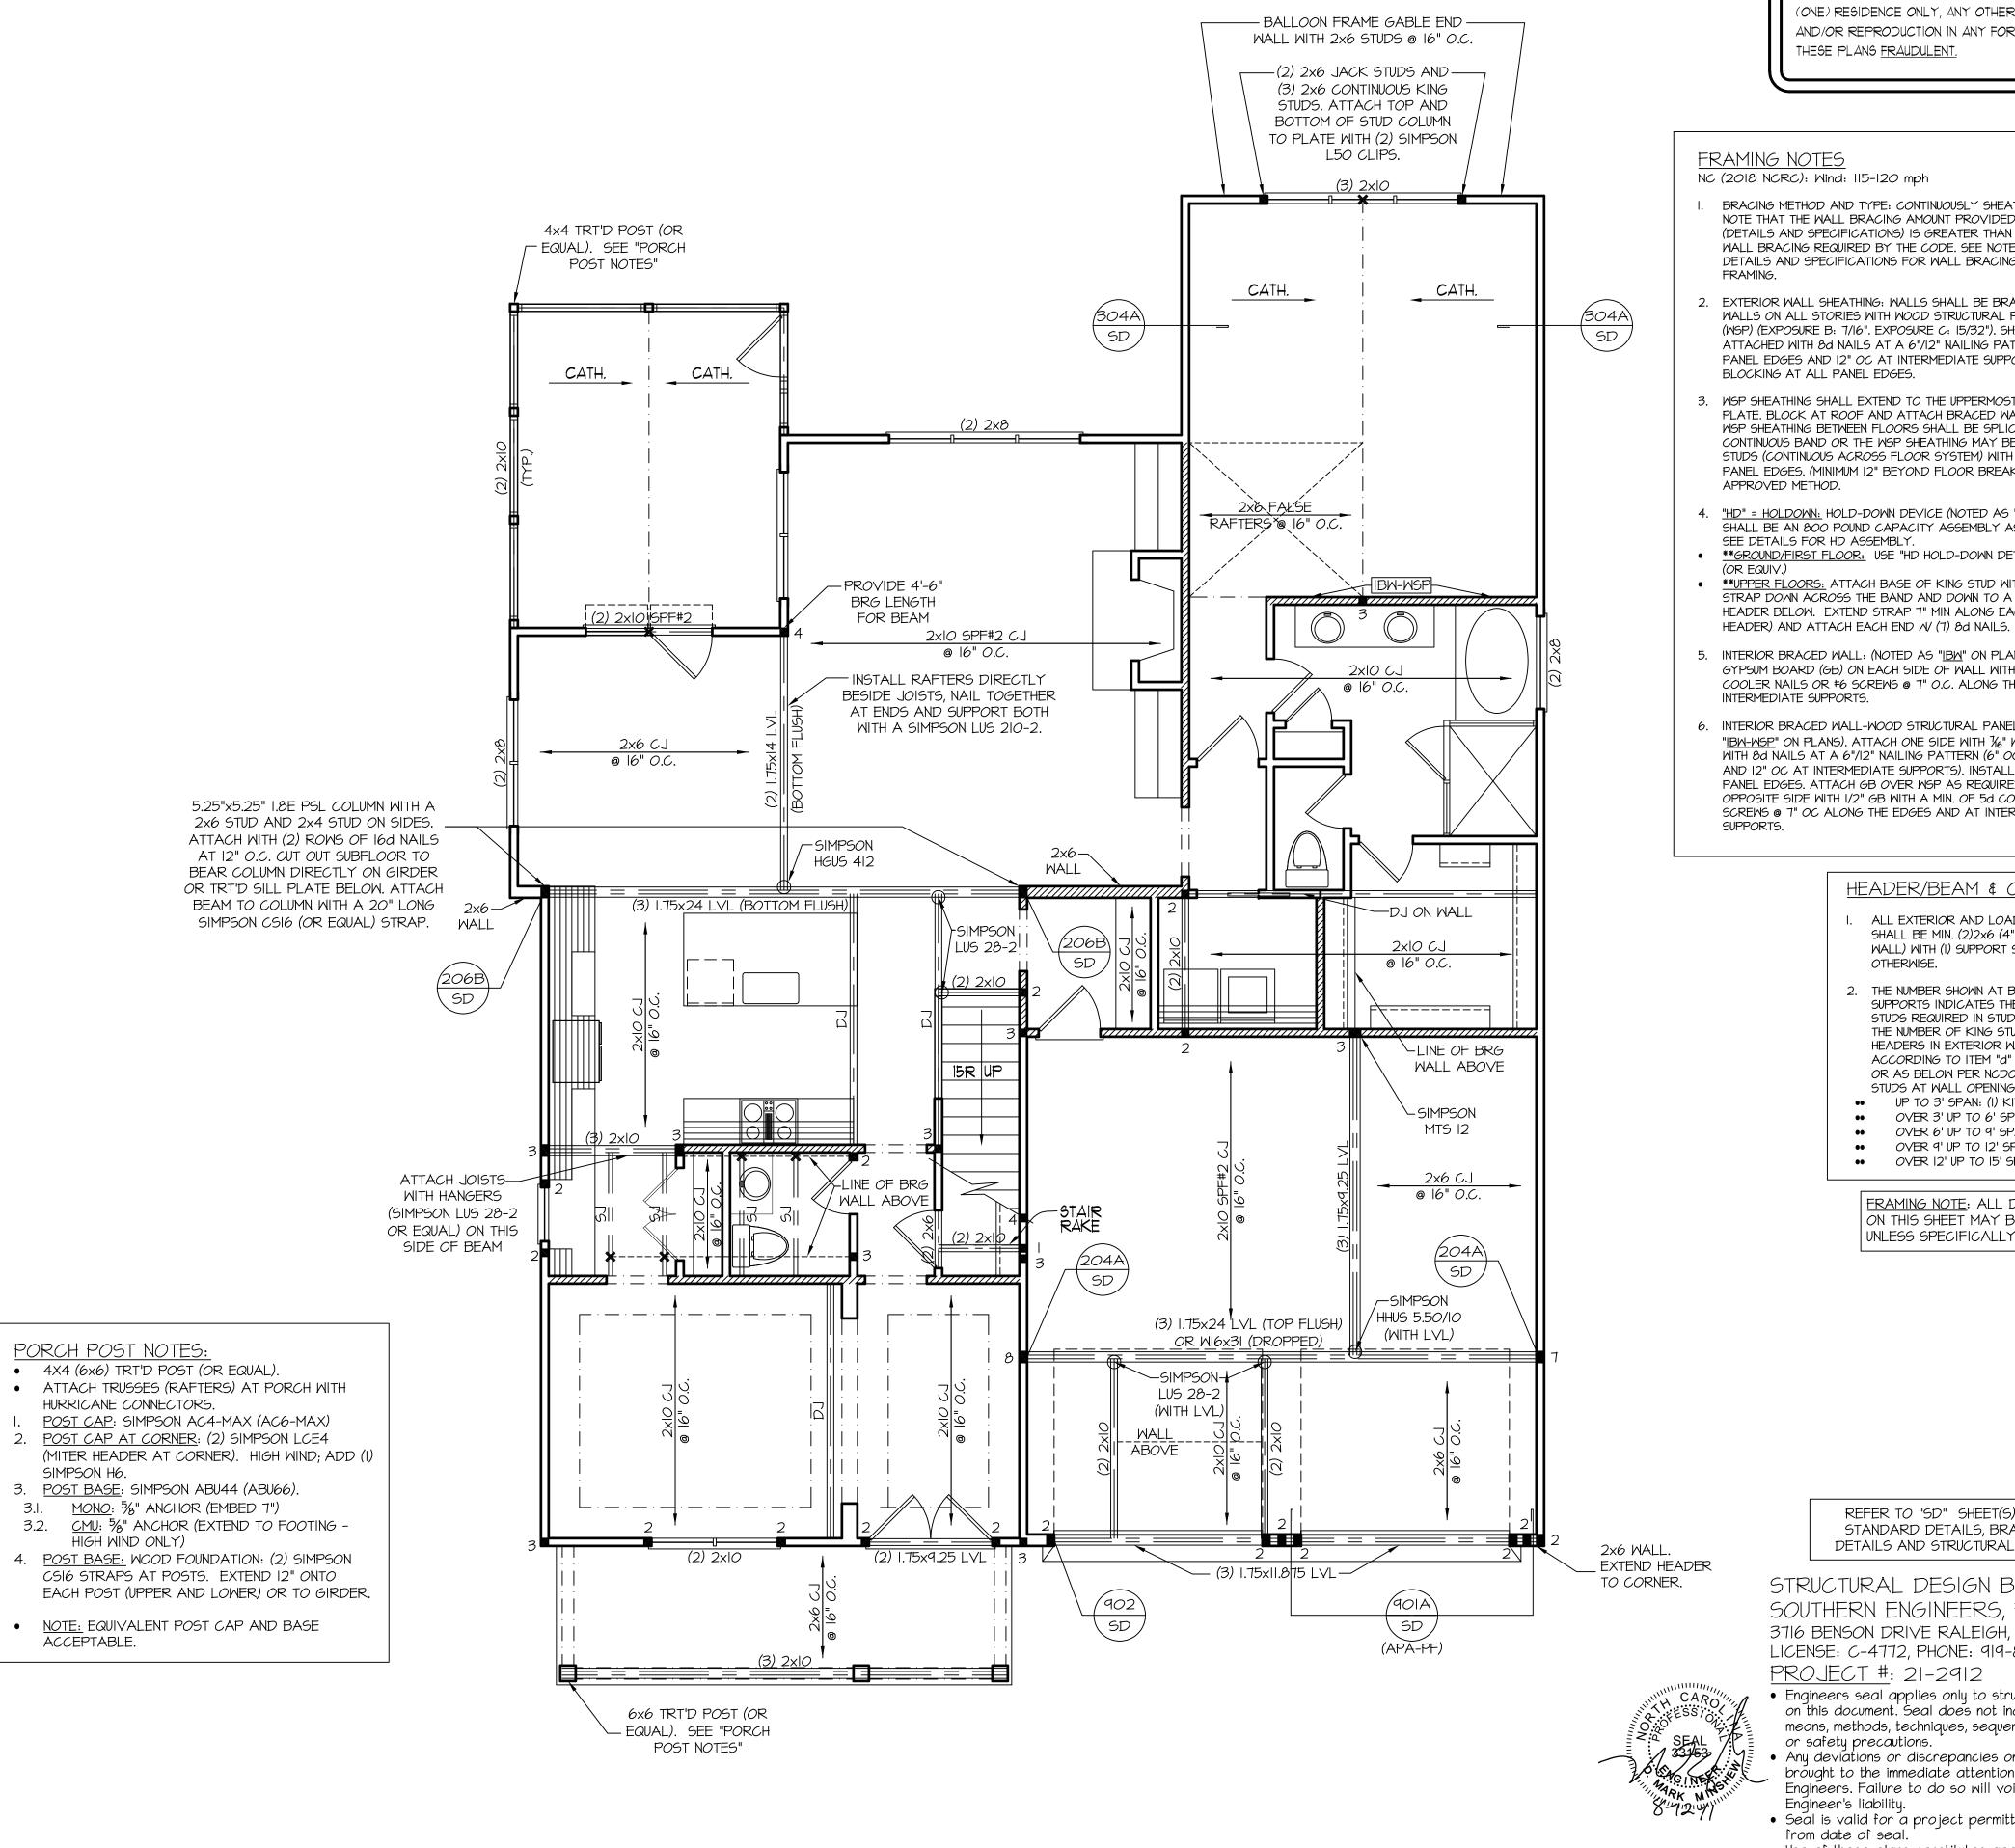

THESE PLANS FRAUDULENT.

FRAMING NOTES NC (2018 NCRC): Wind: 115-120 mph

- I. BRACING METHOD AND TYPE: CONTINUOUSLY SHEATHED WSP: CS-WSP. NOTE THAT THE WALL BRACING AMOUNT PROVIDED ON THE PLANS (DETAILS AND SPECIFICATIONS) IS GREATER THAN THE AMOUNT OF WALL BRACING REQUIRED BY THE CODE. SEE NOTES BELOW FOR DETAILS AND SPECIFICATIONS FOR WALL BRACING AND WALL
- 2. EXTERIOR WALL SHEATHING: WALLS SHALL BE BRACED BY SHEATHING WALLS ON ALL STORIES WITH WOOD STRUCTURAL PANEL SHEATHING (MSP) (EXPOSURE B: 7/16". EXPOSURE C: 15/32"). SHEATHING SHALL BE ATTACHED WITH 8d NAILS AT A 6"/12" NAILING PATTERN (6" OC AT PANEL EDGES AND 12" OC AT INTERMEDIATE SUPPORTS). INSTALL BLOCKING AT ALL PANEL EDGES.
- 3. WSP SHEATHING SHALL EXTEND TO THE UPPERMOST DOUBLE BEARING PLATE. BLOCK AT ROOF AND ATTACH BRACED WALLS PER CODE. WSP SHEATHING BETWEEN FLOORS SHALL BE SPLICED ALONG CONTINUOUS BAND OR THE WSP SHEATHING MAY BE SPLICED ACROSS STUDS (CONTINUOUS ACROSS FLOOR SYSTEM) WITH BLOCKING AT PANEL EDGES. (MINIMUM 12" BEYOND FLOOR BREAK) OR OTHER APPROVED METHOD.
- 4. "HD" = HOLDOWN: HOLD-DOWN DEVICE (NOTED AS "HD" ON PLANS) SHALL BE AN 800 POUND CAPACITY ASSEMBLY AS NOTED ON PLANS. SEE DETAILS FOR HD ASSEMBLY. • **GROUND/FIRST FLOOR: USE "HD HOLD-DOWN DETAIL" ON SD SHEET
- **UPPER FLOORS: ATTACH BASE OF KING STUD WITH A SIMPSON CS22 STRAP DOWN ACROSS THE BAND AND DOWN TO A STUD BELOW OR HEADER BELOW. EXTEND STRAP 7" MIN ALONG EACH STUD (OR
- 5. INTERIOR BRACED WALL: (NOTED AS "IBW" ON PLANS) ATTACH I/2" GYPSUM BOARD (GB) ON EACH SIDE OF WALL WITH A MIN. OF 5d COOLER NAILS OR #6 SCREWS @ 7" O.C. ALONG THE EDGES AND AT INTERMEDIATE SUPPORTS.
- 6. INTERIOR BRACED WALL-WOOD STRUCTURAL PANEL: (NOTED AS "IBW-WSP" ON PLANS). ATTACH ONE SIDE WITH 1/6" WSP SHEATHING WITH 8d NAILS AT A 6"/12" NAILING PATTERN (6" OC AT PANEL EDGES AND 12" OC AT INTERMEDIATE SUPPORTS). INSTALL BLOCKING AT ALL PANEL EDGES. ATTACH GB OVER WSP AS REQUIRED. ATTACH OPPOSITE SIDE WITH I/2" GB WITH A MIN. OF 5d COOLER NAILS OR #6 SCREWS @ 7" OC ALONG THE EDGES AND AT INTERMEDIATE

HEADER/BEAM & COLUMN NOTES

- I. ALL EXTERIOR AND LOAD BEARING HEADERS SHALL BE MIN. (2)2x6 (4" WALL) OR (3)2x6 (6" WALL) WITH (I) SUPPORT STUD, UNLESS NOTED OTHERWISE.
- THE NUMBER SHOWN AT BEAM AND HEADER SUPPORTS INDICATES THE NUMBER OF SUPPORT STUDS REQUIRED IN STUD POCKET OR COLUMN. THE NUMBER OF KING STUDS AT EACH END OF HEADERS IN EXTERIOR WALLS SHALL BE ACCORDING TO ITEM "d" IN TABLE R602.3(5) OR AS BELOW PER NCDOI COMMENTARY "KING STUDS AT WALL OPENINGS" REVISED 1-9-2020:
- •• UP TO 3' SPAN: (I) KING STUD OVER 3' UP TO 6' SPAN: (2) KING STUDS
- OVER 6' UP TO 9' SPAN: (3) KING STUDS OVER 9' UP TO 12' SPAN: (4) KING STUDS OVER 12' UP TO 15' SPAN: (5) KING STUDS

FRAMING NOTE: ALL DIMENSIONAL LUMBER ON THIS SHEET MAY BE SPF #2 OR SYP #2, UNLESS SPECIFICALLY NOTED OTHERWISE.

REFER TO "SD" SHEET(S) FOR STANDARD DETAILS, BRACING DETAILS AND STRUCTURAL NOTES.

STRUCTURAL DESIGN BY: SOUTHERN ENGINEERS, P.A. 3716 BENSON DRIVE RALEIGH, NC 27609 LICENSE: C-4772, PHONE: 919-878-1617 <u>PROJECT #</u>: 21-2912

- Engineers seal applies only to structural components on this document. Seal does not include construction means, methods, techniques, sequences, procedures or safety precautions.
- Any deviations or discrepancies on plans are to be brought to the immediate attention of Southern Engineers. Failure to do so will void Southern
- Engineer's liability. Seal is valid for a project permitted within one year
- from date of seal. Use of these plans constitutes approval of terms and conditions as defined in the customer agreement.

FIRST FLOOR CEILING STRUCTURAL PLAN 9'-0" CLG. HGT.

ALL DIMENSIONS, SITE CONDITIONS & CODES ARE TO

BE VERIFIED BEFORE CONSTR. BEGINS. ONCE CONSTR. HAS

BEGUN MURPHY GARNOW

DESIGN GROUP, INC. WILL NOT

ASSUME ANY LIABILITY FOR ANY EXPENSES ASSOCIATED

WITH ERRORS & OMMISIONS.

 $\frac{\mathbb{Z}}{\mathbb{Z}}$

GARNOW

MURPHY

RINCE LOT

DRAWN BY: TWG FILE NAME: HH-2-2591

5-3-16 TWG PLAN
1-8-19 TWG PLAN
1-1-21 TWG PLAN

© COPYRIGHT 2021 MURPHY GARNOW DESIGN GROUP, INC.

ALL RIGHTS RESERVED HOUSE NAME:

HOUSE NUMBER:

NOT

MURPHY GARNOW DESIGN GROUP, INC.
HEREBY EXPRESSLY RESERVES ITS COPYRIGHT AND
OTHER PROPERTY RIGHTS TO THESE PLANS. THESE
PLANS ARE TO BE USED FOR THE CONSTRUCTION OF
(ONE) RESIDENCE ONLY, ANY OTHER USE, CHANGE
AND/OR REPRODUCTION IN ANY FORM WILL RENDER
THESE PLANS FRAUDULENT.

FRAMING NOTES

NC (2018 NCRC): Wind: 115-120 mph

INTERMEDIATE SUPPORTS.

- I. BRACING METHOD AND TYPE: CONTINUOUSLY SHEATHED MSP: CS-MSP. NOTE THAT THE WALL BRACING AMOUNT PROVIDED ON THE PLANS (DETAILS AND SPECIFICATIONS) IS GREATER THAN THE AMOUNT OF WALL BRACING REQUIRED BY THE CODE. SEE NOTES BELOW FOR DETAILS AND SPECIFICATIONS FOR WALL BRACING AND WALL FRAMING.
- 2. EXTERIOR WALL SHEATHING: WALLS SHALL BE BRACED BY SHEATHING WALLS ON ALL STORIES WITH WOOD STRUCTURAL PANEL SHEATHING (WSP) (EXPOSURE B: 7/16". EXPOSURE C: 15/32"). SHEATHING SHALL BE ATTACHED WITH 8d NAILS AT A 6"/12" NAILING PATTERN (6" OC AT PANEL EDGES AND 12" OC AT INTERMEDIATE SUPPORTS). INSTALL BLOCKING AT ALL PANEL EDGES.
- 3. WSP SHEATHING SHALL EXTEND TO THE UPPERMOST DOUBLE BEARING PLATE. BLOCK AT ROOF AND ATTACH BRACED WALLS PER CODE. WSP SHEATHING BETWEEN FLOORS SHALL BE SPLICED ALONG CONTINUOUS BAND OR THE WSP SHEATHING MAY BE SPLICED ACROSS STUDS (CONTINUOUS ACROSS FLOOR SYSTEM) WITH BLOCKING AT PANEL EDGES. (MINIMUM 12" BEYOND FLOOR BREAK) OR OTHER APPROVED METHOD.
- 4. "HD" = HOLDOWN: HOLD-DOWN DEVICE (NOTED AS "HD" ON PLANS)
 SHALL BE AN 800 POUND CAPACITY ASSEMBLY AS NOTED ON PLANS.
 SEE DETAILS FOR HD ASSEMBLY.
 **GROUND/FIRST FLOOR: USE "HD HOLD-DOWN DETAIL" ON SD SHEET
- (OR EQUIV.)

 **UPPER FLOORS: ATTACH BASE OF KING STUD WITH A SIMPSON CS22
 STRAP DOWN ACROSS THE BAND AND DOWN TO A STUD BELOW OR

HEADER BELOW. EXTEND STRAP 7" MIN ALONG EACH STUD (OR

- HEADER) AND ATTACH EACH END W (7) &d NAILS.

 5. INTERIOR BRACED WALL: (NOTED AS "IBW" ON PLANS) ATTACH I/2"
 GYPSUM BOARD (6B) ON EACH SIDE OF WALL WITH A MIN. OF 5d
 COOLER NAILS OR #6 SCREWS @ 7" O.C. ALONG THE EDGES AND AT
- 6. INTERIOR BRACED WALL-WOOD STRUCTURAL PANEL: (NOTED AS "IBW-WSP" ON PLANS). ATTACH ONE SIDE WITH 1/6" WSP SHEATHING WITH 8d NAILS AT A 6"/12" NAILING PATTERN (6" OC AT PANEL EDGES AND 12" OC AT INTERMEDIATE SUPPORTS). INSTALL BLOCKING AT ALL PANEL EDGES. ATTACH GB OVER WSP AS REQUIRED. ATTACH OPPOSITE SIDE WITH 1/2" GB WITH A MIN. OF 5d COOLER NAILS OR #6 SCREWS @ 7" OC ALONG THE EDGES AND AT INTERMEDIATE SUPPORTS.

HEADER/BEAM & COLUMN NOTES

- I. ALL EXTERIOR AND LOAD BEARING HEADERS SHALL BE MIN. (2)2x6 (4" WALL) OR (3)2x6 (6" WALL) WITH (I) SUPPORT STUD, UNLESS NOTED OTHERWISE.
 - THE NUMBER SHOWN AT BEAM AND HEADER SUPPORTS INDICATES THE NUMBER OF SUPPORT STUDS REQUIRED IN STUD POCKET OR COLUMN. THE NUMBER OF KING STUDS AT EACH END OF HEADERS IN EXTERIOR WALLS SHALL BE ACCORDING TO ITEM "d" IN TABLE R602.3(5) OR AS BELOW PER NCDOI COMMENTARY "KING STUDS AT WALL OPENINGS" REVISED I-9-2020:
- UP TO 3' SPAN: (I) KING STUD
 OVER 3' UP TO 6' SPAN: (2) KING STUDS
 OVER 6' UP TO 9' SPAN: (3) KING STUDS
- OVER 6' UP TO 9' SPAN: (3) KING STUDS
 OVER 9' UP TO 12' SPAN: (4) KING STUDS
 OVER 12' UP TO 15' SPAN: (5) KING STUDS

FRAMING NOTE: ALL DIMENSIONAL LUMBER ON THIS SHEET MAY BE SPF #2 OR SYP #2, UNLESS SPECIFICALLY NOTED OTHERWISE.

REFER TO "SD" SHEET(S) FOR STANDARD DETAILS, BRACING DETAILS AND STRUCTURAL NOTES.

STRUCTURAL DESIGN BY:
SOUTHERN ENGINEERS, P.A.
3716 BENSON DRIVE RALEIGH, NC 27609
LICENSE: C-4772, PHONE: 919-878-1617
PROJECT #: 21-2912

- Engineers seal applies only to structural components on this document. Seal does not include construction means, methods, techniques, sequences, procedures or safety precautions.
- Any deviations or discrepancies on plans are to be brought to the immediate attention of Southern Engineers. Failure to do so will void Southern Engineer's liability.
- Engineer's liability.
 Seal is valid for a project permitted within one year from date of seal.
- Use of these plans constitutes approval of terms and conditions as defined in the customer agreement.

ALL DIMENSIONS, SITE
CONDITIONS & CODES ARE TO
BE VERIFIED BEFORE CONSTR.
BEGINS. ONCE CONSTR. HAS
BEGIN MURPHY GARNOW
DESIGN GROUP, INC. WILL NOT
ASSUME ANY LIABILITY FOR
ANY EXPENSES ASSOCIATED
WITH FRRORS & OMMISIONS

BEGINO ONCE CONSTR. HAS BEGIN MURPHY GARNOW DESIGN GROUP, INC. WILL NOT ASSUME ANY LIABILITY FOR ANY EXPENSES ASSOCIATED WITH ERRORS & OMMISIONS.

4RM ROAD NA 27511 9) 481-6970

||40-500 K||LDARE FARM ROAD | CARY, NORTH CAROLINA 275|| |(919) 481-9115 FAX; (919) 481-697

GARNOW

MURPHY

PRINCE PLACE LOT #61

DRAWN BY: TWG

FILE NAME: HH-2-2591

REVISIONS

5-3-16 TWG PLAN

1-8-19 TWG PLAN

1-1-21 TWG PLAN

COPYRIGHT 2021 RPHY GARNOW DESIGN GROUP INC


© COPYRIGHT 2021 MURPHY GARNOW DESIGN GROUP, INC. ALL RIGHTS RESERVED



HOUSE NUMBER:

PAGE NUMBER:

8 of 9

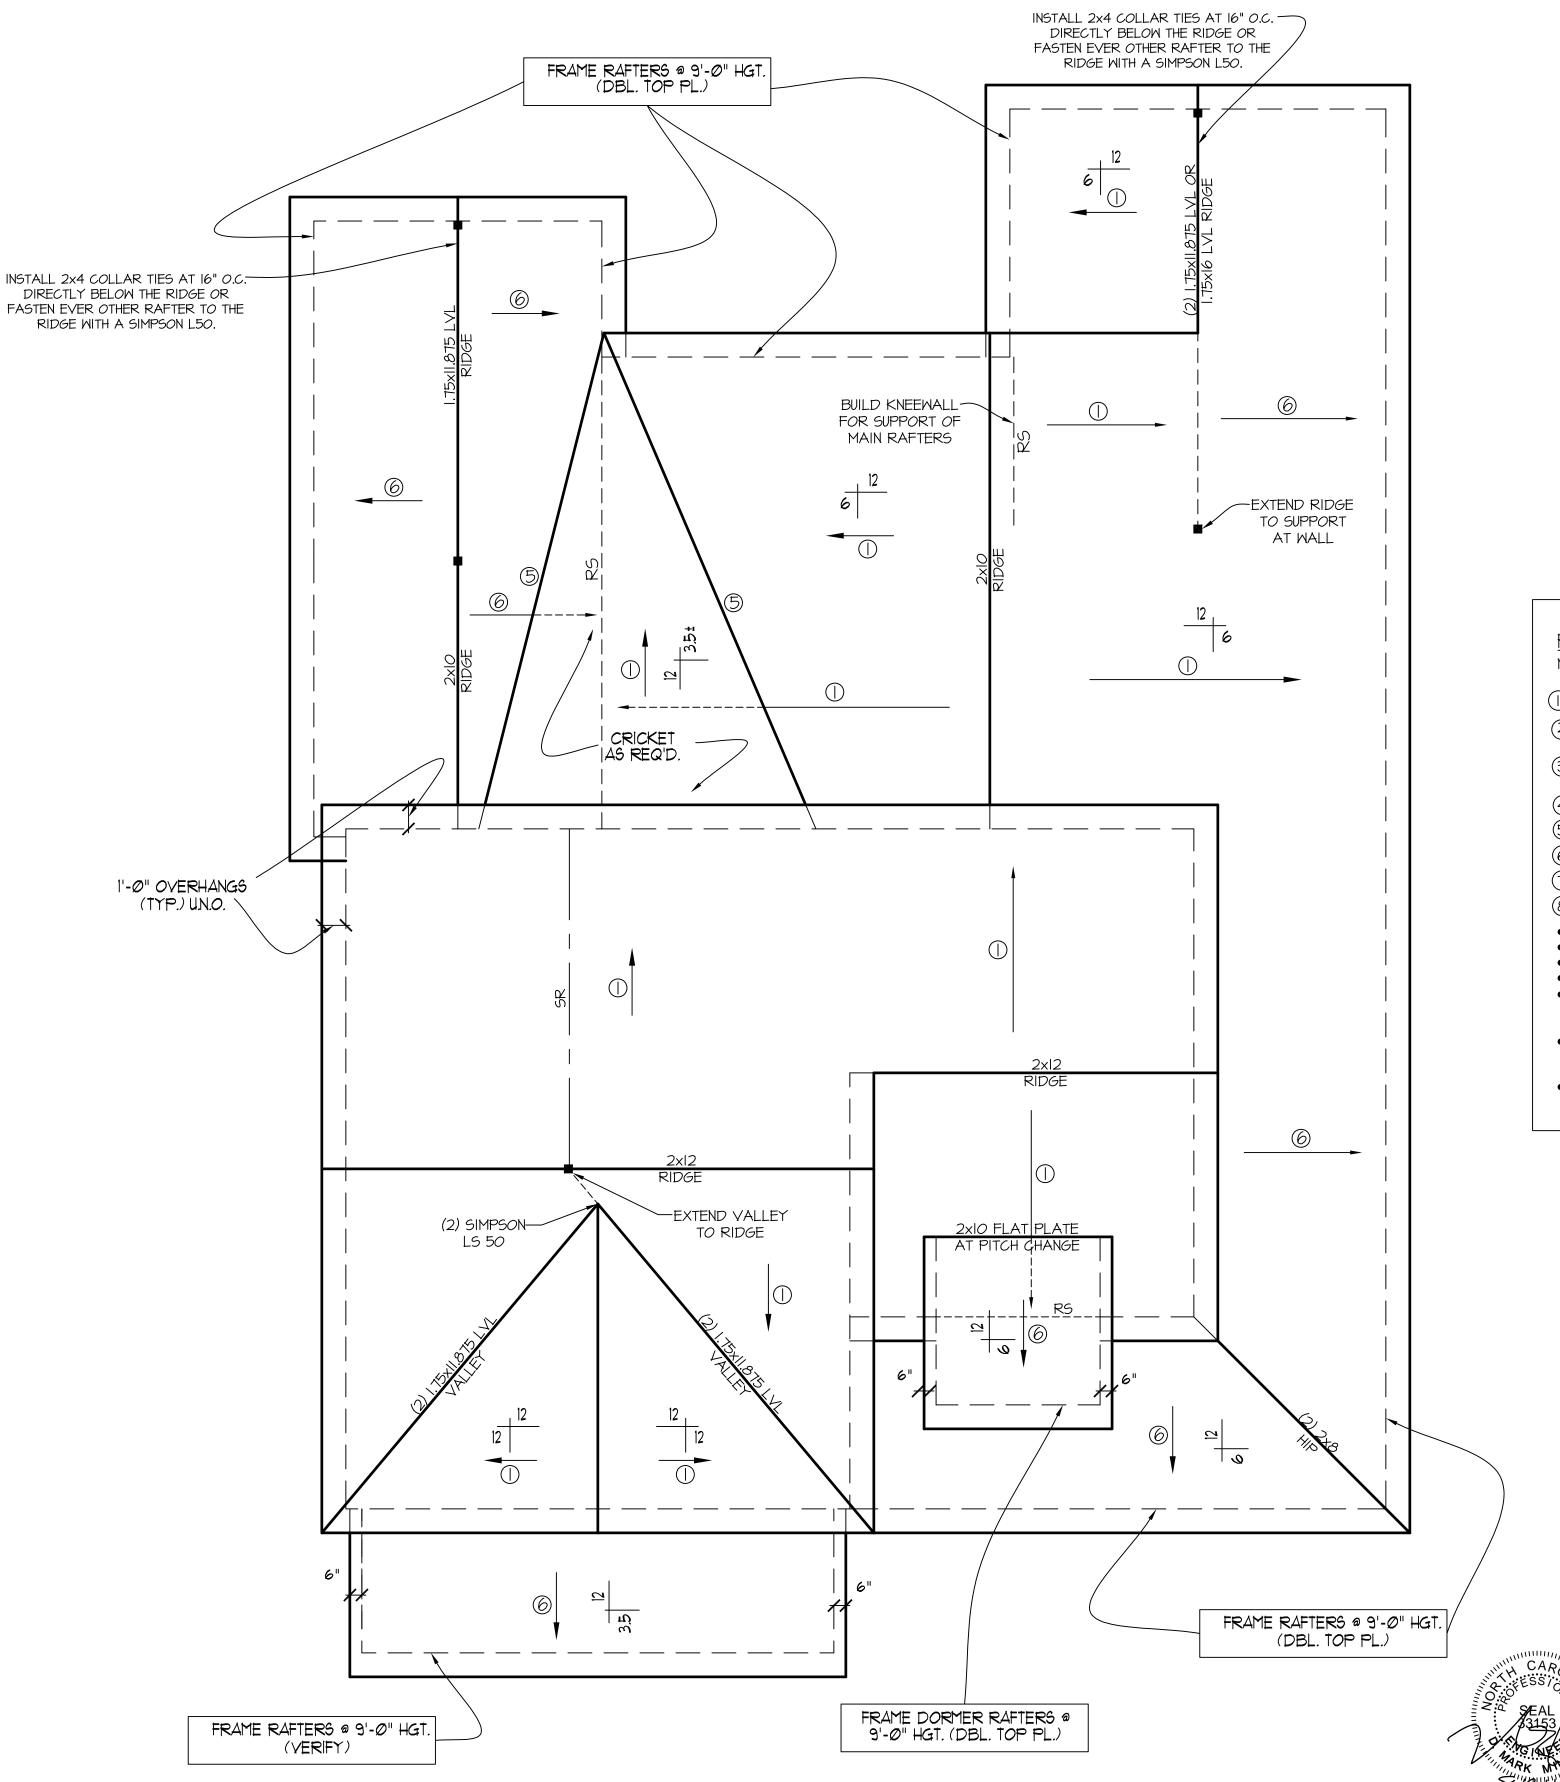

ROOF FRAMING NOTES:

- 1) ALLROOF PITCHES TO BE 10/12 (TYP.) U.N.O. 2) PROVIDE 2x4 COLLAR BEAMS EVERYOTHER RAFTER (TYP.)
- 3) PROVIDE "HURRICANE CLIPS" AT ALL VALLEYS AND OPPPOSING DBL. RAFTERS
- 4) PROVIDE DBL. HEADERS ABD TRIMMERS AT ALL ROOF OPENINGS (EX: DORMERS, SKYLIGHTS, CHIMNEYS,ETC.)
- 5) 2x8 RAFTERS @ CATH. OR YAULTED CLGS. TO BE FURRED DOWN OR USE DEEPER RAFTERS (VERIFY BRNG. HGT.) FOR PROPER INSULATION PER CODE
- 6) VERIFY ALL RAFTER BRNG. HGTS. BEFORE CONSTR. HAS BEGUN

FRAME 12/12 RAFTERS ON A 31/2"± KNEEWALL TO ALIGN SOFFITS W/ 10/12 SOFFITS. (VERIFY W/ BLDR.)

ROOF FRAMING NOTES:

- NC (2018 NCRC): Wind: 115-120 mph
- (I.) 2x8 RAFTERS @ 16" O.C. WITH 2x10 RIDGE, UNO.
- (2) 2x10 OR 1.75x11.875 LVL HIP. (2) 2x10 HIPS MAY BE SPLICED WITH A MIN. 6'-0" OVERLAP AT CENTER
- (2) 2xIO OR 1.75x9.25 LVL VALLEY. DO NOT SPLICE VALLEYS
- (4) 1.75x11.875 LVL OR (2)1.75x9.25 LVL VALLEY
- (5.) FALSE FRAME VALLEY ON 2XIO FLAT PLATE
- (6) 2x6 RAFTERS @ 16" O.C. W/ 2x8 RIDGE, UNO. (7.) 2x10 RAFTERS @ 16" O.C. W/ 2x12 RIDGE, UNO.
- 8) EXTEND RIDGE 12" BEYOND INTERSECTION
 - "SR" = SINGLE RAFTER
- "DR" = DOUBLE RAFTER
- "TR" = TRIPLE RAFTER
- "RS" = ROOF SUPPORT • "■" = (3) STUD OR 4x4 POST FOR ROOF SUPPORT (USE 2X6 STUDS OR 6X6 POST FOR SUPPORT OVER 10'-0" IN
- ATTACH VAULTED RAFTERS WITH HURRICANE CLIPS: SIMPSON "H-2.5A" OR EQUIVALENT. TIES TO BE INSTALLED
- ON THE OUTSIDE FACE OF FRAMING. INSTALL RAFTER TIES AND COLLAR TIES PER SECTION R802.3.1 OF THE 2018 NC RESIDENTIAL CODE.

FRAMING NOTE: ALL DIMENSIONAL LUMBER ON THIS SHEET MAY BE SPF #2 OR SYP #2, | UNLESS SPECIFICALLY NOTED OTHERWISE.

REFER TO "SD" SHEET(S) FOR STANDARD DETAILS, BRACING DETAILS AND STRUCTURAL NOTES.

STRUCTURAL DESIGN BY: SOUTHERN ENGINEERS, P.A. 3716 BENSON DRIVE RALEIGH, NC 27609 LICENSE: C-4772, PHONE: 919-878-1617 <u>PROJECT #</u>: 21-2912

- Engineers seal applies only to structural components on this document. Seal does not include construction means, methods, techniques, sequences, procedures or safety precautions.
- Any deviations or discrepancies on plans are to be brought to the immediate attention of Southern Engineers. Failure to do so will void Southern
- Enqineer's liability. Seal is valid for a project permitted within one year
- from date of seal. Use of these plans constitutes approval of terms and conditions as defined in the customer agreement.

ALL DIMENSIONS, SITE CONDITIONS & CODES ARE TO BE VERIFIED BEFORE CONSTR. BEGINS. ONCE CONSTR. HAS BEGUN MURPHY GARNOW DESIGN GROUP, INC. WILL NOT ASSUME ANY LIABILITY FOR ANY EXPENSES ASSOCIATED WITH ERRORS & OMMISIONS.

aroup, DE51GN FAX; (919) GARNOW

MURPHY

Q

PRINCE LOT

DRAWN BY: TWG


FILE NAME: HH-2-2591


5-3-16 TWG PLAN 1-8-19 TWG PLAN 1-1-1-21 TWG PLAN


© COPYRIGHT 2021 MURPHY GARNOW DESIGN GROUP, INC. ALL RIGHTS RESERVED

HOUSE NAME:

HOUSE NUMBER:

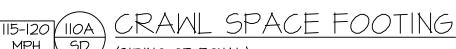

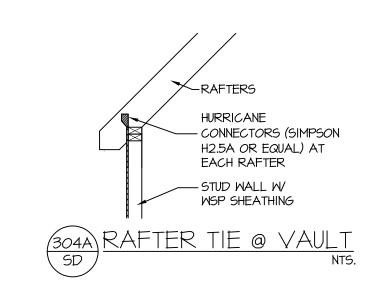

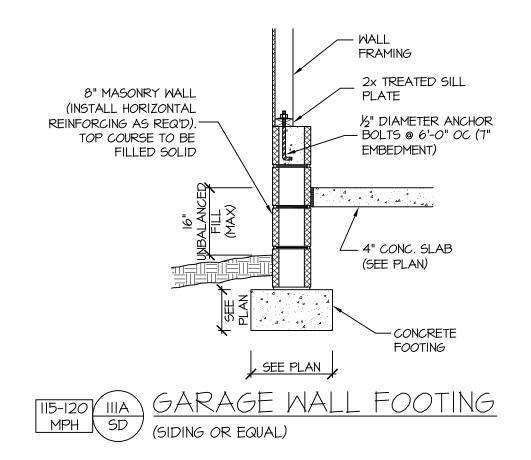

(2) ROWS OF 16d

(2) SIMPSON CSI6 STRAP

TO WALL TOP PLATE AND

MIN (2)2X WALL FRAMING.

SEE PLAN FOR STUD

COLUMN REQUIREMENTS.

%" DIAM. ANCHOR BOLT

2"x2"x¾" PLATE WASHER.

%" THREADED ROD WITH

%"×1½"×1½" PLATE

WASHERS AND NUTS OR

EMBEDMENT INTO FTG.

CONCRETE FOOTING

3" CONC. COVER AT

BOTTOM AND 6" MIN

3.500 LB HOLDOWN (SIMPSON

HTT4 HOLDOWN W/ -

18-16dx2-1/2" NAILS

OR EQUAL)

8" MASONRY WALL

(INSTALL HORIZONTAL

TOP COURSE TO BE FILLED SOLID

REINFORCING AS REQ'D).

%" THREADED ROD WITH %"-

AND NUTS OR SIMPSON "SET

OR SET-XP" EPOXY. 7" MIN.

EMBEDMENT INTO FTG.

x 1 岁" x 1 岁" PLATE WASHERS

CONC. COVER ON

SIDES OF ANCHOR.

(SEE PLANS FOR

SIMPSON "SET OR SET-XP"

(7" EMBEDMENT) WITH

(I) 2x PLATE

TREATED PLATE

8" BOND BEAM

WITH (1) #4 BAR.

8" (MIN) CMU

EPOXY. 7" MIN.

MIN IO" DEEP

MIDTH)

WITH 8d NAILS. (EXTEND

EXTEND 20" UNDER

SINKER NAILS

AT 3" *O*C.

HEADER).

- NOTE: FOR 3" WIDE HEADERS

SOLID BLOCKING AT STRAPS.

SEGMENTS BETWEEN OPENINGS, THE STRAPS SHALL BE INSTALLED AT

THE STUD COLUMN ON EACH END OF

NOTE: AT INTERMEDIATE WALL

THE WALL SEGMENT.

FOR ACTUAL SIZE. EXTEND

PANEL EDGES SHALL BE

OVER PANEL.

PLAN

MIN. 3"xII.25" HEADER. SEE PLAN

FASTEN SHEATHING TO HEADER

W/8d COMMON NAILS IN 3" GRID PATTERN AND 3" O.C. IN ALL

FRAMING (STUDS, BLOCKING, AND ___

BLOCKED AND OCCUR WITHIN 24" OF MID-HEIGHT. ONE ROW OF

ATTACH BLOCKING TOGETHER W

3,500 LB HOLDOWN (SIMPSON

MIN. FTG WIDTH

UNDER OPENING: 12"

HTT4 HOLDOWN W/ 18-16dx2-1/2"

TYP. SHEATHING-TO-FRAMING

NAILING IS REQ'D (3" OC).

(3) 16d SINKERS.

NAILS OR EQUAL)

GARAGE

-SLAB OVER

GRAVEL AS

SPECIFIED

INTERIOR VIEW

____ 2X WALL FRAMING

/-- (I) 2x PLATE

- TREATED PLATE

- 4" CONC. SLAB

(SEE PLAN)

SEE PLAN

FOOTING SECTION

CAPACITIES.

8" BOND BEAM

- WITH (1) #4 BAR.

-OPTIONAL 12" CMU

- 3" CONC. COVER AT

ANCHOR. (TYP)

COVER ON SIDES OF

-MIN IO" DEEP CONCRETE

FOOTING (SEE PLANS FOR


BOTTOM AND 6" MIN CONC.

Y901A) APA PORTAL FRAME W/ HOLD-DOWNS

DETAIL AND APPLICATION BASED ON APA TT-100F WITH USE

OF TABLE I FOR APA PORTAL FRAME WITH HOLD-DOWN

IN 2x6 WALLS, PROVIDE

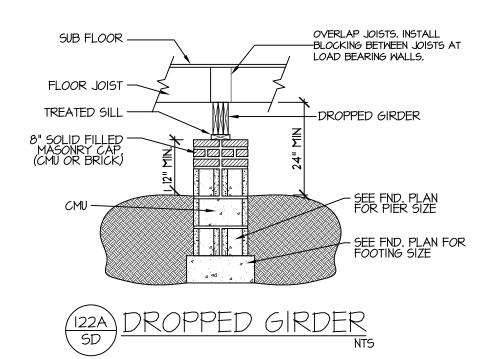

6' TO 18'

MIN 7/16" THICK WOOD

— (2) 2x PLATES

---- TREATED SILLPLATI

STRUCTURAL PANEL

SHEATHING

EXTERIOR VIEW

-SIDE WALL

OPENING


3,500 LB HOLDOWN


HOLDOWN) OR EQUAL


SIMPSON HTT4

(SIMPSON HTT4

PLAN VIEW

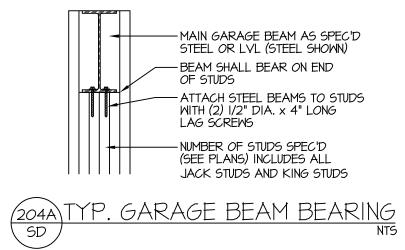

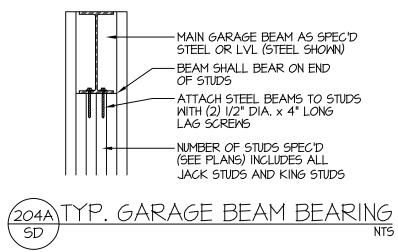

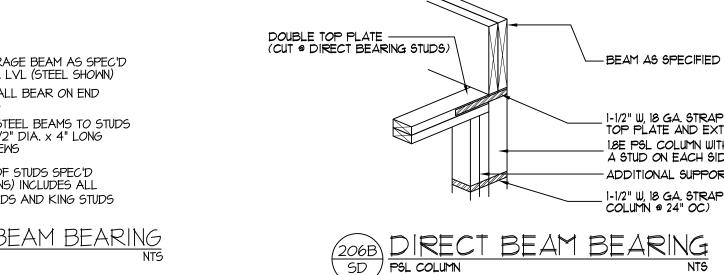

STRUCTURAL NOTES

VALLEYS, RIDGES, FLOORS, WALLS, BEAMS AND HEADERS, COLUMNS, CANTILEVERS, OFFSET LOAD BEARING WALLS, PIER & GIRDER SYSTEM, FOOTING, AND PILING SYSTEM. ENGINEER'S SEAL DOES NOT CERTIFY DIMENSIONAL ACCURACY OR ARCHITECTURAL LAYOUT INCLUDING

ATTIC WITHOUT PERMANENT STAIR: (20 PSF, IO PSF, L/360)

STAIRS: (40 PSF, IO PSF, L/360)

4. WALLS SHALL BE BRACED BY SHEATHING WALLS ON ALL STORIES WITH WOOD STRUCTURAL

5. SEE APPENDIX M (DCA6) FOR EXTERIOR DECK REQUIREMENTS INCLUDING ATTACHMENTS FOR

LATERAL LOADS.

6. CONCRETE SHALL HAVE A MINIMUM 28 DAY STRENGTH OF 3000 PSI AND A MAXIMUM SLUMP OF 5 INCHES UNLESS NOTED OTHERWISE (UNO). AIR ENTRAINED PER TABLE 402.2. ALL CONCRETE SHALL BE PROPORTIONED, MIXED, HANDLED, SAMPLED, TESTED, AND PLACED IN ACCORDANCE WITH ACI STANDARDS. ALL SAMPLES FOR PUMPING SHALL BE TAKEN FROM THE EXIT END OF THE PUMP. CONTROL JOINTS IN SLABS SHALL BE SPACED ON A GRID OF +-30 TIMES THE DEPTH (D). CONTROL JOINTS SHALL BE SAWCUT TO A DEPTH OF I/D. (I.E. 4" CONCRETE SLABS SHALL

8. ALL FRAMING LUMBER SHALL BE SPF #2 (Fb = 875 PSI) UNLESS NOTED OTHERWISE (UNO). ALL TREATED LUMBER SHALL BE SYP # 2. PLATE MATERIAL MAY BE SPF # 3 OR SYP #3 (Fc(perp) =

12. REBAR SHALL BE DEFORMED STEEL, ASTM615, GRADE 60. LAP ALL REBAR SPLICES 30 BAR

AT 24" O.C. (MAX), AND STAGGERED AT THE TOP AND BOTTOM OF BEAM (2" EDGE DISTANCE), WITH 2 BOLTS LOCATED AT 6" FROM EACH END.

14. BRICK LINTELS (WHEN REQUIRED) SHALL BE 3 1/2"x3 1/2"x1/4" STEEL ANGLE FOR UP TO 6'-0" SPAN AND 6"x4"x5/16" STEEL ANGLE WITH 6" LEG VERTICAL FOR SPANS UP TO 9'-O". SEE PLANS FOR SPANS OVER 9'-0". SEE ALSO SECTION R703.8.3 LINTELS.



SOUTHERN ENGINEERS, P.A. 3716 BENSON DRIVE RALEIGH, NC 27609 LICENSE: C-4772, PHONE: 919-878-1617 PROJECT #: 21-2912

 Engineers seal applies only to structural components on this document. Seal does not include construction means, methods, techniques, sequences, procedures

or safety precautions.

• Use of these plans constitutes approval of terms and conditions as defined in the customer agreement.

_ I-1/2" W, 18 G.A. STRAP (WRAP TOP PLATE AND EXTEND 12"; _ 1.8E PSL COLUMN WITH A STUD ON EACH SIDE. -ADDITIONAL SUPPORT STUDS _ 1-1/2" W, 18 G.A. STRAP (WRAP _ COLUMN @ 24" OC)

NC (2018 NCRC): Wind: 115-120 mph

I. ENGINEER'S SEAL APPLIES ONLY TO STRUCTURAL COMPONENTS INCLUDING ROOF RAFTERS, HIPS, ROOF SYSTEM. ALL REQUIREMENTS FOR PROFESSIONAL CERTIFICATION SHALL BE PROVIDED BY THE APPROPRIATE PROFESSIONAL. SOUTHERN ENGINEERS, P.A. CERTIFIES ONLY THE STRUCTURAL COMPONENTS AS SPECIFICALLY STATED.

ALL CONSTRUCTION SHALL CONFORM TO THE LATEST REQUIREMENTS OF THE 2018 NO RESIDENTIAL CODE, PLUS ALL LOCAL CODES AND REGULATIONS. THE STRUCTURAL ENGINEER IS NOT RESPONSIBLE FOR, AND WILL NOT HAVE CONTROL OF, CONSTRUCTION MEANS, METHODS, TECHNIQUES, SEQUENCES OR PROCEDURES, OR FOR SAFETY PRECAUTIONS AND PROGRAMS IN CONNECTION WITH THE CONSTRUCTION WORK, NOR WILL THE ENGINEER BE RESPONSIBLE FOR THE CONTRACTOR'S FAILURE TO CARRY OUT THE CONSTRUCTION WORK IN ACCORDANCE WITH THE CONTRACT DOCUMENTS. "CONSTRUCTION REVIEW" SERVICES ARE NOT PART OF OUR CONTRACT. ALL MEMBERS SHALL BE FRAMED ANCHORED, TIED AND BRACED IN ACCORDANCE WITH GOOD CONSTRUCTION PRACTICE AND THE BUILDING CODE.

3. DESIGN LOADS (LISTED AS: LIVE LOAD, DEAD LOAD, DEFLECTION)

ROOMS OTHER THAN SLEEPING ROOMS: (40 PSF, IO PSF, L/360)

 SLEEPING ROOMS: (30 PSF, IO PSF, L/360) ATTIC WITH PERMANENT STAIR: (40 PSF, IO PSF, L/360)

ATTIC WITHOUT STORAGE: (10 PSF, 10 PSF, L/240)

EXTERIOR BALCONIES: (60 PSF, IO PSF, L/360)

DECKS: (40 PSF, 10 PSF, L/360)

 GUARDRAILS AND HANDRAILS: (200 LBS) PASSSENGER VEHICLE GARAGES: (50 PSF, IO PSF, L/360)

FIRE ESCAPES: (40 PSF, IO PSF, L/360)

SNOW: (20 PSF)

PANELS. SEE FRAMING NOTES FOR THICKNESS AND NAILING REQUIREMENTS.

HAVE 4" DEEP CONTROL JOINTS SAWCUT IN SLAB ON A +-10'-0" x +-10'-0" GRID).

7. ALLOWABLE SOIL BEARING PRESSURE ASSUMED TO BE 2000 PSF. THE CONTRACTOR MUST CONTACT A GEOTECHNICAL ENGINEER AND THE STRUCTURAL ENGINEER IF UNSATISFACTORY SUBSURFACE CONDITIONS ARE ENCOUNTERED. THE SURFACE AREA ADJACENT TO THE FOUNDATION WALL SHALL BE PROVIDED WITH ADEQUATE DRAINAGE, AND SHALL BE GRADED SO AS TO DRAIN SURFACE WATER AWAY FROM FOUNDATION WALLS.

9. L.V.L. SHALL BE LAMINATED VENEER LUMBER: Fb=2600 PSI, Fy=285 PSI, E=I,9xI0 PSI. 9.I. P.S.L. SHALL BE PARALLEL STRAND LUMBER: Fb=2900 PSI, Fv=290 PSI, E=2.0x10 PSI. 9.2. L.S.L. SHALL BE LAMINATED STRAND LUMBER: Fb=2250 PSI, Fv=400 PSI, E=1.55xI0 PSI. INSTALL ALL CONNECTIONS PER MANUFACTURERS INSTRUCTIONS.

IO. ALL ROOF TRUSS AND I-JOIST LAYOUTS SHALL BE PREPARED IN ACCORDANCE WITH THE SEALED STRUCTURAL DRAWINGS. TRUSSES AND I-JOISTS SHALL BE INSTALLED ACCORDING TO THE MANUFACTURE'S SPECIFICATIONS. ANY CHANGE IN TRUSS OR I-JOIST LAYOUT SHALL BE COORDINATED WITH SOUTHERN ENGINEERS.

II. ALL STRUCTURAL STEEL SHALL BE ASTM A-36. STEEL BEAMS SHALL BE SUPPORTED AT EACH END WITH A MINIMUM BEARING LENGTH OF 3 I/2" INCHES AND FULL FLANGE WIDTH. PROVIDE SOLID BEARING FROM BEAM SUPPORT TO FOUNDATION. BEAMS SHALL BE ATTACHED TO EACH SUPPORT WITH TWO LAG SCREWS (I/2" DIAMETER x 4" LONG). LATERAL SUPPORT IS CONSIDERED ADEQUATE PROVIDING THE JOIST ARE TOE NAILED TO THE SOLE PLATE, AND SOLE PLATE IS NAILED OR BOLTED TO THE BEAM FLANGE @ 48" O.C. ALL STEEL TUBING SHALL BE ASTM A500.

13. FLITCH BEAMS SHALL BE BOLTED TOGETHER USING (2) ROWS OF 1/2" DIAMETER BOLTS (ASTM A325) WITH WASHERS PLACED UNDER THE THREADED END OF BOLT. BOLTS SHALL BE SPACED

STRUCTURAL DESIGN BY:

 Any deviations or discrepancies on plans are to be brought to the immediate attention of Southern Engineers. Failure to do so will void Southern Engineer's liability.

• Seal is valid for a project permitted within one year from date of seal.

HOUSE NUMBER: PAGE NUMBER:

ALL DIMENSIONS, SITE CONDITIONS & CODES ARE TO BE VERIFIED BEFORE CONSTR. BEGINS. ONCE CONSTR. HAS BEGUN MURPHY GARNOW DESIGN GROUP, INC. WILL NOT

ASSUME ANY LIABILITY FOR ANY EXPENSES ASSOCIATED

WITH ERRORS & OMMISIONS.

GARNOW

O

DRAWN BY: TWG

FILE NAME: **HH-2-2591**

5-3-16 TWG PLAN

TWG PLAN


COPYRIGHT 2021

MURPHY GARNOW DESIGN

GROUP, INC.

ALL RIGHTS RESERVED

HOUSE NAME:

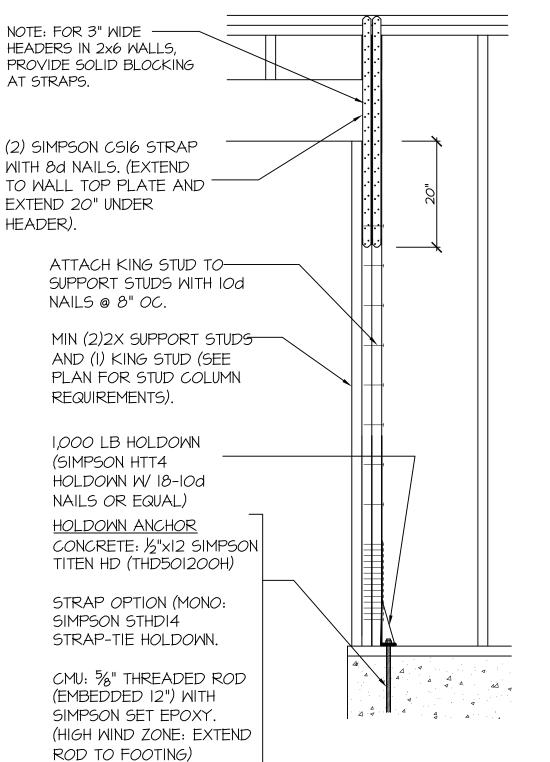

END CONDITION DETAIL

(FOR USE WITH SINGLE APA PORTAL FRAME CONDITION) DETAIL AND APPLICATION BASED ON APA TT-100F WITH USE OF TABLE I FOR APA PORTAL FRAME WITH HOLD-DOWN CAPACITIES.