

RENAISSANCE

RESIDENTIAL DESIGN, INC. RALEIGH, NC 27612

(919) 649-4128 WWW.RRDCAROLINA.COM

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HICKORY-II

DATE: FEBRUARY 19, 2021 REV.:


SCALE: AS NOTED DRAWN BY: WG

ENGINEERED BY:

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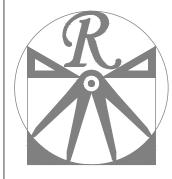
B - ELEVATIONS

A-2

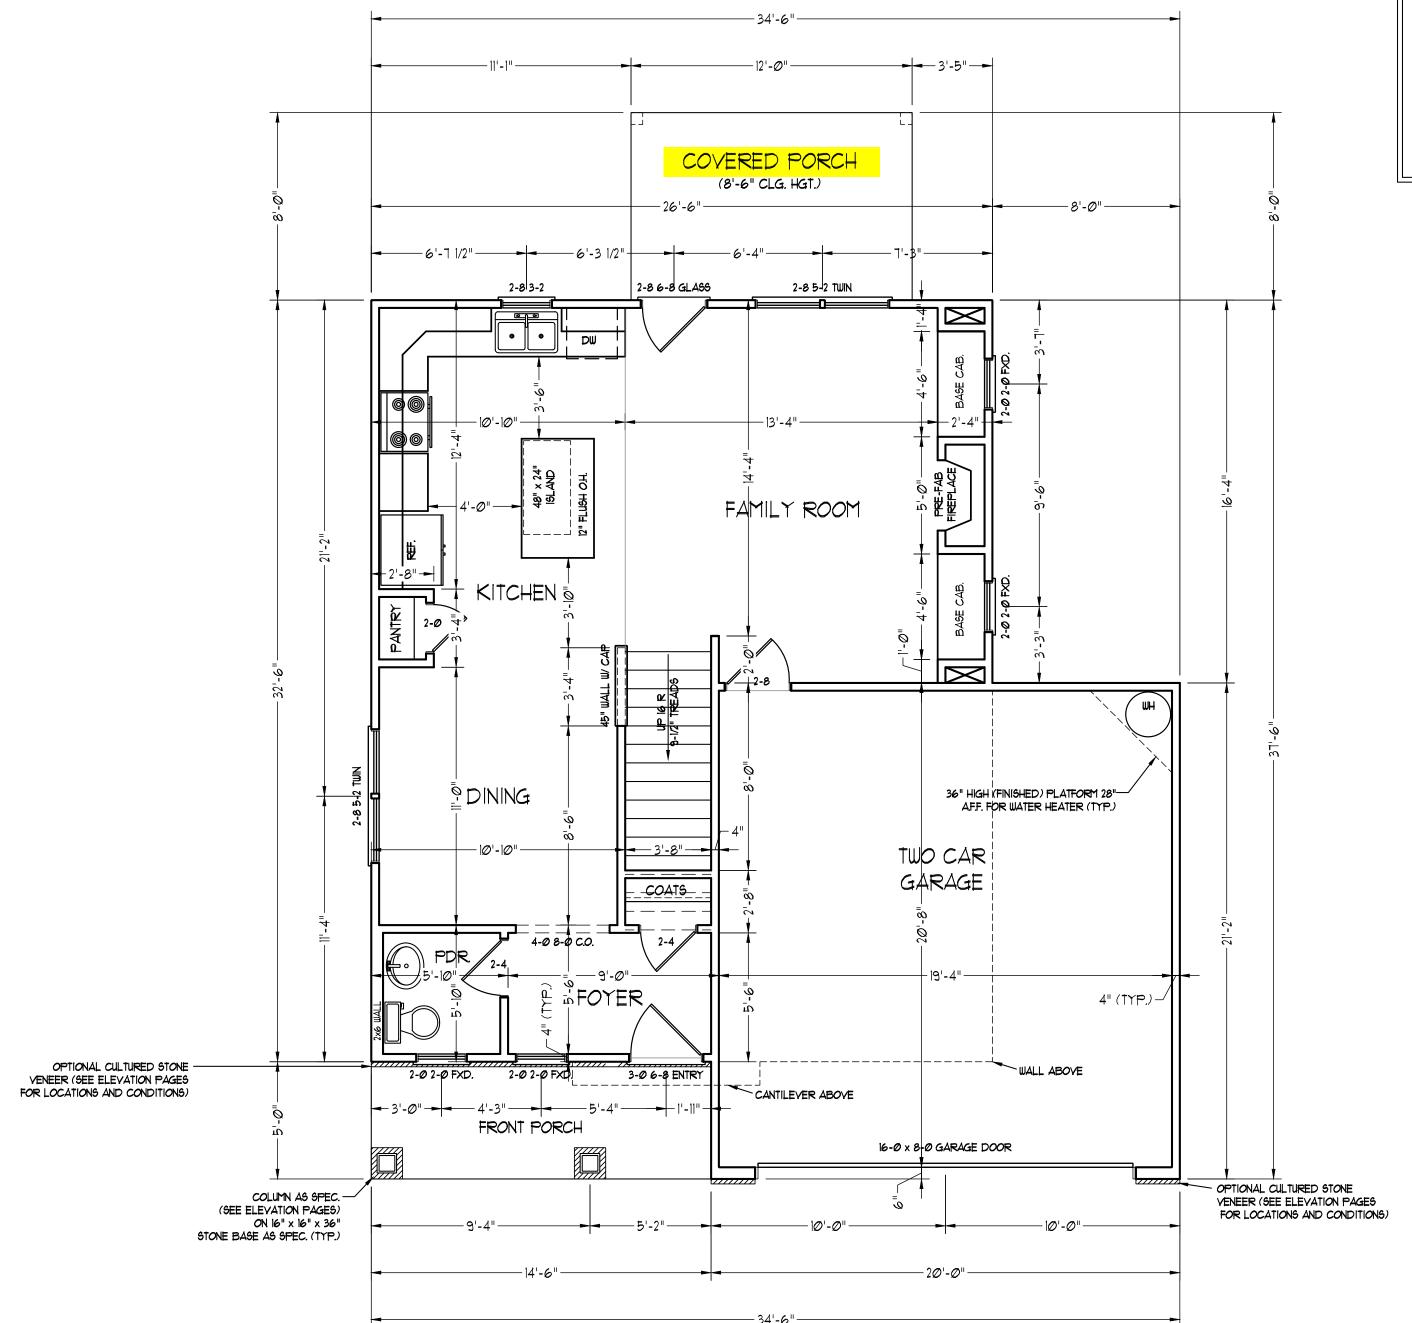

SQUARE FOOTAGE (I.F.S.)

Ist FLOOR: 639 SQ. FT. 795 SQ. FT. 2nd FLOOR: 1434 SQ. FT. TOTAL: 393 SQ. FT. GARAGE: FRONT PORCH: 73 SQ. FT. STD. REAR PATIO: 96 SQ. FT. OPT. REAR PORCH: 96 SQ. FT.



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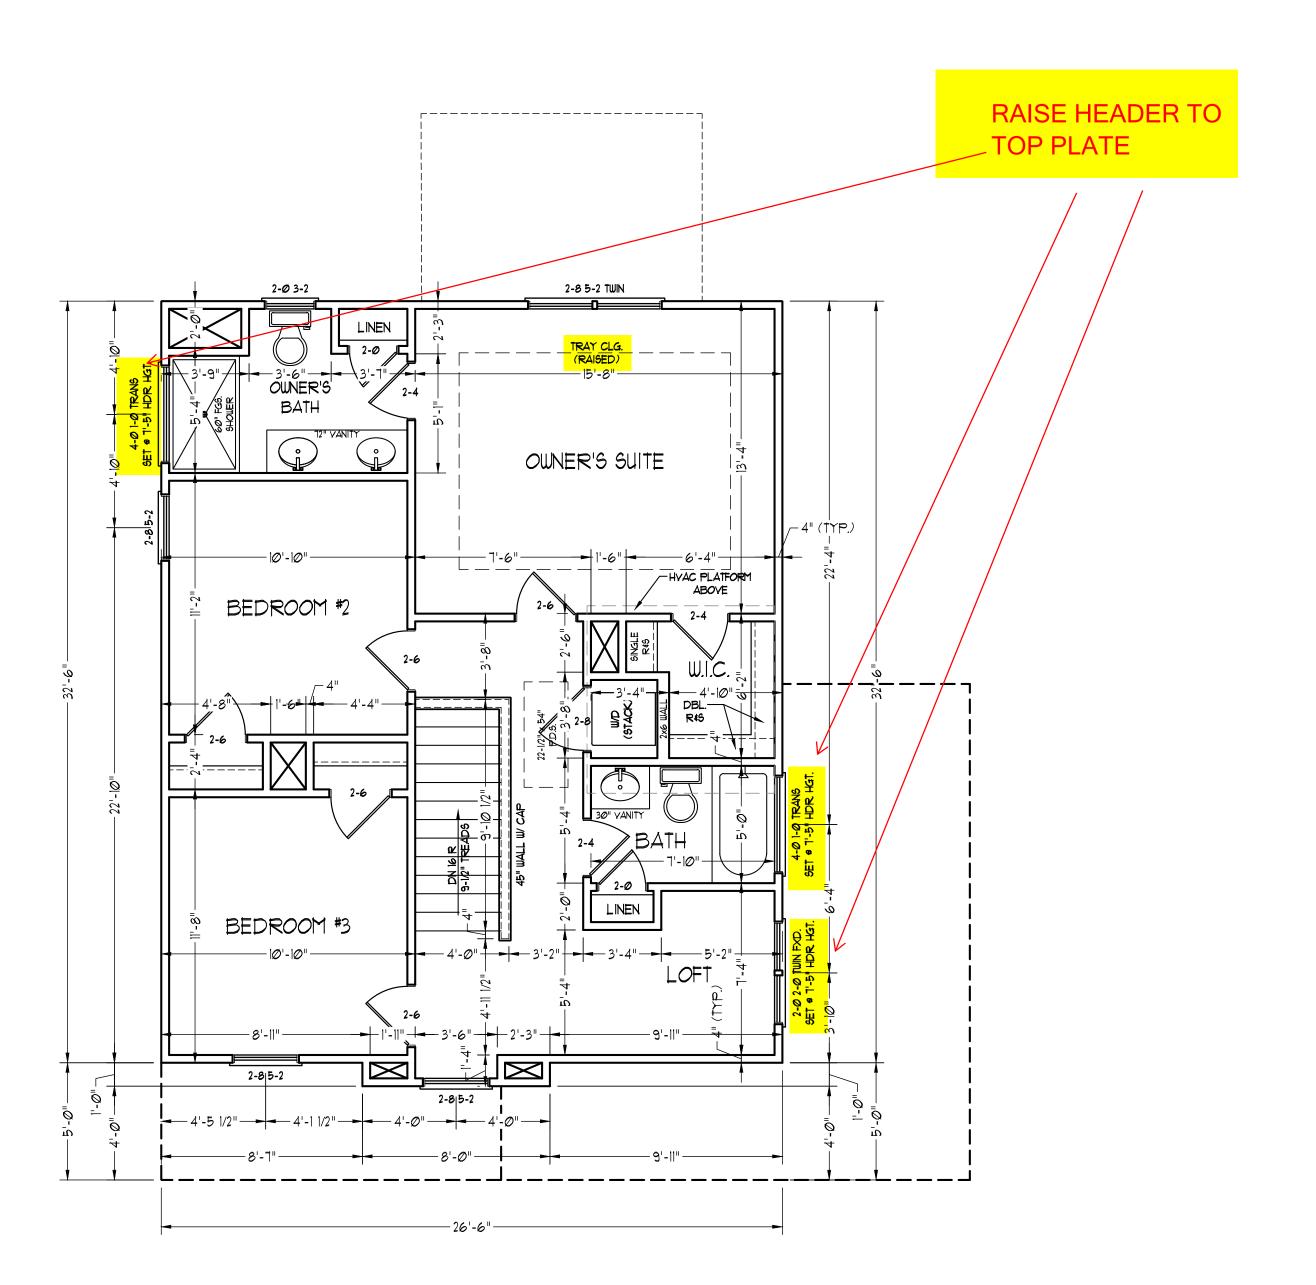
ENGINEERED BY:

REVIEWED BY:

FIRST FLOOR PLAN

A-4

SCALE NOTE: 18x24 PRINTS ARE TO SCALE AS NOTED. 11x17 PRINTS ARE NOT TO SCALE





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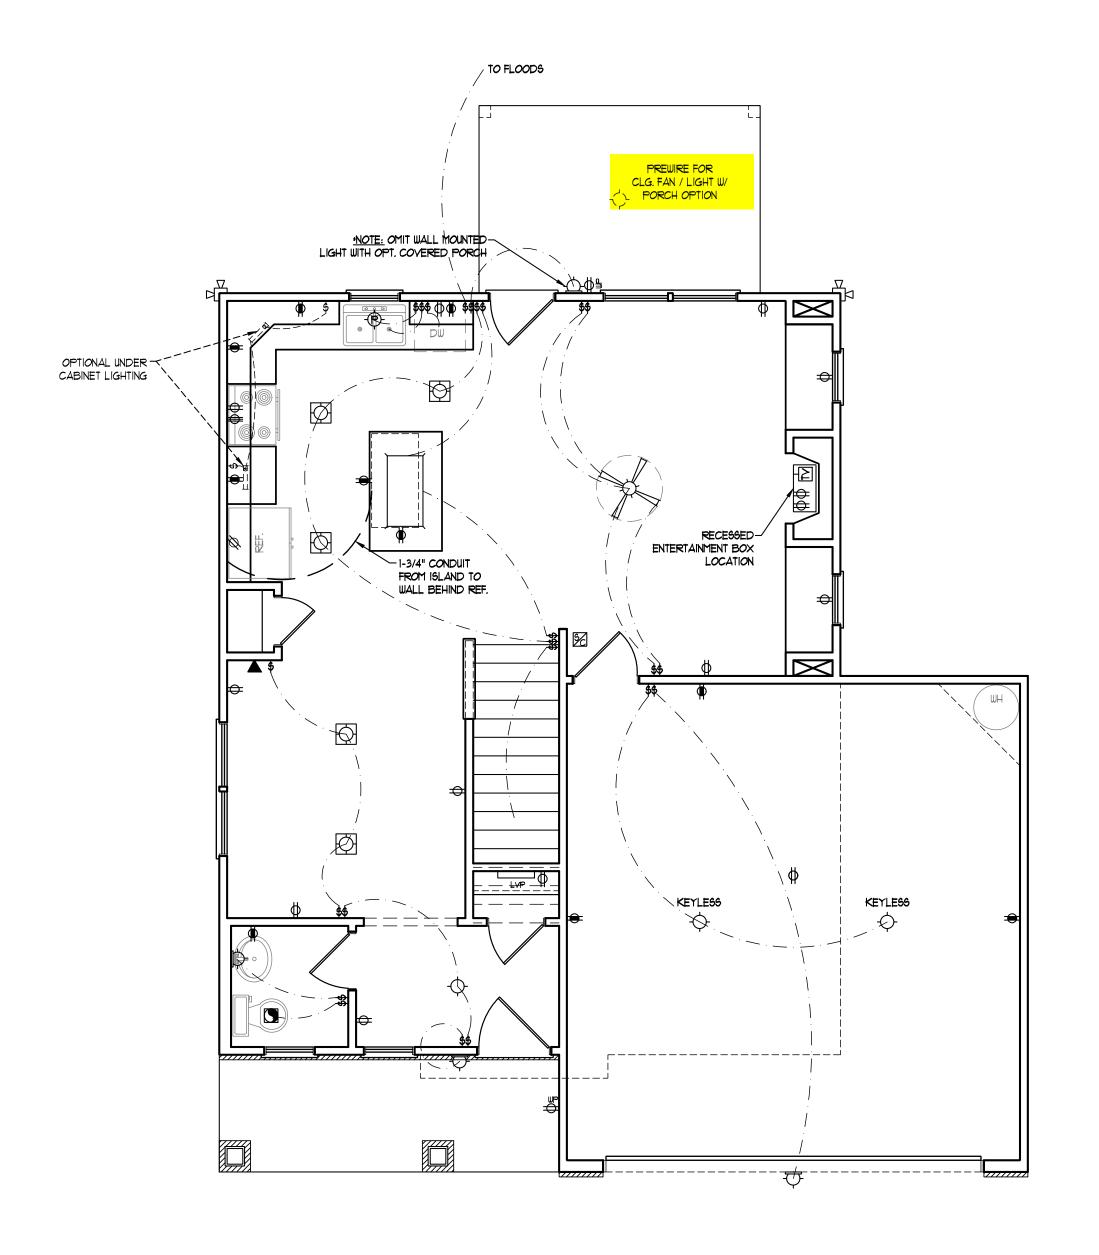
DRAWN BY: WG

ENGINEERED BY: REVIEWED BY:

SECOND FLOOR PLAN

A-5

SCALE NOTE: 18x24 PRINTS ARE TO SCALE AS NOTED. 11x17 PRINTS ARE NOT TO SCALE



ELECTRICAL LAYOUT NOTES:

- 1.) BLOCK AND WIRE FOR ALL CELING FANS PER PLAN.
- 2.) VANITY LIGHTS TO BE SET 90" AFF. (TYP.)
- 3.) ADDITIONAL EXTERIOR OUTLETS REQUIRED BY CODE TO BE LOCATED BY ELECTRICIAN.
- 4.) PLACE SWITCHES 8" (MIN.) FROM ROUGH OPENINGS.


ELECTRICAL LEGEND

- → IIØ Y OUTLET
- = 110 V GFI OUTLET
- → 110 Y SWITCHED OUTLET
- $_{\mathrm{BB}}$ \Longrightarrow 110 V BASEBOARD OUTLET
- 4-PLEX
- COUNTER OR FLOOR MOUNTED
- COUNTER OR FLOOR MOUNTED 110V GF1
- ₩EATHERPROOF
- **⇒** 22Ø ∨ OUTLET
- Ø 110 V DEDICATED CIRCUIT
- # 220 Y DEDICATED CIRCUIT
- PH SPECIAL PURPOSE (240 V, ETC.)
- WALL MOUNT LIGHT
- -P- PENDANT LIGHT
- RECESSED CAN LIGHT
- MINI CAN LIGHT
- EYEBALL LIGHT FLUORESCENT LIGHT
- undercabinet light
- FLOOD LIGHT
- \$ SWITCH
- \$D DIMMER SWITCH
- ▲ TELEPHONE
- \triangle data
- TELEPHONE AND DATA
- TY- TY CONNECTION
- TV/ DATA
- CD- CONDUIT FOR COMPONENT WIRING
- 110 V SMOKE/ CM DETECTOR
- 5D IIØ V SMOKE DETECTOR
- EXHAUST FAN
- LOW VOLTAGE PANEL ALARM PANEL





SCALE NOTE: 18x24 PRINTS ARE TO SCALE AS NOTED. 11x17 PRINTS ARE NOT TO SCALE

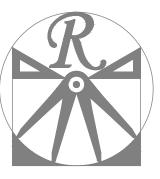

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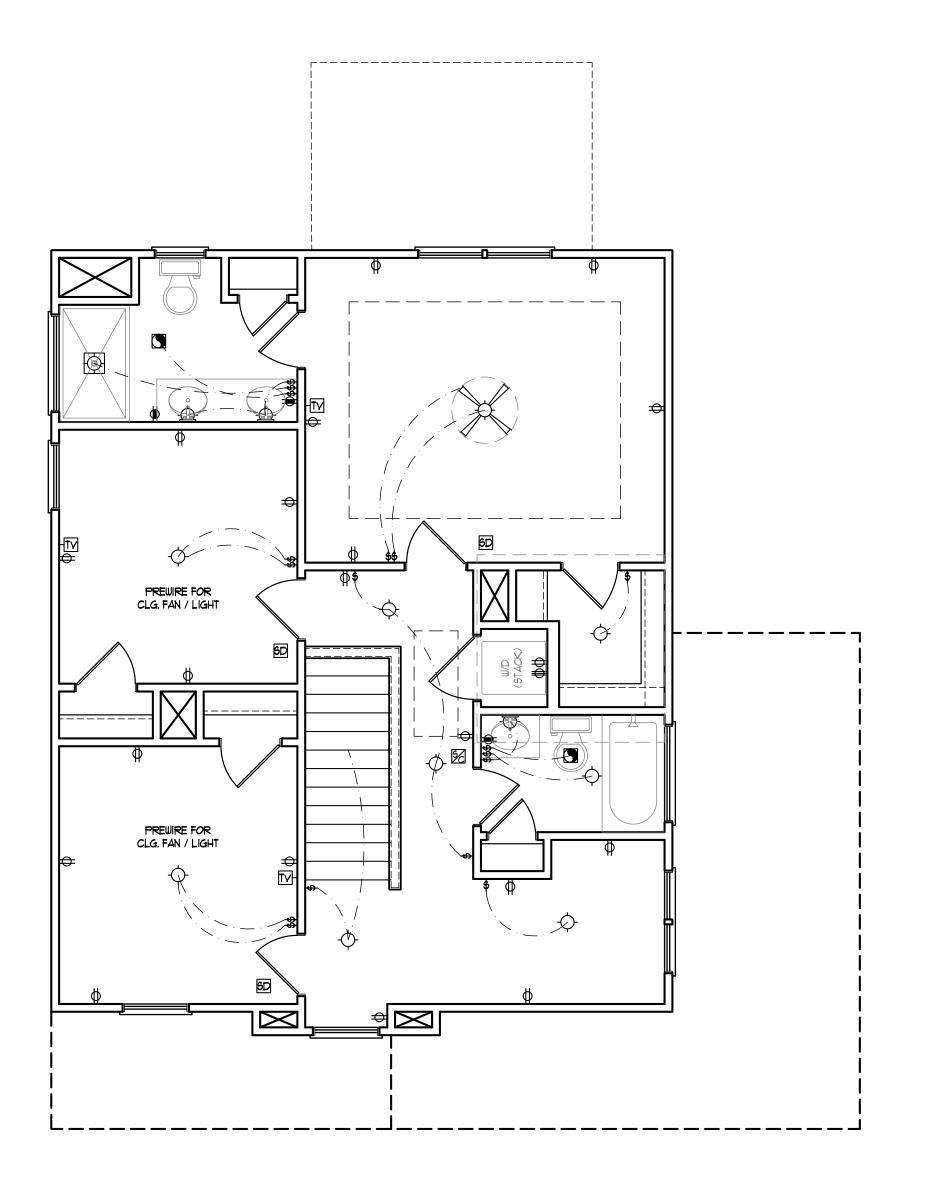
DRAWN BY: WG ENGINEERED BY:

REVIEWED BY: FIRST FLOOR

ELECTRICAL

PLAN

E-1



ELECTRICAL LAYOUT NOTES:

- 1.) BLOCK AND WIRE FOR ALL CELING FANS PER PLAN.
- 2.) VANITY LIGHTS TO BE SET 90" AFF. (TYP.)
- 3.) ADDITIONAL EXTERIOR OUTLETS REQUIRED BY CODE TO BE LOCATED BY ELECTRICIAN.
- 4.) PLACE SWITCHES 8" (MIN.) FROM ROUGH OPENINGS.

ELECTRICAL LEGEND

- ⇒ 110 ∨ OUTLET
- € 110 V GFI OUTLET
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- 4-PLEX
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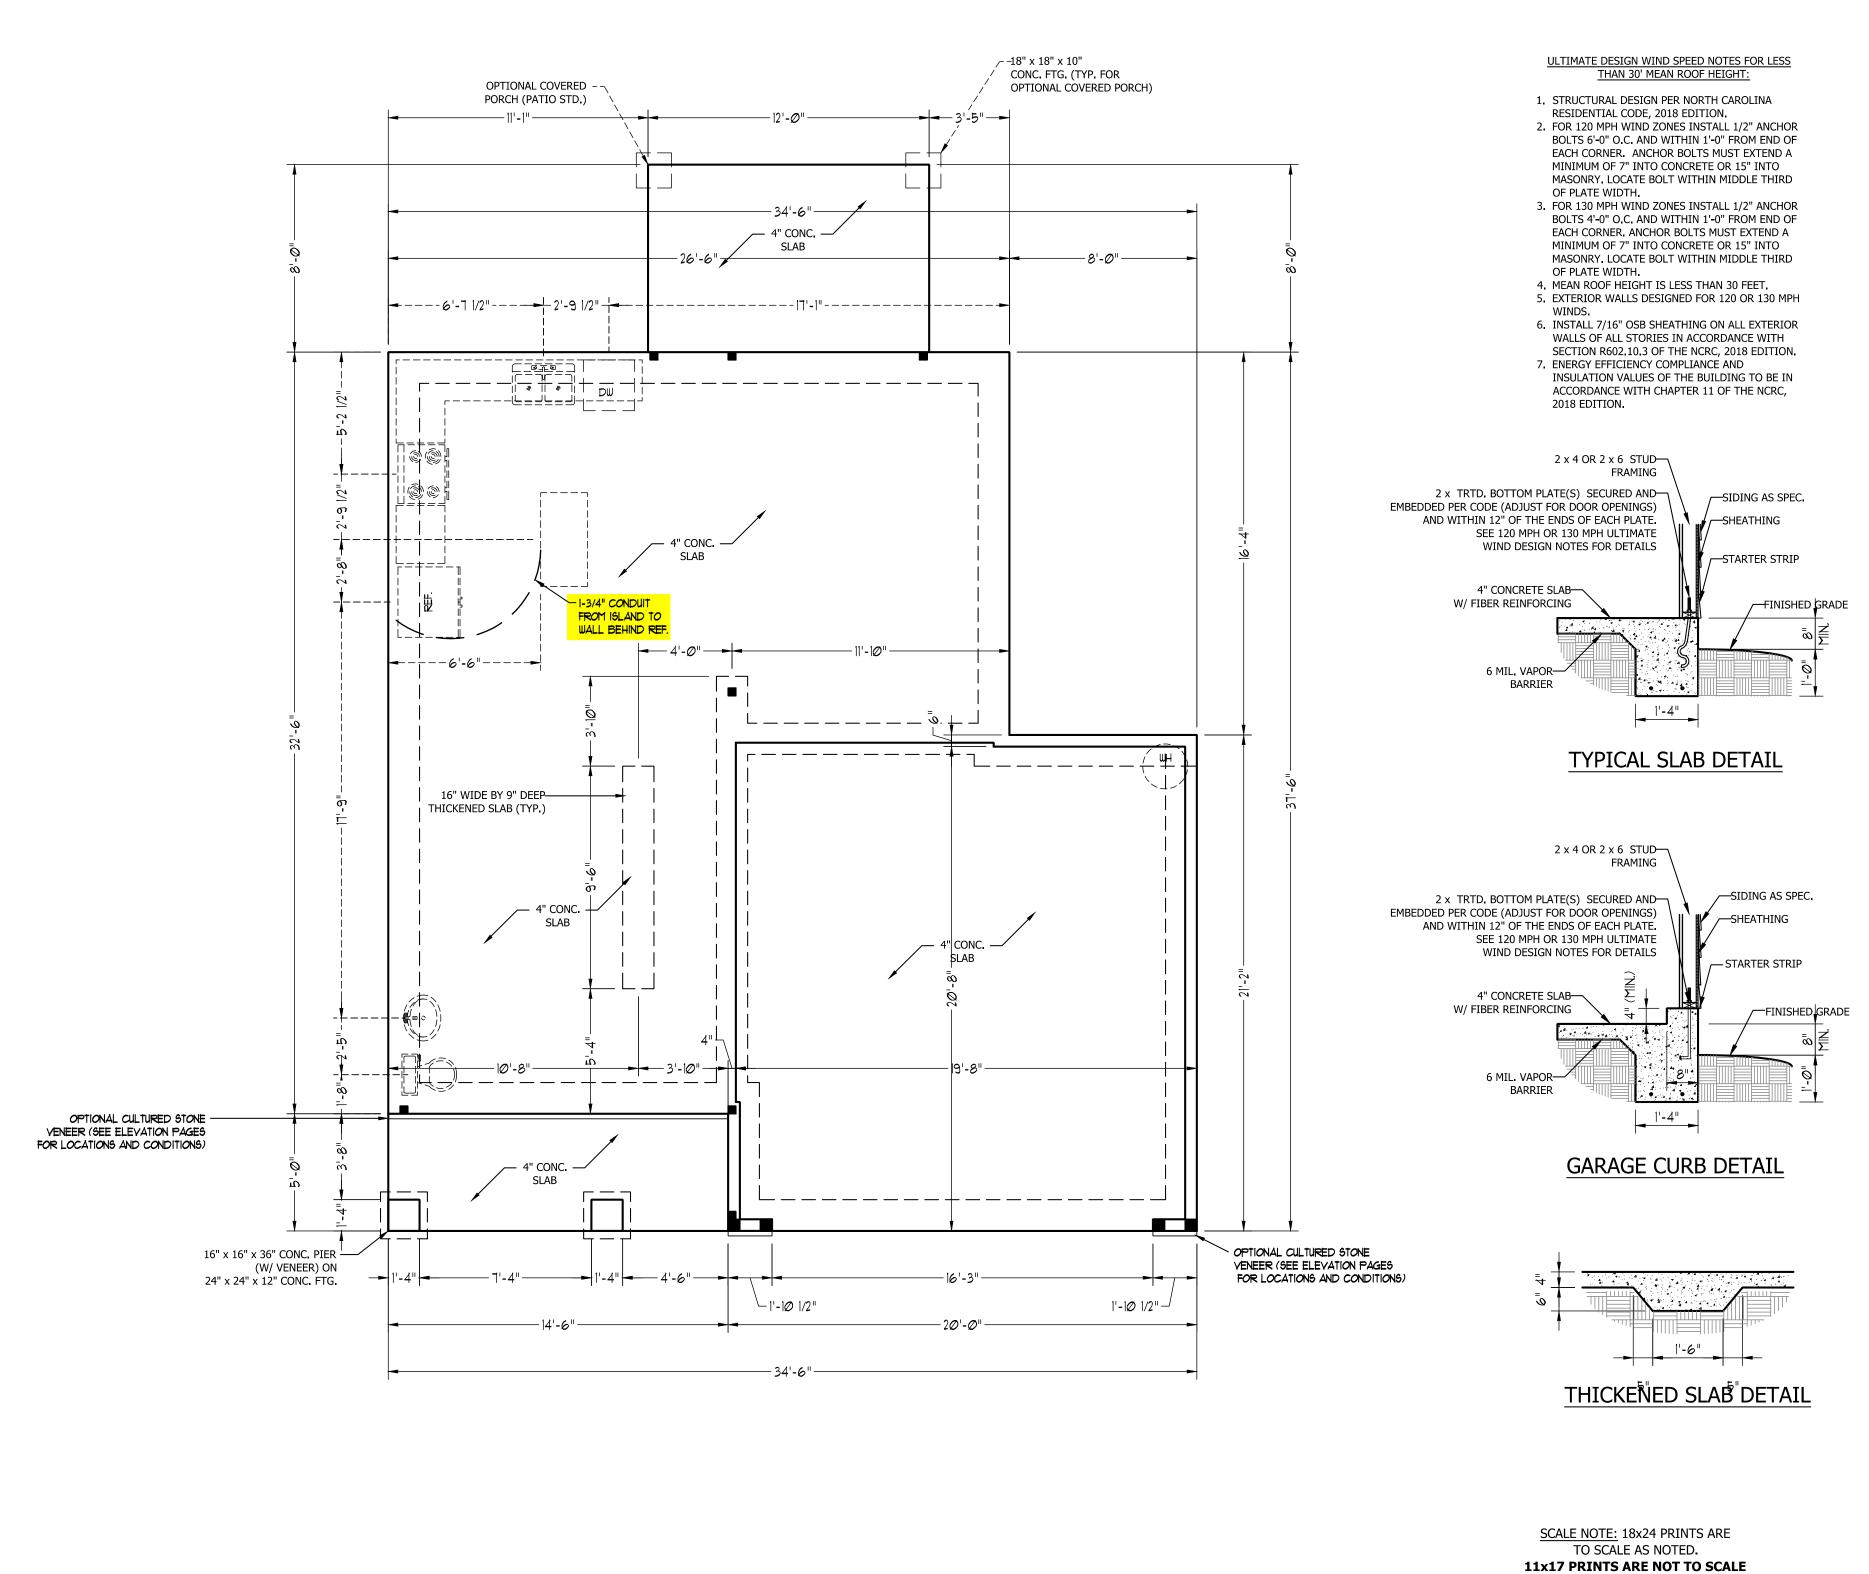
SCALE: 1/4" = 1'-0"

DRAWN BY: WG ENGINEERED BY:

REVIEWED BY:

SECOND FLOOR ELCTRICAL PLAN

E-2



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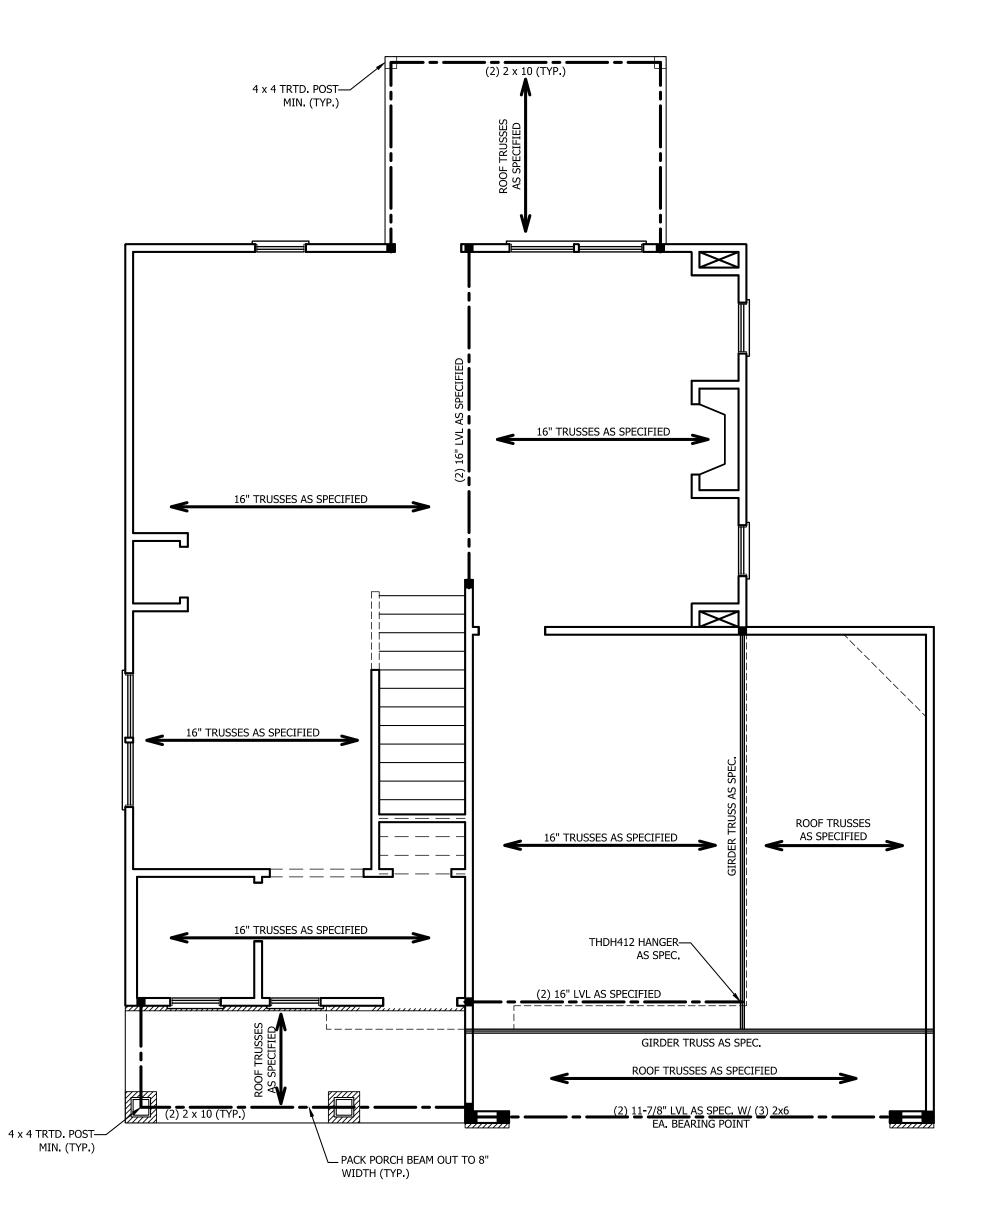
DRAWN BY: WG

ENGINEERED BY: REVIEWED BY:

MONO SLAB FOUNDATION

S-1

PLAN



STRUCTURAL NOTES:

- 1. ALL FRAMING LUMBER TO BE SPF #2 (UNO). ALL TREATED LUMBER TO BE SYP #2
- 2. ALL LOAD BEARING HEADERS TO BE (2) 2 x 4 (UNO).
- 3. INSTALL AN EXTRA JOIST UNDER WALLS PARALLEL TO FLOOR JOISTS
- 4. WINDOW AND DOOR HEADERS TO BE SUPPORTED w/ (1) JACK STUD AND (1) KING STUD EA. END (UNO.). SEE TABLE R602.7.5 FOR ADDITIONAL KING STUD REQUIREMENTS.
- 5. SQUARES DENOTE POINT LOADS WHICH REQUIRE SOLID BLOCKING TO GIRDER OR FOUNDATION. ALL SQUARES TO BE (2) STUDS (UNO.)
- 6. ALL 4 X 4 POSTS SHALL BE ANCHORED TO SLABS W/ SIMPSON ABU44 POST BASES (OR EQUAL) AND 6 X 6 POSTS W/ ABU66 POST BASES (OR EQUAL) (UNO). ALL 4 X 4 AND 6 X 6 POSTS TO BE INSTALLED WITH 700 LB CAPACITY UPLIFT CONNECTORS AT TOP (UNO.)
- 7. FOR FIBERGLASS, ALUMINUM, OR COLUMN ENG. BY OTHERS, SECURE TO SLAB W/ (2) METAL ANGLES USING 2" CONC. SCREWS. FASTEN ANGLES TO COLUMNS W/ 1/4" THROUGH BOLTS W/ NUTS AND WASHERS. LOCATE ANGLES ON OPPOSITE SIDES OF COLUMN. THROUGH BOLTS MUST BE INSTALLED PRIOR TO SETTING COLUMN.

BRACE WALL PANEL NOTES:


EXTERIOR WALLS: ALL EXTERIOR WALLS TO BE SHEALTHED WITH CS-WSP OR CS-SFB IN ACCORDANCE WITH SECTION R602.10.3 UNLESS NOTED OTHERWISE.


REQUIRED LENGTH OF BRACING: REQUIRED BRACE WALL LENGTH FOR EACH SIDE OF THE CIRCUMSCRIBED RECTANGLE ARE INTERPOLATED PER TABLE R602.10.3. METHODS CS-WSP AND CS-SFB CONTRIBUTE THIER ACTUAL LENGTH. METHOD GB CONTRIBUTES 0.5 ITS ACTUAL LENGTH. METHOD PF CONTRIBUTES 1.5 TIMES ITS ACTUAL LENGTH.


GYPSUM: ALL INTERIOR SIDES OF EXTERIOR WALLS AND BOTH SIDES OF INTERIOR WALLS TO HAVE 1/2" GYPSUM INSTALLED. WHEN NOT USING METHOD GB GYPSUM TO BE FASTENED PER TABLE R702.3.5. METHOD GB TO BE FASTENED PER TABLE R602.10.1.

 $\ensuremath{\mathbf{HD:}}$ 800 LBS HOLD DOWN DEVICE FASTENED TO THE EDGE OF THE BRACE WALL PANEL NEAREST TO THE CORNER

METHODS: PER TABLE R602.10.1

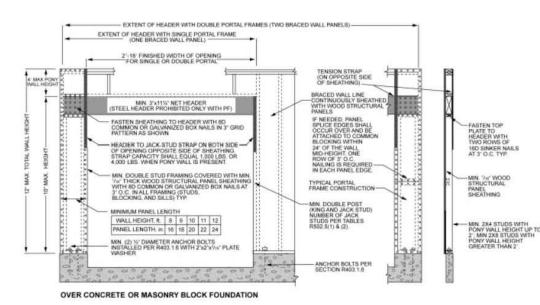

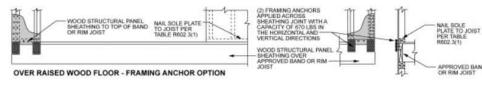

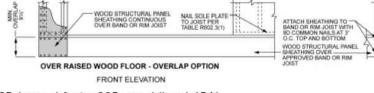

nch = 25.4 mm, 1 foot = 305 mm, 1 lb = 4.45 N.

FIGURE R602.10.1 METHOD PF—PORTAL FRAME CONSTRUCTION

> SCALE NOTE: 18x24 PRINTS ARE TO SCALE AS NOTED. 11x17 PRINTS ARE NOT TO SCALE



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ENGINEERED BY: REVIEWED BY:

SECOND FLOOR FRAMING PLAN

S-2

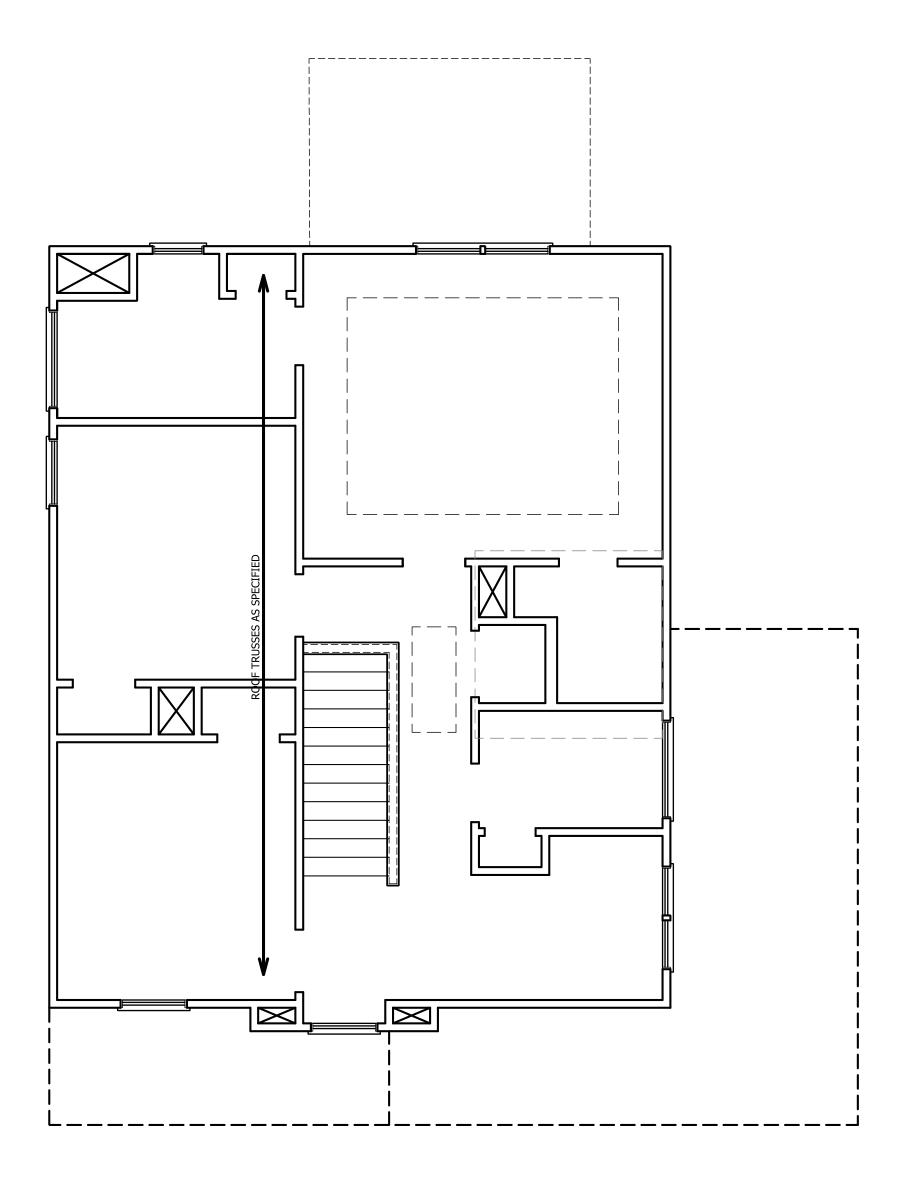



TABLE R602.7.5 MINIMUM NUMBER OF FULL HEIGHT STUDS AT EACH END OF HEADERS IN EXTERIOR WALLS

AT EACH END OF HEADERS IN EXTERIOR WALLS						
HEADER SPAN (FEET)	MAXIMUM STUD SPACING (INCHES) (PER TABLE R602.3(5)					
(. == .)	16	24				
UP TO 3'	1	1				
4'	2	1				
8'	3	2				
12'	5	3				
16'	6	4				

STRUCTURAL NOTES:

- 1. ALL FRAMING LUMBER TO BE SPF #2 (UNO). ALL TREATED LUMBER TO BE SYP #2 (UNO.)
- 2. ALL LOAD BEARING HEADERS TO BE (2) 2 x 6 (UNO).
- 3. WINDOW AND DOOR HEADERS TO BE SUPPORTED w/ (1) JACK STUD AND (1) KING STUD EA. END (UNO.). SEE TABLE R602.7.5 FOR ADDITIONAL KING STUD REQUIREMENTS.
- 4. SQUARES DENOTE POINT LOADS WHICH REQUIRE SOLID BLOCKING TO GIRDER OR FOUNDATION. ALL SQUARES TO BE (2) STUDS (UNO.)

DSP - DOUBLE STUD POCKET TSP - TRIPLE STUD POCKET

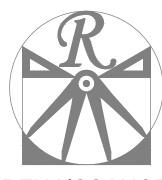

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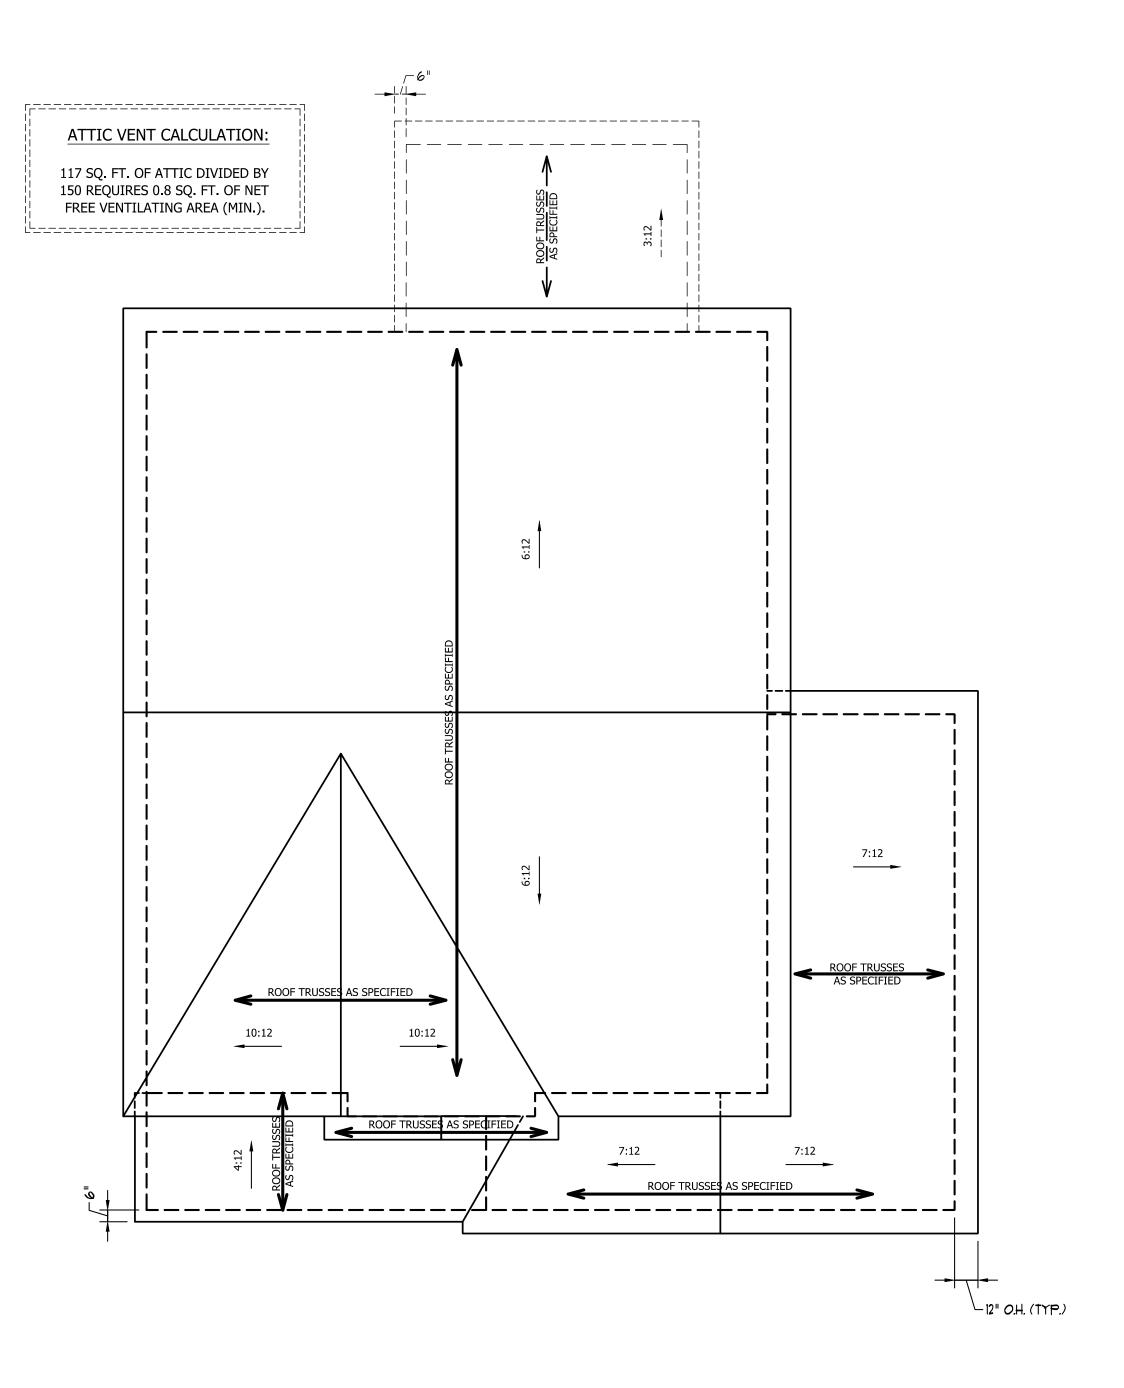
ENGINEERED BY:

REVIEWED BY:

ATTIC FLOOR FRAMING PLAN

S-3

SCALE NOTE: 18x24 PRINTS ARE TO SCALE AS NOTED. 11x17 PRINTS ARE NOT TO SCALE




ATTIC VENT CALCULATION:

1302 SQ. FT. OF ATTIC DIVIDED BY 150 REQUIRES 8.7 SQ. FT. OF NET FREE VENTILATING AREA (MIN.).

STRUCTURAL NOTES:

- 1. ALL FRAMING LUMBER TO BE #2 SPF (UNO).
- 2. HIP SPLICES ARE TO BE SPACED A MIN. OF 8'-0". FASTEN MEMBERS WITH THREE ROWS OF 12d NAILS @ 16" O.C. (TYP.)
- 3. STICK FRAME OVER-FRAMED ROOF SECTIONS W/ 2 x 8 RIDGES, 2 x 6 RAFTERS @ 16" O.C. AND FLAT 2 x 10 VALLEYS OR USE VALLEY TRUSSES.
- 4. FASTEN FLAT VALLEYS TO RAFTERS OR TRUSSES WITH SIMPSON H2.5A HURRICANE TIES @ 32" O.C. MAX. PASS HURRICANE TIES THROUGH NOTCH IN ROOF SHEATHING. EACH RAFTER IS TO BE FASTENED TO THE FLAT VALLEY WITH A MIN. OF (6) 12d TOE NAILS.
- 5. REFER TO SECTION R802.11 OF THE 2018 NCRC FOR REQUIRED UPLIFT RESISTANCE AT RAFTERS AND TRUSSES.

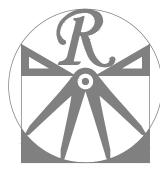

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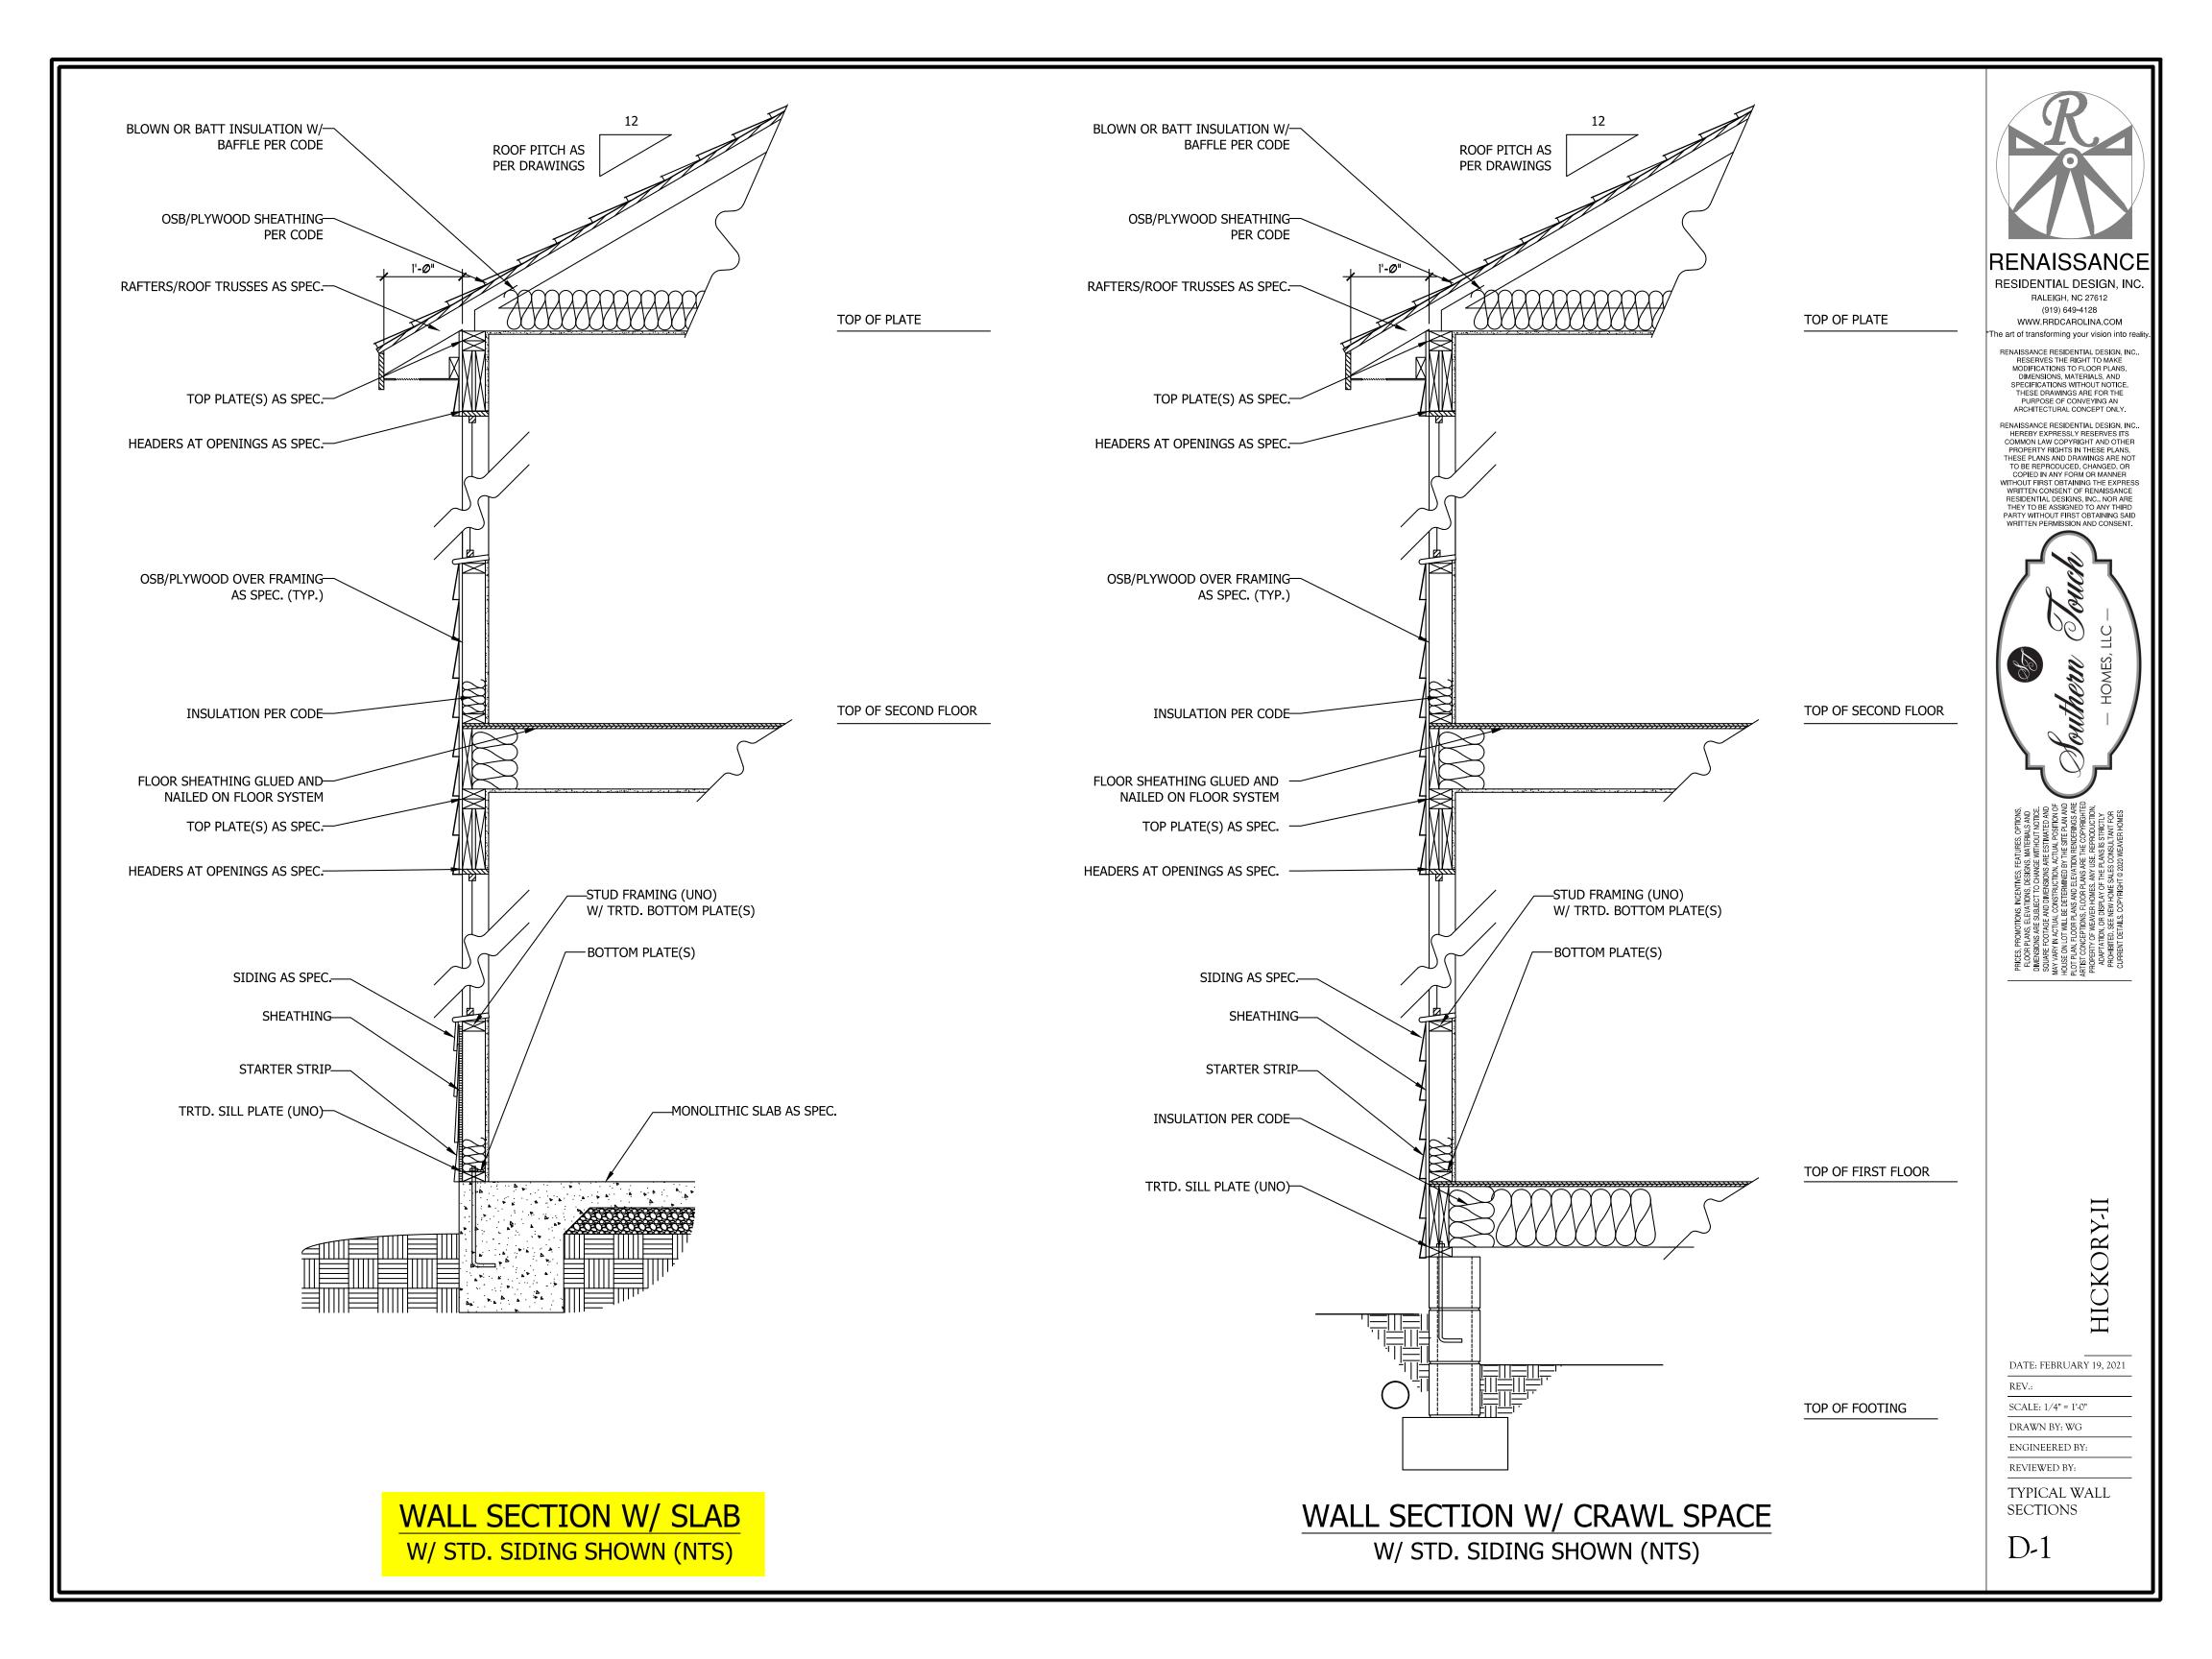
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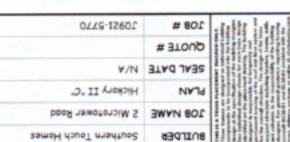
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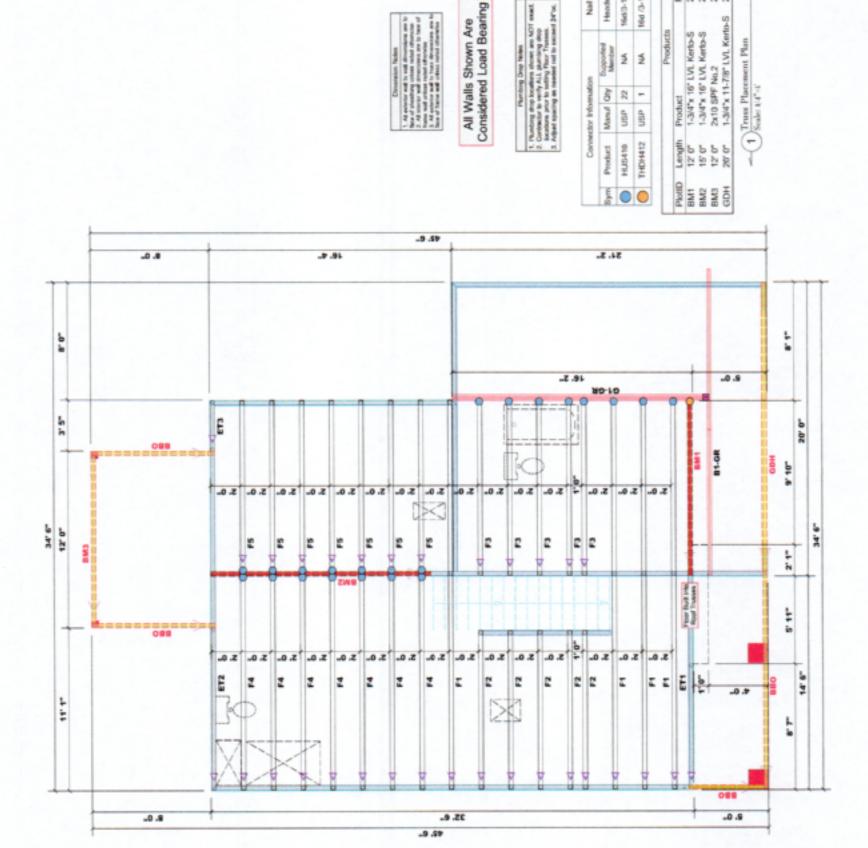
ROOF PLAN

S-4

SCALE NOTE: 18x24 PRINTS ARE TO SCALE AS NOTED. 11x17 PRINTS ARE NOT TO SCALE







SALES REP. Lenny Morris

DRAWN BY V3R STAC

MODEL

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David Landry

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LOAD DHART FOR JACK STUDS


David Landry

ROOF & FLOOR TRUSSES & BEAMS

соттесн

Reilly Road brokustrial Park Fayetteville, N.C. 28309 Phome: (910) 864-8787 Fax: (910) 864-4444

A = Indicates Left End of Truss (Reference Engineered Truss Drawing) Do NOT Erect Truss Bockwards

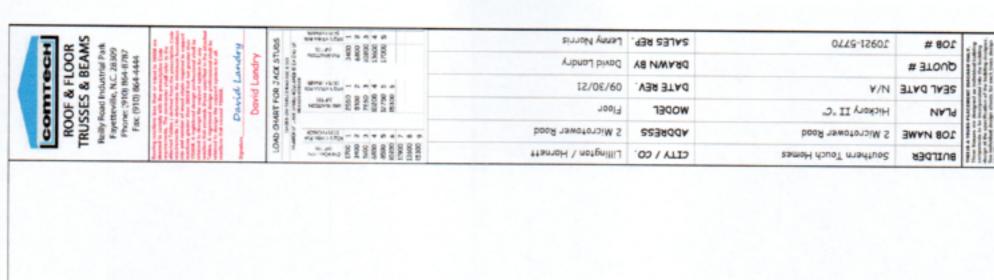

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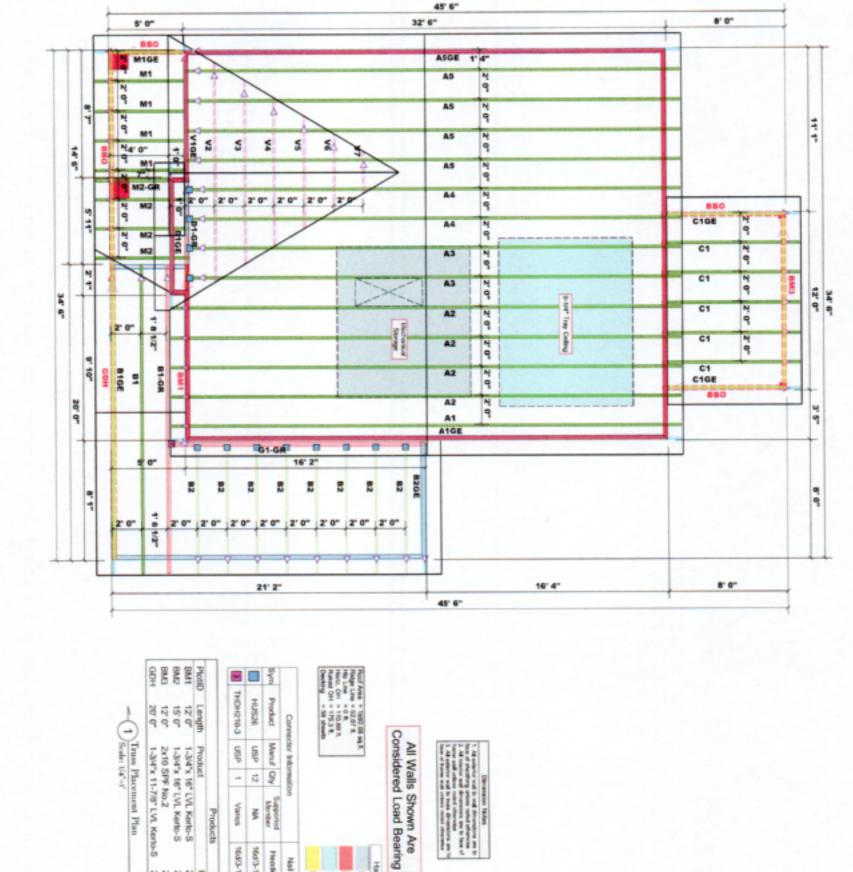
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20.0

34'6"

14.6

A . Indicates Left End of Truss (Reference Engineered Truss Drawing) Do NOT Erect Truss Backwards



Indicates Left End of Truss
 (Reference Engineered Truss Drawing)
 Do NOT Erect Truss Backwards

CITY / CO. Lillington / Harnett BUILDER Southern Touch Homes LOAD CHART FOR JACK STUDS 2 Mircotower Road JOB NAME 2 Microtower Road ADDRESS David Landry MALE CONTRACTOR OF THE CONTRAC MODEL Roof Hickory II "C" PLAN DATE REV. 09/30/21 SEAL DATE N/A DRAWN BY David Landry 17 1000 A 1 1000 A 1000 QUOTE # JOB # J0921-5769 SALES REP. Lenny Norris

Padded HVAC

2nd Floor Wath Tray Cotting


Drop Beam

Nail Information
Header Truss
96d/3-1/2" 16d/3-1/2"

9

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ROOF & FLOOR
TRUSSES & BEAMS
Relly Road Industrial Park
Fayetteville, N.C. 28300
Phone: (910) 864-8787
Fax: (910) 864-4444

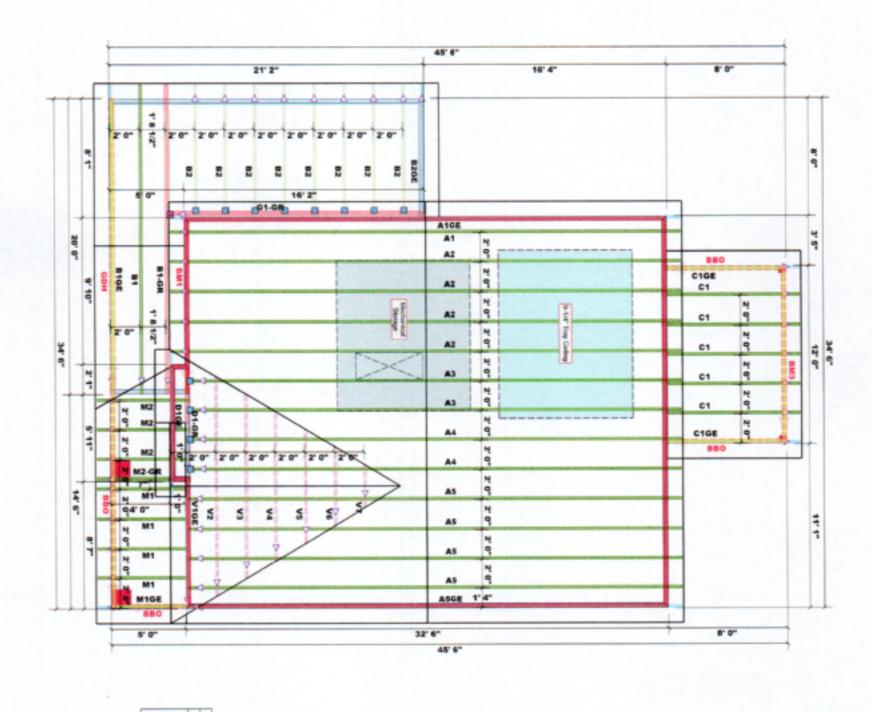

Byrm Product Manuf City ¹

HUS26 USP 12

THIDH210-3 USP 1 PlotiD BM1 BM2 BM3 GDH 15 0° 15 0° 20 0° Truss Placement Plan Product 1-3/4"x 16" LVL Kerto-S 1-3/4"x 16" LVL Kerto-S 2x10 SPF No.2 1-3/4"x 11-7/8" LVL Kerto-S Supported Member NA Varies 1643-12" 1643-12" Header Truss 2 2 2 P Net City 2 2 2 2 FF FF FF FF FF

Employer Wales

1. All orders wall to wall devantations are to focus of threathing unless value differential to the color of threathing unless value differential to All missions and disconnection to the color transport of the color mails of the color transport of the color t

Roof Area = 1682 06 sq.R. Ridge Line = 52.07 ft. Hig. Line = 0.1. Hyu., CH = 115.69 ft. Raked CH = 175.3 ft. Decking = 16 sheets Conne All Walls Shown Are Considered Load Bearing Nail Information Platch Legend
Presided HVAC
2nd Ploor Wate Deop Boarn Tray Celling

(Reference Engineered Truss Drawing)
Do NOT Erect Truss Bookwards

BUILDER	Southern Touch Homes	cITY / co.	Lillington / Harnett	12000 100000 10000 10000 10000 10000 10000 10000 10000 10000 10000 10000 100000 10000 10000 10000 10000 10000 10000 10000 10000 10000 1000	- 1		
JOB NAME	2 Microtower Road	ADDRESS	2 Microtower Road	a a v a a a a v - Kannacha B B			
PLAN	Hickory II "C"	MODEL	Roof	A PART OF THE PART	David La	with the re-stand with the percent percent to a second percent to	(910) (910)
SEAL DATE	N/A	DATE REV.	09/30/21	the car of			N.C.2 9 854-
QUOTE #		DRAWN BY	David Landry	THE SERVICE SERVICE SERVICES	A P		8300 8787
JOB #	J0921-5769	SALES REP.	Lenny Norris	of A w n = High shades 0.	42	10,114	

ROOF & FLOOR TRUSSES & BEAMS



Client:

Southern Touch Homes

Project:

2 Microtower Road

9/30/2021 Date:


Input by: David Landry


Job Name: The Hickory II Plan Project #: J0921-5770

1.750" X 16.000" 2-Ply - PASSED Kerto-S LVL BM1

Address:

Level: Level

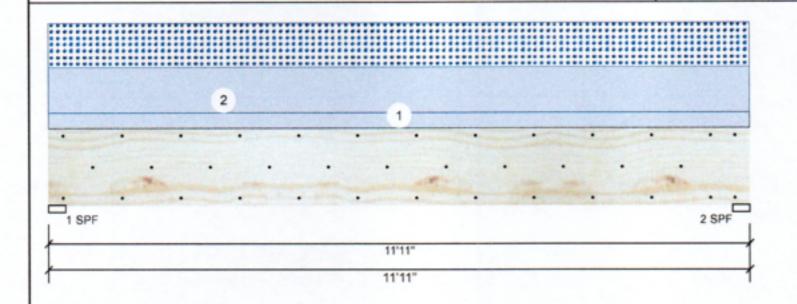

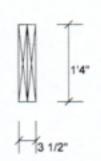

Page 1 of 8

Member Inform	nation
Type:	Girder
Plies: '	2
Moisture Condition:	Dry
Deflection LL:	480
Deflection TL:	360
Importance:	Normal
Temperature:	Temp <= 100°F

Application: Floor Design Method: ASD **Building Code:** Load Sharing: Deck:

Ceiling:

IBC/IRC 2015 Not Checked Gypsum 1/2"

Reaction	ons UNPAT	TERNED IL	(Uplift)		
Brg	Live	Dead	Snow	Wind	Const
1	0	2869	2079	0	0
2	0	2869	2079	0	0

ı	Bearing:	S						
I	Bearing	Length	Cap.	React D/L lb	Total	Ld. Case	Ld. Comb.	
ı	1 - SPF	3.500"	95%	2869 / 2079	4948	L	D+S	
4	2 - SPF	3.500"	95%	2869 / 2079	4948	L	D+S	

Analysis Results

Analysis	Actual	Location	Allowed	Capacity	Comb.	Case
Moment	13679 ft-lb	5'11 1/2"	39750 ft-lb	0.344 (34%)	D+S	L
Unbraced	13679 ft-lb	5'11 1/2"	13695 ft-lb	0.999 (100%)	D+S	L
Shear	3659 lb	1'6 5/8"	13739 lb	0.266 (27%)	D+S	L
LL Defl inch	0.069 (L/2000)	5'11 1/2"	0.287 (L/480)	0.240 (24%)	S	L
TL Defl inch	0.164 (L/840)	5'11 1/2"	0.383 (L/360)	0.430 (43%)	D+S	L

Design Notes

- 1 Fasten all plies using 3 rows of 10d Box nails (.128x3") at 12" o.c. Maximum end distance not to exceed 6".
- 2 Refer to last page of calculations for fasteners required for specified loads.
- 3 Girders are designed to be supported on the bottom edge only.
- 4 Top loads must be supported equally by all plies.
- 5 Top must be laterally braced at a maximum of 8'8 1/4" o.c.
- 6 Lateral slenderness ratio based on single ply width.

I	ID	Load Type	Location	Trib Width	Side	Dead 0.9	Live 1	Snow 1.15	Wind 1.6	Const. 1.25	Comments
I	1	Uniform			Тор	120 PLF	0 PLF	0 PLF	0 PLF	0 PLF	Wall
I	2	Uniform			Тор	349 PLF	0 PLF	349 PLF	0 PLF	0 PLF	A2
ı		Self Weight				12 PLF					

Calculated Structured Designs is responsible only of the structural adequacy of this component based on the design orders and loadings shown. It is the responsibility of the oustomer and/or the contractor to ensure the component suitability of the intended application, and to verify the dimensions and loads.

Lumber

Dry service conditions, unless noted otherwise
 LVL not to be treated with fire retardant or corrosive

LVL beams must not be cut or drilled. Refer to manufacturer's product information regarding installation requirements, multi-ply fastening details, beam strength values, and code

3. Damaged Beams must not be used
4. Design assumes top edge is laterally restrained
5. Provide lateral support at bearing points to avoid lateral displacement and rotation

6. For fat roofs provide proper drainage to prevent

This design is valid until 4/24/2023

Manufacturer Info Metsa Wood

301 Merritt 7 Building, 2nd Floor Norwalk, CT 06851 (800) 622-5850 www.metsawood.com/us ICC-ES: ESR-3633

Comtech, Inc. 1001 S. Reilly Road, Suite #639 28314 910-864-TRUS





Client: Project:

Address:

Southern Touch Homes

2 Microtower Road

Date:

9/30/2021


David Landry Input by:


Job Name: The Hickory II Plan Project #: J0921-5770

Kerto-S LVL BM1

1.750" X 16.000" 2-Ply - PASSED

Level: Level

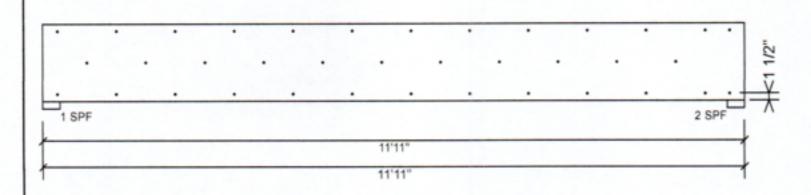

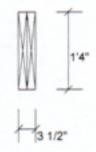

Page 2 of 8

Multi-Ply Analysis

Fasten all plies using 3 rows of 10d Box nails (.128x3") at 12" o.c.. Maximum end distance not to exceed 6"

Capacity Load	0.0 %	
Load	0.0 PLF	
Yield Limit per Foot	245.6 PLF	
Yield Limit per Fastener	81.9 lb.	
Yield Mode	IV	
Edge Distance	1 1/2"	
Min, End Distance	3"	
Load Combination		
Duration Factor	1.00	

Calculated Structured Designs is responsible only of the structural adequacy of this component based on the design criteria and loadings shown. It is the responsibility of the oustomer and/or the contractor to ensure the component suitability of the intended application, and to verify the dimensions and loads.

Handling & Installation

1. LVL beams must not be out or 2. Refer to manufacturer's regarding installation not fautening details, beam ster approvals

Lumber

Dry service conditions, unless noted otherwise
 LVL not to be treated with fire retardant or corresive

chemicals

- LVI, beams must not be out or drilled
 Refer to manufacturer's product information negarding installation neguinements, multi-ply feathering details, beam strength values, and code approvals.
- 3. Damaged Beams must not be used
- Design assumes top edge is laterally restrained
 Provide lateral support at bearing points to avoid lateral displacement and rotation

6. For flat roofs provide proper drainage to prevent

This design is valid until 4/24/2023

Manufacturer Info Metsä Wood

301 Merritt 7 Building, 2nd Floor Norwalk, CT 06851 (800) 622-5850 www.metsawood.com/us ICC-ES: ESR-3633

Comtech, Inc. 1001 S. Reilly Road, Suite #639 Fayetteville, NC USA 28314 910-864-TRUS





Client: Project:

Address:

Southern Touch Homes

2 Microtower Road


9/30/2021 Date:

David Landry Input by:

Job Name: The Hickory II Plan Project #: J0921-5770

1.750" X 16.000" 2-Ply - PASSED BM2 Kerto-S LVL

Level: Level

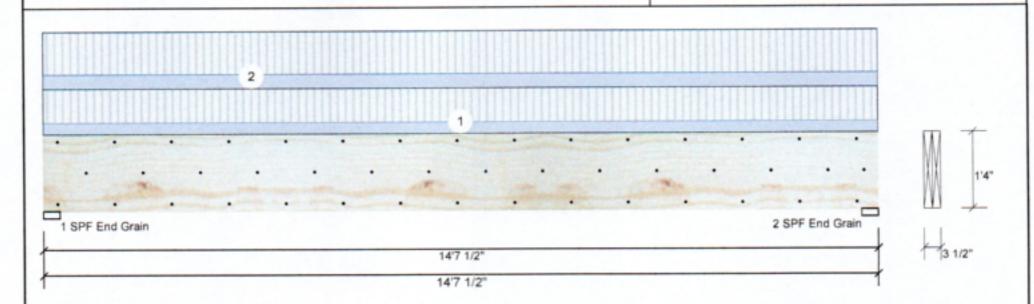

Member Inforn	nation			Reaction	Reactions UNPATTERNED lb (Uplift)						
Type:	Girder	Application:	Floor	Brg	Live	Dead	Snow	1	Wind	Const	
Plies:	2	Design Method:	ASD	1	3868	1385	0		0	0	
Moisture Condition:	Dry	Building Code:	IBC/IRC 2015	2	3868	1385	0		0	0	
Deflection LL:	480	Load Sharing:	No								
Deflection TL:	360	Deck:	Not Checked								
Importance:	Normal	Ceiling:	Gypsum 1/2"								
Temperature:	Temp <= 100°F										
				Bearings							
				Bearing	Length	Cap. Rea	ct D/L lb	Total	Ld. Case	Ld. Comb.	
				4 005	3 500"	400/ 120	05/2060	5254		D+I	

Grain

Analysis Results

Analysis	Actual	Location	Allowed	Capacity	Comb.	Case
Analysis	Actual	Location	Allowed	Capacity	COITID.	Case
Moment	18077 ft-lb	7'3 3/4"	34565 ft-lb	0.523 (52%)	D+L	L
Unbraced	18077 ft-lb	7'3 3/4"	18150 ft-lb	0.996 (100%)	D+L	L
Shear	5080 lb	13" 7/8"	11947 lb	0.425 (43%)	D+L	L
LL Defl inch	0.229 (L/743)	7'3 13/16"	0.355 (L/480)	0.650 (65%)	L	L
TL Defl inch	0.311 (L/547)	7'3 13/16"	0.473 (L/360)	0.660 (66%)	D+L	L

Design Notes

- 1 Fasten all plies using 3 rows of 10d Box nails (.128x3") at 12" o.c. Maximum end distance not to exceed 6".
- 2 Refer to last page of calculations for fasteners required for specified loads.
- 5 Lateral slenderness ratio based on single ply width.

Bearing:	S						
Bearing	Length	Cap.	React D/L lb	Total	Ld. Case	Ld. Comb.	
1 - SPF End Grain	3.500"	49%	1385 / 3868	5254	L	D+L	
2 - SPF End	3.500"	49%	1385 / 3868	5254	L	D+L	

3 Girders are designed to be supported on the bottom edge only. 4 Top must be laterally braced at a maximum of 6'4 1/2" o.c.

		<u> </u>									
ID	Load Type	Location	Trib Width	Side	Dead 0.9	Live 1	Snow 1.15	Wind 1.6	Const. 1.25	Comments	
1	Uniform			Near Face	79 PLF	235 PLF	0 PLF	0 PLF	0 PLF	F5	
2	Uniform			Far Face	98 PLF	294 PLF	0 PLF	0 PLF	0 PLF	F4	
	Self Weight				12 PLF						

Notes

Calculated Structured Designs is responsible only of the structural adequacy of this component based on the design oriticia and loadings shown, it is the responsibility of the customer and/or the comtractor to ensure the component suitability of the intended application, and to verify the dimensions and loads.

Lumber

Dry service conditions, unless noted otherwise
 LVL not to be treated with fire retardant or corrosive

Handling & Installation

LVL beams must not be cut or drilled
 Refer to manufacturer's product information regarding installation requirements, multi-ply fastening details, beam strength values, and code

approvime

3. Damaged Beams must not be used

4. Design assumes top edge is laterally restrained

5. Provide lateral support at bearing points to avoid
lateral displacement and retation

6. For flat roofs provide proper drainage to prevent

This design is valid until 4/24/2023

Metsä Wood 301 Merritt 7 Building, 2nd Floor Norwalk, CT 06851 (800) 622-5850 www.metsawood.com/us ICC-ES: ESR-3633

Manufacturer Info

Comtech, Inc. 1001 S. Reilly Road, Suite #639 Fayetteville, NC USA 28314 910-864-TRUS



Page 3 of 8



Client:

Southern Touch Homes

Project: Address:

2 Microtower Road

Date:

9/30/2021

Page 4 of 8


Input by: David Landry

Job Name: The Hickory II Plan

J0921-5770 Project #: Level: Level

Kerto-S LVL

1.750" X 16.000" 2-Ply - PASSED

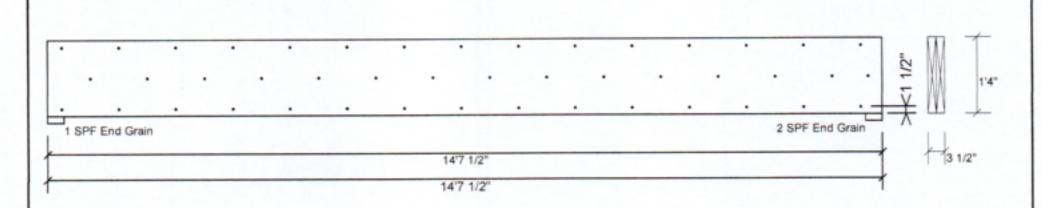

Multi-Ply Analysis

Fasten all plies using 3 rows of 10d Box nails (.128x3") at 12" o.c.. Maximum end distance not to exceed 6"

Capacity	79.8 %	
Load	196.0 PLF	
Yield Limit per Foot	245,6 PLF	
Yield Limit per Fastener	81,9 lb.	
Yield Mode	IV	
Edge Distance	1 1/2"	
Min, End Distance	3"	
Load Combination	D+L	
Duration Factor	1.00	

Calculated Structured Designs is responsible only of the structural adequacy of this component based on the design criteria and leadings shown, it is the responsibility of the customer and/or the contractor to ensure the component suitability of the intended application, and to verify the dimensions and leads.

Lumber

Dry service conditions, unless noted otherwise
 LVL not to be treated with fire retardant or corrosive

Handling & Installation

- LVL beams must not be cut or drilled
 Refer to manufacturer's product information regarding installation requirements, multi-ply fastening details, beam strength values, and code
- approvals
 3. Damaged Beams must not be used
 4. Design assumes top edge is laterally restrained
 5. Provide lateral support at bearing points to avoid lateral displacement and rotation

6. For flat roofs provide proper drainage to prevent

This design is valid until 4/24/2023

Manufacturer Info

Metsä Wood 301 Merritt 7 Building, 2nd Floor Norwalk, CT 06851 (800) 622-5850 www.metsawood.com/us ICC-ES: ESR-3633

Comtech, Inc. 1001 S. Reilly Road, Suite #539 Fayetteville, NC USA 28314 910-864-TRUS



Page 5 of 8 9/30/2021 Date: Client: Southern Touch Homes David Landry Input by: Project: isDesign Job Name: The Hickory II Plan Address: 2 Microtower Road Project #: J0921-5770 Level: Level 2.000" X 10.000" 2-Ply - PASSED BM₃ S-P-F #2 1 2 SPF End Grain 1 SPF End Grain 12 12' Reactions UNPATTERNED lb (Uplift) Member Information Brg Snow Wind Const Live Dead Girder Floor Type: Application: Design Method: 0 0 2 ASD 0 564 564 Plies: 1 Moisture Condition: Dry **Building Code:** IBC/IRC 2015 564 564 0 0 2 0 Load Sharing: No Deflection LL: 480 Not Checked 360 Deflection TL: Deck: Gypsum 1/2" Importance: Normal Ceiling: Temp <= 100°F Temperature: Bearings Bearing Length Ld. Comb. Cap. React D/L lb Total Ld. Case 1128 L D+S 1 - SPF 3.500" 25% 564 / 564 End Grain Analysis Results 2 - SPF 3.500" 564 / 564 1128 L D+S 25% Location Allowed Comb. Case Analysis Actual Capacity End 3130 ft-lb 6' 3946 ft-lb 0.793 (79%) D+S L Moment Grain 1.000 D+S 3130 ft-lb 6' 3132 ft-lb Unbraced (100%)940 lb 11' 2872 lb 0.327 (33%) D+S Shear LL Defl inch 0.135 (L/1022) 6° 0.289 (L/480) 0.470 (47%) S 6' 0.385 (L/360) 0.700 (70%) D+S TL Defl inch 0.271 (L/511) Design Notes 1 Fasten all plies using 2 rows of 10d Box nails (.128x3") at 12" o.c. Maximum end distance not to exceed 6". 2 Refer to last page of calculations for fasteners required for specified loads. 3 Girders are designed to be supported on the bottom edge only. 4 Top loads must be supported equally by all plies. 5 Top must be laterally braced at a maximum of 8'8 5/8" o.c. 6 Lateral slenderness ratio based on single ply width. Comments Wind 1.6 Const. 1.25 Dead 0.9 Live 1 Snow 1.15 Location Trib Width Side ID Load Type 0 PLF C1 0 PLF 0 PLF Uniform Top 94 PLF 94 PLF Manufacturer Info Comtech, Inc. 1001 S. Reilly Road, Suite #539 Fayetteville, NC USA 28314 910-864-TRUS COMTECH

This design is valid until 4/24/2023

Page 6 of 8 9/30/2021 Client: Southern Touch Homes Date: Input by: David Landry Project: isDesign Job Name: The Hickory II Plan Address: 2 Microtower Road J0921-5770 Project #: Level: Level S-P-F #2 2.000" X 10.000" 2-Ply - PASSED BM₃ 2 SPF End Grain 1 SPF End Grain 12' **Multi-Ply Analysis** Fasten all plies using 2 rows of 10d Box nails (.128x3") at 12" o.c.. Maximum end distance not to exceed 6" 0.0 % Capacity 0.0 PLF Load 157.4 PLF Yield Limit per Foot Yield Limit per Fastener 78.7 lb. Yield Mode IV Edge Distance 1 1/2" Min. End Distance Load Combination Duration Factor 1.00 Comtech, Inc. 1001 S. Reilly Road, Suite #539 Fayetteville, NC USA 28314 910-854-TRUS Manufacturer Info

This design is valid until 4/24/2023

COMTECH



Client: Project:

Address:

Southern Touch Homes

2 Microtower Road

Date:


9/30/2021

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David Landry Input by: Job Name: The Hickory II Plan

Project #: J0921-5770

GDH Kerto-S LVL 1.750" X 11.875" 2-Ply - PASSED Level: Level

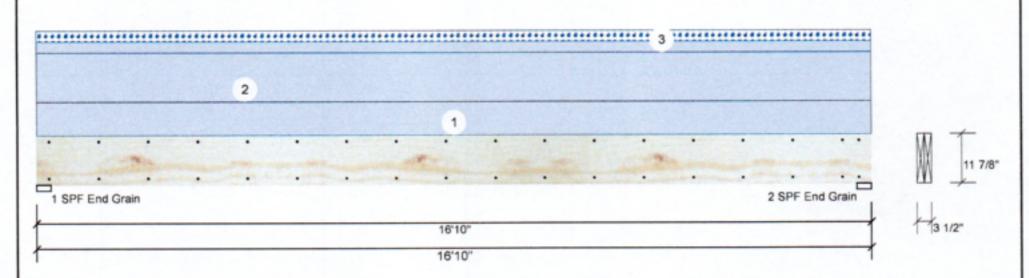

Member Information					Reactions UNPATTERNED Ib (Uplift)						
Type:	Girder	Application:	Floor	Brg	Live	Dead	Snow	Wi	nd	Const	
Plies:	2	Design Method:	ASD	1	0	1509	168		0	0	
Moisture Condition:	Dry	Building Code:	IBC/IRC 2015	2	0	1509	168		0	0	
Deflection LL:	480	Load Sharing:	No								
Deflection TL:	360	Deck:	Not Checked								
Importance:	Normal	Ceiling:	Gypsum 1/2"								
Temperature:	Temp <= 100°F										
				Bearings							
				Bearing	Length	Cap. F	React D/L lb	Total L	d. Case	Ld. Comb.	
				1 - SPF End	3.500"	16%	1509 / 168	1677 L		D+S	
Analysis Result	s			Grain			4500 / 400			0.0	

Case

Uniform

2 - SPF 3.500"

End

Grain

Analysis	Actual	Location	Allowed	Capacity	Comb.	
Moment	6008 ft-lb	8'5"	17919 ft-lb	0.335 (34%)	D	
Unbraced	6678 ft-lb	8'5"	6683 ft-lb	0.999 (100%)	D+S	
	Moment	Moment 6008 ft-lb	Moment 6008 ft-lb 8'5"	Moment 6008 ft-lb 8'5" 17919 ft-lb	Moment 6008 ft-lb 8'5" 17919 ft-lb 0.335 (34%) Unbraced 6678 ft-lb 8'5" 6683 ft-lb 0.999	Moment 6008 ft-lb 8'5" 17919 ft-lb 0.335 (34%) D Unbraced 6678 ft-lb 8'5" 6683 ft-lb 0.999 D+S

Uniform 1290 lb 1'2 5/8" 7980 lb 0.162 (16%) D Shear 8'5 1/16" 0.409 (L/480) 0.090 (9%) S LL Defl inch 0.035 (L/5617) 8'5 1/16" 0.546 (L/360) 0.640 (64%) D+S TL Defl inch 0.348 (L/564)

Design Notes

- 1 Fasten all plies using 2 rows of 10d Box nails (.128x3") at 12" o.c. Maximum end distance not to exceed 6".
- 2 Refer to last page of calculations for fasteners required for specified loads.
- 3 Girders are designed to be supported on the bottom edge only.
- 4 Top loads must be supported equally by all plies.
- 5 Top must be laterally braced at a maximum of 14'10 1/2" o.c.
- 6 Lateral slenderness ratio based on single ply width.

	O Lateral aren	delliege lane pages of	it airigie prij mairi.									
ı	ID	Load Type	Location	Trib Width	Side	Dead 0.9	Live 1	Snow 1.15	Wind 1.6	Const. 1.25	Comments	
١	1	Uniform			Тор	60 PLF	0 PLF	0 PLF	0 PLF	0 PLF	Wall	
	2	Uniform			Тор	90 PLF	0 PLF	0 PLF	0 PLF	0 PLF	B1GE	
	3	Tie-In	0-0-0 to 16-10-0	1-0-0	Top	20 PSF	0 PSF	20 PSF	0 PSF	0 PSF	Roof Load	
		Calf Majort				Q PI F						

Notes

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Lumber

Dry service conditions, unless noted otherwise
 LWL not to be treated with fire retardant or corrosive

Handling & Installation

- LVI, beams must not be cut or drilled.

 Refer to manufacturer's product information regarding installation requirements, multi-ply fastening details, beam strength values, and code appropriate.
- 3. Damaged Beams must not be used
- Design assumes top edge is laterally restrained. Provide lateral support at bearing points to avoid lateral displacement and rotation.

6. For flat roofs provide proper drainage to prevent

This design is valid until 4/24/2023

Metsä Wood 301 Merritt 7 Building, 2nd Floor Norwalk, CT 06851 (800) 622-5850 www.metsawood.com/us.

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1677 L

ICC-ES: ESR-3633

Manufacturer Info

Comtech, Inc. 1001 S. Reilly Road, Suite #639 Fayetteville, NC USA 28314 910-864-TRUS



D+S



Client: Project:

Address:

Southern Touch Homes

2 Microtower Road

Date:


9/30/2021

Page 8 of 8

Input by: David Landry Job Name: The Hickory II Plan

J0921-5770

Kerto-S LVL 1.750" X 11.875" 2-Ply - PASSED Level: Level

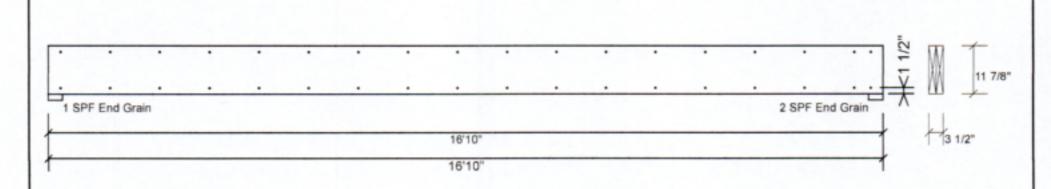

Multi-Ply Analysis

Fasten all plies using 2 rows of 10d Box nails (.128x3") at 12" o.c.. Maximum end distance not to exceed 6"

Capacity	0.0 %
Load	0.0 PLF
Yield Limit per Foot	163.7 PLF
Yield Limit per Fastener	81,9 lb,
Yield Mode	IV
Edge Distance	1 1/2"
Min, End Distance	3"
Load Combination	
Duration Factor	1.00

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Lumber

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Handling & Installation

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