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DATE: FEBRUARY 19, 2021

REV.:

SCALE: 1/4" = 1'-0" DRAWN BY: WG

ENGINEERED BY: REVIEWED BY:

C - ELEVATIONS

A-3

SCALE NOTE: 18x24 PRINTS ARE

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**IAGNOLIA-II DRIVE LEFT** 

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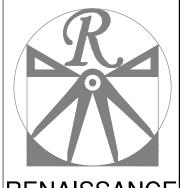
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REVIEWED BY:

FIRST FLOOR PLAN

A-4

SCALE NOTE: 18x24 PRINTS ARE
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MAGNOLIA-II DRIVE LEFT

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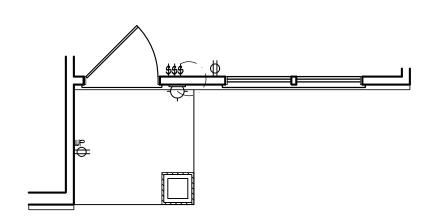
SECOND FLOOR PLAN

A-5


SCALE NOTE: 18x24 PRINTS ARE TO SCALE AS NOTED.

11x17 PRINTS ARE NOT TO SCALE





FRONT PORCH AND DINING ROOM WINDOW ELEVATION B

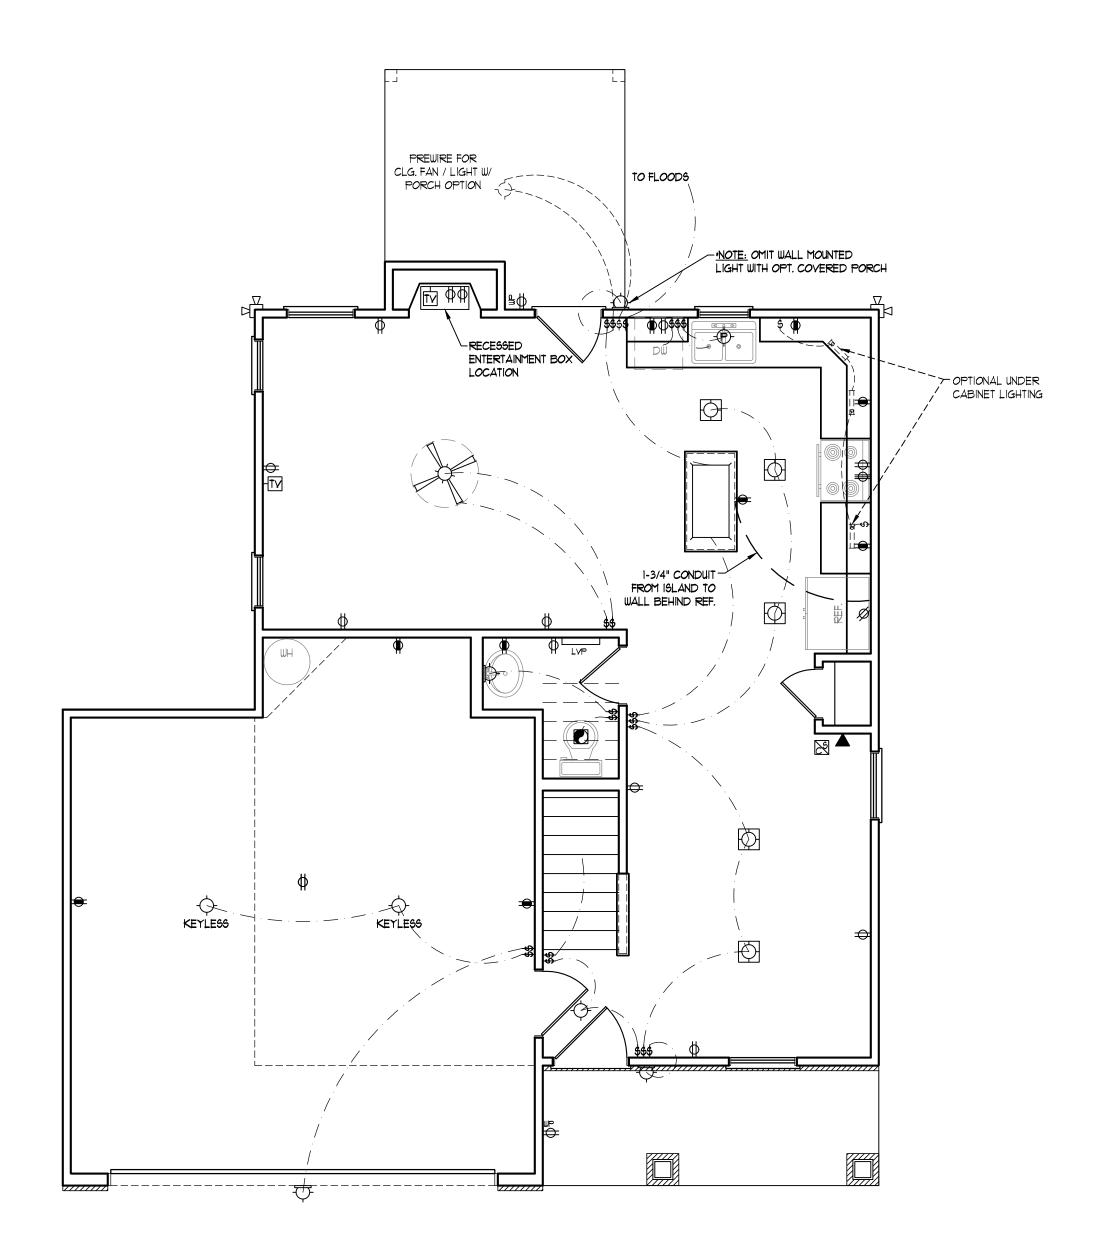

### ELECTRICAL LAYOUT NOTES:

- 1.) BLOCK AND WIRE FOR ALL CELING FANS PER PLAN.
- 2.) VANITY LIGHTS TO BE SET 9 90" AFF. (TYP.)
- 3.) ADDITIONAL EXTERIOR OUTLETS REQUIRED BY CODE TO BE LOCATED BY ELECTRICIAN.
- 4.) PLACE SWITCHES 8" (MIN.) FROM ROUGH OPENINGS.

### ELECTRICAL LEGEND

- ⇒ IIØ Y OUTLET
- € 110 Y GFI OUTLET
- = 110 V SWITCHED OUTLET
- BB IIØ Y BASEBOARD OUTLET
- 4-PLEX
- COUNTER OR FLOOR MOUNTED
- COUNTER OR FLOOR MOUNTED 110V GFI
- ₩EATHERPROOF
- **⇒** 220 ∨ OUTLET
- 10 V DEDICATED CIRCUIT
- # 220 Y DEDICATED CIRCUIT
- PH SPECIAL PURPOSE (240 V, ETC.)
- WALL MOUNT LIGHT
- ---- CEILING MOUNT LIGHT
- -P- PENDANT LIGHT
- RECESSED CAN LIGHT
- MINI CAN LIGHT
- EYEBALL LIGHT

FLUORESCENT LIGHT

undercabinet light

FLOOD LIGHT

SWITCH

DIMMER SWITCH

▲ TELEPHONE

△ DATA

TELEPHONE AND DATA

TY- TY CONNECTION

TV/ DATA

CD- CONDUIT FOR COMPONENT WIRING

SPEAKER

110 V SMOKE/ CM DETECTOR


SD 110 Y SMOKE DETECTOR

EXHAUST FAN

LOW VOLTAGE PANEL ALARM PANEL



SCALE NOTE: 18x24 PRINTS ARE TO SCALE AS NOTED. 11x17 PRINTS ARE NOT TO SCALE

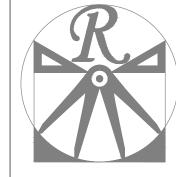

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DATE: FEBRUARY 19, 2021

SCALE: 1/4" = 1'-0"

DRAWN BY: WG

ENGINEERED BY:

FIRST FLOOR ELECTRICAL PLAN

REVIEWED BY:

E-1

### ELECTRICAL LAYOUT NOTES:

- 1.) BLOCK AND WIRE FOR ALL CELING FANS PER PLAN.
- 2.) VANITY LIGHTS TO BE SET @ 90" A.F.F. (TYP.)
- 3.) ADDITIONAL EXTERIOR OUTLETS REQUIRED BY CODE TO BE LOCATED BY ELECTRICIAN.
- 4.) PLACE SWITCHES 8" (MIN.) FROM ROUGH OPENINGS.

### ELECTRICAL LEGEND

- ⇒ IIØ Y OUTLET
- ₩ IIØ Y GFI OUTLET
- → 110 V SWITCHED OUTLET
- BB IIØ V BASEBOARD OUTLET
- 4-PLEX
- COUNTER OR FLOOR MOUNTED
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- **⇒** 22Ø ∨ OUTLET
- 10 V DEDICATED CIRCUIT
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- MINI CAN LIGHT
- EYEBALL LIGHT

FLUORESCENT LIGHT undercabinet light

FLOOD LIGHT

SWITCH

\$D DIMMER SWITCH

▲ TELEPHONE

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TELEPHONE AND DATA

TY- TY CONNECTION

TV/ DATA

CD- CONDUIT FOR COMPONENT WIRING

SP SPEAKER

IIØ Y SMOKE/ CO DETECTOR

6D 110 Y SMOKE DETECTOR

EXHAUST FAN




ALARM PANEL





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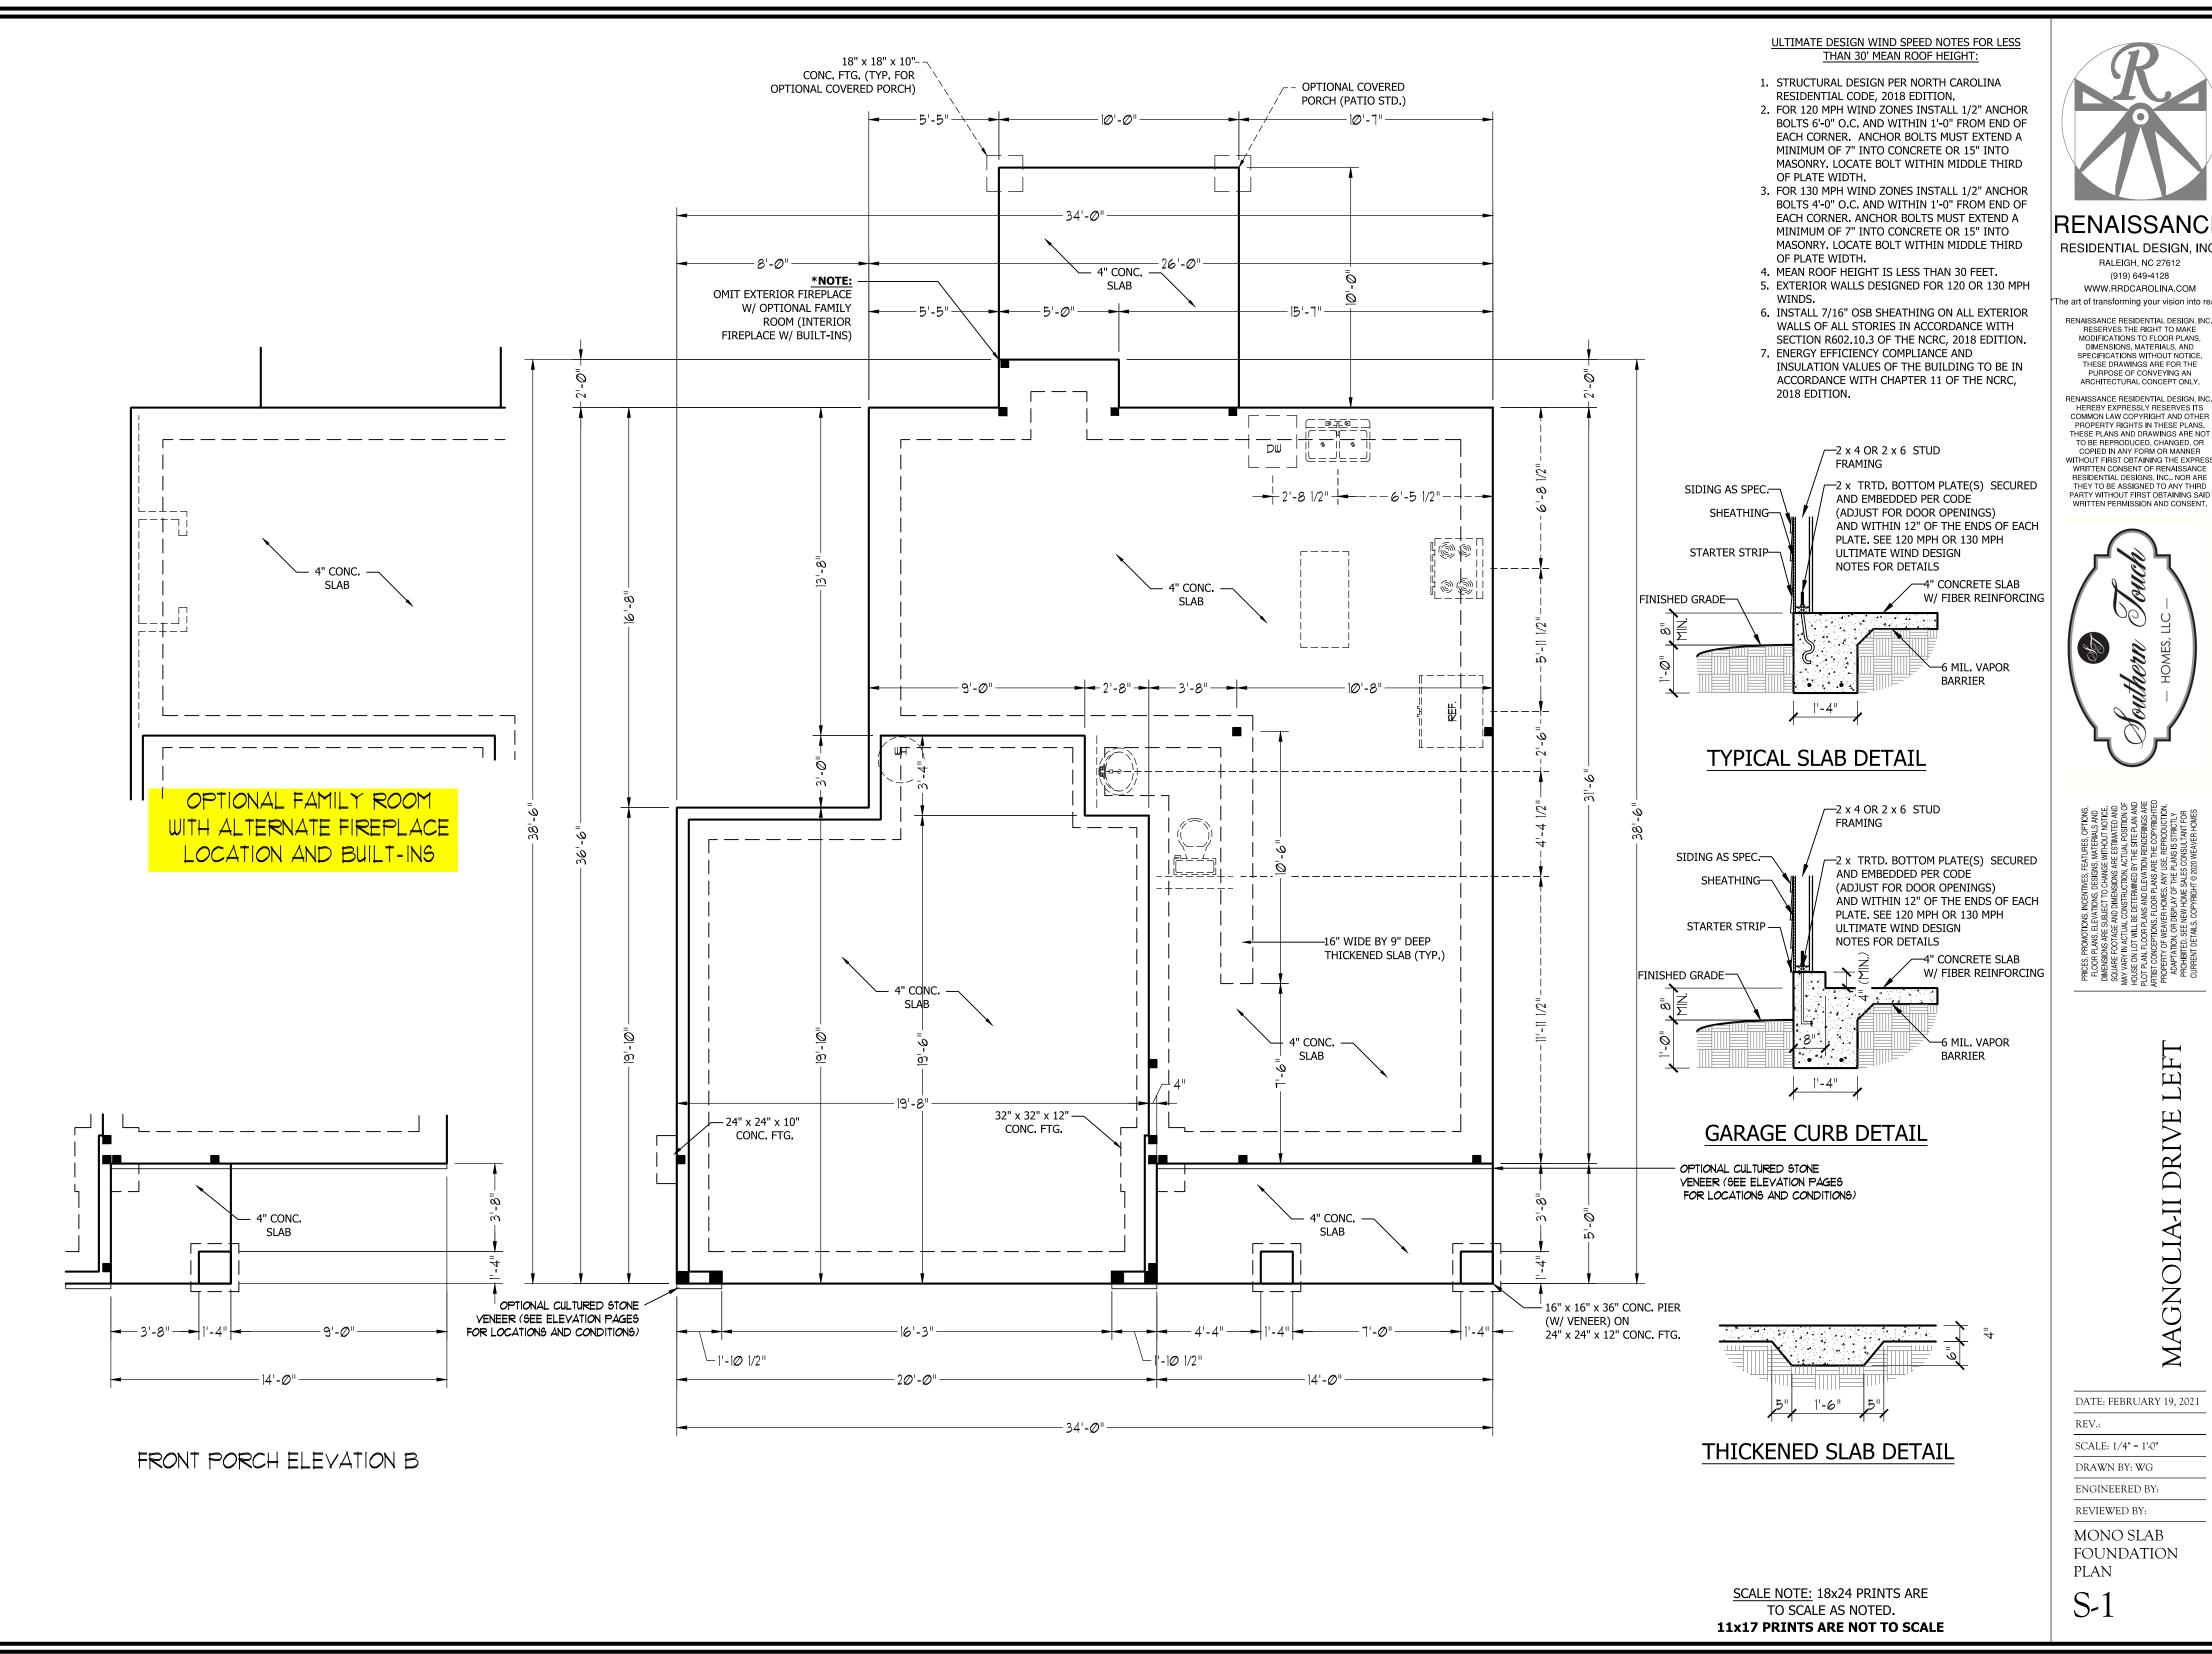
SCALE: 1/4" = 1'-0" DRAWN BY: WG

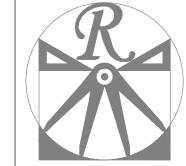
ENGINEERED BY:

REVIEWED BY: SECOND FLOOR

PLAN E-2

ELCTRICAL



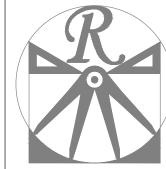

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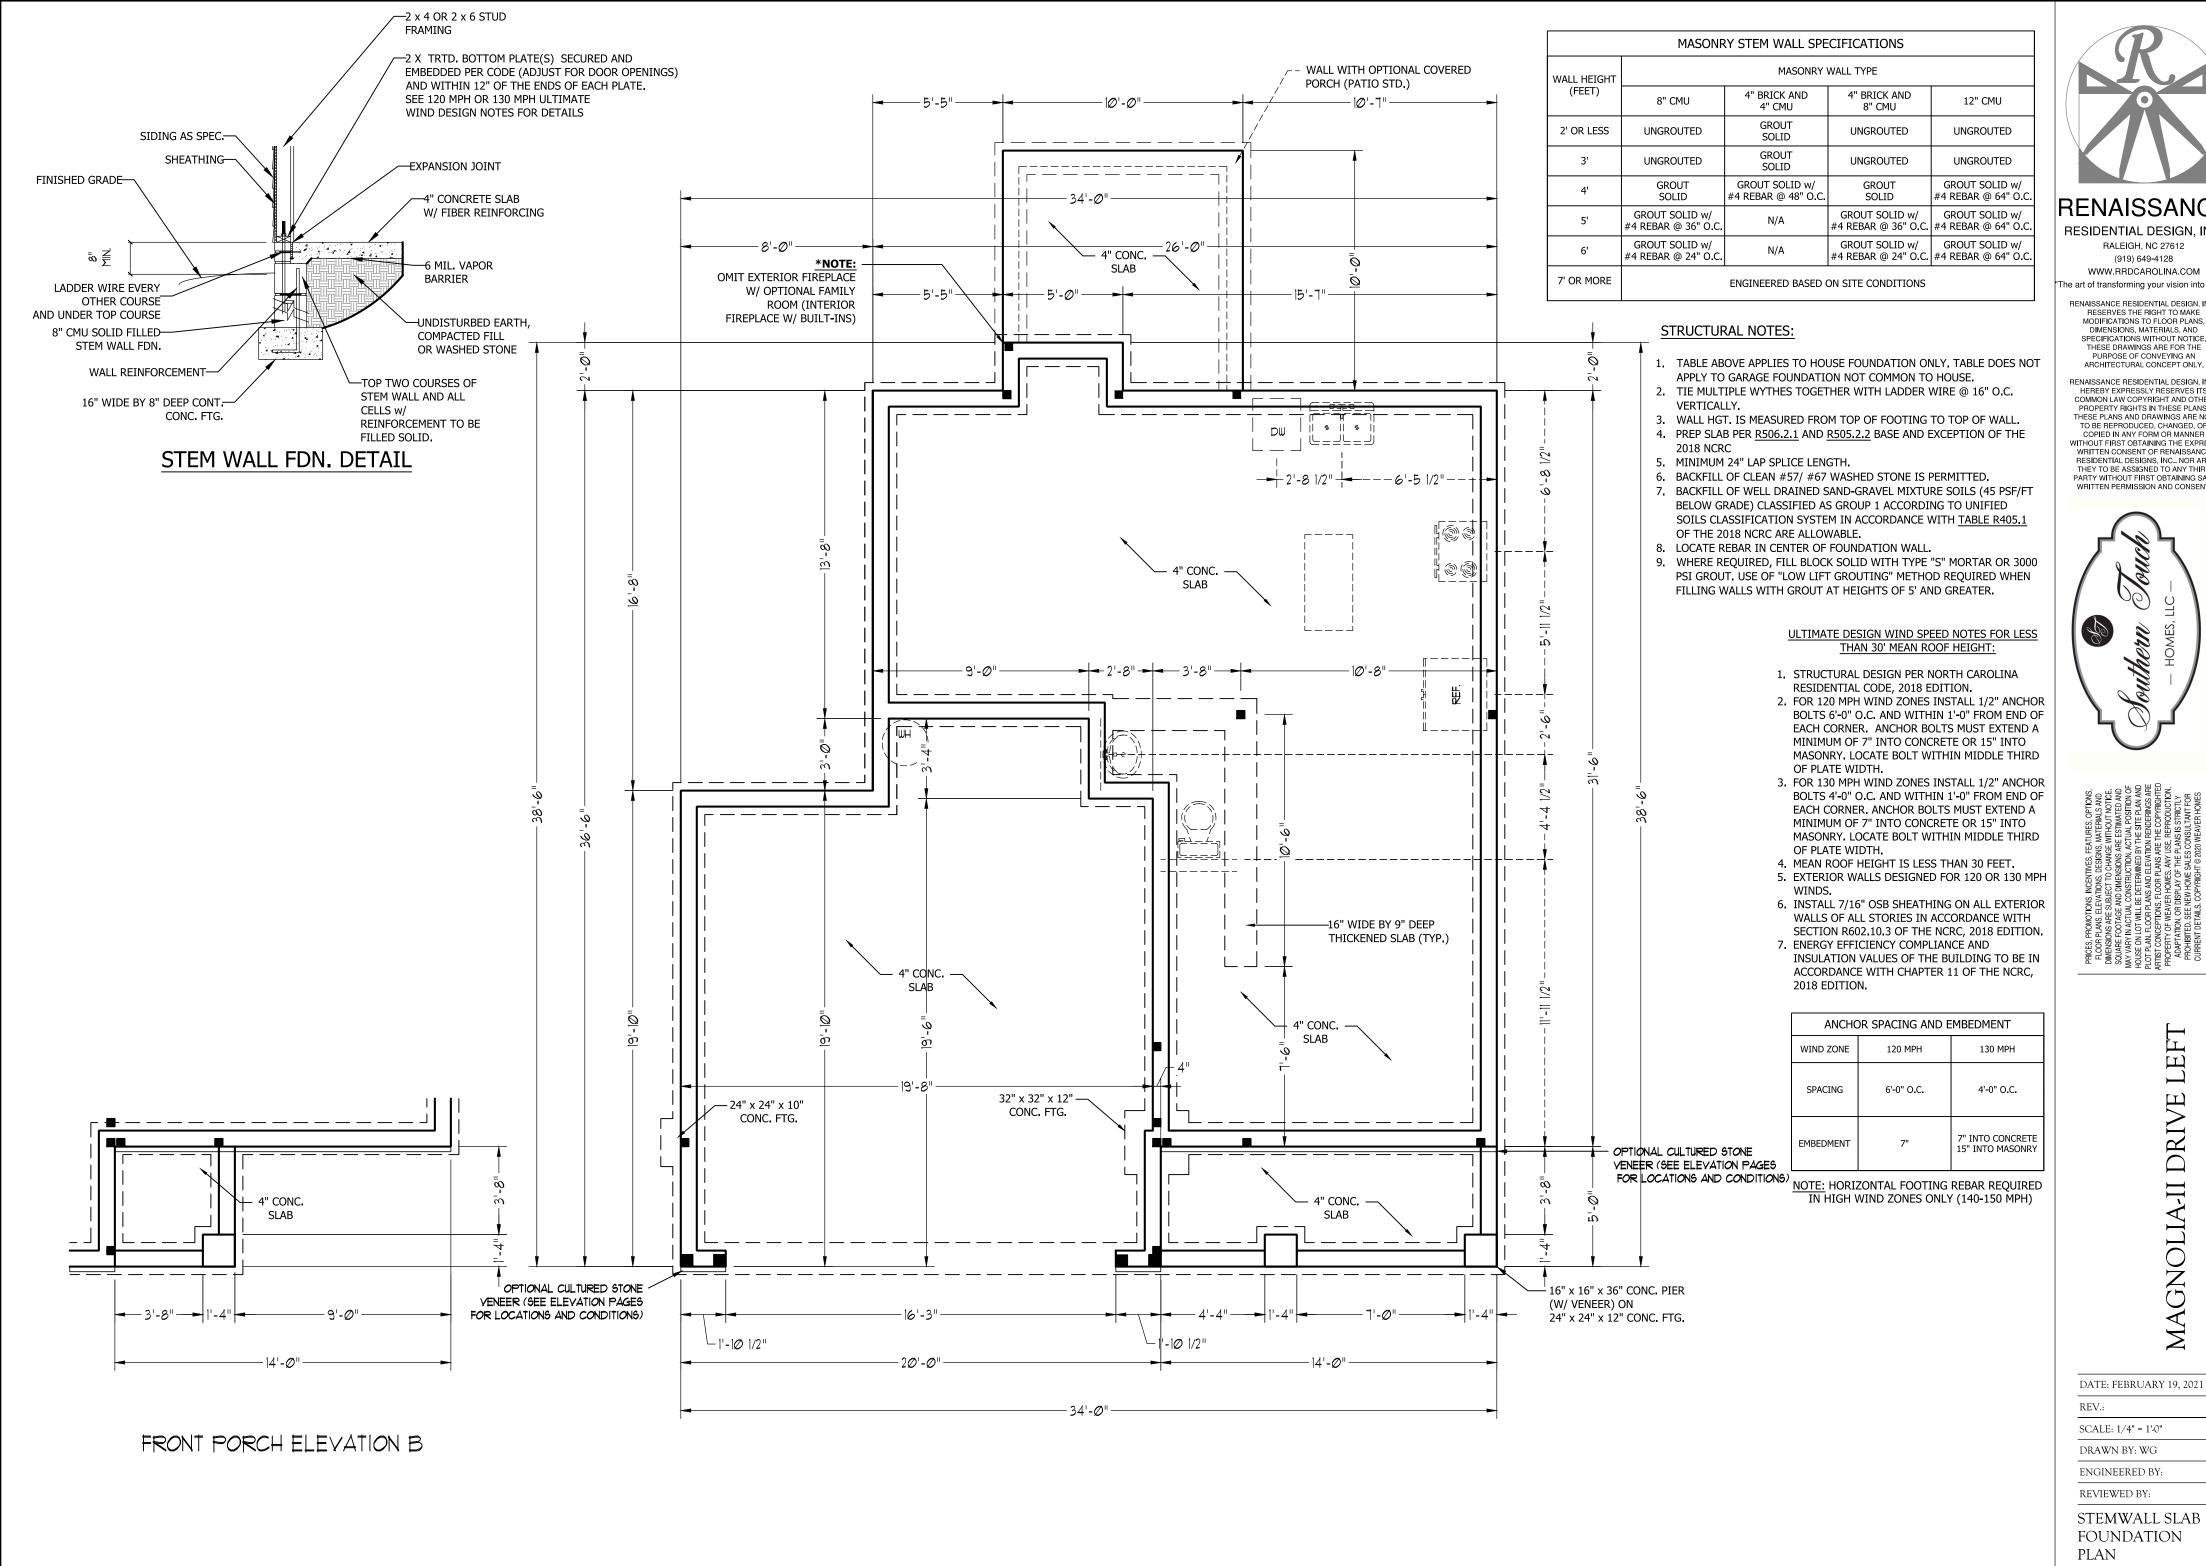
DATE: FEBRUARY 19, 2021

DRAWN BY: WG

ENGINEERED BY:

REVIEWED BY:

FOUNDATION PLAN



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SCALE: 1/4" = 1'-0" DRAWN BY: WG

ENGINEERED BY:

REVIEWED BY:

STEMWALL SLAB FOUNDATION PLAN

S-1

SCALE NOTE: 18x24 PRINTS ARE

TO SCALE AS NOTED. 11x17 PRINTS ARE NOT TO SCALE

MIN (TYP.)


FRONT PORCH AND DINING

ROOM WINDOW ELEVATION B

\_ PACK PORCH BEAM OUT TO 8" WIDTH (TYP.)

### **STRUCTURAL NOTES:**

1. ALL FRAMING LUMBER TO BE SPF #2 (UNO). ALL TREATED LUMBER TO BE SYP #2

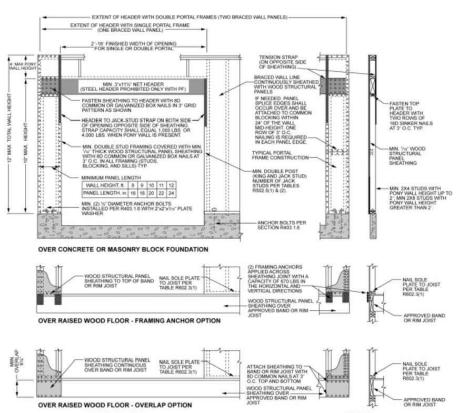

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SCALE: 1/4" = 1'-0"


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ENGINEERED BY: REVIEWED BY:

SECOND FLOOR FRAMING PLAN

S-2

SCALE NOTE: 18x24 PRINTS ARE TO SCALE AS NOTED. 11x17 PRINTS ARE NOT TO SCALE

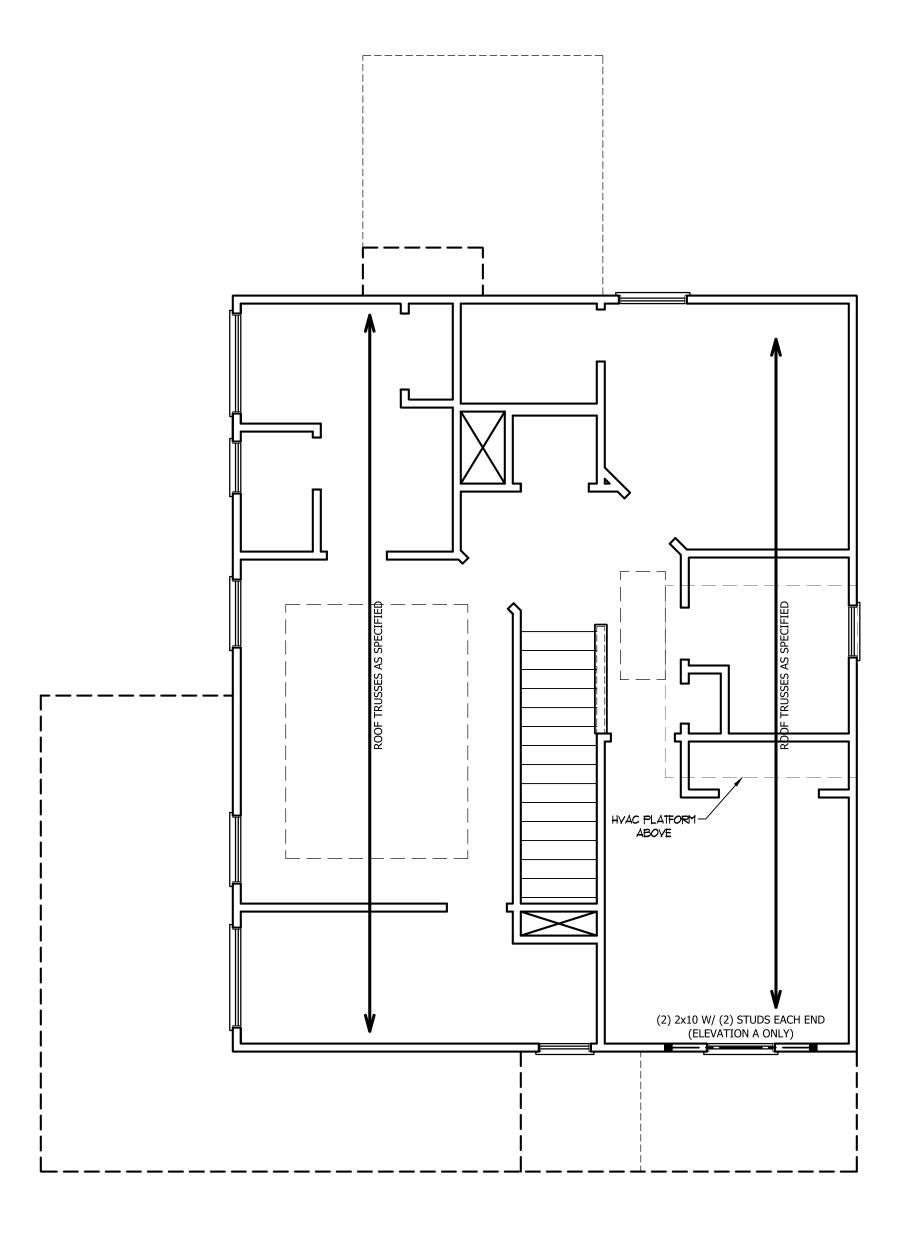


# TABLE R602.7.5 MINIMUM NUMBER OF FULL HEIGHT STUDS AT EACH END OF HEADERS IN EXTERIOR WALLS

,,,,,,,,,,,,,,,,,,,,,,,,,,,,,,,,,,,,,,,
CHES)

### STRUCTURAL NOTES:

- ALL FRAMING LUMBER TO BE SPF #2 (UNO). ALL TREATED LUMBER TO BE SYP #2 (UNO.)
- 2. ALL LOAD BEARING HEADERS TO BE (2) 2 x 6 (UNO).
- 3. WINDOW AND DOOR HEADERS TO BE SUPPORTED w/ (1) JACK STUD AND (1) KING STUD EA. END (UNO.). SEE TABLE R602.7.5 FOR ADDITIONAL KING STUD REQUIREMENTS.
- 4. SQUARES DENOTE POINT LOADS WHICH REQUIRE SOLID BLOCKING TO GIRDER OR FOUNDATION. ALL SQUARES TO BE (2) STUDS (UNO.)

DSP - DOUBLE STUD POCKET TSP - TRIPLE STUD POCKET

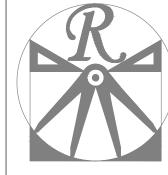

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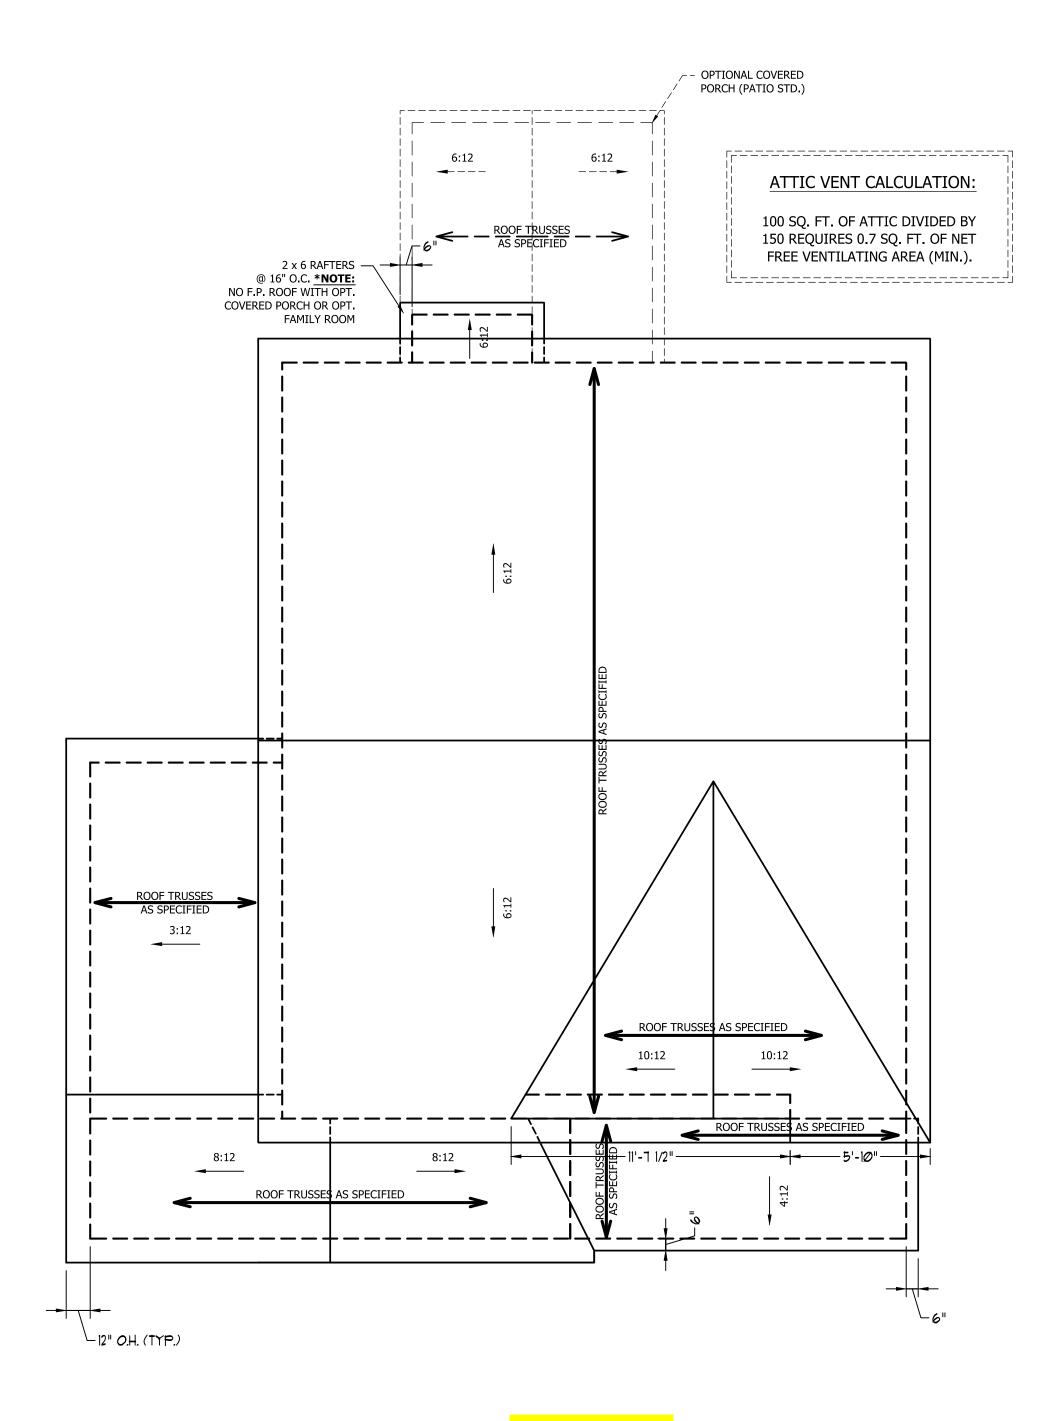
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FRAMING PLAN
S-3

SCALE NOTE: 18x24 PRINTS ARE TO SCALE AS NOTED.

11x17 PRINTS ARE NOT TO SCALE




ELEVATION C

### ATTIC VENT CALCULATION:

1250 SQ. FT. OF ATTIC DIVIDED BY 150 REQUIRES 8.3 SQ. FT. OF NET FREE VENTILATING AREA (MIN.).

### STRUCTURAL NOTES:

- 1. ALL FRAMING LUMBER TO BE #2 SPF (UNO).
- 2. HIP SPLICES ARE TO BE SPACED A MIN. OF 8'-0". FASTEN MEMBERS WITH THREE ROWS OF 12d NAILS @ 16" O.C. (TYP.)
- 3. STICK FRAME OVER-FRAMED ROOF SECTIONS W/ 2 x 8 RIDGES, 2 x 6 RAFTERS @ 16" O.C. AND FLAT 2 x 10 VALLEYS OR USE VALLEY TRUSSES.
- 4. FASTEN FLAT VALLEYS TO RAFTERS OR TRUSSES WITH SIMPSON H2.5A HURRICANE TIES @ 32" O.C. MAX. PASS HURRICANE TIES THROUGH NOTCH IN ROOF SHEATHING. EACH RAFTER IS TO BE FASTENED TO THE FLAT VALLEY WITH A MIN. OF (6) 12d TOE NAILS.
- 5. REFER TO SECTION R802.11 OF THE 2018 NCRC FOR REQUIRED UPLIFT RESISTANCE AT RAFTERS AND TRUSSES.

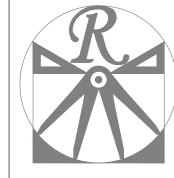

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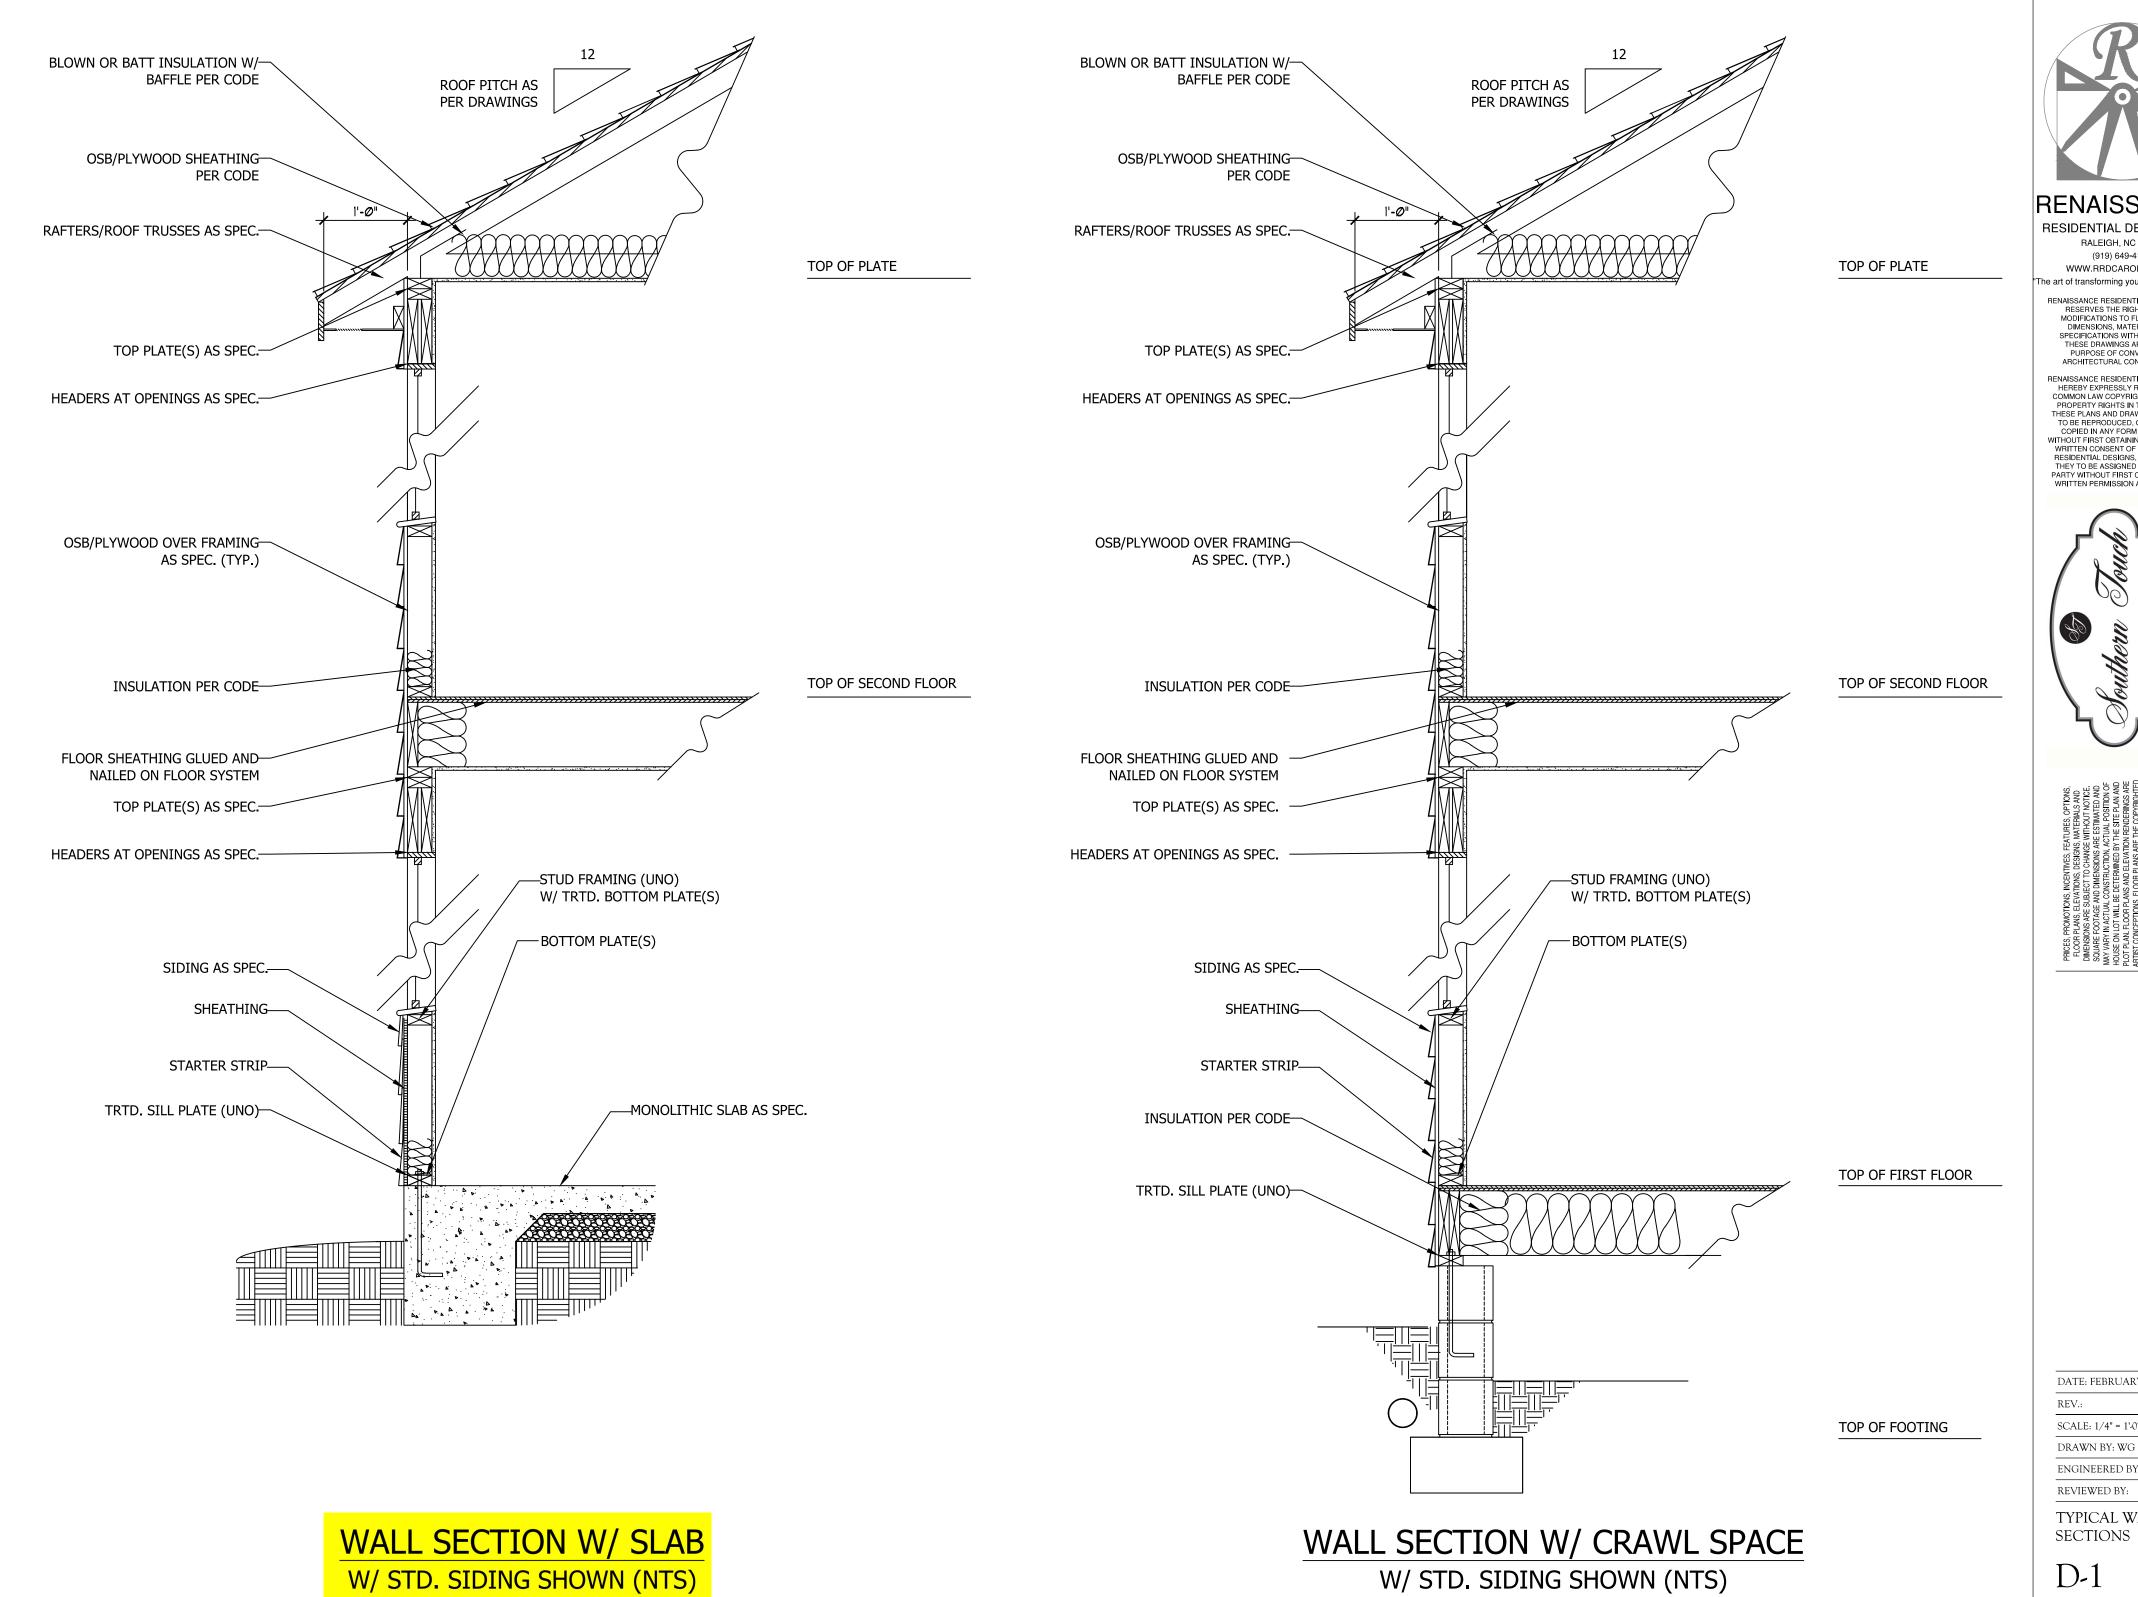
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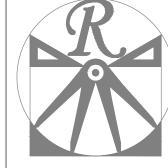
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REVIEWED BY:

ROOF PLAN ELEVATION - C

S-4





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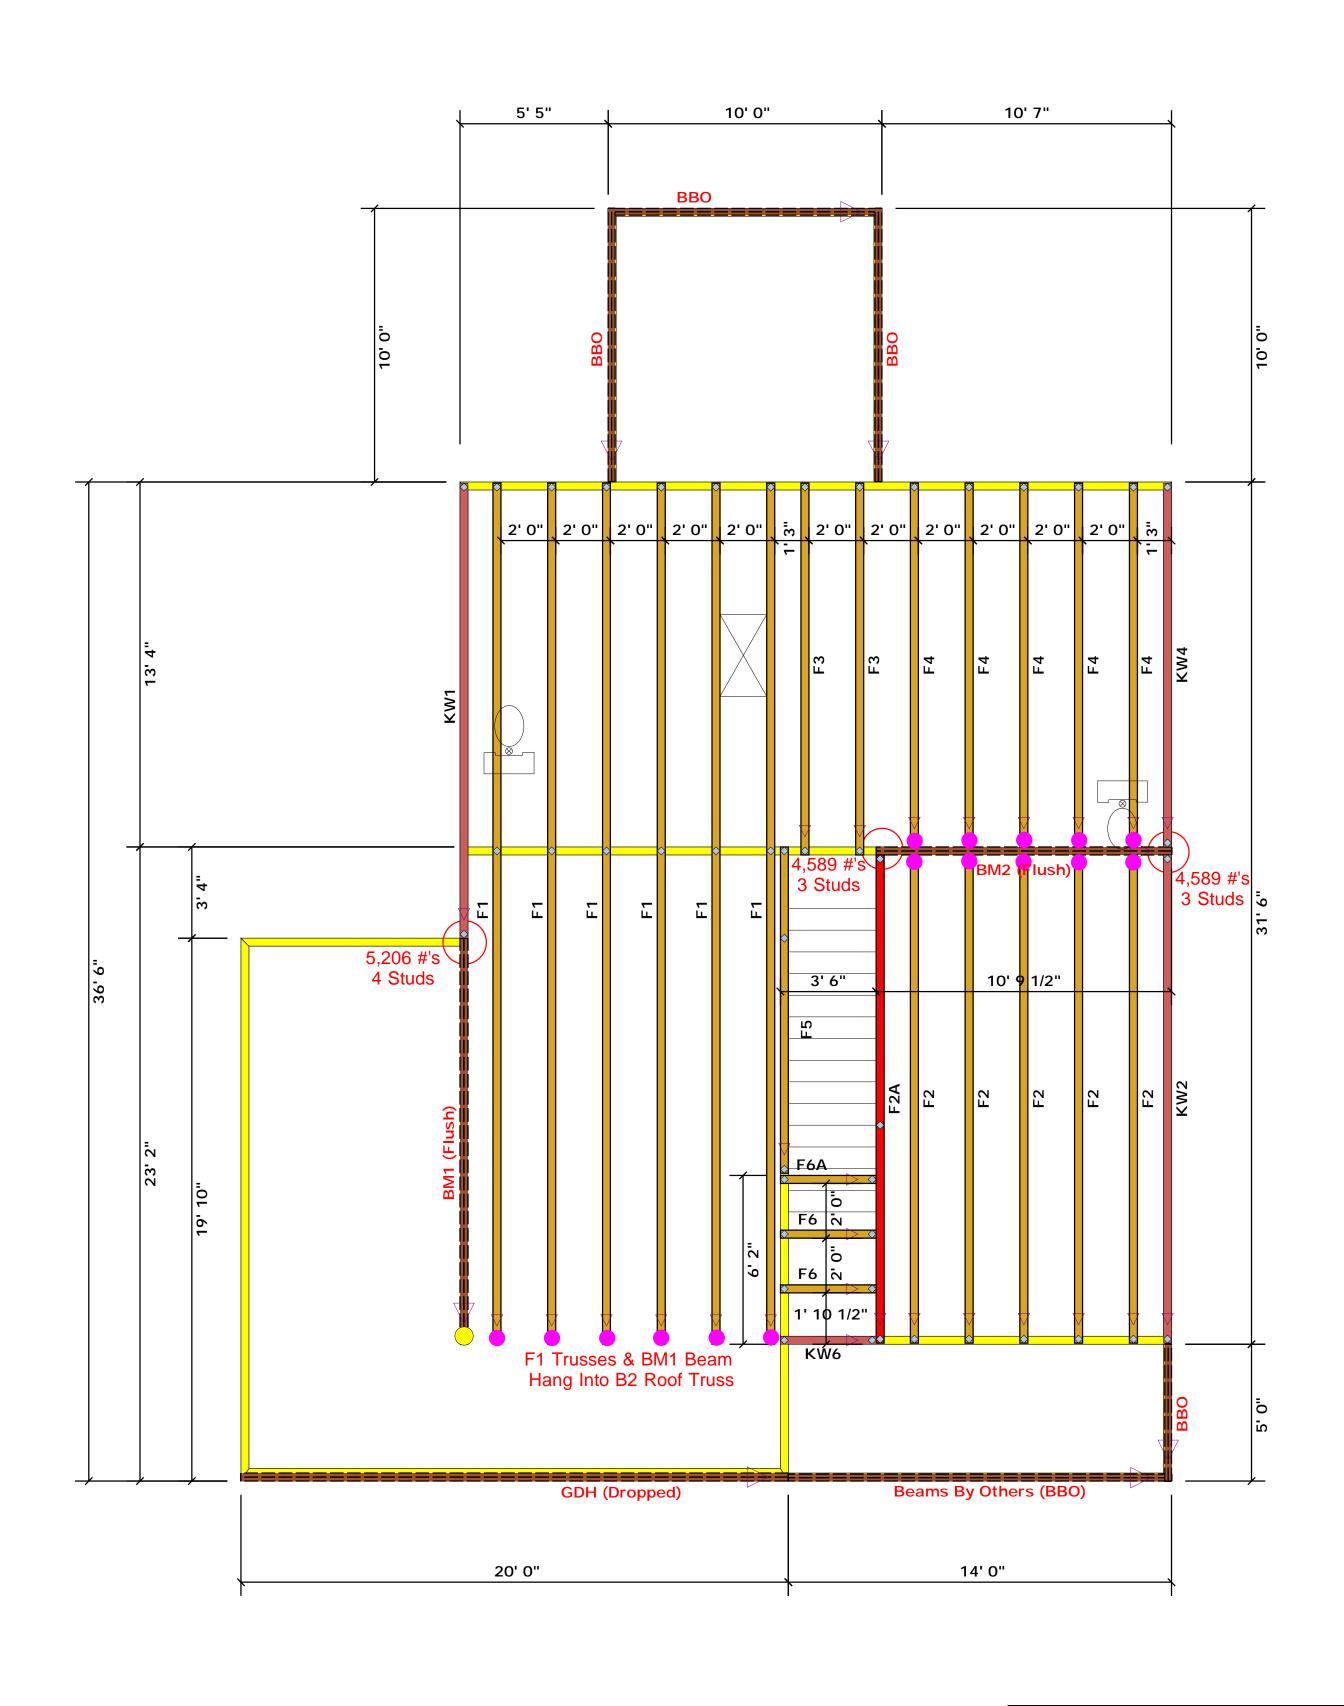
SCALE: 1/4" = 1'-0"

ENGINEERED BY:

REVIEWED BY:

TYPICAL WALL SECTIONS

D-1



# Truss Placement Plan SCALE: NTS

▲= Denotes Left End of Truss (Reference Engineered Truss Drawing)

= HUS410 (Qty. 16) = THD410 (Qty. 1)


		Products			
PlotID	Length	Product	Plies	Net Qty	Fab Type
GDH (Dropped)	20' 0"	1-3/4"x 11-7/8" LVL Kerto-S	2	2	FF
BM1 (Flush)	15' 0"	1-3/4"x 16" LVL Kerto-S	2	2	FF
BM2 (Flush)	11' 0"	1-3/4"x 16" LVL Kerto-S	2	2	FF

All Truss Reactions are Less than 3,000 lbs. Unless Noted Otherwise.

-- Denotes Reaction Greater than 3,000 lbs. Reaction / # of Studs

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5100	3	765	i0	3		10200	3
6800	4	102	00	4		13600	4
8500	5	127	50	5		17000	5
10200	á	153	00	6			
11900	7						
13600	8						
15300							

	BUILDER	Southern Touch Homes	CITY / CO.	Sanford / Lee	THIS IS A TRUSS PLACE These trusses are designed as the building design at the speci sheets for each truss design id	individual building components fication of the building designer.
64069	JOB NAME	1 Microwtower Road	ADDRESS	1 Microtower Road	is responsible for temporary an the overall structure. The desig walls, and columns is the respo regarding bracing, consult BCS	d permanent bracing of the roof n of the truss support structure in ensibility of the building designer
(0) N.Y.H	PLAN	Magnolia I I "C"	MODEL	Floor	or online @ sbcindustry.com  Bearing reactions less than oprescriptive Code requireme	nts. The contractor shall refe
	SEAL DATE	Seal Date	DATE REV.	/ /	( derived from the prescription foundation size and number than 3000# but not greater the retained to design the su	of wood studs required to su an 15000#. A registered desi
	QUOTE #	Quote #	DRAWN BY	Christine Shivy	specified in the attached Tab retained to design the suppo	rt system for all reactions tha
				3	Signature	Christine Sh
	JOB #	J0921-5768	SALES REP.	Lenny Norris		Christine Shi

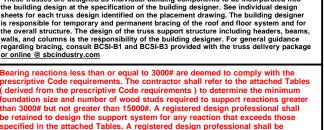


Christine Shivy

**Christine Shivy** 

**ROOF & FLOOR TRUSSES & BEAMS** Reilly Road Industrial Park Fayetteville, N.C. 28309 Phone: (910) 864-8787

Fax: (910) 864-4444

соттесн

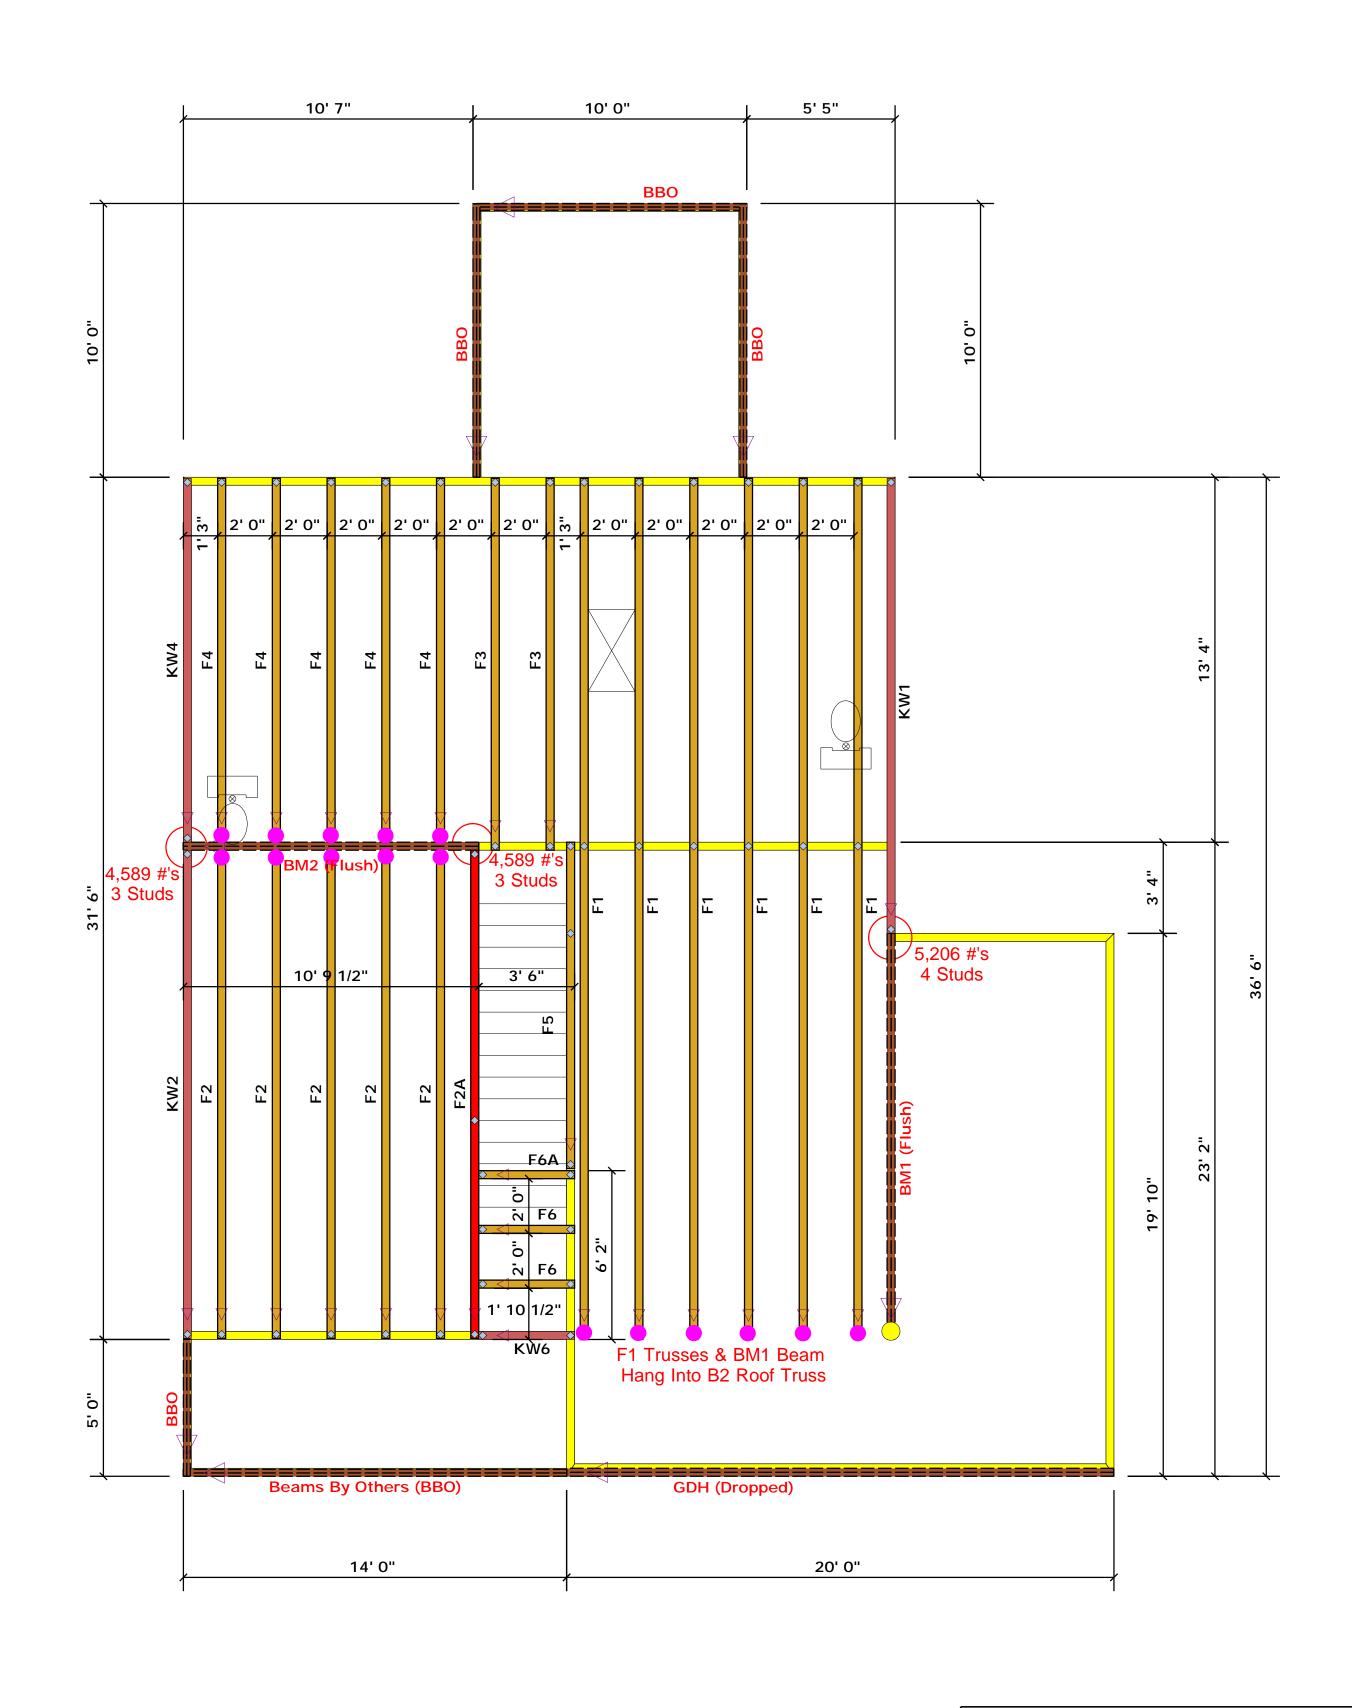

# Truss Placement Plan SCALE: NTS

▲= Denotes Left End of Truss
(Reference Engineered Truss Drawing)

= HUS410 (Qty. 16)
= THD410 (Qty. 1)

		Products			
PlotID	Length	Product	Plies	Net Qty	Fab Type
GDH (Dropped)	20' 0"	1-3/4"x 11-7/8" LVL Kerto-S	2	2	FF
BM1 (Flush)	15' 0"	1-3/4"x 16" LVL Kerto-S	2	2	FF
BM2 (Flush)	11' 0"	1-3/4"x 16" LVL Kerto-S	2	2	FF

All Truss Reactions are Less than 3,000 lbs. Unless Noted Otherwise.

-- Denotes Reaction Greater than 3,000 lbs.

Reaction / # of Studs

LO	AD (	CHART FO	DR J	ACK STUD	5
	00	ASEB ON LABOR	S R502	5(1) Å (b))	
NU	nr(s c	N JACK STUDG PEADER		(CO OP CA CNO SI)	
	3 e	resocc	5 e		8 a
ģ.	ubs Fo HEADER	á,	8 8	Ês	38
145 145	E SE	5 F	67	25	D S LUDS
S S	35	STEASTER CITY	98	ND 1,04 CT (0)	ABQ'D STUDS (4) R/Y HSA
_	*~		Ø		
1700	1	2550	1	3400	1
3400	2	5100	2	6800	2
5100	3	7650	3	10200	3
6800	4	10200	) 4	13600	4
8500	5	12750	5	17000	5
10200	á	15300	6 (		
11900	7				
13600	8				
15300	9				

	BUILDER	Southern Touch Homes	CITY / CO.	Sanford / Lee	T th
240E4	JOB NAME	1 Microwtower Road	ADDRESS	1 Microtower Road	is th w
(4) 11.1	PLAN	Magnolia I I "C"	MODEL	Floor	B p
	SEAL DATE	Seal Date	DATE REV.	/ /	fo th
	QUOTE #	Quote #	DRAWN BY	Christine Shivy	re
	JOB #	J0921-5768	SALES REP.	Lenny Norris	
	JOB #	J0921-5768	SALES REP.	Lenny Norris	




earing reactions less than or equal to 3000# are deemed to comply with the rescriptive Code requirements. The contractor shall refer to the attached Tables derived from the prescriptive Code requirements ) to determine the minimum undation size and number of wood studs required to support reactions greater an 3000# but not greater than 15000#. A registered design professional shall be retained to design the support system for any reaction that exceeds those pecified in the attached Tables. A registered design professional shall be stained to design the support system for all reactions that exceed 15000#.

Christine Shivy

Christine Shivy



Phone: (910) 864-8787 Fax: (910) 864-4444

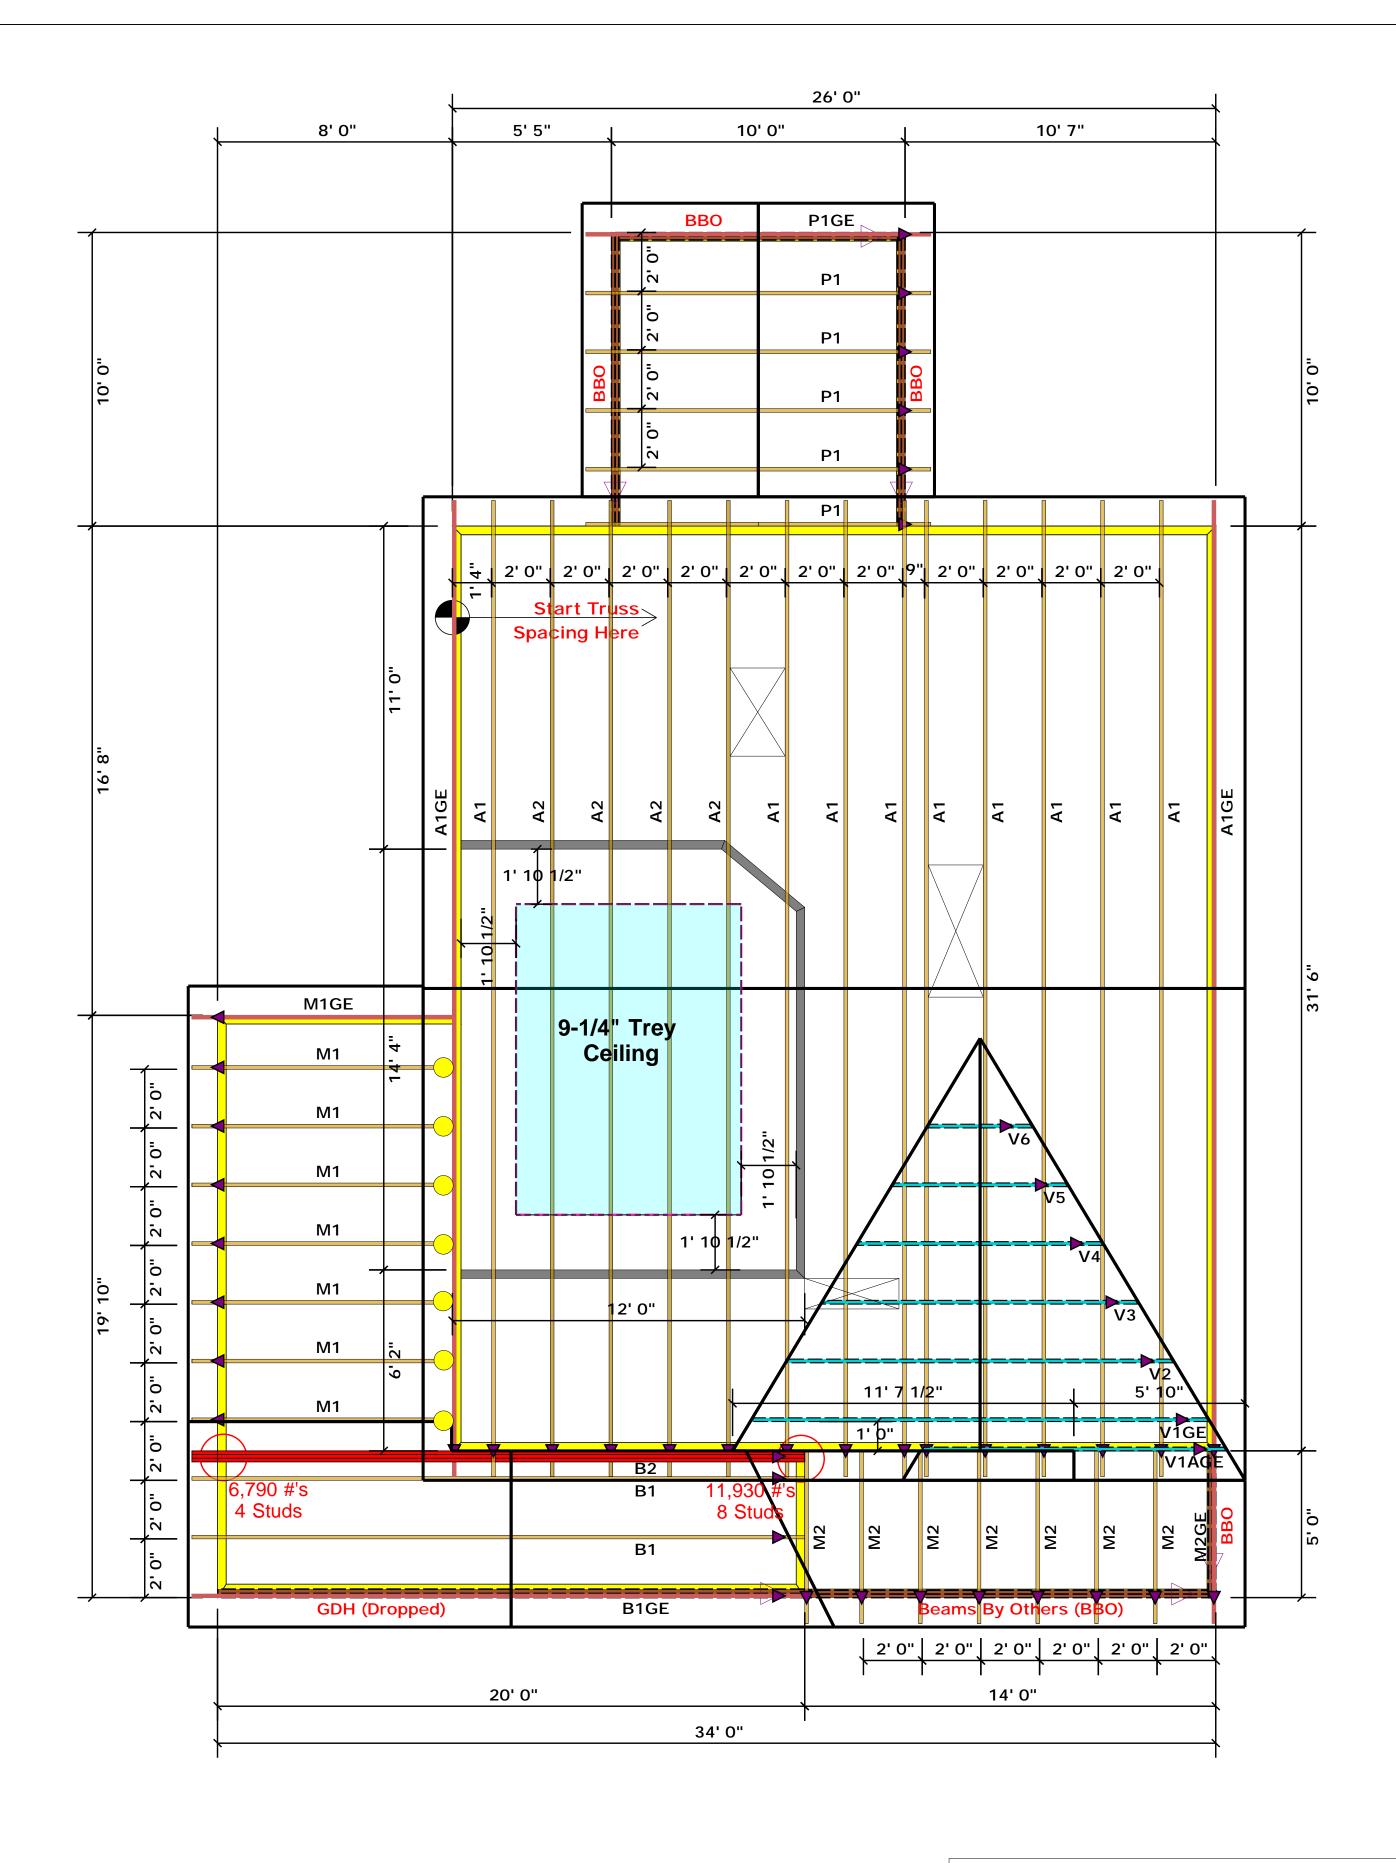

= JUS24 (Qty. 7)

▲ = Denotes Left End of Truss
(Reference Engineered Truss Drawing)

# Truss Placement Plan SCALE: NTS

All Truss Reactions are Less than 3,000 lbs. Unless Noted Otherwise.



-- Denotes Reaction Greater than 3,000 lbs.
Reaction / # of Studs

LOAD CHART FOR JACK STUDS								
	m	45Fb C	N LABLES	s R502	5(1) 4 (	ы		
MA	NPES C					A END OF		
			HEADER!	91,4000			of.	
END REACTION (OT FU)	80, o stubs Pos (r) RIV HEADER		SND PENCTION (IP 70)	SQUESTUDS FOR CIPAN - EMBER		ENB RIACTION (UP TO)	REQUESTABLES FOR (4) PLY HEADER	
1700	1		2550	1		3400	1	
3400	2		5100	2		6600	2	
5100	3		7650	3		10200	3	
6800	4		10200	4		13600	4	
8500	5		12750	5		17000	5	
10200	á		15300	6				
11900	7							
13600	8							

15300 9

BUILDER	Southern Touch Homes	CITY / CO.	Sanford / Lee	
JOB NAME	1 Microtower Road	ADDRESS	1 Microtower Road	
PLAN	Magnolia I I "C"	MODEL	Roof	
SEAL DATE	Seal Date	DATE REV.	/ /	1
QUOTE #	Quote #	DRAWN BY	Christine Shivy	
JOB #	J0921-5767	SALES REP.	Lenny Norris	

THIS IS A TRUSS PLACEMENT DIAGRAM ONLY.

These trusses are designed as individual building components to be incorporated into the building design at the specification of the building designer. See individual design sheets for each truss design identified on the placement drawing. The building designer is responsible for temporary and permanent bracing of the roof and floor system and for the overall structure. The design of the truss support structure including headers, beams, walls, and columns is the responsibility of the building designer. For general guidance regarding bracing, consult BCSI-B1 and BCSI-B3 provided with the truss delivery package or online @ sbcindustry.com


paring reactions less than or equal to 3000# are deemed to comply with the escriptive Code requirements. The contractor shall refer to the attached Tables lerived from the prescriptive Code requirements) to determine the minimum undation size and number of wood studs required to support reactions greater an 3000# but not greater than 15000#. A registered design professional shall retained to design the support system for any reaction that exceeds those ecified in the attached Tables. A registered design professional shall be tained to design the support system for all reactions that exceed 15000#.

Christine Shivy
Christine Shivy



Fayetteville, N.C. 28309

Phone: (910) 864-8787 Fax: (910) 864-4444

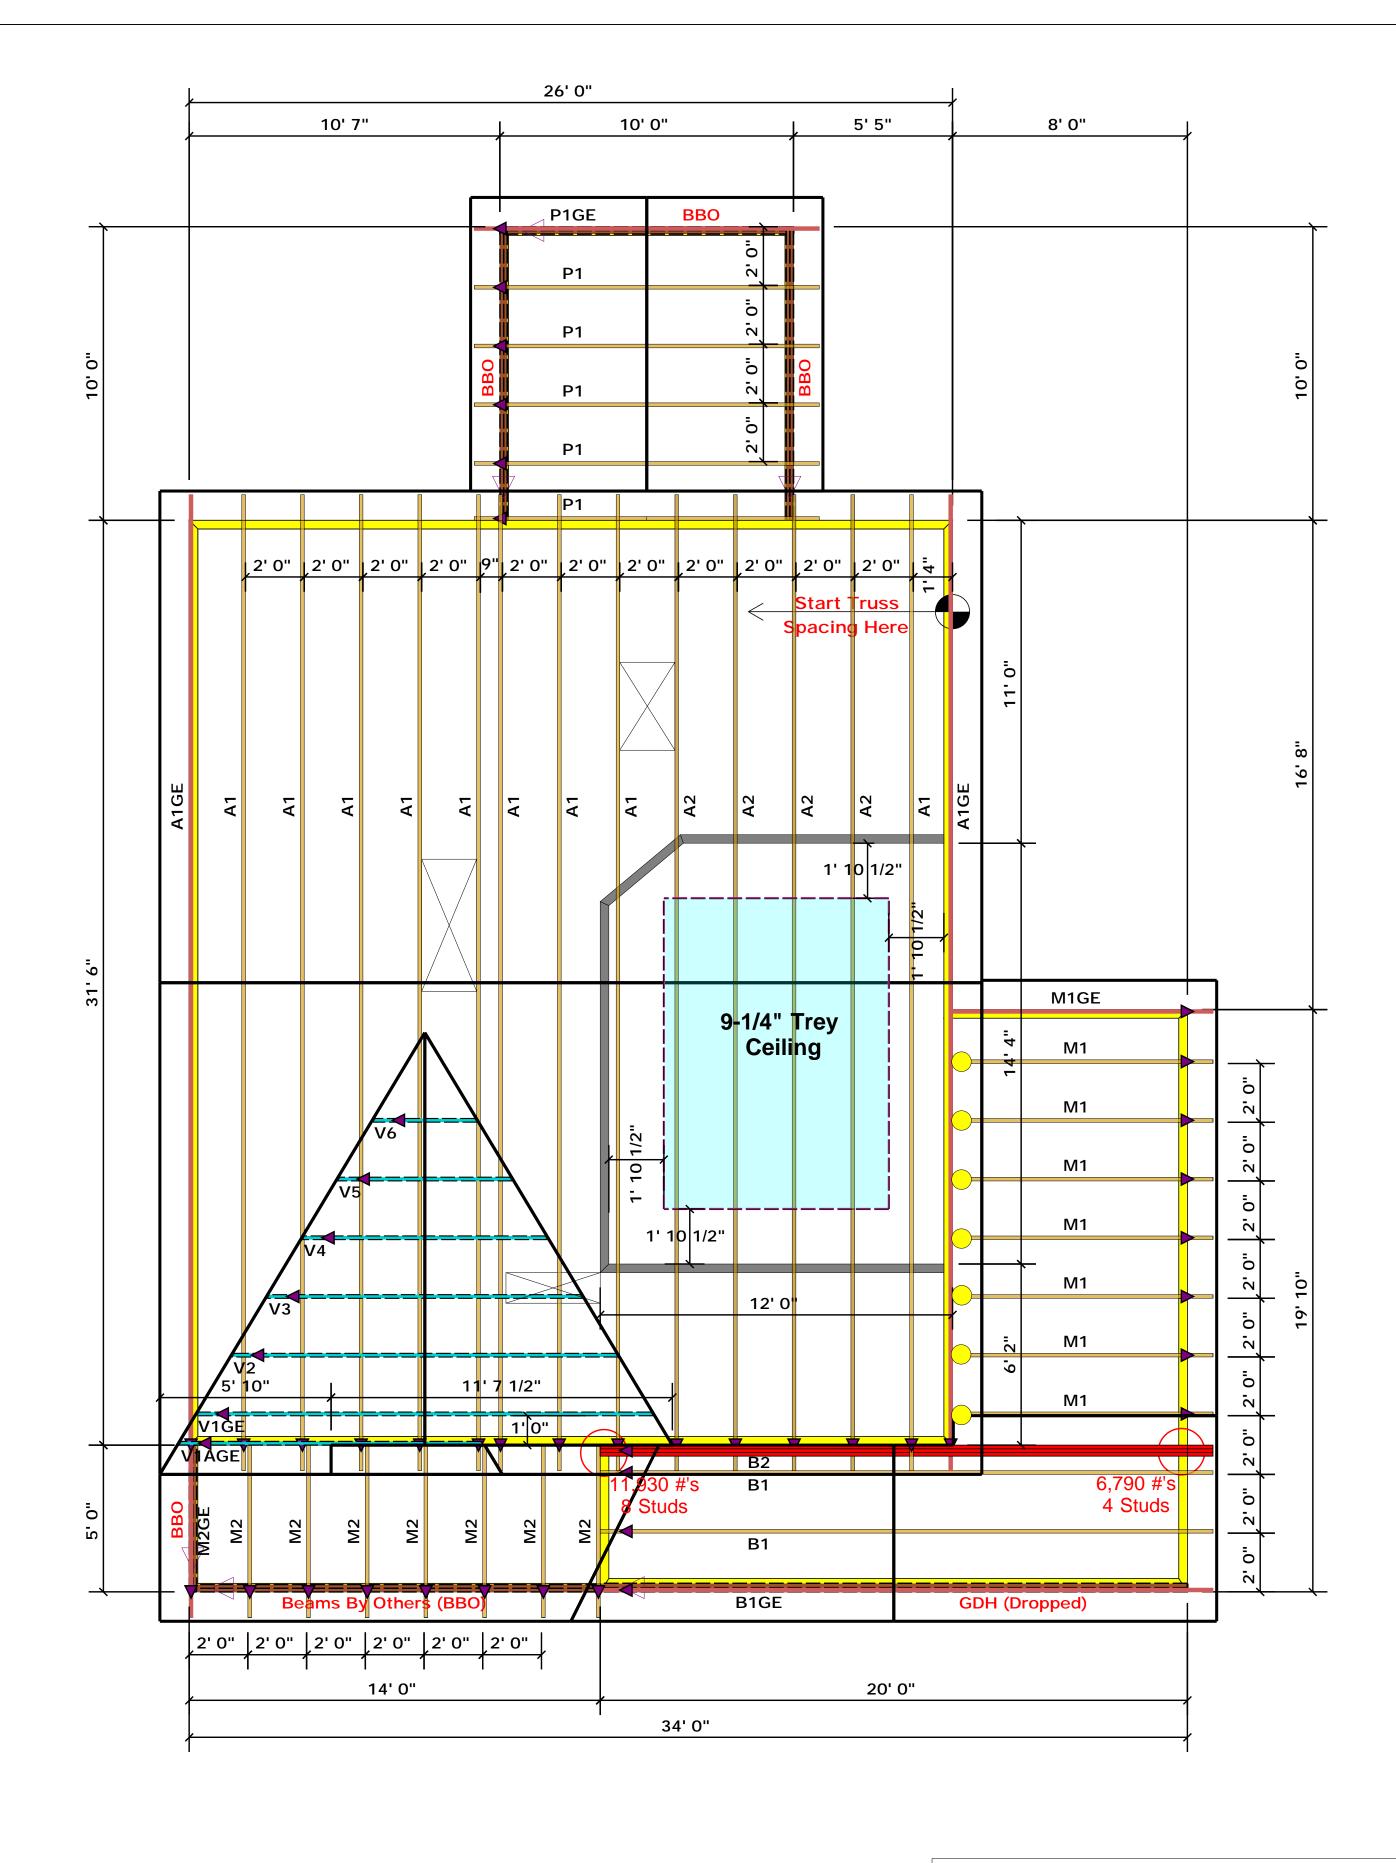

= JUS24 (Qty. 7)

▲= Denotes Left End of Truss (Reference Engineered Truss Drawing)

# Truss Placement Plan SCALE: NTS


All Truss Reactions are Less than 3,000 lbs. Unless Noted Otherwise.



-- Denotes Reaction Greater than 3,000 lbs.
Reaction / # of Studs

LO	4D C	HAR	T FC	РJ	ACK	STUD	5
		ASEN ON					
NLA	MLR O		onues EADER/			CA CND OF	
CND REACTION (UP TO)	EQ DISTUDS FOR CORN HEADER		SND PENCTION OF ALC	SQD STUDS FOR CORN - FABRE		END REACTOON (OF FO)	60/b Stubs FOR
1700	1		2550	1	1	3400	1
3400	2		5100	2	1	6600	2
5100	3		7650	3		10200	3
6800	4		10200	4		13600	4
8500	5		12750	- 5		17000	5
10200	á	1	15300	6			
11900	7						
13600	8						
15300	9						

BUILDER	Southern Touch Homes	CITY / CO.	Sanford / Lee	THIS IS A TRUSS PLACE These trusses are designed as the building design at the speci sheets for each truss design id
JOB NAME	1 Microtower Road	ADDRESS	1 Microtower Road	is responsible for temporary an the overall structure. The desig walls, and columns is the respo regarding bracing, consult BCS
PLAN	Magnolia I I "C"	MODEL	Roof	or online @ sbcindustry.com  Bearing reactions less than prescriptive Code requirement
SEAL DATE	Seal Date	DATE REV.	/ /	( derived from the prescripti foundation size and number than 3000# but not greater the be retained to design the su
QUOTE #	Quote #	DRAWN BY	Christine Shivy	specified in the attached Tal retained to design the suppo
JOB#	J0921-5767	SALES REP.	Lenny Norris	Signature
	JOB NAME PLAN SEAL DATE QUOTE #	JOB NAME 1 Microtower Road  PLAN Magnolia I I "C"  SEAL DATE Seal Date  QUOTE # Quote #	JOB NAME 1 Microtower Road ADDRESS  PLAN Magnolia I I "C" MODEL  SEAL DATE Seal Date DATE REV.  QUOTE # Quote # DRAWN BY	JOB NAME 1 Microtower Road ADDRESS 1 Microtower Road  PLAN Magnolia I I "C" MODEL Roof  SEAL DATE Seal Date DATE REV. / /  QUOTE # Quote # DRAWN BY Christine Shivy

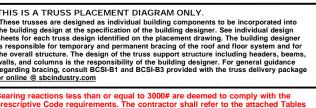

reactions less than or equal to 3000# are deemed to comply with the rescriptive Code requirements. The contractor shall refer to the attached Tables derived from the prescriptive Code requirements ) to determine the minimum bundation size and number of wood studs required to support reactions greater ana 3000# but not greater than 15000#. A registered design professional shall e retained to design the support system for any reaction that exceeds those pecified in the attached Tables. A registered design professional shall be etained to design the support system for all reactions that exceed 15000#.

Christine Shivy

**Christine Shivy** 

Reilly Road Industrial Park
Fayetteville, N.C. 28309
Phone: (910) 864-8787
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ROOF & FLOOR TRUSSES & BEAMS




Client: Project: Address: Southern Touch Magnolia-II Elev. C Magnolia-II Elev. C Date: 10/6/2021

Input by: Christine Shivy Job Name: Magnolia-II Elev. C Page 1 of 1

Project #:

1.750" X 16.000" **Kerto-S LVL** 2-Ply - PASSED BM<sub>1</sub>

Level: Level

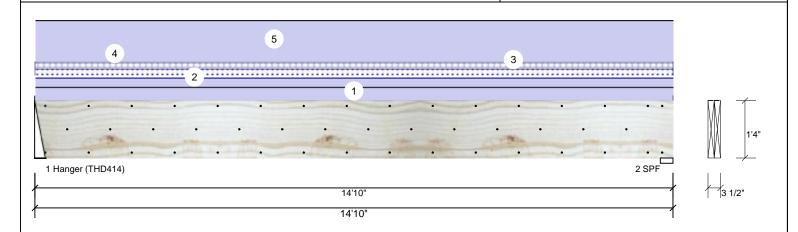

Member Inforr	nation			Reaction	ns UNPAT	TERNED I	(Uplift)	)	
Type:	Girder	Application:	Floor	Brg	Live	Dead	Snow	Wind	Const
Plies:	2	Design Method:	ASD	1	296	4522	577	0	0
Moisture Condition	: Dry	Building Code:	IBC/IRC 2015	2	298	4548	580	0	0
Deflection LL:	480	Load Sharing:	No						
Deflection TL:	360	Deck:	Not Checked						
Importance:	Normal								
Temperature:	Temp <= 100°F								
				Bearings	6				
				Bearing	Length	Cap. Rea	ct D/L lb	Total Ld. Case	Ld. Comb.
				1 - Hanger	3.000"	57% 45	522 / 655	5177 L	D+0.75(L+S)

2 - SPF 3.500"

100%

4548 / 658

5206 L

D+0.75(L+S)

,						
Analysis	Actual	Location	Allowed	Capacity	Comb.	Case
Moment	15931 ft-lb	7'4 3/4"	31109 ft-lb	0.512 (51%)	D	Uniform
Unbraced	18237 ft-lb	7'4 3/4"	18282 ft-lb	0.998 (100%)	D+0.75(L+S)	L
Shear	3723 lb	1'6 1/8"	10752 lb	0.346 (35%)	D	Uniform
LL Defl inch	0.041 (L/4231)	7'4 13/16"	0.361 (L/480)	0.110 (11%)	0.75(L+S)	L
TL Defl inch	0.324 (L/535)	7'4 13/16"	0.481 (L/360)	0.670 (67%)	D+0.75(L+S)	L

### **Design Notes**

Analysis Results

- 1 Fasten all plies using 3 rows of 10d Box nails (.128x3") at 12" o.c. Maximum end distance not to exceed 6".
- 2 Refer to last page of calculations for fasteners required for specified loads.
- 3 Fill all hanger nailing holes.
- 4 Girders are designed to be supported on the bottom edge only.
- 5 Top loads must be supported equally by all plies.
- 6 Top must be laterally braced at a maximum of 6'4 7/8" o.c.
- 7 Bottom braced at bearings.
- 8 Lateral slenderness ratio based on single ply width.

0 = 410141	ololidolilooo latto bacca oli	omigio pij maain								
ID	Load Type	Location	Trib Width	Side	Dead 0.9	Live 1	Snow 1.15	Wind 1.6	Const. 1.25	Comments
1	Uniform			Тор	125 PLF	0 PLF	0 PLF	0 PLF	0 PLF	Exterior Wall
2	Uniform			Near Face	78 PLF	0 PLF	78 PLF	0 PLF	0 PLF	M1
3	Uniform			Far Face	15 PLF	40 PLF	0 PLF	0 PLF	0 PLF	Floor Load
4	Uniform			Тор	130 PLF	0 PLF	0 PLF	0 PLF	0 PLF	Exterior Load
5	Uniform			Тор	251 PLF	0 PLF	0 PLF	0 PLF	0 PLF	A1GE
	Self Weight				12 PLF					

### Notes

Calculated Structured Designs is responsible only of the structural adequacy of this component based on the design criteria and loadings shown. It is the responsibility of the customer and/or the contractor to ensure the component suitability of the intended application, and to verify the dimensions and loads.

- Dry service conditions, unless noted otherwise
   LVL not to be treated with fire retardant or corrosive
- Indiang & Installation

  LVL beams must not be cut or drilled

  Refer to manufacturer's product information regarding installation requirements, multi-ply fastening details, beam strength values, and code approvals

  Damaged Beams must not be used

  Design assumes top edge is laterally restrained.

  Provide lateral support at bearing points to avoid lateral displacement and rotation

Handling & Installation

6. For flat roofs provide proper drainage to prevent ponding

This design is valid until 1/8/2023

Metsä Wood 301 Merritt 7 Building, 2nd Floor Norwalk, CT 06851 (800) 622-5850 www.metsawood.com/us ICC-ES: ESR-3633

Manufacturer Info

Comtech, Inc. 1001 S. Reilly Road, Suite #639 Fayetteville, NC USA 28314 910-864-TRUS







Client: Project: Address:


Southern Touch Magnolia-II Elev. C Magnolia-II Elev. C Date: 10/6/2021 Input by:


Christine Shivy Job Name: Magnolia-II Elev. C

Project #:

1.750" X 16.000" 2-Ply - PASSED **Kerto-S LVL BM2** 

Level: Level

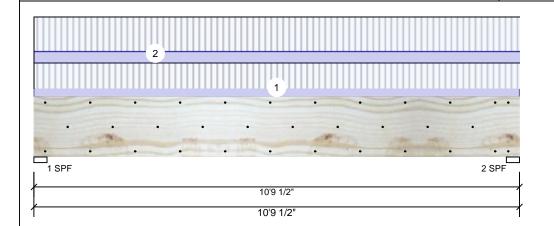

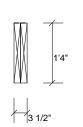

Page 1 of 1

Member Info	rmation			Reactio	ns UNPA	TERNED I	(Uplift)		
Type:	Girder	Application:	Floor	Brg	Live	Dead	Snow	Wind	Const
Plies:	2	Design Method:	ASD	1	3389	1200	0	0	0
Moisture Condition	on: Dry	Building Code:	IBC/IRC 2015	2	3389	1200	0	0	0
Deflection LL:	480	Load Sharing:	No						
Deflection TL:	360	Deck:	Not Checked						
Importance:	Normal								
Temperature:	Temp <= 100°F								
				Bearing	gs				
				Bearing	g Length	Cap. Rea	ct D/L lb	Total Ld. Case	e Ld. Comb.
				1 - SPF	3.500"	88% 120	00 / 3389	4589 L	D+L
				2 - SPF	3 500"	88% 120	00 / 3389	4589 I	D+I

### Analysis Results

Analysis	Actual	Location	Allowed	Capacity	Comb.	Case
Moment	11397 ft-lb	5'4 3/4"	34565 ft-lb	0.330 (33%)	D+L	L
Unbraced	11397 ft-lb	5'4 3/4"	11746 ft-lb	0.970 (97%)	D+L	L
Shear	4386 lb	1'6 5/8"	11947 lb	0.367 (37%)	D+L	L
LL Defl inch	0.085 (L/1457)	5'4 3/4"	0.259 (L/480)	0.330 (33%)	L	L
TL Defl inch	0.115 (L/1076)	5'4 3/4"	0.345 (L/360)	0.330 (33%)	D+L	L

### **Design Notes**

- 1 Fasten all plies using 3 rows of 10d Box nails (.128x3") at 12" o.c. Maximum end distance not to exceed 6".
- 2 Refer to last page of calculations for fasteners required for specified loads.
- 3 Girders are designed to be supported on the bottom edge only.
- 4 Top braced at bearings.
- 5 Bottom braced at bearings.
- 6 Lateral slenderness ratio based on single ply width

o Late	o Eatoral dionactrices ratio based on single ply water.									
ID	Load Type	Location	Trib Width	Side	Dead 0.9	Live 1	Snow 1.15	Wind 1.6	Const. 1.25	Comments
1	Uniform			Far Face	89 PLF	267 PLF	0 PLF	0 PLF	0 PLF	F4
2	Uniform			Near Face	121 PLF	361 PLF	0 PLF	0 PLF	0 PLF	F2
	Self Weight				12 PLF					

### Notes

Calculated Structured Designs is responsible only of the structural adequacy of this component based on the design criteria and loadings shown. It is the responsibility of the customer and/or the contractor to ensure the component suitability of the intended application, and to verify the dimensions and loads.

- Dry service conditions, unless noted otherwise
   LVL not to be treated with fire retardant or corrosive

### Handling & Installation

Handling & Installation

1. UVI beams must not be out or drilled

2. Refer to manufacturer's product information regarding installation requirements, multi-ply fastening details, beam strength values, and code approvals

3. Damaged Beams must not be used

4. Design assumes top edge is laterally restrained

5. Provide lateral support at bearing points to avoid lateral displacement and rotation

For flat roofs provide proper drainage to prevent ponding

Metsä Wood 301 Merritt 7 Building, 2nd Floor Norwalk, CT 06851 (800) 622-5850 www.metsawood.com/us ICC-ES: ESR-3633

Comtech, Inc. 1001 S. Reilly Road, Suite #639 Fayetteville, NC USA 28314 910-864-TRUS



This design is valid until 1/8/2023 CSD BOOK

Manufacturer Info




Client: Project: Address: Southern Touch Magnolia-II Elev. C Magnolia-II Elev. C Date: 10/6/2021

Input by: Christine Shivy Job Name: Magnolia-II Elev. C Page 1 of 1

Project #:

**Kerto-S LVL** 2-Ply - PASSED 1.750" X 11.875" **GDH** 

Level: Level

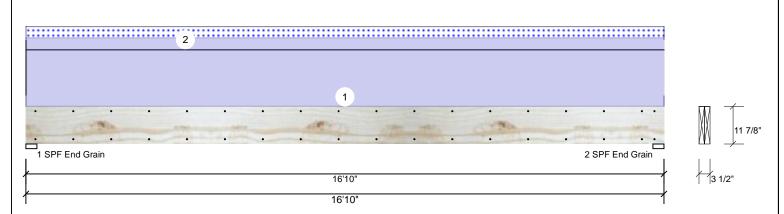

√lember In	formation						Reaction	ns UNPAT	TERNE	D lb (Uplift)	)		
Type:	Girder		Applicat	ion: F	loor		Brg	Live	Dead	d Snow	V	/ind	Const
Plies:	2		Design I	Method: A	ASD		1	0	2098	337		0	0
Moisture Con	dition: Dry		Building	Code: I	BC/IRC 2015		2	0	2098	3 337		0	0
Deflection LL:	480		Load Sh	aring:	No								
Deflection TL:	360		Deck:	1	Not Checked								
Importance:	Normal												
Temperature:	Temp <= 1	00°F					Bearing						
							Bearing		Cap.	React D/L lb	Total I	Ld. Case	Ld. Comb
							1 - SPF End	3.500"	23%	2098 / 337	2434 I	L	D+S
Analysis Re	sults						Grain						
Analysis	Actual	Location	Allowed	Capacity	Comb.	Case	2-SPF	3.500"	23%	2098 / 337	2434 I	L	D+S
Moment	8354 ft-lb	8'5"	17919 ft-lb	0.466 (47%	%) D	Uniform	End Grain						
Unbraced	9694 ft-lb	8'5"	9704 ft-lb	0.999 (100%)	D+S	L							
Shear	1794 lb	1'2 5/8"	7980 lb	0.225 (22%	6) D	Uniform							

### **Design Notes**

1 Fasten all plies using 2 rows of 10d Box nails (.128x3") at 12" o.c. Maximum end distance not to exceed 6".

8'5 1/16" 0.409 (L/480) 0.170 (17%) S

8'5 1/16" 0.546 (L/360) 0.930 (93%) D+S

- 2 Refer to last page of calculations for fasteners required for specified loads.
- 3 Girders are designed to be supported on the bottom edge only.
- 4 Top loads must be supported equally by all plies.
- 5 Top must be laterally braced at a maximum of 9'6 3/4" o.c.
- 6 Bottom braced at bearings.

LL Defl inch 0.070 (L/2809)

TL Defl inch 0.506 (L/388)

7 Lateral slenderness ratio based on single ply width.

ID	Load Type	Location	Trib Width	Side	Dead 0.9	Live 1	Snow 1.15	Wind 1.6	Const. 1.25	Comments	
1	Uniform			Тор	200 PLF	0 PLF	0 PLF	0 PLF	0 PLF	Exterior Loads	
2	Uniform			Тор	40 PLF	0 PLF	40 PLF	0 PLF	0 PLF	2'-0" Gable End	
	Self Weight				9 PLF						

1

### Notes

Calculated Structured Designs is responsible only of the structural adequacy of this component based on the design criteria and loadings shown. It is the responsibility of the customer and/or the contractor to ensure the component suitability of the intended application, and to verify the dimensions and loads.

- Dry service conditions, unless noted otherwise
   LVL not to be treated with fire retardant or corrosive
- Handling & Installation
- Indicating & Installation

  I. VIL beams must not be cut or drilled

  Refer to manufacturer's product information regarding installation requirements, multi-ply fastening details, beam strength values, and code approvals

  3. Damaged Beams must not be used

  1. Design assumes top edge is laterally restrained

  5. Provide lateral support at bearing points to avoid lateral displacement and rotation

- 6. For flat roofs provide proper drainage to prevent ponding

Metsä Wood 301 Merritt 7 Building, 2nd Floor Norwalk, CT 06851 (800) 622-5850 www.metsawood.com/us ICC-ES: ESR-3633

Manufacturer Info

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This design is valid until 1/8/2023