
THIS PLAN HAS BEEN DRAWN TO CONFORM TO THE 2018 NORTH CAROLINA RESIDENTIAL CODE


CONTRACTOR SHALL VERIFY ALL DIMENSIONS AND CONDITIONS PRIOR TO BEGGINING WORK. CONTRACTOR IS RESPONSIBLE FOR COMPLIANCE WITH ALL STATE AND LOCAL BUILDING CODES AND ORDINANCES. KADS CUSTOM HOME DESIGNS ASSUMES NO LIABILITY FOR SITE CONDITIONS, CONSTRUCTION METHODS OR ANY DEVIATION OF THESE PLANS.

NOTE:
ALL WINDOWS TO BE INSTALLED MUST MEET
A MAXIMUM OF .32 U VALUE OR BETTER, UNLESS
ENERGY CALCULATIONS ARE SUBMITTED WITH PLANS
PROVIDED BY BUILDER AT TIME OF PLAN REVIEW.

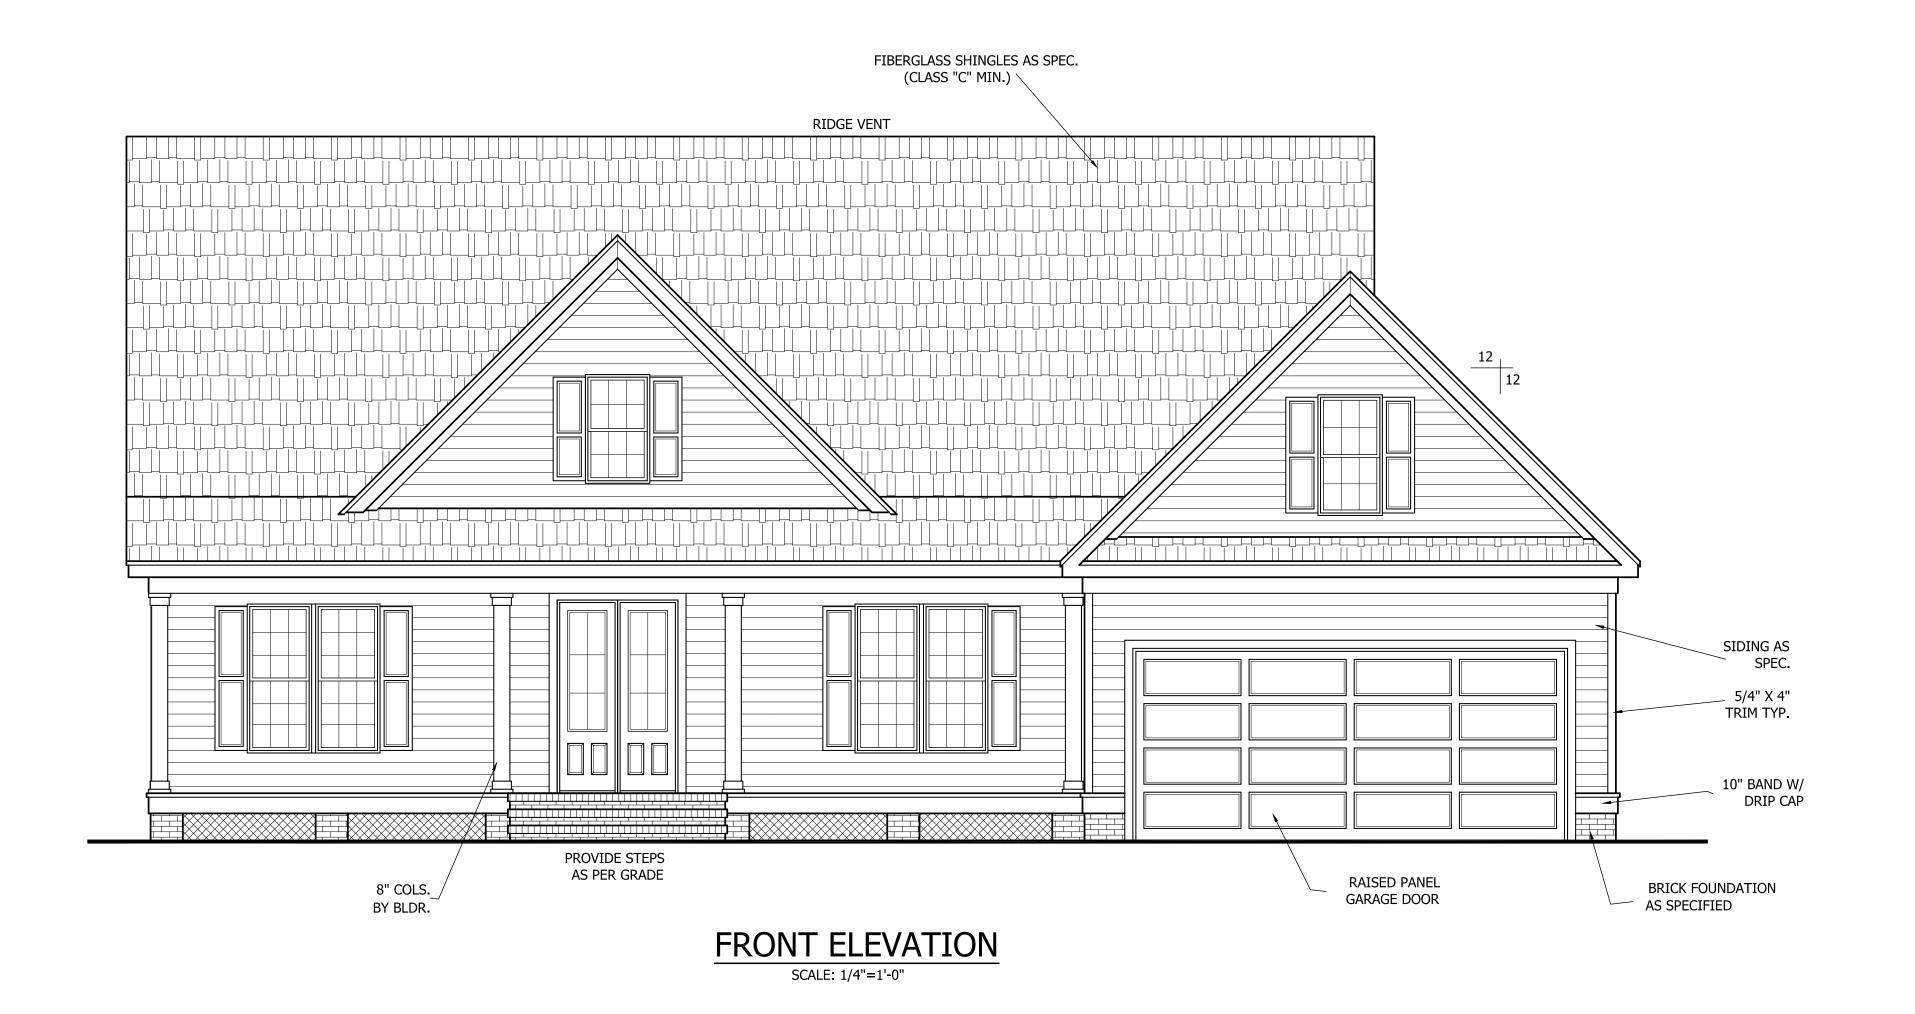






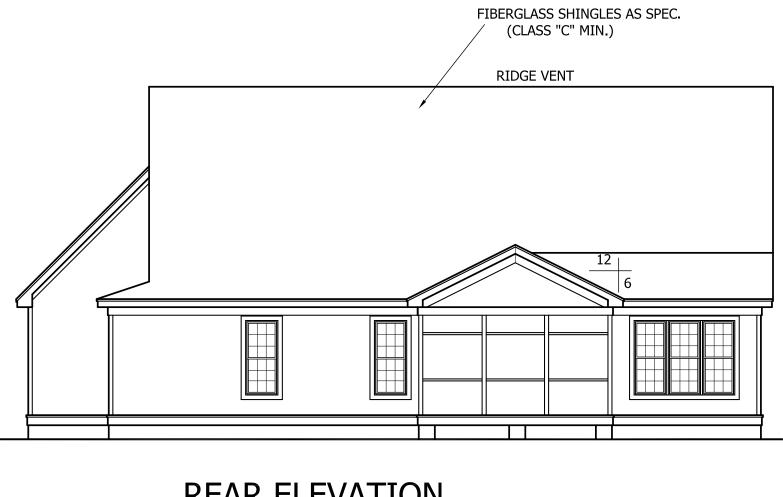

REAR ELEVATION

SCALE: 1/8"=1'-0"

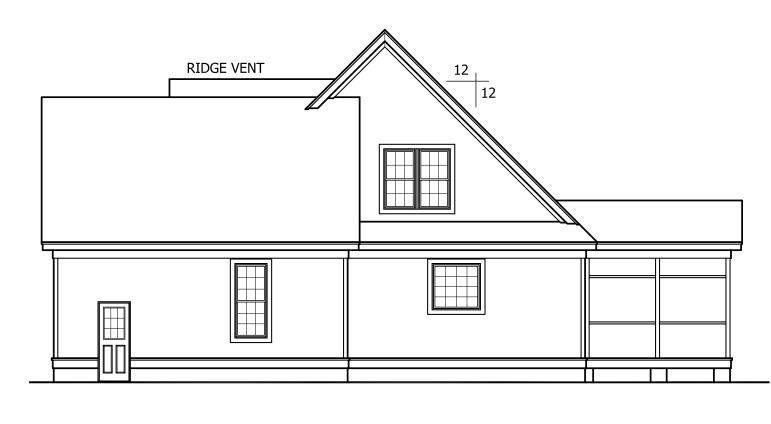


RIGHT ELEVATION

SCALE: 1/8"=1'-0"

# TEPHENSON BUILDERS, INC "I OT 27 MOPCAN EARMS"



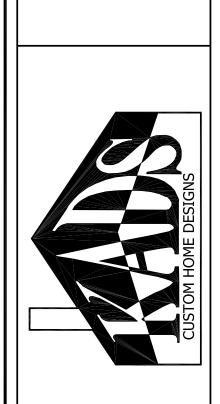

ANGIER, NC 919-369-7181

DRAWN BY: D.W.O.

DATE:


10/13/21

PAGE NO

2

OF

PLAN NO. DK2728

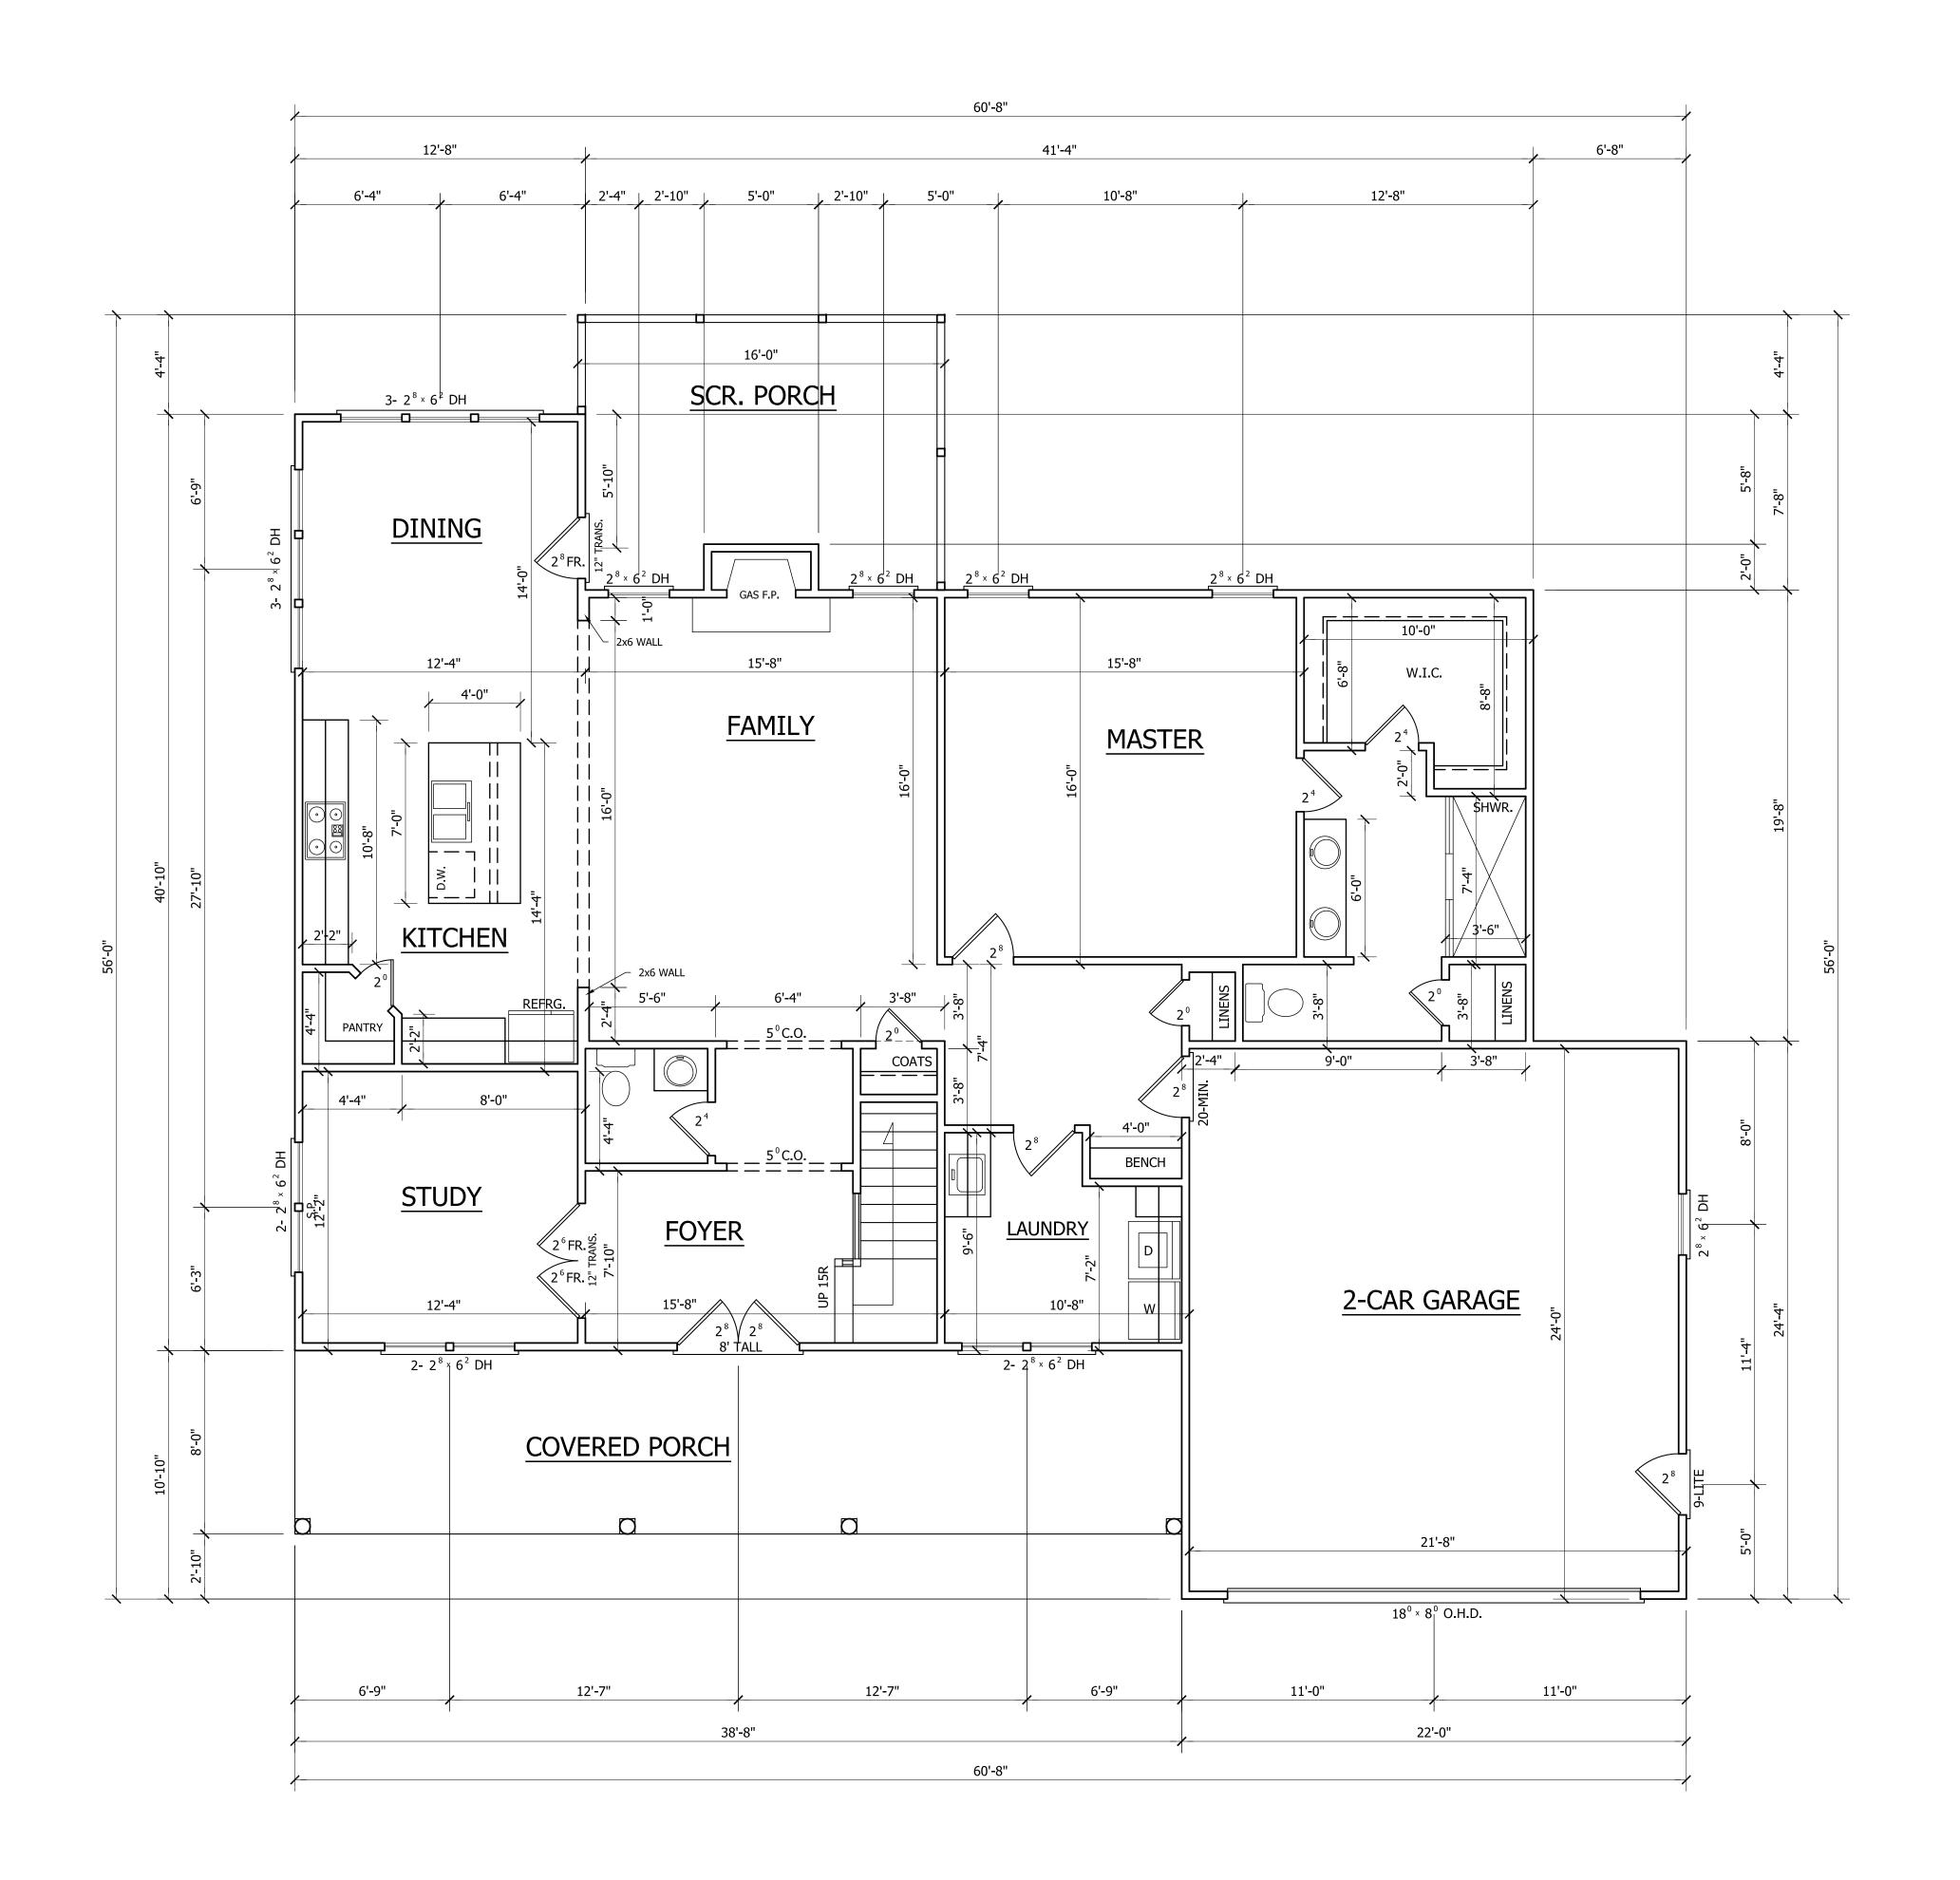

FIRST FLOOR PLAN

FRONT PORCH SQ. FT. GARAGE SQ. FT. STORAGE SQ. FT. SCREEN PORCH SQ. FT.

FIRST FLOOR HTD. SQ. FT. = 1691 SECOND FLOOR HTD. SQ. FT. = 737

TOTAL HTD. SQ FT. = 2728

= 300

= 309 = 525

= 173

SCALE: 1/4"=1'-0" 9'-0" CLG. HGT. SET WINDOWS AT 7'-10" A.F.F.

<u>HEATED</u>

REC. ROOM

<u>UNHEATED</u>

# SECOND FLOOR PLAN

SCALE: 1/4"=1'-0" 8'-0" CLG. HGT. SET WINDOWS AT 7'-6" A.F.F. (U.N.O.)

# TEPHENSON BUILDERS, INC "LOT 27 MORGAN FARMS"



ANGIER, NC 919-369-7181

DRAWN BY: D.W.O.


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PAGE NO

3

OF 4

PLAN NO. DK2728

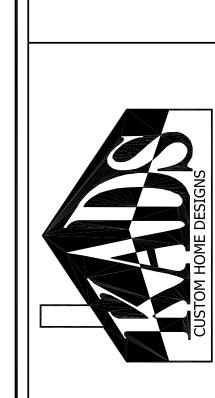

ANGIER, NC 919-369-7181

DRAWN BY: D.W.O.


DATE:

10/13/21

PAGE NO

OF

PLAN NO. DK2728

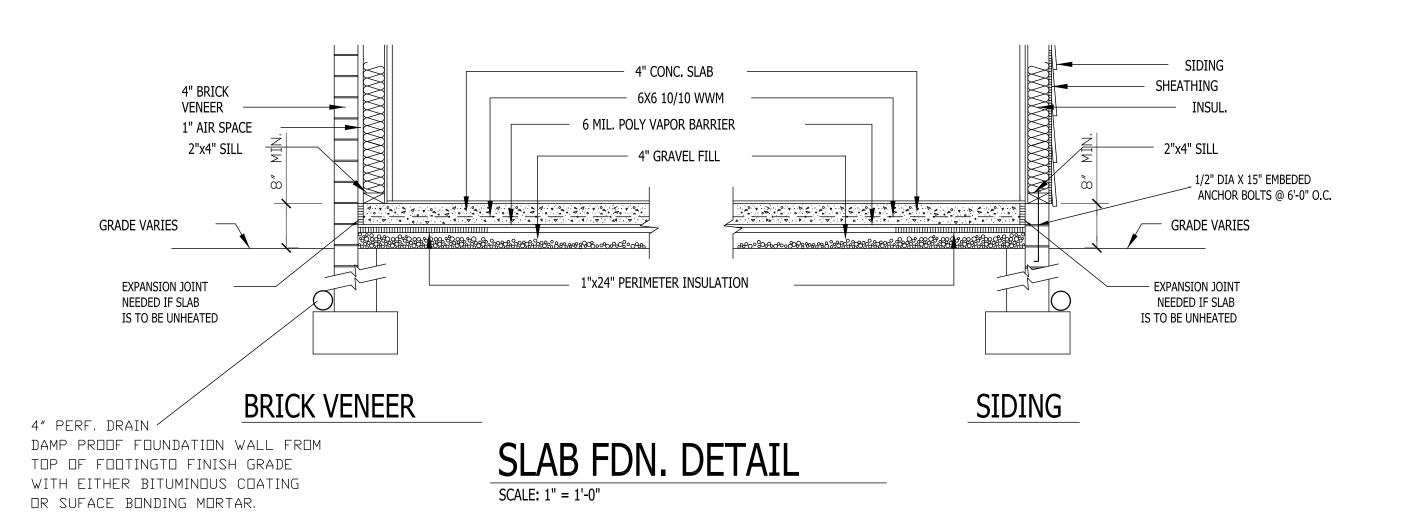

-COMPOSITE CLG. INSULATION R-31 240 lb. ASPHALT SHINGLES - 240 lb. ASPHALT SHINGLES 15 lb. FELT - 2X4 COLLAR BEAM @ 48" O.C. \" PLYWOOD SHEATHING — \" PLYWOOD SHEATHING 2ND FLOOR HVAC IN ATTIC - 2×4 RAFTER TIE @ 32″ O.C. ——— 1X8 FASCIA 2×4 RAFTER TIE — @ 32″ O.C. R-38 INSULATION 1×8 FASCIA— CLG, JOIST - 12" SQ. EDGE SIDING 12" SQ. EDGE SIDING— CLG, JOIST 2" CONT. VENT STRIP—— 2" CONT. VENT STRIP -1×10 SPRUCE 31" CROWN \_\_\_\_ —\_3I″ CR□WN 1×10 SPRUCE -1×6 SPRUCE - 1/2" SHEATHING 1/2" GYPSUM BOARD - R-13 INSULATION TYP. FOR INTERIOR WALLS — 2×4 STUDS BRICK VENEER WITH — WALL TIES EVERY 3 SQ. FT. FL, JOIST FL, JOIST 1/2" SHEATHING-—1" AIR SPACE 2×4 STUDS— - COMPOSITE WALL INSULATION R-16 COMPOSITE FLOOR **INSULATION R-20** SUBFLOOR — -SUBFLOOR R-19 INSULATION FINISH FLOOR - FINISH FLOOR 2 X BAND— — 2 X BAND FL, JOIST FL, JOIST WEEP HOLES 48" O.C. TREATED SILL CORBEL BRICK TREATED SILL

— 8" SOLID CAP FOR 2 STORY

4" SOLID CAP FOR 1 STORY 1/2" DIA X 15" EMBEDED ANCHOR BOLTS @ 6'-0" O.C. GIRDER AS SHOWN BELOW 8" SOLID CAP 1/2" DIA X 15" EMBEDED ANCHOR BOLTS @ 6'-0" O.C. 1ST FLOOR HVAC IN CRAWL SPACE FINISH GRADE (MIN. 22" CLEARANCE) 4" PERF. DRAIN \_DAMP PROOF FOUNDATION WALL FROM — CONC. BLOCK TOP OF FOOTINGTO FINISH GRADE 3" MIN. PROJECTION MAX. - THICKNESS OF WITH EITHER BITUMINOUS COATING OR SUFACE BONDING MORTAR. FOOTING

BRICK SECTION

CRAWL SPACE VENTILATION

PROVIDE AT LEAST 1.0 SQ. FT. NET FREE VENTILATION AREA FOR EACH 150 SQ. FT. OF CRAWL SPACE. CRAWL SPACE AREA = 1644 SQ.FT. 1644/150 = 10.96 SQ. FT. REQ'D.

REDUCE REQUIRED AREA TO 1.0 SQ. FT SQ. FT. OF CRAWL SPACE WITH APPROVED VAPOR BARRIER.

PROVIDE (1) VENT WITHIN 3'-0" OF EACH CORNER. REFER TO MANUFACTURER SPECIFICATIONS FOR ACTUAL VENTS USED TO DETERMINE NUMBER OF VENTS REQUIRED. ROOF VENTILATING REQUIREMENTS


= <u>18.90</u> SQ. FT. REQ'D

**ROOF VENTILATING REQUIREMENTS** (POWER ROOF VENTILATOR REQUIRED)


= <u>9.45</u> SQ. FT. REQ'D

BUILDER TO PROVIDE APPROPRIATE VENTILATING

AS REQUIRED.

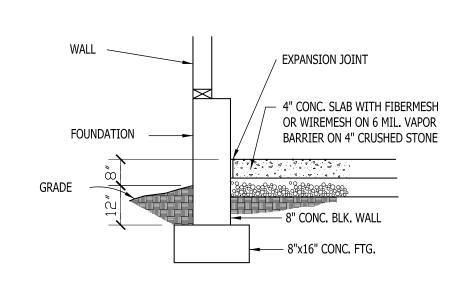

GARAGE SLAB SCALE: NTS

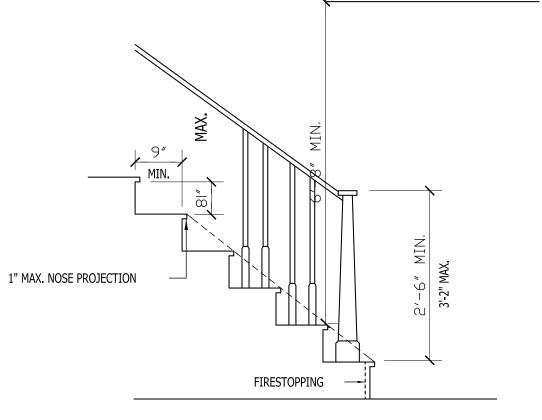



NOTE: MINIMUM CLEAR WIDTH: 2'-8\" FOR INTERIOR STAIRS 3'-0" FOR EXTERIOR STAIRS

STAIR DETAIL SCALE: NTS

WALL SECTION SCALE: \" = 1'-0"

SIDING SECTION

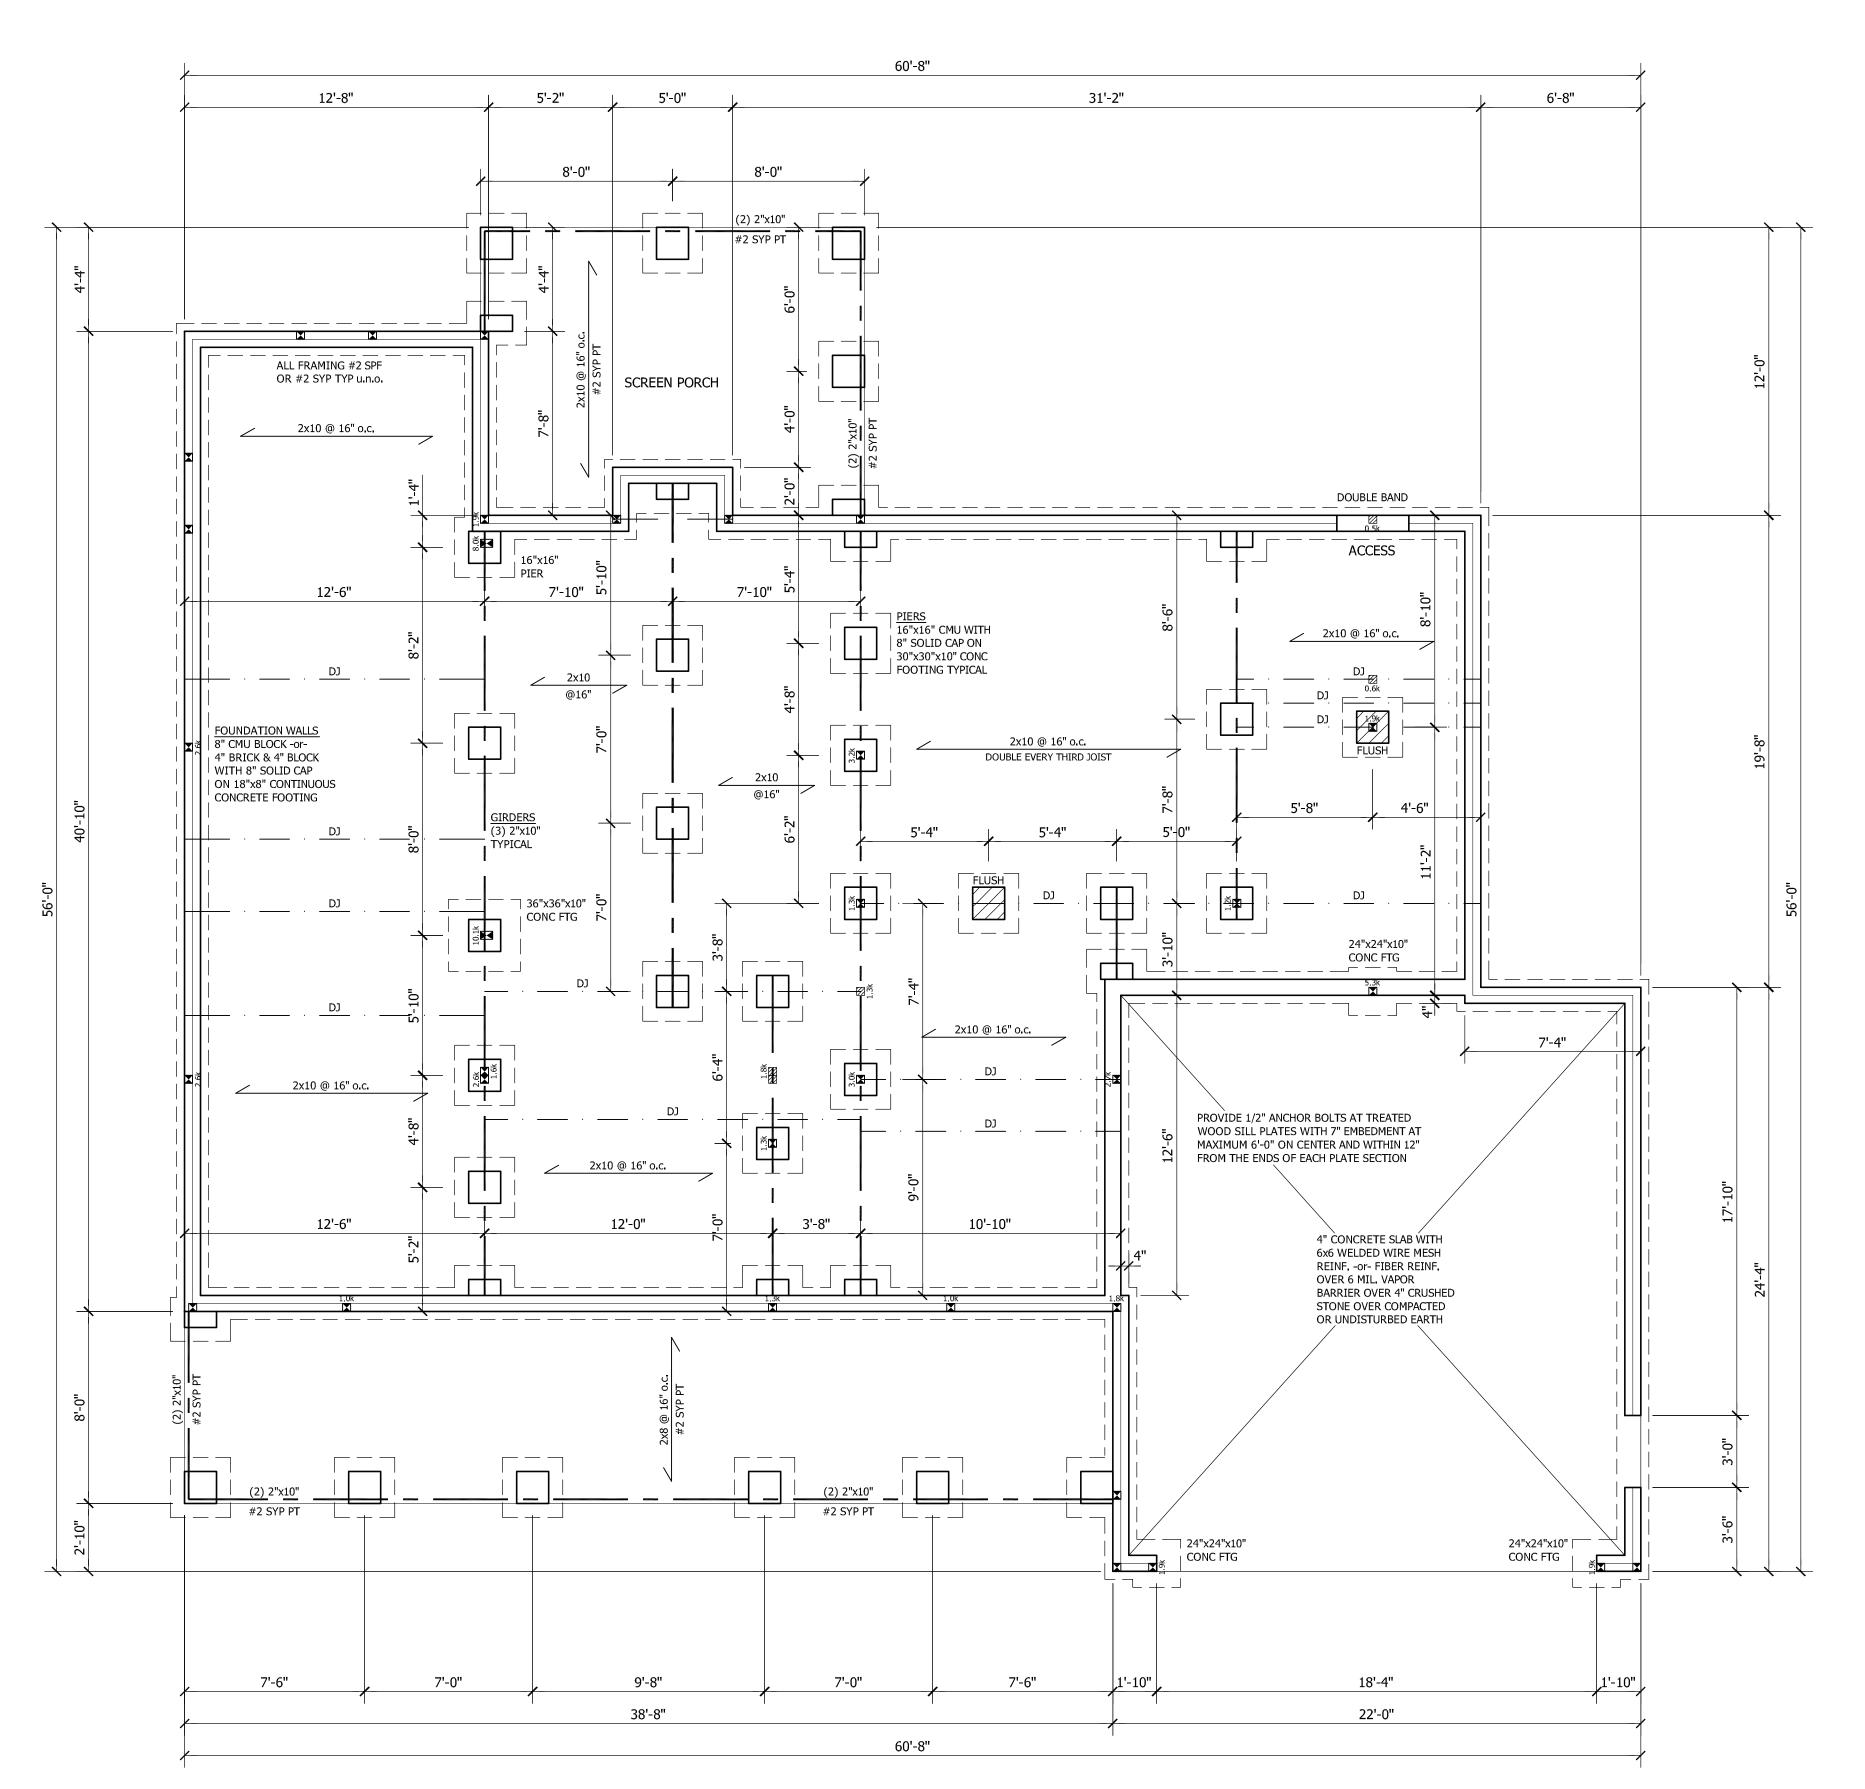

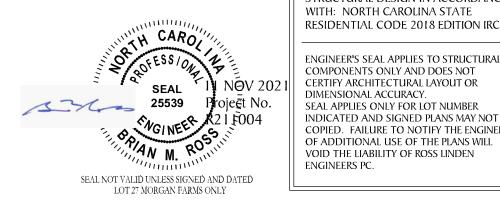

STRUCTURAL DESIGN IN ACCORDANCE WITH: NORTH CAROLINA STATE RESIDENTIAL CODE 2018 EDITION IRC ENGINEER'S SEAL APPLIES TO STRUCTURAL COMPONENTS ONLY AND DOES NOT CERTIFY ARCHITECTURAL LAYOUT OR DIMENSIONAL ACCURACY. SEAL APPLIES ONLY FOR LOT NUMBER INDICATED AND SIGNED PLANS MAY NOT BE COPIED. FAILURE TO NOTIFY THE ENGINEER

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AND ONLY FOR THE SAID LOCATION.

STEPHENSON BUILDERS LOT 27 MORGAN FARMS

PROJECT NO.

R211004

DESIGN BY LLR 10 NOV 2021

DATE REVISION 170704 25 AUG 1*7* 

FOUNDATION & FIRST FLOOR

SHEET NO.

OF S5

FOUNDATION & FIRST FLOOR FRAMING

SCALE: 1/4" = 1'-0"

# WALL BRACING NOTES:

WALL BRACING SHALL BE IN ACCORDANCE WITH SECTION R602.10.3
CONTINUOUS SHEATHING. BRACING METHOD CS-WSP SHALL BE USED IN
ACCORDANCE WITH TABLE R602.10.1.

THE REOUIRED LENGTH OF BRACING FOR EACH SIDE OF A RECTANGLE CIRCUMSCRIBED AROUND THE PLAN OR A PORTION OF THE PLAN AT EACH STORY LEVEL SHALL BE IN ACCORDANCE WITH TABLE R602.10.3 AND FIGURE R602.10.3(1). UNLESS NOTED OTHERWISE, THE ENTIRE STRUCTURE IS ASSUMED TO CIRCUMSCRIBED WITHIN A SINGLE RECTANGLE.

MINIMUM PANEL WIDTH IS 24". SEE SECTION R602.10.3 FOR ADDITIONAL INFORMATION. CONNECTION CRITERIA SHALL BE IN ACCORDANCE WITH TABLE R602.10.1. PORTAL FRAME CONSTRUCTION SHALL BE IN ACCORDANCE WITH FIGURE R602.10.1

HOLD DOWN DEVICE SHALL BE AS FOLLOWS: SIMPSON LSTA24 STRAP (OR EQUIVALENT) BETWEEN FLOORS EXTENDING FROM BOTTOM OF FLOOR BAND UP STUDS WHERE SHOWN. SIMPSON HD3B HOLDOWN (OR EQUIVALENT) WHERE REQUIRED TO CONNECT DIRECTLY TO FOUNDATION.

# WIND SPEED: 115 mph

EAVE TO RIDGE HEIGHT: 17.5 ft

PROVIDED LENGTH OF BRACING =  $\frac{27.5 \text{ ft}}{}$ 

PROVIDED LENGTH OF BRACING =  $\frac{26.5 \text{ ft}}{}$ 

FIRST FLOOR:

SHORT SIDE LENGTH OF CIRCUMSCRIBED RECTANGLE: 51.67 ft REQUIRED LENGTH OF BRACING = 6.2 ft

LONG SIDE LENGTH OF CIRCUMSCRIBED RECTANGLE: 60.67 ft REQUIRED LENGTH OF BRACING = 7.3 ft





1. STRUCTURAL NOTES SHEET S5.

2. FRAMING SHALL BE #2 SPF OR #2 SYP u.n.o.

3. EXTERIOR AND BEARING HEADERS (2) 2"x10" u.n.o.

4. ■ DENOTES POINT LOAD. SEE CONSTRUCTION NOTE #4 ON S5.

FRAMING SYSTEM
JOIST LAYOUT AND PLACEMENT BY MANUFACTURER TO COINCIDE WITH THE SUPPORT LOCATIONS SHOWN. JOISTS SHALL BE DESIGNED FOR MAXIMUM L/480 LIVE LOAD DEFLECTION. JOIST LAYOUT SHALL BE PROVIDED FOR REVIEW AND COORDINATED WITH THE ENGINEER OF RECORD. INSTALLATION SHALL BE IN ACCORDANCE WITH THE MANUFACTURER'S INSTRUCTIONS.

EXTEND HEADER AND PROVIDE CS-PF PORTAL FRAME PANEL PER FIG. R602.10.1. PROVIDE LSTA24 STRAP (OR EQUIVALENT) EACH SIDE AS SHOWN. FASTEN SHEATHING TO HEADER AND WALL FRAMING (EACH STUD) WITH 8d NAILS AT 3" o.c. AS SHOWN. SEE FIG. R602.10.1 FOR ADDITIONAL REQUIREMENTS. SEE SHEET S5 FOR DETAIL.

SEAL NOT VALID UNLESS SIGNED AND DATED LOT 27 MORGAN FARMS ONLY

STRUCTURAL DESIGN IN ACCORDANCE WITH: NORTH CAROLINA STATE RESIDENTIAL CODE 2018 EDITION IRC ENGINEER'S SEAL APPLIES TO STRUCTURAL

ENGINEERS PC.

COMPONENTS ONLY AND DOES NOT CERTIFY ARCHITECTURAL LAYOUT OR DIMENSIONAL ACCURACY. SEAL APPLIES ONLY FOR LOT NUMBER INDICATED AND SIGNED PLANS MAY NOT BE COPIED. FAILURE TO NOTIFY THE ENGINEER OF ADDITIONAL USE OF THE PLANS WILL VOID THE LIABILITY OF ROSS LINDEN



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STEPHENSON BUILDERS LOT 27 MORGAN FARMS

PROJECT NO. R211004

DESIGN BY LLR

10 NOV 2021

REVISION DATE 170704 25 AUG 17

> FIRST CEILING FRAMING

SHEET NO.

OF S5

PER SECTION R602.10.3.2, THE AMOUNT OF BRACING PROVIDED ON THE SECOND STORY EQUALS OR EXCEEDS THE AMOUNT OF BRACING FOR THE FIRST STORY BELOW, THEREFORE A SEPARATE ANALYSIS OF SECOND STORY BRACING IS NOT REQUIRED.


FRAMING NOTES


1. STRUCTURAL NOTES SHEET S5.

2. FRAMING SHALL BE #2 SPF OR #2 SYP u.n.o.


3. EXTERIOR AND BEARING HEADERS (2) 2"x10" u.n.o.

4. ■ DENOTES POINT LOAD. SEE CONSTRUCTION NOTE #4 ON S5.

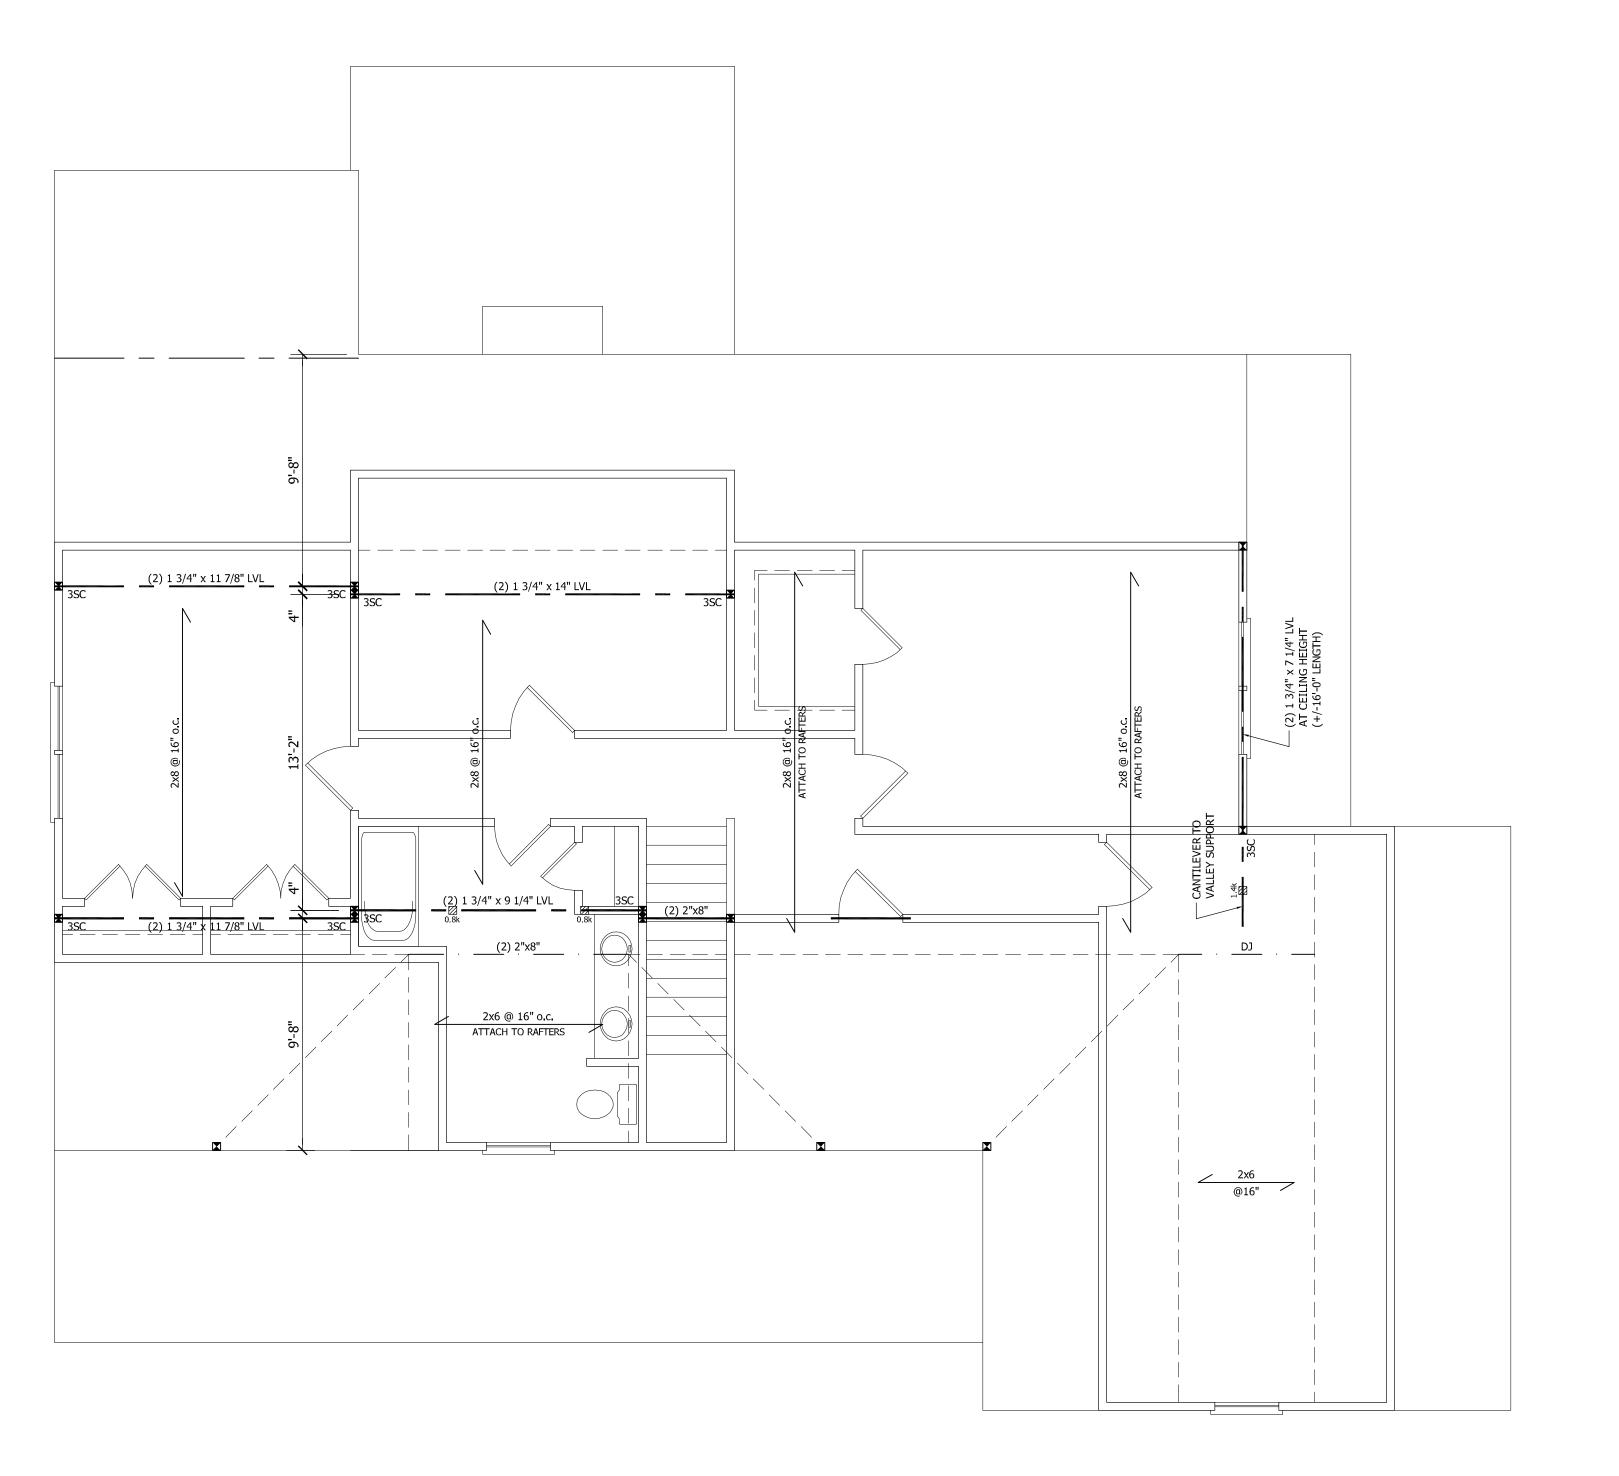

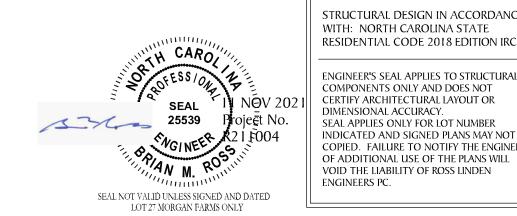

STRUCTURAL DESIGN IN ACCORDANCE WITH: NORTH CAROLINA STATE RESIDENTIAL CODE 2018 EDITION IRC ENGINEER'S SEAL APPLIES TO STRUCTURAL COMPONENTS ONLY AND DOES NOT CERTIFY ARCHITECTURAL LAYOUT OR DIMENSIONAL ACCURACY.
SEAL APPLIES ONLY FOR LOT NUMBER INDICATED AND SIGNED PLANS MAY NOT BE COPIED. FAILURE TO NOTIFY THE ENGINEER

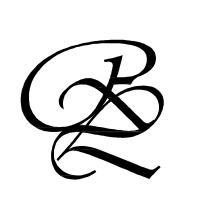

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PLAN ENGINEERING REMAINS THE PROPERTY PLAN ENGINEERING REMAINS THE PROPERTY
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STEPHENSON BUILDERS LOT 27 MORGAN FARMS

PROJECT NO. R211004


DESIGN BY LLR

10 NOV 2021 DATE REVISION 170704 25 AUG 1*7* 

SECOND CEILING FRAMING

SHEET NO.

OF S5

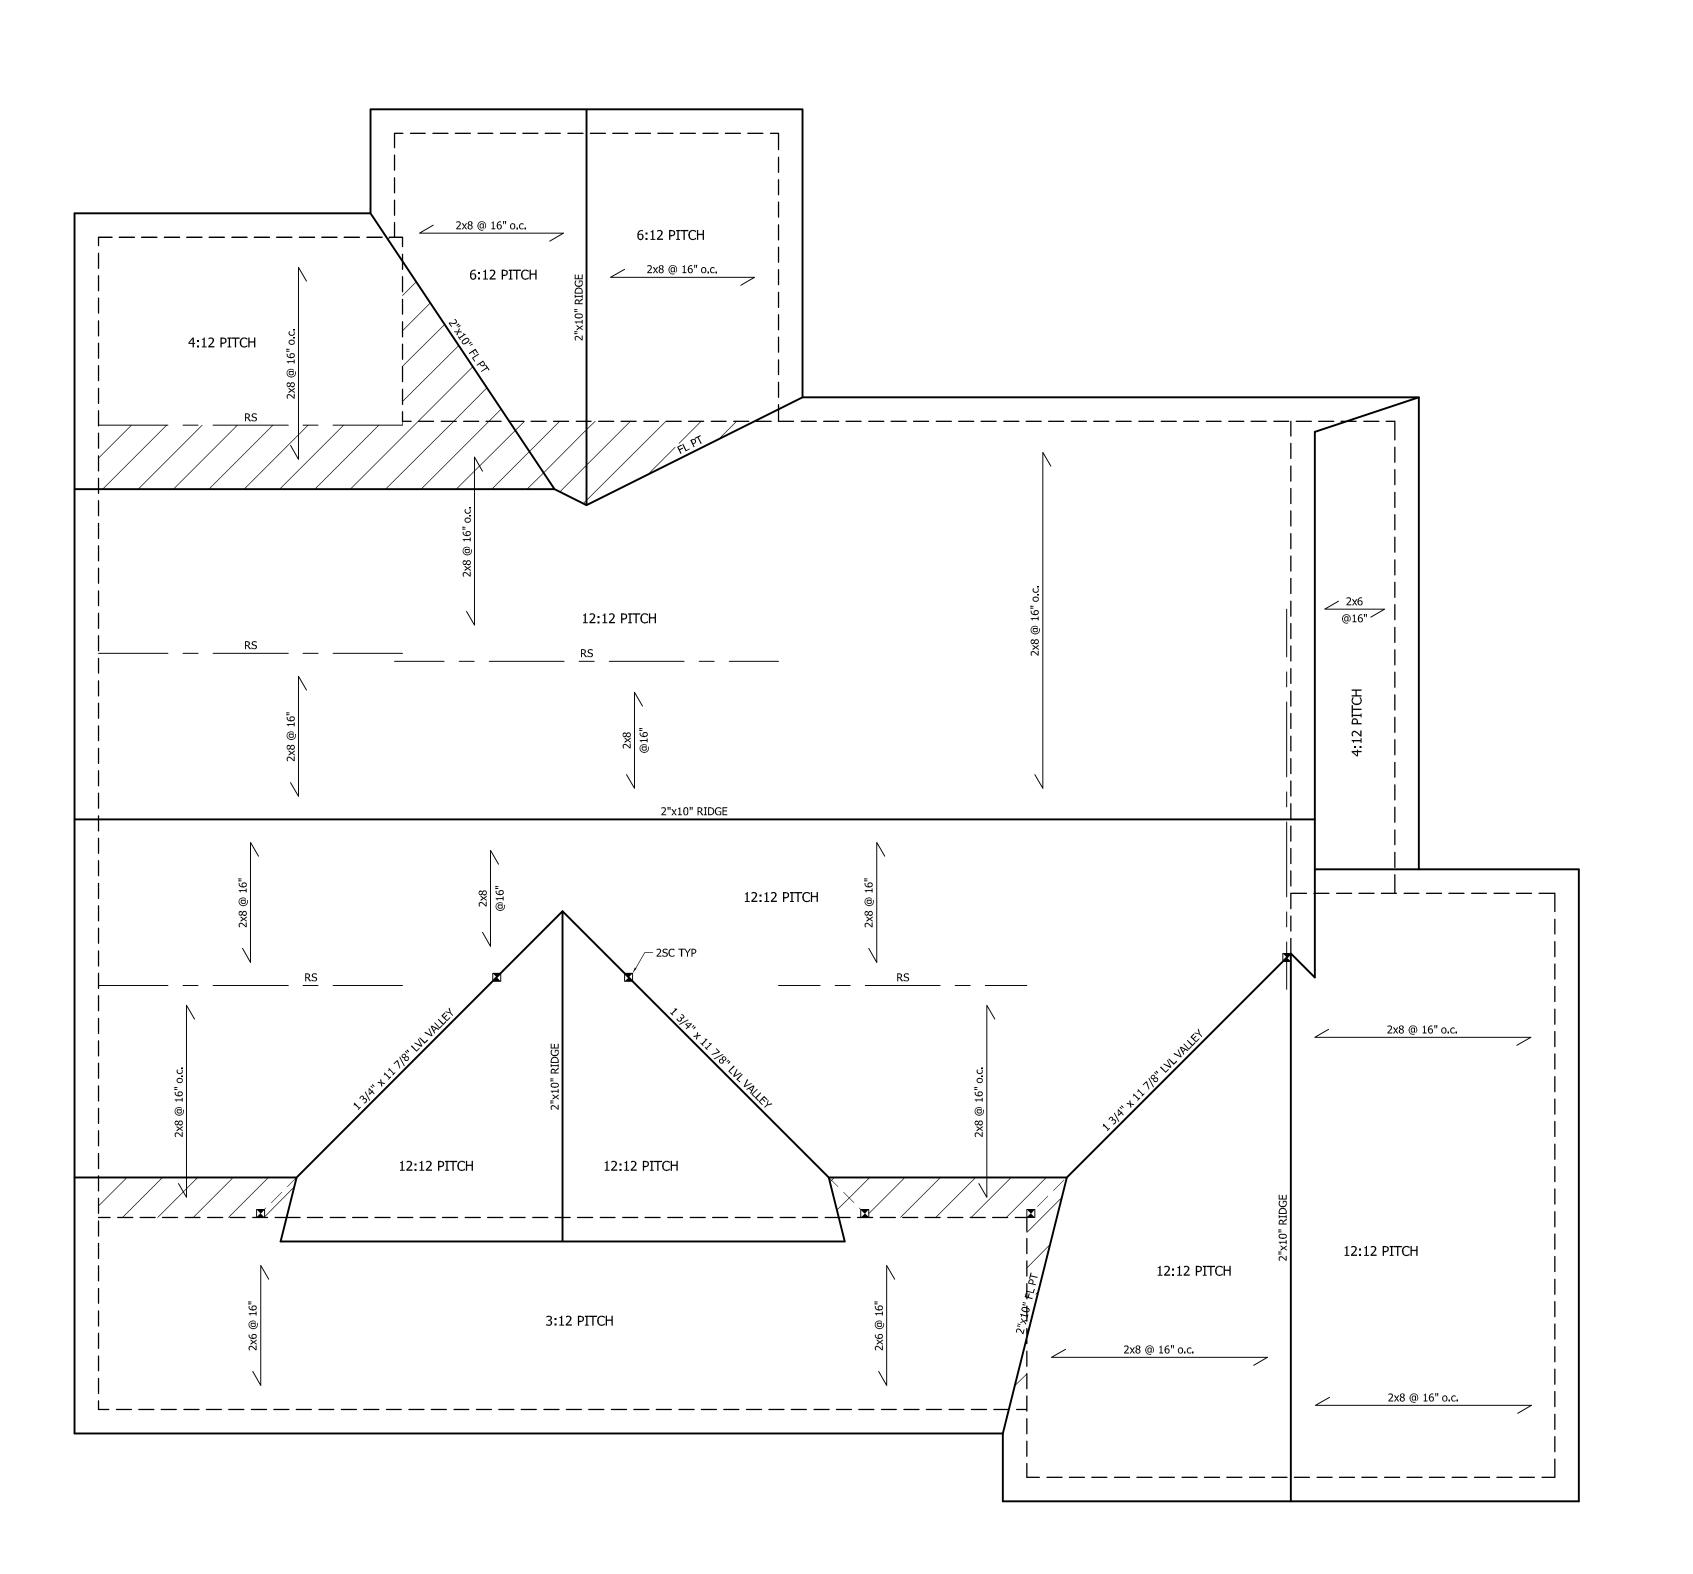

ROOF FRAMING NOTES

1. STRUCTURAL NOTES SHEET S5.

2. FRAMING SHALL BE #2 SPF OR #2 SYP u.n.o.

3. PROVIDE 2x4 COLLAR TIES AT 48" o.c. AT UPPER THIRD OF RAFTERS u.n.o. ON PLAN.

4. FUR RIDGES FOR FULL RAFTER CONTACT

5. ■ DENOTES POINT LOAD. SEE CONSTRUCTION NOTE #4 ON S5.

DENOTES OVERFRAMED AREA

PROVIDE 2x4 RAFTER TIES AT 16" o.c. AT 45° BETWEEN RAFTERS AND CEILING JOISTS. USE (4) 16d NAILS AT EACH CONNECTION. RAFTER TIES MAY BE SPACED AT 48" o.c. AT LOCATIONS WHERE NO KNEE WALLS ARE INSTALLED.

INDICATED AND SIGNED PLANS MAY NOT BE COPIED. FAILURE TO NOTIFY THE ENGINEER OF ADDITIONAL USE OF THE PLANS WILL VOID THE LIABILITY OF ROSS LINDEN ENGINEERS PC. SEAL NOT VALID UNLESS SIGNED AND DATED LOT 27 MORGAN FARMS ONLY

STRUCTURAL DESIGN IN ACCORDANCE WITH: NORTH CAROLINA STATE RESIDENTIAL CODE 2018 EDITION IRC ENGINEER'S SEAL APPLIES TO STRUCTURAL COMPONENTS ONLY AND DOES NOT CERTIFY ARCHITECTURAL LAYOUT OR DIMENSIONAL ACCURACY. SEAL APPLIES ONLY FOR LOT NUMBER

SHEET NO.

ROOF PLAN FRAMING SCALE: 1/4" = 1'-0"



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STEPHENSON BUILDERS LOT 27 MORGAN FARMS

PROJECT NO. R211004

**REVISION** 

DESIGN BY LLR


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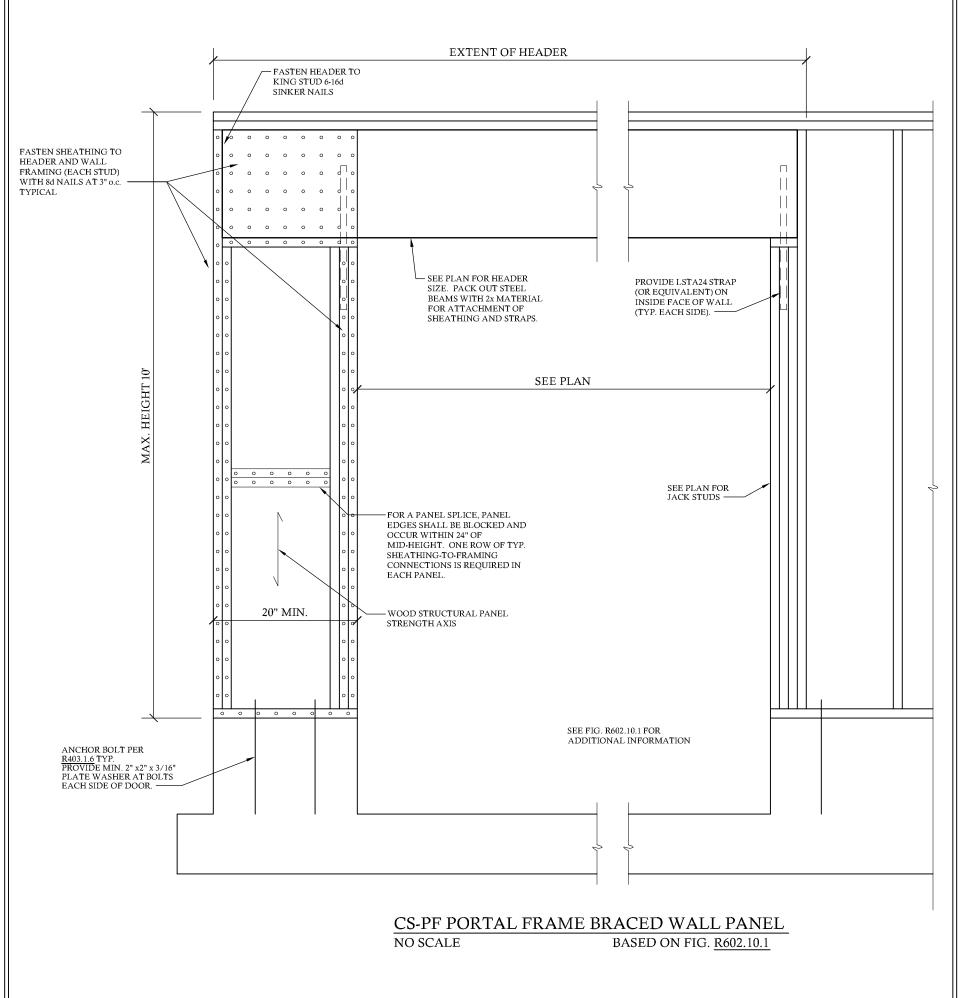
170704 25 AUG 1*7* 

DATE

**ROOF PLAN** FRAMING

OF S5



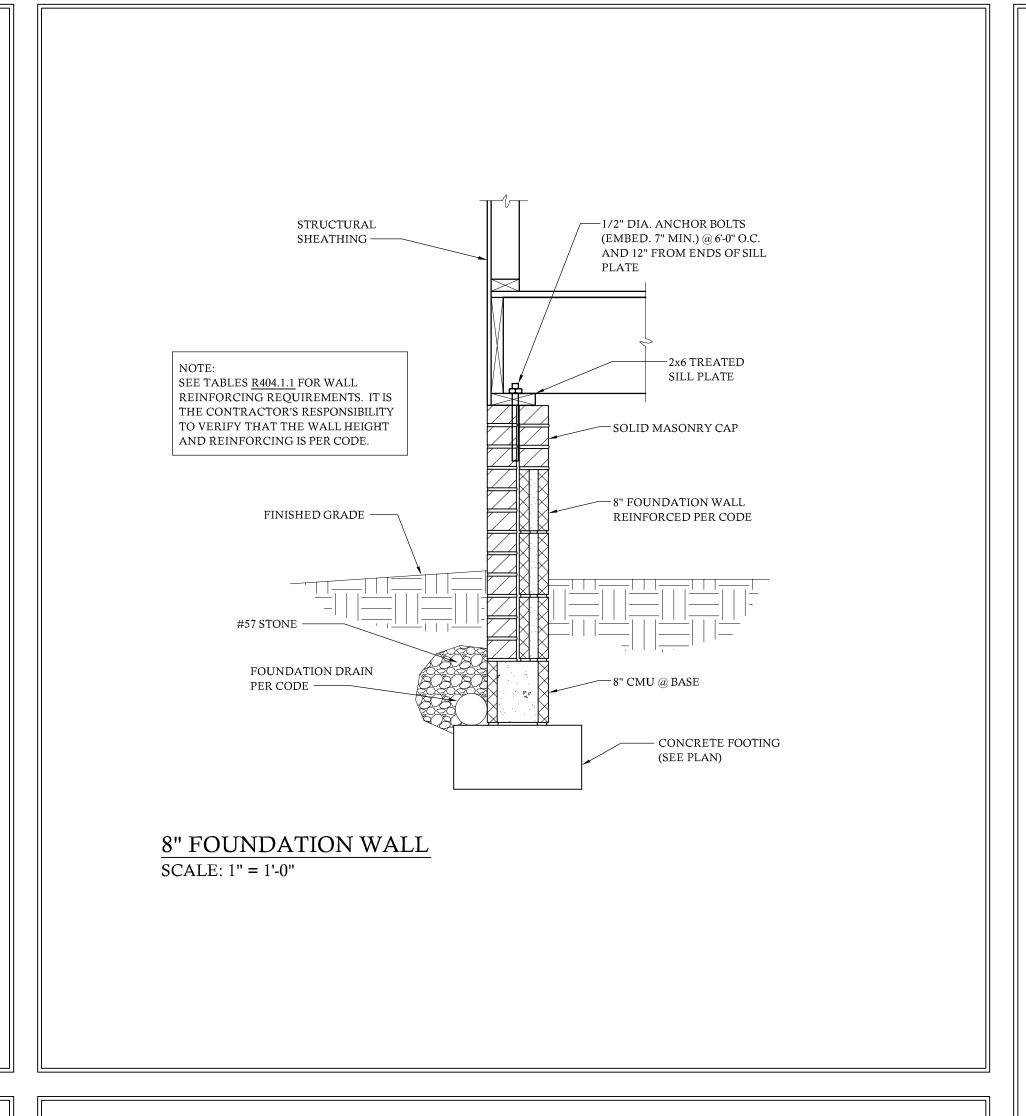

# STRUCTURAL NOTES

1. ENGINEER'S SEAL APPLIES TO STRUCTURAL COMPONENTS ONLY AND DOES NOT CERTIFY ARCHITECTURAL LAYOUT OR DIMENSIONAL ACCURACY. ROSS LINDEN ENGINEERS PC ASSUMES NO LIABILITY FOR CHANGES OR MODIFICATIONS MADE TO THESE PLANS BY OTHERS, OR FOR CONSTRUCTION METHODS, OR FOR ANY DEVIATION FROM THE PLANS.

2. ALL CONSTRUCTION, WORKMANSHIP, MATERIAL QUALITY AND SELECTION SHALL BE IN ACCORDANCE WITH THE NORTH CAROLINA STATE BUILDING CODE - RESIDENTIAL CODE 2018 EDITION FROM THE INTERNATIONAL RESIDENTIAL CODE 2015 (IRC), AND LOCAL CODES AND REGULATIONS. DIMENSIONS SHALL GOVERN OVER SCALE AND CODE SHALL GOVERN OVER DIMENSIONS.

3. CONTACT THE ENGINEER PRIOR TO CONSTRUCTION IF ANY DISCREPANCIES ARE NOTED ON THE PLANS.

4. ONLY CURRENT SEALED DRAWINGS ARE TO BE USED FOR CONSTRUCTION.

# **DESIGN LOADS** LIVE LOAD DEAD LOAD DWELLING UNITS SLEEPING ROOMS ATTICS WITH STORAGE ATTICS WITHOUT STORAGE ROOF SNOW STAIRS DECKS EXTERIOR BALCONIES PASSENGER VEHICLE GARAGES FIRE ESCAPES GUARDRAILS AND HANDRAILS

# ADDITIONAL LOADS

TABLE R301.2(4) - BASIC DESIGN WIND SPEED 115 MPH

TABLE R301.2(7) - SEISMIC DESIGN CATEGORY B

 $\underline{\text{TABLE R301.2(6)}}$  - DESIGN POSITIVE AND NEGATIVE PRESSURE FOR DOORS AND WINDOW FOR A MEAN ROOF HEIGHT OF 35 FEET OR LESS SHALL BE 25 PSF

TABLE R301.2(2) - COMPONENT AND CLADDING LOADS FOR A BUILDING LOCATED IN EXPOSURE B

ROOF VALUES BOTH POSITIVE AND NEGATIVE SHALL BE DESIGNED BASED ON ROOF PITCHES AND MEAN ROOF HEIGHT AS FOLLOWS:

2.25:12 TO 7:12 34.8 PSF 36.5 PSF 37.9 PSF 7:12 TO 12:12 21.0 PSF 22.1 PSF 22.9 PSF

WALL CLADDING SHALL BE DESIGNED FOR A 24.1 PSF POSITIVE AND NEGATIVE PRESSURE

# **MATERIALS**

1. FRAMING LUMBER SHALL BE #2 SPRUCE PINE FIR (SPF) WITH THE FOLLOWING DESIGN PROPERTIES: Fb = 875 PSI Fv = 70 PSI E = 1.4E6 PSI

2. FRAMING LUMBER EXPOSED TO WEATHER OR IN CONTACT WITH THE GROUND, CONCRETE OR MASONRY SHALL BE #2 SOUTHERN YELLOW PINE (SYP) TREATED IN ACCORDANCE WITH AWPA C22 WITH THE FOLLOWING DESIGN PROPERTIES: Fb = 1050 PSI Fv = 95 PSI E = 1.6E6 PSI

3. ENGINEERED WOOD BEAMS SHALL BE LAMINATED VENEER LUMBER (LVL) OR PARALLEL STRAND LUMBER (PSL) WITH THE FOLLOWING MINIMUM DESIGN PROPERTIES: Fb = 2600 PSI Fv = 285 PSI E = 1.9E6 PSITHE FOLLOWING PRODUCTS MEET OR EXCEED THE ABOVE SPECIFICATIONS AND MAY BE USED AT THE LOCATION

INDICATED ON THE PLANS: BROADSPAN 1.9E-2750Fb LVL BY GEORGIA PACIFIC iLEVEL TRUS JOIST 1.9E MICROLLAM LVL BY WEYERHAUSER

4. STRUCTURAL STEEL WIDE FLANGE BEAMS SHALL CONFORM TO ASTM A992 OR A572, GRADE 50. ALL OTHER STRUCTURAL STEEL SHALL CONFORM TO ASTM A36.

5. BOLTS SHALL CONFORM TO A325 MINIMUM GRADE.

6. REBAR SHALL BE DEFORMED STEEL CONFORMING TO ASTM A615 GRADE 60.

7. SEE <u>TABLE R602.3(1)</u> FOR STRUCTURAL MEMBER FASTENING

REQUIREMENTS. 8. POURED CONCRETE SHALL HAVE A MINIMUM SPECIFIED COMPRESSIVE STRENGTH OF 3000 PSI AT 28 DAYS. MATERIALS

USED TO PRODUCE CONCRETE SHALL COMPLY WITH THE

APPLICABLE STANDARDS LISTED IN ACI 318 OR ASTM C 1157. 9. CONCRETE LOCATED PER <u>TABLE R402.2</u> SHALL BE AIR ENTRAINED WITH THE TOTAL AIR CONTENT NOT LESS THAN 5 PERCENT OR MORE THAN 7 PERCENT.

10. MASONRY UNITS SHALL CONFORM TO ACI 530/ASCE 5/TMS 402 AND MORTAR SHALL COMPLY WITH ASTM C 270.

# CONSTRUCTION

1. STEEL BEAMS SHALL BE SUPPORTED AT EACH END WITH A MINIMUM BEARING LENGTH OF 3 1/2" AND FULL FLANGE WIDTH. BEAMS MUST BE ANCHORED AT EACH END WITH A MINIMUM OF FOUR 16d NAILS OR TWO 1/2" x 4" LAG SCREWS.

2. ENGINEERED WOOD BEAMS SHALL BE INSTALLED WITH ALL CONNECTIONS PER MANUFACTURER'S INSTRUCTIONS.

3. ALL BEAMS SHALL BE CONTINUOUSLY SUPPORTED LATERALLY AND SHALL BEAR FULL WIDTH ON THE SUPPORTING WALLS OR COLUMNS INDICATED WITH A MINIMUM OF THREE STUDS.

4. SOLID BLOCKING SHALL BE PROVIDED AT ALL POINT LOADS TO TRANSFER LOADS THROUGH FLOOR LEVELS. COLUMNS SHALL BE CONTINUOUS TO THE FOUNDATION OR TO OTHER STRUCTURAL ELEMENTS.

5. ENGINEERED WOOD FLOOR SYSTEMS AND ROOF TRUSS SYSTEMS SHALL BE PROVIDED FOR REVIEW AND COORDINATED WITH THE ENGINEER OF RECORD. INSTALLATION SHALL BE IN ACCORDANCE WITH THE MANUFACTURER'S INSTRUCTIONS. ROOF TRUSS DRAWINGS SHALL BE SIGNED AND SEALED BY THE MANUFACTURER AND REVIEWED BY THE ENGINEER OF RECORD PRIOR TO CONSTRUCTION.

6. WALL BRACING REQUIREMENTS SHALL BE IN ACCORDANCE WITH SECTION R602.10 OF THE NORTH CAROLINA RESIDENTIAL

A. EXTERIOR WALLS ARE ASSUMED TO BE BRACED WALL LINES. ADDITIONAL INTERIOR WALLS MAY ALSO BE USED AS BRACED WALL LINES WHERE APPLICABLE. SEE PLAN FOR LOCATIONS.

B. THE EXTERIOR OF THE STRUCTURE SHALL BE CONTINUOUSLY SHEATHED WITH 1/2" WOOD STRUCTURAL SHEATHING (PLYWOOD OR OSB) PER CODE SECTION <u>R602.10.3</u>. EXTERIOR BRACED WALL LINES ARE ASSUMED TO BE BRACED WITH CS-WSP (WOOD STRUCTURAL PANEL) BRACED WALL PANELS. ALTERNATE BRACING METHODS, IF USED, MUST BE INSTALLED IN ACCORDANCE WITH THE APPLICABLE SECTIONS OF THE CODE AND MUST BE REVIEWED BY THE ENGINEER PRIOR TO CONSTRUCTION.

C. INTERIOR BRACED WALL LINES ARE CONSIDERED TO BE BRACED WITH 1/2" GB (GYPSUM BOARD) BRACED WALL PANELS. SEE TABLE R602.10.2 FOR CONNECTION CRITERIA. D. SEE PLANS FOR SPECIAL WALL BRACING REQUIREMENTS FOR GARAGE WALLS AND OTHER WALLS WITH MULTIPLE

OR LARGE OPENINGS.

7. STEEL FLITCH BEAMS SHALL BE FASTENED TOGETHER WITH 1/2" DIAMETER BOLTS WITH WASHERS PLACED UNDER THE THREADED END OF THE BOLT. BOLTS SHALL BE SPACED AT MAXIMUM 24" o.c. STAGGERED TOP AND BOTTOM OF BEAM WITH A MINIMUM 2" EDGE DISTANCE. TWO BOLTS SHALL BE LOCATED AT 6" FROM EACH END OF FLITCH BEAM.

8. BRICK LINTELS SHALL BE 3  $1/2 \times 3 1/2 \times 1/4$  STEEL ANGLE FOR UP TO 6'-0" MAXIMUM SPAN AND 6 x 4 x 5/16 FOR SPANS GREATER THAN 6'-0".

9. BRICK LINTELS AT SLOPED AREAS SHALL BE 4 x 3 1/2 x 1/4 STEEL ANGLE WITH 16d NAILS IN 3/16" HOLES IN 4" ANGLE LEG AT 12" o.c. TO TRIPLE RAFTER. WHEN THE SLOPE EXCEEDS 4:12 A MINIMUM OF 3 x 3 x 1/4 PLATES SHALL BE WELDED AT 24" o.c. ALONG THE STEEL ANGLE.

# **FOUNDATION**

1. MINIMUM ALLOWABLE SOIL BEARING CAPACITY IS ASSUMED TO BE 2000 PSF. IT IS THE CONTRACTOR'S RESPONSIBILITY TO VERIFY SOIL BEARING CAPACITY.

2. CONCRETE AND MASONRY FOUNDATION WALLS SHALL BE SELECTED AND CONSTRUCTED IN ACCORDANCE WITH THE PROVISIONS OF SECTION R404 OR IN ACCORDANCE WITH ACI 318, NCMA TR68-A, OR ACI 530/ASCE 5/TMS 402.

3. MASONRY AND POURED CONCRETE WALL REINFORCEMENT SHALL BE IN ACCORDANCE WITH TABLES R404.1.1 (1 THROUGH 4) OF THE NORTH CAROLINA RESIDENTIAL CODE.

A. PER R404.1.3, TABLES ASSUME THAT WALLS HAVE PERMANENT LATERAL SUPPORT AT THE TOP AND BOTTOM. B. WALL REINFORCING SHALL BE PLACED ACCORDING TO FOOTNOTE (c) OF THE TABLES (REINFORCING IS NOT CENTERED IN WALL).

C. FOUNDATION DRAINS ARE ASSUMED AT ALL WALLS PER


4. WOOD SILL PLATES SHALL BE ANCHORED TO THE FOUNDATION WITH 1/2" ANCHOR BOLTS WITH MINIMUM 7" EMBEDMENT SPACED A MAXIMUM OF 6'-0" o.c. AND WITHIN 12" FROM THE ENDS OF EACH PLATE SECTION.

5. THE UNSUPPORTED HEIGHT OF SOLID MASONRY PIERS SHALL NOT EXCEED TEN TIMES THEIR LEAST DIMENSION. UNFILLED HOLLOW PIERS MAY BE USED IF THE UNSUPPORTED HEIGHT IS NOT MORE THAN FOUR TIMES THEIR LEAST DIMENSION.

6. CENTERS OF PIERS SHALL BEAR IN THE MIDDLE THIRD OF THE FOOTINGS, AND GIRDERS SHALL CENTER IN THE MIDDLE THIRD

7. ALL FOOTINGS SHALL HAVE MINIMUM 2" PROJECTION ON EACH SIDE OF FOUNDATION WALLS.

ABBREVIATIONS	
00110	0.011.00
CONC	CONCRETE
CONT	CONTINUOUS
DBL	DOUBLE
DJ	DOUBLE JOIST
DSP	DOUBLE STUD POCKET
EA	EACH
FL PT	FLAT PLATE
FTG	FOOTING
HGR	HANGER
LVL	LAMINATED VENEER LUMBER
NTS	NOT TO SCALE
OC	ON CENTER
PT	PRESSURE TREATED
RS	RAFTER SUPPORT
SC	STUD COLUMN
SP	STUD POCKET
TJ	TRIPLE JOIST
TYP	TYPICAL
UNO	UNLESS NOTED OTHERWISE
XJ	EXTRA JOIST

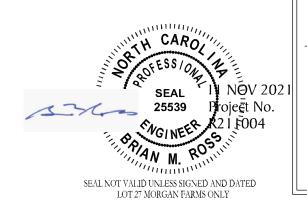



STRUCTURAL DESIGN IN ACCORDANCE WITH: NORTH CAROLINA STATE RESIDENTIAL CODE 2018 EDITION IRC

ENGINEER'S SEAL APPLIES TO STRUCTURAL COMPONENTS ONLY AND DOES NOT CERTIFY ARCHITECTURAL LAYOUT OR DIMENSIONAL ACCURACY. SEAL APPLIES ONLY FOR LOT NUMBER INDICATED AND SIGNED PLANS MAY NOT BE COPIED. FAILURE TO NOTIFY THE ENGINEER OF ADDITIONAL USE OF THE PLANS WILL VOID THE LIABILITY OF ROSS LINDEN ENGINEERS PC.



709 W. JONES STREET RALEIGH, NC 27603 TEL 919.832.5680 FAX 919.832.5675 WWW.ROSSLINDEN.COM

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> BUILDERS N FARMS PHENSON B 27 MORGAN F 7

PROJECT NO. R211004

DESIGN BY LLR

10 NOV 2021

170704 25 AUG 17

DATE

STRUCTURAL **NOTES & DETAILS** 

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