JORDAN

JORDAN REVISION LIST - STRUCTURAL:

- 1.) CODE UPDATE TO SCRC 2018 (1-20)
- 2.) CHANGE 2X6 EXTERIOR WALLS TO 2X4 EXTERIOR WALLS. (3-5-20)
- 3.) ADDED BASEMENT PLAN WHICH EXTENDS GARAGE FRONT 2'-0". (5-1-20)



JORDAN REVISION LIST - ARCHITECTURAL:

1.) LIPDATED PLANS: 7'40' HDR HGT. ADDED 2 HOSE BIBB LOC'NS, CHANGE MASTERS TO OWNERS, CHANGE


SOFFITS TO C.O., CHANGE MASTERS BATH TO OWNER'S BATH 1, CHANGED POWDER TO PDR 1, AND CHANGED BATH TO BATH 2, (114-19)


- 2,) ADDED ROOF VENT CALCULATIONS FOR ELEV. A AND B. (122-19)
- 3.) UPDATED CUTSHEETS FOR THE GARAGE RIGHT. (12-13-19)
- 4.) CHANGED FIREPLACE FROM STANDARD TO OPTIONAL. (5-1-20)
- 5.) REMOVE GLASS INSERTS FROM GARAGE WINDOWS AND REMOVE METAL ACCESSORIES.(5-1-20)
- 6.) UPDATED CUTSHEETS TO MEET H&H STANDARDS, (5-1-20)
- 7.) ADDED OPTIONAL GLASS INSERTS TO TOP WINDOWS ONLY TO GARAGE DOORS. (5-1-20)
- 8.) CHANGED THE CORNERBOARDS FROM 6" TO 4", (5-1-20)
- 9.) REMOVED OPTIONAL KITCHEN CAN AND REPLACED WITH FLUORSCENT LIGHT IN THE KITCHEN. (5-1-20)
- 10.) CHANGE LOCATION OF THE HOSE BIBBS. (5-1-20)
- 11.) ADDED OPTIONAL GAS LINE NOTE AT PATIO. (5-1-20)
- 12.) CHANGED REFRIGERATOR, WASHER, AND DRYER TO OPTIONAL COMPONENTS. (5-1-20)
- 13.) CHANGE COFFERED CEILING IN DINING TO OPTIONAL WITH DETAIL, (5-1-20)
- 14.) ADDED WEATHERING STRIPPING AT 2-0 X 4-0 SOLID DOOR. (5-1-20)
- 15.) ADDED NOTE TO REMOVE (1)-3-0 5-0 WINDOW FOR BEDROOM #5 OPTION. (5-1-20)
- 16.) REMOVED GRIDS FROM SIDE AND REAR WINDOWS. (5-1-20)
- 17.) CHANGED 3-0 5-0 WINDOW IN LOFT TO STANDARD. (5-1-20)
- 18.) UPDATED STONE HATCH ON ELEVATIONS. (5-1-20)
- 19.) REMOVED ALL TV OUTLETS, PHONE OUTLETS, AND ELECTRICAL OUTLETS EXCEPT FLOOR OUTLETS, (5-1-20)
- 20,) ADDED CO2 DETECTORS PER LOCATE CODE. (5-1-20)
- 21.) CHANGED CEILING FANS TO OPTIONAL AND CHANGE THE LIGHTS TO PRE-WIRE. (5-1-20)
- 22,) ADDED CRICKETS TO FRONT ELEVATIONS. (5-1-20)
- 23.) UPDATED THE ELEVATION COACH LIGHTS TO MATCH THE ELECTRICAL PLANS. (5-1-20)
- 24.) CREATED ADDITIONAL SHEETS FOR FIRST FLOOR AND SECOND FLOOR OPTIONS (A4.1, A5.1, A6.1, A7.1, E3, AND E4) AND REMOVED OPTIONS FROM BASE SHEETS. (5-1-20)
- 25,) ADDED DIMENSION FOR WATER TABLE TO FINISH FLOOR ON ELEVATION, (5-1-20)
- 26.) ADDED INSULATION DETAIL TO FIRST AND SECOND FLOOR SHEETS. (5-1-20)
- 27.) ADDED OPTIONAL (3) RECESS LIGHTING AND SWITCHES IN FAMILY ROOM, (5-1-20)
- 28.) ADDED SHEET 7.0 FOR FLOOR PLAN EXTERIOR SURFACES LAYOUTS. (5-1-20)
- 28.) CREATED OWNER'S BATH 2 AND OWNER'S BATH 3, (5-1-20)
- 28.) ADDED SHOWER DETAIL FOR OPTIONAL OWNER'S BATH 3. (5-1-20)
- 29,) UPDATED CUTSHEETS, (5-1-20)
- 30.) CHANGED OWNER'S BATH #3 WINDOW FROM 2-0 2-0 WINDOW TO 2-0 4-0 TEMP. (5-1-20)
- 31.) ADDED PATIO W/ EXTENDED PATIO OPTION. (5-1-20)
- 32.) ADDED OPTIONAL BASEMENT PLAN. (5-1-20)
- 33.) ADDED CHANGES TO OPTIONS WHEN BASEMENT OPTION SELECTED. (5-1-20)
- 34.) REVISED SHUTTERS ON ELEVATIONS B TO BE B&B (5-1-20)
- 35.) REMOVED HARDWARE FROM SHUTTERS ON ELEVATION C (5-1-20)
- 36.) REMOVED LIGHT OVER KITCHEN SINK (7-8-20)
- 37.) REMOVED NOTE "KEYLESS" FROM GARAGE CHANGED TO STANDARD CEILING MOUNTED LIGHT (7-8-20)
- 38.) CHANGED STANDARD LIGHT IN KITCHEN FROM 2-BULB FLUORESCENT TO 3 BULB CEILING MOUNT (7-8-20)
- 39.) CHANGED SWING OF SERVICE DOOR IN GARAGE TO OUT SWING (SEE SHEET A6.1) (7-8-20)
- 40.) REMOVED LIGHT IN SECONDARY BATH OVER TUB/SHOWER COMBO (7-8-20)
- 41.) REMOVED "RECESSED ENTERTAINMENT BOX" OVER FIREPLACE (7-8-20)
 42.) CHANGED WINDOW TO OWNER'S BATH 1 TO 4'0"x1'0" TRANSOM WINDOW (7-8-20)
- 43.) ADDED GABLE PEDIMENT DETAIL TO B ELEVATIONS

| 世 |HOMES

ENGINEERED BY: REVIEWED BY:

CS

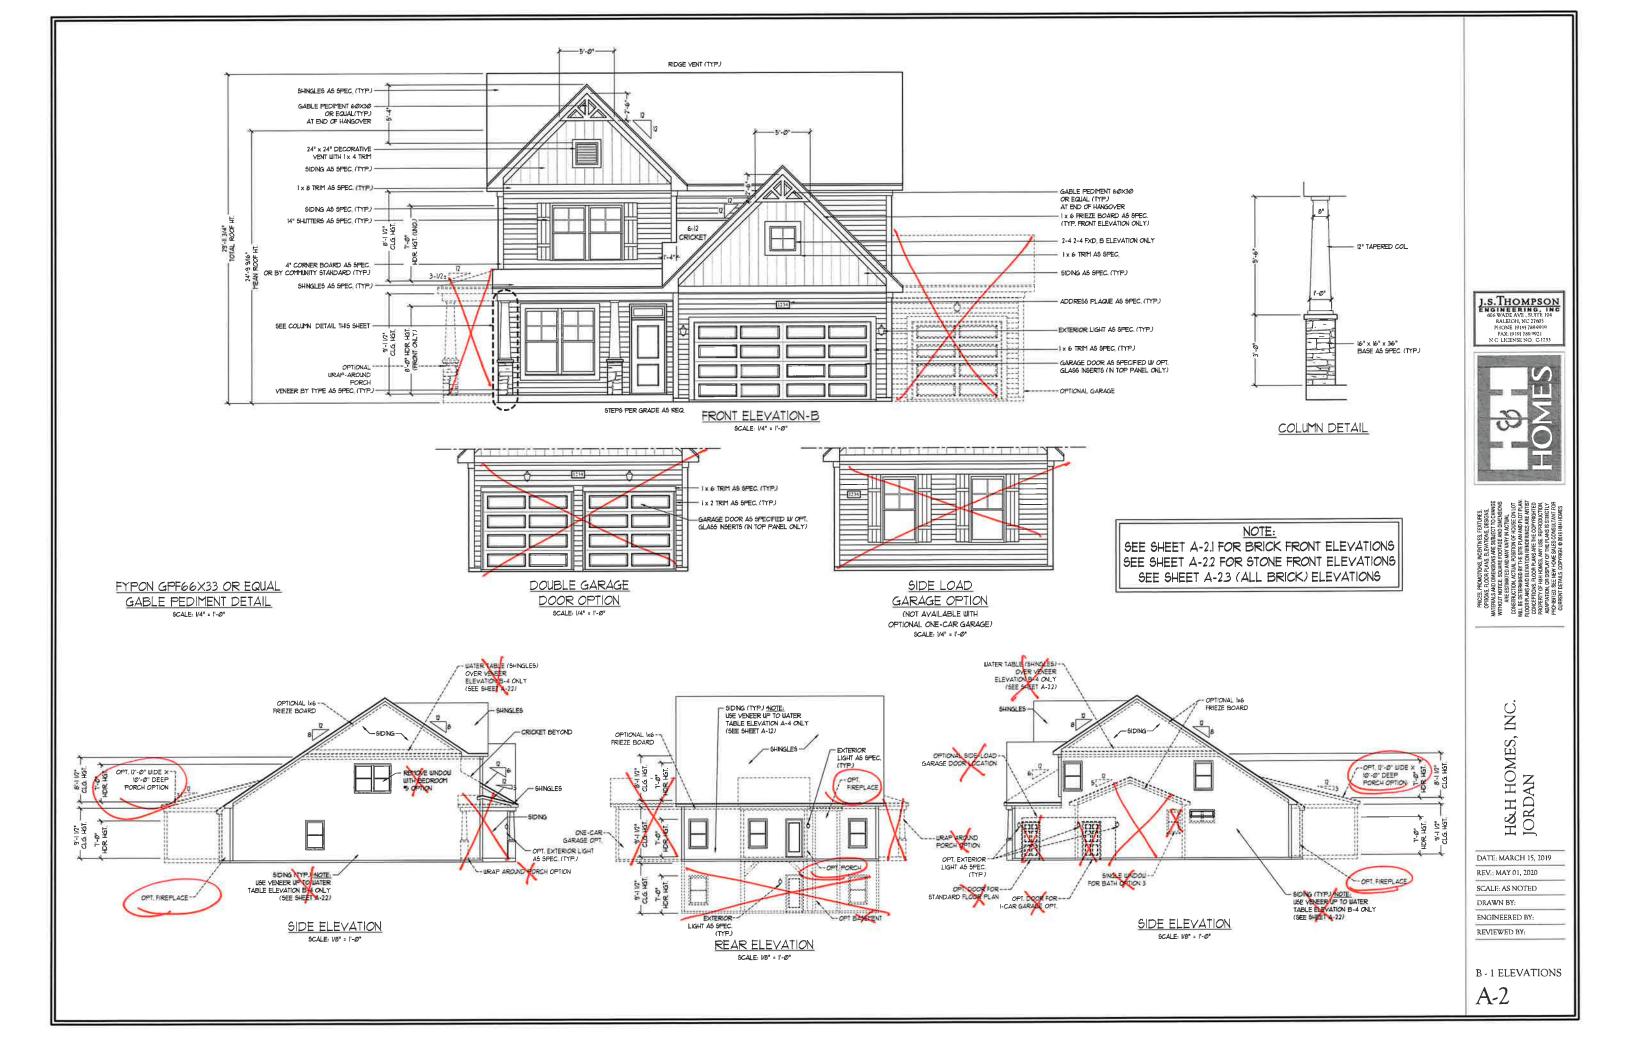

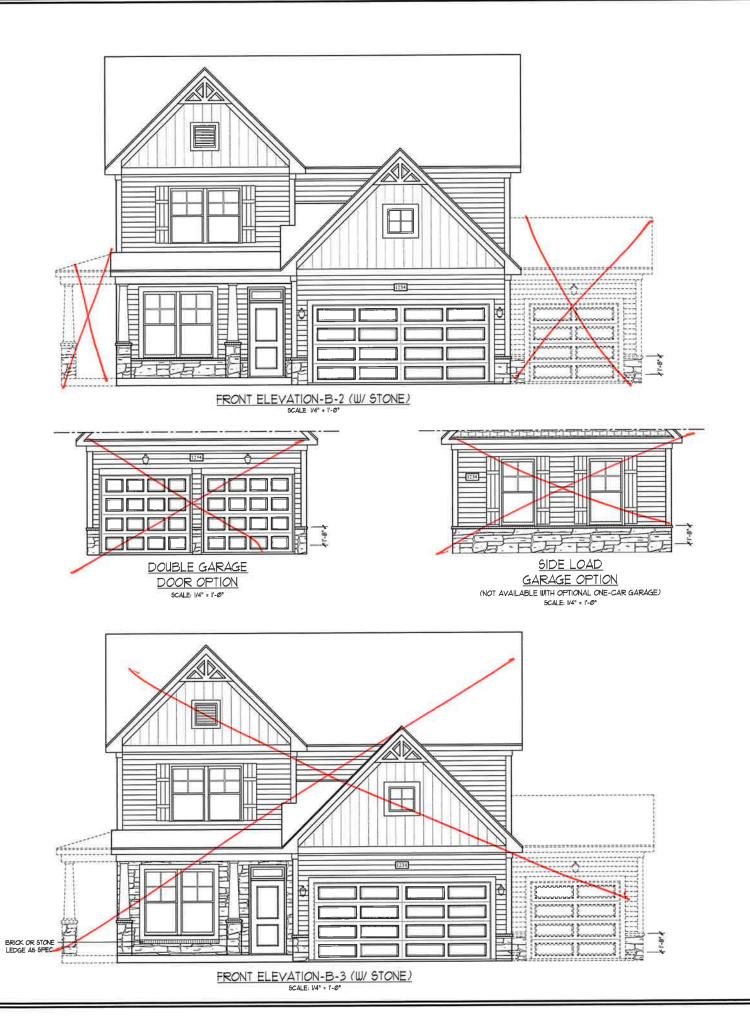

J.S.THOMPSON ENGINEERING, INC 606 WADE AVE, SUITE 104 RALEIGH, NC 27605 PHONE (919) 789-9019 FAX, (919) 789-9021



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H&H HOMES, INC. JORDAN


DATE: MARCH 15, 2019
REV.: MAY 01, 2020
SCALE: AS NOTED

DRAWN BY: ENGINEERED BY:

REVIEWED BY:

B - 2 & B - 3 ELEVATIONS WITH STONE

A-2.1

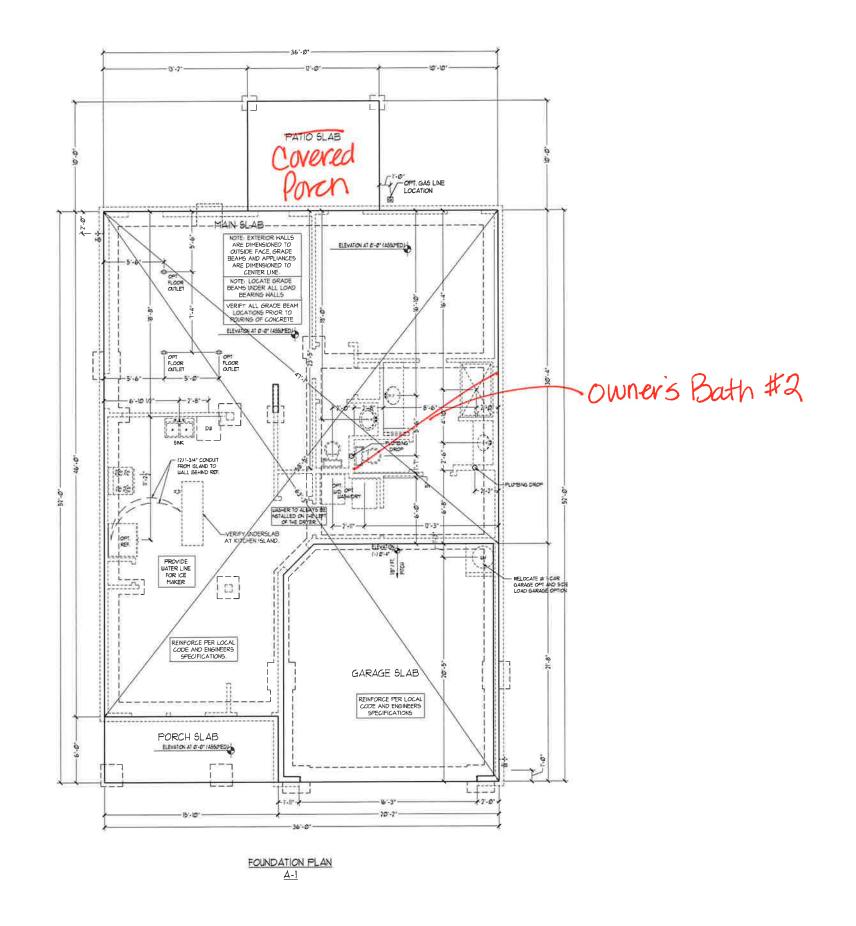

1.S.THOMPSON ENGINEERING, INC 606 WADE AVE, SUITE 104 RALEIGHI, NC 27605 PHONE (010) 780-9021 FAX (010) 780-9021 NC LICENSE NO. G1733



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H&H HOMES, INC. JORDAN

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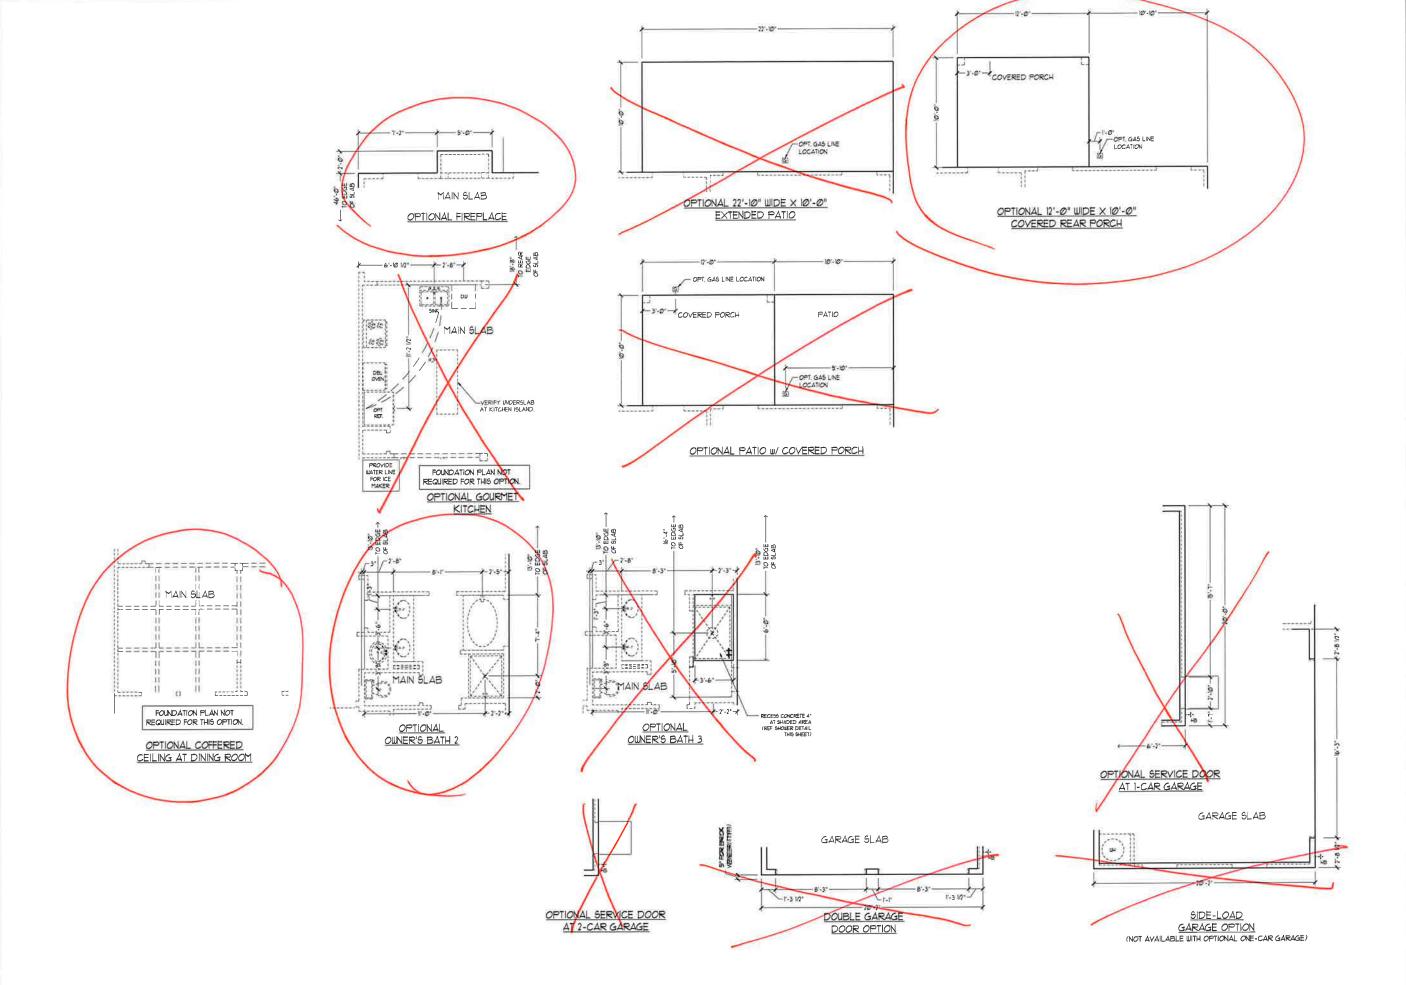
SCALF: 1/4"=1'0" DRAWN BY:

ENGINEERED BY:

REVIEWED BY:

SLAB INTERFACE PLAN

A-4



J.S.THOMPSON
ENGINEERING, INC
606 WADE AVE, SUITE 104
RALEIGH, N.º 27605
PILONE (191) 780-901
FAX. (191) 780-902)
N.C. LICENSE NG. C. 1733




H&H HOMES, INC. JORDAN

DATE: MARCH 15, 2019
REV.: MAY 01, 2020
SCALE: 1/4"=1'0"
DRAWN BY:

ENGINEERED BY:

SLAB INTERFACE OPTIONS

A-4.1

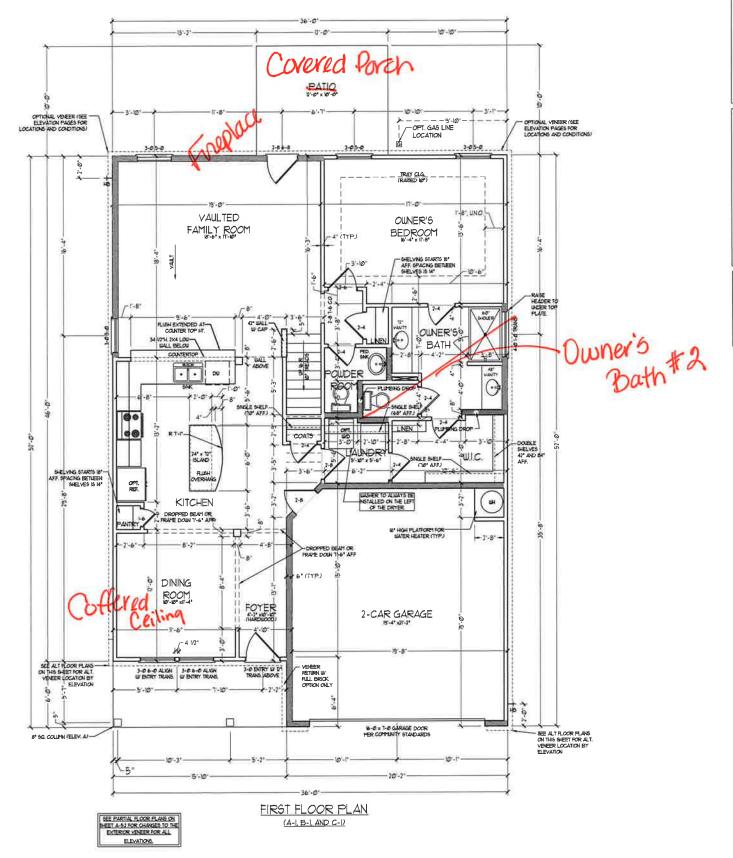

SQUARE FOOTAGE

Int FLOOR OPTIONS OPT, FIREPLACE:

2nd FLOOR OPTIONS OPT. WINDOW BOX AT BEDROOM 2: 9 6Q FT.

10 50 FT.

14 5Q FT.

UNBEATED OPTIONS
OPT. BASEMENT:
OPT I-CAR GARAGE:
OPT. REAR COVERED PORCH:
OPT (2"-0" X (0"-10" PATIO: 1270/ 602 FT. 240/ 602 FT. 120/ 602 FT. 100/ 502 FT.

SQUARE FOOTAGE (IN FULL BRICK)

INTELOOR: INTELOOR: TOTAL: GARAGE: FRONT PORCH: STD. REAR PATIO: IN FLOOR OPTIONS OPT. HREPLACE:

2rd FLOOR OPTIONS
UNIDOU BOX AT BEDROOM 2 (ELEV. C ONLY). 9 SQ. FT.

UNEATED OPTIONS
OPT. BASEMENT:
OPT. I-CAR GARAGE:
OPT. REAR COVERED PORCH:
OPT 12'-0" X 10"-10" PATIO:

WOTE, ALL EXTENSIVE WALLS AND ATTIC WALLS ARE TO BE $7 \times 4 \times 80^\circ$ CC (DIAC). ALL INTERCRE LOAD BEARNS WALLS ARE TO BE $3 \times 4 \times 80^\circ$ CC (DIAC) AND NAH-LOAD BEARNS WITEROOF WALLS ARE TO BE $2 \times 4 \times 24^\circ$ CC (DIAC).

24 BALL SHADED BALLS ARE TO BE 2 x 6 * 6*
OC. (LOAD BEARNS) OR 2 x 6 * 24* OC.
(NON-LOAD BEARNS) REGARDLESS OF
EXTEROR BALL CONDITION J.S.THOMPSON ENGINEERING INC 606 WADE AVE., SUITE 104 RAIEIGH, NC 27605 PHONE (0/10) 7880-901 FAX, 10/10) 7880-901 N.C. LICENSE NO. C1733



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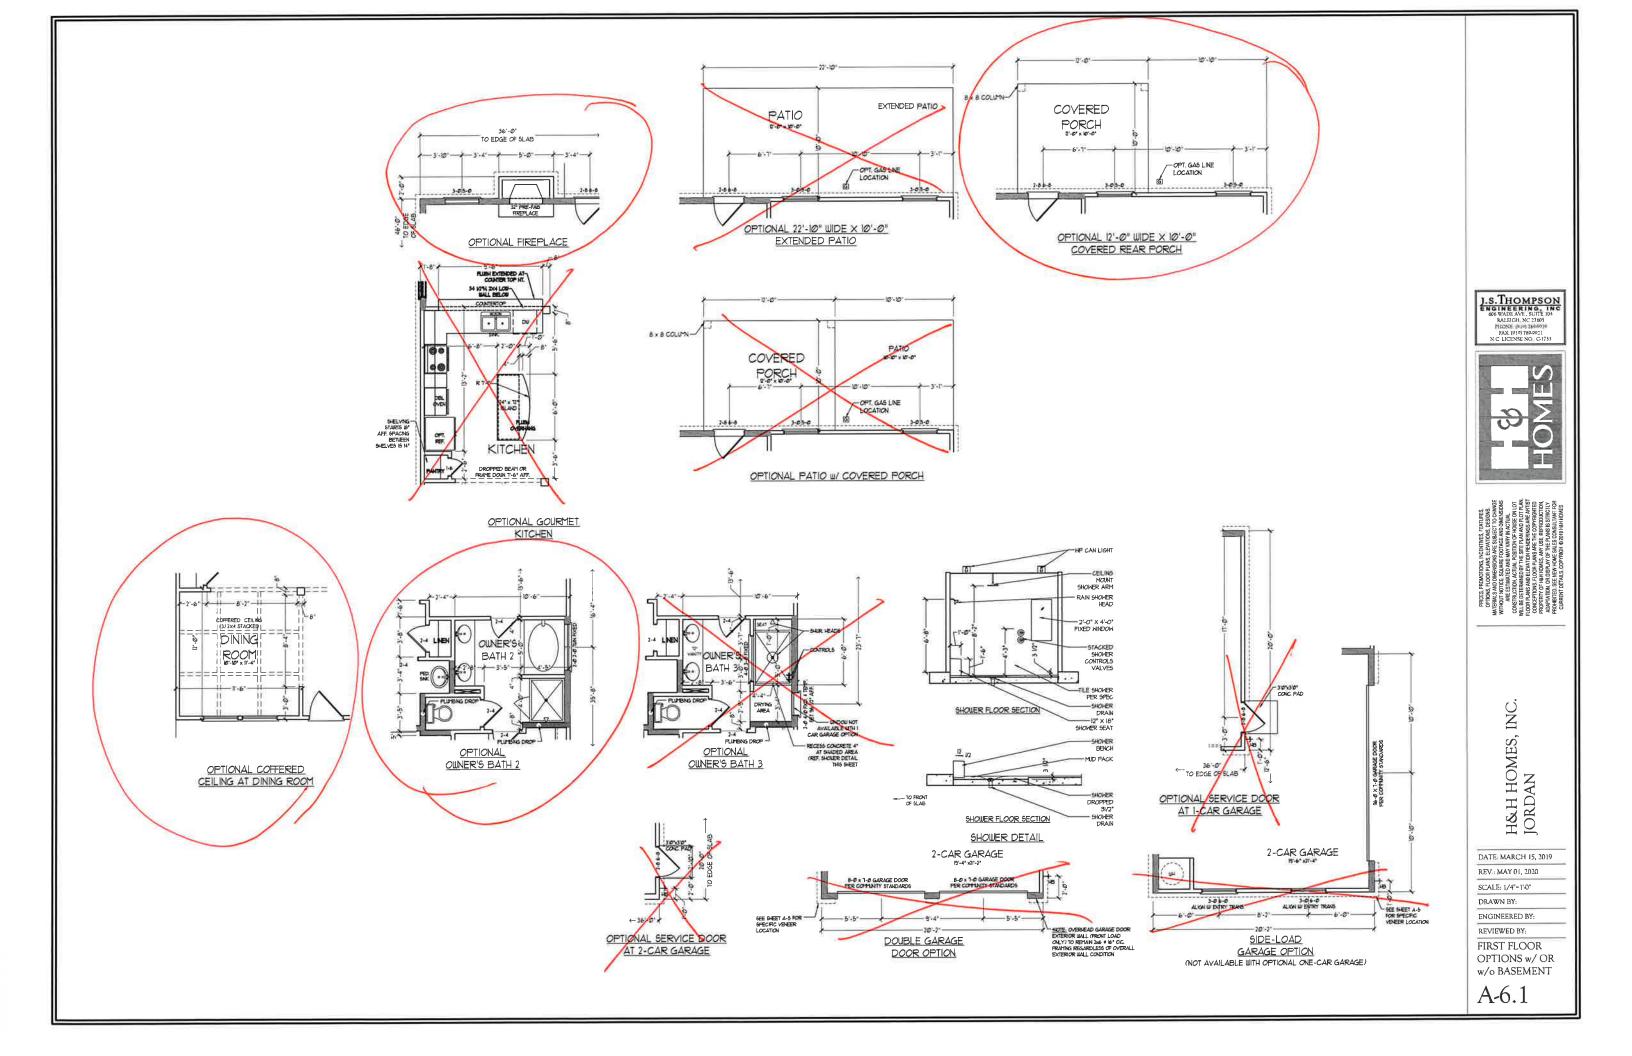
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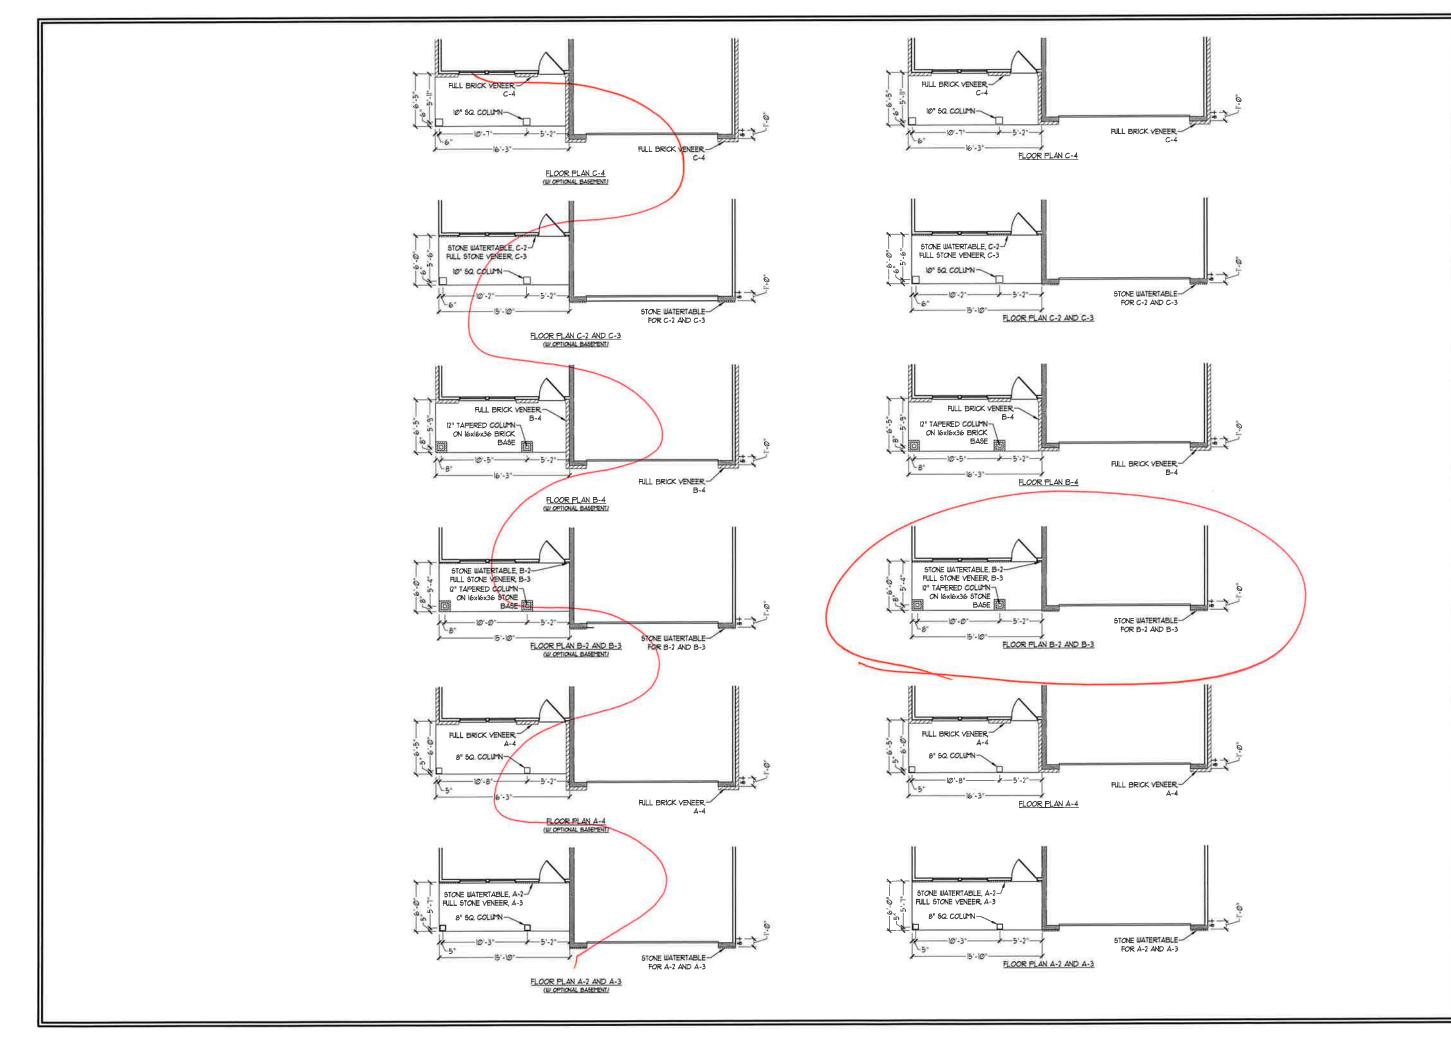
DRAWN BY: ENGINEERED BY:

REVIEWED BY:

FIRST FLOOR PLAN

A-6





J.S. THOMPSON ENGINEERING, INC 606 WADE AVE, SUITE 104 RALEIGH, NC 72605 PHONE (191) 78499019 FAX, (191) 7849921 N.C. LICENSE NO. C1733



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H&H HOMES, INC. JORDAN

DATE: MARCH 15, 2019

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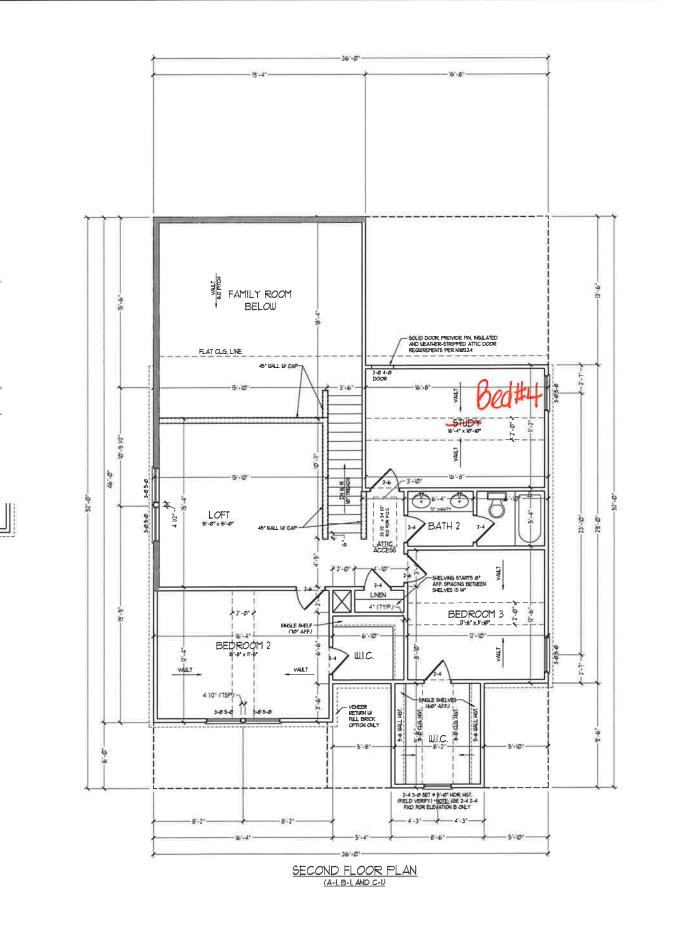
FIRST FLOOR

PARTIAL PLANS

W/ & W/O

BASEMENT

A-6.3



2 x 6 FLOOR JOISTS-

2 x 8 BOX DOWN-FOR EXTERIOR TRIM

> WINDOW BOX DETAIL (ELEVATION C ONLY) SCALE: 1/2" - 1/4"

OPTIONAL WINDOW BOX AT BEDROOM 2 (ELEVATION C ONLY) 1.S.THOMPSON ENGINEERING, INC 606 WADE AVE. SUITE 104 RALEIGH, NC. 27465 PHONE (010) 780-0010 FAX. (070) 780-0021 N.C. LICENSE NO. C.1733



ENGAGE TO THE PARK TH

26 HALL

* CHADED MALLS ARE TO BE 2 x 6 * 16*
OC. (LOAD BEARNIG) OR 2 x 6 * 24* OC.
(NON-LOAD BEARNIG) REGARDLESS OF
EXTERIOR MALL CONDITION

PROVIDE MINIMUM INSULATION IN CEILINGS AND WALLS PER SECTION N 1102,1

SEE PARTIAL FLOOR PLANS ON SHEET A-62 FOR CHANGES TO THE EXTENSIVE YEARTH FOR ALL ELEVATIONS. WITHOUT WOTCE SCHAREL COTTORS AND WITHOUT WOTCE SCHARE COTTORS AND UNITED MAIN WAY WARY HANG! CONSTRUCTION ACTIVAL COSTING OF HOUSE OF EVEN WITH SET EVAN AND ELECANTON READERNASS OF THE SOFT EVAN AND CHOOSE PLANS AND ELECANTON MER THROUGH CONSTRUCTION AND CHOOSE OF THE COSTING OF THE COSTING OF THAN AND CHOOSE OF THAN AND CHOOSE OF THE COSTING OF T

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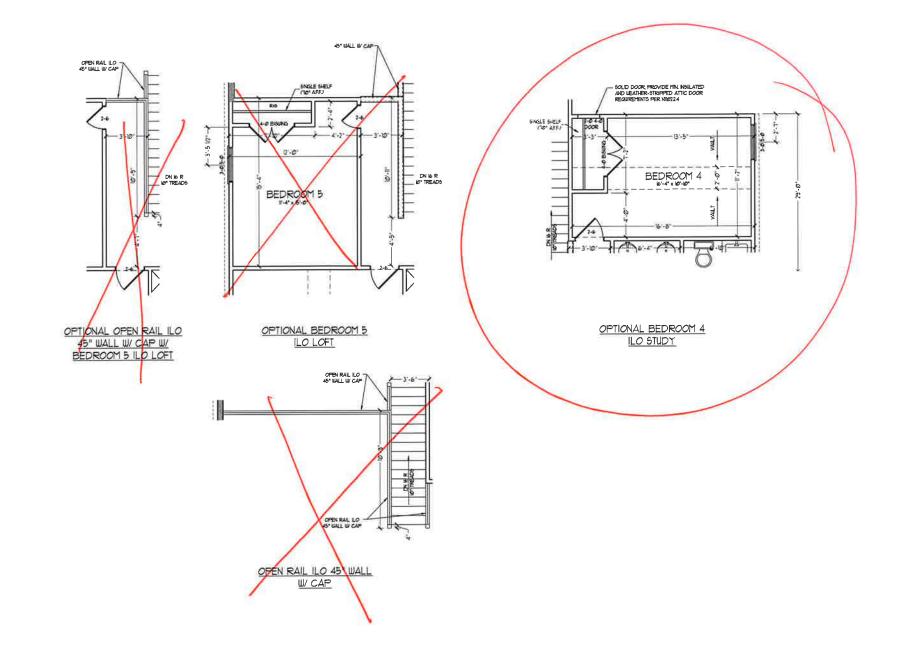
SCALE: 1/4"-1'-0" DRAWN BY:

DRAWN BY: ENGINEERED BY:

REVIEWED BY:

SECOND FLOOR PLAN

A-7



J.S.THOMPSON
ENGINEERING, INC
606 WADE AVE, SUITE 104
RALEIGH, NC 27605
PHONE [010] 789-90-10
FAX (010) 789-90-21
NC LICENSE NO. CLI33



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H&H HOMES, INC. JORDAN

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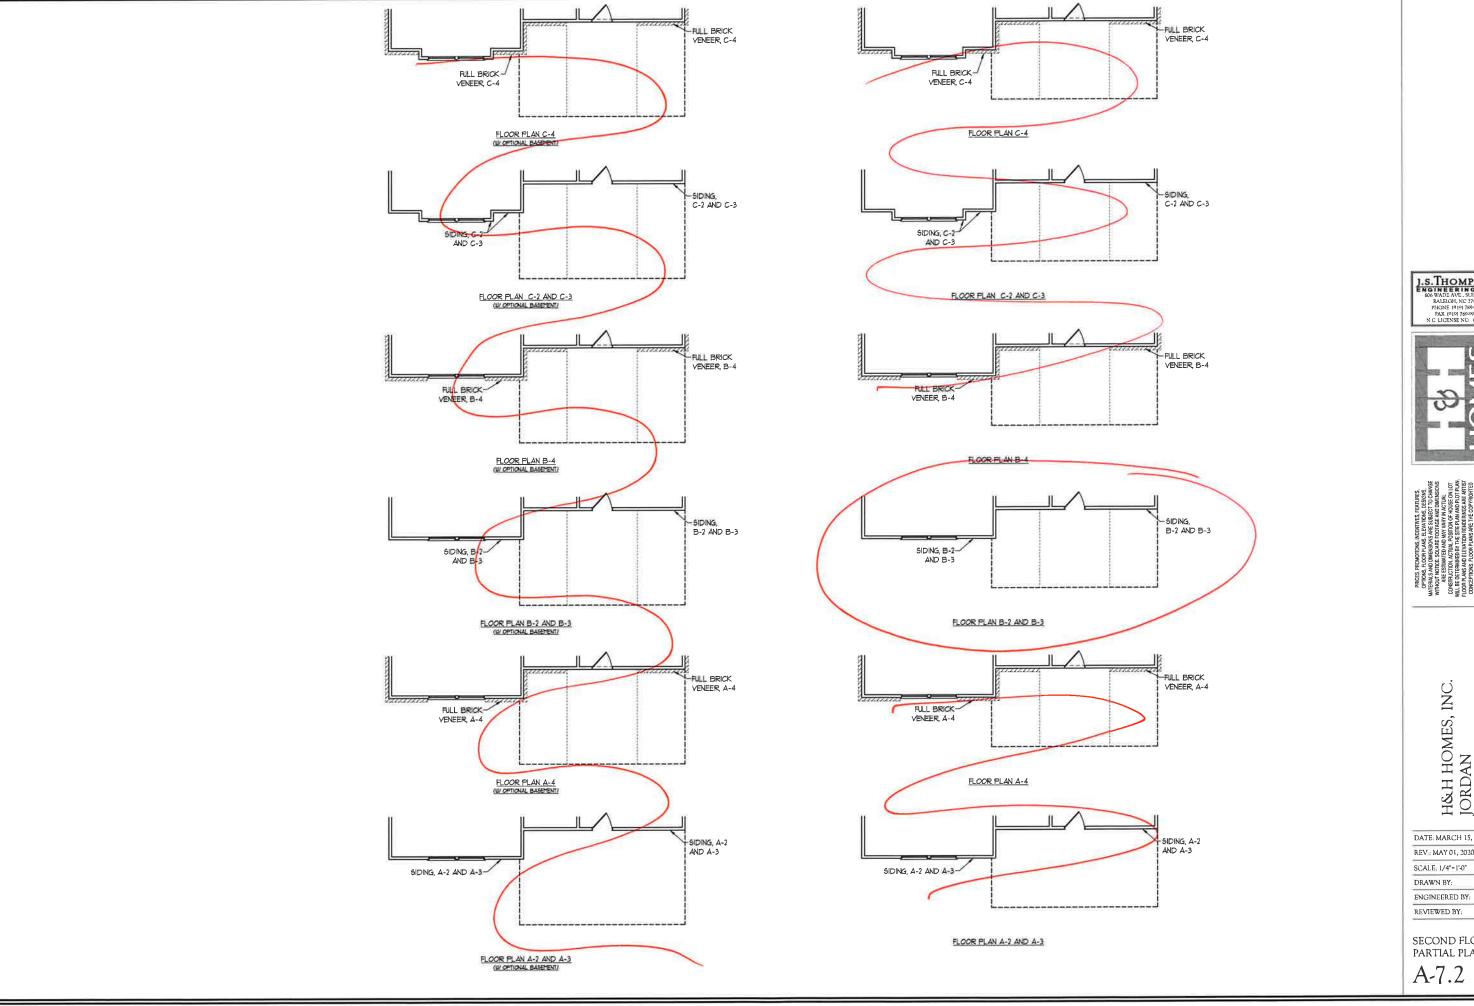
DRAWN BY:

ENGINEERED BY:

REVIEWED BY:

SECOND FLOOR OPTIONS

A-7.1



LS.THOMPSON ENGINEERING, INC 606 WADE AVE, SUITE 104 RALEIGH, NC 27605 PHONE (919) 7890919 FAX (919) 7890921 NC LICENSE NO C1733



H&H HOMES, INC. JORDAN

DATE: MARCH 15, 2019 REV: MAY 01, 2020 SCALE: 1/4"=1'-0"

DRAWN BY:

REVIEWED BY:

SECOND FLOOR PARTIAL PLANS

A-7.2

ROOF PLAN (A-L B-L AND C-1)



J.S.THOMPSON ENGINEERING, INC 606 WADE AVE, SUITE 104 RALEIGH, NC 27605 BMCONE (910) 289 0010



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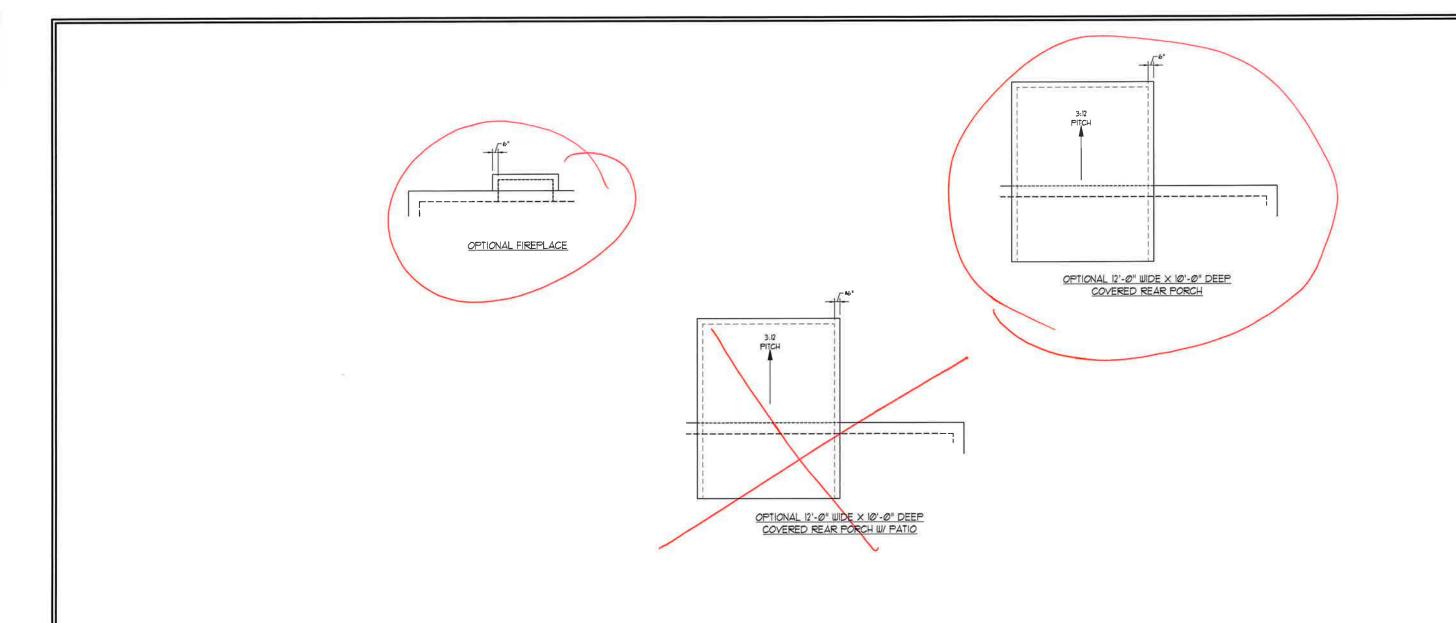
SCALE: 1/4"=1'-0"

DRAWN BY:

ENGINEERED BY: REVIEWED BY:

ROOF PLAN ELEVATIONS A&B

A-8







PRICES, PROMOTONS, INCENTIVES, FEATURES, OPTIONS COSPILATED SERVING EXPRENTING EXPRENTING EXPRENTING EXPRENTING EXPRENTING EXPRING EXPRENTING E

H&H HOMES, INC. JORDAN

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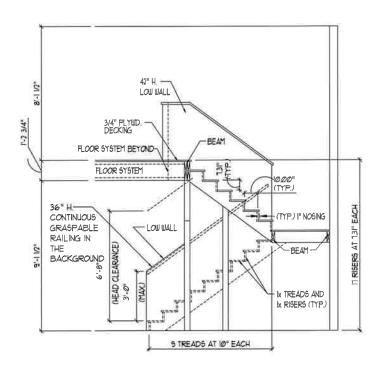
DRAWN BY:

ENGINEERED BY:

REVIEWED BY:

ROOF PLAN ELEVATION - A/B &C

A-8.2



TYPICAL STAIR DETAIL (NTS)

BALLIG
BALLISTERS SHALL BE SPACED SO THAT A 4" SPHERE CANNOT PASS THROUGH.

THE TRIANGLEAR OPENINGS FORTED BY THE RISER TREAD AND BOTTOM RAIL OF A GUARD AT THE OPEN SIDE OF A STARBUAT ARE PERMITTED TO BE A SUCH A SIZE THAT A SPHERE OF & INCLES CANNOT PASS THROUGH OPENINGS FOR RECUIRED GUARDS ON THE SIDES OF STAIR TREADS SHALL NOT ALLOU A SPHERE 4 3/8 INCHES TO PASS THROUGH


HADDRAILS FOR STAIRBUAYS SHALL BE CONTINUOUS FOR THE PULL LENGTH OF THE FLIGHT, FROM A POINT DIRECTLY ABOVE THE TOP RISER OF THE FLIGHT FROM A POINT DIRECTLY ABOVE THE TOP RISER OF THE FLIGHT TO A POINT DIRECTLY ABOVE THE LOUIST RISER HANDRAIL BOTS SHALL BE RETURADED OR SHALL TERMINATE IN NEUEL POSTS OR SAFETY TERMINALS.

CONTINUOUS GRASPABLE HANDRAIL MUST MEET TYPE ONE OR TYPE TWO CRITERIA

* * STAIR NOTES:

ZONE 3-R-30 INSULATION (MEET THE CI REQUIREMENT OF INSULATION EXTENDING
ACROSS THE TOP PLATE
R-36 INSULATION W HEEL LESS THAN 9" ROOF PITCH AS R-38 INSULATION W HEEL GREATER PER DRAWINGS OSB/PLYWOOD SHEATHING-PER CODE RAFTERS/ROOF TRUSSES AS SPEC-TOP OF PLATE TOP PLATE(S) AS SPEC-HEADERS AT OPENINGS AS SPEC-HI02) OF PROVIDE THE NEULATION FOR ALL NEATED AREAS R36 OR R30CI FOR CELING, R-IN FLOORS, RIS OR RIS CAVITY PLIS R25 CONTINUOUS FOR HALLS OSB/PLYWOOD OVER FRAMMS AS SPEC. (TYP.) TOP OF SECOND FLOOR FLOOR SHEATHING GLUED AND NAILED ON FLOOR SYSTEM TOP PLATE(5) AS SPEC-HEADERS AT OPENINGS AS SPEC--5TUD FRAMING (UND) W TRID BOTTOM PLATE(S) -BOTTOM PLATE(S) SIDING AS SPEC-SHEATHING STARTER STRIP. -MONOLITHIC SLAB AS SPEC. TRID. SILL PLATE (UNO)-

WALL SECTION W/ SLAB W/ STD. SIDING SHOWN (NTS)

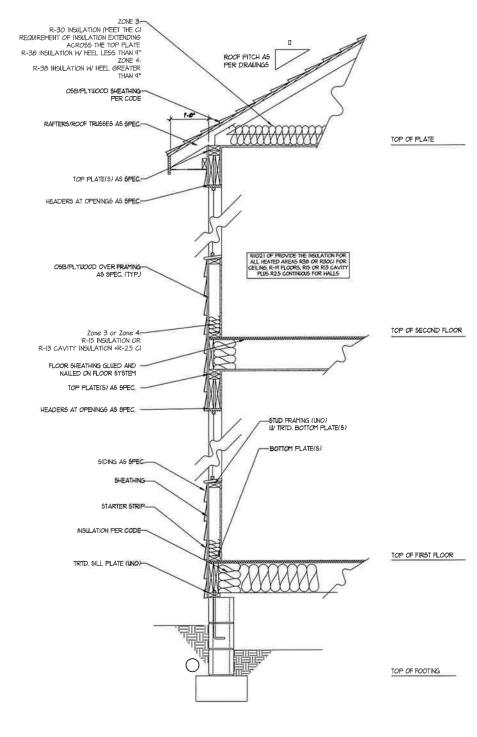

WALL SECTION W/ CRAWL SPACE
W/ STD. SIDING SHOWN (NTS)

J.S.THOMPSON ENGINEERING, INC 608 WADE AVE, SUITE 104 RALFIGH, NC 27605 PHONE (PPM) 1899018



PRIECE REMOUTONS, EUCHTUSE, STANDERS, PERPORA FOOR FAVAS, ELEVATIONS, DESENSA; THEMAS, SOON DEMESTORS ARE SERIEST TO CHANGE THE CHARACTH AND THE PROSTROM. A THE EUGENBARE EOTH OF THE PAYA HAD FOUT PLAY, THE EUGENBARE ED THE THE PAYA HAD FOUT PLAY, THE STANDERS FOR THE PAYA HAD FOUT PLAY, THE PAYA FOR THE PAYA HAD FOUT PLAY. THE PAYA FOR THE PAYA FOR THE PAYA FOR THE PAYA FOR THE PAYA PAYA FOUT PLAY. THE PAYA FOR THE PAYA FOR

> H&H HOMES, INC. JORDAN

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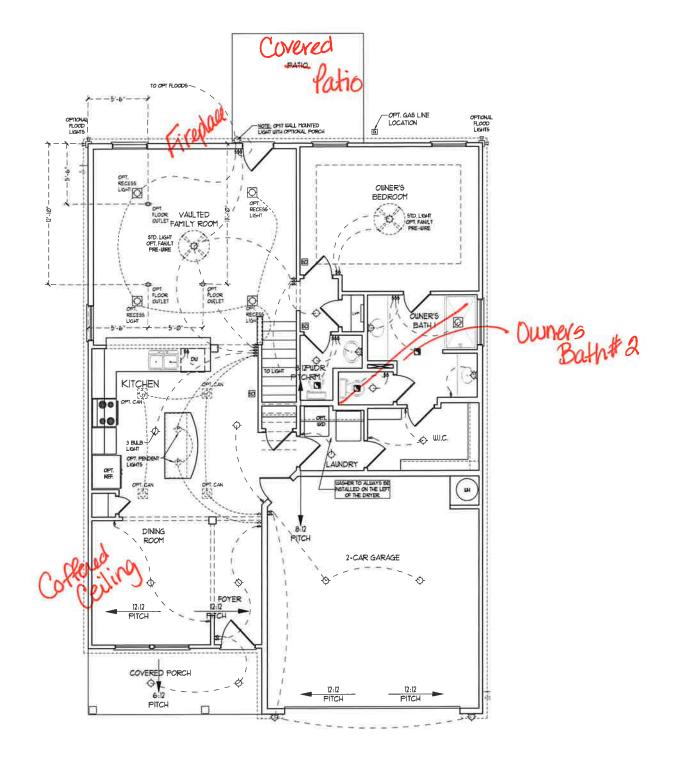
DRAWN BY:

ENGINEERED BY:

WALL SECTIONS AND STAIR DETAIL

AD-1

WALL SECT



ELECTRICAL LAYOUT NOTES: U BLOOK AND USE FOR ALL CELING FANS PER PLAN. 2) VANITY LIGHTS TO BE SET # 90° AFF. (TYP) 3) ADDITIONAL EXTERIOR OUTLETS REQUIRED BY CODE TO BE LOCATED BY ELECTRICIAN.

4.) PLACE SUITCHES 8" (HIN.) PROM ROUGH OPENINGS.

ELECTRICAL LEGEND IND Y OUTLET WALL MOUNT LIGHT CEILING MOUNT LIGHT PENDANT LIGHT RECESSED CAN LIGHT MINI CAN LIGHT EYEBALL LIGHT FLUORESCENT LIGHT 2 LAMP, 4' FLUORESCENT LIGHT FLOOD LIGHT SWITCH 3-WAY SWITCH 4-WAY SWITCH DIFFER SUITCH
CONDUIT FOR COFFENENT
BIRING
SPEAKER DOORBELL CHIME IIØ V SMOKE DETECTOR CO DETECTOR EXHAUST FAN LVP LOW YOLTAGE PANEL CEILING FAN

I.S.THOMPSON ENGINEERING INC 608 WADE AVE. SUITE 104 RALEIGH, NC 27605 PHONE (919) 789 901 NC LICINSE NO G1733



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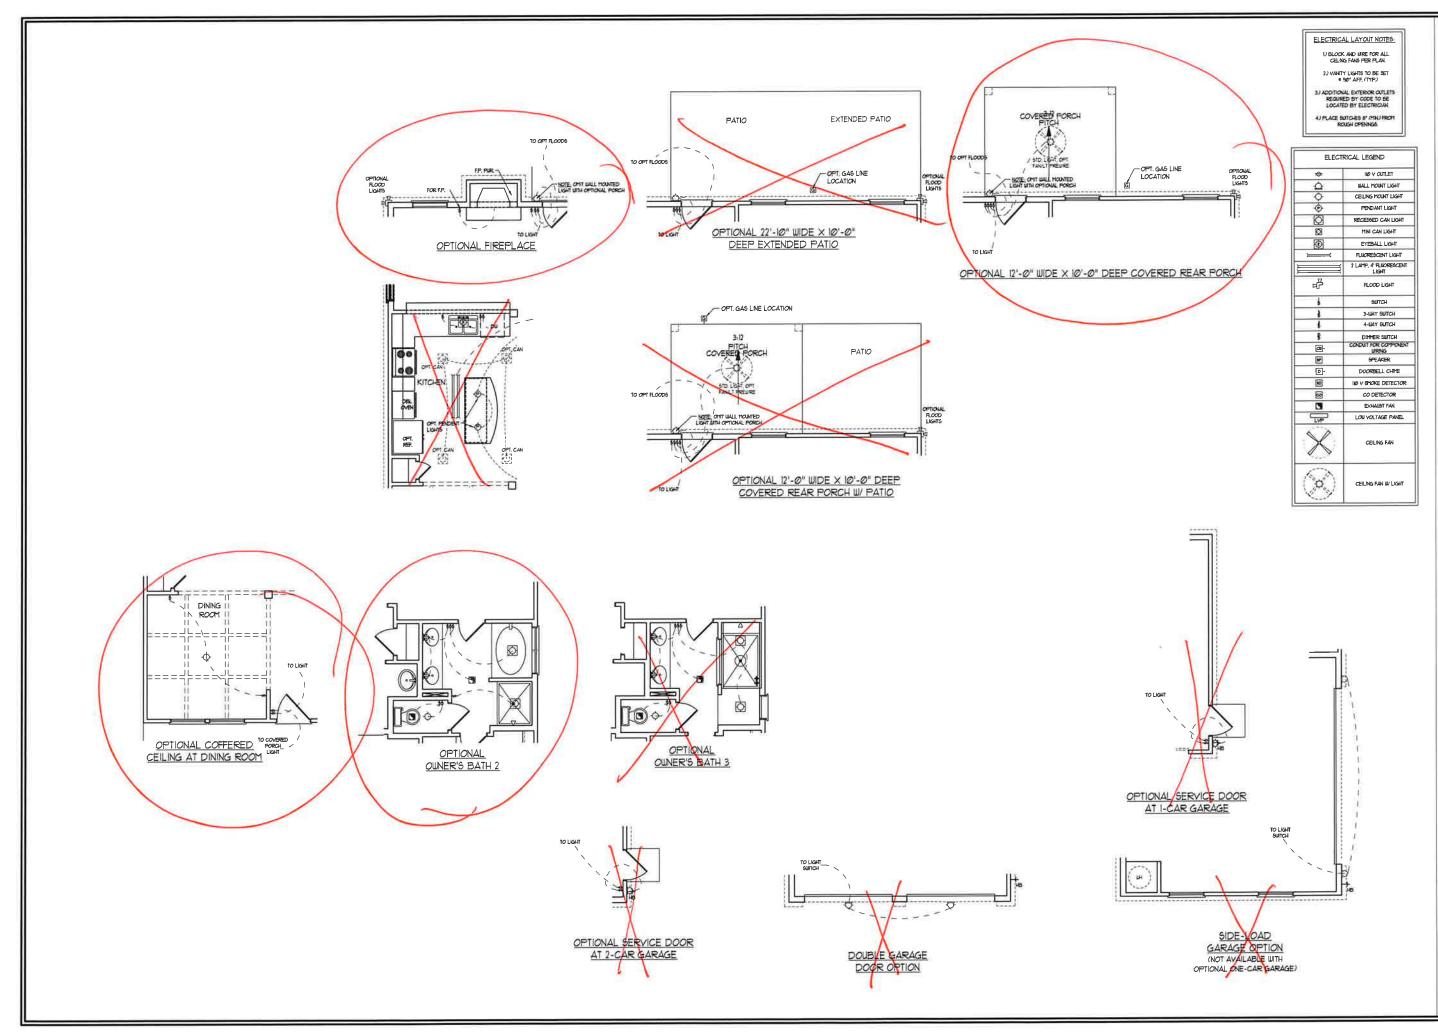
SCALE: 1/4"=1'-0" DRAWN BY:

ENGINEERED BY: REVIEWED BY:

FIRST FLOOR ELECTRICAL PLAN

E-1

FIRST FLOOR PLAN (A-I, B-I, AND C-I)





J.S.THOMPSON ENGINEERING, INC 606 WADE AVE, SUITE 104 RALEIGH, NC 27605 PHONE (919) 78949919

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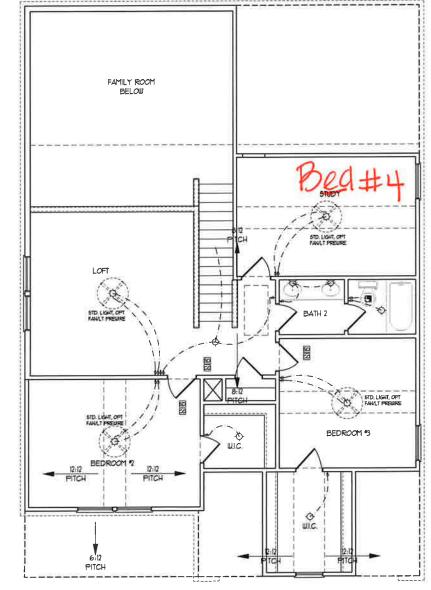
SCALE: 1/4"-1'-0"

DRAWN BY:

ENGINEERED BY:

FIRST FLOOR ELECTRICAL OPTIONS

E-1.1



SECOND FLOOR PLAN (A-I, B-I, AND C-I)

ELECTRICAL LAYOUT NOTES:

U BLOCK AND DIRE FOR ALL CELNG FASS PER PLAN

3.) ADDITIONAL EXTERIOR CUITLETS REQUIRED BY CODE TO BE LOCATED BY ELECTRICIAN

4.) PLACE SUITCHES 8" (MIN.) FROM ROUGH OPENINGS.

ELECTRICAL LEGEND 1⊌0 ∨ CUITLET WALL MOUNT LIGHT PENDANT LIGHT RECESSED CAN LIGHT MINI CAN LIGHT EYEBALL LIGHT FLUORESCENT LIGHT 2 LAMP, 4" FLUORESCENT LIGHT FLOOD LIGHT SWITCH 3-WAY SWITCH 4-WAY SUITCH DIMMER BUTCH
CONDUIT FOR COMPONENT
WIRNAG
SPEAKER DOORBELL CHIME 16 V SMOKE DETECTOR CO DETECTOR EXHAUST FAN LOW VOLTAGE PANEL CEILING FAN

S.THOMPSON ENGINEERING, INC 606 WADE AVE, SUITE 104 RALEIGH, NC 27605 PILONE (0-19) 780-0021 FAX (0-10) 780-0021 N C LICENSE NO C1733



H&H HOMES, INC. JORDAN

DATE: MARCH 15, 2019 REV: MAY 01, 2020


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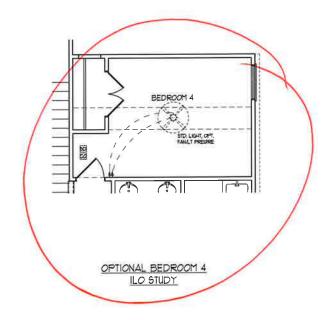
ENGINEERED BY: REVIEWED BY:

SECOND FLOOR ELECTRICAL

PLAN E-2

OPTIONAL WINDOW BOX AT BEDROOM 2 (ELEVATION C ONLY)



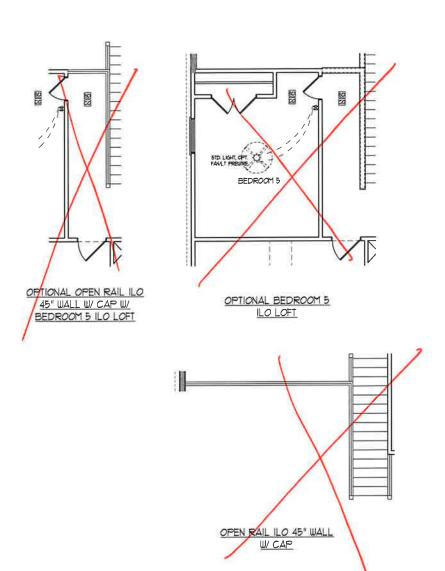

ELECTRICAL LAYOUT NOTES:

1) BLOCK AND WIRE FOR ALL
CELNG FANG FER PLAN.

1) VANTE LIGHTS TO BE SET
9 90" AFF. (TYP)

3) ADDITIONAL EXTENDER CURLETS
REQUIRED BY CODE TO BE
LOCATED BY ELECTRICAN.

4) PLACE SUTCHES 9" WHO FROM
ROLEM OPENING.

ELECTRICAL LEGEND		
\$	IØ ∨ CUTLET	
Δ	WALL MOUNT LIGHT	
	CEILING MOUNT LIGHT	
•	PENDANT LIGHT	
Ø	RECESSED CAN LIGHT	
Ø	MINI GAN LIGHT	
0	EYEBALL LIGHT	
	FLUORESCENT LIGHT	
====	2 LAMP, 4" FLUORESCENT LIGHT	
译	FLOOD LIGHT	
j.	BUITCH	
14	3-DIAY SUITCH	
š	4-WAY SWITCH	
8	DIMMER SUITCH	
(a)-	CONDUIT FOR CONFIDENT URENG	
2	SPEAKER	
D-	DOORBELL CHIME	
9	IIØ V SMOKE DETECTOR	
Ø	CO DETECTOR	
3	EXHAUST FAN	
LVP	LOW VOLTAGE PANEL	
X	CEILING FAN	
(0)	CEILING FAN W LIGHT	

I.S.THOMPSON ENGINEERING, INC 606 WADE AVE, SUITE 104 RALEIGH, NC 77605 PHONE (919) 788-901 FAX (919) 788-9021 N C LICENSE NO C1733



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H&H HOMES, INC. JORDAN


DATE: MARCH 15, 2019 REV.: MAY 01, 2020

SCALE: 1/4"=1'-0" DRAWN BY:

ENGINEERED BY:

SECOND FLOOR ELECTRICAL OPTIONS

E-2.1

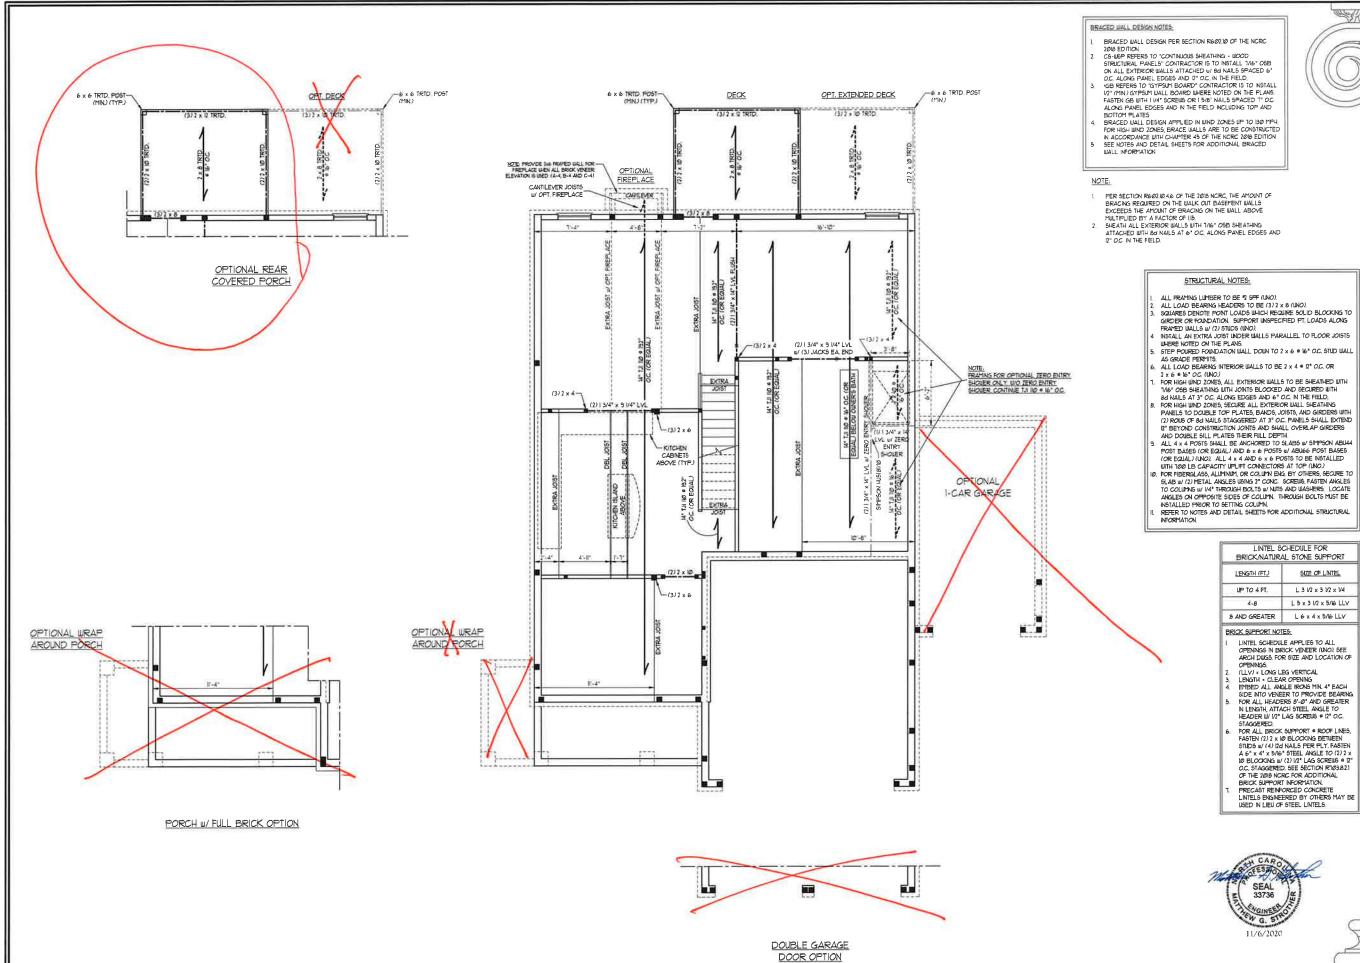

- BRACED WALL DESIGN PER SECTION R60210 OF THE NORC

- FER SECTION R602 1046 OF THE 2018 NGRC, THE AMOUNT OF BRACING REQUIRED ON THE WALK OUT BASEMENT WALLS EXCEEDS THE AMOUNT OF BRACING ON THE WALL ABOVE

STRUCTURAL NOTES:

- ALL FRAMING LUMBER TO BE % SPF (UNO).

 ALL LOAD BEARING HEADERS TO BE (3) 2 x 8 (UNO).

 SQUIARES DENOTE PONT LOADS WHICH REQUIRE SOLID BLOCKING TO GIRDER OR FOUNDATION. SUPPORT UNSPECIFIED PT, LOADS ALONG
- PRA*ED WALLS W (?) STUDS (INO).

 NSTALL AN EXTRA JOIST INDER WALLS PARALLEL TO FLOOR JOISTS

 WHERE NOTE ON THE PLANS.

 STEP POWED FOUNDATION WALL DOWN TO 2 x 6 ° 16 ° C. STUD WALL
- AS GRADE PERMITS
- ALL LOAD BEARING INTERIOR WALLS TO BE 2 x 4 . 12" OC. OR

- ANSTALLED PRIOR TO SETTING COLUMN.
 REFER TO NOTES AND DETAIL SHEETS FOR ADDITIONAL STRUCTURAL INFORMATION.

	LINTEL SCHEDULE FOR BRICKNATURAL STONE SUPPORT		
LENGTH (FT.)		SIZE OF LINTEL	
	UP TO 4 FT.	L 3 1/2 x 3 1/2 x 1/4	
	4-8	L 5 x 3 l/2 x 5/l6 LLv	
	8 AND GREATER	L 6 x 4 x 5/16 LLV	

BRICK SUPPORT NOTES:

- LINTEL SCHEDULE APPLIES TO ALL OPPNINGS IN BRICK VENEER (UNO). SEE ARCH DUGS, FOR SIZE AND LOCATION OF

- ARCH DUISS, FOR SIZE AND LOCATION OF OFFENNES.
 (*LLV)* LONG LEG VERTICAL.
 LENGTH* CLEAR OFFENNE
 EMBED ALL ANGLE ROADS MIN 4* EACH
 SIDE NIO VENEER TO FENOUDE EBEARING.
 FOR ALL HEADERS 8*-0* AND GREATEN
 IN LENGTH, ATTACH STELL ANGLE TO
 EFADER WI 1/2* LAG SORRUE* 8* 12* OC.
 STAGGERED.
 FOR ALL BRICK SUPPORT * ROOF LINES,
 FASTEN (2) 2 x 1/0* BLOCKING BETWEEN
 STUDS at (*1) 20 HALLS FER FLY, FASTEN
 A 6* x 4* x 51/6* STELL ANGLE TO (2) 2 x
 0° BLOCKING WI (2) 1/2* LAG SORRUE 0* 2*
 OC. STAGGERED, SEE SECTION F1/03-321
 OF THE 2019 ROCKE FOR ADDITIONAL. OF THE 2018 NCRC FOR ADDITIONAL
- BRICK SUPPORT INFORMATION
 PRECAST REINFORCED CONCRETE
 LINTELS ENGINEERED BY OTHERS MAY BE
 USED IN LIEU OF STEEL LINTELS.



SON H. NC 27605 7899921 ERING, SUITE 104 RALEIGH, P. 789-5919 FAX. (919) 788 LICENSE NO.: C.1733 ENGINEE GOWADEAPE, SUPPONE, (919) 789 PHONE, (919) 789 N.C. LIC

JORDAN HOMES, H&H

DATE NOVEMBER 5, 2020

INTERED BY WIR

SCALE 1/4" - 1'0"

DRAWN BY RENAISSANCE RESIDENTIAL DESIG

SHEFT 5 OF 10 S-1.4a FIRST FLOOR

CONTR. 7-1 1/2

FILL BETWEEN PRADERS SOLID W/KING STUDS STRAP HEADERS TOUTHER W (2) 5" LONG SIMPSON CSIG STRAPS INSTALLED TOP 4 BOTTOM ON THE INSIDE FACE OF THE HEADERS

CONTR 2'-0"

DOUBLE GARAGE DOOR OPTION

WINDOW BOX DETAIL

x 8 FLOOR JOISTS *

16" O.C. SHEATHING TO COVER JOISTS AS WELL

NSTALL CONT 1/16" OSB SHEATHING OF

INSTALL CONT. WE' COST SHEATHING O OUTSIDE OF BRACED WALLS, ATTACH OSB WITH 8d NAILS 3" O.C. ALONG EDGES AND 6" OC IN THE FIELD

FRAME DOWN FER DETAIL ON SECOND

FLOOR ARCHITECTURAL SHEET.



- BRACED WALL DESIGN PER SECTION R602 10 OF THE NORC
- 1/2" (MN) GYPSM WALL BOARD WHERE NOTED ON THE PLANS.
 FASTEN GB WITH I 1/4" SCREWS OR I 5/8" NAILS SPACED 7" OC.
 ALCAK PANEL EDGES AND IN THE FIELD INCLUDING TOP AND

ATTIC WALLS ARE TO BE 2 x 6 6 16" O.C. (UNO). 2 x 4 @ 16" O.C. EXTERIOR WALLS MAY BE CONSTRUCTED IN LIEU OF 2 x 6 WALLS (UNO), ALL INTERIOR LOAD BEARING WALLS ARE TO BE 2: 4 8 16" O.C. (UNO) AND NON-LOAD BEARING INTERIOR WALLS ARE TO BE 2 x 4 @ 24" O.C. (UNO).

LINTEL SCHEDULE FOR BRICK/NATURAL STONE SUPPORT		
LENGTH (FT.)	SIZE OF LINTEL	
UP TO 4 FT.	L 3 1/2 x 3 1/2 x 1/4	
4-8	L 5 x 3 l/2 x 5/l6 LLY	
8 AND GREATER	L 6 x 4 x 5/16 LLV	

BRICK SUPPORT NOTES

- LINTEL SCHEDULE APPLIES TO ALL OPENINGS IN BRICK VENEER (UNO), SEE ARCH DIUGS, FOR SIZE AND LOCATION OF

- ARCH DIUSS, FOR SIZE AND LOCATION OF OPPINIOSS (LLV) ** LONG LEG VERTICAL LEWATH ** CLEAR OPPINING PHIBD ALL ANGLE HONDS NN 4* EACH SIDE NTO VENEER TO PROVIDE BEARING FOR ALL HEADERS 9* 0" AND GREATER N LENGTH, ATTACH STELL ANGLE TO HEADER W 1/2" LAG SCREWS ** 12" OC. STAGGERED. FOR ALL BRICK SUPPORT ** ROOF LINES, FASTEN (2)" 2 x 1/2 BLOCKING BETWEEN STIDS w (4") 20" ANGLE TO (2)" 2 x 0" BLOCKING W (2)" 12" LAG SCREWS ** 2" OC. STAGGERED. SEE SECTION ** 1703.321 OF THE 2019 NORCE FOR ADDITIONAL. OF THE 2018 NORC FOR ADDITIONAL
- BRICK SUPPORT INFORMATION
 PRECAST REINFORCED CONCRETE
 LINTELS ENGINEERED BY OTHERS MAY E
 USED IN LIEU OF STEEL LINTELS.

STRUCTURAL NOTES:

- ALL FRAMING LUMBER TO BE SET 12 (UNO). ALL
- ALL PROVINGS EMPER TO BE STP 7 (MA)

 ALL LOAD BEARNS HEADERS TO BE (2) 2 x 6 (MA)

 ALL LOAD BEARNS HEADERS TO BE (2) 2 x 6 (MA)

 WINDOW AND DOOR HEADERS TO BE SIPPORTED W

 (1) JACK STUD AND (1) KING STUD EA END (MA), SEE TABLE R602.15 FOR ADDITIONAL KING STUD
- TABLE REPZI, IS FOR ADDITIONAL, KING SILID REQUIREMENTS.
 SQLIARES DENOTE POINT LOADS WHICH REQUIRE SOLID BLOCKING TO GIRDER OR FOUNDATION. ALL SQLIARES TO BE (7) STILDS (NAV.)
 FOR HIGH WIND ZONES, ALL EXTERIOR WALLS TO BE
- SHEATHED WITH 1/16" OSB SHEATHING WITH JOINTS BLOCKED AND SECURED WITH BY NAILS AT 3" OC. ALONG EDGES AND 6" OC. IN THE FIELD. FOR HIGH WIND ZONES, SECURE ALL EXTERIOR WALL SHEATHING PANELS TO DOUBLE TOP PLATES,
- BANDS, JOISTS, AND GIRDERS WITH (2) ROUS OF Bd NAILS STAGGERED AT 3" O.C. PANELS SHALL EXTEND NAILS STANGERED AT 5 'OF PARKETS SHALL EX 2" BEYOND CONSTRUCTION JOINTS AND SHALL OVERLAP GIRDERS AND DOUBLE SILL PLATES THEIR RILL DEPTH REFER TO NOTES AND DETAIL SHEETS FOR
- ADDITIONAL STRUCTURAL INFORMATION

"TSP" INDICATES TRIPLE STUD POCKET BETWEEN

TABLE R6@2.15 MINIMUM NUMBER OF FULL HEIGHT STUDS AT EACH END OF HEADERS IN EXTERIOR WALLS

HEADER SPAN (FEET)	MAXIMUM STUD SPACING (INCHES (PER TABLE R6023(5)		
	16	14	
UP TO 3	T	1	
4'	2	1	
8'	3	2	
12'	5	3	
161	6	4	

DATE: NOVEMBER 5, 2020 SCALE 1/4" - 1'0" DRAWN BY RENAISSANCE RESIDENTIAL DESI NOINI ERED BY WFB


> o 10 S-3 CEILING FRAMING


NOTE: ALL EXTERIOR WALLS AND

JORDAN H&H HOMES, I

HOMPSON E.SUTE OF ALECH, NC 27605 91) 7899919 FAX. (919) 7899921 CLICENSE NO. C. LICENSE NO. C.

NGINEE ROBE, SUPPOSE PHONE, SUPPOSE N.C. LIC

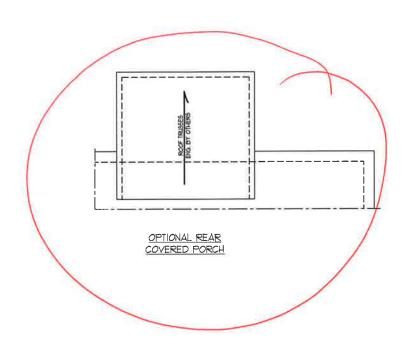

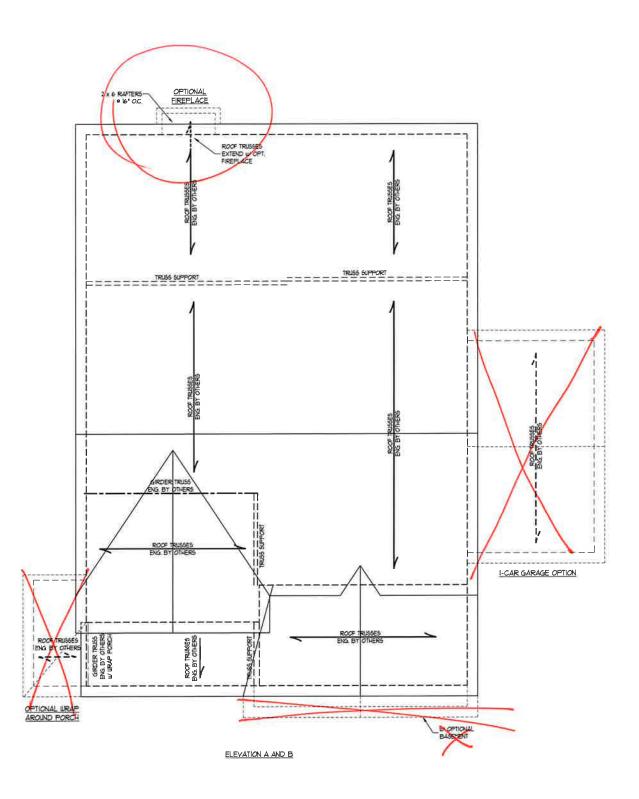



- L FASTEN (2) 2 x 60 BLOCKING BETWEEN WALL STUDS W (4) TICH MAILS FERR FL.Y, FASTEN A 6" x 4" x 5/16" STEEL ANGLE TO (2) 2 x 10 BLOCKING W (2) 12" LAG SCREWS 6" 2" O.C. STAGGERED. SEE SECTION RI02321 CF THE 2019 NORCE FOR ADDITIONAL BRICK SUPPORT INFORMATION.

 WHERE ROOF SLOPES DECEED 1:12, NSTALL. 3" x 3" x 14" STEEL PLATE STOPS AT 24" O.C. FER SECTION RI02321 OF THE NORTH CAROLINA RESIDENTIAL CODE, 2019 EDITION.

STRUCTURAL NOTES:

- ALL FRAMING LUMBER TO BE 72
 SFF (IMO).

 CIRCLES DENOTE (3) 2 x 4 POSTS
 FOR ROOF SUPPORT.

 FRAME DOPITER WALLS ON TOP
 OF DOUBLE OR TRIPLE RAFTERS.
 HIP SPILCES ARE TO BE SPACED
 A MIN OF 8'-0". FASTEN
 MEMBERS WITH THACE ROUS OF
 120 MAILS 9' RIO OC. (TTP).
 STICK FRAME OVER-FRAMED
 ROOF SECTIONS WI 2 x 9 RIORGES,
 2 x 6 RAFTERS 9 W" OC. AND
 FLAT 2 x 10 VALLEY'S OR USE
 VALLEY TRUSSES.
 FASTEN FLAT VALLEY'S TO
 RAFTERS OR TRUSSES WITH
 SYMPSON HUSA HARRICANE
 TIES THROUGH NOTCH IN ROOF
 SHEATHING. EACH RAFTER 15 TO
 BE FASTENED TO THE FLAT
 VALLEY WITH A NAY OF 16 JUG
 TOE MAILS.
 REFER TO SECTION REQUITED THE
 ZOB NACE FOR REQUIRED UP-LIF
 TOSIN STANDED TO THE FLAT
 VALLEY WITH A NAY OF 16 JUG
 TOE MAILS.
 REFER TO SECTION REQUITED UP-LIF
 TOSIN STANDED TO NOTE ON THE
 SHEETS FOR ADDITIONAL
 SHEETS FOR ADDITIONAL
 STRUCTURAL INFORMATION

DRAWN BY, RENAISSANCE RESIDENTIAL DESIG

SHEET 9 OF 10 S-4a ROOF FRAMING PLAN



ENGINEERING, INC
606 WALE NESSUITE OF RALIGH SEASONS
PHONE (919) 7899991 FAX (919) 7899921
N.C. LICENSE NO. C. C. T. 333

YAYAYAYAYAYAYAYAYAY

INC. JORDAN H&H HOMES, I

DATE NOVEMBER 5, 2020

ENGINEERED BY WITE

DETAIL I

TYPICAL SLAB DETAIL

DETAIL 3

GARAGE CURB DETAIL

DETAIL 5

5" FER PLAN 5"

THICKENED SLAB DETAIL

DETAIL 1

GARAGE DOOR JAME

UNDISTURBED EART COMPACTED FUL OR

BALL FRAMING AND TRID-SILL PLATE FER PLAN

TRID BOTTOM PLATE SECURED BY VI' DIA-BOLTS, VI' REDHEAD ANCHORS, OR VI' SEPSON 1TEN HO BOLTS WITHIN IT OF EACH CORNER (MINMAN OF TWO ANCHORS PER PLATE SECTION). SEE CHART FOR SPACING AND BHIBEDTENT REQ.

4" COMPACTED WELL-DRAINING SOIL OR WASHED STONE

COMPACTED FULL OR

SUL PLATE PER PLAN

TRID BOTTOM PLATE SECURED BY 10" DIA-BOLTE, 10" REDIEAD AND COSE, OR 10" BRIESON TITON NO BOLTS STAM OF OF EACH CORNER MAYAM OF TAO MACHOS PER PLATE SECTION SEE CHART FOR SHACING AND EMBEDYEN RED

MIL VAPOR BARREN

4" COPPLETED-WELL-DRAWING SOIL OR WASHED STONE

MONOLITHIC SLAB DETAILS

-SONO AS SPEC

SONG AS SPEC

SHEATHNO

ATARTER STREE

DETAIL 2

BRICK VENEER DETAIL

DETAIL 4

GARAGE CURB BRICK LEDGE DETAIL

DETAIL 6

0 6

STEP IN GARAGE DETAIL

WALL FRAMING AND TRID-SILL PLATE PER PLAN

TRID BOTTON PLATE SECURD BY UP DIA-BOLLS UP REDIESO ACCION OR UP SHERON TIEN DO BUTS WITHIN IT OF BELL CORRER (HINTUM OF TUD AICHORS PER PLATE SECTION SEE CHART FOR PACING AND EMBEDHENT REQ.

4" CONCRETE
W FIBER RENFORCING
OR WELDED WIRE FABRIC

MALL FRAMING AND TRID-SILL PLATE FER PLAN

TRID BOTTOM PLATE SECURED BY MOVIA-BOL 15 MY REDEAD ANGLOS OR MY SHOOL THIN 10 BOL 15 HAIR 17 OF EACH CORNER (HINTH) OF THO ANCHORS PER PLATE SECTION) SEE CHART FOR SPACING AND TREEDTHIN TEXA

MIL VAPOR BARRER

4" CONTROTTED

UELL-DRANNG SOIL

OR WASHED STONE

INDISTRIBED EARTH
COMPACTED FILL OR

ASHED STONE

- LEEP HOLES -5" LEDGE

1-4" VERTICALLY AND 1-6" HORIZONTALLY BRICK VENEER

-LEEP HOLES - NISHE GRADI

W FIBER RENFORCH

-FLASHING

WALL FRAMING AND TRID-

TRUD BOTTOM PLATE SECURED BY 1/7 DIA-BOO, 15 (// REDIEAD ANGIORE) OR 1/7 SIMPSON TIEN DO BOUTS UTIEN IT OF EACH CORNER (THATTOM OF TAD ANGIORES PER PLATE SECTION) SEE CHART FOR SPACING AND D'RECOMENT REQ AND D'RECOMENT REQ

4" CONCRETE 1LAD W/ FIBER REINFORCING OR HELDED WIRE FABRIC

WELL-DRAINING SOIL OR WASHED STONE

DATE NOVEMBER 14, 2018 SCALE NTS

DRAWN BY JST ENGINEERED BY: JES

70

D-1 FOUNDATION DETAILS

STEMWALL DETAILS

THE VERTICALLY AS 1'-6" HORIZONTALLY -4" BRICK VENEER

TRID BOTTOM PLATE SECURED BY 10" DIA-BOLTS OR THREADED ROOS, UTHN 10" OF EACH CORRER ITMINION OF TO ANCHORS PER PLATE SECTION SEE CHART FOR SPIACNG AND EMBEDMENT REQ. -SHEATHING -SONG AS SPEC -6.4500 TO CHU BLOCK UNDSTURBED EARTH-COMPACTED FILL OR WASHED STONE COC NO NORTHER TO SO, NOT BY 9, DEED LOS OLIVING BACK THE BURNEY. TOP TWO COURSES OF STEM WALL AND ALL CELLS W REINF TO BE GROUTED SOLID CON CONC. ELV.

TYPICAL STEM WALL DETAIL

(W/ OPTIONAL WATERTABLE)

DETAIL I

MALL FRAMING AND TRID -SILL PLATE PER PLAN

BALL FRAMING AND TRID-SILL PLATE FER PLAN INID BOTTOT PLATE SECRED BY MY DIA-BOLLS OR THE ADDRESS BY MY DIA-EACH CORNER MAINTH OF THE ANCHORS PER PLATE SECTION, SEE CHART FOR SPACING AND EMBEDMENT REQ. SONG AS SPEC SHEATHING 4" LEDGE-4" CONCRETE # 24 W FIBER RENFORCING R WELDED LINRE FABRIC 6 MIL VAPOR-BARRER 4" COMPACTED

JELL-DRAINING SOIL

OR WASHED STONE FNS-ED GRADE UNDISTURBED EARTH-COTFACTED FLL OR BIASHED STONE ONT CONC. FIR. MENT TO BE GROUTED SOLID

OPTIONAL DETAIL

OPTIONAL STEM WALL DETAIL

DETAIL 3

DETAIL 2 SILL PLATE PER PLAN 1'-4" VERTICALLY AND 2'-6" HORIZONTALLY BRICK VENEER TRID BOTTOM PLATE SCUENCED BY VE THAT BOLTS OR THREADED RODS, JHN VE OF EACH CORNER (MINIMUM OF TWO ANCHORS) FER PLATE SECTION). SEE CHART FOR PLATE SECTION). SEE CHART FOR SPACING AND EMBEDMENT REQ. -FLASHBO 4' CONCRETE \$ 45-W FIBER REINFORCING OR WELDED WIRE FABRIC 4" LEDGE-LEEP HOLES BARRIER h 2 4" COTFACTED-UELL DRANING SOIL OR WASHED STONE -LASDER URE EVERY OTHER COURSE -0" CHU BLOCK

SILL PLATE PER PLAN ATTO BOTTOM PLATE SECURED BY UP DIA-BOLTS OR TIMELOTER MODS, WHIN IT OF EACH CORNER MINITUM OF TWO ANCHORS FER PLATE SECTIONI SEE GHART FOR SPACING AND EMBEDHENT REQ. SONG AS SPEC SEATHNO. 6 HIL WARDER BARRIER FINSHED GRADE 4" COMPACTED-LELL-DRAINING SOIL OR ILASHED STONE OTHER COURSE - CHU BLOCK TOP TWO COURSES OF STEE


TYPICAL STEM WALL FND. W/ BRICK DETAIL

TYPICAL STEM WALL FND. DETAIL W/ CURB & GARAGE

OPTIONAL DETAIL 3 I . . UALL FRAMES AND TRID-2 x 6 MM 1RTD. BOTTOM PLATE SECURED BY-V/* DIA BOLTS OR THREADED ROD WITHIN IP* OF EACH CORNER (MINITUM OF TWO ANCHORS) PER PLATE SECTION/ SEE CHART FOR -S-EATHNG SPACING AND EMBEDMENT REG MOTCH BRICK PER DETAIL B. SEE THREADED ROD THROUGH BRICK DETAIL 4" CONCRETE \$1.45 W FIBER REINFORCING OR WELDED WIRE FABRIC 6 MIL VAPOR -BARRIER 4° COMPACTED WELL-DRAINING SOIL OR WASHED STONE -LADDER URE EVERY OTHER COURSE - C'U BLOCK CONT CONC FIG WALL AND ALL CELLS & RENF TO BE GROUTED SOLD OPTIONAL STEM WALL FND. DETAIL W/ CURB @ GARAGE

DETAIL 4 WALL FRAMING AND TRID -SILL PLATE PER PLAN TRID BOTION PLATE SECURED BY A DI-BOLIS OR THREADED ROD STAIN OF OF EACH CONDER IMMOUT OF TUD ANCHORS PER PLATE SECTION, SEE CHART FOR EPACKS AND EPEED AN INCO -FLASHNO CONCRETE SCAS-WEEF HOLES 6 HIL VAPOR— BARRIER 4" CO-FACTED-LELL-DRANNG SOIL OR LIASHED STONE LADDER URE EVERY OTHER COURSE CHI BLOCK RENT TO BE GROUTED SOLID

> TYPICAL STEM WALL FND DETAIL W/ BRICK AND CURB @ GARAGE

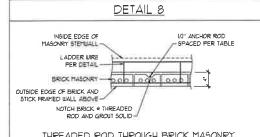

SLOPE SLAB VO" PER FOOT 6 HL VAPOR BARRER 1-4° UELL-DRANNG SOIL OR WASHED STONE

SLAB AT GARAGE DOOR DETAIL

THREADED ROD THROUGH BRICK MASONRY

MASONRY STEMWALL SPECIFICATIONS

l	WALL HEIGHT (FEET)	MASONRY WALL TYPE				
l		8" CMJ	4" BRICK AND 4" CMIJ	4" BRICK AND 8" CMU	12" CMU	
I	2 AND BELOW	UNGROUTED	GROUT SOLID	UNGROUTED	UNGROUTED	
ĺ	3	UNGROUTED	GROUT SOLID	UNGROUTED	UNGROUTED	
İ	4	GROUT SOLID	GROUT SOLID w/ º4 REBAR 9 48" O.C.	GROUT SOLID	GROUT SOLID W/ *4 REBAR # 64" OC	
	5	GROUT SOLID w/ *4 REBAR * 36" OC	NOT APPLICABLE	GROUT SOLID w/ *4 REBAR * 36" OC	GROUT SOLID W/ *4 REBAR # 64* OC	
İ	6	GROUT SOLID w/ *4 REBAR © 24* O.C.	NOT APPLICABLE	GROUT SOLID 11/ 4 REBAR 6 24" O.C.	GROUT SOLID W/ *4 REBAR 9 64" OC	

ENGINEERED DESIGN BASED ON SITE CONDITIONS

STRUCTURAL NOTES:

WALL HEIGHT MEASURED FROM TOP OF FOOTING TO TOP OF THE WALL

TIE MULTIPLE INTHES TOGETHER WITH LADDER WIRE AT 16" OC VERTICALLY, CHART APPLICABLE FOR HOUSE FOUNDATION ONLY, CONSULT ENGINEER FOR DESIGN OF GARAGE

CHART APPLICABLE FOR HOUSE FOUNDATION 2011, CONSULT ENGINEER FOR DESIGN OF GARAGE FOUNDATION NOT COMPION TO HOUSE.

BACKFILL OF CLEAN 571 % 1 WASHED STONE IS ALLOWABLE.

BACKFILL OF URLL DRAINED OR SAND - GRAVEL MIXTURE SOILS (45 PSF/FT BELOW GRADE)

CLASSHED AS GROWN I ACCORDING TO WHIRED SOILS CLASSHICATION SYSTEM IN ACCORDING WITH TABLE REGIST OF THE YOR INTERNATIONAL RESIDENTIAL CODE ARE ALLOWABLE.

PREP SLAB PER REGIST AND RESOLUTION RESIDENTIAL CODE ARE ALLOWABLE.

MINIMUM 24" LAP SPLICE LENGTH

TIME UP 24: LAP SPLICE LEASIN LOCATE REBAR N CENTER OF FOUNDATION WALL. 3. WHERE REQUIRED, FILL BLOCK SOLID WITH TYPE 15" MORTAR OR 3,000 PSI GROUT, USE OF "LOW LIFT GROUTING" METHOD REQUIRED WHEN FILLING WALLS WITH GROUT AT HEIGHTS OF 5" AND GREATER.

ANCHOR SPACING AND EMBEDMENT			
WIND ZONE 120 MPH		13/0 MPH	
SPACING 6'-0" OC		4'-Ø" O.C	
EMBEDMENT	T ²	15" INTO MASONRY 1" INTO CONCRETE	


GENERAL WALL BRACING NOTES:


- WALL BRACING DESIGNED IN ACCORDANCE WITH CHAPTER 6 OF THE 2016 NC RESIDENTIAL BUILDING CODE (NCRC).
 TABLES AND FIGURES REFERENCED ARE FROM THE 2016 NCRC.
 SEE THIS SHEET FOR GENERAL DETAILS. REFER TO THE 2016 NCRC FOR ADDITIONAL INFORMATION AS NEEDED.
- 3 SEE STRUCTURAL SHEETS FOR BRACED WALL LOCATIONS, DIMENSIONS, HOLD DOWN TYPE AND LOCATIONS, BRACED WALL LINE KEY WITH WALL DESIGN SUMMARY OF REQUIRED/PROVIDED TOTALS FOR EACH WALL LINE AND ANY SPECIAL NOTES
- 4. ALL EXTERIOR WALLS ARE TO BE SHEATHED WITH CS-USP IN ACCORDANCE WITH SECTION R602 103 UNLESS NOTED
- OTHERWISE


 5. ALL EXTERIOR AND INTERIOR WALLS TO HAVE 1/2" GYPSUM INSTALLED, WHEN NOT USING METHOD "GB", GYPSUM TO BE PASTENED PER TABLE RIGIZES. HETHOD GB TO BE PASTENED PER TABLE RIGIZES. HETHOD GB TO BE PASTENED PER TABLE RIGIZES.


 6. G-WEP REFERS TO THE "CONTINUOUS SHEATHING" WOOD STRUCTURAL PANEL" WALL BRACING METHOD. 1/46" CSB SHEATHING IS TO BE INSTALLED ON ALL EXTRENOR WALLS ATTRICHED W 64 COMPON NAILS OR 84 (7 1/2" LONG x 8/15").
- SHEATHING IS TO BE NOTALLED ON ALL EXTERIOR WILLS ATTACHED W 6d. COMMON MAILS OR 8d (2 1/2" LONG x 8/15" DIAMPETER NAILS SPACED 6" OC. AL ONG PAMEL EDGES AND 10" OC. N THE FIELD (INDO.)

 1. GB REFERS TO THE "GYPSIM BOARD" WALL BRACING METHOD. (1/2" (MIN.) GYPSIM WALL BOARD IS TO BE INSTALLED ON BOTH SIDES OF THE BRACED WALL FASTENED WITH 11/4" SCREWS OR 15/6" NAILS SPACED T" OC. ALONG PAWLE EDGES INCLIDING TOP AND BOTHOM PLATES AND INTERFEDIENT SUPPORTS (MIN.O.). VERTIF ALL FASTENED OPTIONS FOR 1/2" AND 5/6" GYPSIM PRIOR TO CONSTRUCTION. FOR INTERIOR FASTENER OPTIONS SEE TABLE REGISTALL ENGINE STATEMENT OF THE - METHOD FF CONTRIBUTES 15 TIMES ITS ACTUAL LENGTH.

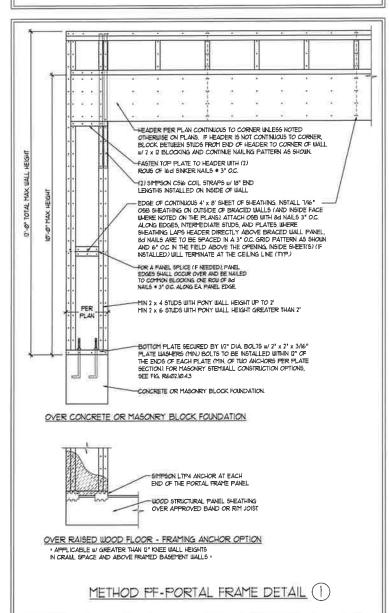


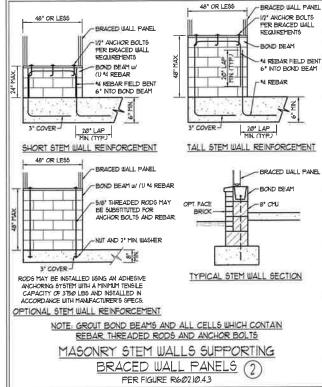


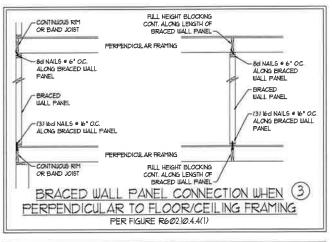


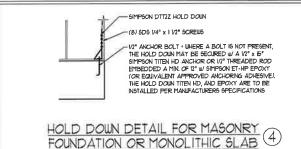



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27605 0 **RING**94 RALEIGH,
FAX. (919) 78
NO.: C-1733 O ME TO THE NGINEE 606 WADEAVE. SILT

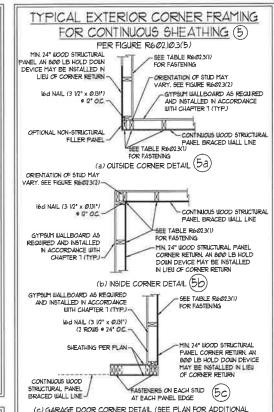SPEED DESIGN WIND S S AND DETAILS MPH ULTIMATE I BRACING NOTES MPH - 130 WALL F 120

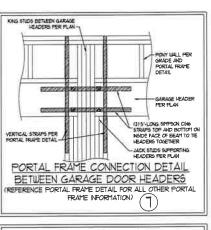DATE: NOVEMBER 14, 2018

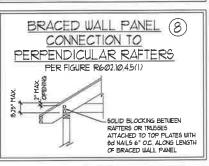DRAWN BY IST

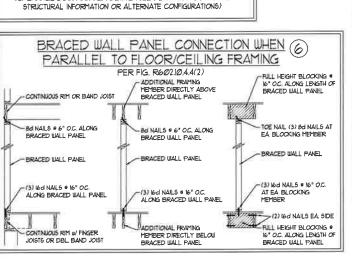NGINEERED BY IST

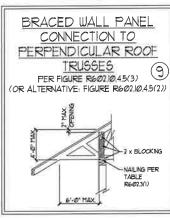D-7 BRACED WALL NOTES AND DETAILS AND PF DETAIL

- ENGINEER'S SEAL APPLIES ONLY TO STRUCTURAL COMPONENTS INCLUDING ROOF RAFTERS, HIPS, VALLEYS, RIDGES, FLOORS, WALLS, BEAMS, HEADERS, COLUMNS, CANTILEVERS, OFFSET LOAD BEARING WALLS, PIERS, GIRDER SYSTEM AND FOOTING. ENGINEER'S SEAL DOES NOT CERTIFI DIFENSIONAL ACCURACY OF ARCHITECTURAL LAYOUT INCLUDING ROOF, ENGINEER'S SEAL DOES NOT APPLY TO 1-JOIST OR FLOOR/ROOF TRUSS LAYOUT DESIGN AND ACCURACY.
- 2 ALL CONSTRUCTION SHALL CONFORM TO THE LATEST REQUIREMENTS OF THE NORTH CAROLINA RESIDENTIAL CODE (NCRC), 2018 EDITION, PLUS ALL LOCAL CODES AND REGULATIONS. THE STRUCTURAL ENGINEER IS NOT RESPONSIBLE FOR AND WILL NOT HAVE CONTROL OF, CONSTRUCTION MEANS, METHODS, TECHNIQUES, SEQUENCES OR PROCEDURES, OR SAFETY PRECAUTIONS AND PROCRAMS IN CONNECTION WITH THE CONSTRUCTION WORK NOR WILL THE BUSINEER BE RESPONSIBLE FOR THE CONTRACTORS FAILURE TO CARRY OUT THE CONSTRUCTION WORK IN ACCORDANCE WITH THE CONTRACT DOCUMENTS.
- 3. STRUCTURAL DESIGN BASED ON THE PROVISIONS OF THE NORG, 2016 EDITION (R3/01.4 R3/01.7)

DESIGN CRITERIA:	LIVE LOAD (PSF)	DEAD LOAD (PSF)	DEPLECTION (IN)
ATTIC WITH LIMITED STORAGE	20	10	L/240 (L/360 w/ BRITTLE FINISHES)
ATTIC WITHOUT STORAGE	10	IØ	L/36Ø
DECKS	40	10°	L/36Ø
EXTERIOR BALCONIES	40	100	L/360
FIRE ESCAPES	40	1Ø	L/360
HANDRAIL5/GUARDRAIL5	200 LB OR 50 (PLF)	10	L/36Ø
PASSENGER VEHICLE GARAGE	50	10°	L/36Ø
ROOMS OTHER THAN SLEEPING ROOM	40	IØ	L/36Ø
SLEEPING ROOMS	3Ø	10	L/36Ø
5TAIRS	40	10	L/36Ø
WIND LOAD	(BASED ON TABLE R3012)	4) WIND ZONE AND EXPOSURE	
GROUND SNOW LOAD: Pa	2Ø (PSF)		

- I-JOIST SYSTEMS DESIGNED WITH 12 PSF DEAD LOAD AND DEFLECTION (IN) OF L/480
- FLOOR TRUSS SYSTEMS DESIGNED WITH IS PSF DEAD LOA
- 4 FOR US AND USE MICH WIND JONES FOUNDATION ANCHORAGE IS TO COMPLY WITH SECTION R40316 OF THE NORC 2018 EDITION. FOR ISO MEH, 140 MPH, AND 150 MPH WIND ZONES, FOUNDATION ANCHORAGE IS TO COMPLY WITH SECTION 4504 OF THE NCRC, 2018 EDITIO
- 5. ENERGY EFFICIENCY COMPLIANCE AND INSULATION VALUES OF THE BUILDING TO BE IN ACCORDANCE WITH CHAPTER II OF THE NORC, 2018 EDITION.

FOOTING AND FOUNDATION NOTES

- 1 FOUNDATION DESIGN BASED ON A MINIMUM ALLOWABLE BEARING CAPACITY OF 2000 PSF. CONTACT GEOTECHNICAL ENGINEER IF BEARING
- 2. FOR ALL CONCRETE SLARS AND FOOTINGS THE AREA WITHIN THE PERIMETER OF THE BUILDING ENVELOPE SHALL HAVE ALL VEGETATION, FOR FOR ALL CONCRETE SLABS AND POOTINGS, THE AREA WITHIN THE PERIMETER OF THE BUILDING SUVELOPE SHALL HAVE ALL VEGETATION, IC SOIL, AND POREIGN MATERIAL, REMOVED. HILL MATERIAL SHALL BE FREE OF VEGETATION, AND FOREIGN HATERIAL. THE FILL SHALL BE COMPACTED TO ASSURE WIFORM SUPPORT OF THE SLAB, AND EXCEPT WHERE APPROVED, THE RILL DEPTHS SHALL NOT EXCEED 24 FOR CLEAN SAND OR GRAVEL. A 4" THICK BASED COURSE CONSISTING OF CLEAN GRADED SAND OR GRAVEL SHALL BE PLACED. A BASE CURSE IS NOT REQUIRED WHERE A CONCRETE SLAB IS NISTALLED ON WELL-DRAINED OR SAND-GRAVEL MIXTURE SOILS CLASSFIED AS GROUP I, ACCORDING TO THE WITTED SOIL CLASSFIEDATION SYSTEM IN ACCORDANCE WITH TABLE R4051 OF THE NORC, 2016 EDITION.
- APPLICABLE, 3/4" 1" DEEP CONTROL JOINTS ARE TO BE SAUED WITHIN 4 TO 12 HOURS OF CONCRETE FINISHING AND WALL LOCATIONS HAVE BEEN MARKED. ADJUST WHERE NECESSARY.
- 4. CONCRETE SHALL CONFORM TO SECTION R4022 OF THE NORC 2016 EDITION. CONCRETE REINFORCING STEEL TO BE ASTM A615 GRADE 60. URLDED UNE FABRICT OF BE ASTM AIRS. MANTAIN A HINIMPH CONCRETE COVER AROUND REINFORCING STEEL OF 3" IN FOOTINGS AND 112" IN SLABS, FOR POUNED CONCRETE UALLS, CONCRETE COVER FOR REINFORCING STEEL HEASURED FROM THE INSIDE FACE OF THE UALL SHALL NOT BE LESS THAN 34". CONCRETE COVER FOR REINFORCING STEEL MEASURED FROM THE OUTSIDE FACE OF THE UALL SHALL NOT BE LESS THAN 1 1/2" FOR 5 BARS OR SMALLER, AND NOT LESS THAN 2" FOR 5'S BARS OR LARGER.
- 5. MASONRY UNITS TO CONFORM TO ACE 530/ASCE 5/TMS 402. MORTAR SHALL COMFORM
- 6. THE UNSUPPORTED HEIGHT OF MASONRY PIERS SHALL NOT EXCEED FOUR TIMES THEIR LEAST DIMENSION FOR UNFILLED HOLLOW CONCRETE MASONRY UNITS AND TEN TIMES THEIR LEAST DIMENSION FOR SOLID OR SOLID FILLED PIERS. PERS MAY BE FILLED SOLID WITH CONCRETE OR TYPE M OR 5 MORTAR PIERS AND WALLS SHALL BE CAPPED WITH B' OF SOLID MASONRY.
- 1. THE CENTER OF EACH OF THE PIERS SHALL BEAR IN THE MIDDLE THIRD OF ITS RESPECTIVE FOOTING, EACH GIRDER SHALL BEAR IN THE MIDDLE THIRD OF THE PIERS.
- 6. ALL CONCRETE AND MASONRY FOUNDATION WALLS ARE TO BE CONSTRUCTED IN ACCORDANCE WITH THE PROVISIONS OF SECTION R404 OF THE NORG, 2018 EDITION OR IN ACCORDANCE WITH ACI 318, ACI 332, NOMA TR68-A OR ACE 530/ASCE 5/TMS 402, MASONRY FOUNDATION WALLS ARE TO BE REINFORCED PER TABLE R404.1(1), R404.1(2), R404.1(3), OR R404.1(4) OF THE NCRC 2018 EDITION CONCRETE FOUNDATION WALLS ARE TO BE REINFORCED FER TABLE R4041X5) OF THE NORC, 2018 EDITION. STEP CONCRETE FOUNDATION WALLS TO 2 x 6 FRAMED WALLS AT 16" O.C. WHERE GRADE PERHITS (UNO).

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FRAMING NOTES

- 2. LAMINATED VENEER LUMBER (LVL) SHALL HAVE THE FOLLOWING MINIMUM PROPERTIES: FD =2600 PSI, FV = 285 PSI, E = 1900000 PSI. LAMINATED STRAND LUMBER (LSL) SHALL HAVE THE FOLLOWING MINIMUM PROPERTIES: Bo = 2325 PSL Ev = 3/0 PSL E = 155/0/0/0/ PSL PARALLEL STRAND LUMBER (PSL) UP TO 1" DEPTH SHALL HAVE THE FOLLOUING MINIMUM PROPERTIES: Fig. = 1500 PSI; E : 1800 0000 PSI PARALLEL STRAND LUMBER (PSL) MORE THAN 1" DEPTH SHALL HAVE THE FOLLOUING MINIMUM PROPERTIES: Fig. = 2900 PSI; E : 2000 000

W AND WT SHAPES: CHANNELS AND ANGLES: A5TM A992 A5TM A36 PLATES AND BARS: ASTM A36 HOLLOW STRUCTURAL SECTIONS: ASTM A500 GRADE B

4. STEEL BEAMS SHALL BE SUPPORTED AT EACH END WITH A MINIMUM BEARNS LENGTH OF 3 I/21 AND FULL FLANGE WIDTH (IN/O). PROVIDE SOLID BEARNS FROM BEAM SUPPORT TO FOUNDATION. BEAMS SHALL BE ATTACHED AT THE BOTTOM FLANGE TO EACH SUPPORT AS

(2) 1/2" DIA x 4" LONG LAG SCREUS A, WOOD FRAMING B. CONCRETE (2) 1/2" DIA y 4" HEDGE ANCHORS

LATERAL SUPPORT IS CONSIDERED ADEQUATE PROVIDING THE JOISTS ARE TOE NAILED TO THE 2x NAILER ON TOP OF THE STEEL BEAM W (2) ROUS OF SELF TAPPING SCREUS # 16" O.C. OR (2) ROUS OF 12" DIAMETER BOLTS # 16" O.C. IF 1/2" BOLTS ARE USED TO FASTEN THE NAILER THE STEEL BEAM SHALL BE FABRICATED w/ (2) ROUS OF 9/16" DIAMETER

- 5. SQUARES DENOTE POINT LOADS WHICH REQUIRE SOLID BLOCKING TO GIRDER OR FOUNDATION. SHADED SQUARES DENOTE POINT LOADS
- 6. ALL LOAD BEARING HEADERS TO CONFORM TO TABLE R602.1(1) AND R602.1(2) OF THE NCRC, 2018 EDITION OR BE (2) 2 x 6 WITH (1) JACK AND (1) KING STUD EACH END (UNO), WHICHEVER IS GREATER ALL HEADERS TO BE SECURED TO EACH JACK STUD WITH (4) 8d NAILS. ALL BEAMS TO BE SUPPORTED WITH (2) STUDS AT EACH BEARING POINT (UNO). INSTALL KING STUDS PER SECTION R602.15 OF THE NORTH
- T. ALL BEAMS HEADERS OR GIRDER TRUSSES PARALLEL TO WALL ARE TO BEAR FULLY ON (1) JACK OR (2) STUDS MINIMUM OR THE NUMBER OF JACKS OR STILDS NOTED. ALL BEAMS OR GIRDER TRUSSES PERPENDICILLAR TO WALL AND SUPPORTED BY (3) STILDS OR LESS ARE TO HAVE I I'M MINIMUM BEARNS (UND). ALL BEAMS OR GIRDER TRUSSES PERPENDICULAR TO WALL AND SUPPORTED BY MORE THAN (3) STILDS OR OTHER NOTED COLUMN ARE TO BEAR FULLY ON SUPPORT COLUMN FOR ENTIRE WALL DEPTH (UNO). BEAM ENDS THAT BUTT INTO ONE ANOTHER ARE TO EACH BEAR EQUAL LENGTHS (UNO).
- BE BROUGHT TO THE ATTENTION OF THE ENGINEER OF RECORD PRIOR TO INSTALL ATION.
- (Ø) BRACED WALL PANELS SHALL BE CONSTRUCTED ACCORDING TO THE NORTH CAROLINA RESIDENTIAL CODE 2016 EDITION WALL BRACING CRITERIA THE AMOUNT, LENGTH, AND LOCATION OF BRACING SHALL COMPLY WITH ALL APPLICABLE TABLES IN SECTION R6/02/10.
- RUSSES OR 1-JOISTS PER MANUFACTURER'S SPECIFICATIONS. INSTALL BLOCKING BETWEEN JOISTS OR TRUSSES FOR POINT LOAD SUPPORT
- 12" O.C. STAGGERED AND IN ACCORDANCE WITH SECTION RT03.821 OF THE NORG, 2018 EDITION.
- 8'-0". FASTEN MEMBERS WITH THREE ROUS OF 12d NAILS AT 16" O.C., FRAME DORMER WALLS ON TOP OF DOUBLE OR TRIPLE RAFTERS AS
- 14. FOR TRUSSED ROOFS: FRAME DORMER WALLS ON TOP OF 2 x 4 LADDER FRAMING AT 24" OC. BETWEEN ADJACENT ROOF TRUSSES. STICK TE OVER-FRAMED ROOF SECTIONS WITH 2×8 RIDGES, 2×6 RAFTERS AT 16" O.C. AND FLAT 2×10 VALLEYS (UNO).
- F. ALLAY 4 AND 6 Y 6 POSTS TO BE INSTALLED WITH TOOL B CAPACITY UPLIET CONNECTORS TOP AND BOTTOM (UND.) POSTS MAY BE SECULED USING ONE SIMPSON HE OR LISTS UPLIFF CONNECTOR FASTBLED TO THE BAND AT THE BOTTOM AND THE BEAM AT THE TOP OF EACH POST, ONE IS SECTION OF SIMPSON CSIS COIL STRAPPING WITH (8) BUT HOUSE AND AT EACH END MAY BE USED IN LIEU OF EACH TUIST STRAP IF DESIRED FOR MASONRY OR CONCRETE FOUNDATION USE SIMPSON POST BASE

ALL FRAMING LUMBER SHALL BE 7 SFF MINIMUM (Fo = 815 PS), Fv = 315 PS), E = 16000000 PSI) UNLESS NOTED OTHERWISE (UNO). ALL TREATED LUMBER SHALL BE 7 SYP MINIMUM (Fb = 915 PSI, Fv = 115 PSI, E = 16000000 PSI) UNLESS NOTED OTHERWISE (UNO).

PSI_INSTALL ALL CONNECTIONS PER MANUFACTURER'S SPECIFICATIONS.

3. STRUCTURAL STEEL SHALL CONFORM TO THE FOLLOWING ASTM SPECIFICATIONS

ASTM A53, GRADE B, TYPE E OR S

C MASONRY (FULLY GROUTED) (2) 1/2" DIA. x 4" LONG SIMPSON TITEN HD ANCHORS

FROM ABOVE WHICH REQUIRE SOLID BLOCKING TO SUPPORTING MEMBER BELOW.

FLITCH BEAMS SHALL BE BOLTED TOSETHER USING 12" DIAMETER BOLTS (ASTM A301) WITH WASHERS FLACED AT THREADED BND OF BOLT.
 BOLTS SHALL BE SPACED AT 24" CENTERS (MAXIMM), AND STAGGERED AT TOP AND BOTTOM OF BEAM (2" EDGE DISTANCE), WITH (2) BOLTS

- 9. ALL I-JOIST OR TRUSS LAYOUTS ARE TO BE IN COMPLIANCE WITH THE OVERALL DESIGN SPECFIED ON THE PLANS. ALL DEVIATIONS ARE TO
- IL PROVIDE DOUBLE JOIST UNDER ALL WALLS PARALLEL TO FLOOR JOISTS. PROVIDE SUPPORT UNDER ALL WALLS PARALLEL TO FLOOR
- POR ALL HEADERS SUPPORTING BRICK VENEER THAT ARE LESS THAN 8'-Ø" IN LENGTH, REST A 6" x 4" x 5/16" STEEL ANGLE WITH 6" MINIMUM EMBEDMENT AT SIDES FOR BRICK SUPPORT (WAO). FOR ALL HEADERS 8'-Ø" AND GREATER IN LENGTH, BOLT A 6" x 4" x 5/16" STEEL ANGLE TO HEADER WITH 1/2" LAG SCREWS AT 12" O.C. STAGGERED FOR BRICK SUFFORT, FOR ALL BRICK SUFFORT AT ROOF LINES, BOLT A 6" x 4" x 5/16" STEEL ANGLE TO (2) 2 x 10 BLOCKING INSTALLED W (4) 12d NAILS EA PLY BETWEEN WALL STUDS WITH (2) ROUG OF 1/2" LAG SCREWS AT
- B. FOR STICK FRAMED ROOFS: CIRCLES DENOTE (3) 2 x 4 POSTS FOR ROOF MEMBER SUPPORT. HIP SPLICES ARE TO BE SPACED A MINIMUM OF

SPEED LTIMATE DESIGN WIND STRUCTURAL NOTES · 130 MPH UL STANDARD S MPH 20

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DATE NOVEMBER 14, 2018 SCALE 1/4" = 1'0"

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STRUCTURAL