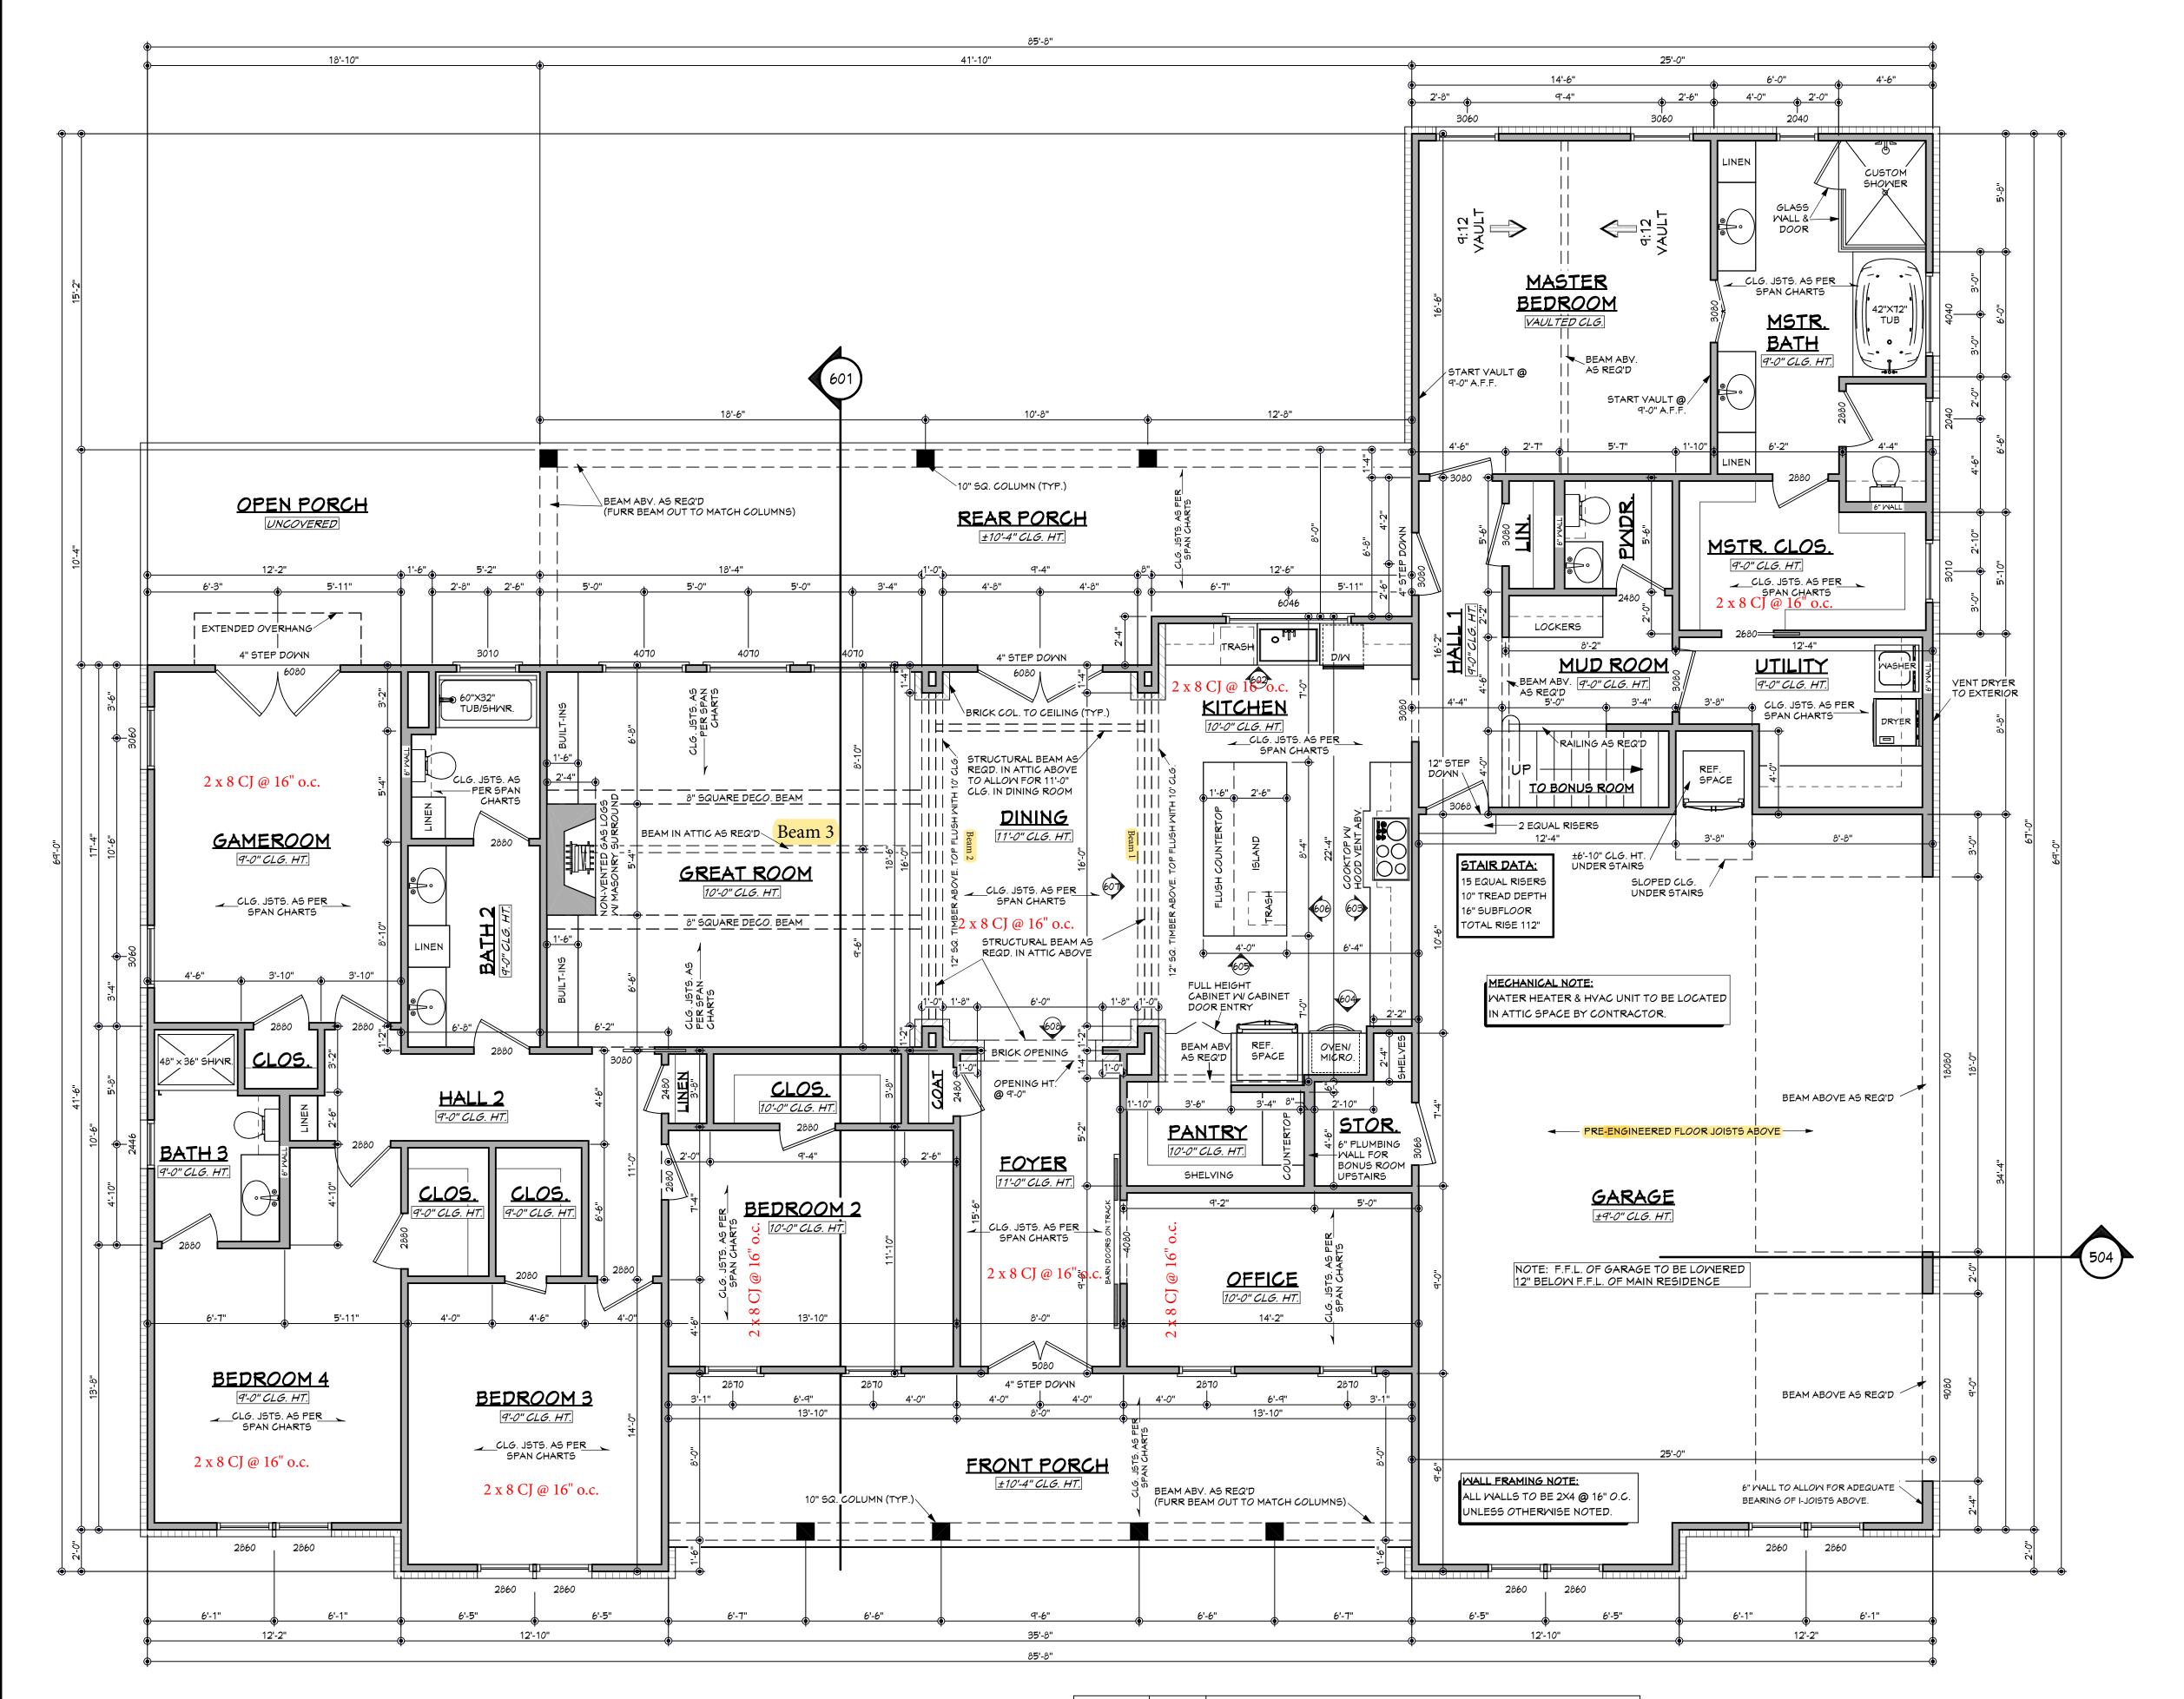


Foundation Section

species and for other loading conditions, refer to the AF&PA

-The allowable span of girders fabricated of dimension lumber shall not exceed the values set forth in Tables R502.5(1) and R502.5(2).

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NOTES:

1. ALL DIMENSIONS & SITE CONDITIONS TO BE VERIFIED BY CONTRACTOR PRIOR TO CONSTRUCTION.
2. ALL FINISHES (INTERIOR & EXTERIOR) TO BE VERIFIED

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3. VERIFY ALL DOOR AND WINDOW STYLES AND SIZES WITH OWNER PRIOR TO CONSTRUCTION. MANUFACTURER TO SUPPLY ALL ROUGH OPENING SIZES.

4. CONTRACTOR TO VERIFY ALL CLEARANCES OF ALL DOORS, WINDOWS AND OTHER ITEMS THAT ARE CRITICAL, PRIOR TO CONSTRUCTION.
5. CONTRACTOR TO ADAPT PLANS AS REQUIRED TO MEET

ALL APPLICABLE CODES AT SITE.

6. ALL BEAMS TO BE SIZED BY A LICENSED STRUCTURAL ENGINEER.

7. PORCHES, BALCONIES OR RAISED FLOOR SURFACES LOCATED MORE THAN 30 INCHES ABOVE THE FLOOR OR GRADE BELOW AT ANY POINT WITHIN 36 INCHES HORIZONTALLY SHALL HAVE GUARDS NOT LESS THAN 36 INCHES IN HEIGHT. OPEN SIDES OF STAIRS WITH A TOTAL RISE OF MORE THAN 30 INCHES ABOVE THE FLOOR OR GRADE BELOW SHALL HAVE GUARDS NOT LESS THAN 34 INCHES IN HEIGHT MEASURED VERTICALLY FROM THE NOSING OF THE TREADS. INSECT SCREENING SHALL NOT BE CONSIDERED AS A GUARD. IRC 2018, R312.1.1 & R312.1.2 8. M1305.1.2 APPLIANCES IN ATTICS. ATTICS CONTAINING APPLIANCES SHALL BE PROVIDED WITH AN OPENING AND A CLEAR AND UNOBSTRUCTED PASSAGEWAY LARGE ENOUGH TO ALLOW REMOVAL OF THE LARGEST APPLIANCE, BUT NOT LESS THAN 30 INCHES HIGH AND 22 INCHES MIDE AND NOT MORE THAN 20 FEET LONG MEASURED ALONG THE CENTERLINE OF THE PASSAGEWAY FROM THE OPENING TO THE APPLIANCE. THE PASSAGEWAY SHALL HAVE CONTINUOUS SOLID FLOORING IN ACCORDANCE WITH CHAPTER 5 NOT LESS THAN 24 INCHES WIDE. A LEVEL SERVICE SPACE AT LEAST 30 INCHES DEEP AND 30 INCHES WIDE SHALL BE PRESENT ALONG ALL SIDES OF THE APPLIANCE WHERE ACCESS IS REQUIRED. THE CLEAR ACCESS OPENING DIMENSIONS SHALL BE A MINIMUM OF 20 INCHES BY 30 INCHES, AND LARGE ENOUGH TO ALLOW REMOVAL OF THE LARGEST APPLIANCE. EXCEPTIONS:

a. THE PASSAGEWAY AND LEVEL SERVICE SPACE ARE NOT REQUIRED WHERE THE APPLIANCE CAN BE SERVICED AND REMOVED THROUGH THE REQUIRED OPENING.
b. WHERE THE PASSAGEWAY IS UNOBSTRUCTED AND NOT LESS THAN 6 FEET HIGH AND 22 INCHES WIDE FOR ITS ENTIRE LENGTH, THE PASSAGEWAY SHALL BE NOT MORE THAN 50 FEET LONG.

9. APPLIANCE ACCESS FOR INSPECTION SERVICE, REPAIR AND REPLACEMENT. APPLIANCES SHALL BE ACCESSIBLE FOR INSPECTION, SERVICE, REPAIR AND REPLACEMENT WITHOUT REMOVING PERMANENT CONSTRUCTION, OTHER APPLIANCES, OR ANY OTHER PIPING OR DUCTS NOT CONNECTED TO THE APPLIANCE BEING INSPECTED, SERVICED, REPAIRED OR REPLACED. A LEVEL WORKING SPACE AT LEAST 30 INCHES DEEP AND 30 INCHES WIDE SHALL BE PROVIDED IN FRONT OF THE CONTROL SIDE TO SERVICE AN APPLIANCE. M1305.1.1

10. EMERGENCY ESCAPE AND RESCUE OPENINGS SHALL BE OPERATIONAL FROM THE INSIDE OF THE ROOM WITHOUT THE USE OF KEYS, TOOLS OR SPECIAL KNOWLEDGE. WINDOW OPENING CONTROL DEVICES COMPLYING WITH ASTM F 2090 SHALL BE PERMITTED FOR USE ON WINDOWS SERVING AS A REQUIRED EMERGENCY ESCAPE AND RESCUE OPENING. ALL SLEEPING ROOMS TO HAVE AN EXTERIOR ACCESS THROUGH A DOOR OR WINDOW WITH A MINIMUM OF 5.7 SQUARE FEET NET CLEAR OPENING AS PER IRC 2018 R310.2.1. EXCEPTION: GRADE FLOOR OR BELOW GRADE OPENINGS SHALL HAVE A MINIMUM NET CLEAR OPENING OF 5 SQUARE FEET. MAXIMUM SILL HEIGHT TO BE 44 INCHES. MINIMUM NET CLEAR OPENING WIDTH TO BE 20 INCHES.


11. ALL RETURN AIR GRILLS ARE TO BE LOCATED TO COMPLY WITH SECTION M1602 OF THE IRC 2018.

12. ALL SQUARE FOOTAGE MEASUREMENTS ARE APPROXIMATE AND MAY DIFFER FROM ACTUAL CONSTRUCTED RESIDENCE OR BUILDING.

13. FIRE SPRINKLER SYSTEM TO BE DESIGNED AND INSTALLED (IF REQUIRED BY LOCAL CODES) AS PER THE IRC 2018 AND BY A LICENSED PROFESSIONAL IN THE AREA OF CONSTRUCTION.

14. ALL BATHROOM EXHAUST VENTS SHALL BE VENTED DIRECTLY TO THE EXTERIOR OF THE HOME AND NOT INTO THE ATTIC. IRC 2018, M1505.2

AREAS:	3086	S.F. HEATED - NOT INCLUDING MASONRY
	525	S.F. UNHEATED - BONUS ROOM
	285	S.F. UNHEATED - FRONT PORCH
	890	S.F. UNHEATED - GARAGE
	403	S.F. UNHEATED - REAR PORCH
	30	S.F. UNHEATED - STORAGE
	2133	S.F. UNHEATED - TOTAL
	5219	S.F. TOTAL UNDER ROOF

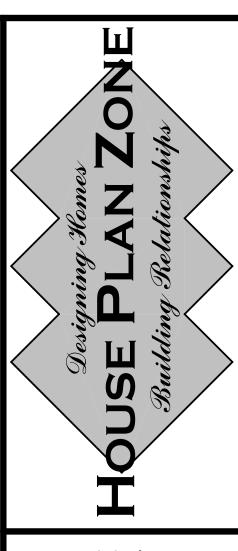

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mpletion of these construction
n Zone, LLC. assumes no
s in the design.
er in the area of construction,
comply to seismic, wind and
struction. If a foundation plan

deficit in the development of these plans and the completion puilding codes and site specific conditions, House Plan Zone, failures resulting from errors, omissions or deficiencies in the second plans to the second plans and second plans to the s

House Plan Zone, LLC. has exercised documents. However, due to the great responsibility for any damages, includir House Plan Zone, LLC. highly recommin addition to your local building officials other special conditions required by local body.


ate: 09/24/19

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Drawn By: R.B.M.

Project Name:

SHEET NUMBER

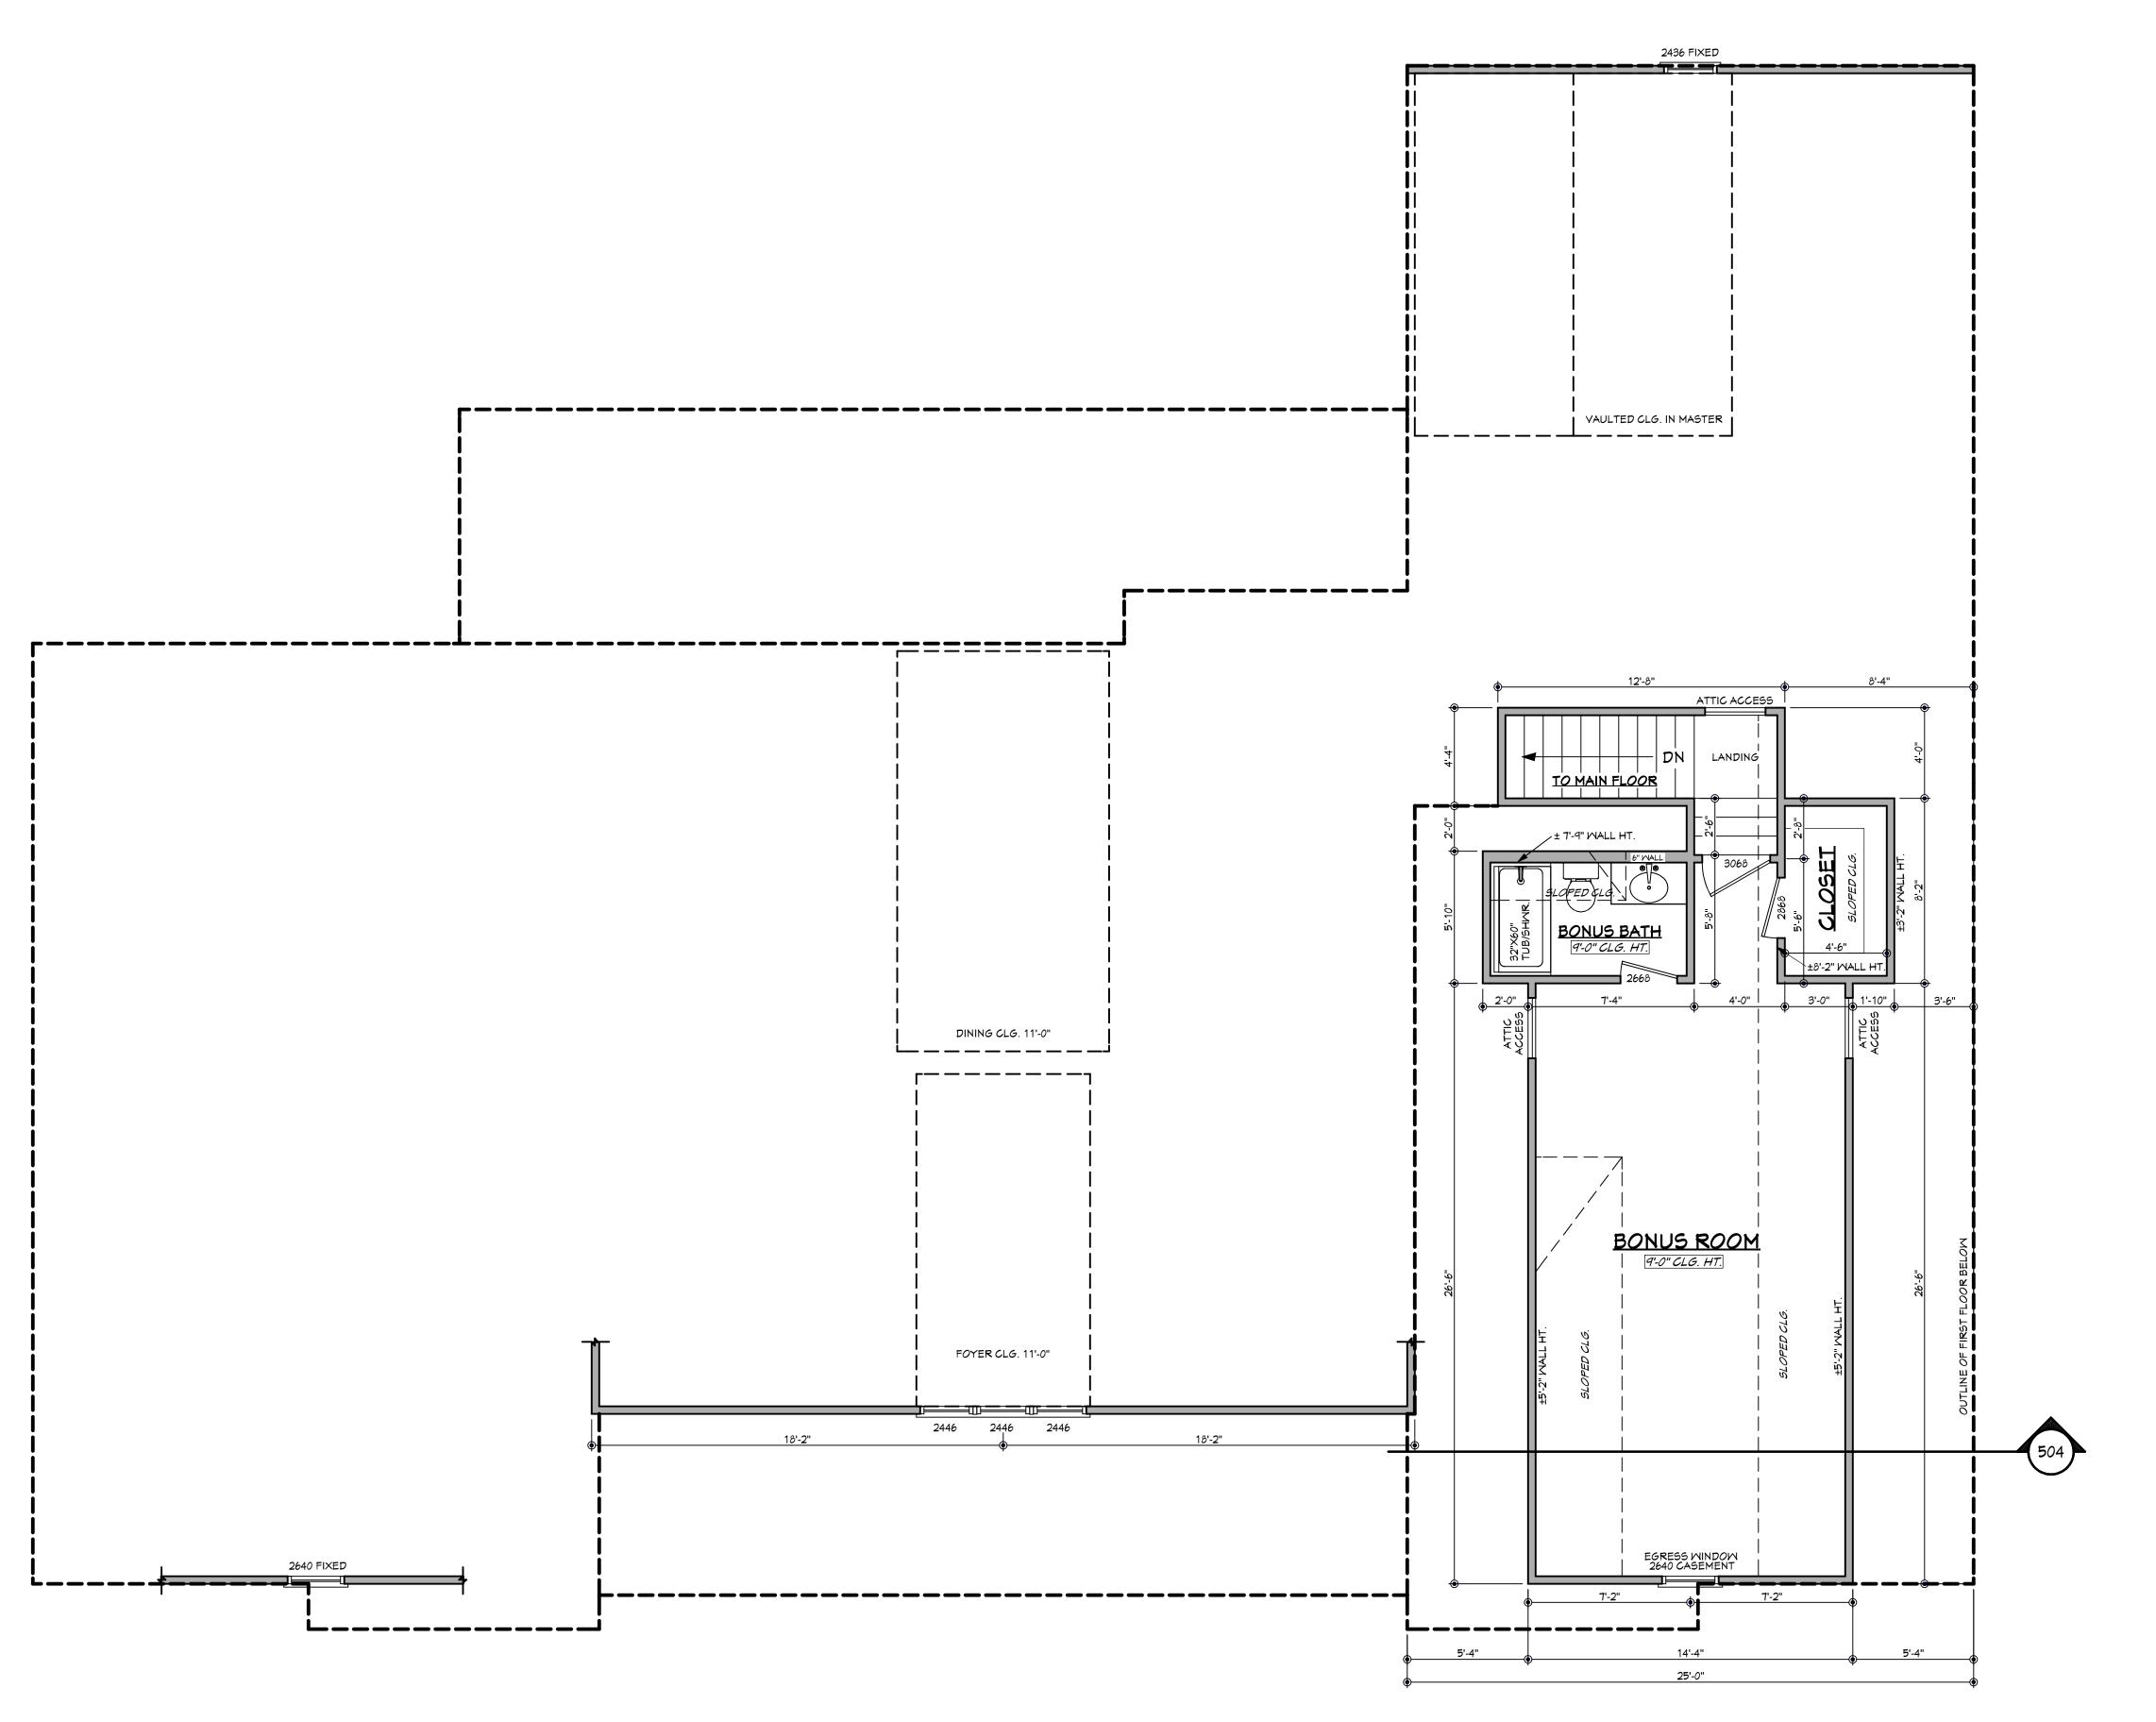

BONUS ROOM FLOOR PLAN

NOTES:

1. ALL DIMENSIONS & SITE CONDITIONS TO BE VERIFIED BY CONTRACTOR PRIOR TO CONSTRUCTION. 2. ALL FINISHES (INTERIOR & EXTERIOR) TO BE VERIFIED

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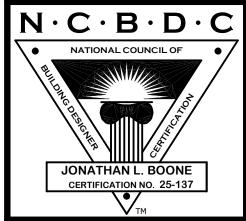
14. ALL BATHROOM EXHAUST VENTS SHALL BE VENTED DIRECTLY TO THE EXTERIOR OF THE HOME AND NOT INTO THE ATTIC. IRC 2018, M1505.2

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sales@hpzplans.com

Phone: 601.336.3254


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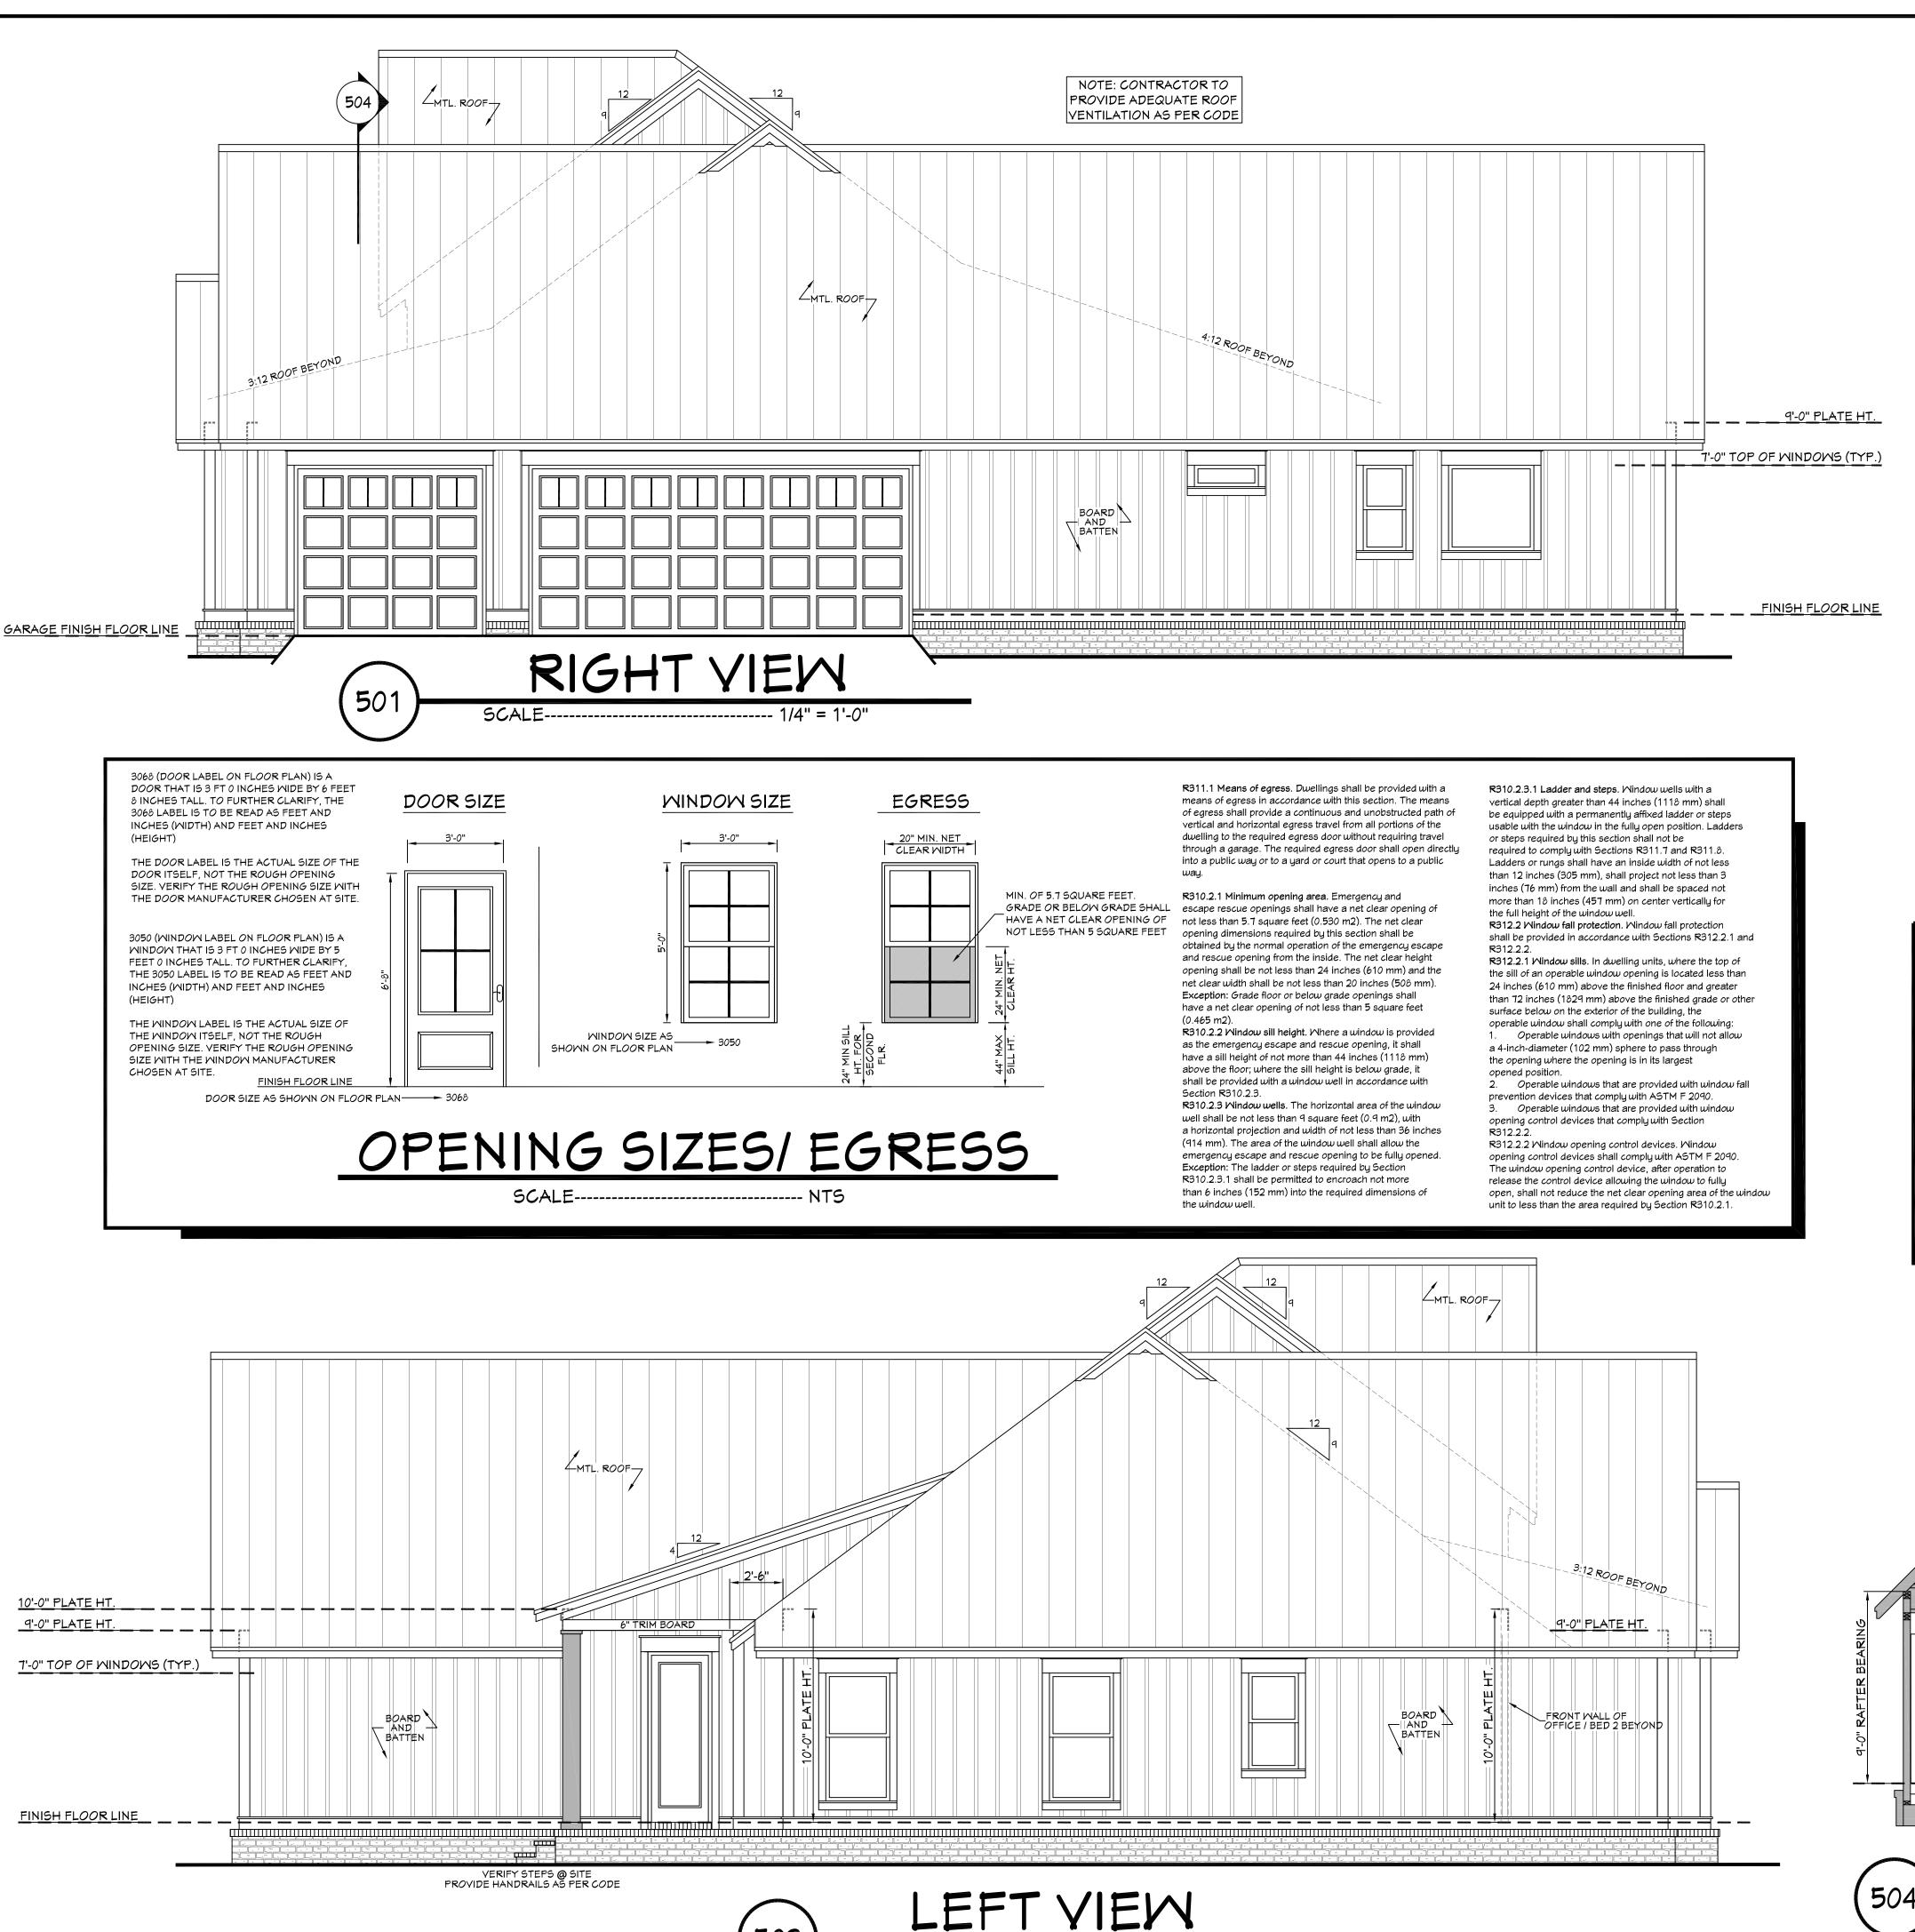



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R.B.M.

SHEET NUMBER





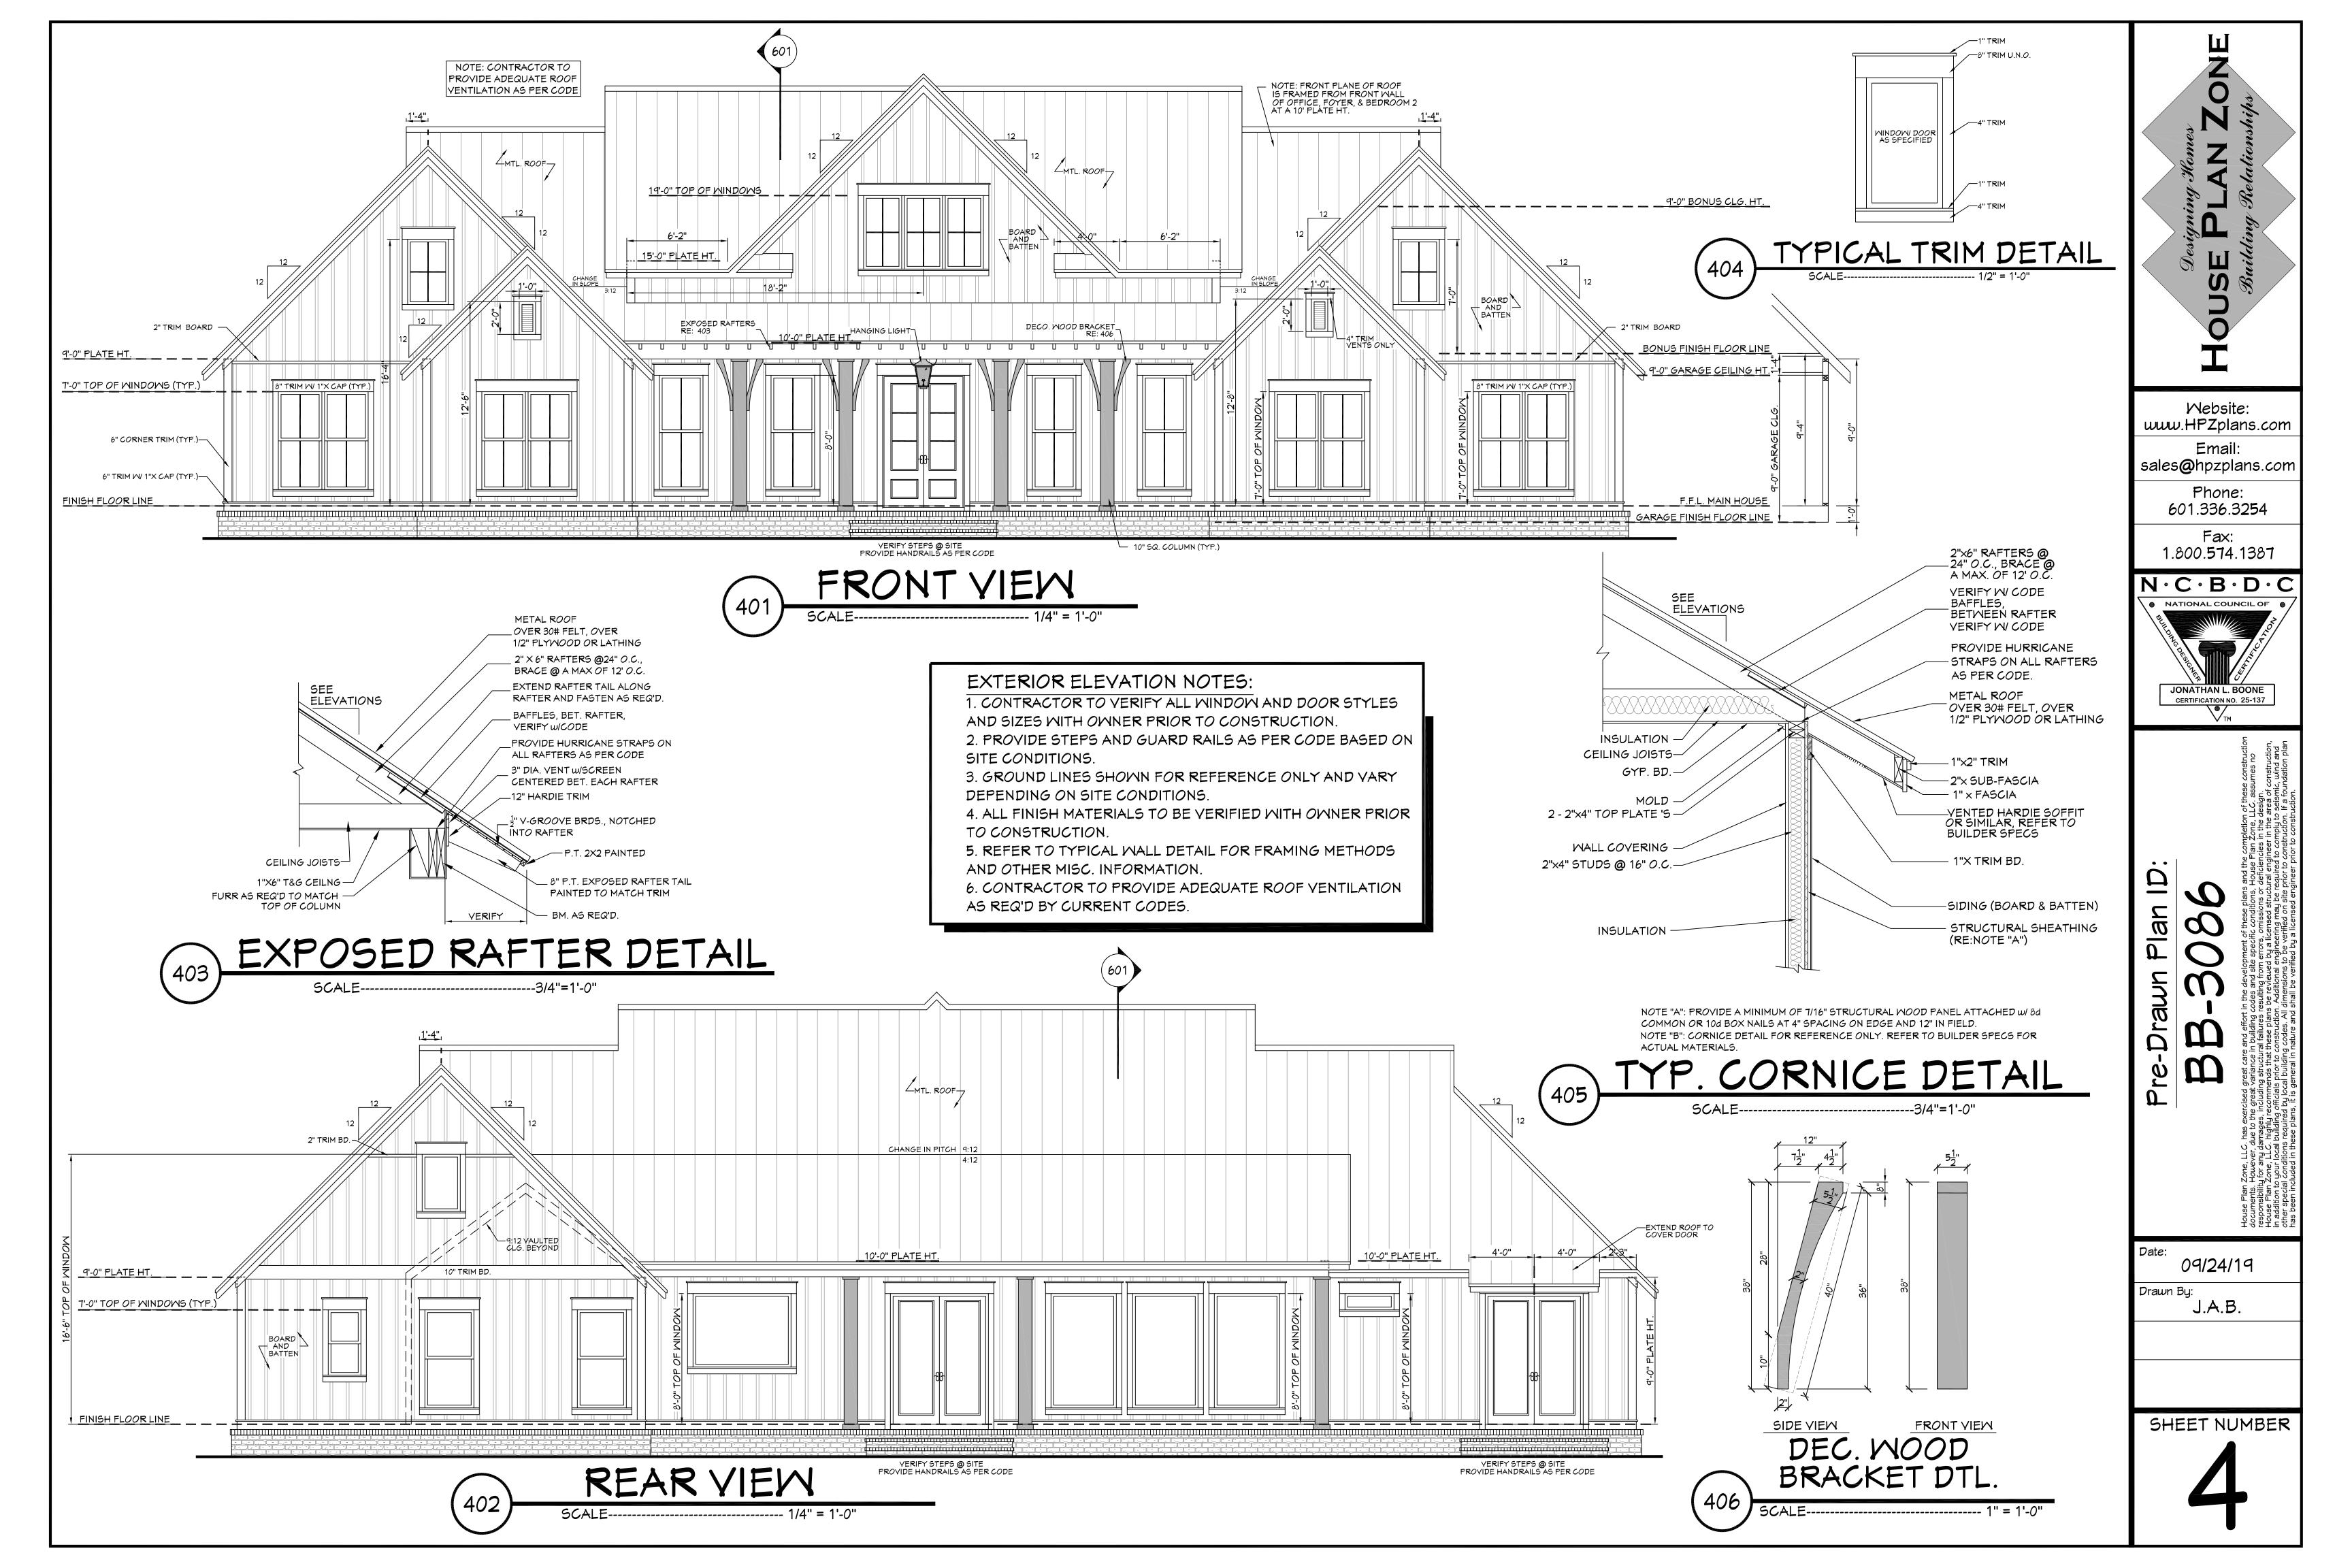

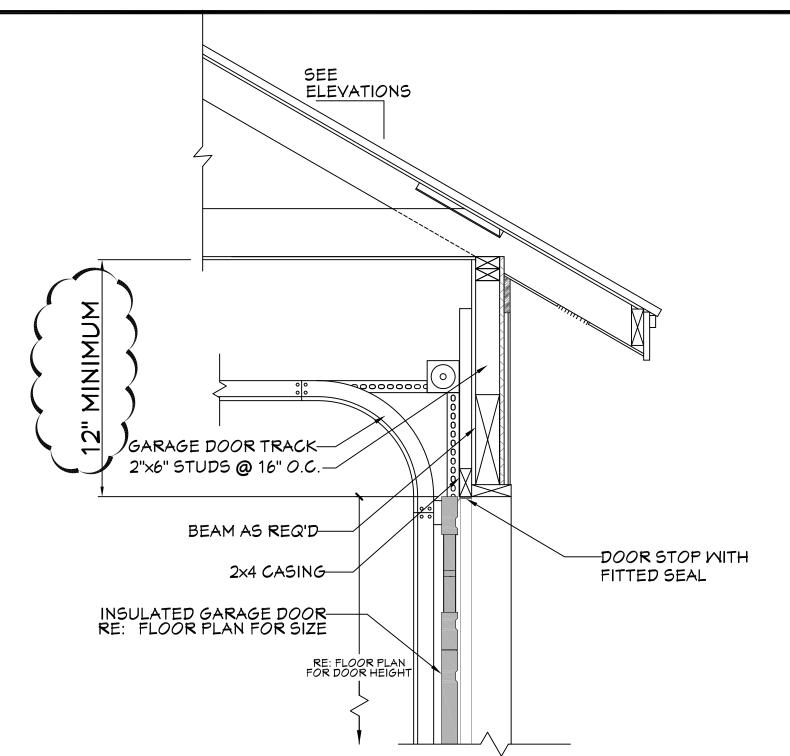GARAGE DOOR CLEARANCE


SCALE----- N.T.S.

THE INTENT OF THIS DETAIL IS TO SHOW THE MINIMUM REQUIRED DISTANCE FROM THE TOP OF THE GARAGE DOOR OPENING TO THE CEILING OF THE GARAGE.

EXTERIOR ELEVATION NOTES:

1. CONTRACTOR TO VERIFY ALL WINDOW AND DOOR STYLES AND SIZES WITH OWNER PRIOR TO CONSTRUCTION.

- 2. PROVIDE STEPS AND GUARD RAILS AS PER CODE BASED ON SITE CONDITIONS.
- 3. GROUND LINES SHOWN FOR REFERENCE ONLY AND VARY DEPENDING ON SITE CONDITIONS.
- 4. ALL FINISH MATERIALS TO BE VERIFIED WITH OWNER PRIOR TO CONSTRUCTION.
- 5. REFER TO TYPICAL WALL DETAIL FOR FRAMING METHODS AND OTHER MISC. INFORMATION.
- 6. CONTRACTOR TO PROVIDE ADEQUATE ROOF VENTILATION AS REQ'D BY CURRENT CODES.

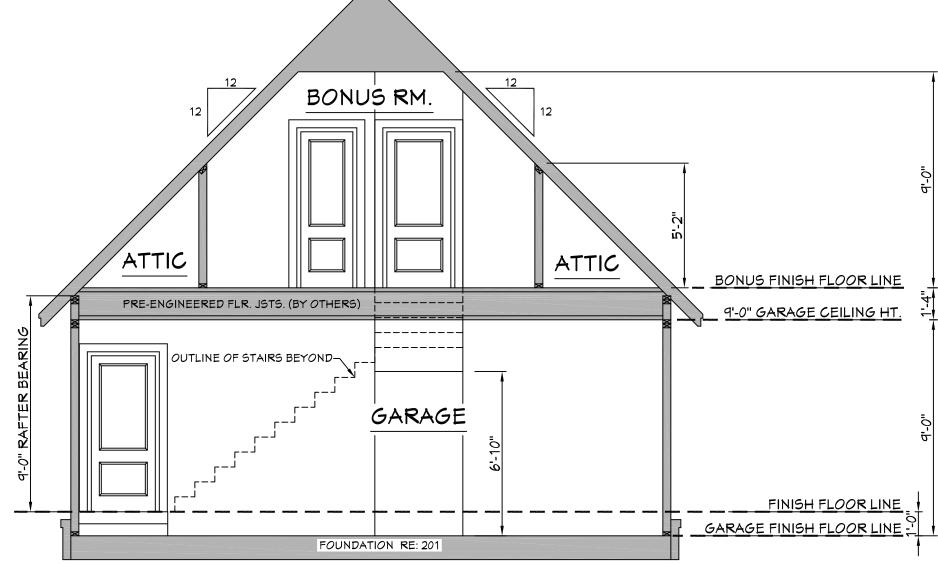

GARAGE SECTION

SCALE------1/4"=1'-0"

Designing Homes

HOUSE PLAN ZONE


Building Relationships

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Email: sales@hpzplans.com Phone:

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Te-Drawn Plan ID:

BB-3086

great care and effort in the development of these plans and the completion of

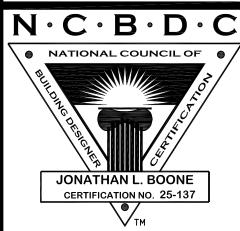· 09/24/19

J.A.B.

SHEET NUMBER

5

CEILING JOIST SPANS

CEILING JOIST SPANS FOR SOUTHERN PINE SPECIES (UNINHABITABLE ATTICS WITH LIMITED STORAGE LIVE LOAD = 20psf, L/\triangle =240) DEAD LOAD = 10psf)

> INTERIOR SPACING -

***IF HABITABLE ATTIC SPACE IS DESIRED,
REFER TO THE INTERNATIONAL RESIDENTIAL CODE, SPAN TABLES.***

REFER TO THE INTERNATIONAL RESIDENTIAL CODE, SPAN TABLES.***				
SIZE	SPACING (INCHES)	VISUALLY GRADED #2 SOUTHERN PINE (MAXIMUM CEILING JOIST SPANS) (FT IN.)		
	12.0	9-3		
2×4	16.0	8-0		
- ~ 1	19.2	7-4		
	24.0	6-7		
	12.0	13-11		
2×6	16.0	12-0		
2.0	19.2	11-0		
	24.0	9-10		
	12.0	17-7		
2a	16.0	15-3		
2×8	19.2	13-11		
	24.0	12-6		
	12.0	20-11		
2 × 10	16.0	18-1		
2 × 10	19.2	16-6		
	24.0	14-9		

The above tables are based on the IRC 2018 TABLE R802.5.1(2)

RAFTER SPANS

RAFTER SPANS FOR SOUTHERN PINE SPECIES LIVE LOAD=30psf, L/A=180 DEAD LOAD = 10psf

SIZE	SPACING (INCHES)	SPANS (MAXIMUM RAFTER SPANS BETWEEN BRACING) (FT IN.)
. 0	12.0	12-11
×	16.0	11-2
5	19.2	10-2
	24.0	9-2
	12.0	16-4
8	16.0	14-2
×	19.2	12-11
2	24.0	11-7
0	12.0	19-5
× 10	16.0	16-10
	19.2	15-4
7	24.0	13-9
2	12.0	22-10
× 12	16.0	19-10
×	19.2	18-1
7	24.0	16-2


NOTES:

The above tables are based on the IRC 2018 TABLE R802.4.1(3)

HIP/ VALLEY CONVERSION THEN HIP/ VALLEY RAFTER ROOF RAFTER ROOF PITCH BECOMES. PITCH IS ... RISE/ RUN SLOP 1/17 1/12 2/17 2/12 3/12 3/17 4/17 4/12 5/12 5/17 6/17 6/12 7/17 7/12 8/17 8/12 9/12 9/17 10/12 10/17 11/12 11/17 42° 12/17 CONVERSION CHART FOR SIMPLE ROOFS ONLY.

CHART DOES NOT APPLY FOR DUAL PITCH ROOFS.

RAFTER LENGTH CHART					
ROOF PITCH		FACTOR			
3/12		1.05			
4/12		1.07			
5/12		1.10			
6/12		1.14			
7/12		1.17			
8/12		1.20			
9/12		1.25			
10/12		1.30			
11/12		1.35			
12/12		1.40			
14/12		1.54			
16/12		1.70			

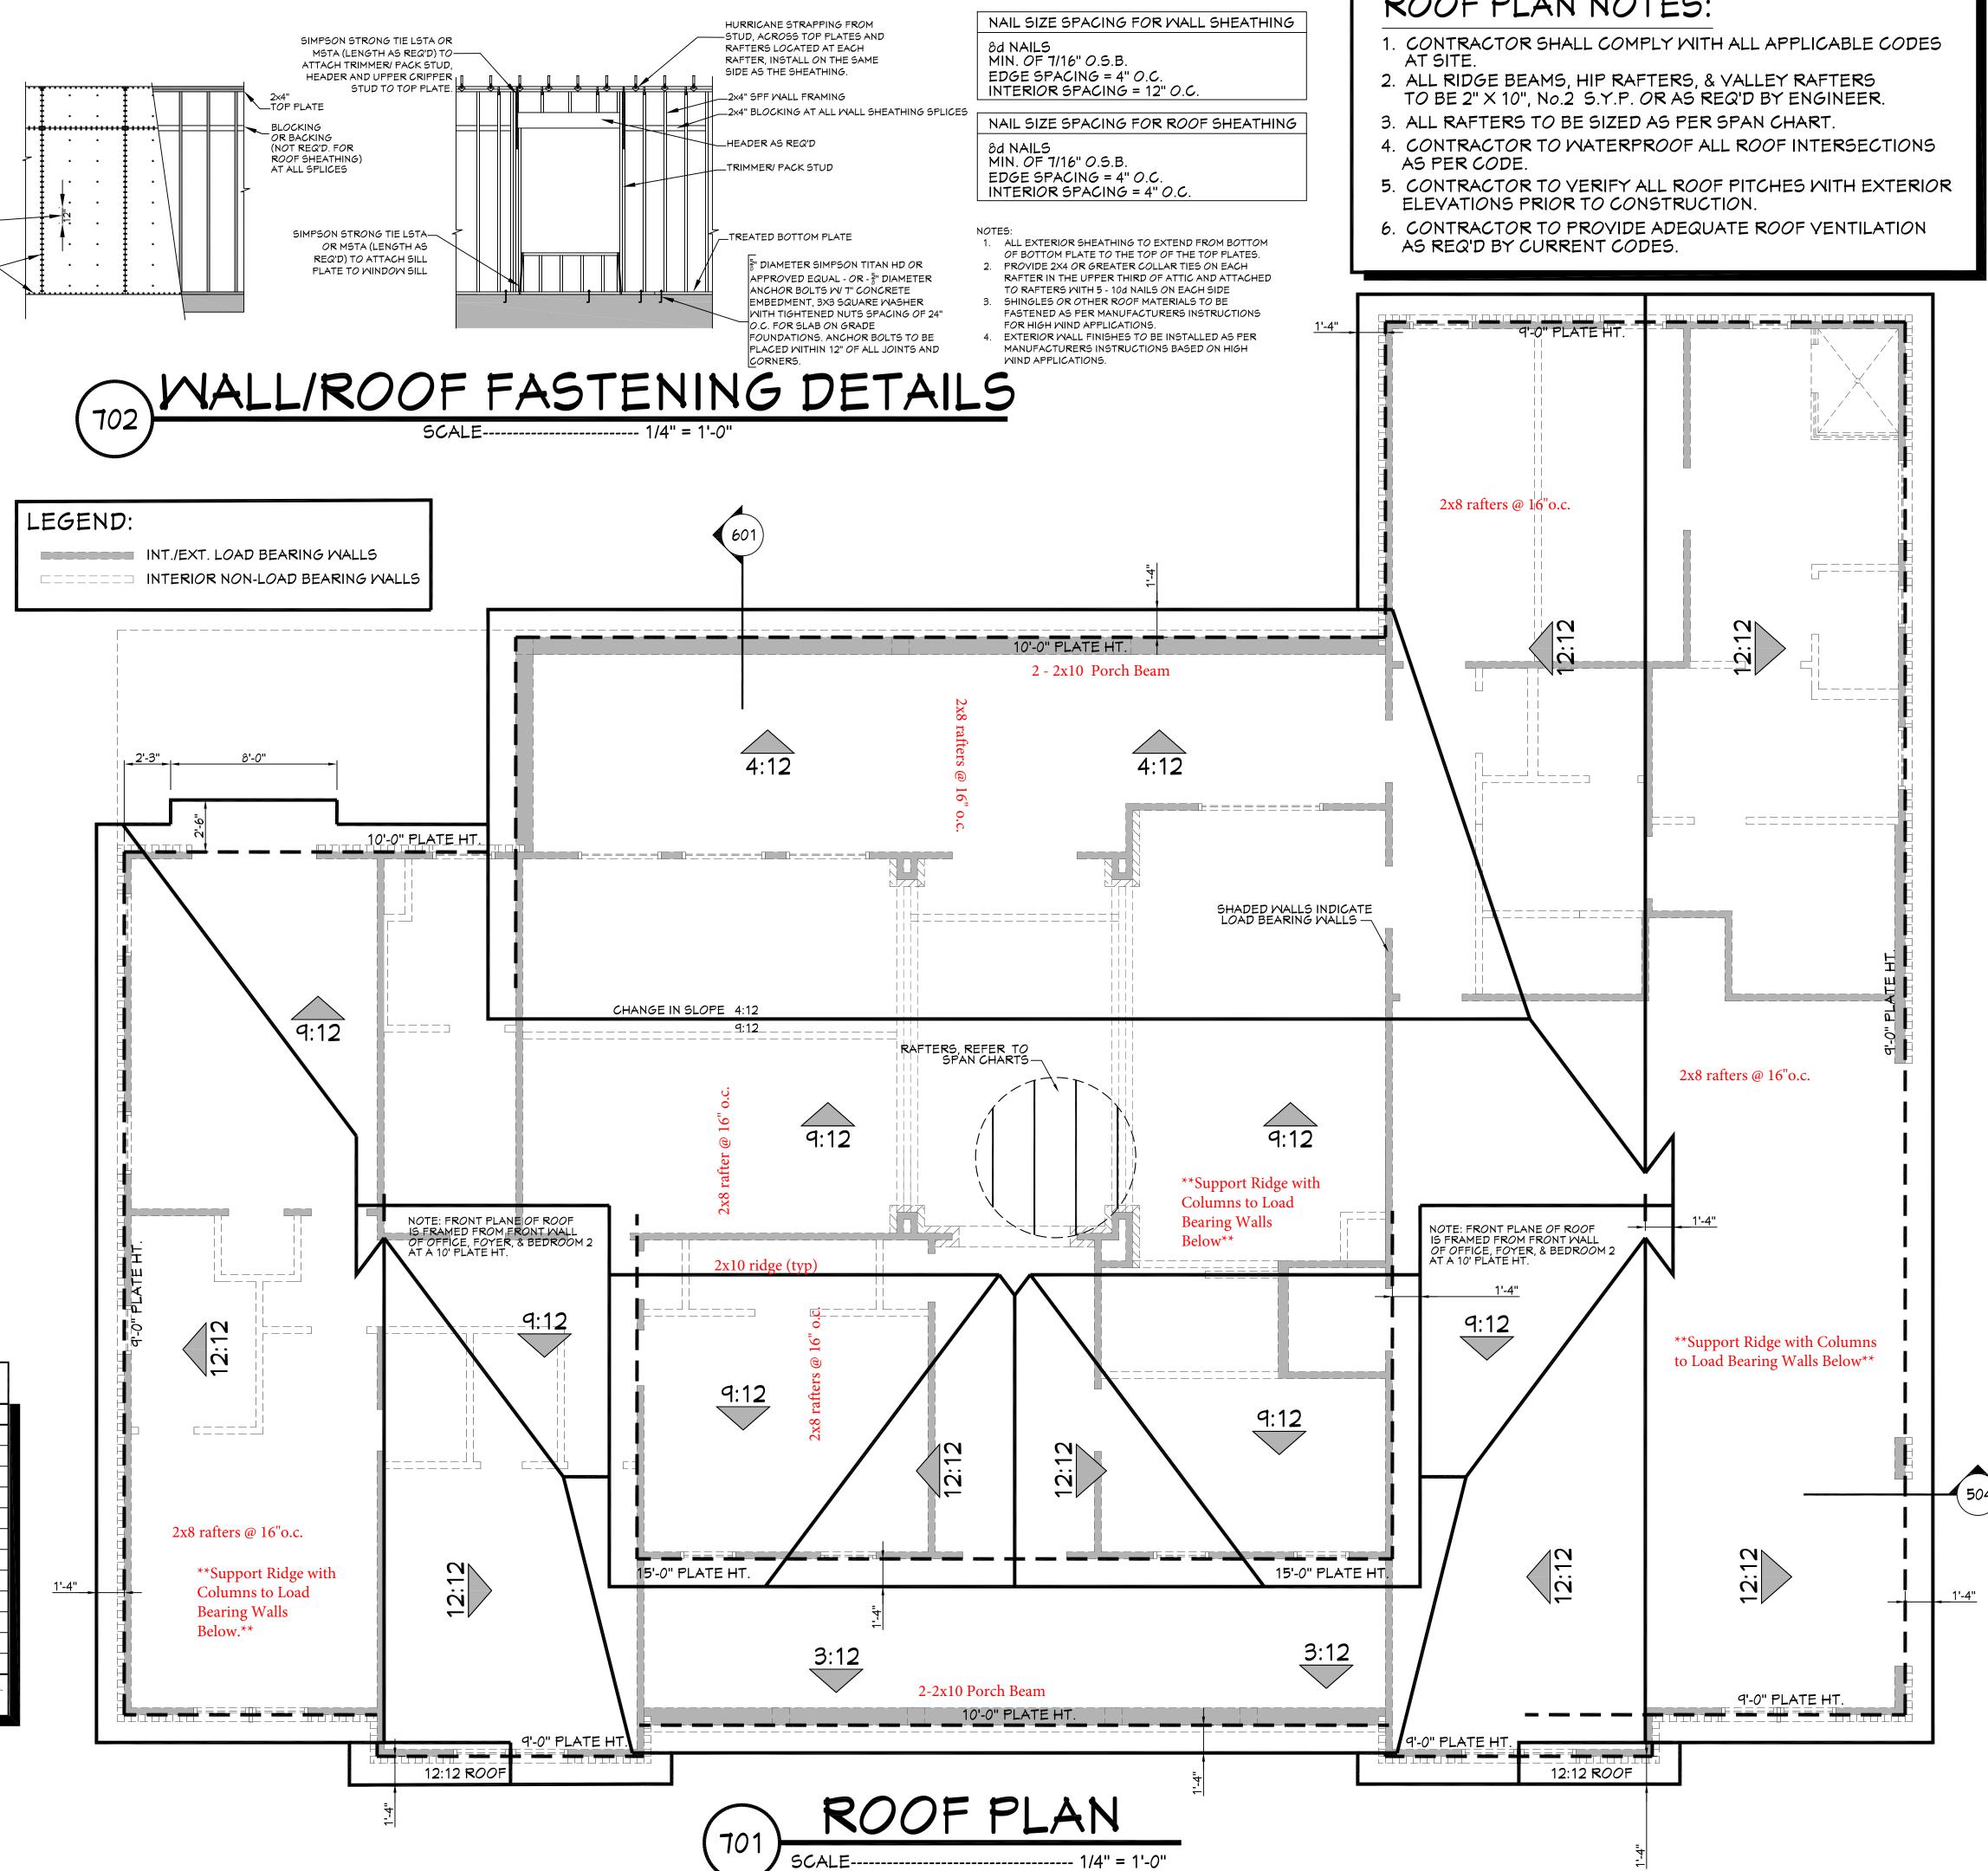

ROOF PLAN NOTES:


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Email: sales@hpzplans.com Phone:

> Fax: 1.800.574.1387

601.336.3254



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09/24/19

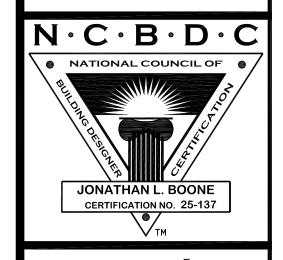Drawn By:

SHEET NUMBER