
PLANS DESIGNED TO THE 2018 NORTH CAROLINA STATE RESIDENTIAL BUILDING CODE.

RIDGE VENT (TYP.) SITE REQUIREMENTS. 1 x 4 FRIEZE BOARD AS SPEC. (TYP. FRONT ELEVATION ONLY) SIDING AS SPEC. (TYP.)-SHINGLES AS SPEC. (TYP.)-14" SHUTTERS AS SPEC. (TYP.) -CORNER BOARD 8'-1 1/2"" CLG. HGT. AS SPEC. (TYP.) 24'-Ø 1/2" TEAN ROOF + SHINGLES AS SPEC. (TYP.)-EXTERIOR LIGHT AS SPEC. (TYP.) EXTERIOR LIGHT AS SPEC. (TYP.) -1 x 4 TRIM AS SPEC. (TYP.)-9'-1 1/2"" CLG. HGT 12" TAPERED COLUMN ON 16" x 16" x 36" GARAGE DOOR AS SPEC. WITH STONE BASE AS SPEC. (TYP.) OPTIONAL HARDWARE OPTIONAL CULTURED CULTURED STONE AS SPEC. (TYP.) -STONE SKIRT (SHOWN)

FRONT ELEVATION-A SCALE: 1/4" = 1'-0"

STEPS PER GRADE AS REQ.

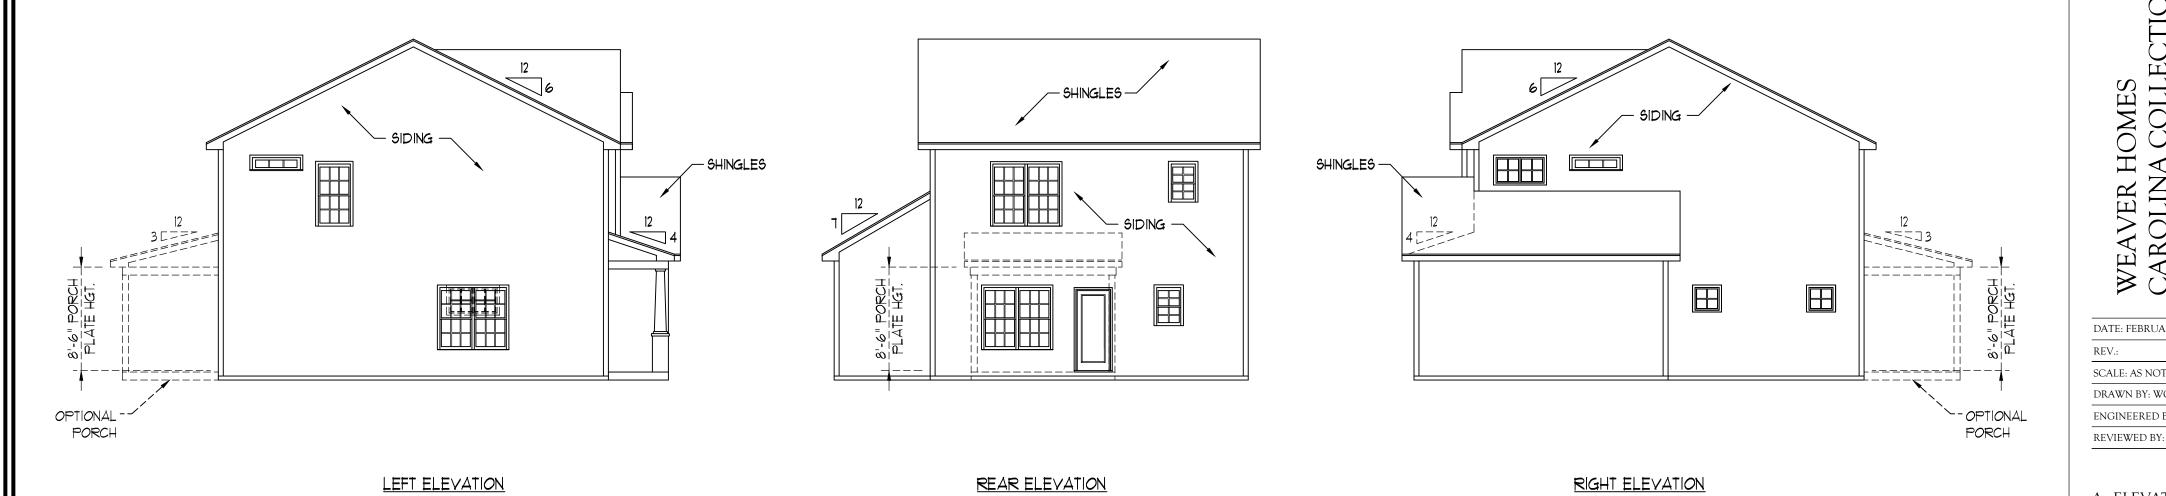

SCALE: 1/8" = 1'-0"

SCALE: 1/8" = 1'-0"

- 1. ALL WORK SHALL BE PERFORMED IN ACCORDANCE WITH ALL APPLICABLE NATIONAL, STATE, AND LOCAL CODES AND REGULATIONS.
- 2. CONTRACTOR SHALL THOROUGHLY REVIEW ALL SHEETS IN PLAN SET AND VERIFY ALL DETAILS AND DIMENSIONS BEFORE BEGINNING CONSTRUCTION. ANY DISCREPANCIES SHALL BE REPORTED TO RENAISSANCE RESIDENTIAL DESIGN, INC. FOR JUSTIFICATION AND/OR CORRECTION BEFORE PROCEEDING WITH WORK. CONTRACTORS SHALL ASSUME RESPONSIBILITY FOR ERRORS THAT ARE NOT REPORTED PRIOR TO CONSTRUCTION.
- 3. ALL DIMENSIONS SHOULD BE READ OR CALCULATED AND NEVER SCALED.
- 4. CONTRACTOR SHALL ENSURE COMPATIBILITY OF THE BUILDING WITH ALL

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DATE: FEBRUARY 19, 2021

SCALE: AS NOTED

DRAWN BY: WG ENGINEERED BY:

A - ELEVATIONS

A-1

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SCALE: 1/8" = 1'-0"

PLANS DESIGNED TO THE 2018 NORTH CAROLINA STATE RESIDENTIAL BUILDING CODE.

STONE BASE AS SPEC. (TYP.)


CULTURED STONE AS SPEC. (TYP.) -

SCALE: 1/8" = 1'-0"

RIDGE VENT (TYP.) SITE REQUIREMENTS. 1 x 4 FRIEZE BOARD AS SPEC. (TYP. FRONT ELEVATION ONLY) SIDING AS SPEC. (TYP.)-SHINGLES AS SPEC. (TYP.)-14" SHUTTERS AS SPEC. (TYP.) -CORNER BOARD 8'-1 1/2"" CLG. HGT. AS SPEC. (TYP.) 24'-Ø 1/2" TEAN ROOF + SHINGLES AS SPEC. (TYP.)-EXTERIOR LIGHT AS SPEC. (TYP.) EXTERIOR LIGHT AS SPEC. (TYP.) -9'-1 1/2"" CLG. HGT 1 x 4 TRIM AS SPEC. (TYP.)-8" SQUARE COLUMN ON 16" x 16" x 36"

FRONT ELEVATION-B SCALE: 1/4" = 1'-0"

STEPS PER GRADE AS REQ.

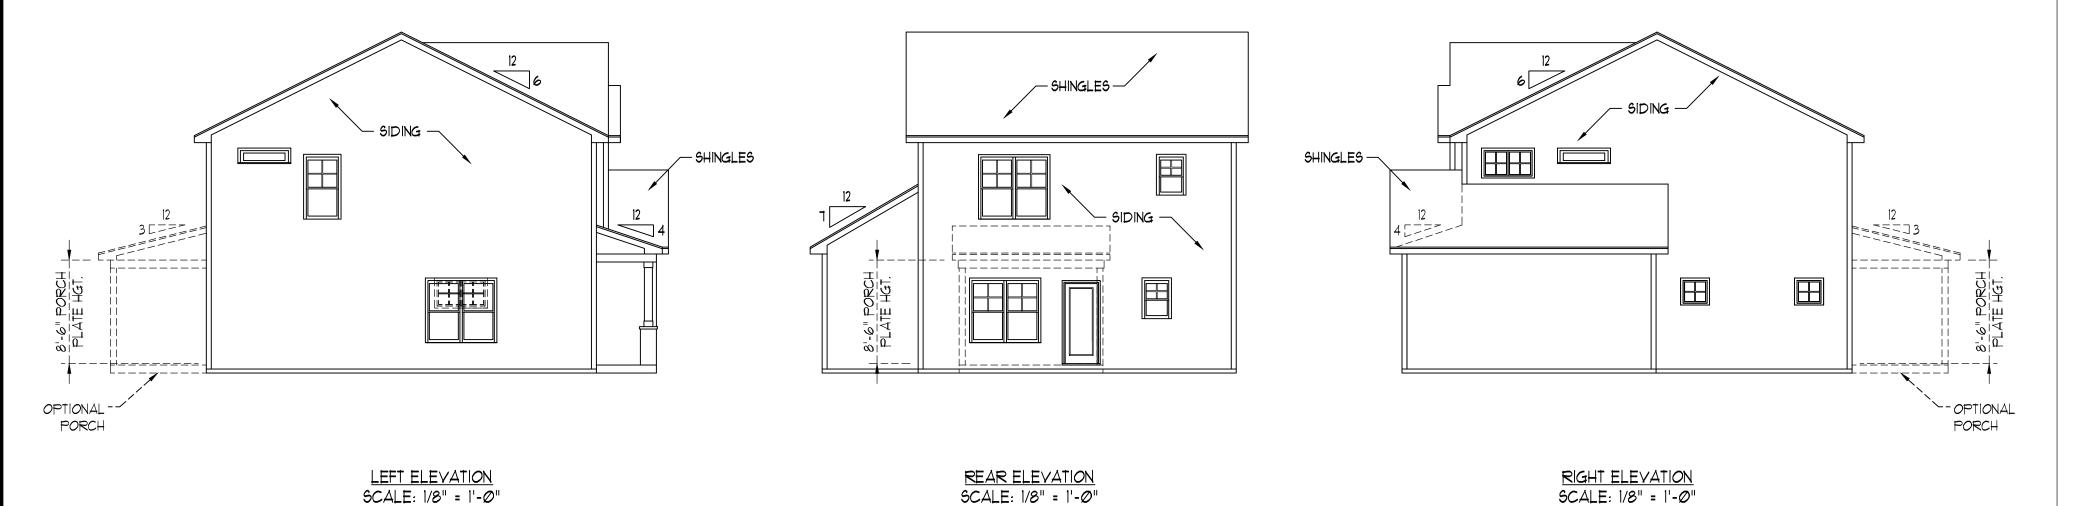

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- 3. ALL DIMENSIONS SHOULD BE READ OR CALCULATED AND NEVER SCALED.
- 4. CONTRACTOR SHALL ENSURE COMPATIBILITY OF THE BUILDING WITH ALL

GARAGE DOOR AS SPEC. WITH

OPTIONAL HARDWARE

OPTIONAL CULTURED

STONE SKIRT (SHOWN)

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DATE: FEBRUARY 19, 2021

SCALE: AS NOTED DRAWN BY: WG

ENGINEERED BY: REVIEWED BY:

B - ELEVATIONS

A-2

PLANS DESIGNED TO THE 2018 NORTH CAROLINA STATE RESIDENTIAL BUILDING CODE.

EXTERIOR LIGHT AS SPEC. (TYP.) -

8" SQUARE COLUMN ON 16" x 16" x 36"

SCALE: 1/8" = 1'-0"

1 x 4 TRIM AS SPEC. (TYP.)-

STONE BASE AS SPEC. (TYP.)


CULTURED STONE AS SPEC. (TYP.) -

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FRONT ELEVATION-C

SCALE: 1/4" = 1'-0"

STEPS PER GRADE AS REQ.

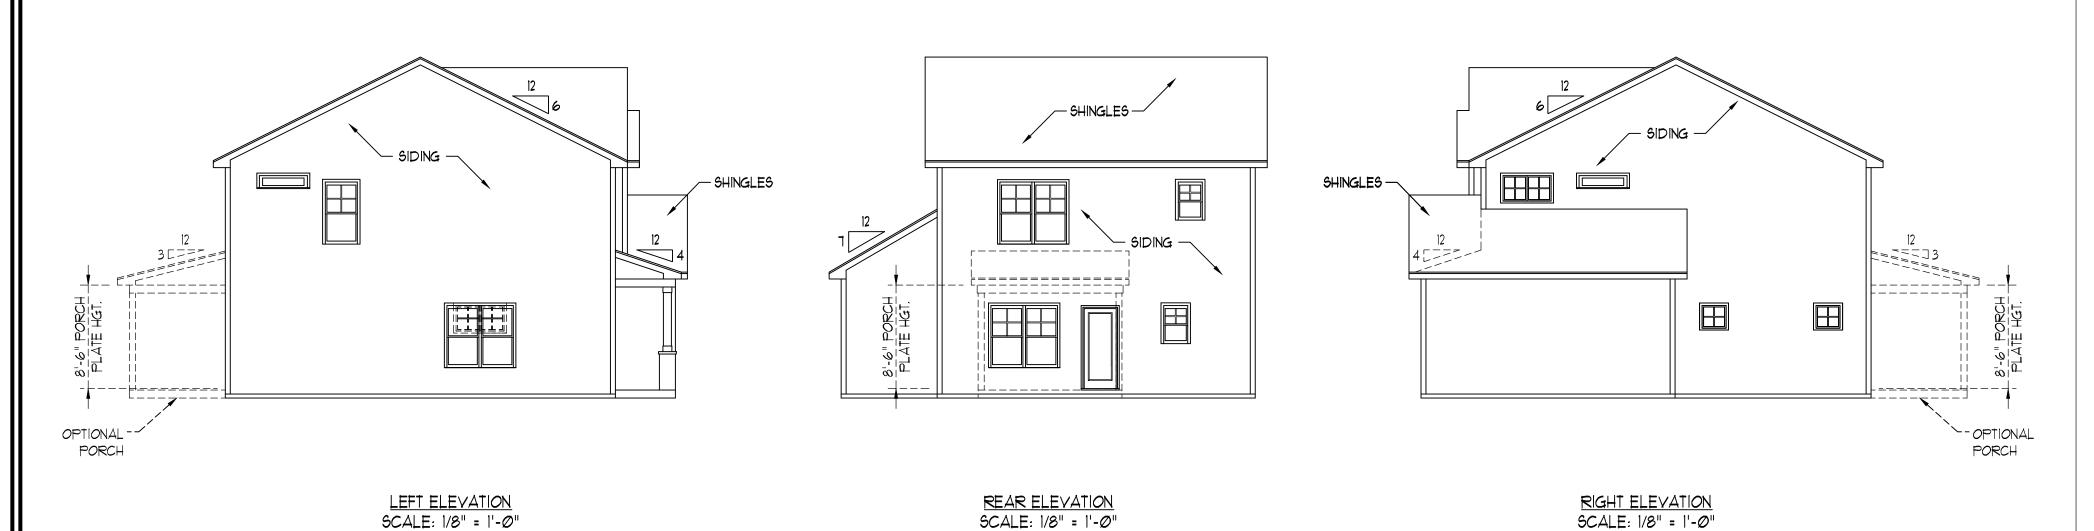

SCALE: 1/8" = 1'-0"

9'-1 1/2"" CLG. HGT

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GARAGE DOOR AS SPEC. WITH

OPTIONAL HARDWARE

OPTIONAL CULTURED

STONE SKIRT (SHOWN)

FOR ERRORS THAT ARE NOT REPORTED PRIOR TO CONSTRUCTION. 3. ALL DIMENSIONS SHOULD BE READ OR CALCULATED AND NEVER SCALED.

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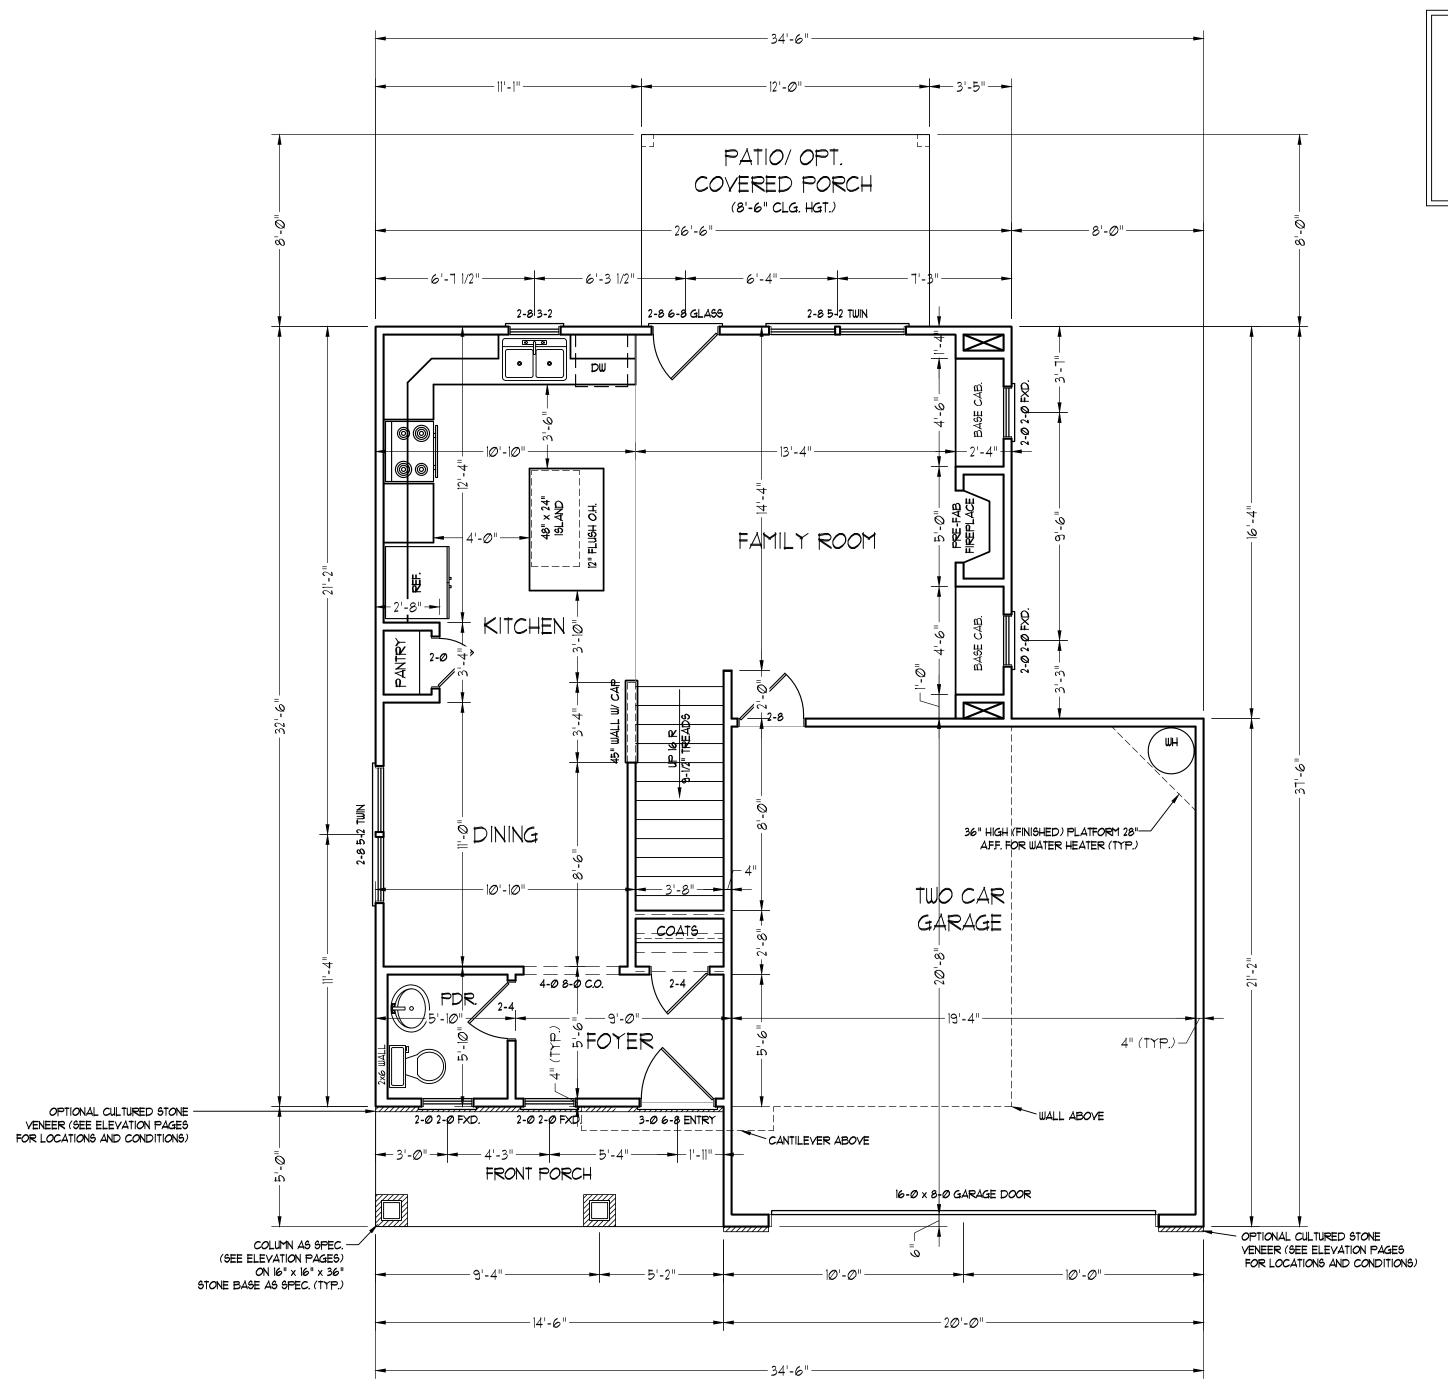
SCALE: 1/4" = 1'-0" DRAWN BY: WG

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C - ELEVATIONS

A-3

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SQUARE FOOTAGE (IF.S.)

 Ist FLOOR:
 639 SQ. FT.

 2nd FLOOR:
 195 SQ. FT.

 TOTAL:
 1434 SQ. FT.

 GARAGE:
 393 SQ. FT.

 FRONT PORCH:
 13 SQ. FT.

 STD. REAR PATIO:
 96 SQ. FT.

 OPT. REAR PORCH:
 96 SQ. FT.



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WEAVER HOMES CAROLINA COLLECTIO) HICKORY-II

DATE: FEBRUARY 19, 2021

REV.:

SCALE: 1/4" = 1'-0"

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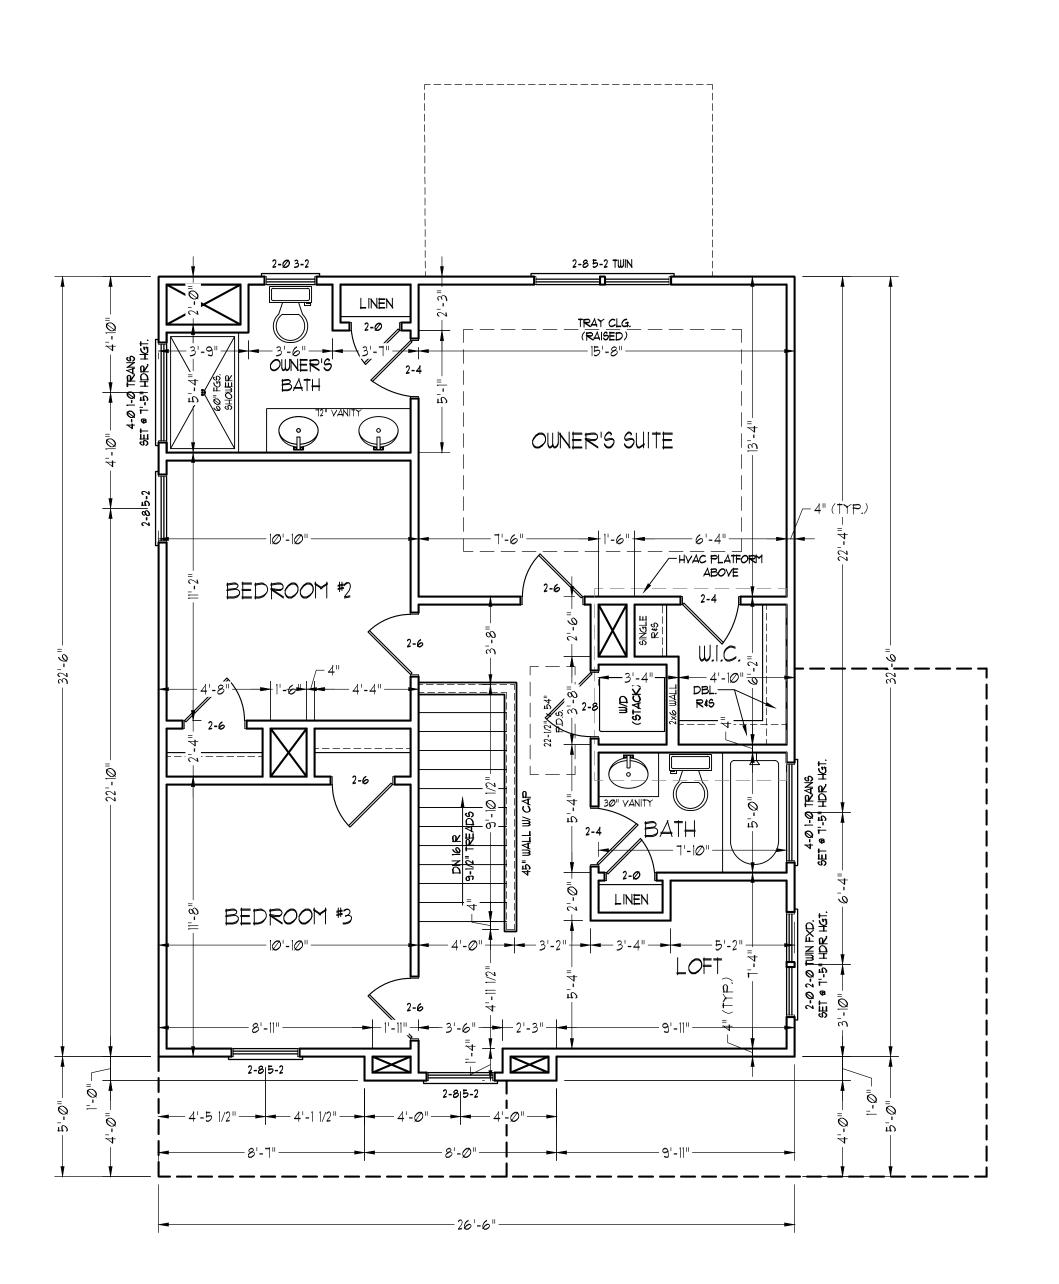
REVIEWED BY:

FIRST FLOOR PLAN

A-4

SCALE NOTE: 18x24 PRINTS ARE TO SCALE AS NOTED.

11x17 PRINTS ARE NOT TO SCALE





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WEAVER HOMES CAROLINA COLLECTION HICKORY-II

DATE: FEBRUARY 19, 2021

REV.:

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DRAWN BY: WG

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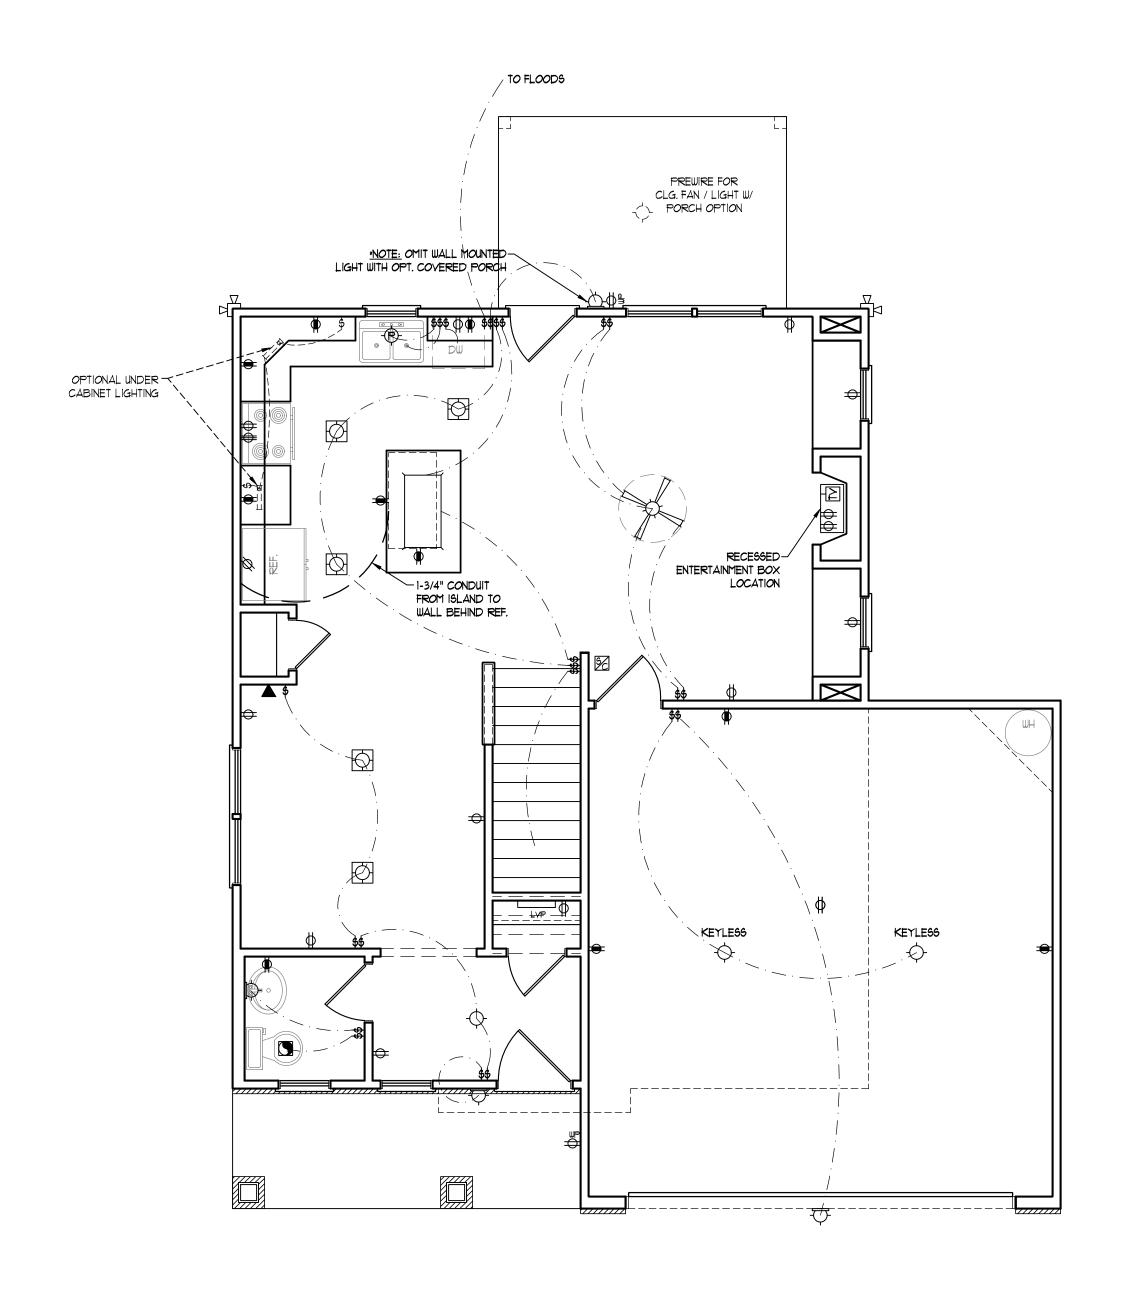
REVIEWED BY:

SECOND FLOOR PLAN

A-5

SCALE NOTE: 18x24 PRINTS ARE TO SCALE AS NOTED.

11x17 PRINTS ARE NOT TO SCALE



ELECTRICAL LAYOUT NOTES:

- 1.) BLOCK AND WIRE FOR ALL CELING FANS PER PLAN.
- 2.) VANITY LIGHTS TO BE SET 9 90" AFF. (TYP.)
- 3.) ADDITIONAL EXTERIOR OUTLETS REQUIRED BY CODE TO BE LOCATED BY ELECTRICIAN.
- 4.) PLACE SWITCHES 8" (MIN.) FROM ROUGH OPENINGS.

ELECTRICAL LEGEND

- → IIØ ∨ OUTLET
- ₩ 110 Y GFI OUTLET
- → 110 V SWITCHED OUTLET
- BB == 110 Y BASEBOARD OUTLET
- 4-PLEX
- COUNTER OR FLOOR MOUNTED
- COUNTER OR FLOOR MOUNTED 110V GF1
- ₩EATHERPROOF
- **⇒** 220 ∨ OUTLET
- Ø 110 V DEDICATED CIRCUIT
- # 220 Y DEDICATED CIRCUIT
- SPECIAL PURPOSE (240 V, ETC.)
- WALL MOUNT LIGHT
- CEILING MOUNT LIGHT
- -P- PENDANT LIGHT
- RECESSED CAN LIGHT
- MINI CAN LIGHT
- EYEBALL LIGHT

FLUORESCENT LIGHT

undercabinet light

FLOOD LIGHT

- 5 SWITCH
- \$D DIMMER SWITCH
- ▲ TELEPHONE
- TELEPHONE AND DATA
- TV- TV CONNECTION
- PT- TV/ DAT
- CD- CONDUIT FOR COMPONENT WIRING
- SP SPEAKER
- MOV SMOKE/CM DETECTOR
- 6D 110 V SMOKE DETECTOR
- EXHAUST FAN



ALART FANEL



CEILING FAN W/ LIGH

SCALE NOTE: 18x24 PRINTS ARE TO SCALE AS NOTED.

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WEAVER HOMES CAROLINA COLLECTIC HICKORY-II

DATE: FEBRUARY 19, 2021

REV.:

SCALE: 1/4" = 1'-0"

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ENGINEERED BY:


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PLAN

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ELECTRICAL LAYOUT NOTES:

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ELECTRICAL LEGEND

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- € 110 V GFI OUTLET
- = 110 Y SWITCHED OUTLET
- $_{\mathrm{BB}}$ \Longrightarrow 110 $_{\mathrm{V}}$ BASEBOARD OUTLET
- 4-PLEX
- COUNTER OR FLOOR MOUNTED
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- ₩EATHERPROOF
- **⇒** 22Ø ∨ OUTLET
- Ø 110 V DEDICATED CIRCUIT
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- PH SPECIAL PURPOSE (240 V, ETC.)
- WALL MOUNT LIGHT
- -P- PENDANT LIGHT
- RECESSED CAN LIGHT
- MINI CAN LIGHT
- EYEBALL LIGHT

FLUORESCENT LIGHT

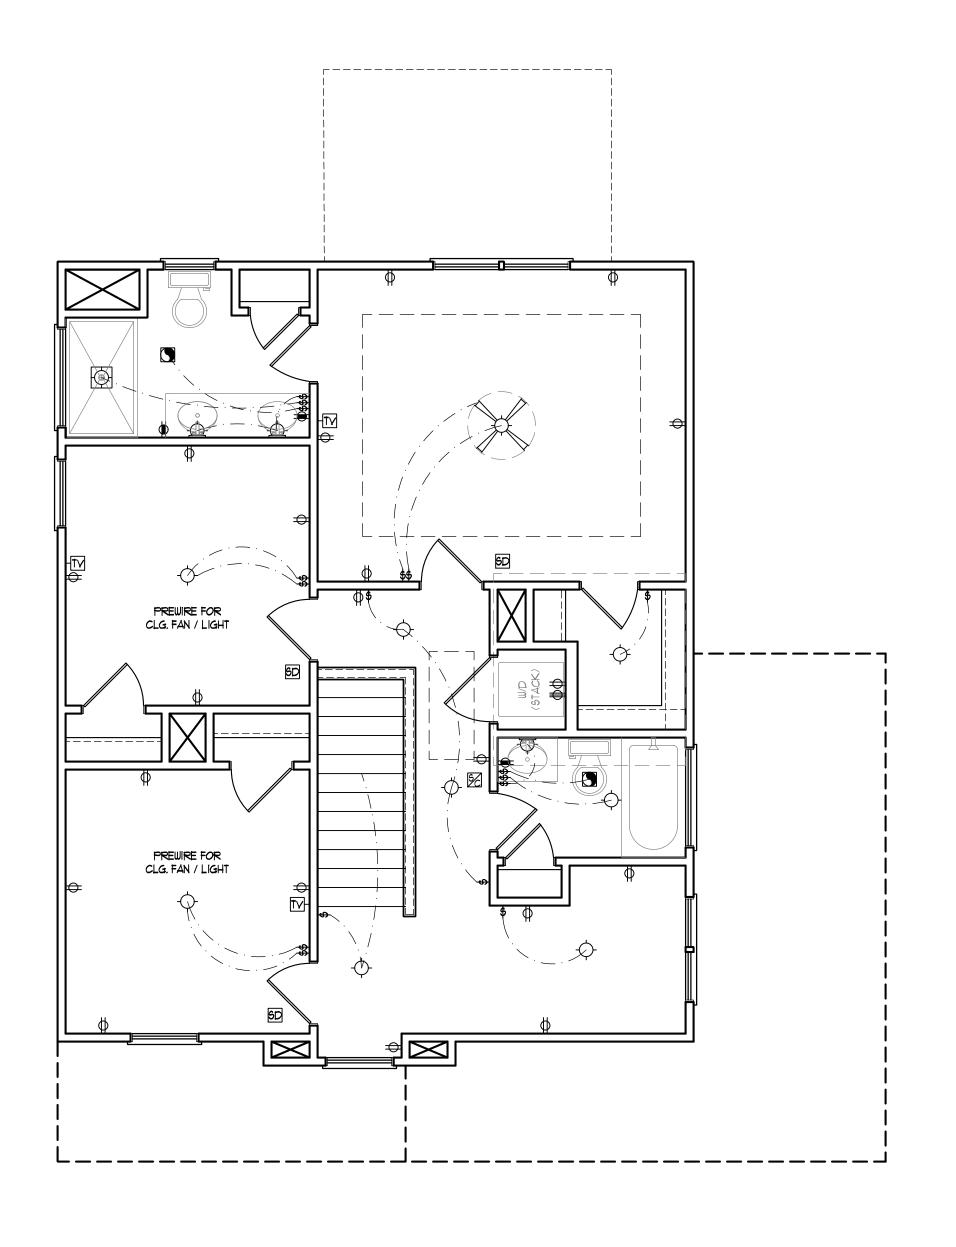UNDERCABINET LIGHT

- FLOOD LIGHT
- SWITCH
- \$D DIMMER SWITCH
- ▲ TELEPHONE
- \triangle DATA
- TELEPHONE AND DATA
- TY- TY CONNECTION
- CD- CONDUIT FOR COMPONENT WIRING
- SP SPEAKER
- MOV SMOKE/ CO DETECTOR
- SD 110 Y SMOKE DETECTOR
- EXHAUST FAN





SCALE NOTE: 18x24 PRINTS ARE TO SCALE AS NOTED. 11x17 PRINTS ARE NOT TO SCALE



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WEAVER HOMES CAROLINA COLL HICKORY-II

DATE: FEBRUARY 19, 2021

SCALE: 1/4" = 1'-0"


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REVIEWED BY: SECOND FLOOR ELCTRICAL

E-2

PLAN

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WEAVER HOMES CAROLINA COLLECTIO HICKORY-II

DATE: FEBRUARY 19, 2021

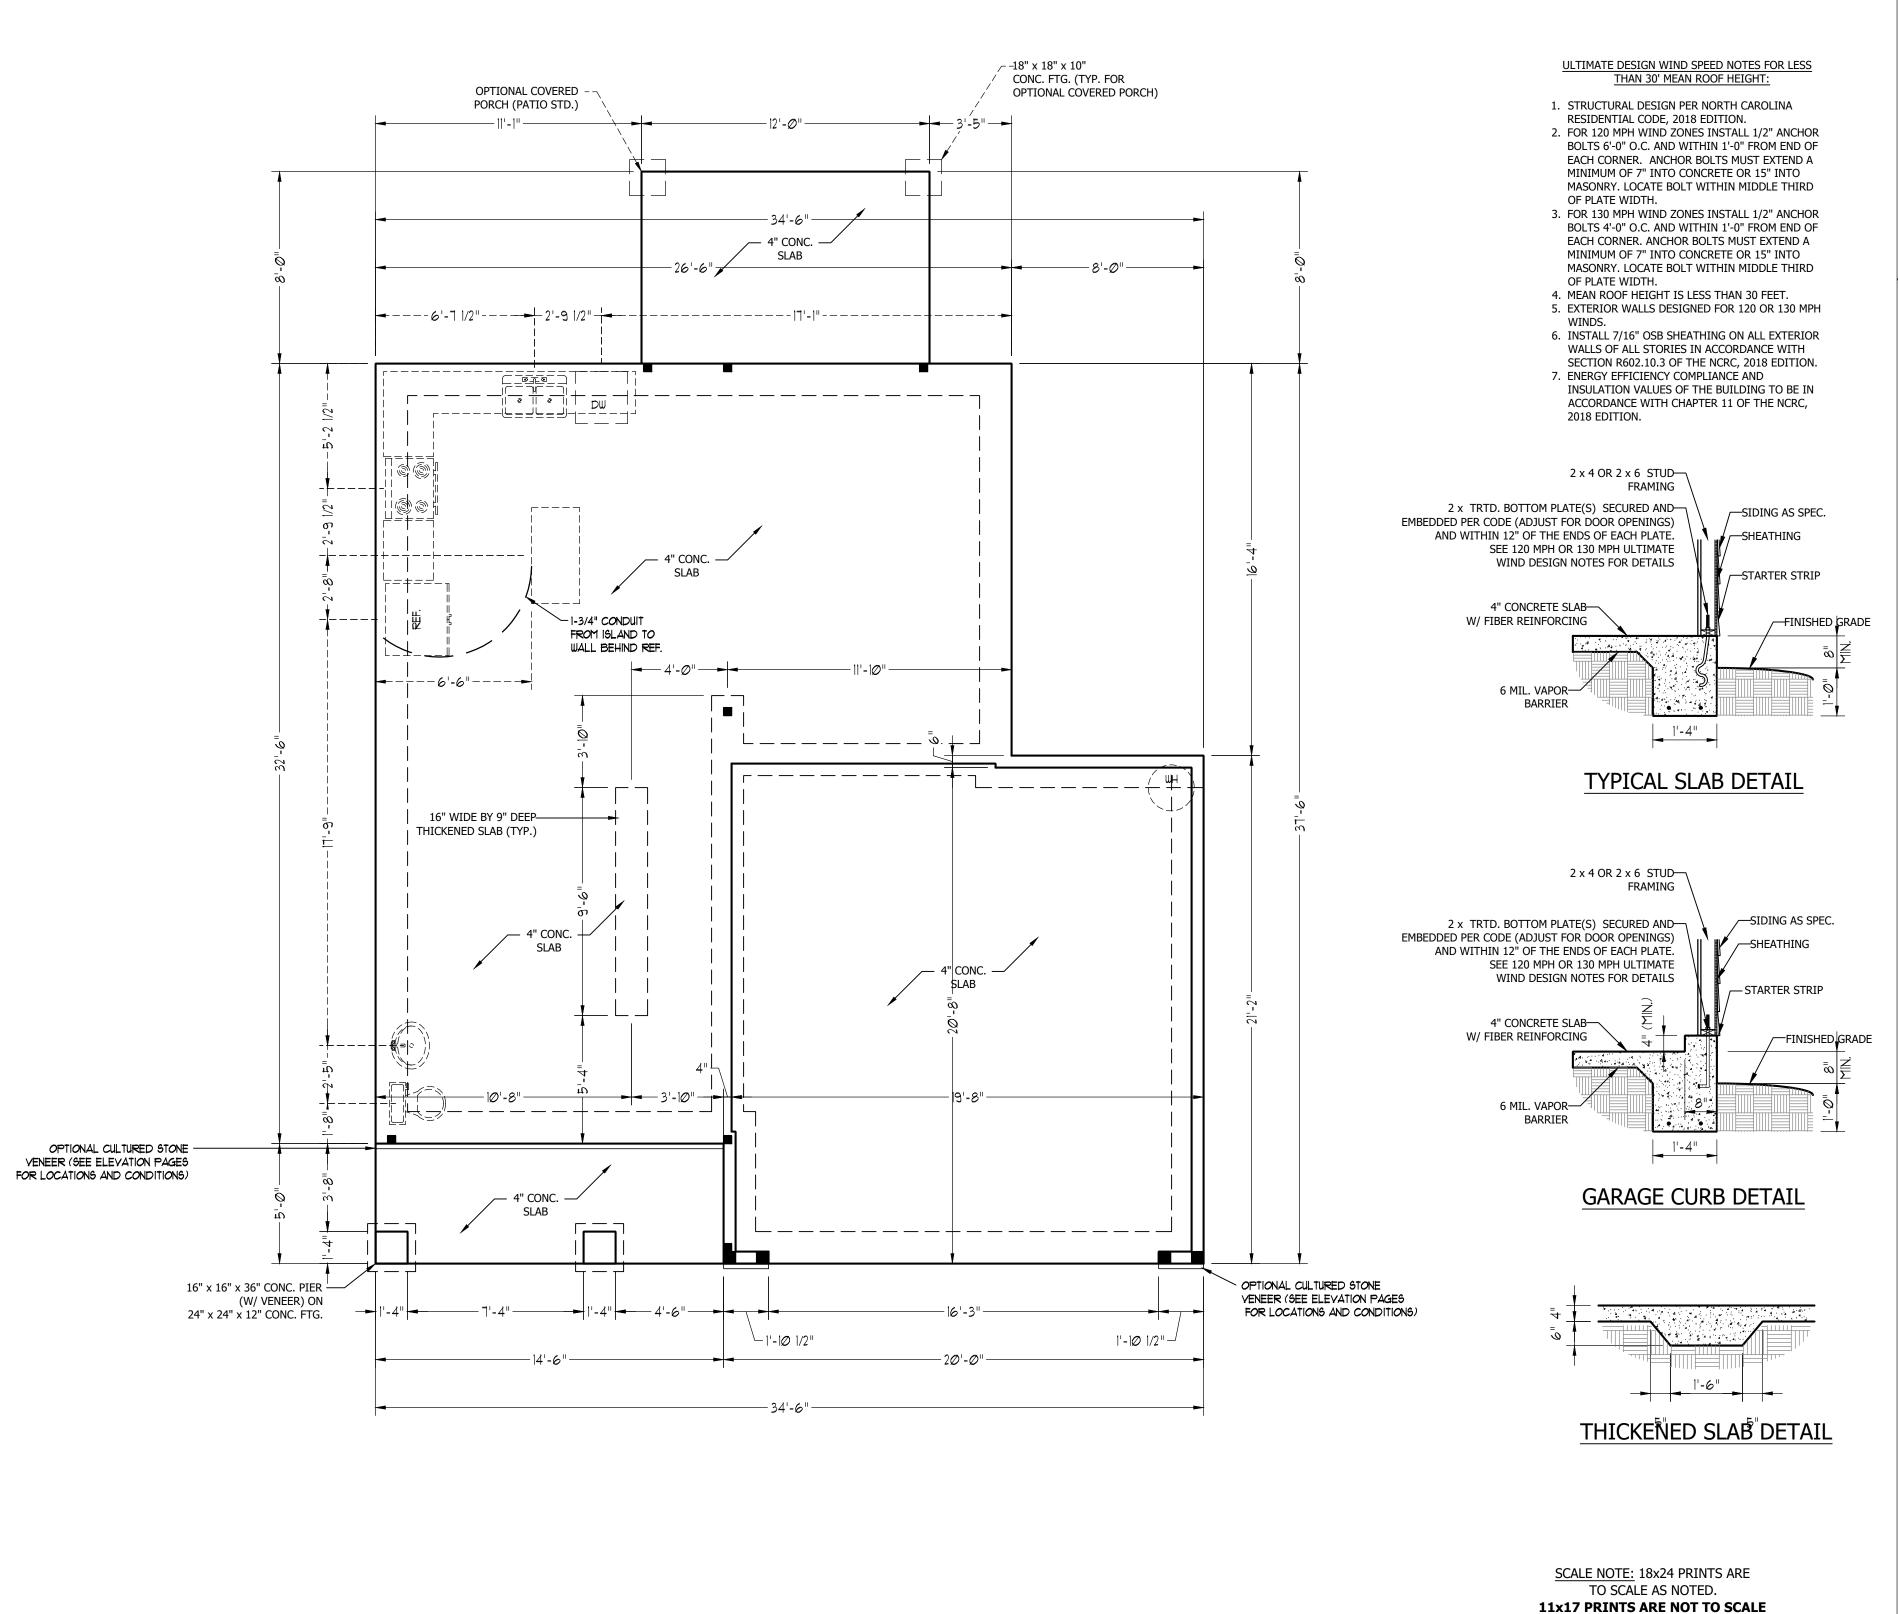REV.:

SCALE: 1/4" = 1'-0"

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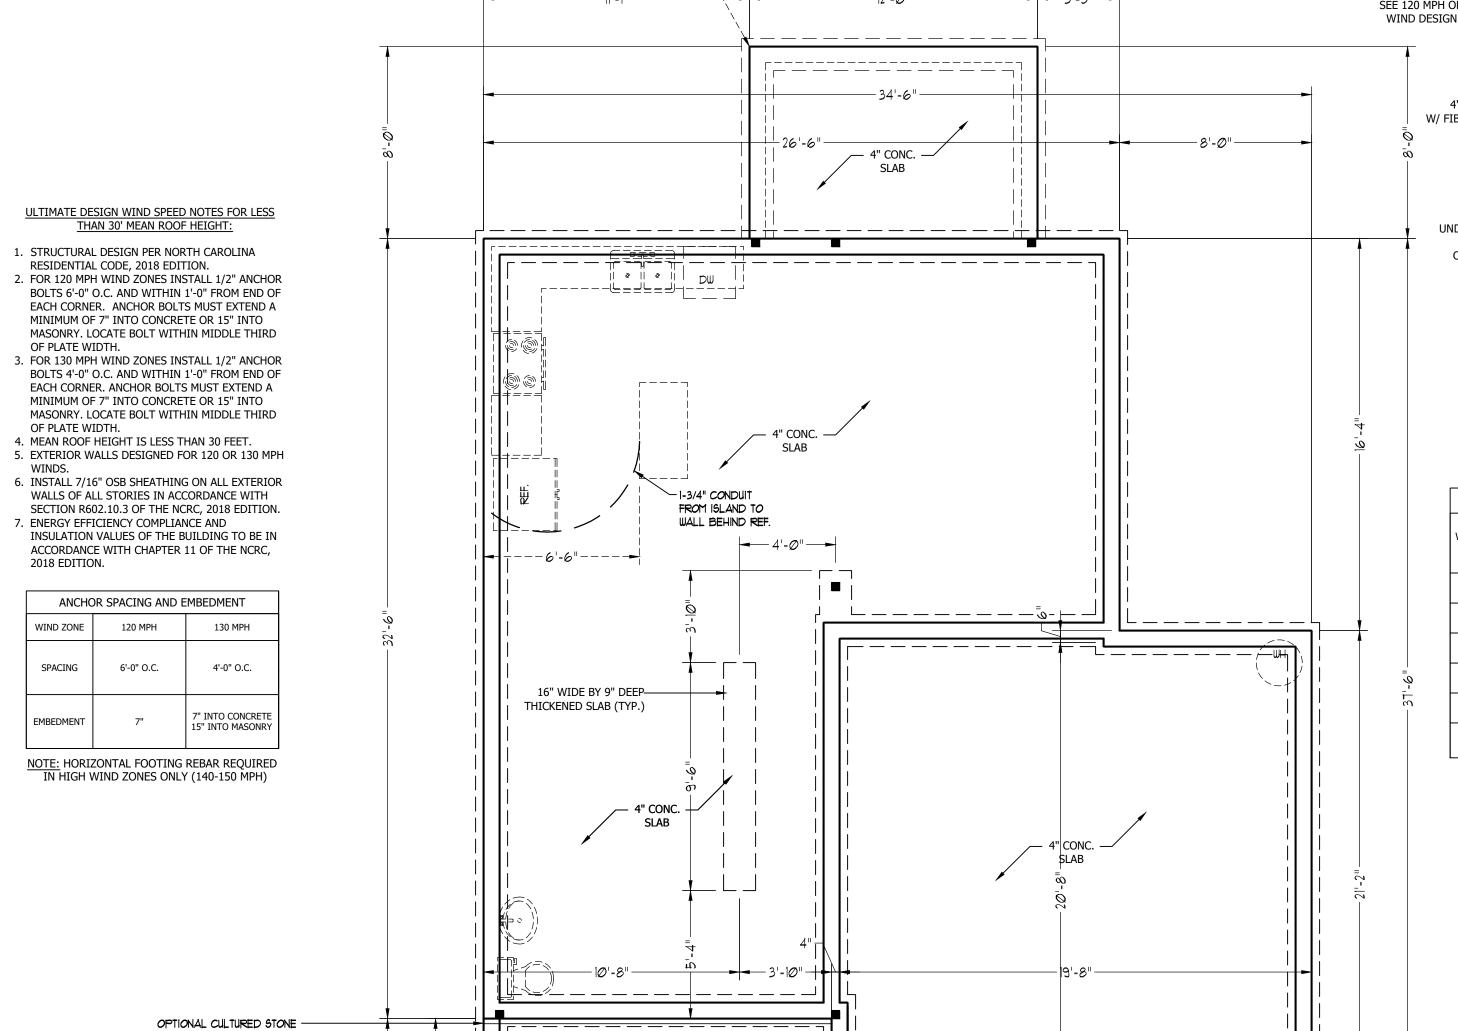
ENGINEERED BY:

REVIEWED BY:

MONO SLAB FOUNDATION

PLAN
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-1'-1Ø 1/2"


- 34'-6"

-20'-0"

1'-1Ø 1/2"-

OPTIONAL COVERED


PORCH (PATIO STD.)

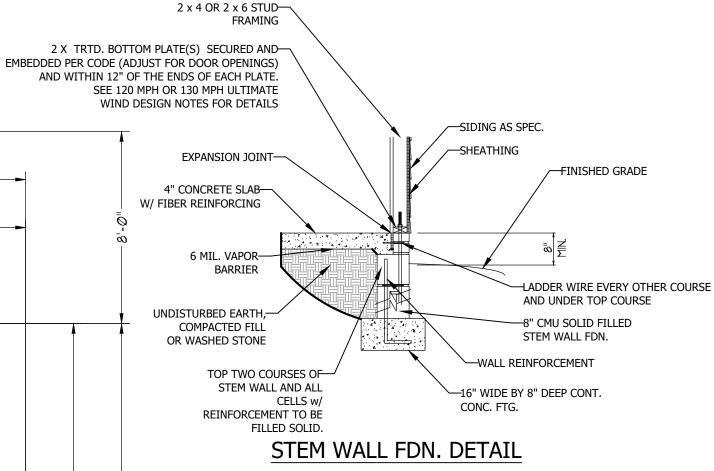

	MASONR	RY STEM WALL SPE	CIFICATIONS	
WALL HEIGHT		MASONRY '	WALL TYPE	
(FEET)	8" CMU	4" BRICK AND 4" CMU	4" BRICK AND 8" CMU	12" CMU
2' OR LESS	UNGROUTED	GROUT SOLID	UNGROUTED	UNGROUTED
3'	UNGROUTED	GROUT SOLID	UNGROUTED	UNGROUTED
4'	GROUT SOLID	GROUT SOLID w/ #4 REBAR @ 48" O.C.	GROUT SOLID	GROUT SOLID w/ #4 REBAR @ 64" O.C.
5'	GROUT SOLID w/ #4 REBAR @ 36" O.C.	N/A	GROUT SOLID w/ #4 REBAR @ 36" O.C.	GROUT SOLID w/ #4 REBAR @ 64" O.C.
6'	GROUT SOLID w/ #4 REBAR @ 24" O.C.	N/A	GROUT SOLID w/ #4 REBAR @ 24" O.C.	GROUT SOLID w/ #4 REBAR @ 64" O.C.
7' OR MORE		ENGINEERED BASED (ON SITE CONDITIONS	

STRUCTURAL NOTES:

- 1. TABLE ABOVE APPLIES TO HOUSE FOUNDATION ONLY. TABLE DOES NOT APPLY TO GARAGE FOUNDATION NOT COMMON TO HOUSE.
- 2. TIE MULTIPLE WYTHES TOGETHER WITH LADDER WIRE @ 16" O.C. VERTICALLY. 3. WALL HGT. IS MEASURED FROM TOP OF FOOTING TO TOP OF WALL.
- 4. PREP SLAB PER R506.2.1 AND R505.2.2 BASE AND EXCEPTION OF THE 2018 NCRC
- 5. MINIMUM 24" LAP SPLICE LENGTH.
- 6. BACKFILL OF CLEAN #57/ #67 WASHED STONE IS PERMITTED.
- 7. BACKFILL OF WELL DRAINED SAND-GRAVEL MIXTURE SOILS (45 PSF/FT BELOW GRADE) CLASSIFIED AS GROUP 1 ACCORDING TO UNIFIED SOILS CLASSIFICATION SYSTEM IN ACCORDANCE WITH TABLE R405.1 OF THE 2018 NCRC ARE ALLOWABLE.
- 8. LOCATE REBAR IN CENTER OF FOUNDATION WALL.
- 9. WHERE REQUIRED, FILL BLOCK SOLID WITH TYPE "S" MORTAR OR 3000 PSI GROUT. USE OF "LOW LIFT GROUTING" METHOD REQUIRED WHEN FILLING WALLS WITH GROUT AT HEIGHTS OF 5' AND GREATER.

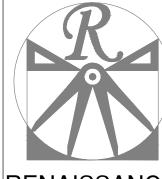

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DATE: FEBRUARY 19, 2021

REV.:

SCALE: 1/4" = 1'-0"

DRAWN BY: WG ENGINEERED BY:

REVIEWED BY:


STEMWALL SLAB FOUNDATION PLAN

S-1

SCALE NOTE: 18x24 PRINTS ARE TO SCALE AS NOTED. 11x17 PRINTS ARE NOT TO SCALE

VENEER (SEE ELEVATION PAGES FOR LOCATIONS AND CONDITIONS)

> 16" x 16" x 36" CONC. PIER -(W/ VENEER) ON 24" x 24" x 12" CONC. FTG.

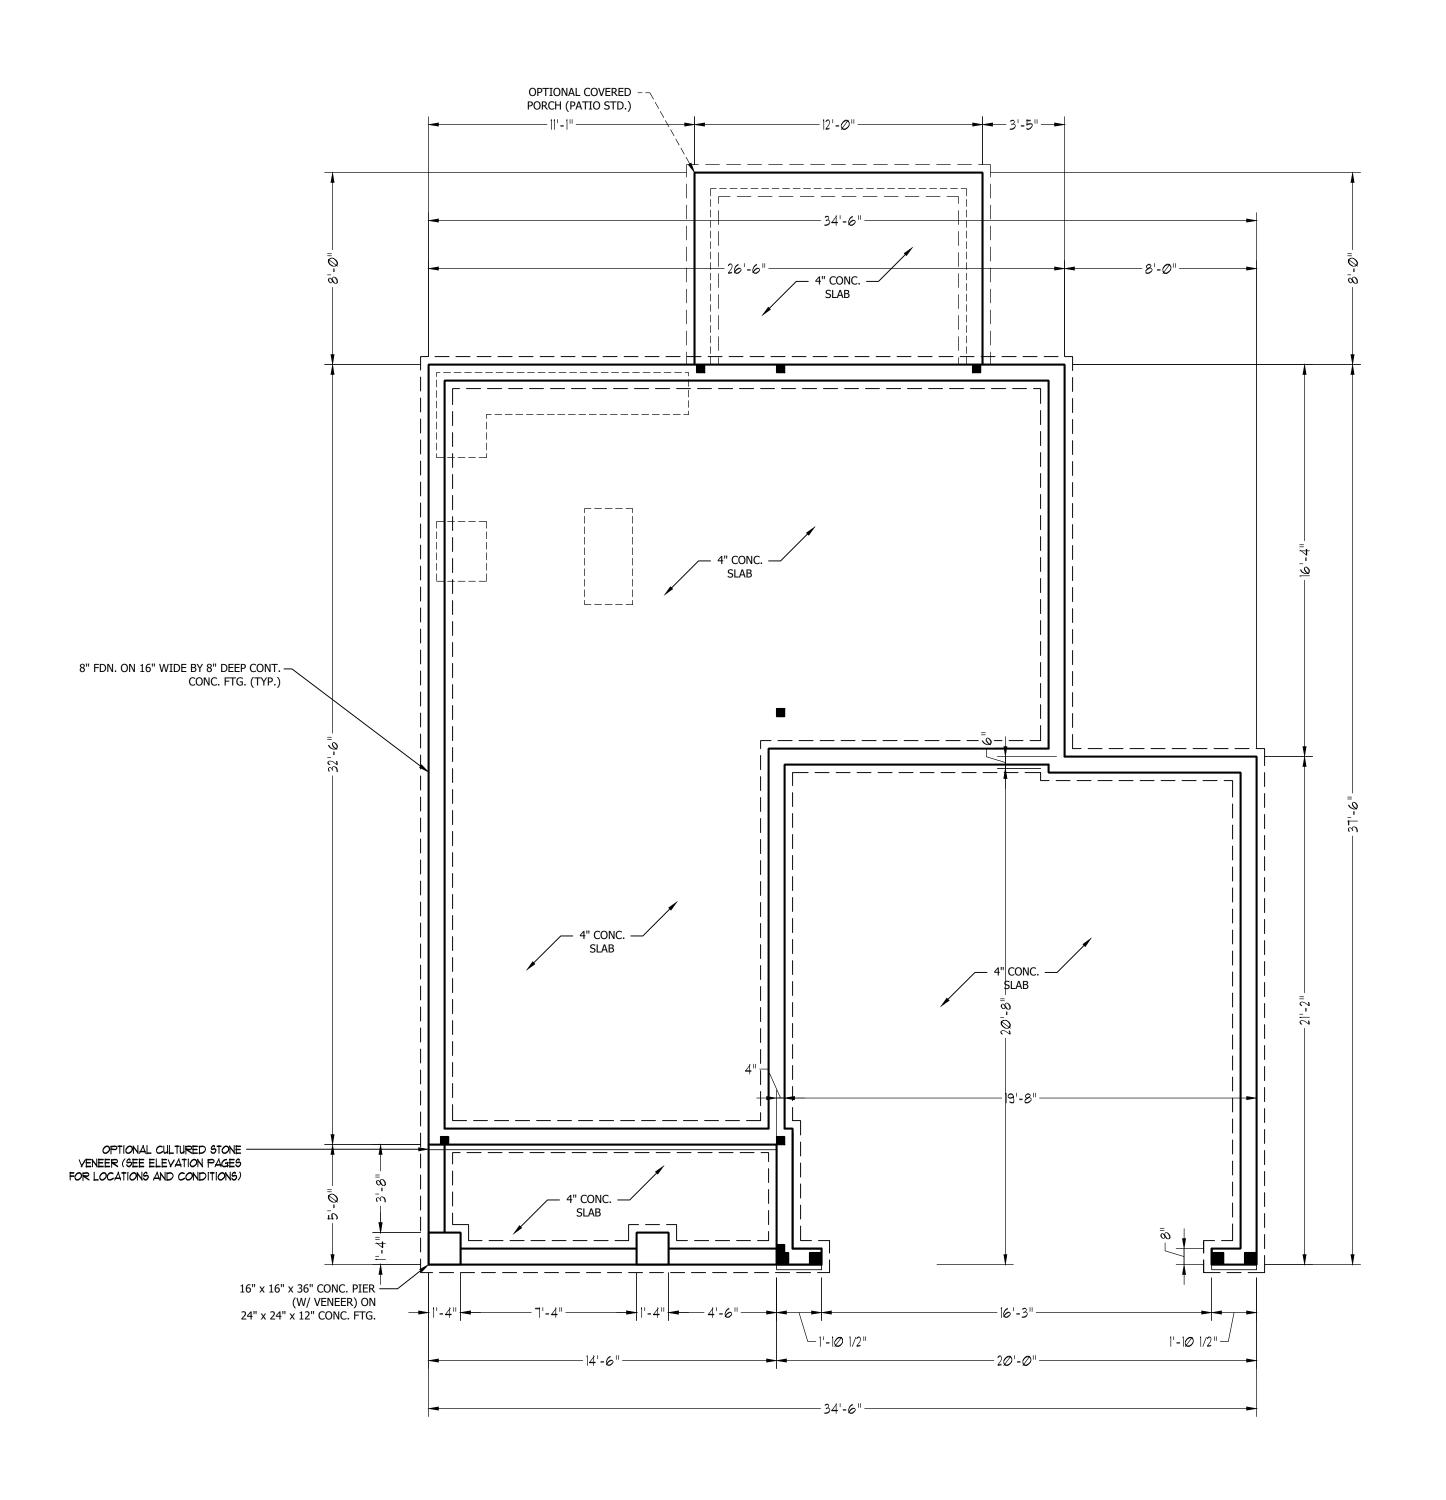

STRUCTURAL NOTES:

- 1. ALL FRAMING LUMBER TO BE #2 SPF (UNO). ALL TREATED LUMBER TO BE #2 SYP (UNO.)
- 2. INSTALL AN EXTRA OR DOUBLE JOIST UNDER WALLS
- PARALLEL TO FLOOR JOISTS.
- 3. SQUARES REPRESENT POINT LOADS WHICH REQUIRE SOLID
- BLOCKING TO GIRDER OR FOUNDATION.
- SHADED PIERS TO BE FILLED SOLID.
 INSTALL LADDER WIRE @ 16" O.C. TO SECURE MULTIPLE WYTHE FOUNDATION WALLS TOGETHER.


ULTIMATE DESIGN WIND SPEED NOTES FOR LESS THAN 30' MEAN ROOF HEIGHT:

- STRUCTURAL DESIGN PER NORTH CAROLINA RESIDENTIAL CODE, 2018 EDITION.
- 2. FOR 120 MPH WIND ZONES INSTALL 1/2" ANCHOR BOLTS 6'-0" O.C. AND WITHIN 1'-0" FROM END OF EACH CORNER. ANCHOR BOLTS MUST EXTEND A MINIMUM OF 7" INTO CONCRETE OR 15" INTO MASONRY. LOCATE BOLT WITHIN MIDDLE THIRD OF PLATE WIDTH.
- 3. FOR 130 MPH WIND ZONES INSTALL 1/2" ANCHOR BOLTS 4'-0" O.C. AND WITHIN 1'-0" FROM END OF EACH CORNER. ANCHOR BOLTS MUST EXTEND A MINIMUM OF 7" INTO CONCRETE OR 15" INTO MASONRY. LOCATE BOLT WITHIN MIDDLE THIRD OF PLATE WIDTH.
- MEAN ROOF HEIGHT IS LESS THAN 30 FEET.
 EXTERIOR WALLS DESIGNED FOR 120 OR 130 MPH
- EXTERIOR WALLS DESIGNED FOR 120 OR 130 MPH WINDS.
- 6. INSTALL 7/16" OSB SHEATHING ON ALL EXTERIOR WALLS OF ALL STORIES IN ACCORDANCE WITH
- SECTION R602.10.3 OF THE NCRC, 2018 EDITION.

 7. ENERGY EFFICIENCY COMPLIANCE AND
- I. ENERGY EFFICIENCY COMPLIANCE AND INSULATION VALUES OF THE BUILDING TO BE IN ACCORDANCE WITH CHAPTER 11 OF THE NCRC, 2018 EDITION.

FOUNDATION VENTILATION CALCULATION

678 SQ. FT. OF CRAWL SPACE DIVIDED BY 1500 EQUALS 0.5 SQ. FT. OF NET FREE AREA REQUIRED. INSTALL 6 MIL POLY TO COVER ENTIRE CRAWL SPACE. LOCATE VENTS WITHIN 3'-0" OF EACH CORNER OF THE BUILDING TO PROVIDE CROSS-VENTILATION.

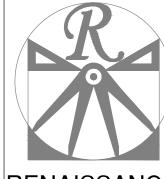

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WEAVER HOMES CAROLINA COLLECTIC HICKORY-II

DATE: FEBRUARY 19, 2021

REV.:

SCALE: 1/4" = 1'-0"

DRAWN BY: WG

ENGINEERED BY:


REVIEWED BY:

CRAWL FOUNDATION PLAN

S-1

SCALE NOTE: 18x24 PRINTS ARE TO SCALE AS NOTED.

11x17 PRINTS ARE NOT TO SCALE

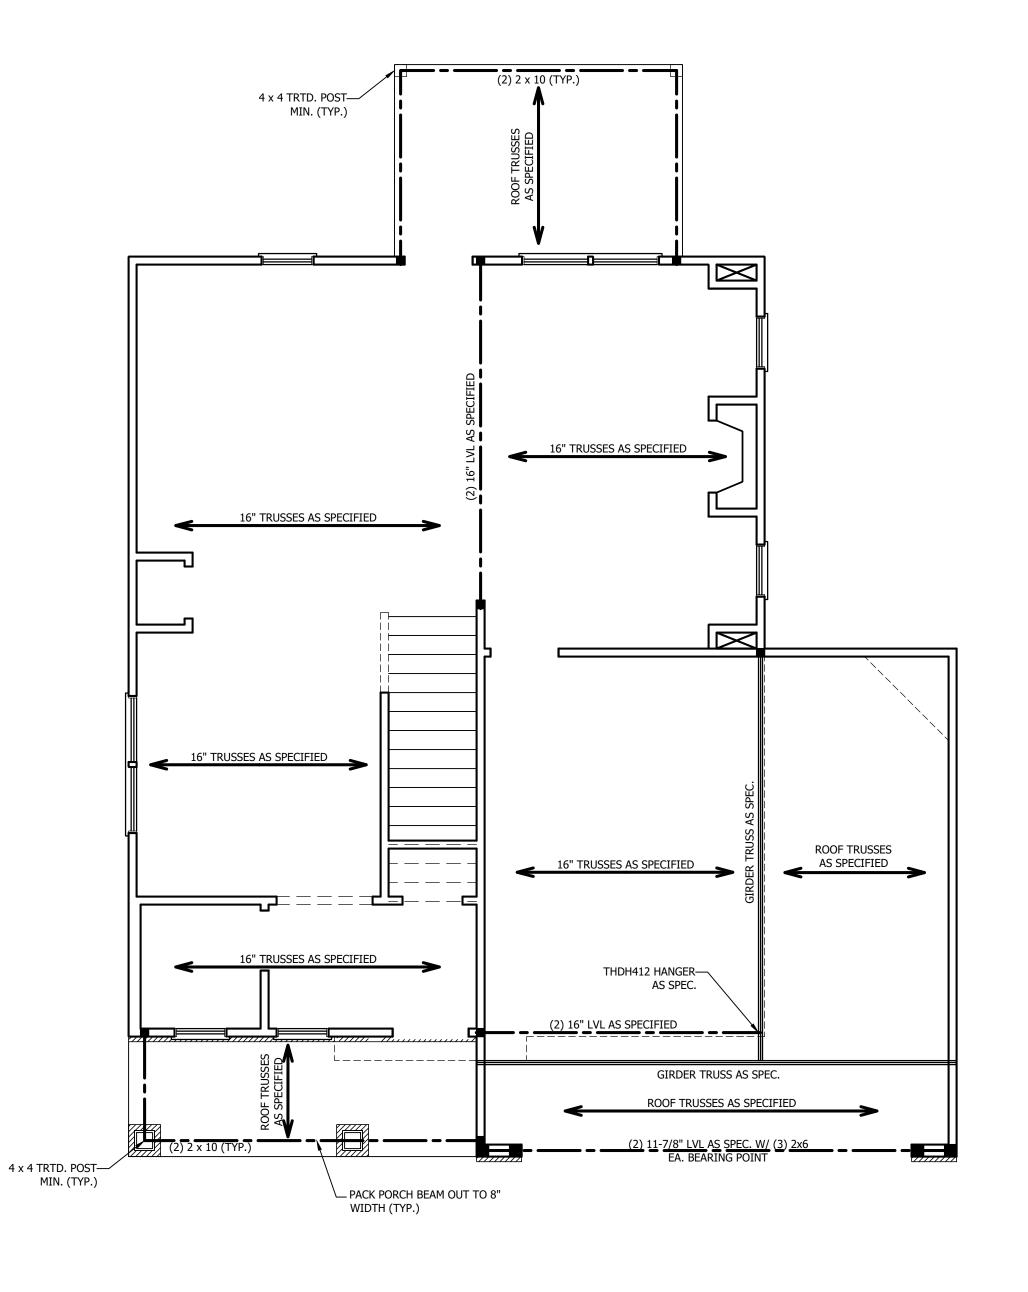

STRUCTURAL NOTES:

- 1. ALL FRAMING LUMBER TO BE SPF #2 (UNO). ALL TREATED LUMBER TO BE SYP #2
- 2. ALL LOAD BEARING HEADERS TO BE (2) 2 x 4 (UNO).
- 3. INSTALL AN EXTRA JOIST UNDER WALLS PARALLEL TO FLOOR JOISTS
- 4. WINDOW AND DOOR HEADERS TO BE SUPPORTED w/ (1) JACK STUD AND (1) KING STUD EA. END (UNO.). SEE TABLE R602.7.5 FOR ADDITIONAL KING STUD REQUIREMENTS.
- 5. SQUARES DENOTE POINT LOADS WHICH REQUIRE SOLID BLOCKING TO GIRDER OR FOUNDATION. ALL SQUARES TO BE (2) STUDS (UNO.)
- 6. ALL 4 X 4 POSTS SHALL BE ANCHORED TO SLABS W/ SIMPSON ABU44 POST BASES (OR EQUAL) AND 6 X 6 POSTS W/ ABU66 POST BASES (OR EQUAL) (UNO). ALL 4 X 4 AND 6 X 6 POSTS TO BE INSTALLED WITH 700 LB CAPACITY UPLIFT CONNECTORS AT TOP (UNO.)
- 7. FOR FIBERGLASS, ALUMINUM, OR COLUMN ENG. BY OTHERS, SECURE TO SLAB W/ (2) METAL ANGLES USING 2" CONC. SCREWS. FASTEN ANGLES TO COLUMNS W/ 1/4" THROUGH BOLTS W/ NUTS AND WASHERS. LOCATE ANGLES ON OPPOSITE SIDES OF COLUMN. THROUGH BOLTS MUST BE INSTALLED PRIOR TO SETTING COLUMN.

BRACE WALL PANEL NOTES:


EXTERIOR WALLS: ALL EXTERIOR WALLS TO BE SHEALTHED WITH CS-WSP OR CS-SFB IN ACCORDANCE WITH SECTION R602.10.3 UNLESS NOTED OTHERWISE.

REQUIRED LENGTH OF BRACING: REQUIRED BRACE WALL LENGTH FOR EACH SIDE OF THE CIRCUMSCRIBED RECTANGLE ARE INTERPOLATED PER TABLE R602.10.3. METHODS CS-WSP AND CS-SFB CONTRIBUTE THIER ACTUAL LENGTH. METHOD GB CONTRIBUTES 0.5 ITS ACTUAL LENGTH. METHOD PF CONTRIBUTES 1.5 TIMES ITS ACTUAL LENGTH.

GYPSUM: ALL INTERIOR SIDES OF EXTERIOR WALLS AND BOTH SIDES OF INTERIOR WALLS TO HAVE 1/2" GYPSUM INSTALLED. WHEN NOT USING METHOD GB GYPSUM TO BE FASTENED PER TABLE R702.3.5. METHOD GB TO BE FASTENED PER TABLE R602.10.1.

HD: 800 LBS HOLD DOWN DEVICE FASTENED TO THE EDGE OF THE BRACE WALL PANEL NEAREST TO THE CORNER

METHODS: PER TABLE R602.10.1

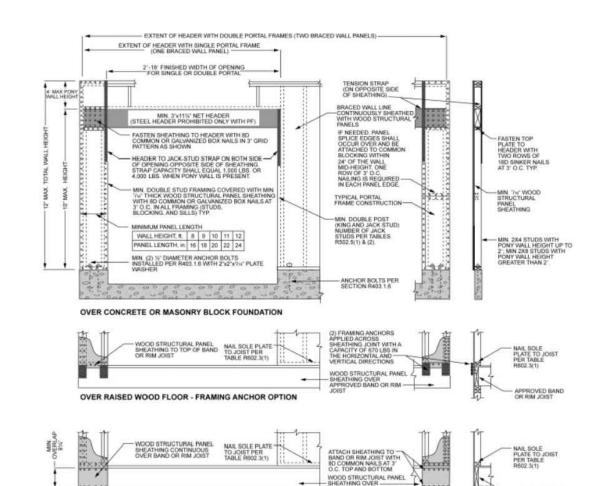


nch = 25.4 mm, 1 foot = 305 mm, 1 lb = 4.45 N.

OVER RAISED WOOD FLOOR - OVERLAP OPTION FRONT ELEVATION

FIGURE R602.10.1
METHOD PF—PORTAL FRAME CONSTRUCTION

SCALE NOTE: 18x24 PRINTS ARE
TO SCALE AS NOTED.
11x17 PRINTS ARE NOT TO SCALE

SECTION

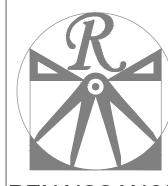

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WEAVER HOMES CAROLINA COLLECTIOI HICKORY-II

DATE: FEBRUARY 19, 2021

REV.:

SCALE: 1/4" = 1'-0"

DRAWN BY: WG
ENGINEERED BY:

REVIEWED BY:

SECOND FLOOR FRAMING PLAN

S-2

C:\Users\Wade\Documents\Projects\Westan-Weaver\Hickory\Hickory-II_2-21.dwg, 4/21/2021 8:31:02 AM

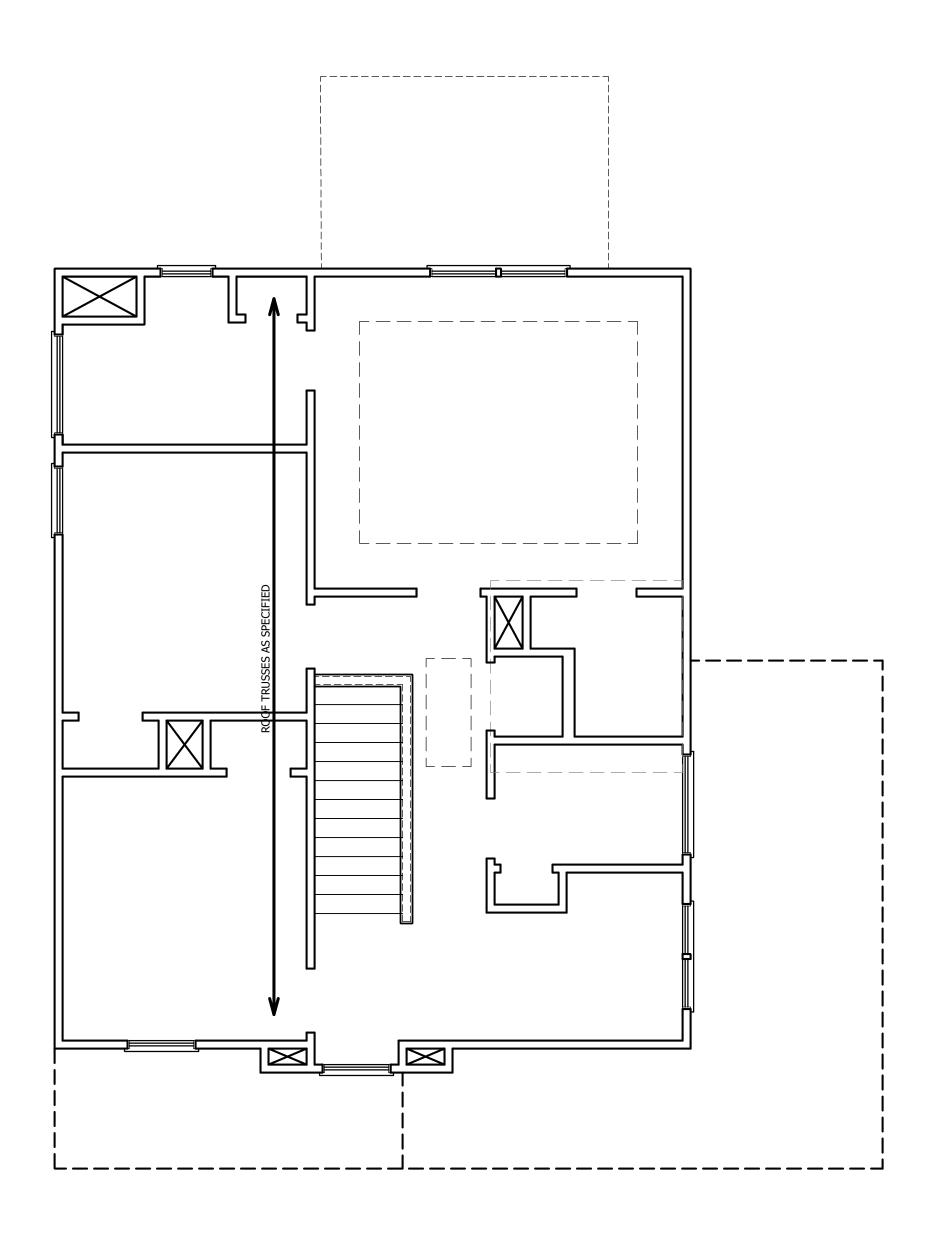


TABLE R602.7.5 MINIMUM NUMBER OF FULL HEIGHT STUDS AT EACH END OF HEADERS IN EXTERIOR WALLS

HEADER SPAN (FFFT)		SPACING (INCHES) E R602.3(5)
(== .)	16	24
UP TO 3'	1	1
4'	2	1
8'	3	2
12'	5	3
16'	6	4
	(FEET) UP TO 3' 4' 8' 12'	(PER TABL (FEET) 16 UP TO 3' 1 4' 2 8' 3 12' 5

STRUCTURAL NOTES:

- 1. ALL FRAMING LUMBER TO BE SPF #2 (UNO). ALL TREATED LUMBER TO BE SYP #2 (UNO.)
- 2. ALL LOAD BEARING HEADERS TO BE (2) 2 x 6 (UNO).
- 3. WINDOW AND DOOR HEADERS TO BE SUPPORTED w/ (1) JACK STUD AND (1) KING STUD EA. END (UNO.). SEE TABLE R602.7.5 FOR ADDITIONAL KING STUD REQUIREMENTS.
- 4. SQUARES DENOTE POINT LOADS WHICH REQUIRE SOLID BLOCKING TO GIRDER OR FOUNDATION. ALL SQUARES TO BE (2) STUDS (UNO.)

DSP - DOUBLE STUD POCKET TSP - TRIPLE STUD POCKET



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WEAVER HOMES CAROLINA COLLECTIO HICKORY-II

DATE: FEBRUARY 19, 2021

REV.:

SCALE: 1/4" = 1'-0"

DRAWN BY: WG


ENGINEERED BY:

REVIEWED BY:

ATTIC FLOOR FRAMING PLAN

S-3

SCALE NOTE: 18x24 PRINTS ARE
TO SCALE AS NOTED.
11x17 PRINTS ARE NOT TO SCALE

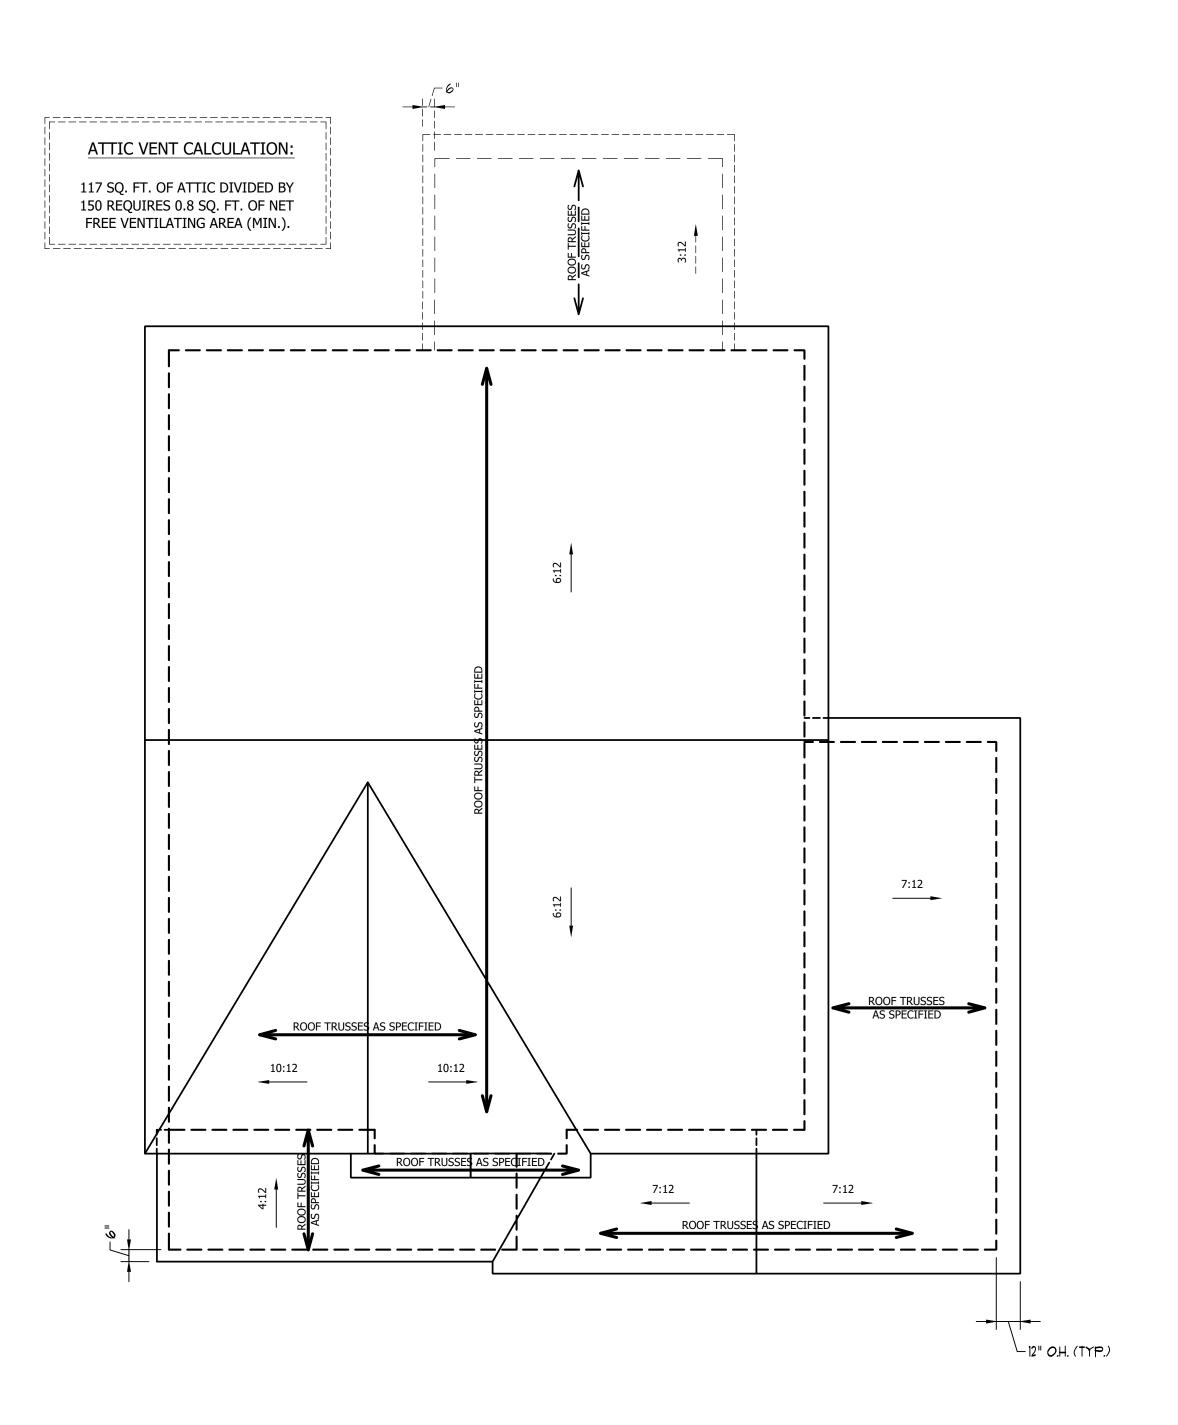


ATTIC VENT CALCULATION:

1302 SQ. FT. OF ATTIC DIVIDED BY 150 REQUIRES 8.7 SQ. FT. OF NET FREE VENTILATING AREA (MIN.).

STRUCTURAL NOTES:

- 1. ALL FRAMING LUMBER TO BE #2 SPF (UNO).
- HIP SPLICES ARE TO BE SPACED A MIN. OF 8'-0". FASTEN MEMBERS WITH THREE ROWS OF 12d NAILS @ 16" O.C. (TYP.)
- 3. STICK FRAME OVER-FRAMED ROOF SECTIONS W/ 2 x 8 RIDGES, 2 x 6 RAFTERS @ 16" O.C. AND FLAT 2 x 10 VALLEYS OR USE VALLEY TRUSSES.
- 4. FASTEN FLAT VALLEYS TO RAFTERS OR TRUSSES WITH SIMPSON H2.5A HURRICANE TIES @ 32" O.C. MAX. PASS HURRICANE TIES THROUGH NOTCH IN ROOF SHEATHING. EACH RAFTER IS TO BE FASTENED TO THE FLAT VALLEY WITH A MIN. OF (6) 12d TOE NAILS.
- 5. REFER TO SECTION R802.11 OF THE 2018 NCRC FOR REQUIRED UPLIFT RESISTANCE AT RAFTERS AND TRUSSES.

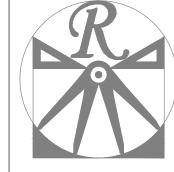

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WEAVER HOMES CAROLINA COLLECTIC HICKORY-II

DATE: FEBRUARY 19, 2021

REV.:

SCALE: 1/4" = 1'-0"

DRAWN BY: WG


ENGINEERED BY:

REVIEWED BY:


ROOF PLAN

S-4

SCALE NOTE: 18x24 PRINTS ARE
TO SCALE AS NOTED.
11x17 PRINTS ARE NOT TO SCALE

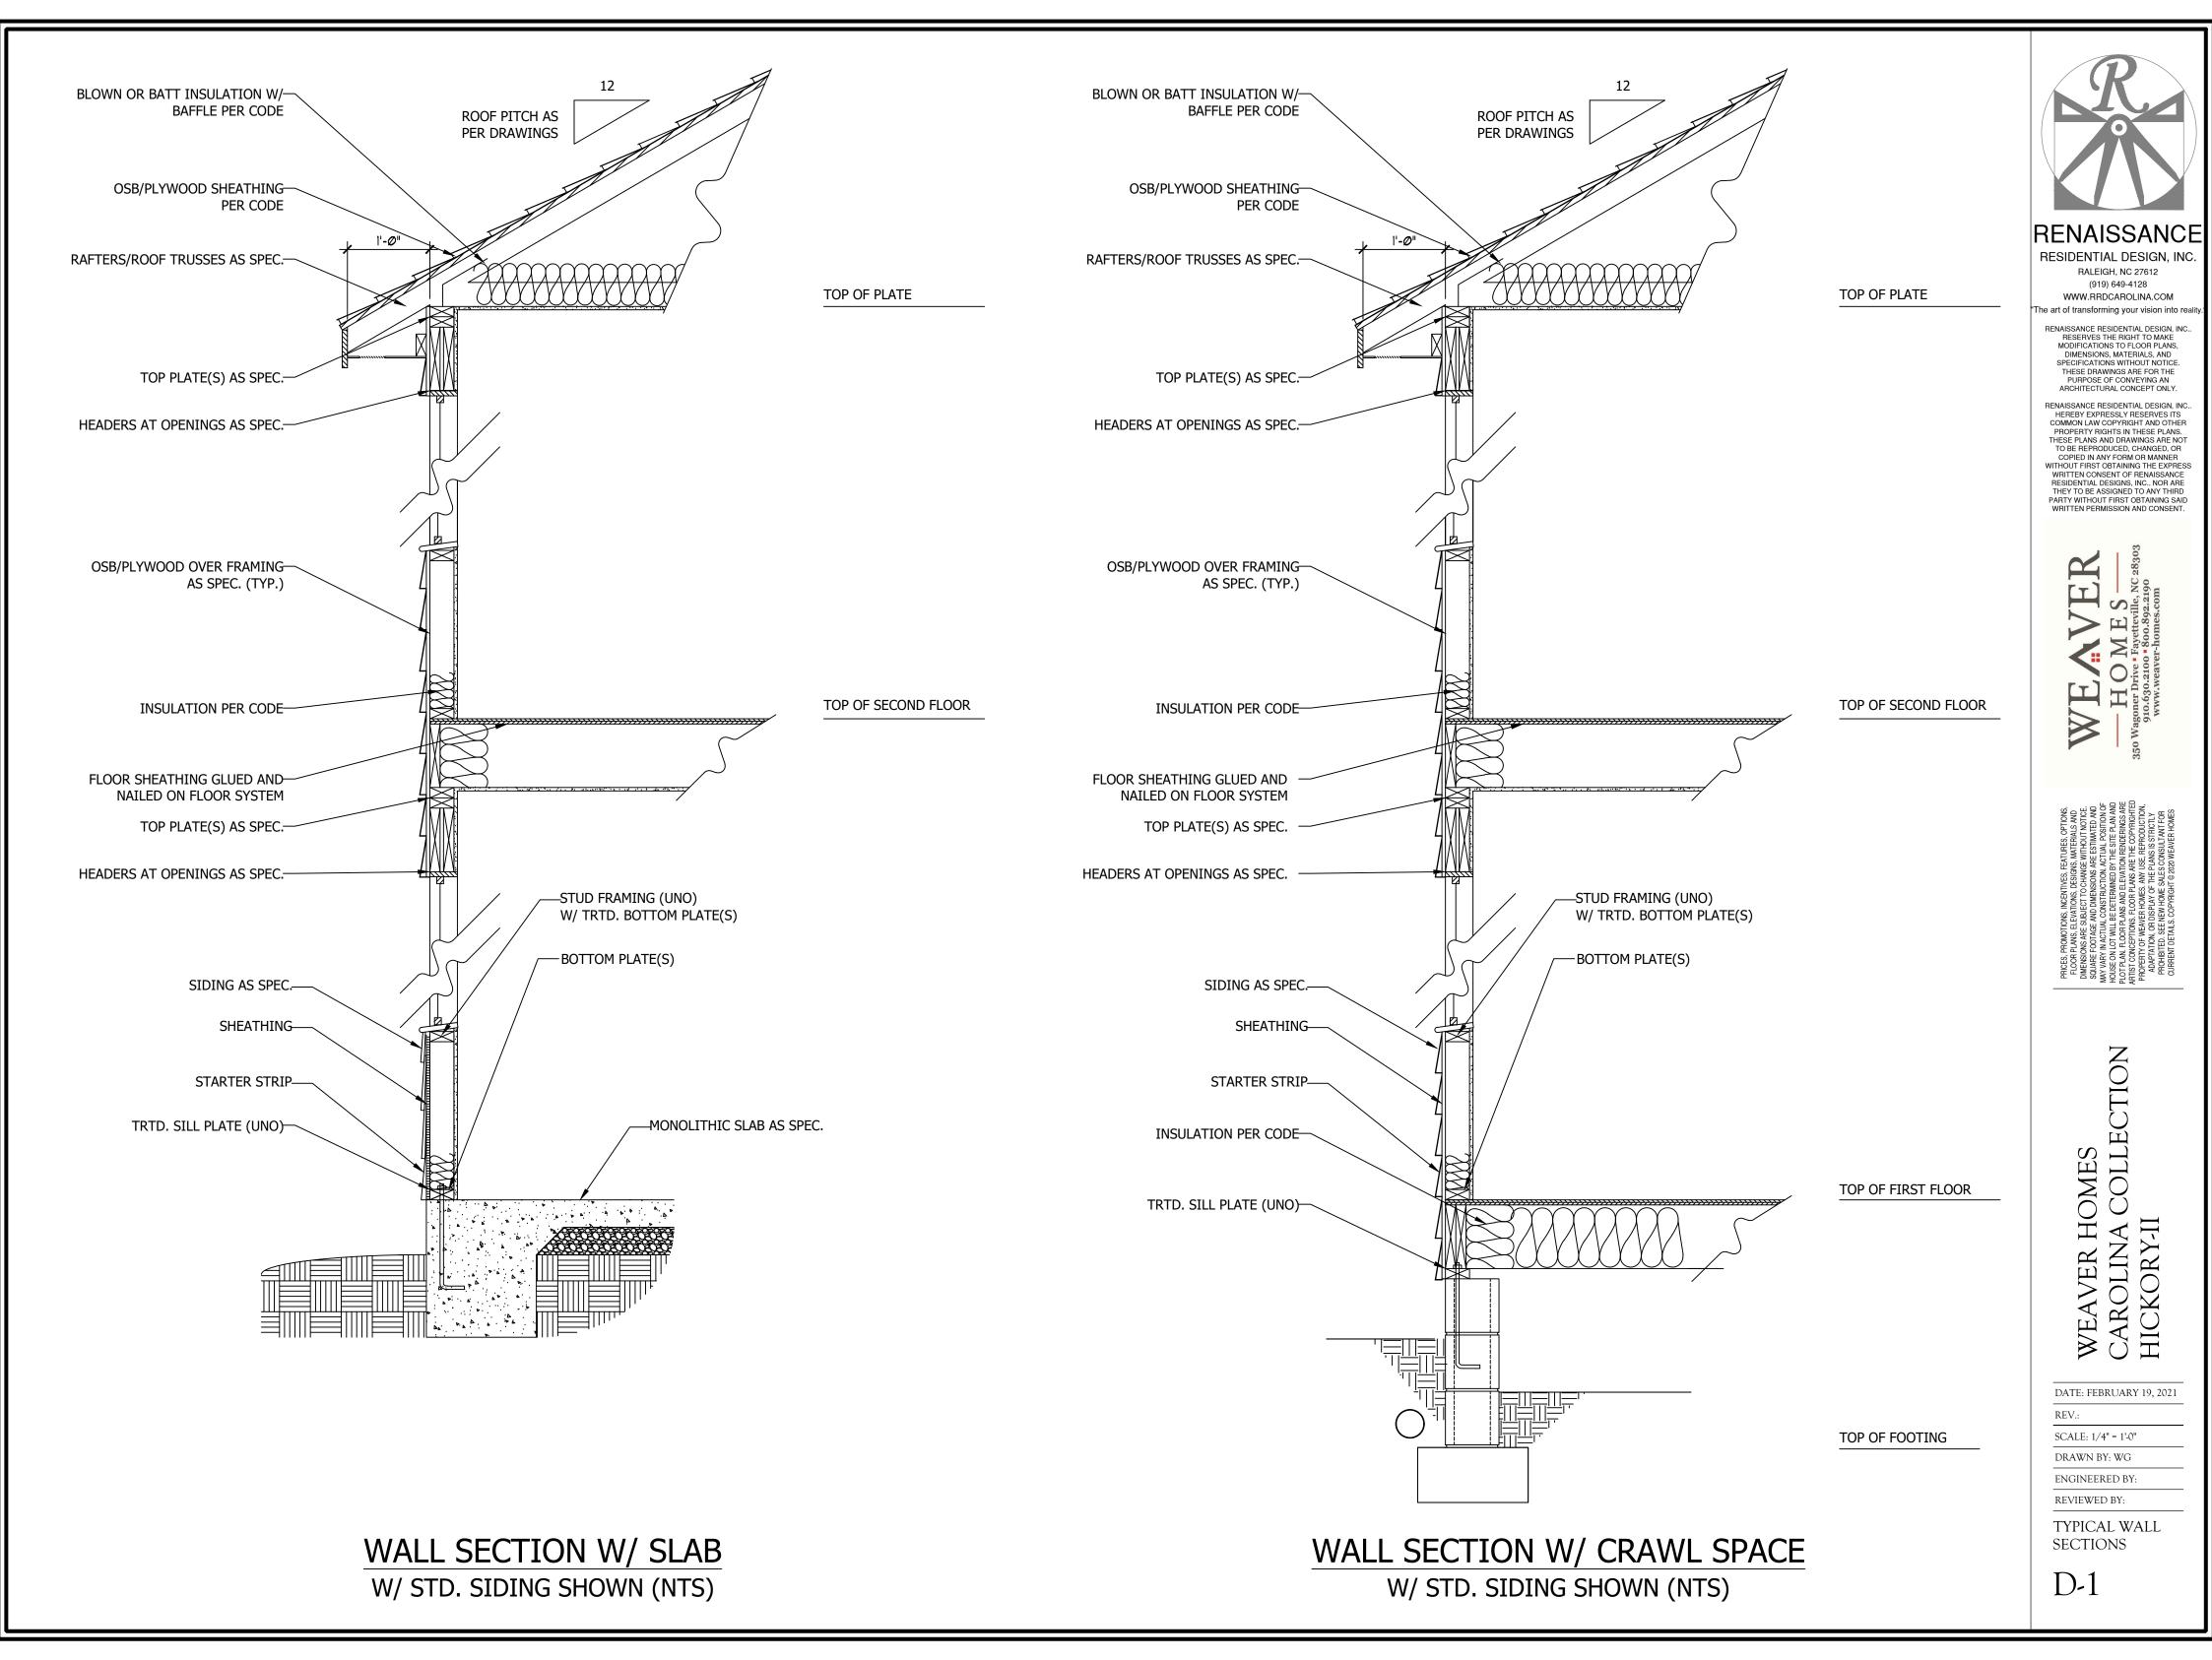

 $C: \label{locuments} \label{locuments} C: \label{locuments} We are \label{locuments} We aver \$

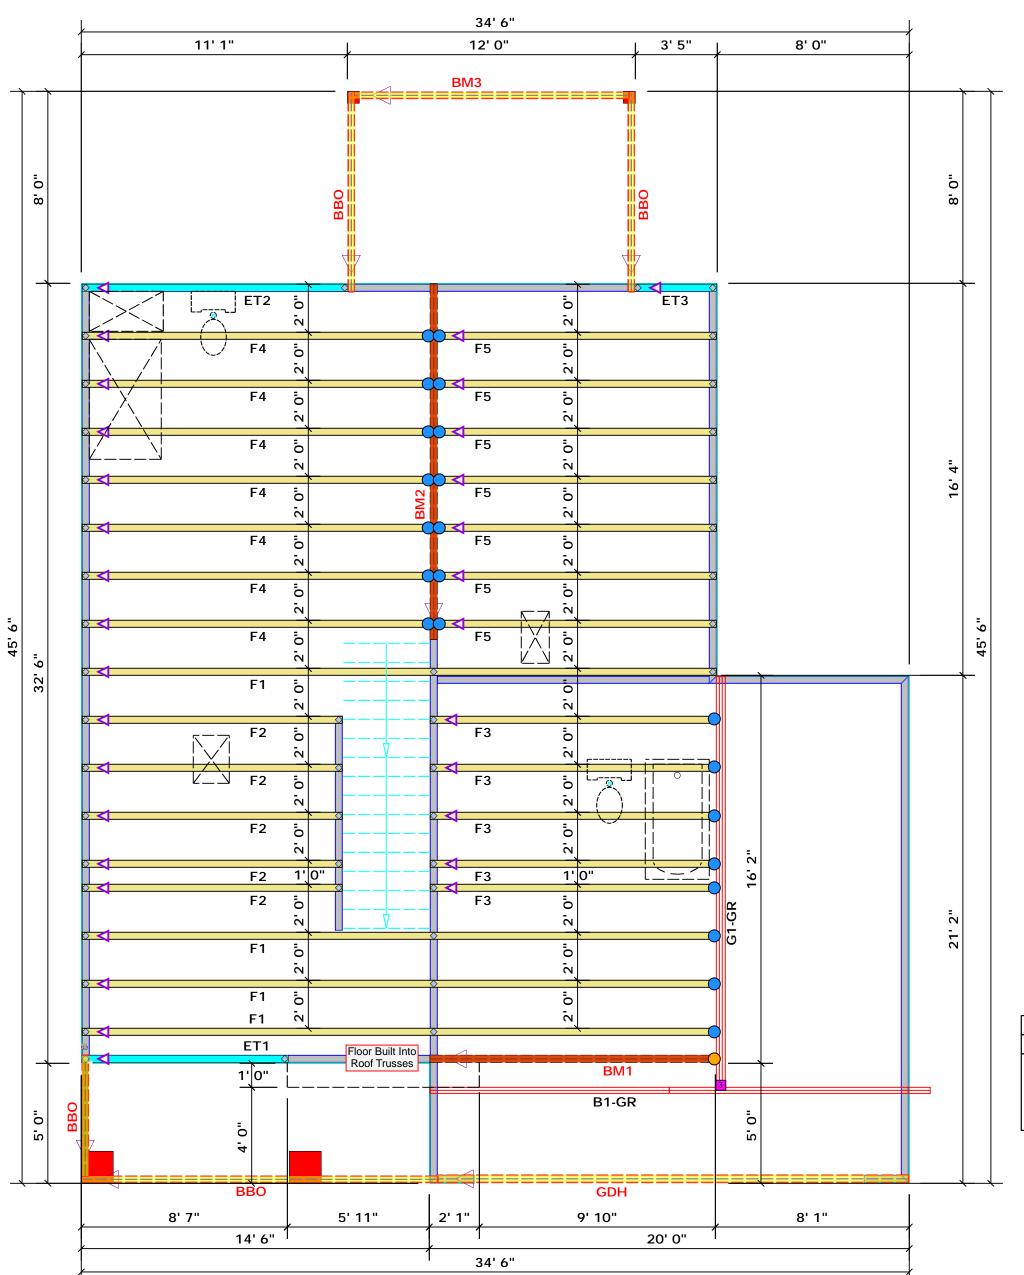

Dimension Notes All exterior wall to wall dimensions are to face of sheathing unless noted otherwise
 All interior wall dimensions are to face of frame wall unless noted otherwise
 All exterior wall to truss dimensions are to face of frame wall unless noted otherwise

All Walls Shown Are Considered Load Bearing

Plumbing Drop Notes 1. Plumbing drop locations shown are NOT exact. Contractor to verify ALL plumbing drop locations prior to setting Floor Trusses.
 Adjust spacing as needed not to exceed 24"oc.

	Connector Information			Nail Information		
Sym	Product	Manuf	Qty	Supported Member	Header Truss	
	HUS410	USP	22	NA	16d/3-1/2"	16d/3-1/2"
	THDH412	USP	1	NA	16d /3-1/2"	16d /3-1/2"

		Products			
PlotID	Length	Product	Plies	Net Qty	Fab Type
BM1	12' 0"	1-3/4"x 16" LVL Kerto-S	2	2	FF
BM2	15' 0"	1-3/4"x 16" LVL Kerto-S	2	2	FF
ВМ3	12' 0"	2x10 SPF No.2	2	2	FF
GDH	20' 0"	1-3/4"x 14" LVL Kerto-S	2	2	FF

Truss Placement Plan
Scale: 1/4"=1'

соттесн **ROOF & FLOOR TRUSSES & BEAMS**

> Reilly Road Industrial Park Fayetteville, N.C. 28309 Phone: (910) 864-8787 Fax: (910) 864-4444

tearing reactions less than or equal to 3000# are eemed to comply with the prescriptive Code equirements. The contractor shall refer to the ttached Tables (derived from the prescriptive Code equirements) to determine the minimum foundation ize and number of wood studs required to support eactions greater than 3000# but not greater than 5000#. A registered design professional shall be etained to design the support system for any eaction that exceeds those specified in the attached ables. A registered design professional shall be etained to design the support system for all eactions that exceed 15000#.

David Landry


David Landry


LOAD CHART FOR JACK STUDS (BASED ON TABLES ROOF (1) & (b))

NU	WBER C	F JA	STUBS A HEADERA			EA END OF	F
END REACTION (UP 10)	REQ10 STUBS FOR (2) PLY HEADER		END REACTION (UP TO)	REQ15 STUDS FOR (3) ALY READER		END REACTION (UP TO)	REQ10 STUDS FOR (4) PLY HEADER
1700	1		2550	1		3400	1
3400	2		5100	2		6800	2
5100	3		7650	3		10200	3
6800	4		10200	4		13600	4
8500	5		12750	5		17000	5
10200	6		15300	6	_		
11900	7						
13600	8						
15300	9						

BUILDER	Regency Homes	CITY / CO.	CI TY / CO. Erwin / Harnett	6800 8500 10200 11900 13600 15300
JOB NAME	JOB NAME Lot 3 Walker Farm	ADDRESS	Wire Rd.	4 5 6 7 8 9
PLAN	Hickory II / GR	MODEL	Floor	10200 12750 15300
SEAL DATE		DATE REV.	09/01/21	5
QUOTE #		DRAWN BY	DRAWN BY David Landry	1360
JOB#	J0921-5281	SALES REP. Bob Lewis	Bob Lewis	

THIS IS A TRUSS PLACEMENT DIAGRAM ONLY.
These trusses are designed as individual building components to be incorporated into the building design at the specification of the building design at the specification of the building designer. See individual design sheets for each truss design identified on the placement drawing. The building designer is responsible for temporary and permanent bracing of the roof and floor system and for the overall structure. The design of the truss support structure including headers, beams, walls, and columns is the responsibility of the building designer. For general guidance regarding bracing, consult BCSI-B1 and BCSI-B3 provided with the truss delivery package or online @ sbcindustry.com

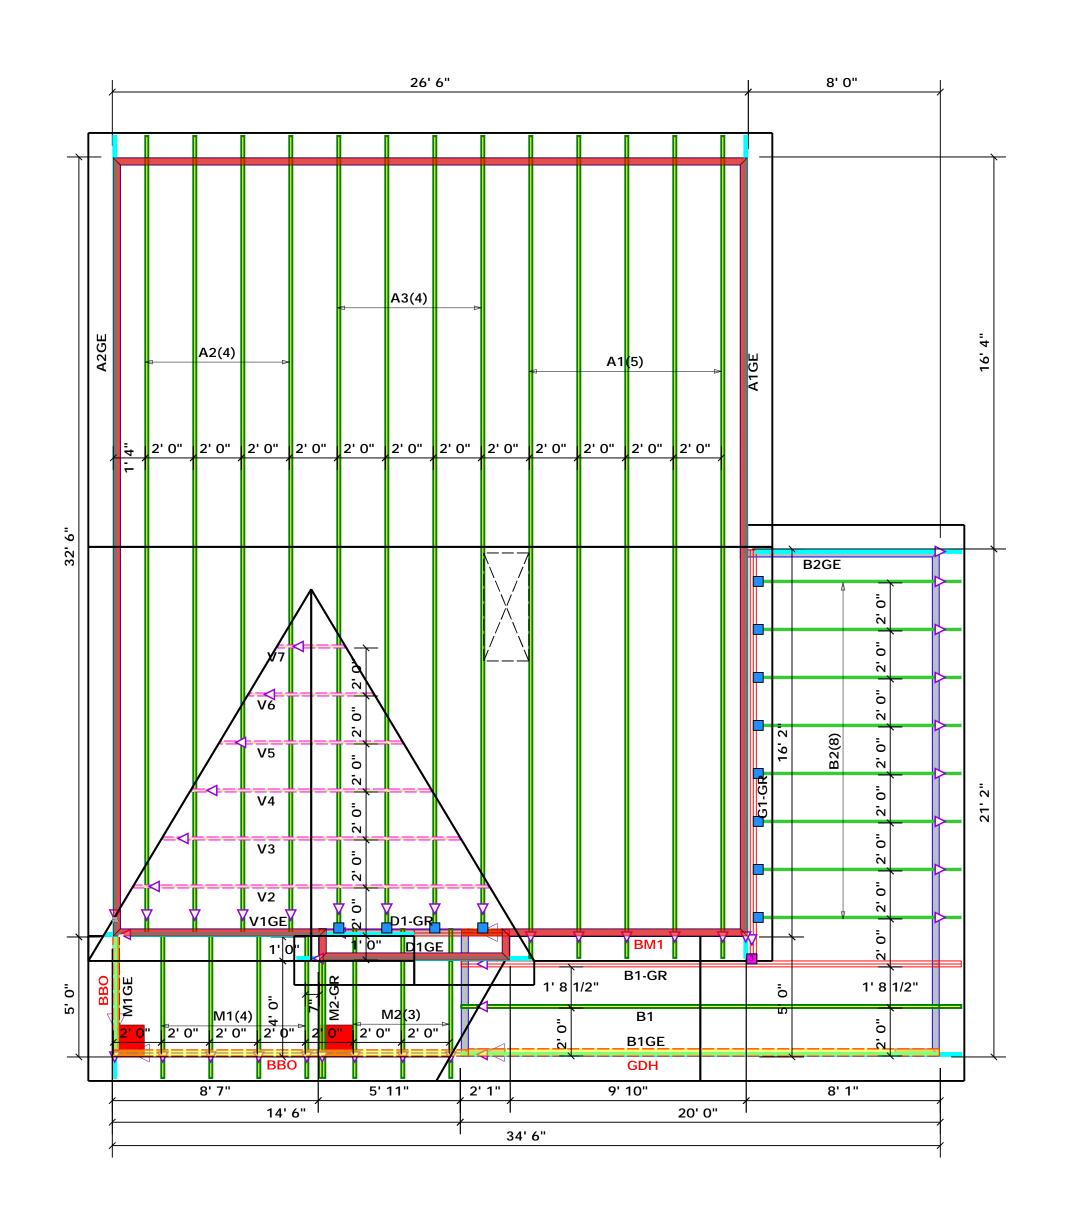

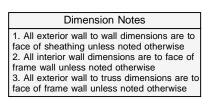


All Walls Shown Are Considered Load Bearing

Roof Area = 1561.6 sq.ft.
Ridge Line = 52.07 ft.
Hip Line = 0 ft.
Horiz. OH = 101.69 ft.
Raked OH = 156.66 ft.
Decking = 54 sheets

На	atch Legend
	2nd Floor Walls
	Drop Beam

	Connector Information				Connector Information Nail Information			ormation
Sym	Product	Manuf	Qty	Supported Member	Header	Truss		
	HUS26	USP	12	NA	16d/3-1/2"	16d/3-1/2"		
3	THDH210-3	USP	1	Varies	16d/3-1/2"	16d/3-1/2"		

		Products			
PlotID	Length	Product	Plies	Net Qty	Fab Type
BM1	12' 0"	1-3/4"x 16" LVL Kerto-S	2	2	FF
BM2	15' 0"	1-3/4"x 16" LVL Kerto-S	2	2	FF
GDH	20' 0"	1-3/4"x 11-7/8" LVL Kerto-S	2	2	FF

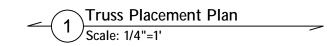



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Bearing reactions less than or equal to 3000# are leemed to comply with the prescriptive Code equirements. The contractor shall refer to the attached Tables (derived from the prescriptive Code equirements) to determine the minimum foundation size and number of wood studs required to support eactions greater than 3000# but not greater than 15000#. A registered design professional shall be etained to design the support system for any eaction that exceeds those specified in the attached Tables. A registered design professional shall be etained to design the support system for all eactions that exceed 15000#.

David Landry

David Landry

LOAD CHART FOR JACK STUDS

	(3	ased.	ON TABL	ês Roc	32.5(1) å	$k(\mathbf{b})$	
NU	WBER C	JE JAC	K STUBS HEADER			EA END O	F
END REACTION (UP 10)	REQ'D STUDS FOR (2) PLY HEADER		END REACTION (UP TD)	REQ15 STUBS FOR	(3) ATY ARABER	END REACTION (UP TO)	REQUESTUBS FOR
1700	1		2550) 1		3400	1
3400	2		5100) 2		6800	2
5100	3		7650) 3		10200	3
6800	4		1020	0 4		13600	4
8500	5		1275	0 5		17000	5
10200	6		1530	0 6			
11900	7						
13600	8						
15300	9						
	1			I			

Regency Homes	CI TY / CO.	CI TY / CO. Erwin / Harnett	8500 10200 11900 13600 15300
Lot 3 Walker Farm	ADDRESS	Wire Rd.	5 6 7 8 9
Hickory II / GR	MODEL	Roof	12750 15300
	DATE REV. 09/01/21	09/01/21	
	DRAWN BY	DRAWN BY David Landry	1700
J0921-5280	SALES REP. Bob Lewis	Bob Lewis	00 5

THIS IS A TRUSS PLACEMENT DIAGRAM ONLY.
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SEAL DATE

QUOTE 7

JOB NAME

BUILDER