

RENAISSANCE RESIDENTIAL DESIGN, INC.

4810 GLENMIST CT. | RALEIGH, NC 27612 (919) 649-4128 WWW.RRDCAROLINA.COM

"The art of transforming your vision into rea RENAISSANCE RESIDENTIAL DESIGN, INC.. RESERVES THE RIGHT TO MAKE MODIFICATIONS TO FLOOR PLANS, DIMENSIONS, MATERIALS, AND SPECIFICATIONS WITHOUT NOTICE. THESE DRAWINGS ARE FOR THE PURPOSE OF CONVEYING AN ARCHITECTURAL CONCEPT ONLY.

HEREMY EXPRESSLY RESERVES ITS
COMMON LAW COPYRIGHT AND OTHER
PROPERTY RIGHTS IN THESE PLANS,
THESE PLANS AND DRAWINGS ARE NOT
TO BE REPRODUCED, CHANGED, OR
COPIED IN ANY FORM OR MANNER
WITHOUT FIRST DOTAINING THE EXPRESS
WRITTEN CONSENT OF REMAISSANCE
RESIDENTIAL DESIGNS, INC., NOR ARE
THEY TO BE ASSIGNED TO ANY THIRD

J.S.THOMPSON ENGINEERING, INC 606 WADE AVE., SUITE 104

606 WADE AVE., SUITE 104 RALEIGH, NC 27605 PHONE: (919) 789-9919 FAX: (919) 789-9921 N.C. LICENSE NO.: C-1733



OCAT FANS. ELECTRICAS. DESIGNS, WILLFIRAZ. AND CONTROLS. AND CONTROLS. AND CONTROLS. AND CONTROLS. AND CONTROLS. AND CONTROLS. AND CARRY IN ACTUAL CONSTRUCTION ACTUAL POSITION OF SE ON LOT WILL BE DETERMINED BY THE SITE PLAN AND PLAN EN CHOOR PLANS AND ELEVATION RENDERINGS ARE IT CONCEPTIONS. FLOOR PLANS ARE THE COPYRIGHTED PERTY OF WESTAN HOMES. ANY USE, REPRODUCTION, ON DISPLAY OF THE PLANS IS STRICTLY ADHIBITED. SEE NEW HOME SALES CONSULTANT FOR RIBARLED. SEE NEW HOME SALES CONSULTANT FOR RIBARLED.

WESTAN HOMES JAMES-II DRIVE LEFT

DATE: MAY 15, 2020

REV.:


SCALE: 1/4" = 1'-0"


DRAWN BY: WG

ENGINEERED BY: ZHH
REVIEWED BY: MGS

FIRST FLOOR PLAN OPTIONS

A-4.1

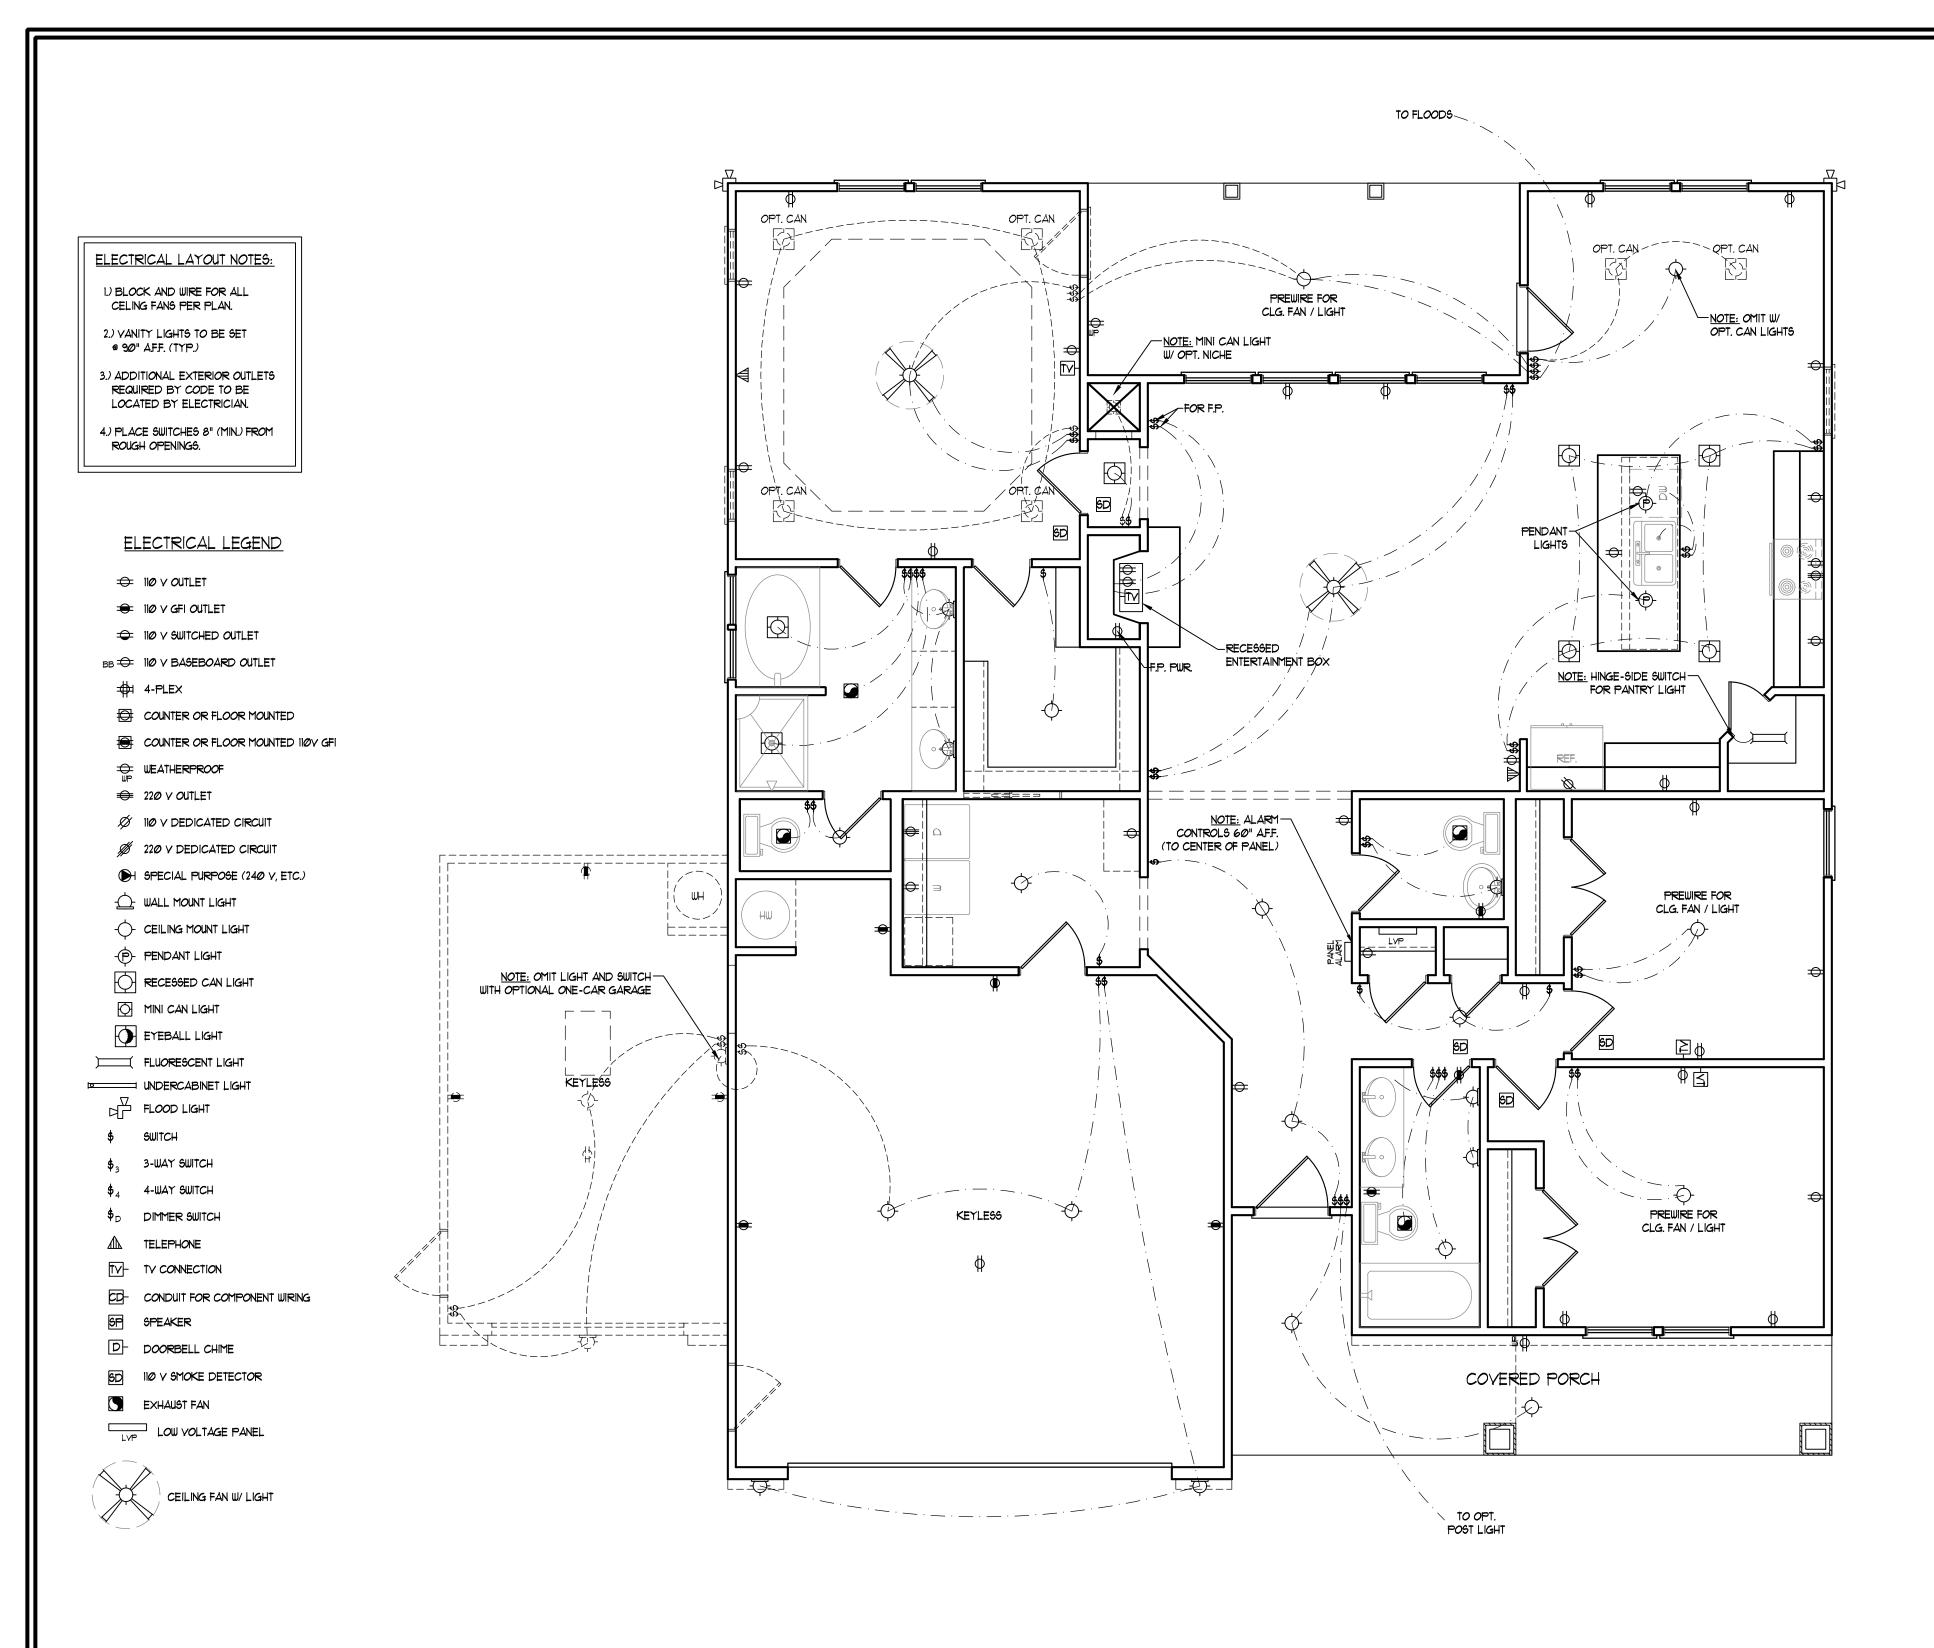

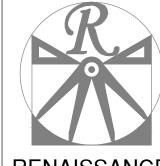

RENAISSANCE
RESIDENTIAL DESIGN, INC.
4810 GLENMIST CT. | RALEIGH, NC 27612

(919) 649-4128 WWW.RRDCAROLINA.COM "The art of transforming your vision into re

RENAISSANCE RESIDENTIAL DESIGN, INC..
RESERVES THE RIGHT TO MAKE
MODIFICATIONS TO FLOOR PLANS,
DIMENSIONS, MATERIALS, AND
SPECIFICATIONS WITHOUT NOTICE.
THESE DRAWINGS ARE FOR THE
PURPOSE OF CONVEYING AN
ARCHITECTURAL CONCEPT ONLY.

RENAISSANCE RESIDENTIAL DESIGN, INC..
HEREBY EXPRESSLY RESERVES ITS
COMMON LAW COPYRIGHT AND OTHER
PROPERTY RIGHTS IN THESE PLANS.
THESE PLANS AND DRAWINGS ARE NOT
TO BE REPRODUCED, CHANGED, OR
COPIED IN ANY FORM OR MANNER
WITHOUT FIRST OBTAINING THE EXPRESS
WRITTEN CONSENT OF RENAISSANCE
RESIDENTIAL DESIGNS, INC.. NOR ARE
THEY TO BE ASSIGNED TO ANY THIRD
PARTY WITHOUT FIRST OBTAINING SAID
WRITTEN PERMISSION AND CONSENT.

J.S.THOMPSON ENGINEERING, INC 606 WADE AVE., SUITE 104 RALEIGH, NC 27605 PHONE: (919) 789-9919 FAX: (919) 789-9921 N.C. LICENSE NO.: C-1733



HUCOR PLANS, ELEVATIONS, DESIGNS, MATERIALS AND DIMENSIONS ARE SUBJECT TO CHANGE WITHOUT NOTICE. SOUME FOOTAGE AND DIMENSIONS ARE ESTIMATED AND DAY WARY IN ACTUAL CONSTRUCTION ACTUAL POSITION OF YOUR HOSTON OF THE SITE PLAN AND DUSE ON LOT OWL BE DETERMINED BY THE SITE PLAN AND OF PLAN FLOOP PLANS AND ELEVATION RENDERINGS ARE TIST CONCEPTIONS, FLOOR PLANS ARE THE COPYRIGHTED FOPERTY OF WEST AN HOMES, ANY USE, REPRODUCTION, ADAPTATION, OR DISPLAY OF THE PLANS IS STRICTLY PROHIBITED. SEE INSW HOME SALES CONSULTANT FOR CURRENT DETAILS, COPYRIGHT © 2019 WESTAN HOMES

WESTAN HOMES JAMES-II DRIVE LEFT

DATE: MAY 15, 2020

REV.:

SCALE: 1/4" = 1'-0"


DRAWN BY: WG

ENGINEERED BY: ZHH
REVIEWED BY: MGS

FIRST FLOOR

ELECTRICAL PLAN

E-1

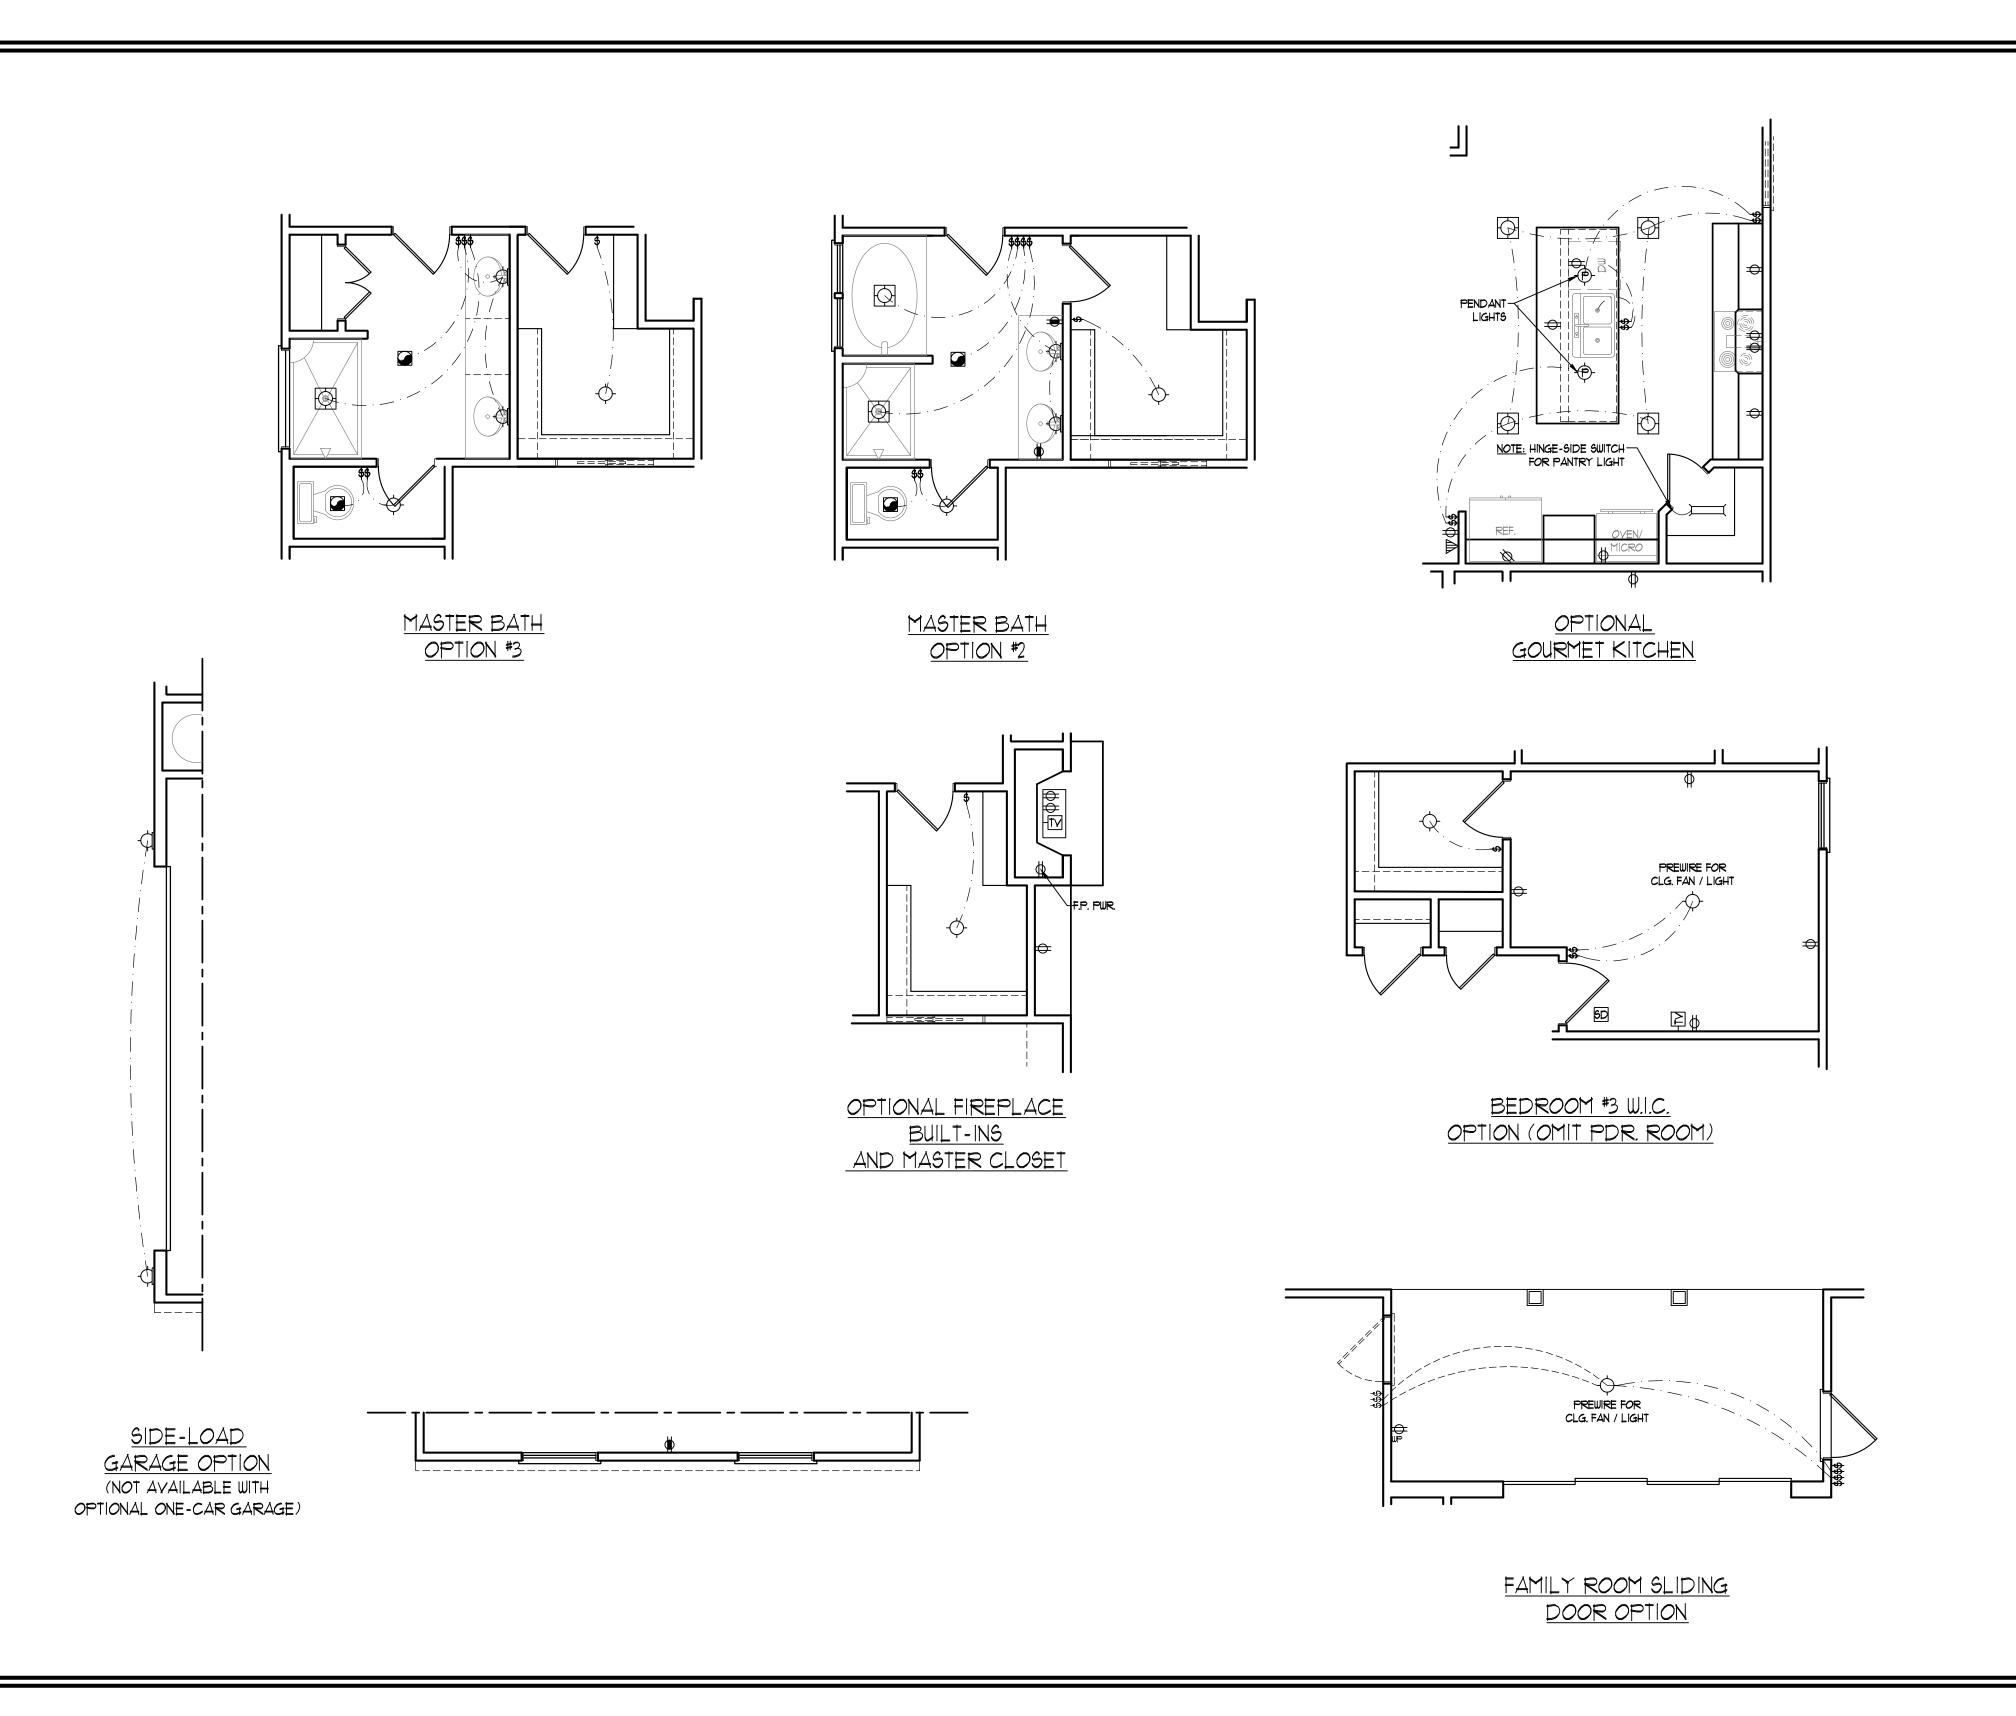

RESIDENTIAL DESIGN, INC. 4810 GLENMIST CT. | RALEIGH, NC 27612

(919) 649-4128 WWW.RRDCAROLINA.COM

"The art of transforming your vision into re RENAISSANCE RESIDENTIAL DESIGN, INC..
RESERVES THE RIGHT TO MAKE
MODIFICATIONS TO FLOOR PLANS,
DIMENSIONS, MATERIALS, AND
SPECIFICATIONS WITHOUT NOTICE.
THESE DRAWINGS ARE FOR THE
PURPOSE OF CONVEYING AN
ARCHITECTURAL CONCEPT ONLY.

J.S.THOMPSON ENGINEERING, INC 606 WADE AVE., SUITE 104 RALEIGH, NC 27605 PHONE: (919) 789-9919 FAX: (919) 789-9921 N.C. LICENSE NO.: C1733



WESTAN HOMES JAMES-II DRIVE LEFT

DATE: MAY 15, 2020


SCALE: 1/4" = 1'-0" DRAWN BY: WG

ENGINEERED BY: ZHH

REVIEWED BY: MGS

FF OPTIONS ELECTRICAL PLAN


E-1.1

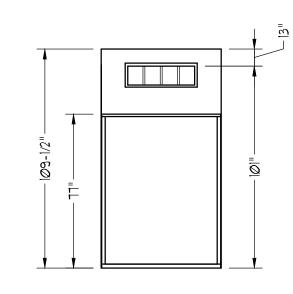

BATHROOM TRANSOM WINDOW

OVER SHOWER DETAIL WITH 9-0 CEILING


SCALE: 1/4" = 1'-0"

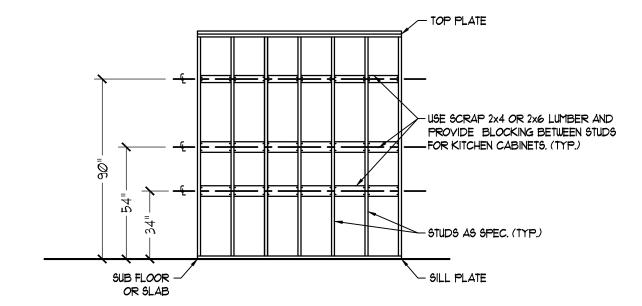

KITCHEN WALL CABINET


BLOCKING DETAIL

SCALE: 1/4" = 1'-0"

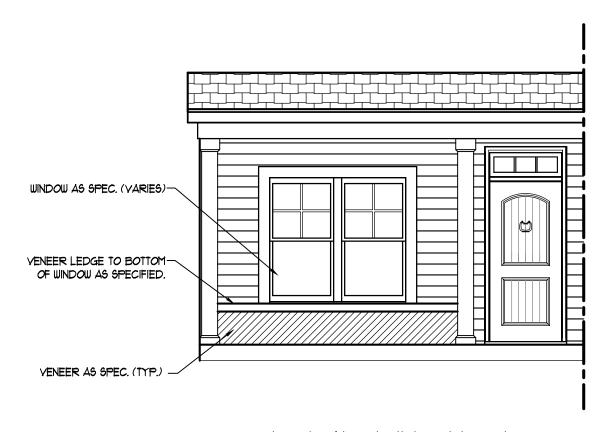

TYPICAL VENEER LEDGE
UNDER FRONT WINDOW DETAIL


SCALE: 1/4" = 1'-0"

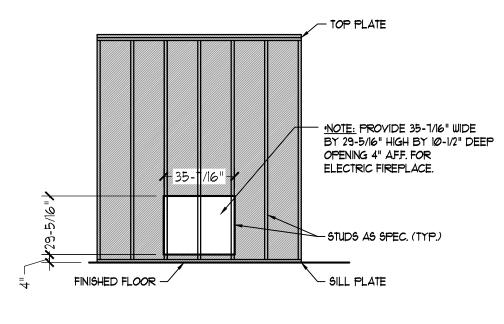

33" ELECTRIC FIREPLACE

OPENING DETAIL

SCALE: 1/4" = 1'-0"

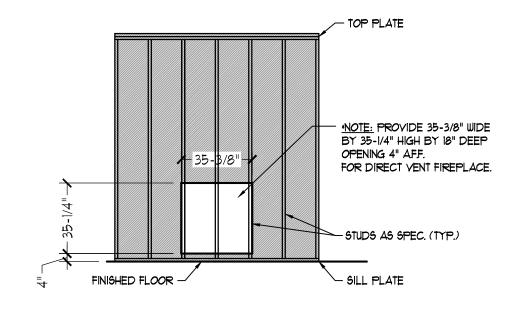

35" DIRECT VENT FIREPLACE

OPENING DETAIL

SCALE: 1/4" = 1'-0"



RESIDENTIAL DESIGN, INC.
4810 GLENMIST CT. | RALEIGH, NC 27612

(919) 649-4128 WWW.RRDCAROLINA.COM "The art of transforming your vision into real

RENAISSANCE RESIDENTIAL DESIGN, INC..
RESERVES THE RIGHT TO MAKE
MODIFICATIONS TO FLOOR PLANS,
DIMENSIONS, MATERIALS, AND
SPECIFICATIONS WITHOUT NOTICE.
THESE DRAWINGS ARE FOR THE
PURPOSE OF CONVEYING AN
ARCHITECTURAL CONCEPT ONLY.

RENAISSANCE RESIDENTIAL DESIGN, INC..
HEREBY EXPRESSLY RESERVES ITS
COMMON LAW COPYRIGHT AND OTHER
PROPERTY RIGHTS IN THESE PLANS.
THESE PLANS AND DRAWINGS ARE NOT
TO BE REPRODUCED, CHANGED, OR
COPIED IN ANY FORM OR MANNER
WITHOUT FIRST OBTAINING THE EXPRESS
WRITTEN CONSENT OF RENAISSANCE
RESIDENTIAL DESIGNS, INC.. NOR ARE
THEY TO BE ASSIGNED TO ANY THIRD
PARTY WITHOUT FIRST OBTAINING SAID
WRITTEN PERMISSION AND CONSENT.

J.S.THOMPSON ENGINEERING, INC 606 WADE AVE, SUITE 104 RALEIGH, NC 27605 PHONE: (919) 789-9919

RALEIGH, NC 27605
PHONE: (919) 789-9919
FAX: (919) 789-9921
N.C. LICENSE NO.: C-1733



DR PLANS, ELEVATIONS, DESIGNS, MATERIALS AND SISIONS ARE SUBLECT TO CHAMEE WITHOUT NOTICE. HE FOOTAGE AND DIMENSIONS ARE ESTIMATED AND RRY IN ACTUAL CONSTRUCTION ACTUAL POSITION OF ON LOT WILL BE DETERMINED BY THE SITE PLAN AND A. FLOOR PLANS ARE THE COPYRICHTED CONCEPTIONS. FLOOR PLANS ARE THE COPYRICHTED FRITY OF WESTAN HOMES. ANY USE, REPRODUCTION, PITATION, OR DISPLAY OF THE PLANS IS STRICTLY HIBITED. SEE NEW HOME SALES CONSULTANT FOR REIN DETAILS. COPYRIGHT © 2019 WESTAN HOMES

WESTAN HOMES JAMES-II DRIVE LEFT

DATE: MAY 15, 2020

REV.:

SCALE: 1/4" = 1'-0"

DRAWN BY: WG

ENGINEERED BY: ZHH

REVIEWED BY: MGS


STANDARD DETAILS


D-1

-----12'**-**Ø"-----

-----12'**-**Ø"-----120 MPH ULTIMATE DESIGN WIND SPEED NOTES FOR LESS THAN SEE MONOLITHIC SLAB DETAIL 30' MEAN ROOF HEIGHT: SHEET FOR FND. OPTIONS. ENGINEER'S SEAL APPLIES ONLY TO STRUCTURAL COMPONENTS. ENGINEER'S SEAL DOES NOT CERTIFY DIMENSIONAL ACCURACY OR ARCHITECTURAL LAYOUT RENAISSANCE INCLUDING ROOF SYSTEM. RESIDENTIAL DESIGN, INC. STRUCTURAL DESIGN PER NORTH CAROLINA -18" x 18" x 12" 4810 GLENMIST CT. | RALEIGH, NC 27612 RESIDENTIAL CODE, 2018 EDITION. (919) 649-4128 CONC. FTG. (TYP.) INSTALL 1/2" ANCHOR BOLTS 6'-0" O.C. AND WWW.RRDCAROLINA.COM WITHIN 1'-0" FROM END OF EACH CORNER. The art of transforming your vision into re a ANCHOR BOLTS MUST EXTEND A MINIMUM OF -4" CONC.-1" INTO MASONRY OR CONCRETE. LOCATE RESERVES THE RIGHT TO MAKE MODIFICATIONS TO FLOOR PLANS, DIMENSIONS, MATERIALS, AND SPECIFICATIONS WITHOUT NOTICE. THESE DRAWINGS ARE FOR THE PURPOSE OF CONVEYING AN ARCHITECTURAL CONCEPT ONLY. SLAB BOLT WITHIN MIDDLE THIRD OF PLATE WIDTH. MEAN ROOF HEIGHT IS LESS THAN 30 FEET. 5. EXTERIOR WALLS DESIGNED FOR 120 MPH WINDS. RENAISSANCE RESIDENTIAL DESIGN, INC.. HEREBY EXPRESSLY RESERVES ITS COMMON LAW COPYRIGHT AND OTHER PROPERTY RIGHTS IN THESE PLANS. THESE PLANS AND DRAWINGS ARE NOT TO BE REPRODUCED, CHANGED, OR COPIED IN ANY FORM OR MANNER WITHOUT FIRST OBTAINING THE EXPRESS WRITTER CONSENT OF RENAISSANCE RESIDENTIAL DESIGNS, INC.. NOR ARE THEY TO BE ASSIGNED TO ANY THIRD PARTY WITHOUT FIRST OBTAINING SAID WRITTEN PERMISSION AND CONSENT. WALL CLADDING DESIGNED FOR +15.5 PSF AND -20 PSF (+/- INDICATE POSITIVE / NEGATIVE PRESSURE (TYP). ROOF CLADDING DESIGNED FOR +14.2 PSF AND -18 PSF FOR ROOF PITCHES 7/12 TO 12/12 AND +10 PSF AND -36 PSF FOR ROOF PITCHED 2.25/12 TO 1/12. INSTALL 7/16" OSB SHEATHING ON ALL EXTERIOR WALLS OF ALL STORIES IN i.s.Thompson ACCORDANCE WITH SECTION R602.10.3 OF --+----9'-6"------ ENGINEERING, INC THE NCRC, 2018 EDITION. SEE THE WALL 606 WADE AVE., SUITE 104 BRACING NOTES AND DETAILS SHEET FOR RALEIGH, NC 27605 PHONE: (919) 789-9919 MORE INFORMATION. FAX: (919) 789-9921 ENERGY EFFICIENCY COMPLIANCE AND N.C. LICENSE NO.: C-1733 INSULATION VALUES OF THE BUILDING TO BE IN ACCORDANCE WITH CHAPTER II OF THE NCRC, 2018 EDITION. 10. REFER TO NOTES AND DETAIL SHEETS FOR 4" CONC.— ADDITIONAL STRUCTURAL INFORMATION. SLAB --| 2'-1 1/2"-|-2'-1 1/2"-|------8'-5"------130 MPH ULTIMATE DESIGN WIND SPEED NOTES FOR LESS THAN ====== 30' MEAN ROOF HEIGHT: ENGINEER'S SEAL APPLIES ONLY TO STRUCTURAL COMPONENTS. ENGINEER'S SEAL DOES NOT CERTIFY DIMENSIONAL |'-|Ø" |- ACCURACY OR ARCHITECTURAL LAYOUT INCLUDING ROOF SYSTEM. Ω STRUCTURAL DESIGN PER NORTH CAROLINA RESIDENTIAL CODE, 2018 EDITION. INSTALL 1/2" ANCHOR BOLTS 4'-0" O.C. AND WITHIN 1'-0" FROM END OF EACH CORNER ANCHOR BOLTS MUST EXTEND A MINIMUM OF WH 1" INTO MASONRY OR CONCRETE. LOCATE BOLT WITHIN MIDDLE THIRD OF PLATE WIDTH. MEAN ROOF HEIGHT IS LESS THAN 30 FEET. EXTERIOR WALLS DESIGNED FOR 130 MPH WINDS. WALL CLADDING DESIGNED FOR +18.2 PSF AND -24 PSF (+/- INDICATE POSITIVE / NEGATIVE PRESSURE (TYP). ROOF CLADDING DESIGNED FOR +16.7 PSF OPTIONAL AND -21 PSF FOR ROOF PITCHES 7/12 TO 12/12 1-CAR GARAGE AND +10.5 PSF AND -43 PSF FOR ROOF PITCHED 2.25/12 TO 1/12. -11'-Ø 3/4"-INSTALL 7/16" OSB SHEATHING ON ALL EXTERIOR WALLS OF ALL STORIES IN ACCORDANCE WITH SECTION R602.10.3 OF NOTE: PROVIDE 2-8 6-8 ``-4" ¢ONC.-5/21/2020 THE NCRC, 2018 EDITION. SEE THE WALL ROUGH OPENING WITH 1-CAR SLIAB BRACING NOTES AND DETAILS SHEET FOR GARAGE OPTION. MORE INFORMATION. ENERGY EFFICIENCY COMPLIANCE AND INSULATION VALUES OF THE BUILDING TO BE NCRC, 2018 EDITION. 10. REFER TO NOTES AND DETAIL SHEETS FOR ADDITIONAL STRUCTURAL INFORMATION. -5" BRICK LEDGE FOR 4" CONC .-SLAB OPTIONAL VENEER WESTAN JAMES-II DRIVE LE (SEE ELEVATION PAGES FOR LOCATIONS AND CONDITIONS) -11'-10" ELEV. C----- 20'-0" -4" CONC. SLAB-*NOTE: FRONT PORCH STOPS HERE - SEE WALL BRACING DETAIL SHEET FOR ELEVATION C ONLY DATE: MAY 15, 2020 FOR FOUNDATION DETAILS REV.: SCALE: 1/4" = 1'-0" DRAWN BY: WG SEE WALL BRACING DETAIL SHEET FOR BRICK NEER (TYP.) ENGINEERED BY: ZHH \sim 18" \times 18" \times 12" CONC. FTG. (TYP.) FOR FOUNDATION DETAILS OR FOR ELEVATION B&C: REVIEWED BY: MGS -16'-4"-16" x 16" MASONRY PIER MONO SLAB (INCLUDING VENEER) ON **FOUNDATION** 24" x 24" x 12" CONC. FTG. (TYP.) - 21'-Ø" - 25'-Ø" -PLAN


S-1

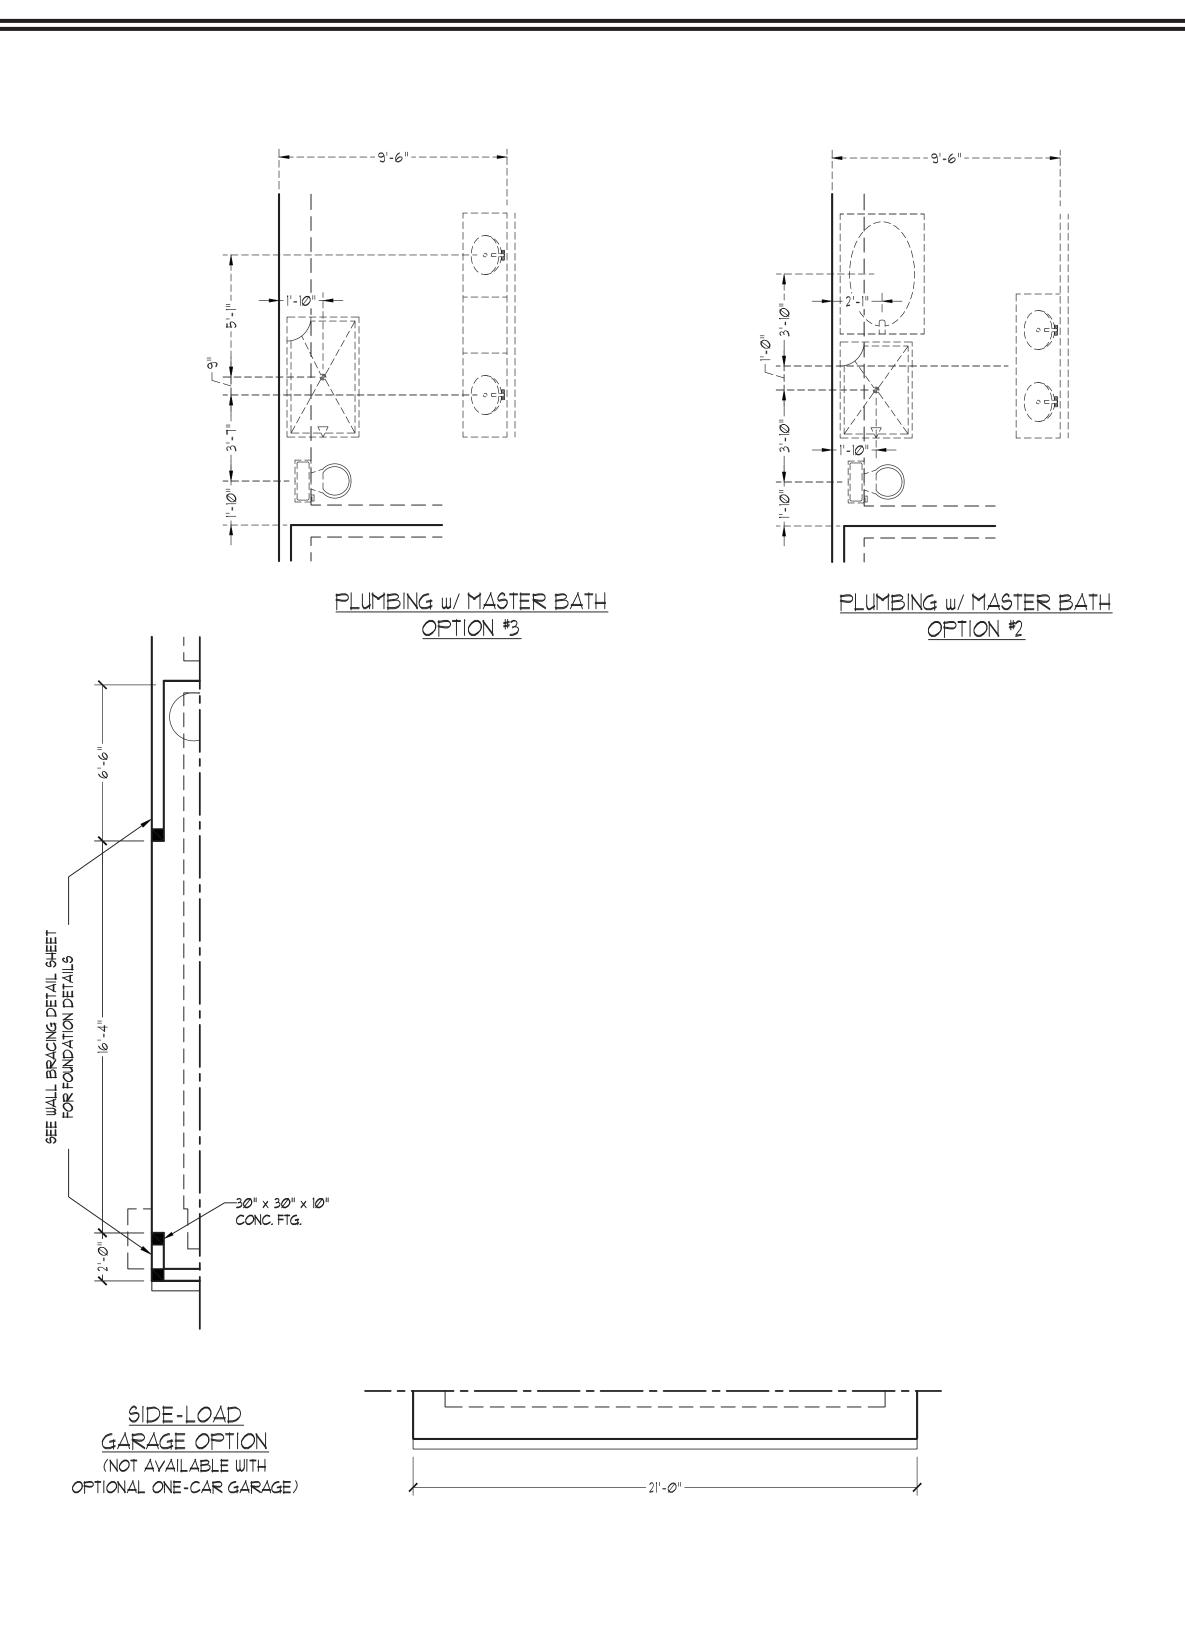

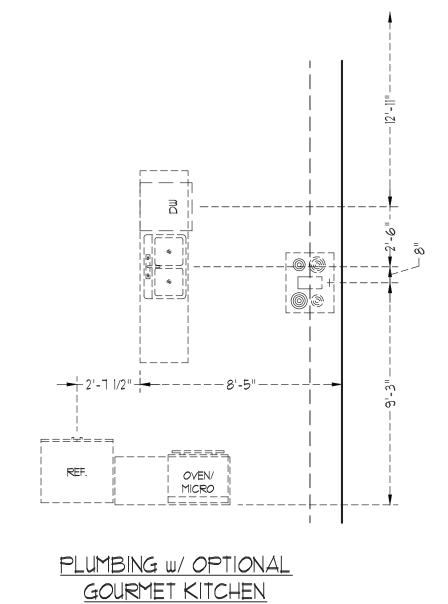




5/21/2020

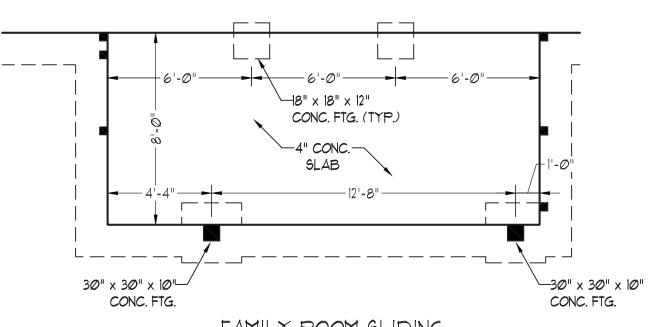

FAMILY ROOM SLIDING DOOR OPTION

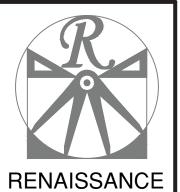

RESIDENTIAL DESIGN, INC. 4810 GLENMIST CT. | RALEIGH, NC 27612

(919) 649-4128 WWW.RRDCAROLINA.COM "The art of transforming your vision into re ality.

RENAISSANCE RESIDENTIAL DESIGN, INC...
RESERVES THE RIGHT TO MAKE
MODIFICATIONS TO FLOOR PLANS,
DIMENSIONS, MATERIALS, AND
SPECIFICATIONS WITHOUT NOTICE.
THESE DRAWINGS ARE FOR THE
PURPOSE OF CONVEYING AN
ARCHITECTURAL CONCEPT ONLY.

RENAISSANCE RESIDENTIAL DESIGN, INC..
HEREBY EXPRESSLY RESERVES ITS
COMMON LAW COPYRIGHT AND OTHER
PROPERTY RIGHTS IN THESE PLANS.
THESE PLANS AND DRAWINGS ARE NOT
TO BE REPRODUCED, CHANGED, OR
COPIED IN ANY FORM OR MANNER
WITHOUT FIRST OBTAINING THE EXPRESS
WRITTEN CONSENT OF RENAISSANCE
RESIDENTIAL DESIGNS, INC.. NOR ARE
THEY TO BE ASSIGNED TO ANY THIRD
PARTY WITHOUT FIRST OBTAINING SAID
WRITTEN PERMISSION AND CONSENT.

J.S.THOMPSON ENGINEERING, INC 606 WADE AVE., SUITE 104 RALEIGH, NC 27605 PHONE: (919) 789-9919 FAX: (919) 789-9921 N.C. LICENSE NO.: C-1733



S WESTAN HOMES JAMES-II DRIVE LEFT


DATE: MAY 15, 2020


SCALE: 1/4" = 1'-0" DRAWN BY: WG

ENGINEERED BY: ZHH REVIEWED BY: MGS


MONO SLAB FOUNDATION PLAN OPTIONS

S-1.1

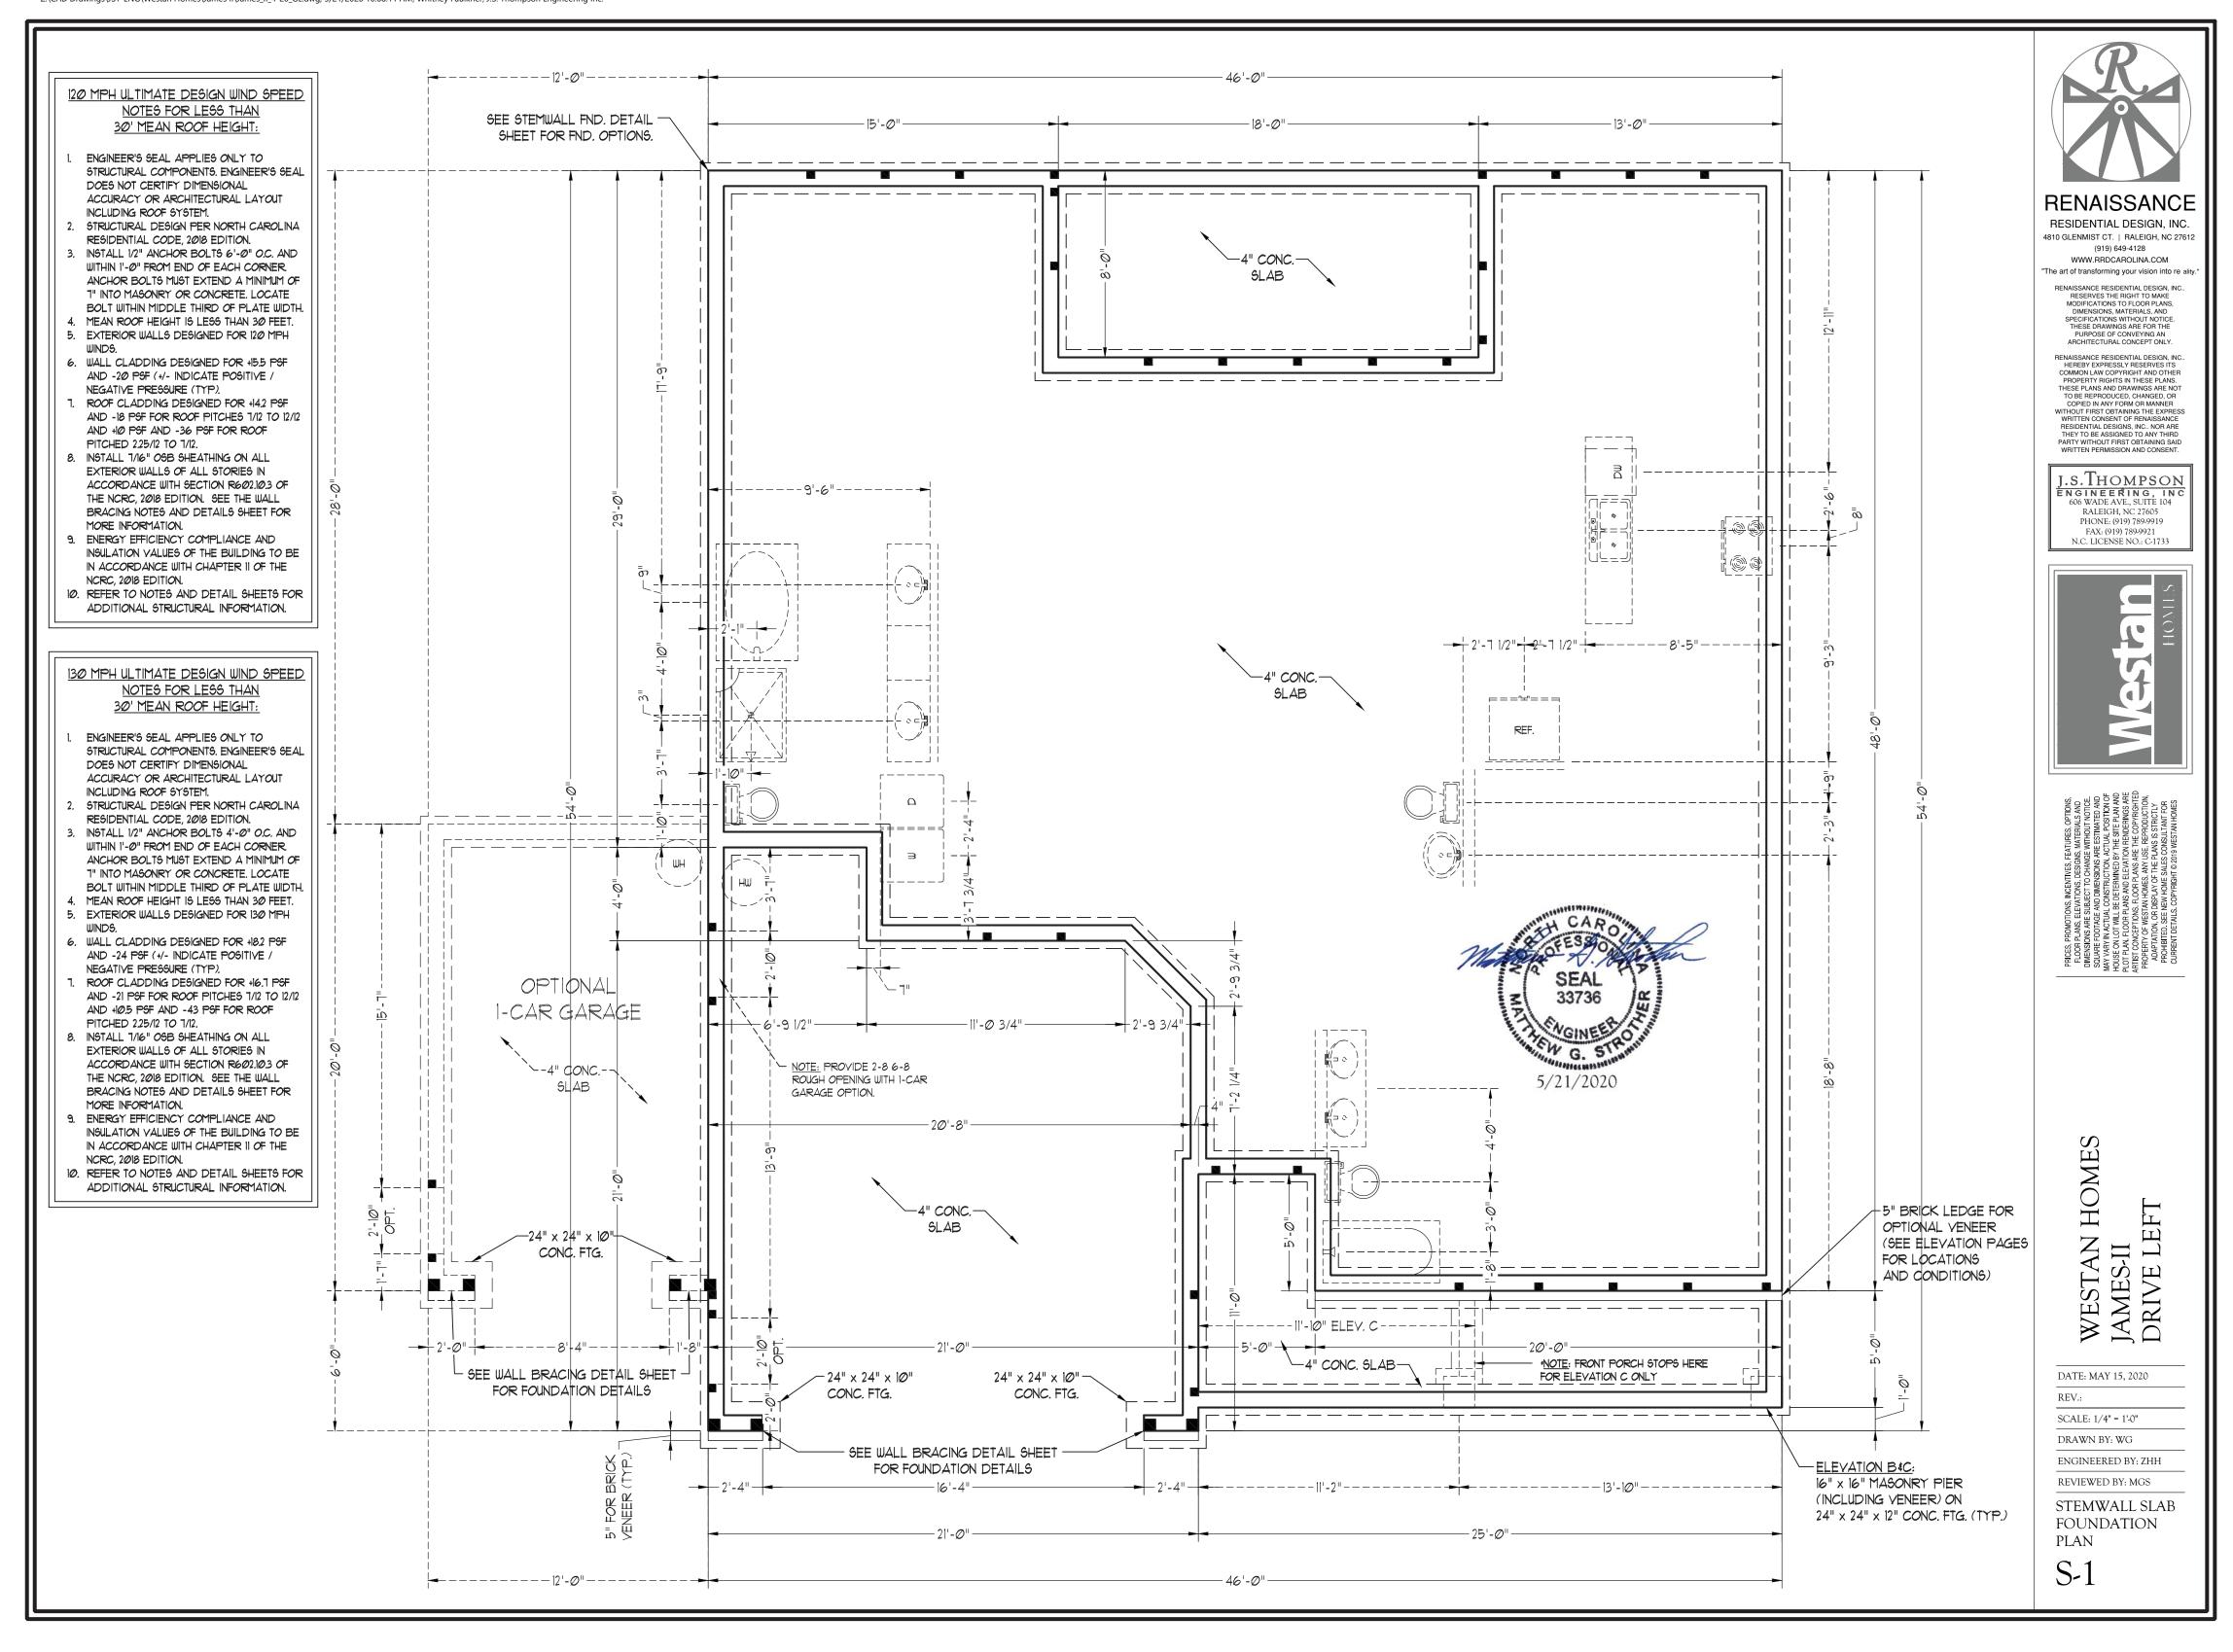


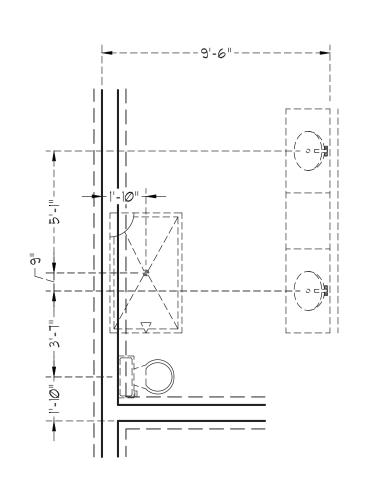

PLUMBING W/ MASTER BATH OPTION #3

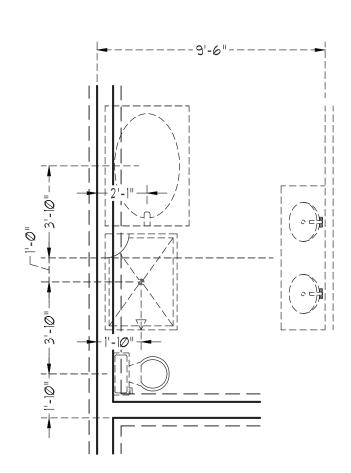


PLUMBING W/ MASTER BATH OPTION #2

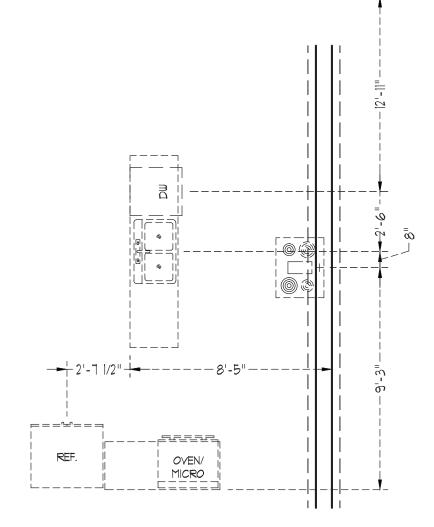

PLUMBING W/ OPTIONAL



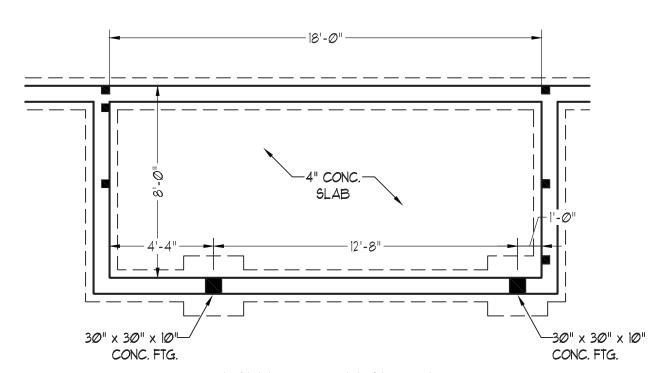

FAMILY ROOM SLIDING DOOR OPTION

GOURMET KITCHEN



WESTAN HOMES JAMES-II DRIVE LEFT

RENAISSANCE RESIDENTIAL DESIGN, INC. 4810 GLENMIST CT. | RALEIGH, NC 27612 (919) 649-4128 WWW.RRDCAROLINA.COM "The art of transforming your vision into re ality

RENAISSANCE RESIDENTIAL DESIGN, INC...
RESERVES THE RIGHT TO MAKE
MODIFICATIONS TO FLOOR PLANS,
DIMENSIONS, MATERIALS, AND
SPECIFICATIONS WITHOUT NOTICE.
THESE DRAWINGS ARE FOR THE
PURPOSE OF CONVEYING AN
ARCHITECTURAL CONCEPT ONLY.

RENAISSANCE RESIDENTIAL DESIGN, INC...
HEREBY EXPRESSLY RESERVES ITS
COMMON LAW COPYRIGHT AND OTHER
PROPERTY RIGHTS IN THESE PLANS.
THESE PLANS AND DRAWNIGS ARE NOT
TO BE REPRODUCED, CHANGED, OR
COPIED IN ANY FORM OR MANNER
WITHOUT FIRST OBTAINING THE EXPRESS
WRITTEN CONSENT OF RENAISSANCE
RESIDENTIAL DESIGNS, INC.. NOR ARE
THEY TO BE ASSIGNED TO ANY THIRD
PARTY WITHOUT FIRST OBTAINING SAID
WRITTEN PERMISSION AND CONSENT.

J.S.THOMPSON ENGINEERING, INC 606 WADE AVE., SUITE 104 RALEIGH, NC 27605 PHONE: (919) 78899919

FAX: (919) 789-9921 N.C. LICENSE NO.: C-1733

DATE: MAY 15, 2020

REV.: SCALE: 1/4" = 1'-0"


DRAWN BY: WG

ENGINEERED BY: ZHH


REVIEWED BY: MGS

STEMWALL SLAB FOUNDATION PLAN OPTIONS


S-1.1

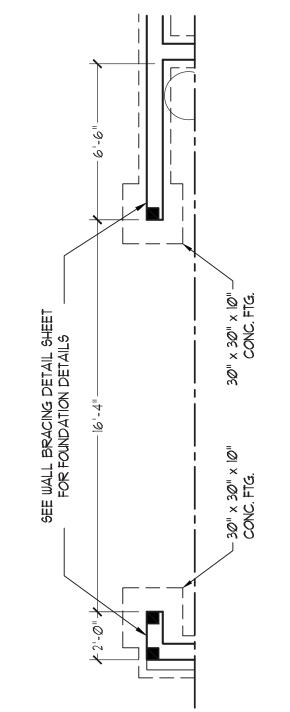


SIDE-LOAD GARAGE OPTION (NOT AVAILABLE WITH OPTIONAL ONE-CAR GARAGE)

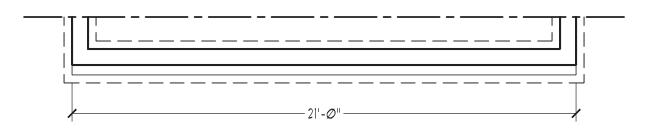


FOUNDATION VENTILATION CALCULATION 1616 SQ. FT. OF CRAWL SPACE DIVIDED BY -----12'**-**Ø"-----1500 EQUALS 1.1 SQ. FT. OF NET FREE AREA REQUIRED. INSTALL 6 MIL POLY TO COVER 8" FND. ON 16" WIDE ENTIRE CRAWL SPACE. LOCATE VENTS SEAL BY 8" DEEP CONT. WITHIN 3'-0" OF EACH CORNER OF THE 33736 18" x 24" CRAWL ACCESS CONC. FTG. (TYP.) BUILDING TO PROVIDE CROSS-VENTILATION. (MIN.) PER GRADE. WGINEE W G. 51 120 MPH ULTIMATE DESIGN WIND SPEED NOTES FOR LESS THAN RENAISSANCE 30' MEAN ROOF HEIGHT: /21/2020 RESIDENTIAL DESIGN, INC. 4810 GLENMIST CT. | RALEIGH, NC 27612 ENGINEER'S SEAL APPLIES ONLY TO (919) 649-4128 WWW.RRDCAROLINA.COM STRUCTURAL COMPONENTS. ENGINEER'S SEAL The art of transforming your vision into re DOES NOT CERTIFY DIMENSIONAL SLAB ACCURACY OR ARCHITECTURAL LAYOUT RESERVES THE RIGHT TO MAKE MODIFICATIONS TO FLOOR PLANS, INCLUDING ROOF SYSTEM. MODIFICATIONS TO FLOOR PLANS, DIMENSIONS, MATERIALS, AND SPECIFICATIONS WITHOUT NOTICE. THESE DRAWINGS ARE FOR THE PURPOSE OF CONVEYING AN ARCHITECTURAL CONCEPT ONLY. STRUCTURAL DESIGN PER NORTH CAROLINA RESIDENTIAL CODE, 2018 EDITION. INSTALL 1/2" ANCHOR BOLTS 6'-0" O.C. AND RENAISSANCE RESIDENTIAL DESIGN, INC. HEREBY EXPRESSLY RESERVES ITS COMMON LAW COPYRIGHT AND OTHER PROPERTY RIGHTS IN THESE PLANS. THESE PLANS AND DRAWINGS ARE NOT TO BE REPRODUCED, CHANGED, OR COPIED IN ANY FORM OR MANNER WITHOUT FIRST OBTAINING THE EXPRESS WRITTEN CONSENT OF RENAISSANCE RESIDENTIAL DESIGNS, INC., NOR ARE THEY TO BE ASSIGNED TO ANY THIRD THEY TO BE ASSIGNED TO ANY THIRD WRITTEN PERMISSION AND CONSENT. WITHIN 1'-0" FROM END OF EACH CORNER ANCHOR BOLTS MUST EXTEND A MINIMUM OF 1" INTO MASONRY OR CONCRETE. LOCATE BOLT WITHIN MIDDLE THIRD OF PLATE WIDTH. MEAN ROOF HEIGHT IS LESS THAN 30 FEET. EXTERIOR WALLS DESIGNED FOR 120 MPH WINDS. -16" x 16" CMU PIER WALL CLADDING DESIGNED FOR +15.5 PSF AND -20 PSF (+/- INDICATE POSITIVE / W/ 30" x 30" x 10" i.s.Thompson NEGATIVE PRESSURE (TYP). CONC. FTG. (TYP.) ENGINEERING, IN ROOF CLADDING DESIGNED FOR +14.2 PSF 606 WADE AVE., SUITE 104 AND -18 PSF FOR ROOF PITCHES 1/12 TO 12/12 RALEIGH, NC 27605 AND +10 PSF AND -36 PSF FOR ROOF PHONE: (919) 789-9919 FAX: (919) 789-9921 PITCHED 2.25/12 TO 1/12. N.C. LICENSE NO.: C-1733 INSTALL 1/16" OSB SHEATHING ON ALL EXTERIOR WALLS OF ALL STORIES IN ACCORDANCE WITH SECTION R602.10.3 OF THE NCRC, 2018 EDITION. SEE THE WALL 3'-Ø" BRACING NOTES AND DETAILS SHEET FOR (3) 2 x 10 GIRDER-1 MORE INFORMATION. DROPPED (TYP.) ENERGY EFFICIENCY COMPLIANCE AND INSULATION VALUES OF THE BUILDING TO BE IN ACCORDANCE WITH CHAPTER II OF THE NCRC, 2018 EDITION. **CABINETS** 10. REFER TO NOTES AND DETAIL SHEETS FOR ISLAND ABOVE ADDITIONAL STRUCTURAL INFORMATION. 130 MPH ULTIMATE DESIGN WIND SPEED NOTES FOR LESS THAN 30' MEAN ROOF HEIGHT: 7'-8"--8'-10" -8'-10" 2'-10/1/2 ENGINEER'S SEAL APPLIES ONLY TO STRUCTURAL COMPONENTS. ENGINEER'S SEAL DOES NOT CERTIFY DIMENSIONAL ACCURACY OR ARCHITECTURAL LAYOUT INCLUDING ROOF SYSTEM. STRUCTURAL DESIGN PER NORTH CAROLINA RESIDENTIAL CODE, 2018 EDITION. INSTALL 1/2" ANCHOR BOLTS 4'-0" O.C. AND WITHIN 1'-0" FROM END OF EACH CORNER. ANCHOR BOLTS MUST EXTEND A MINIMUM OF 1" INTO MASONRY OR CONCRETE. LOCATE BOLT WITHIN MIDDLE THIRD OF PLATE WIDTH. NOTE: PROVIDE 2-8 6-8 8'-0" -8'-8" OPTIONAL ROUGH OPENING WITH 1-CAR MEAN ROOF HEIGHT IS LESS THAN 30 FEET. GARAGE OPTION. EXTERIOR WALLS DESIGNED FOR 130 MPH 1-CAR GARAGE WINDS. -11'-Ø 3/4"-WALL CLADDING DESIGNED FOR +18.2 PSF AND -24 PSF (+/- INDICATE POSITIVE / NEGATIVE PRESSURE (TYP). ROOF CLADDING DESIGNED FOR +16.1 PSF --4" CONC. AND -21 PSF FOR ROOF PITCHES 1/12 TO 12/12 SLAB AND +10.5 PSF AND -43 PSF FOR ROOF PITCHED 2.25/12 TO 1/12. INSTALL 1/16" OSB SHEATHING ON ALL EXTERIOR WALLS OF ALL STORIES IN ACCORDANCE WITH SECTION R602.10.3 OF THE NCRC, 2018 EDITION. SEE THE WALL BRACING NOTES AND DETAILS SHEET FOR MORE INFORMATION. 12" FND. ON 20" WIDE-ENERGY EFFICIENCY COMPLIANCE AND -5" BRICK LEDGE FOR 2'-10" OPT. 4" CONC.--24" x 24" x 1Ø' BY 8" DEEP CONT. INSULATION VALUES OF THE BUILDING TO BE SLAB OPTIONAL VENEER CONC. FTG. IN ACCORDANCE WITH CHAPTER II OF THE CONC. FTG. (TYP. FOR WESTAN JAMES-II (SEE ELEVATION PAGES NCRC, 2018 EDITION. BRICK VENEER) 10. REFER TO NOTES AND DETAIL SHEETS FOR FOR LOCATIONS ADDITIONAL STRUCTURAL INFORMATION. AND CONDITIONS) STRUCTURAL NOTES: ALL FRAMING LUMBER TO BE #2 SPF (UNO). *NOTE: FRONT PORCH STOPS HERE 24" × 24" × 10" -FOR ELEVATION C ONLY -24" × 24" × 1Ø" DATE: MAY 15, 2020 – SEE WALL BRACING DETAIL SHEET ALL TREATED LUMBER TO BE #2 SYP (UNO.) CONC. FTG. CONC. FTG. FOR FOUNDATION DETAILS INSTALL AN EXTRA OR DOUBLE JOIST REV.: UNDER WALLS PARALLEL TO FLOOR JOISTS SCALE: 1/4" = 1'-0" WHERE NOTED ON THE PLANS. DRAWN BY: WG SQUARES DENOTE POINT LOADS WHICH SEE WALL BRACING DETAIL SHEET REQUIRE SOLID BLOCKING TO GIRDER OR ENGINEERED BY: ZHH -ELEVATION B&C: FOR FOUNDATION DETAILS FOUNDATION. REVIEWED BY: MGS 16" x 16" MASONRY PIER -16'-4"-SHADED PIERS TO BE FILLED SOLID. (INCLUDING VENEER) ON **CRAWL** INSTALL LADDER WIRE @ 16" O.C. TO 24" x 24" x 12" CONC. FTG. (TYP.) **FOUNDATION** SECURE MULTIPLE WYTHE FOUNDATION - 25'-Ø" PLAN WALLS TOGETHER. REFER TO NOTES AND DETAIL SHEETS FOR S-1 ADDITIONAL STRUCTURAL INFORMATION.

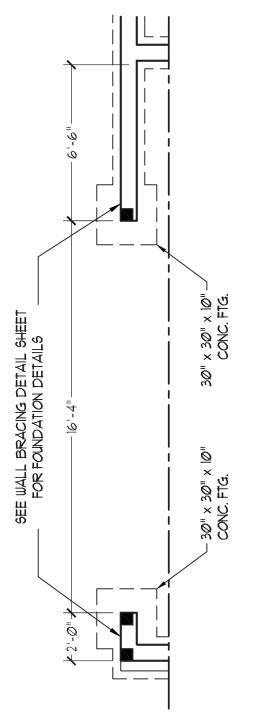

SIDE-LOAD GARAGE OPTION (NOT AVAILABLE WITH OPTIONAL ONE-CAR GARAGE)

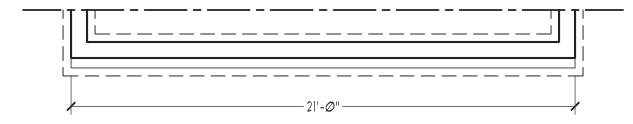



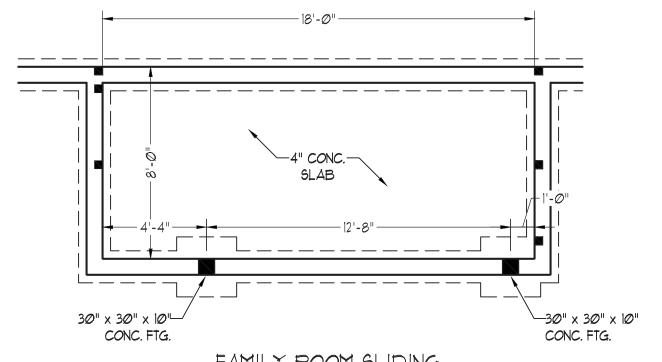

FAMILY ROOM SLIDING DOOR OPTION



RENAISSANCE |

RESIDENTIAL DESIGN, INC. 4810 GLENMIST CT. | RALEIGH, NC 27612 (919) 649-4128

The art of transforming your vision into re ality.

WWW.RRDCAROLINA.COM

RENAISSANCE RESIDENTIAL DESIGN, INC...
RESERVES THE RIGHT TO MAKE
MODIFICATIONS TO FLOOR PLANS,
DIMENSIONS, MATERIALS, AND
SPECIFICATIONS WITHOUT NOTICE.
THESE DRAWINGS ARE FOR THE
PURPOSE OF CONVEYING AN
ARCHITECTURAL CONCEPT ONLY.

RENAISSANCE RESIDENTIAL DESIGN, INC...
HEREBY EXPRESSLY RESERVES ITS
COMMON LAW COPYRIGHT AND OTHER
PROPERTY RIGHTS IN THESE PLANS.
THESE PLANS AND DRAWNINGS ARE NOT
TO BE REPRODUCED, CHANGED, OR
COPIED IN ANY FORM OR MANNER
WITHOUT FIRST OBTAINING THE EXPRESS
WRITTEN CONSENT OF RENAISSANCE
RESIDENTIAL DESIGNS, INC.. NOR ARE
THEY TO BE ASSIGNED TO ANY THIRD
PARTY WITHOUT FIRST OBTAINING SAID
WRITTEN PERMISSION AND CONSENT.

J.S.THOMPSON ENGINEERING, INC 606 WADE AVE., SUITE 104 RALEIGH, NC 27605 PHONE: (919) 789-9919 FAX: (919) 789-9921 N.C. LICENSE NO.: C-1733



WESTAN HOMES JAMES-II DRIVE LEFT

DATE: MAY 15, 2020

REV.:


SCALE: 1/4" = 1'-0" DRAWN BY: WG


ENGINEERED BY: ZHH

REVIEWED BY: MGS

CRAWL FOUNDATION PLAN OPTIONS

S-1.1

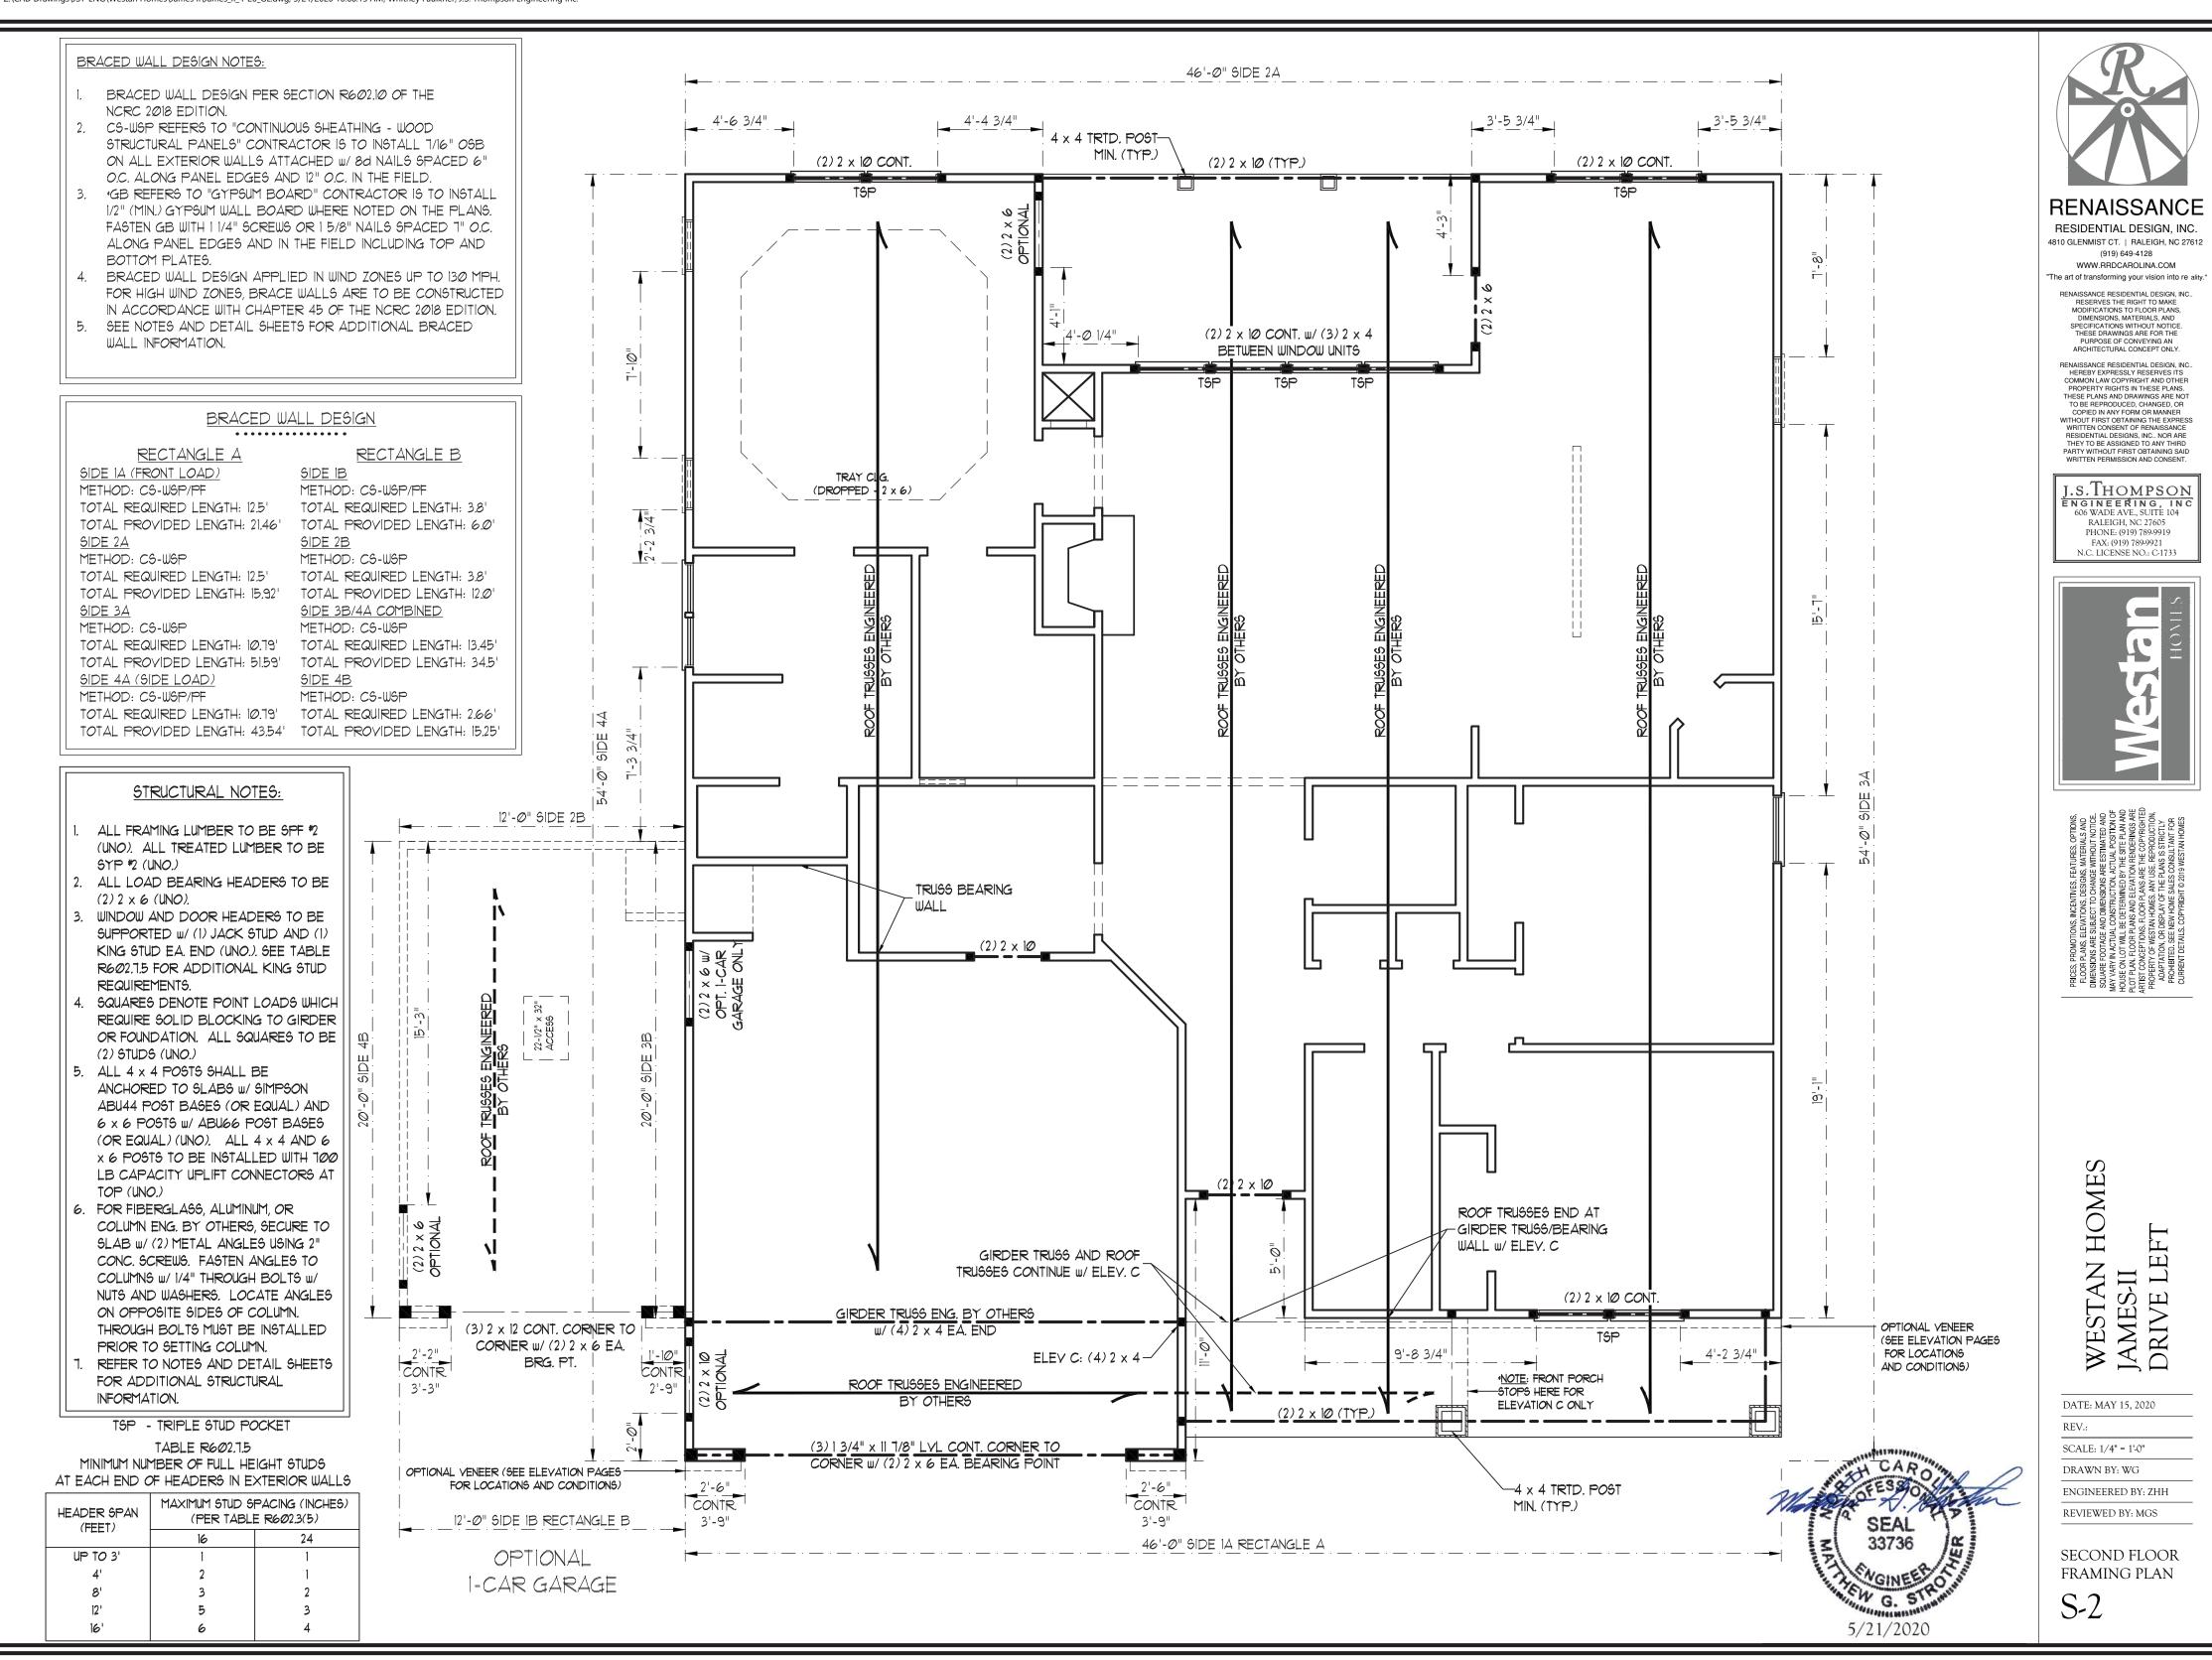

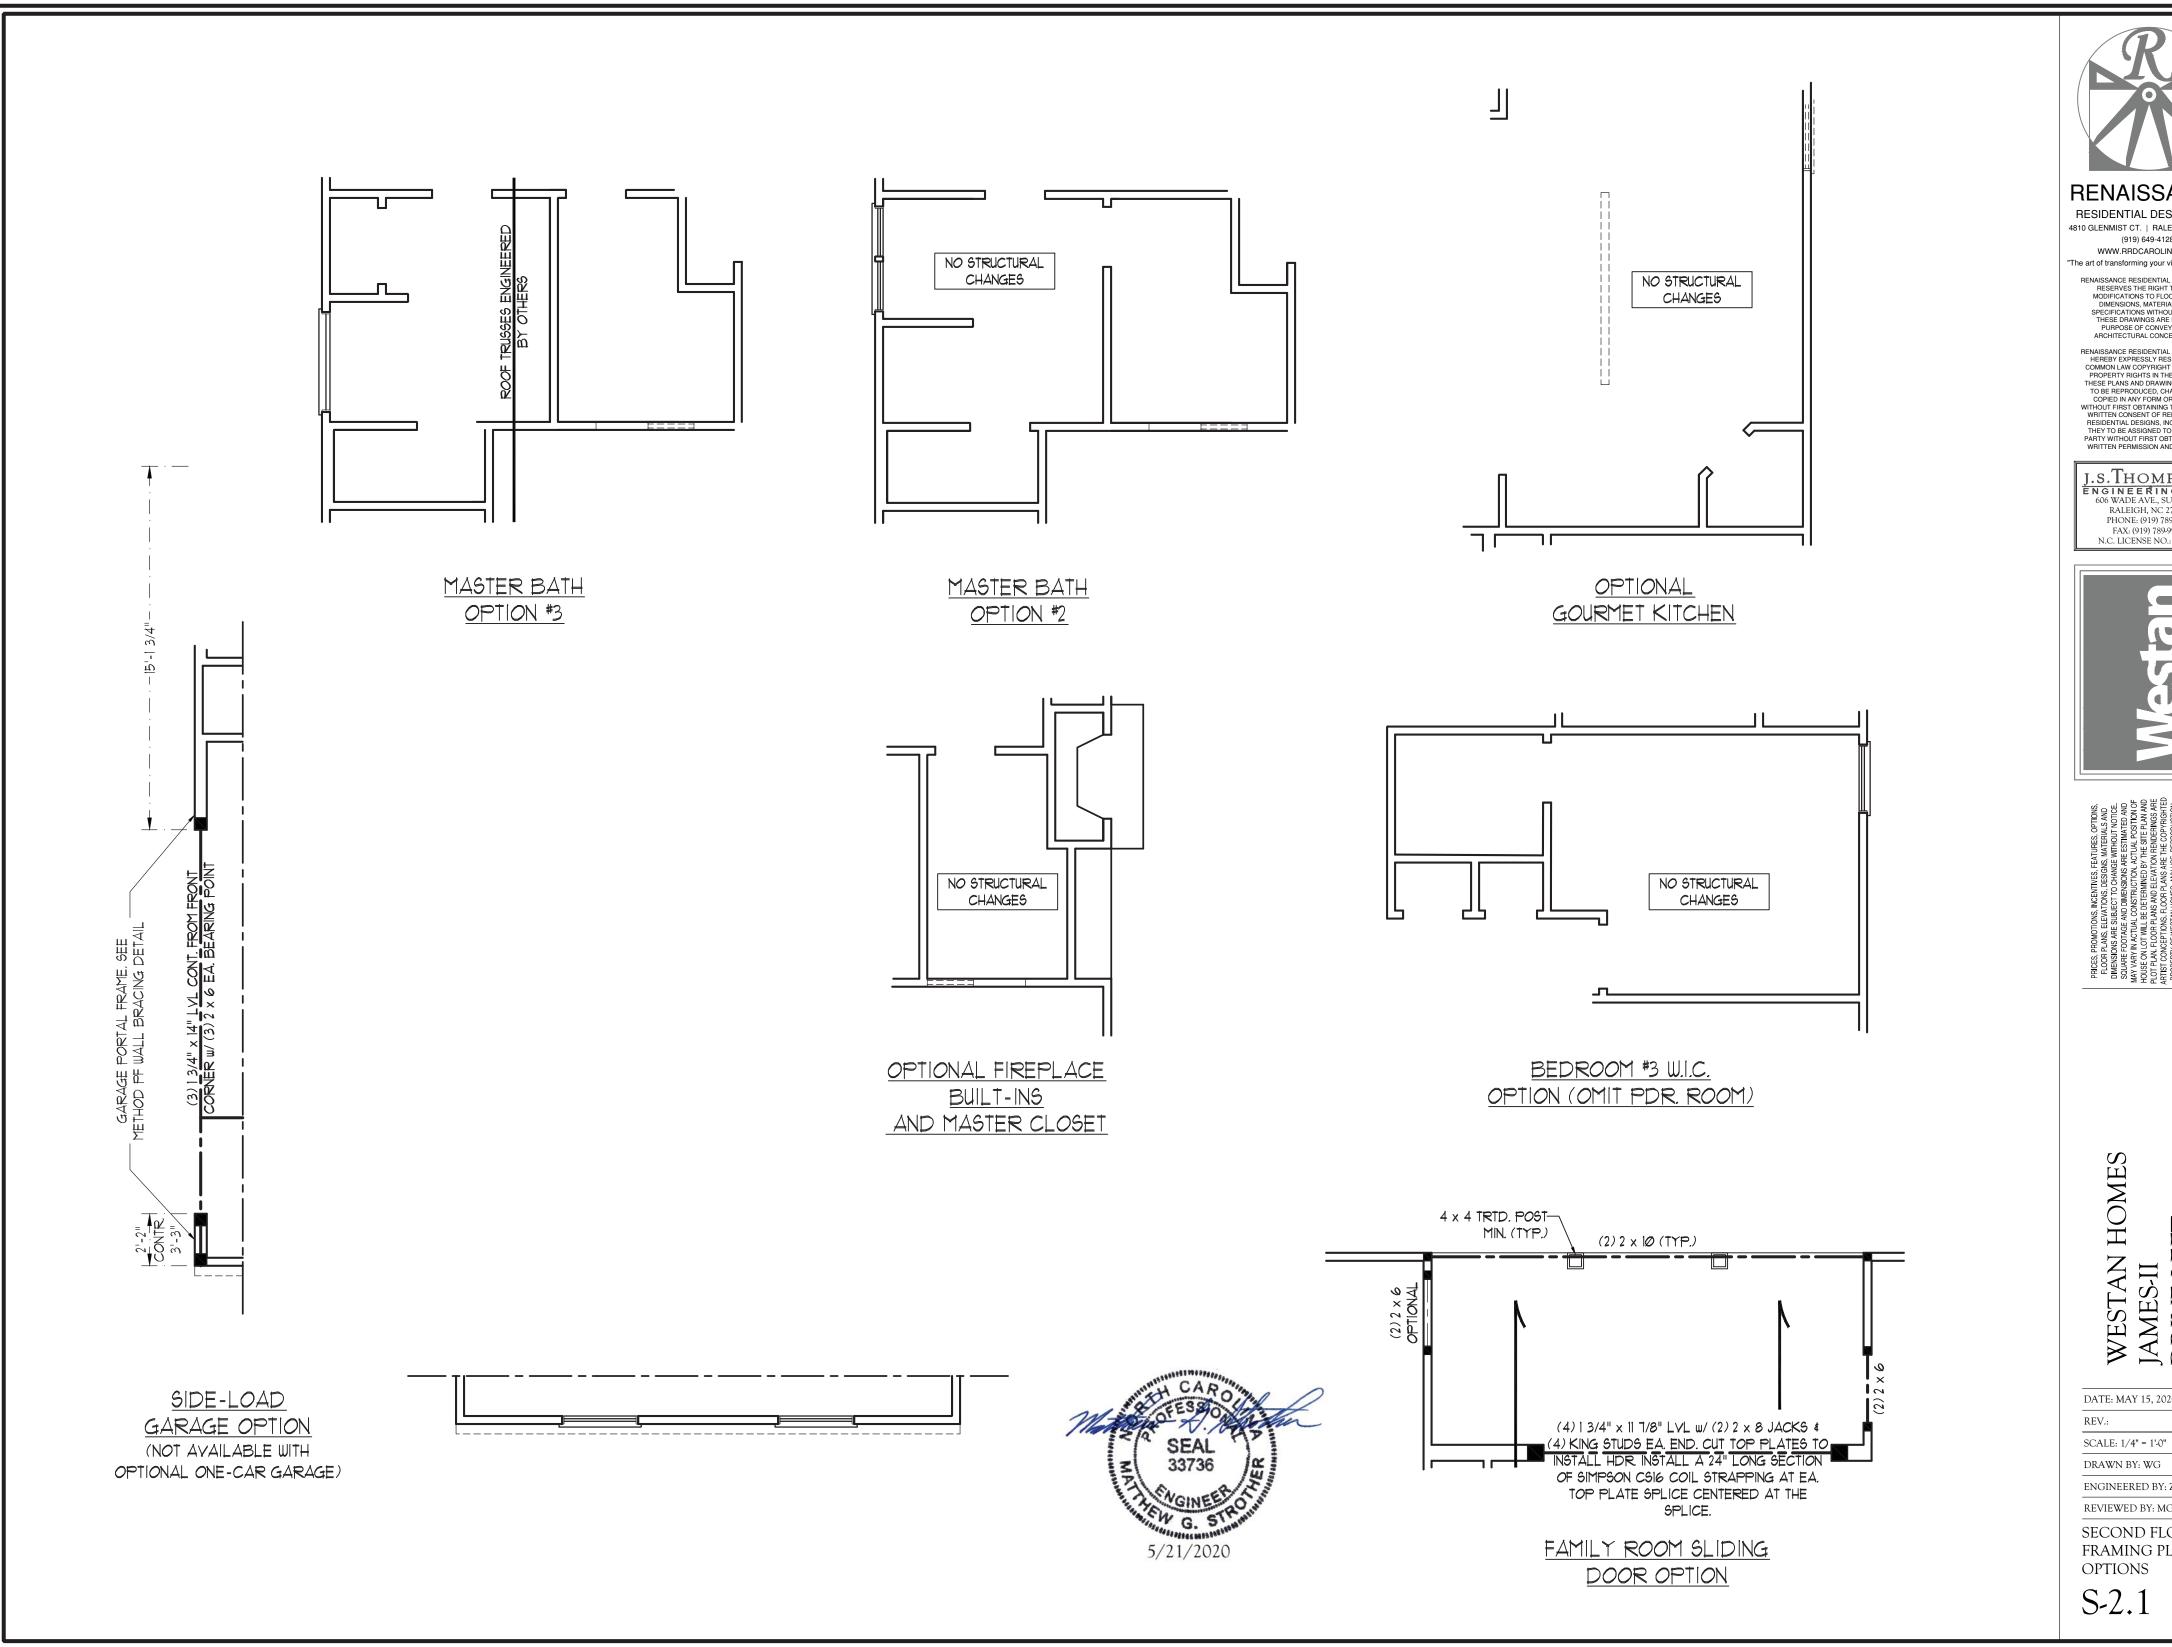



RESIDENTIAL DESIGN, INC. 4810 GLENMIST CT. | RALEIGH, NC 27612 (919) 649-4128

WWW.RRDCAROLINA.COM "The art of transforming your vision into re ality

RENAISSANCE RESIDENTIAL DESIGN, INC...
RESERVES THE RIGHT TO MAKE
MODIFICATIONS TO FLOOR PLANS,
DIMENSIONS, MATERIALS, AND
SPECIFICATIONS WITHOUT NOTICE.
THESE DRAWINGS ARE FOR THE
PURPOSE OF CONVEYING AN
ARCHITECTURAL CONCEPT ONLY.

RENAISSANCE RESIDENTIAL DESIGN, INC...
HEREBY EXPRESSLY RESERVES ITS
COMMON LAW COPYRIGHT AND OTHER
PROPERTY RIGHTS IN THESE PLANS.
THESE PLANS AND DRAWINGS ARE NOT
TO BE REPRODUCED, CHANGED, OR
COPIED IN ANY FORM OR MANNER
WITHOUT FIRST OBTAINING THE EXPRESS
WRITTEN CONSENT OF RENAISSANCE
RESIDENTIAL DESIGNS, INC.. NOR ARE
THEY TO BE ASSIGNED TO ANY THIRD
PARTY WITHOUT FIRST OBTAINING SAID
WRITTEN PERMISSION AND CONSENT.

J.S.THOMPSON ENGINEERING, INC 606 WADE AVE., SUITE 104 RALEIGH, NC 27605 PHONE: (919) 789-9919 FAX: (919) 789-9921 N.C. LICENSE NO.: C-1733



WESTAN HOMES JAMES-II

DATE: MAY 15, 2020

DRAWN BY: WG

ENGINEERED BY: ZHH

REVIEWED BY: MGS

SECOND FLOOR FRAMING PLAN **OPTIONS**

S-2.1

ATTIC VENT CALCULATION:

2688 SQ. FT. OF ATTIC DIVIDED BY 150 REQUIRES 17.9 SQ. FT. OF NET FREE VENTILATING AREA (MIN.).

STRUCTURAL NOTES:

- . ALL FRAMING LUMBER TO BE *2 SPF (UNO).
- 2. CIRCLES DENOTE (3) 2 x 4 POSTS FOR ROOF SUPPORT.
- 3. FRAME DORMER WALLS ON TOP
- OF DOUBLE OR TRIPLE RAFTERS.

 4. HIP SPLICES ARE TO BE SPACED
 A MIN. OF 8'-0". FASTEN
 MEMBERS WITH THREE ROWS OF
- 5. STICK FRAME OVER-FRAMED ROOF SECTIONS W/2 x 8 RIDGES, 2 x 6 RAFTERS @ 16" O.C. AND FLAT 2 x 10 VALLEYS OR USE VALLEY TRUSSES.


12d NAILS @ 16" O.C. (TYP.)

- 6. FASTEN FLAT VALLEYS TO RAFTERS OR TRUSSES WITH SIMPSON H2.5A HURRICANE TIES @ 32" O.C. MAX. PASS HURRICANE TIES THROUGH NOTCH IN ROOF SHEATHING. EACH RAFTER IS TO BE FASTENED TO THE FLAT VALLEY WITH A MIN. OF (6) 12d TOE NAILS.
- 1. REFER TO SECTION R802.11 OF THE 2018 NCRC FOR REQUIRED UPLIFT RESISTANCE AT RAFTERS AND TRUSSES.
- 8. REFER TO NOTES AND DETAIL SHEETS FOR ADDITIONAL STRUCTURAL INFORMATION.

ATTIC VENT CALCULATION:

294 SQ. FT. OF ATTIC DIVIDED BY 150 REQUIRES 2.0 SQ. FT. OF NET FREE VENTILATING AREA (MIN.).



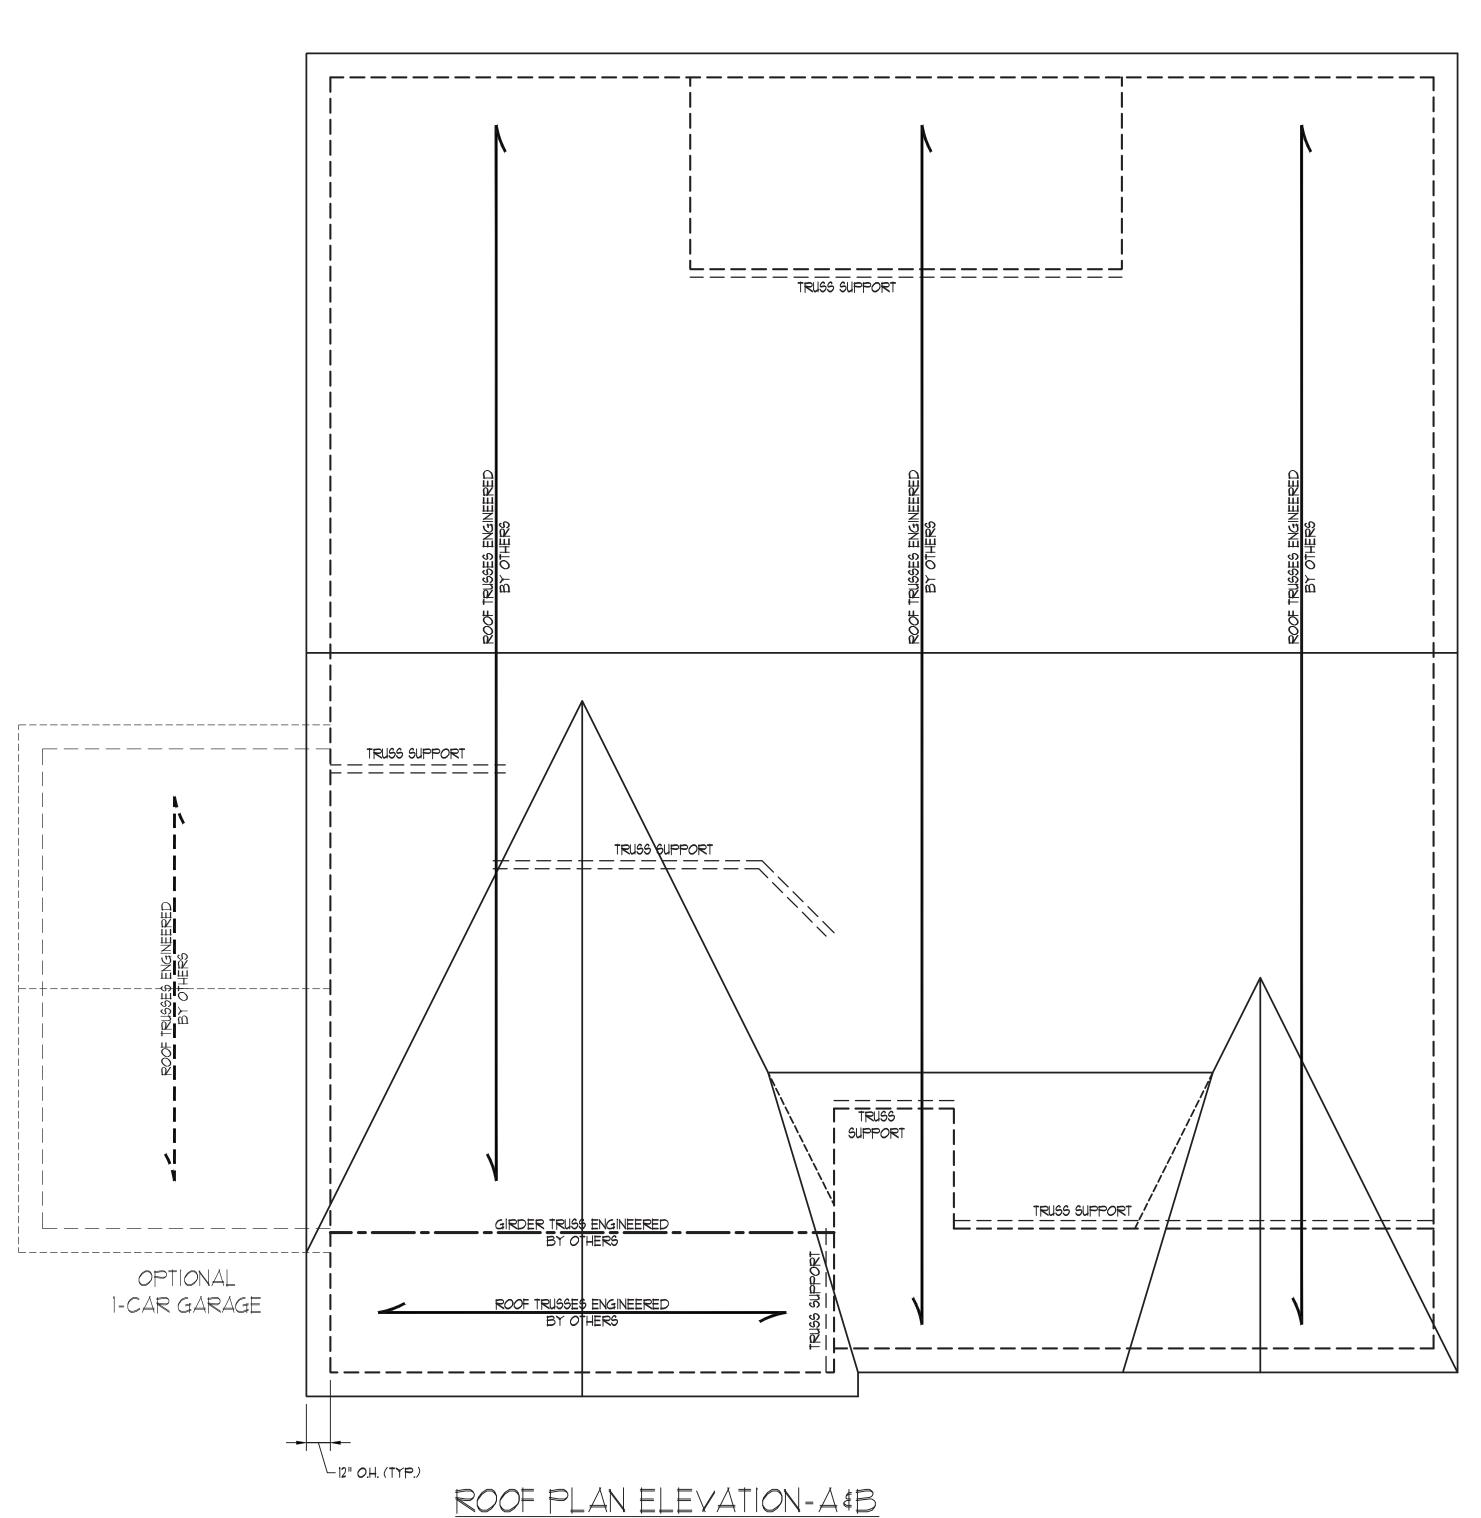



RENAISSANC

RESIDENTIAL DESIGN, INC. 4810 GLENMIST CT. | RALEIGH, NC 27612 (919) 649-4128

WWW.RRDCAROLINA.COM
"The art of transforming your vision into re ality

RENAISSANCE RESIDENTIAL DESIGN, INC...
RESERVES THE RIGHT TO MAKE
MODIFICATIONS TO FLOOR PLANS,
DIMENSIONS, MATERIALS, AND
SPECIFICATIONS WITHOUT NOTICE.
THESE DRAWINGS ARE FOR THE
PURPOSE OF CONVEYING AN
ARCHITECTURAL CONCEPT ONLY.

RENAISSANCE RESIDENTIAL DESIGN, INC...
HEREBY EXPRESSLY RESERVES ITS
COMMON LAW COPYRIGHT AND OTHER
PROPERTY RIGHTS IN THESE PLANS.
THESE PLANS AND DRAWNIGS ARE NOT
TO BE REPRODUCED, CHANGED, OR
COPIED IN ANY FORM OR MANNER
WITHOUT FIRST OBTAINING THE EXPRESS
WRITTEN CONSENT OF RENAISSANCE
RESIDENTIAL DESIGNS, INC.. NOR ARE
THEY TO BE ASSIGNED TO ANY THIRD
PARTY WITHOUT FIRST OBTAINING SAID
WRITTEN PERMISSION AND CONSENT.

J.S.THOMPSON ENGINEERING, INC 606 WADE AVE., SUITE 104 RALEIGH, NC 27605 PHONE: (919) 789-9919 FAX: (919) 789-9921 N.C. LICENSE NO.: C1733



PRICES, PROMOTIONS, INCENTIVES, FEATURES, OPTIONS, FLOOR PLANS, ELEVATIONS, DESIGNS, MATERIALS AND MICHISONS ARE SUBLECT OCHANGE WITHOUT NOTICE. SOUNGEFOOTAGE AND DIMENSIONS ARE ESTIMATED AND AY VARY IN ACTUAL CONSTRUCTION. ACTUAL POSITION OF OUSE ON LOT WILL BE DETERMINED BY THE STIF PLAN AND COT PLAN. FLOOR PLANS AND ELEVATION REDURBINGS ARE THE COPYRIGHTED PROPERTY OF WESTAN HOMES. ANY USE, REPRODUCTION, ADAPTATIONS, COPYRIGHTED SEE NEW HOME SALES CONSULTANT FOR CLIRRENT DETAILS. COPYRIGHTED AND SALES DESIGNED AND SALES AND WESTAN HOMES.

WESTAN HOMES JAMES-II DRIVE LEFT

DATE: MAY 15, 2020

REV.:

SCALE: 1/4" = 1'-0"

DRAWN BY: WG

ENGINEERED BY: ZHH

REVIEWED BY: MGS

ROOF PLAN ELEVATIONS A&B

S-3

ATTIC VENT CALCULATION:

2688 SQ. FT. OF ATTIC DIVIDED BY 150 REQUIRES 17.9 SQ. FT. OF NET FREE VENTILATING AREA (MIN.).

STRUCTURAL NOTES:

- ALL FRAMING LUMBER TO BE *2 SPF (UNO).
- 2. CIRCLES DENOTE (3) 2 x 4 POSTS
- FOR ROOF SUPPORT.

 3. FRAME DORMER WALLS ON TOP
- OF DOUBLE OR TRIPLE RAFTERS.


 4. HIP SPLICES ARE TO BE SPACED
 A MIN. OF 8'-O". FASTEN
 MEMBERS WITH THREE ROWS OF
- 5. STICK FRAME OVER-FRAMED ROOF SECTIONS W/2 x 8 RIDGES, 2 x 6 RAFTERS @ 16" O.C. AND FLAT 2 x 10 VALLEYS OR USE VALLEY TRUSSES.

12d NAILS @ 16" O.C. (TYP.)

- 6. FASTEN FLAT VALLEYS TO RAFTERS OR TRUSSES WITH SIMPSON H2.5A HURRICANE TIES @ 32" O.C. MAX. PASS HURRICANE TIES THROUGH NOTCH IN ROOF SHEATHING. EACH RAFTER IS TO BE FASTENED TO THE FLAT VALLEY WITH A MIN. OF (6) 12d TOE NAILS.
- 1. REFER TO SECTION R802.II OF THE 2018 NCRC FOR REQUIRED UPLIFT RESISTANCE AT RAFTERS AND TRUSSES.
- 8. REFER TO NOTES AND DETAIL SHEETS FOR ADDITIONAL STRUCTURAL INFORMATION.

ATTIC VENT CALCULATION:

294 SQ. FT. OF ATTIC DIVIDED BY 150 REQUIRES 2.0 SQ. FT. OF NET FREE VENTILATING AREA (MIN.).

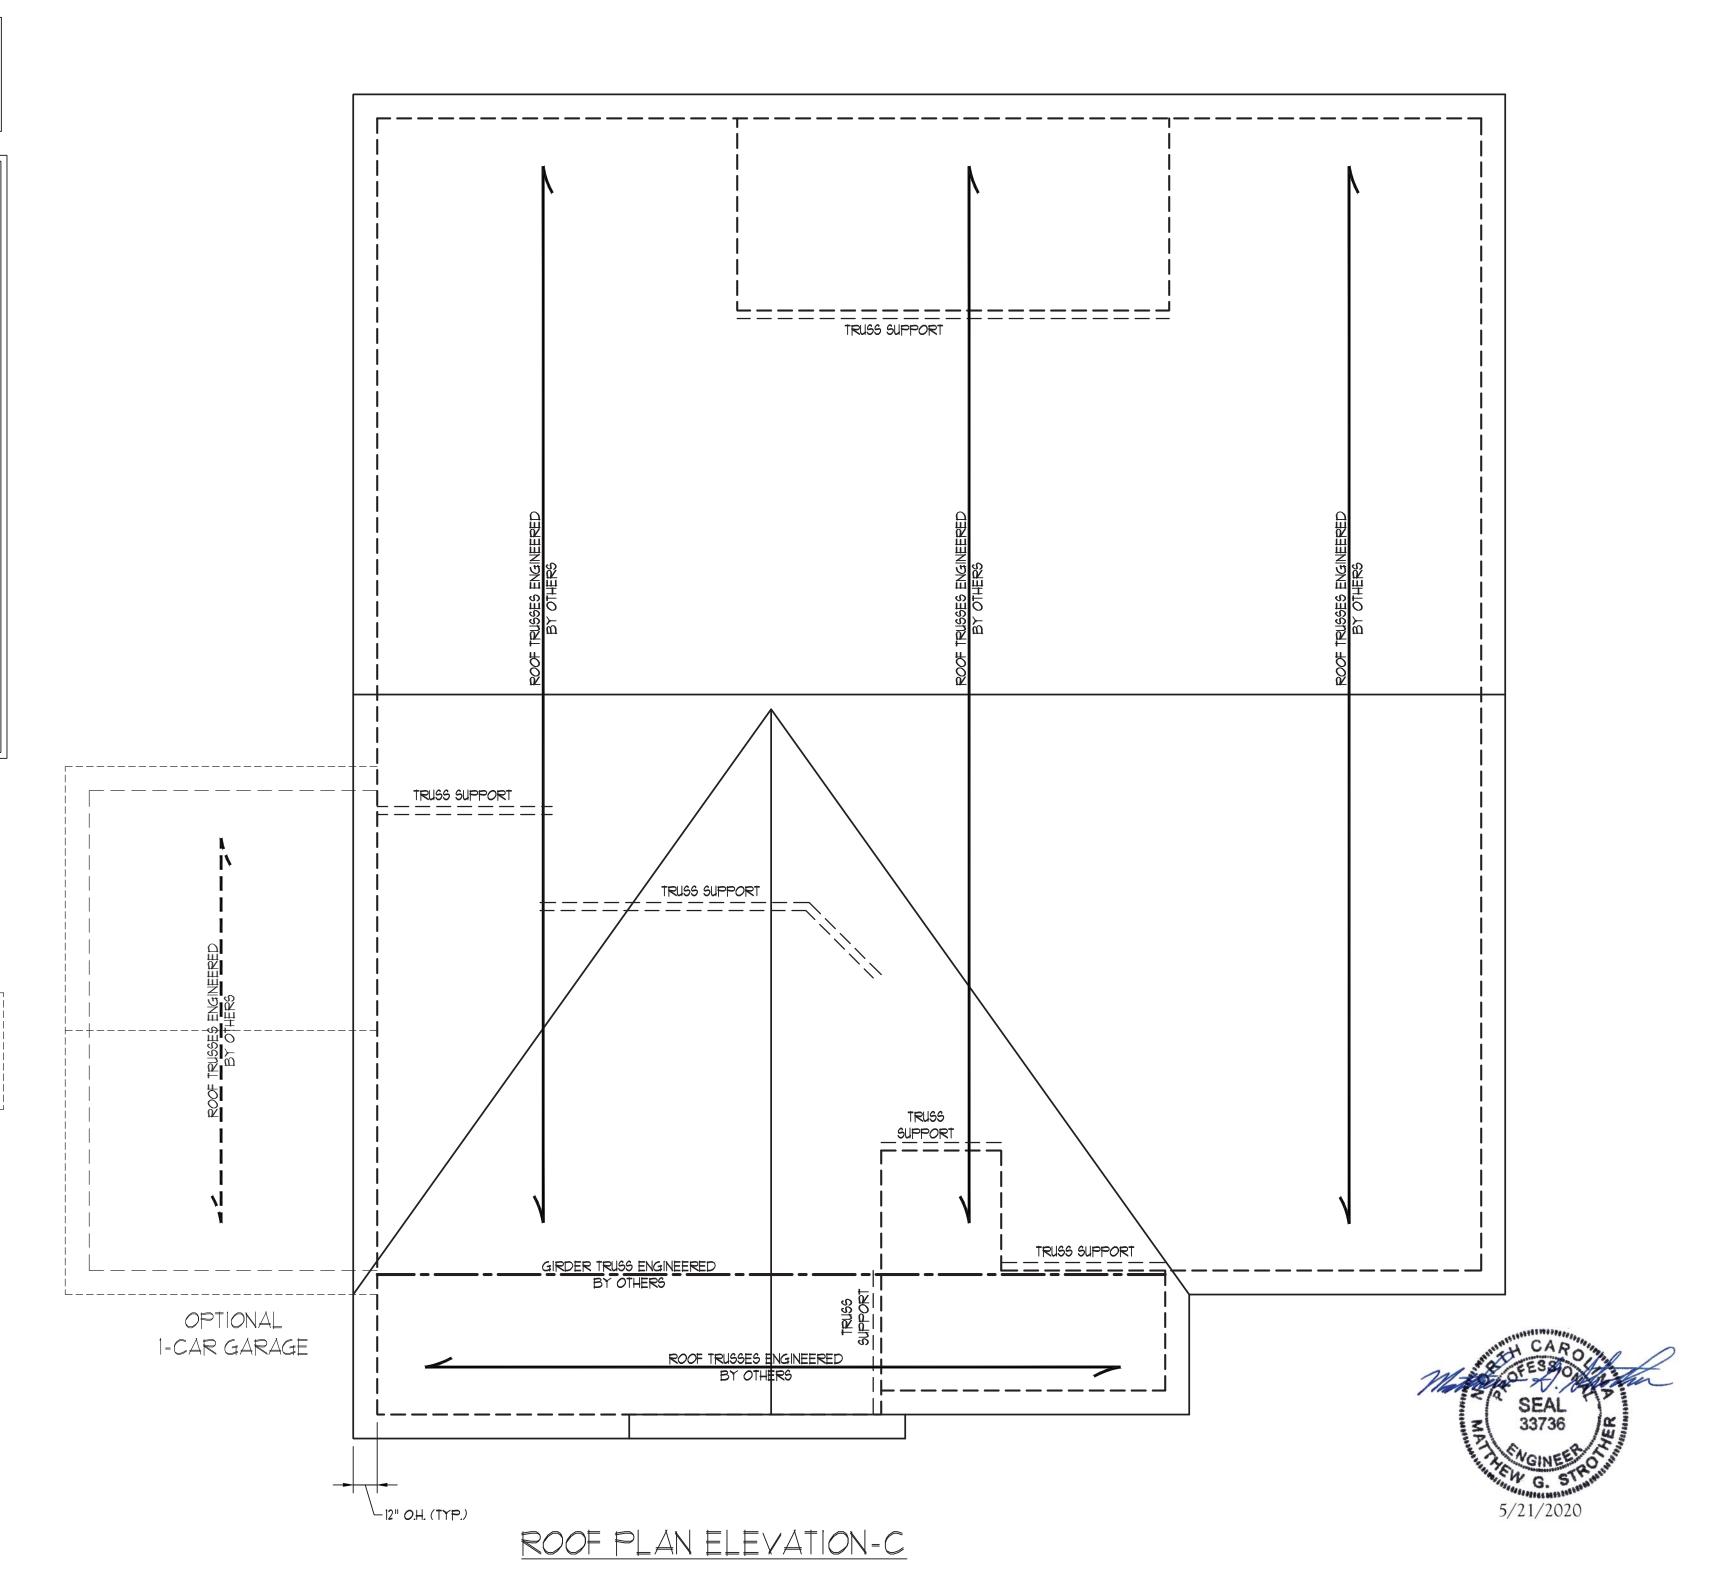



RENAISSANC

RESIDENTIAL DESIGN, INC. 4810 GLENMIST CT. | RALEIGH, NC 27612 (919) 649-4128

WWW.RRDCAROLINA.COM
"The art of transforming your vision into re ality

RENAISSANCE RESIDENTIAL DESIGN, INC...
RESERVES THE RIGHT TO MAKE
MODIFICATIONS TO FLOOR PLANS,
DIMENSIONS, MATERIALS, AND
SPECIFICATIONS WITHOUT NOTICE.
THESE DRAWINGS ARE FOR THE
PURPOSE OF CONVEYING AN
ARCHITECTURAL CONCEPT ONLY.

RENAISSANCE RESIDENTIAL DESIGN, INC...
HEREBY EXPRESSLY RESERVES ITS
COMMON LAW COPYRIGHT AND OTHER
PROPERTY RIGHTS IN THESE PLANS.
THESE PLANS AND DRAWNIGS ARE NOT
TO BE REPRODUCED, CHANGED, OR
COPIED IN ANY FORM OR MANNER
WITHOUT FIRST OBTAINING THE EXPRESS
WRITTEN CONSENT OF RENAISSANCE
RESIDENTIAL DESIGNS, INC.. NOR ARE
THEY TO BE ASSIGNED TO ANY THIRD
PARTY WITHOUT FIRST OBTAINING SAID
WRITTEN PERMISSION AND CONSENT.

J.S.THOMPSON ENGINEERING, INC 606 WADE AVE., SUITE 104 RALEIGH, NC 27605 PHONE: (919) 789-9919 FAX: (919) 789-9921 N.C. LICENSE NO.: C1733



PRICES, PROMOTIONS, INCENTIVES, FEATURES, OPTIONS, PLOOR PLANS, ELEVATIONS, DESIGNS, MATERIALS AND DIMENSIONS ARE SUBBECT TO CHANGE WITHOUT NOTICE.

ON THE FOOTAGE AND DIMENSIONS ARE ESTIMATED AND ANY VARY IN ACTUAL CONSTRUCTION, ACTUAL POSITION OF OUSE ON LOT WILL BE DETERMINED BY THE STIF PLAN AND COT PLAN. FLOOR PLANS AND ELEVATION RENDERINGS ARE THIST CONCEPTIONS. FLOOR PLANS ARE THE COPYRIGHTED PROPERTY OF WESTAN HOMES. ANY USE, REPRODUCTION, ADAPTATION, OR DISPLAY OF THE PLANS IS STRICTLY ADAPTATION, OR DISPLAY OF THE PLANS IS STRICTLY PROPINITED. SEE NEW HOME SALES CONSULTANT FOR CURRENT DETAILS. COPYRIGHTED 2019 WESTAN HOMES.

WESTAN HOME JAMES-II DRIVE LEFT

DATE: MAY 15, 2020

REV.:


SCALE: 1/4" = 1'-0"

DRAWN BY: WG

ENGINEERED BY: ZHH
REVIEWED BY: MGS

ROOF PLAN ELEVATION - C

S-3

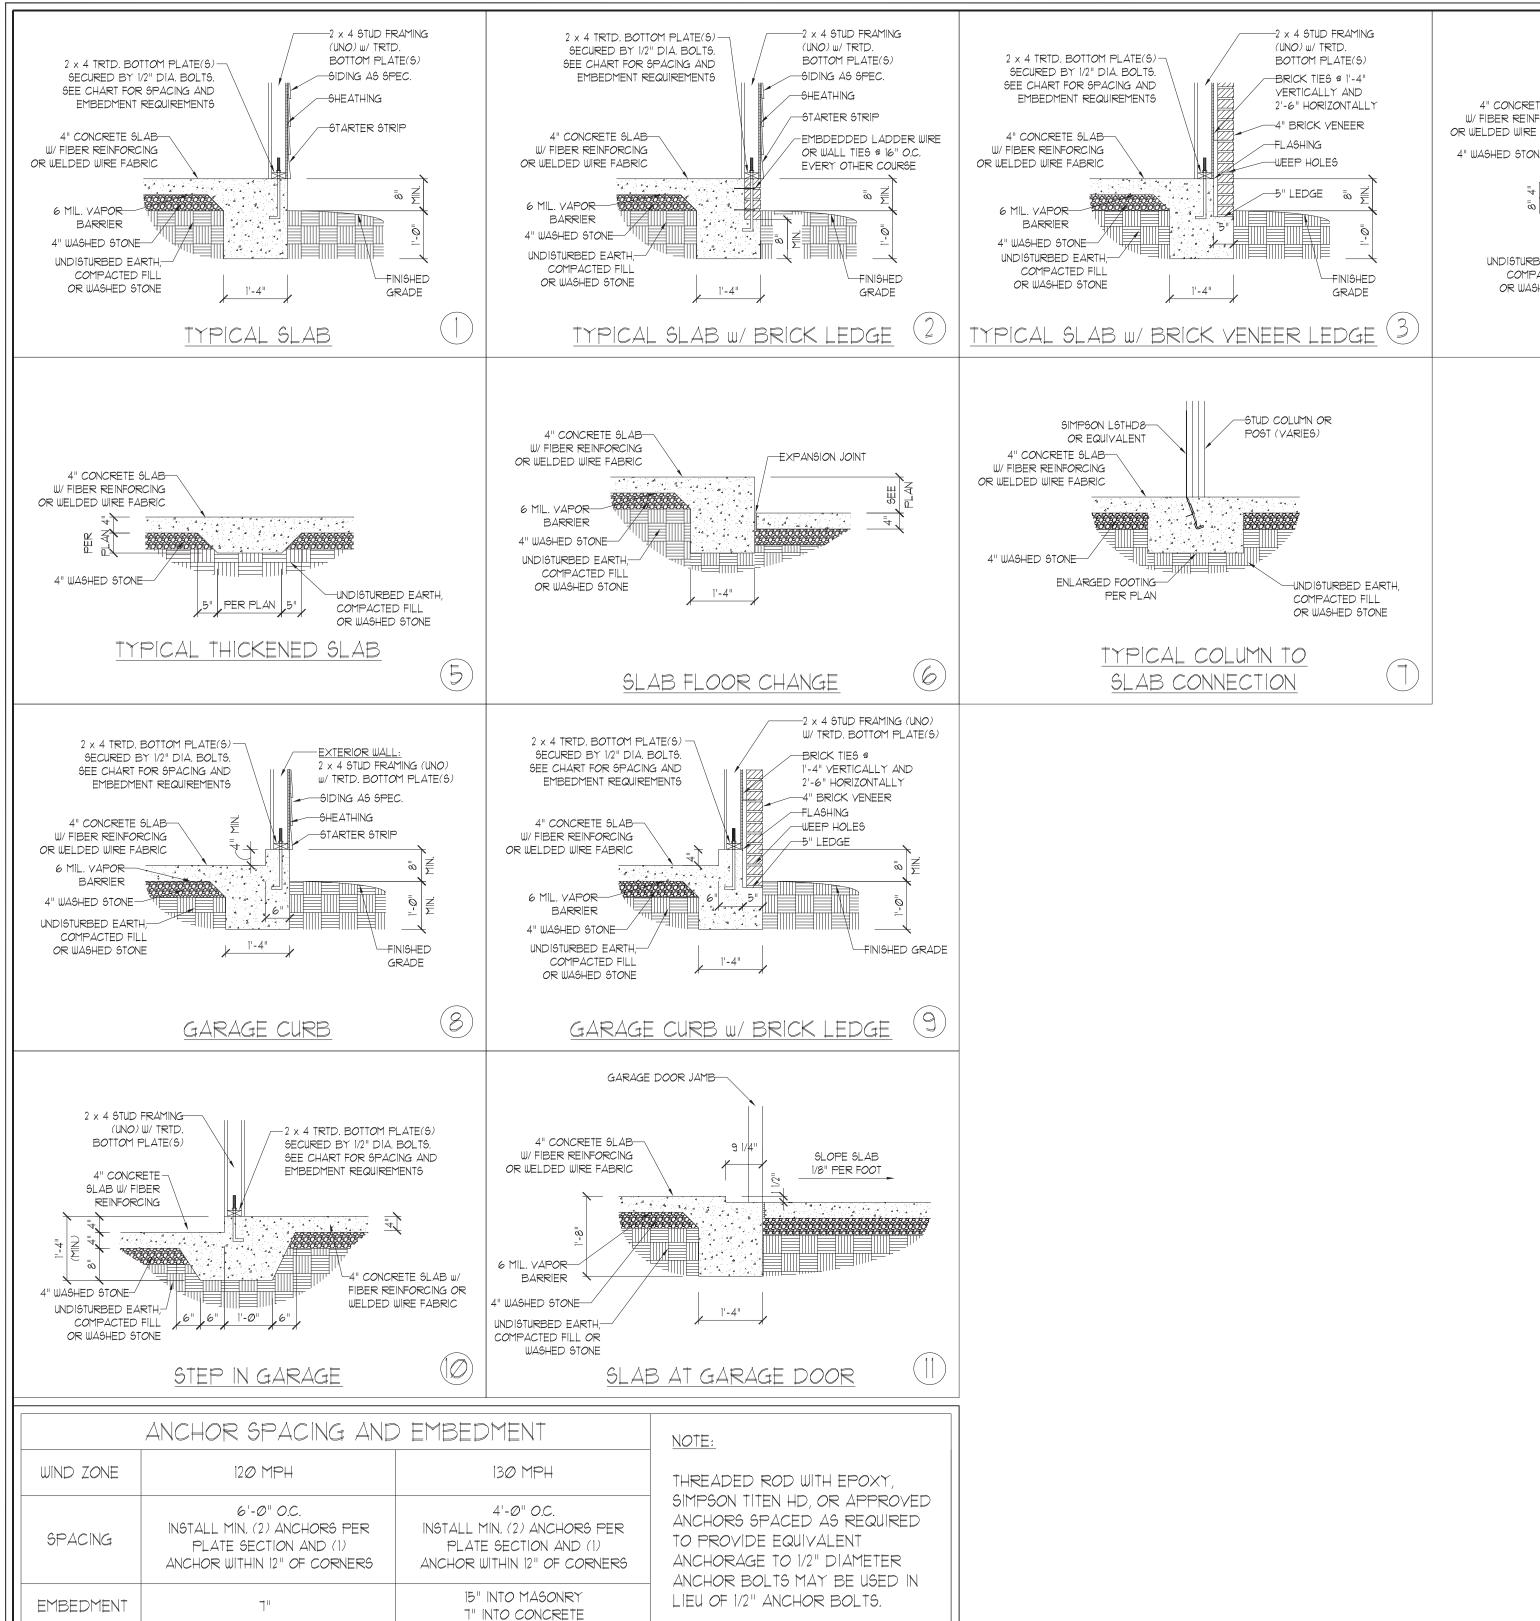

4" CONCRETE SLAB
W/ FIBER REINFORCING
OR WELDED WIRE FABRIC
4" WASHED STONE

UNDISTURBED EARTH
COMPACTED FILL
OR WASHED STONE

PORCH/SCREEN PORCH

TREATED POST
PER PLAN
POST BASE PER PLAN
FINISHED GRADE

1'-4"

PORCH/SCREEN PORCH

4

SOUTH OMESON
606 WADE AVE., SUITE 104 RALEIGH, NC 27605
PHONE: (919) 789-9919 FAX: (919) 789-9921
N.C. LICENSE NO.: C1733

MONOLITHIC SLAB FOUNDATION DETAILS



This sealed page is to be used in

conjunction with a full plan set

engineered by J.S. Thompson

Engineering, Inc. only. Use of this

individual sealed page within

architectural pages or shop drawings

by others is a punishable offense

under N.C. Statute § 89C-23

DATE: NOVEMBER 1, 2018

SCALE: NTS

DRAWN BY: JST

ENGINEERED BY: JST

FOUNDATION DETAILS

DATE: NOVEMBER 1, 2018

SCALE: NTS DRAWN BY: JST

ENGINEERED BY: JST

FOUNDATION **DETAILS**

2 AND UNGROUTED GROUT SOLID UNGROUTED UNGROUTED BELOW 3 UNGROUTED GROUT SOLID UNGROUTED UNGROUTED GROUT SOLID w/ #4 GROUT SOLID w/ #4 GROUT SOLID GROUT SOLID REBAR @ 48" O.C. REBAR @ 64" O.C. GROUT SOLID w/ #4 GROUT SOLID w/ #4 GROUT SOLID w/ #4 NOT APPLICABLE 5 REBAR @ 64" O.C. REBAR @ 36" O.C. REBAR @ 36" O.C. GROUT SOLID w/ #4 GROUT SOLID w/ #4 GROUT SOLID w/ #4 NOT APPLICABLE REBAR @ 24" O.C. REBAR @ 64" O.C. REBAR @ 24" O.C.

MASONRY STEMWALL SPECIFICATIONS

4" BRICK AND

4" CMU

MASONRY WALL TYPE

ENGINEERED DESIGN BASED ON SITE CONDITIONS

4" BRICK AND

8" CMU

12" CMU

STRUCTURAL NOTES:

1) WALL HEIGHT MEASURED FROM TOP OF FOOTING TO TOP OF THE WALL

8" CMU

- 2) TIE MULTIPLE WYTHES TOGETHER WITH LADDER WIRE AT 16" O.C. VERTICALLY.
- 3) CHART APPLICABLE FOR HOUSE FOUNDATION ONLY. CONSULT ENGINEER FOR DESIGN OF GARAGE FOUNDATION NOT COMMON TO HOUSE.
- 4) BACKFILL OF CLEAN #57 / #67 WASHED STONE IS ALLOWABLE.
- 5) BACKFILL OF WELL DRAINED OR SAND GRAYEL MIXTURE SOILS (45 PSF/FT BELOW GRADE) CLASSIFIED AS GROUP I ACCORDING TO UNIFIED SOILS CLASSIFICATION SYSTEM IN ACCORDANCE WITH TABLE R405.1 OF THE 2018 NORTH CAROLINA RESIDENTIAL CODE ARE ALLOWABLE.
- 6) PREP SLAB PER <u>R506.2.1</u> AND <u>R506.2.2</u> BASE AND <u>EXCEPTION</u> OF 2018 NORTH CAROLINA RESIDENTIAL CODE.
- 1) MINIMUM 24" LAP SPLICE LENGTH.


WALL HEIGHT

(FEET)

7 AND

GREATER

- 8) LOCATE REBAR IN CENTER OF FOUNDATION WALL.
- 9) WHERE REQUIRED, FILL BLOCK SOLID WITH TYPE "S" MORTAR OR 3000 PSI GROUT. USE OF "LOW LIFT GROUTING" METHOD REQUIRED WHEN FILLING WALLS WITH GROUT AT HEIGHTS OF 5' AND GREATER.

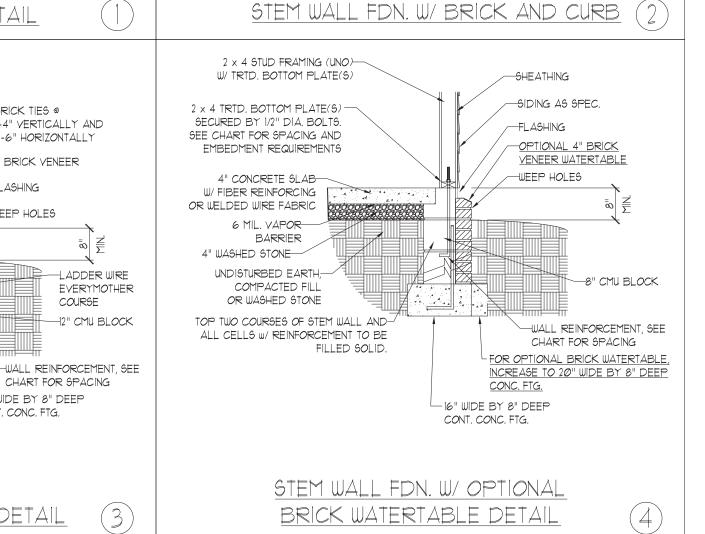

2 x 4 STUD FRAMING (UNO)

BRICK TIES @ 1'-4" VERTICALLY AND

2'-6" HORIZONTALLY

ADDER WIRE

EVERY OTHER

-12" CMU BLOCK

COURSE

-WALL REINFORCEMENT,

-20" WIDE BY 8" DEEP

CONT. CONC. FTG.

SEE CHART FOR SPACING

-4" BRICK VENEER

-FLASHING

WEEP HOLES

W/ TRTD. BOTTOM PLATE(S)

2 x 4 TRTD. BOTTOM PLATE(S)-

SECURED BY 1/2" DIA. BOLTS.

EMBEDMENT REQUIREMENTS

SEE CHART FOR SPACING AND

4" CONCRETE SLAB-W/ FIBER REINFORCING [

> 6 MIL. VAPOR-BARRIER

UNDISTURBED EARTH,

COMPACTED FILL

OR WASHED STONE

TOP TWO COURSES OF STEM WALL AND-

ALL CELLS W/ REINFORCEMENT TO BE

FILLED SOLID.

OR WELDED WIRE FABRIC

4" WASHED STONE-

_				
	ANCHOR SPACING AND EMBEDMENT			
	WIND ZONE	120 MPH	13Ø MPH	1
	SPACING	6'-0" O.C. INSTALL MIN. (2) ANCHORS PER PLATE SECTION AND (1) ANCHOR WITHIN 12" OF CORNERS	4'-0" O.C. INSTALL MIN. (2) ANCHORS PER PLATE SECTION AND (1) ANCHOR WITHIN 12" OF CORNERS	7
	EMBEDMENT	7"	15" INTO MASONRY 1" INTO CONCRETE	

2 x 4 STUD FRAMING (UNO)-W/ TRTD. BOTTOM PLATE(S)

-SIDING AS SPEC.

LADDER WIRE IN TOP TWO

-OPTIONAL BRICK VENEER

COURSES (W/ VENEER ONLY)

-FINISHED GRADE

LADDER WIRE

EVERY OTHER

—8" CMU BLOCK

COURSE

-WALL REINFORCEMENT, SEE

CHART FOR SPACING

H6" WIDE BY 8" DEEP

BRICK TIES @

1'-4" VERTICALLY AND

LADDER WIRE

(3)

COURSE

2'-6" HORIZONTALLY

4" BRICK VENEER

-FLASHING

WEEP HOLES

- 20" WIDE BY 8" DEEP CONT. CONC. FTG.

CONT. CONC. FTG.

STEM WALL FON. DETAIL

-SHEATHING

2 x 4 TRTD. BOTTOM PLATE(S)-

SECURED BY 1/2" DIA. BOLTS.

SEE CHART FOR SPACING AND

THICKENED SLAB

4" CONCRETE SLAB-

6 MIL. VAPOR-

UNDISTURBED EARTH,

COMPACTED FILL

OR WASHED STONE

TOP TWO COURSES OF STEM WALL AND-

ALL CELLS W/ REINFORCEMENT TO BE

2 x 4 STUD FRAMING (UNO)

W/ TRTD. BOTTOM PLATE(S)

2 x 4 TRTD. BOTTOM PLATE(S) -

SECURED BY 1/2" DIA. BOLTS.

SEE CHART FOR SPACING AND

4" CONCRETE SLAB

6 MIL. VAPOR-

UNDISTURBED EARTH,

BARRIER

COMPACTED FILL

TOP TWO COURSES OF STEM WALL AND-

ALL CELLS W/ REINFORCEMENT TO BE

FILLED SOLID.

STEM WALL FDN. W/ BRICK DETAIL

OR WASHED STONE

W/ FIBER REINFORCING

OR WELDED WIRE FABRIC

4" WASHED STONE

EMBEDMENT REQUIREMENTS

FILLED SOLID.

BARRIER

W/ FIBER REINFORCING

OR WELDED WIRE FABRIC

4" WASHED STONE-

NOT REQUIRED

EMBEDMENT REQUIREMENTS

NOTE:


THREADED ROD WITH EPOXY, SIMPSON TITEN HD, OR APPROVED ANCHORS SPACED AS REQUIRED TO PROVIDE EQUIVALENT ANCHORAGE TO 1/2" DIAMETER ANCHOR BOLTS MAY BE USED IN LIEU OF 1/2" ANCHOR BOLTS.


- X. 1873 SEAL 5/21/2020


> This sealed page is to be used in conjunction with a full plan set engineered by J.S. Thompson Engineering, Inc. only. Use of this individual sealed page within architectural pages or shop drawings by others is a punishable offense under N.C. Statute § 89C-23


GENERAL WALL BRACING NOTES:

- WALL BRACING DESIGNED IN ACCORDANCE WITH CHAPTER 6 OF THE 2018 NC RESIDENTIAL BUILDING CODE (NCRC). TABLES AND FIGURES REFERENCED ARE FROM THE 2018 NCRC.
- SEE THIS SHEET FOR GENERAL DETAILS. REFER TO THE 2018 NCRC FOR ADDITIONAL INFORMATION AS NEEDED . BRACED EXTERIOR WALLS SUPPORTING ROOF TRUSSES AND RAFTERS, INCLUDING STORIES BELOW THE TOP FLOOR, HAVE BEEN DESIGNED PER R60235 (3), WALL SHEATHING AND FASTENERS HAVE BEEN DESIGNED TO RESIST COMBINED UPLIFT AND SHEAR FORCES IN ACCORDANCE WITH ACCEPTED ENGINEERED PRACTICE.
- SEE STRUCTURAL SHEETS FOR BRACED WALL LOCATIONS, DIMENSIONS, HOLD DOWN TYPE AND LOCATIONS, BRACED WALL LINE KEY WITH WALL DESIGN SUMMARY OF REQUIRED/PROVIDED TOTALS FOR EACH WALL LINE AND ANY SPECIAL NOTES
- 5. ALL EXTERIOR WALLS ARE TO BE SHEATHED WITH CS-WSP IN ACCORDANCE WITH SECTION R602.103 UNLESS NOTED
- 6. ALL EXTERIOR AND INTERIOR WALLS TO HAVE 1/2" GYPSUM INSTALLED. WHEN NOT USING METHOD "GB", GYPSUM TO BE FASTENED PER TABLE R1023.5. METHOD GB TO BE FASTENED PER TABLE R602.10.1
- CS-USP REFERS TO THE "CONTINUOUS SHEATHING WOOD STRUCTURAL PANELS" WALL BRACING METHOD. 1/16" OSB SHEATHING IS TO BE INSTALLED ON ALL EXTERIOR WALLS ATTACHED W/ 6d COMMON NAILS OR 8d (2 1/2" LONG x Ø.113" DIAMETER) NAILS SPACED 6" O.C. ALONG PANEL EDGES AND 12" O.C. IN THE FIELD (UN.O.).
- GB REFERS TO THE "GYPSUM BOARD" WALL BRACING METHOD. 1/2" (MIN.) GYPSUM WALL BOARD 16 TO BE INSTALLED ON BOTH SIDES OF THE BRACED WALL FASTENED WITH 1 1/4" SCREWS OR 1 5/8" NAILS SPACED 1" O.C. ALONG PANEL EDGES INCLUDING TOP AND BOTTOM PLATES AND INTERMEDIATE SUPPORTS (UN.O.). VERIFY ALL FASTENER OPTIONS FOR 1/2" AND 5/8" GYP6UM PRIOR TO CONSTRUCTION. FOR INTERIOR FASTENER OPTIONS SEE TABLE R102.3.5. FOR EXTERIOR FASTENER OPTIONS SEE TABLE R6023(1). EXTERIOR GB TO BE INSTALLED VERTICALLY.
- REQUIRED BRACED WALL LENGTH FOR EACH SIDE OF THE CIRCUMSCRIBED RECTANGLE ARE INTERPOLATED PER TABLE R602. 10.3. METHOD C5-USP CONTRIBUTES ITS ACTUAL LENGTH, METHOD GB CONTRIBUTES .5 ITS ACTUAL LENGTH, AND METHOD PF CONTRIBUTES 1.5 TIMES ITS ACTUAL LENGTH.

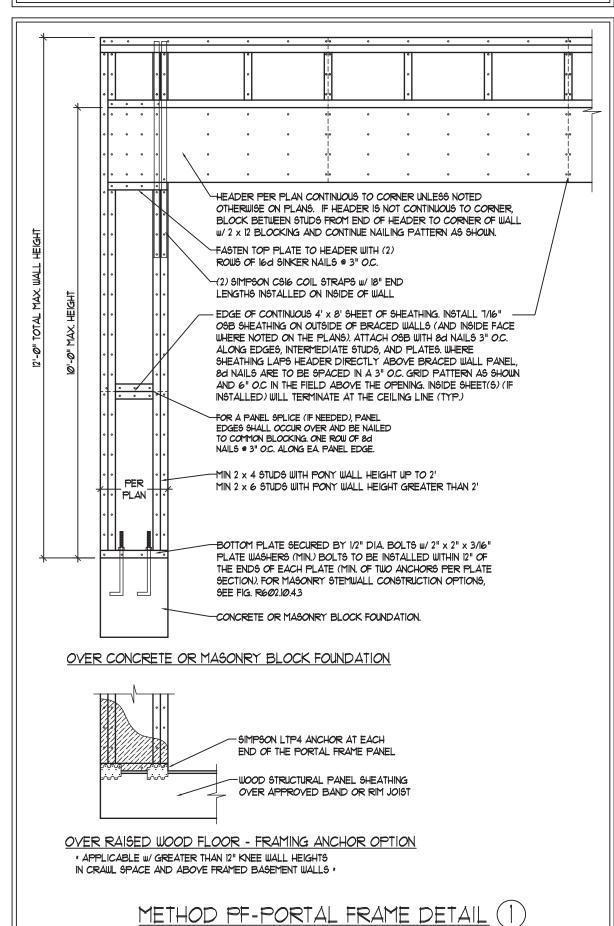


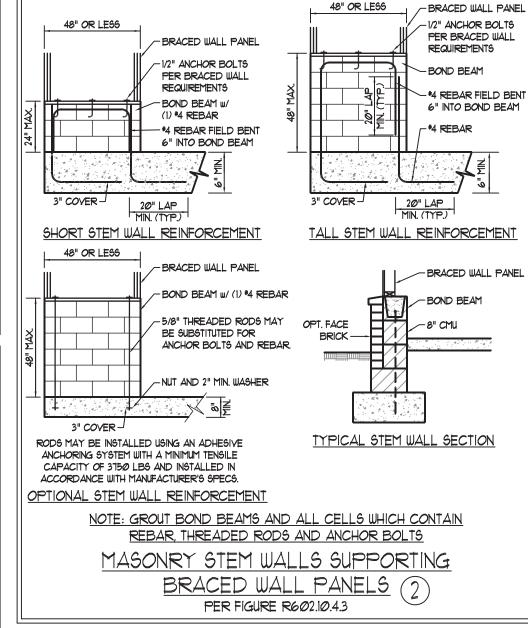


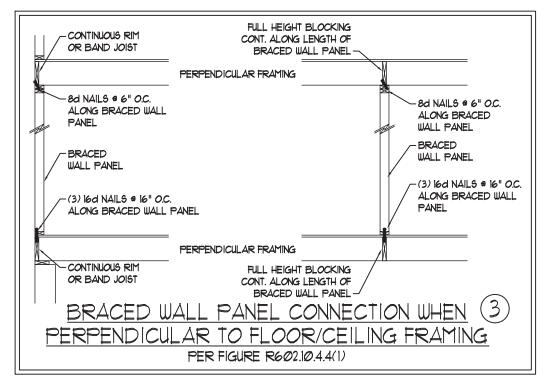


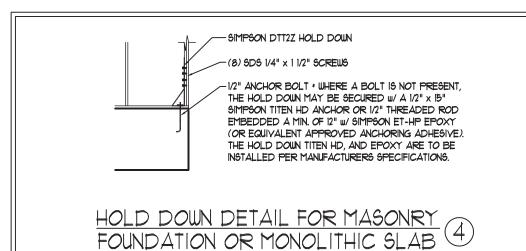


* APPLICABLE ONLY WHERE SPECIFIED ON PLAN *

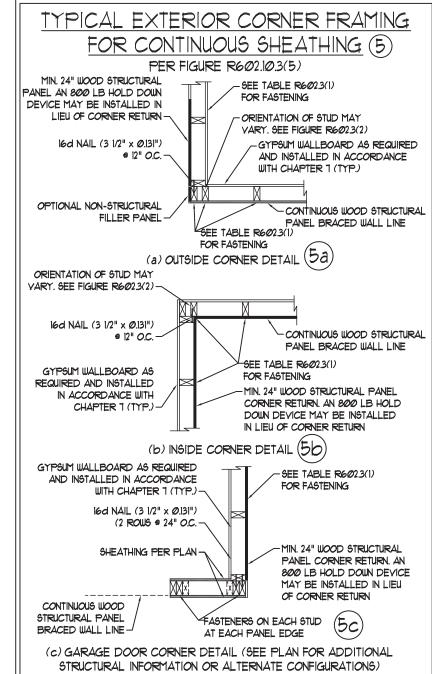

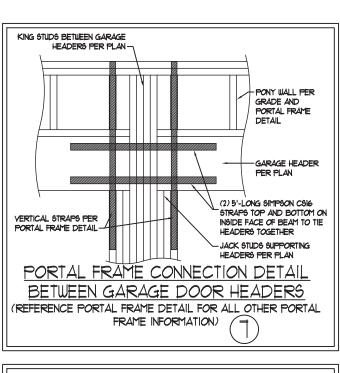

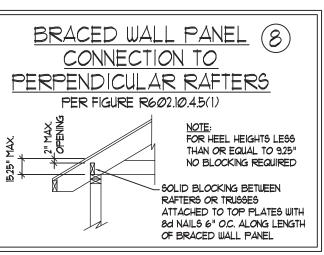

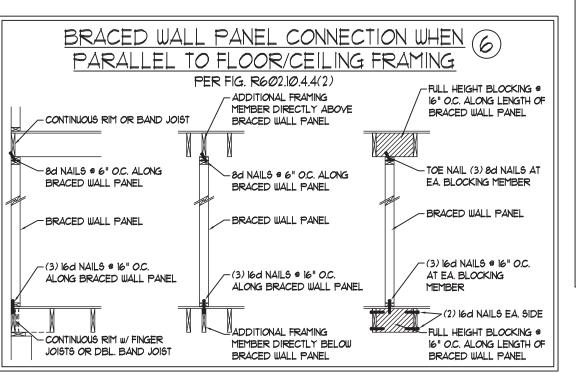


This sealed page is to be used in conjunction with a full

plan set engineered by J.S. Thompson Engineering, Inc.

only. Use of this individual sealed page within

architectural pages or shop drawings by others is a punishable offense under N.C. Statute § 89C-23

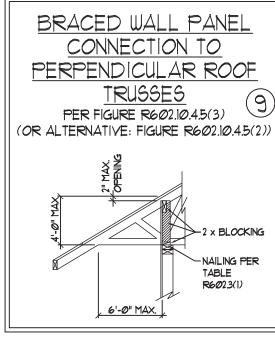

9 -2 x BLOCKING

5/21/2020

AND NOTES BRACING

DATE: MAY 18, 2020 SCALE: 1/4" = 1'-0"

DRAWN BY: IST ENGINEERED BY: JST

> BRACED WALL NOTES AND DETAILS AND PF DETAIL

GENERAL NOTES

- 1. ENGINEER'S SEAL APPLIES ONLY TO STRUCTURAL COMPONENTS INCLUDING ROOF RAFTERS, HIPS, VALLEYS, RIDGES, FLOORS, WALLS, BEAMS, HEADERS, COLUMNS, CANTILEVERS, OFFSET LOAD BEARING WALLS, PIERS, GIRDER SYSTEM AND FOOTING. ENGINEER'S SEAL DOES NOT CERTIFY DIMENSIONAL ACCURACY OF ARCHITECTURAL LAYOUT INCLUDING ROOF. ENGINEER'S SEAL DOES NOT APPLY TO 1-JOIST OR FLOOR/ROOF TRUSS LAYOUT DESIGN AND ACCURACY.
- 2. ALL CONSTRUCTION SHALL CONFORM TO THE LATEST REQUIREMENTS OF THE NORTH CAROLINA RESIDENTIAL CODE (NCRC), 2018 EDITION, PLUS ALL LOCAL CODES AND REGULATIONS. THE STRUCTURAL ENGINEER IS NOT RESPONSIBLE FOR, AND WILL NOT HAVE CONTROL OF, CONSTRUCTION MEANS, METHODS, TECHNIQUES, SEQUENCES OR PROCEDURES, OR SAFETY PRECAUTIONS AND PROGRAMS IN CONNECTION WITH THE CONSTRUCTION WORK. NOR WILL THE ENGINEER BE RESPONSIBLE FOR THE CONTRACTORS FAILURE TO CARRY OUT THE CONSTRUCTION WORK IN ACCORDANCE WITH THE CONTRACT DOCUMENTS.
- 3. STRUCTURAL DESIGN BASED ON THE PROVISIONS OF THE NCRC, 2018 EDITION (R301.4 R301.7)

DESIGN CRITERIA:	LIVE LOAD (PSF)	DEAD LOAD (PSF)	DEFLECTION (IN)
ATTIC WITH LIMITED STORAGE	2Ø	10	L/240 (L/360 w/ BRITTLE FINISHES)
ATTIC WITHOUT STORAGE	10	10	L/36Ø
DECKS	40	10	L/36Ø
EXTERIOR BALCONIES	40	10	L/360
FIRE ESCAPES	40	10	L/360
HANDRAILS/GUARDRAILS	200 LB OR 50 (PLF)	10	L/360
PASSENGER VEHICLE GARAGE	5Ø	10	L/360
ROOMS OTHER THAN SLEEPING ROOM	40	10	L/360
SLEEPING ROOMS	3Ø	10	L/360
STAIRS	40	10	L/360
WIND LOAD	(BASED ON TABLE R301.2(4) WIND ZONE AND EXPOSURE)		
GROUND SNOW LOAD: Pg	2Ø (PSF)		

- I-JOIST SYSTEMS DESIGNED WITH 12 PSF DEAD LOAD AND DEFLECTION (IN) OF L/480
- FLOOR TRUSS SYSTEMS DESIGNED WITH 15 PSF DEAD LOAD
- 4. FOR 115 AND 120 MPH WIND ZONES, FOUNDATION ANCHORAGE 15 TO COMPLY WITH SECTION R403.1.6 OF THE NCRC, 2018 EDITION. FOR 130 MPH, 140 MPH, AND 150 MPH WIND ZONES, FOUNDATION ANCHORAGE 15 TO COMPLY WITH SECTION 4504 OF THE NCRC, 2018 EDITION.
- 5. ENERGY EFFICIENCY COMPLIANCE AND INSULATION VALUES OF THE BUILDING TO BE IN ACCORDANCE WITH CHAPTER II OF THE NCRC, 2018 EDITION.

FOOTING AND FOUNDATION NOTES

- I. FOUNDATION DESIGN BASED ON A MINIMUM ALLOWABLE BEARING CAPACITY OF 2000 PSF. CONTACT GEOTECHNICAL ENGINEER IF BEARING CAPACITY IS NOT ACHIEVED.
- 2. FOR ALL CONCRETE SLABS AND FOOTINGS, THE AREA WITHIN THE PERIMETER OF THE BUILDING ENVELOPE SHALL HAVE ALL VEGETATION, TOP SOIL AND FOREIGN MATERIAL REMOVED. FILL MATERIAL SHALL BE FREE OF VEGETATION AND FOREIGN MATERIAL. THE FILL SHALL BE COMPACTED TO ASSURE UNIFORM SUPPORT OF THE SLAB, AND EXCEPT WHERE APPROVED, THE FILL DEPTHS SHALL NOT EXCEED 24" FOR CLEAN SAND OR GRAVEL. A 4" THICK BASED COURSE CONSISTING OF CLEAN GRADED SAND OR GRAVEL SHALL BE PLACED. A BASE COURSE IS NOT REQUIRED WHERE A CONCRETE SLAB IS INSTALLED ON WELL-DRAINED OR SAND-GRAVEL MIXTURE SOILS CLASSIFIED AS GROUP I, ACCORDING TO THE UNITED SOIL CLASSIFICATION SYSTEM IN ACCORDANCE WITH TABLE R405.1 OF THE NCRC, 2018 EDITION.
- 3. PROPERLY DEWATER EXCAVATION PRIOR TO POURING CONCRETE WHEN BOTTOM OF CONCRETE SLAB IS AT OR BELOW WATER TABLE. IF APPLICABLE, 3/4" 1" DEEP CONTROL JOINTS ARE TO BE SAWED WITHIN 4 TO 12 HOURS OF CONCRETE FINISHING AND WALL LOCATIONS HAVE BEEN MARKED. ADJUST WHERE NECESSARY.
- 4. CONCRETE SHALL CONFORM TO SECTION R402.2 OF THE NCRC, 2018 EDITION. CONCRETE REINFORCING STEEL TO BE ASTM A615 GRADE 60. WELDED WIRE FABRIC TO BE ASTM A185. MAINTAIN A MINIMUM CONCRETE COVER AROUND REINFORCING STEEL OF 3" IN FOOTINGS AND 1 1/2" IN SLABS. FOR POURED CONCRETE WALLS, CONCRETE COVER FOR REINFORCING STEEL MEASURED FROM THE INSIDE FACE OF THE WALL SHALL NOT BE LESS THAN 3/4". CONCRETE COVER FOR REINFORCING STEEL MEASURED FROM THE OUTSIDE FACE OF THE WALL SHALL NOT BE LESS THAN 1 1/2" FOR #5 BARS OR SMALLER, AND NOT LESS THAN 2" FOR #6 BARS OR LARGER.
- 5. MASONRY UNITS TO CONFORM TO ACE 530/ASCE 5/TMS 402. MORTAR SHALL COMFORM TO ASTM C270.
- 6. THE UNSUPPORTED HEIGHT OF MASONRY PIERS SHALL NOT EXCEED FOUR TIMES THEIR LEAST DIMENSION FOR UNFILLED HOLLOW CONCRETE MASONRY UNITS AND TEN TIMES THEIR LEAST DIMENSION FOR SOLID OR SOLID FILLED PIERS. PERS MAY BE FILLED SOLID WITH CONCRETE OR TYPE M OR S MORTAR PIERS AND WALLS SHALL BE CAPPED WITH 8" OF SOLID MASONRY.
- 1. THE CENTER OF EACH OF THE PIERS SHALL BEAR IN THE MIDDLE THIRD OF ITS RESPECTIVE FOOTING. EACH GIRDER SHALL BEAR IN THE MIDDLE THIRD OF THE PIERS.
- 8. ALL CONCRETE AND MASONRY FOUNDATION WALLS ARE TO BE CONSTRUCTED IN ACCORDANCE WITH THE PROVISIONS OF SECTION R404 OF THE NCRC, 2018 EDITION OR IN ACCORDANCE WITH ACI 318, ACI 332, NCMA TR68-A OR ACE 530/ASCE 5/TMS 402. MASONRY FOUNDATION WALLS ARE TO BE REINFORCED PER TABLE R404.I.(1), R404.I.(2), R404.I.(3), OR R404.I.(4) OF THE NCRC, 2018 EDITION. CONCRETE FOUNDATION WALLS ARE TO BE REINFORCED PER TABLE R404.I.(5) OF THE NCRC, 2018 EDITION. STEP CONCRETE FOUNDATION WALLS TO 2 x 6 FRAMED WALLS AT 16" O.C. WHERE GRADE PERMITS (UNO).



This sealed page is to be used in conjunction with a full plan set engineered by J.S. Thompson Engineering, Inc. only. Use of this individual sealed page within architectural pages or shop drawings by others is a punishable offense under N.C. Statute § 89C-23

FRAMING NOTES

- 1. ALL FRAMING LUMBER SHALL BE *2 SPF MINIMUM (Fb = 875 PSI, Fv = 375 PSI, E = 1600000 PSI) UNLESS NOTED OTHERWISE (UNO). ALL TREATED LUMBER SHALL BE *2 SYP MINIMUM (Fb = 975 PSI, Fv = 175 PSI, E = 1600000 PSI) UNLESS NOTED OTHERWISE (UNO).
- 2. LAMINATED VENEER LUMBER (LVL) SHALL HAVE THE FOLLOWING MINIMUM PROPERTIES: Fb = 2600 PSI, Fv = 285 PSI, E = 1900000 PSI.

 LAMINATED STRAND LUMBER (LSL) SHALL HAVE THE FOLLOWING MINIMUM PROPERTIES: Fb = 2325 PSI, Fv = 310 PSI, E = 1550000 PSI.

 PARALLEL STRAND LUMBER (PSL) UP TO T" DEPTH SHALL HAVE THE FOLLOWING MINIMUM PROPERTIES: Fc = 2500 PSI, E = 18000000 PSI.

 PARALLEL STRAND LUMBER (PSL) MORE THAN T" DEPTH SHALL HAVE THE FOLLOWING MINIMUM PROPERTIES: Fc = 2900 PSI, E = 20000000 PSI. INSTALL ALL CONNECTIONS PER MANUFACTURER'S SPECIFICATIONS.
- 3. STRUCTURAL STEEL SHALL CONFORM TO THE FOLLOWING ASTM SPECIFICATIONS

A. W AND WT SHAPES: ASTM A992
B. CHANNELS AND ANGLES: ASTM A36
C. PLATES AND BARS: ASTM A36

D. HOLLOW STRUCTURAL SECTIONS: ASTM A500 GRADE B

STEEL PIPE: ASTM A53, GRADE B, TYPE E OR S

4. STEEL BEAMS SHALL BE SUPPORTED AT EACH END WITH A MINIMUM BEARING, LENGTH OF 3 1/2" AND FULL FLANGE WIDTH (UNO). PROVIDE SOLID BEARING FROM BEAM SUPPORT TO FOUNDATION. BEAMS SHALL BE ATTACHED AT THE BOTTOM FLANGE TO EACH SUPPORT AS FOLLOWS (UNO):

A. WOOD FRAMING (2) 1/2" DIA. x 4" LONG LAG SCREWS
B. CONCRETE (2) 1/2" DIA. x 4" WEDGE ANCHORS

C. MASONRY (FULLY GROUTED) (2) 1/2" DIA. x 4" LONG SIMPSON TITEN HD ANCHORS

LATERAL SUPPORT IS CONSIDERED ADEQUATE PROVIDING THE JOISTS ARE TOE NAILED TO THE 2x NAILER ON TOP OF THE STEEL BEAM, AND THE 2x NAILER IS SECURED TO THE TOP OF THE STEEL BEAM w/ (2) ROWS OF SELF TAPPING SCREWS @ 16" O.C. OR (2) ROWS OF 1/2" DIAMETER BOLTS @ 16" O.C. IF 1/2" BOLTS ARE USED TO FASTEN THE NAILER, THE STEEL BEAM SHALL BE FABRICATED w/ (2) ROWS OF 9/16" DIAMETER HOLES @ 16" O.C.

- 5. SQUARES DENOTE POINT LOADS WHICH REQUIRE SOLID BLOCKING TO GIRDER OR FOUNDATION. SHADED SQUARES DENOTE POINT LOADS FROM ABOVE WHICH REQUIRE SOLID BLOCKING TO SUPPORTING MEMBER BELOW.
- 6. ALL LOAD BEARING HEADERS TO CONFORM TO TABLE R602.7(1) AND R602.7(2) OF THE NCRC, 2018 EDITION OR BE (2) 2 x 6 WITH (1) JACK AND (1) KING STUD EACH END (UNO), WHICHEVER IS GREATER ALL HEADERS TO BE SECURED TO EACH JACK STUD WITH (4) 8d NAILS. ALL BEAMS TO BE SUPPORTED WITH (2) STUDS AT EACH BEARING POINT (UNO). INSTALL KING STUDS PER SECTION R602.7.5 OF THE NORTH CAROLINA RESIDENTIAL CODE, 2018 EDITION.
- 1. ALL BEAMS, HEADERS, OR GIRDER TRUSSES PARALLEL TO WALL ARE TO BEAR FULLY ON (1) JACK OR (2) STUDS MINIMUM OR THE NUMBER OF JACKS OR STUDS NOTED. ALL BEAMS OR GIRDER TRUSSES PERPENDICULAR TO WALL AND SUPPORTED BY (3) STUDS OR LESS ARE TO HAVE I 1/2" MINIMUM BEARING (UNO). ALL BEAMS OR GIRDER TRUSSES PERPENDICULAR TO WALL AND SUPPORTED BY MORE THAN (3) STUDS OR OTHER NOTED COLUMN ARE TO BEAR FULLY ON SUPPORT COLUMN FOR ENTIRE WALL DEPTH (UNO). BEAM ENDS THAT BUTT INTO ONE ANOTHER ARE TO EACH BEAR EQUAL LENGTHS (UNO).
- 8. FLITCH BEAMS SHALL BE BOLTED TOGETHER USING 1/2" DIAMETER BOLTS (ASTM A3ØT) WITH WASHERS PLACED AT THREADED END OF BOLT.
 BOLTS SHALL BE SPACED AT 24" CENTERS (MAXIMUM), AND STAGGERED AT TOP AND BOTTOM OF BEAM (2" EDGE DISTANCE), WITH (2) BOLTS LOCATED AT 6" FROM EACH END (UNO).
- 9. ALL 1-JOIST OR TRUSS LAYOUTS ARE TO BE IN COMPLIANCE WITH THE OVERALL DESIGN SPECIFIED ON THE PLANS. ALL DEVIATIONS ARE TO BE BROUGHT TO THE ATTENTION OF THE ENGINEER OF RECORD PRIOR TO INSTALLATION.
- 10. BRACED WALL PANELS SHALL BE CONSTRUCTED ACCORDING TO THE NORTH CAROLINA RESIDENTIAL CODE 2018 EDITION WALL BRACING CRITERIA. THE AMOUNT, LENGTH, AND LOCATION OF BRACING SHALL COMPLY WITH ALL APPLICABLE TABLES IN SECTION R602.10.
- 11. PROVIDE DOUBLE JOIST UNDER ALL WALLS PARALLEL TO FLOOR JOISTS. PROVIDE SUPPORT UNDER ALL WALLS PARALLEL TO FLOOR TRUSSES OR 1-JOISTS PER MANUFACTURER'S SPECIFICATIONS. INSTALL BLOCKING BETWEEN JOISTS OR TRUSSES FOR POINT LOAD SUPPORT FOR ALL POINT LOADS ALONG OFFSET LOAD LINES.
- 12. FOR ALL HEADERS SUPPORTING BRICK VENEER THAT ARE LESS THAN 8'-0" IN LENGTH, REST A 6" x 4" x 5/16" STEEL ANGLE WITH 6" MINIMUM EMBEDMENT AT SIDES FOR BRICK SUPPORT (UN.O). FOR ALL HEADERS 8'-0" AND GREATER IN LENGTH, BOLT A 6" x 4" x 5/16" STEEL ANGLE TO HEADER WITH 1/2" LAG SCREWS AT 12" O.C. STAGGERED FOR BRICK SUPPORT. FOR ALL BRICK SUPPORT AT ROOF LINES, BOLT A 6" x 4" x 5/16" STEEL ANGLE TO (2) 2 x 10 BLOCKING INSTALLED w/ (4) 12d NAILS EA. PLY BETWEEN WALL STUDS WITH (2) ROWS OF 1/2" LAG SCREWS AT 12" O.C. STAGGERED AND IN ACCORDANCE WITH SECTION R103.8.2.1 OF THE NCRC, 2018 EDITION.
- 13. FOR STICK FRAMED ROOFS: CIRCLES DENOTE (3) 2 x 4 POSTS FOR ROOF MEMBER SUPPORT. HIP SPLICES ARE TO BE SPACED A MINIMUM OF 8'-0". FASTEN MEMBERS WITH THREE ROWS OF 12d NAILS AT 16" O.C. FRAME DORMER WALLS ON TOP OF DOUBLE OR TRIPLE RAFTERS AS SHOWN (UNO).
- 14. FOR TRUSSED ROOFS: FRAME DORMER WALLS ON TOP OF 2 x 4 LADDER FRAMING AT 24" O.C. BETWEEN ADJACENT ROOF TRUSSES. STICK FRAME OVER-FRAMED ROOF SECTIONS WITH 2 x 8 RIDGES, 2 x 6 RAFTERS AT 16" O.C. AND FLAT 2 x 10 VALLEYS (UNO).
- 15. ALL 4 x 4 AND 6 x 6 POSTS TO BE INSTALLED WITH 100 LB CAPACITY UPLIFT CONNECTORS TOP AND BOTTOM (UNO.) POSTS MAY BE SECURED USING ONE SIMPSON H6 OR LTS12 UPLIFT CONNECTOR FASTENED TO THE BAND AT THE BOTTOM AND THE BEAM AT THE TOP OF EACH POST. ONE 16" SECTION OF SIMPSON CS16 COIL STRAPPING WITH (8) 8d HDG NAILS AT EACH END MAY BE USED IN LIEU OF EACH TWIST STRAP IF DESIRED. FOR MASONRY OR CONCRETE FOUNDATION USE SIMPSON POST BASE.

ENGINEERING, INGORDA 606 WADE AVE., SUITE 104 RALEIGH, NC 27605 PHONE; (919) 789-9919 FAX; (919) 789-9921 N.C. LICENSE NO.: C-1733

STANDARD STRUCTURAL NOTES

DATE: OCTOBER 29, 2018

DRAWN BY: JES
ENGINEERED BY: JST

SCALE: 1/4" = 1'-0"

STRUCTURAL NOTES