GENERAL NOTES:

- IT IS THE CONTRACTORS RESPONSIBILITY TO VERIFY THAT ALL DIMENSIONS, ROOF PITCHES, AND SQUARE FOOTAGE ARE CORRECT PRIOR TO CONSTRUCTION. K&A HOME DESIGNS, INC. IS NOT RESPONSIBLE FOR ANY DIMENSIONING, ROOF PITCH, OR SQUARE FOOTAGE ERRORS ONCE CONSTRUCTION BEGINS.
- 2. ALL WALLS SHOWN ON THE FLOOR PLANS ARE DRAWN AT 4" UNLESS NOTED OTHERWISE.
- 3. ALL ANGLED WALL SHOWN ON THE PLANS ARE 45 DEGREES UNLESS NOTED OTHERWISE.
- 4. STUD WALL DESIGN SHALL CONFORM TO ALL NORTH CAROLINA STATE BUILDING CODE REQUIREMENTS.
- 5. DO NOT SCALE PLANS. DRAWING SCALE MAY BE DISTORTED DUE TO COPIER IMPERFECTIONS.
- 6. ALL CONSTRUCTION SHALL BE IN ACCORDANCE WITH NORTH CAROLINA STATE BUILDING CODE, 2018 EDITION.

SQUARE FOOTAGE

HEATED SQUARE FOOTAGE		UNHEATED SQUAR	UNHEATED SQUARE FOOTAGE	
FIRST FLOOR =	1414	GARAGE =	N/A	
SECOND FLOOR =	N/A	FRONT PORCH =	108	
THIRD FLOOR =	N/A	SCREEN PORCH =	N/A	
BASEMENT=	N/A	DECK=	N/A	
		STORAGE =	N/A	

TOTAL HEATED = 1414 TOTAL UNHEATED = 108

CRAWL SPACE VENTILATION CALCULATIONS

-VENT LOCATIONS MAY VARY FROM THOSE SHOWN ON THE PLAN BUT SHOULD BE PLACED TO PROVIDE ADEQUATE VENTILATION AT ALL POINTS TO PREVENT DEAD AIR POCKETS.

-100% VAPOR BARRIER MUST BE PROVIDED WITH 12" MIN. LAP JOINTS.

-THE TOTAL AREA OF VENTILATION OPENINGS MAY BE REDUCED TO 1/1500 AS LONG AS REQUIRED OPENINGS ARE PLACED SO AS TO PROVIDE CROSS-VENTILATION OF THE SPACE. THE INSTALLATION OF OPERABLE LOUVERS SHALL NOT BE PROHIBITED. (COMPLY WITH NC CODE MIN. WITH REGARD TO VENT PLACEMENT FROM CORNERS)

1414 SQ. FT. OF CRAWL SPACE/1500

.94 SQ. FT. OF REQUIRED VENTILATION

PROVIDED BY: 3 VENTS AT 0.45 SQ. FT. NET FREE

VENTILATION EACH= 1.35 SQ. FT. OF VENTILATION

**FOUNDATION DRAINAGE- WATERPROOFING PER SECTIONS 405 & 406.

ATTIC VENTILATION CALCULATIONS

- CALCULATIONS SHOWN BELOW ARE BASED ON VENTILATORS USED AT LEAST 3 FT. ABOVE THE CORNICE VENTS WITH THE BALANCE OF VENTIALTION PROVIDED BE EAVE VENTS.
- CATHEDRAL CEILINGS SHALL HAVE A MIN. 1" CLEARANCE BETWEEN THE BOTTOM OF THE ROOF DECK AND THE INSULATION.

1522 SQ. FT. OF ATTIC/300= 5.07 EACH OF INLET AND OUTLET REQUIRED.

$\underline{^*WALL\,AND\,ROOF\,CLADDING\,DESIGN\,VALUES}$

- WALL CLADDING IS DESIGNED FOR A 24.1 SQ. FT. OR GREATER POSITIVE AND NEGATIVE PRESSURE.
- ROOF VALUES BOTH POSITVE AND NEGATIVE SHALL BE AS FOLLOWS:

45.5 LBs. PER SQ. FT. FOR ROOF PITCHES OF $0/12\ {\rm TO}\ 2.25/12$

34.8 LBS. PER SQ. FT. FOR ROOF PITCHES OF 2.25/12 TO 7/12

 $21\,\text{LBS}.\,\text{PER}\,\text{SQ}.\,\text{FT}.\,\text{FOR}\,\text{ROOF}\,\text{PITCHES}\,\text{OF}\,7/12\,\text{TO}\,12/12$


** MEAN ROOF HEIGHT 30' OR LESS




FRONT ELEVATION


1/4" = 1'-0"

1/8" = 1'-0"

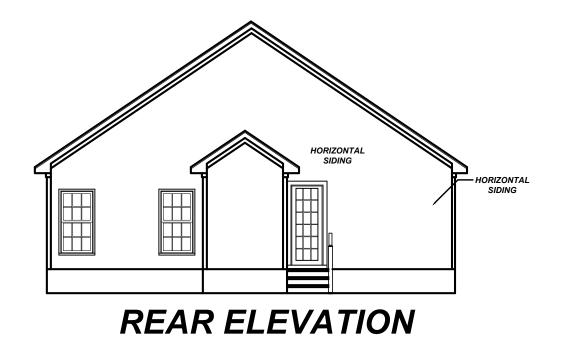

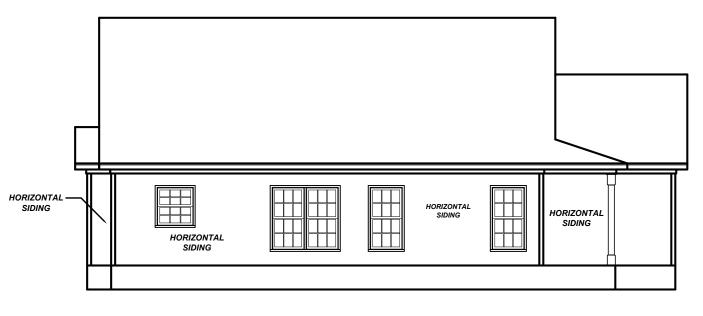



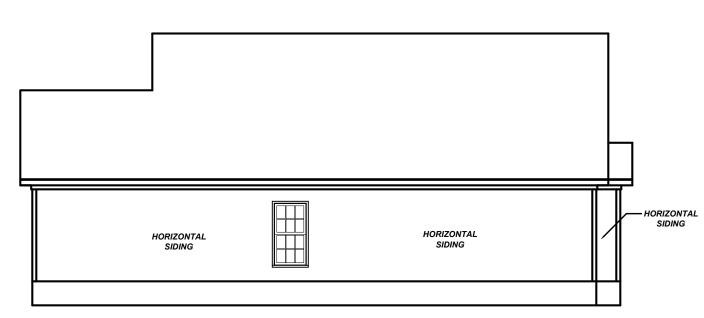

RIGHT ELEVATION

1/8" = 1'-0"

	_
Project #:	7
19-047	
Date:	
1-27-21	
Drawn/Design By:	
KBB	
Scale:	
REFER TO FLEV.	

_		
	RI	EVISIONS
No.	Date:	Remarks
1		
2		
3		

Ten Rd. IC 27603 9) 302-0693

9101 Ten-Ten RRaleigh, NC 276Office: (919) 302



The Cedar (Master Right)

KMB Building, LLC 5609 Stewart Rd. Raleigh, NC 27603

ELEVATIONS

Sheet Number

GENERAL NOTES:

- IT IS THE CONTRACTORS RESPONSIBILITY TO VERIFY THAT ALL DIMENSIONS, ROOF PITCHES, AND SQUARE FOOTAGE ARE CORRECT PRIOR TO CONSTRUCTION. K&A HOME DESIGNS, INC. IS NOT RESPONSIBLE FOR ANY DIMENSIONING, ROOF PITCH, OR SQUARE FOOTAGE ERRORS ONCE CONSTRUCTION BEGINS.
- 2. ALL WALLS SHOWN ON THE FLOOR PLANS ARE DRAWN AT 4" UNLESS NOTED OTHERWISE.
- 3. ALL ANGLED WALL SHOWN ON THE PLANS ARE 45 DEGREES UNLESS NOTED OTHERWISE.
- 4. STUD WALL DESIGN SHALL CONFORM TO ALL NORTH CAROLINA STATE BUILDING CODE REQUIREMENTS.
- 5. DO NOT SCALE PLANS. DRAWING SCALE MAY BE DISTORTED DUE TO COPIER IMPERFECTIONS.
- 6. ALL CONSTRUCTION SHALL BE IN ACCORDANCE WITH NORTH CAROLINA STATE BUILDING CODE, 2018 EDITION.

SQUARE FOOTAGE

HEATED SQUARE FOOTAGE		UNHEATED SQUAF	REFOOTAG
FIRST FLOOR =	1414	GARAGE =	N/A
SECOND FLOOR =	N/A	FRONT PORCH =	108
THIRD FLOOR =	N/A	SCREEN PORCH=	N/A
BASEMENT =	N/A	DECK=	N/A
		STORAGE =	N/A

TOTAL HEATED = 1414 TOTAL UNHEATED = 108

CRAWL SPACE VENTILATION CALCULATIONS

-VENT LOCATIONS MAY VARY FROM THOSE SHOWN ON THE PLAN BUT SHOULD BE PLACED TO PROVIDE ADEQUATE VENTILATION AT ALL POINTS TO PREVENT DEAD AIR POCKETS.

-100% VAPOR BARRIER MUST BE PROVIDED WITH 12" MIN. LAP JOINTS.

-THE TOTAL AREA OF VENTILATION OPENINGS MAY BE REDUCED TO 1/1500 AS LONG AS REQUIRED OPENINGS ARE PLACED SO AS TO PROVIDE CROSS-VENTILATION OF THE SPACE. THE INSTALLATION OF OPERABLE LOUVERS SHALL NOT BE PROHIBITED. (COMPLY WITH NC CODE MIN. WITH REGARD TO VENT PLACEMENT FROM CORNERS)

1414 SQ. FT. OF CRAWL SPACE/1500

.94 SQ. FT. OF REQUIRED VENTILATION

PROVIDED BY: 3 VENTS AT 0.45 SQ. FT. NET FREE

VENTILATION EACH= 1.35 SQ. FT. OF VENTILATION

**FOUNDATION DRAINAGE- WATERPROOFING PER SECTIONS 405 & 406.

ATTIC VENTILATION CALCULATIONS

- CALCULATIONS SHOWN BELOW ARE BASED ON VENTILATORS USED AT LEAST 3 FT. ABOVE THE CORNICE VENTS WITH THE BALANCE OF VENTIALTION PROVIDED BE EAVE VENTS.
- CATHEDRAL CEILINGS SHALL HAVE A MIN. 1" CLEARANCE BETWEEN THE BOTTOM OF THE ROOF DECK AND THE INSULATION.

1522 SQ. FT. OF ATTIC/300= 5.00 EACH OF INLET AND OUTLET REQUIRED.

$\underline{^*WALL\,AND\,ROOF\,CLADDING\,DESIGN\,VALUES}$


- WALL CLADDING IS DESIGNED FOR A 24.1 SQ. FT. OR GREATER POSITIVE AND NEGATIVE PRESSURE.
- ROOF VALUES BOTH POSITVE AND NEGATIVE SHALL BE AS FOLLOWS:

45.5 LBs. PER SQ. FT. FOR ROOF PITCHES OF $0/12\ {\rm TO}\ 2.25/12$

 $34.8\,LBS.$ PER SQ. FT. FOR ROOF PITCHES OF 2.25/12 TO 7/12

21 LBs. PER SQ. FT. FOR ROOF PITCHES OF $7/12\,\mathrm{TO}\,12/12$


** MEAN ROOF HEIGHT 30' OR LESS

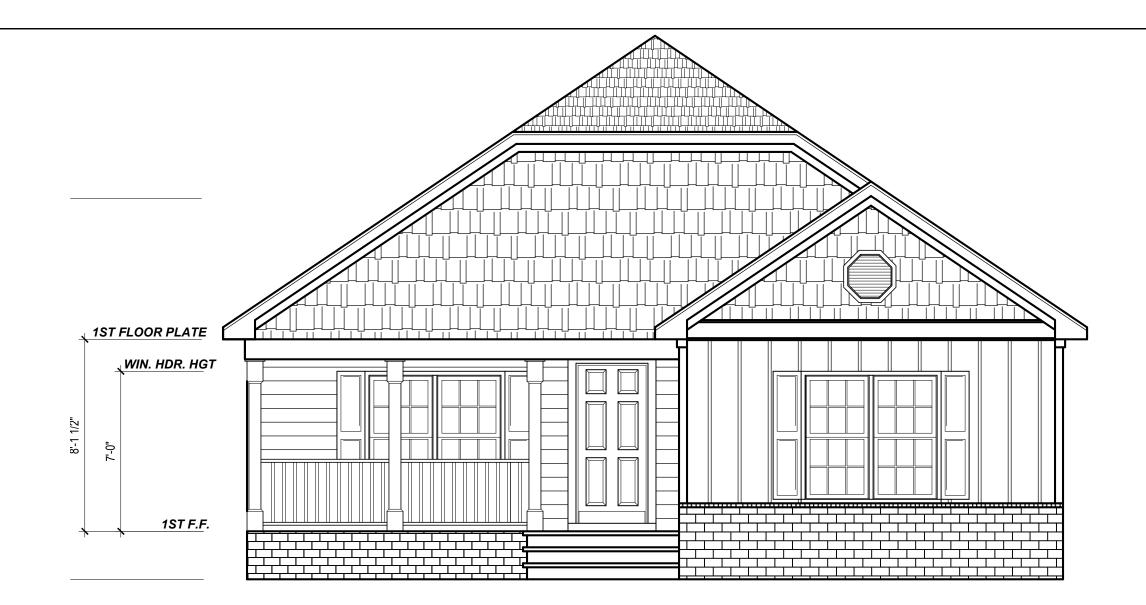


FRONT ELEVATION 'B'


1/4" = 1'-0"

1/8" = 1'-0"

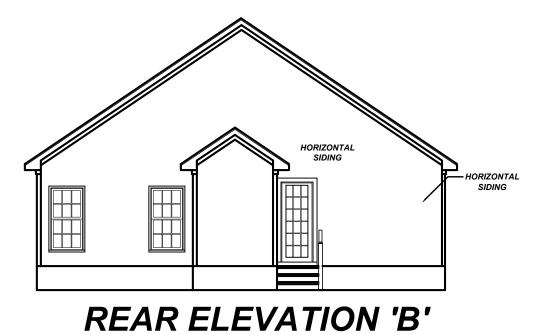

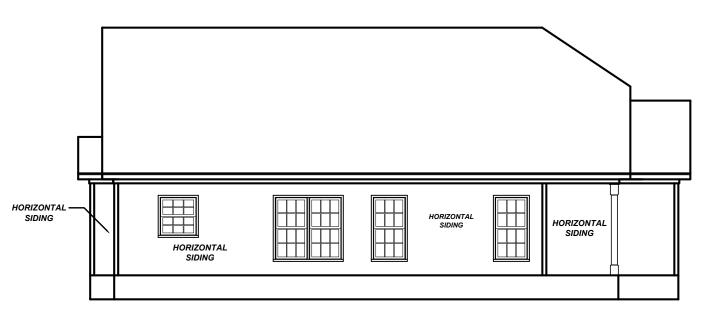



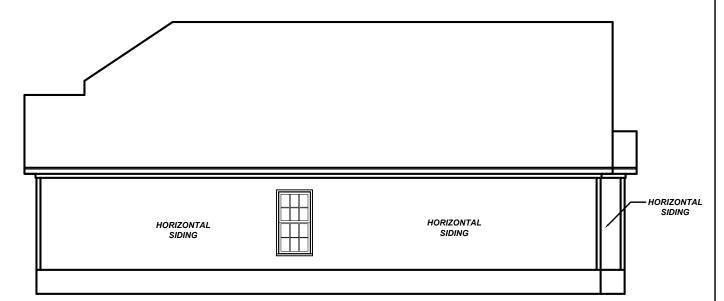

RIGHT ELEVATION 'B'

1/8" = 1'-0"

}	Project #:	
1	19-047	
	<u>Date:</u> 1-27-21	
	<u>Drawn/Design By:</u> KBB	
	Scale: REFER TO ELEV.	

	RI	EVISIONS
No.	Date:	Remarks
1		
2		
3		
Ţ.		

Ten-Ten Rd. igh, NC 27603 e: (919) 302-0693




The Cedar (Master Righ

KMB Building, LLC 5609 Stewart Rd. Raleigh, NC 27603

ELEVATIONS

Sheet Numb

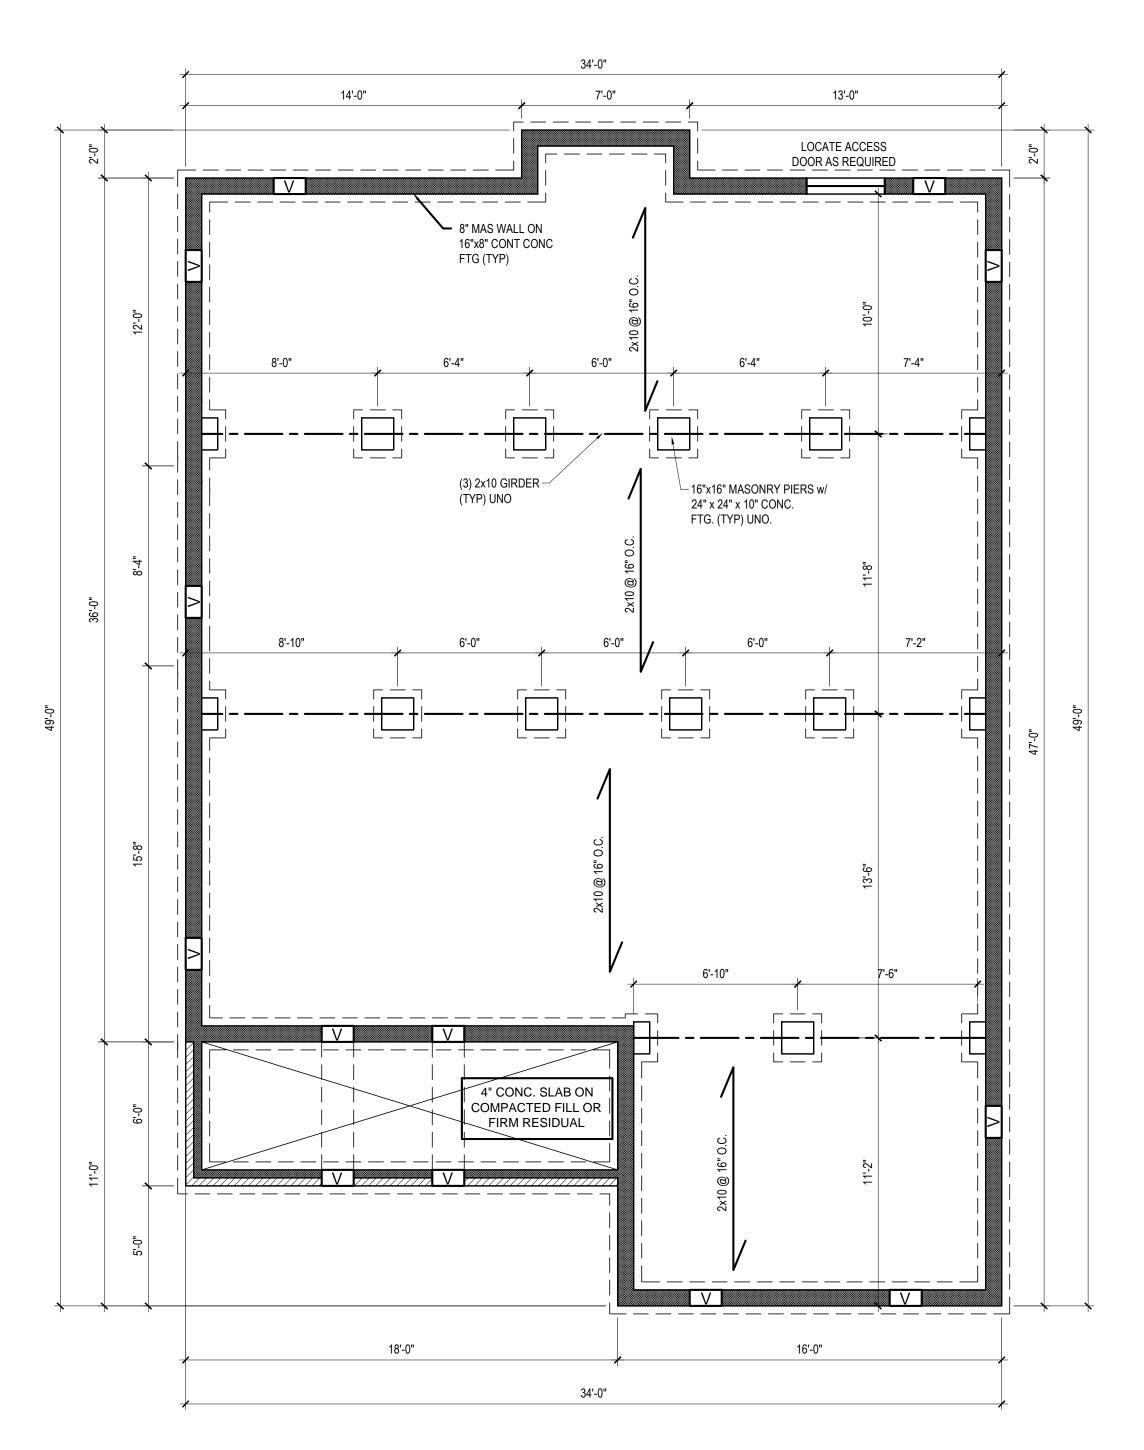

FOUNDATION PLAN 1/4" = 1'-0"


<u>Date:</u> 1-27-21 Drawn/Design By: Scale: 1/4" = 1'-0"

Remarks

The Cedar (Master Right)

KMB Building, LLC 5609 Stewart Rd. Raleigh, NC 27603

FOUNDATION

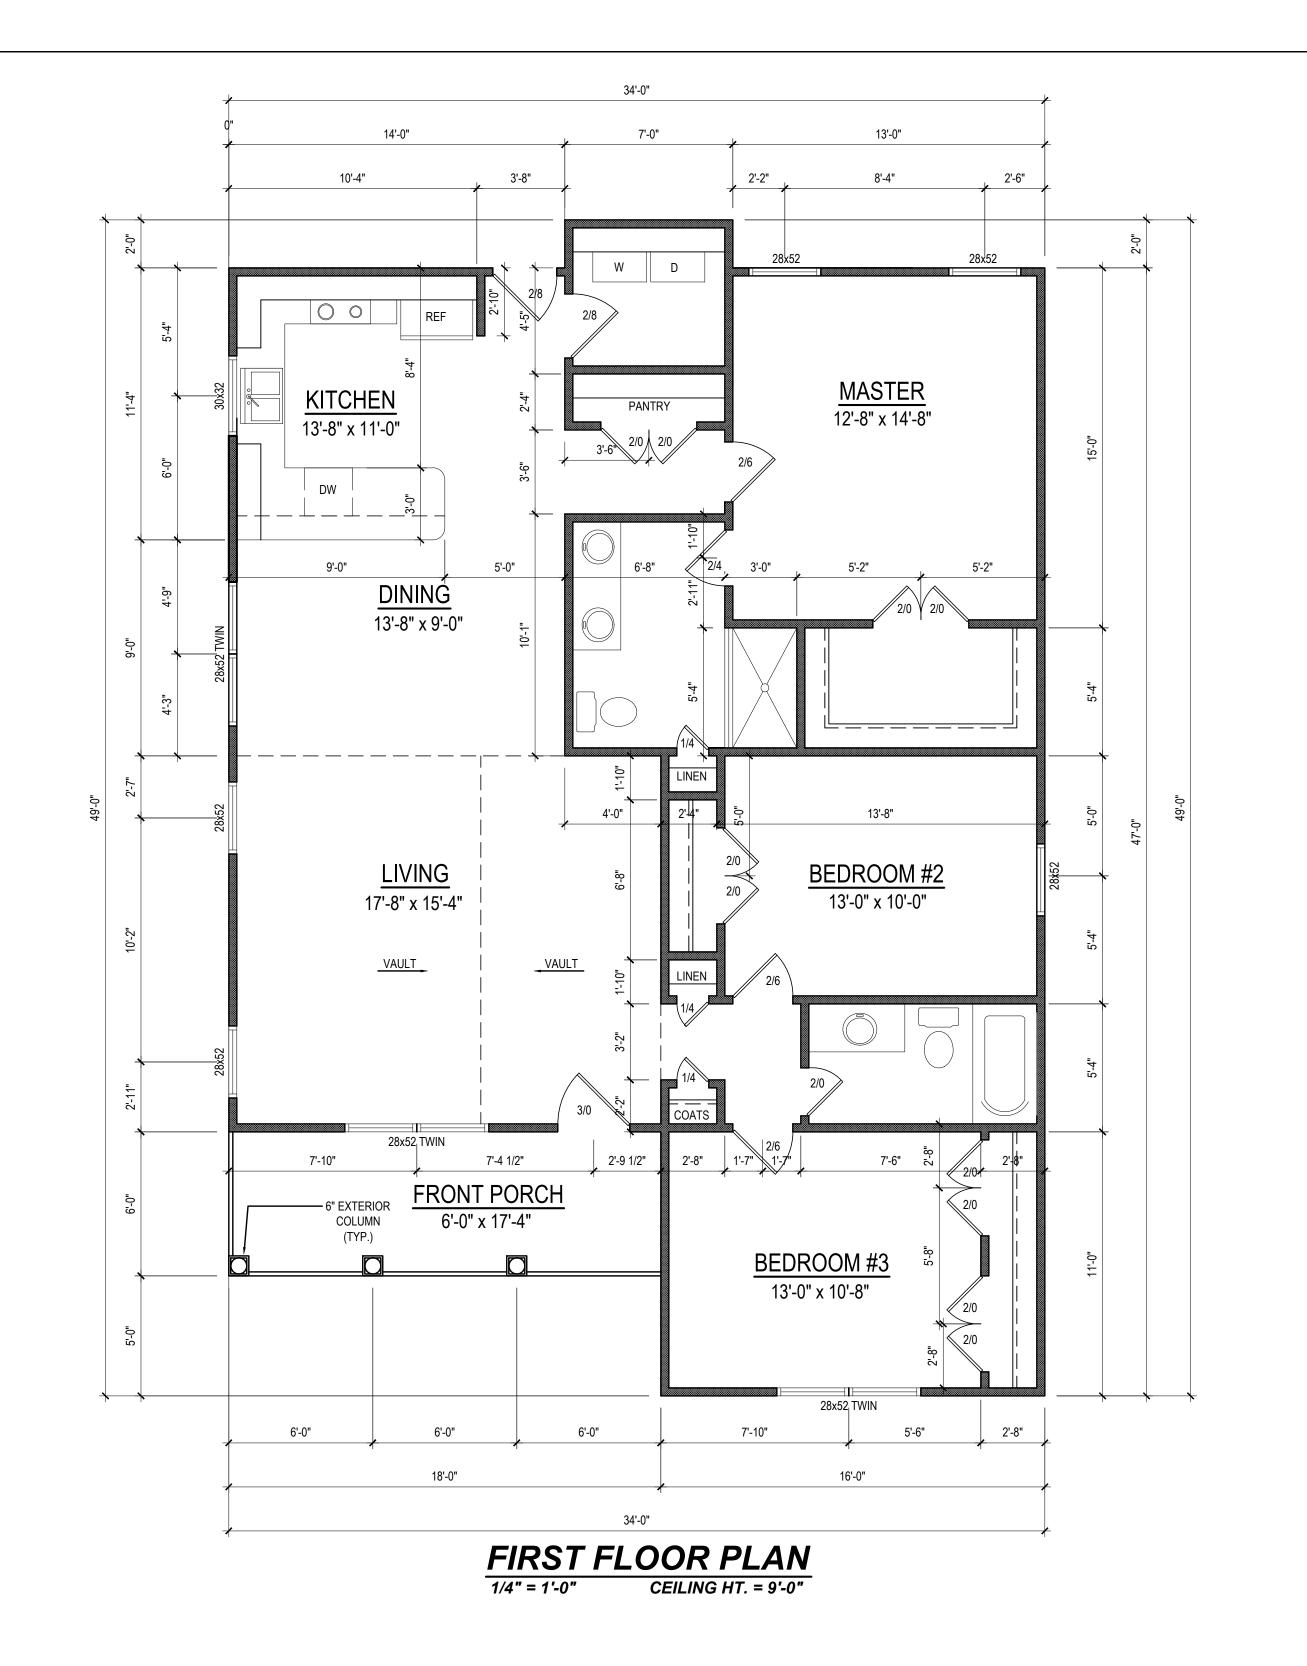

Project #: 19-047 <u>Date:</u> 1-27-21 Drawn/Design By: Scale: 1/4" = 1'-0"

		_
	REVISIONS	
No.	Date:	Remarks
1		
2		
3		
4		

9101 Ten-Ten Rd. Raleigh, NC 27603 Office: (919) 302-0693

S N

Website: www.KandAHomeDesigns.com


Email: Kent@KandAHomeDesigns.com

The Cedar (Master Right)

KMB Building, LLC 5609 Stewart Rd. Raleigh, NC 27603

FIRST FLOOR

Sheet Number 3

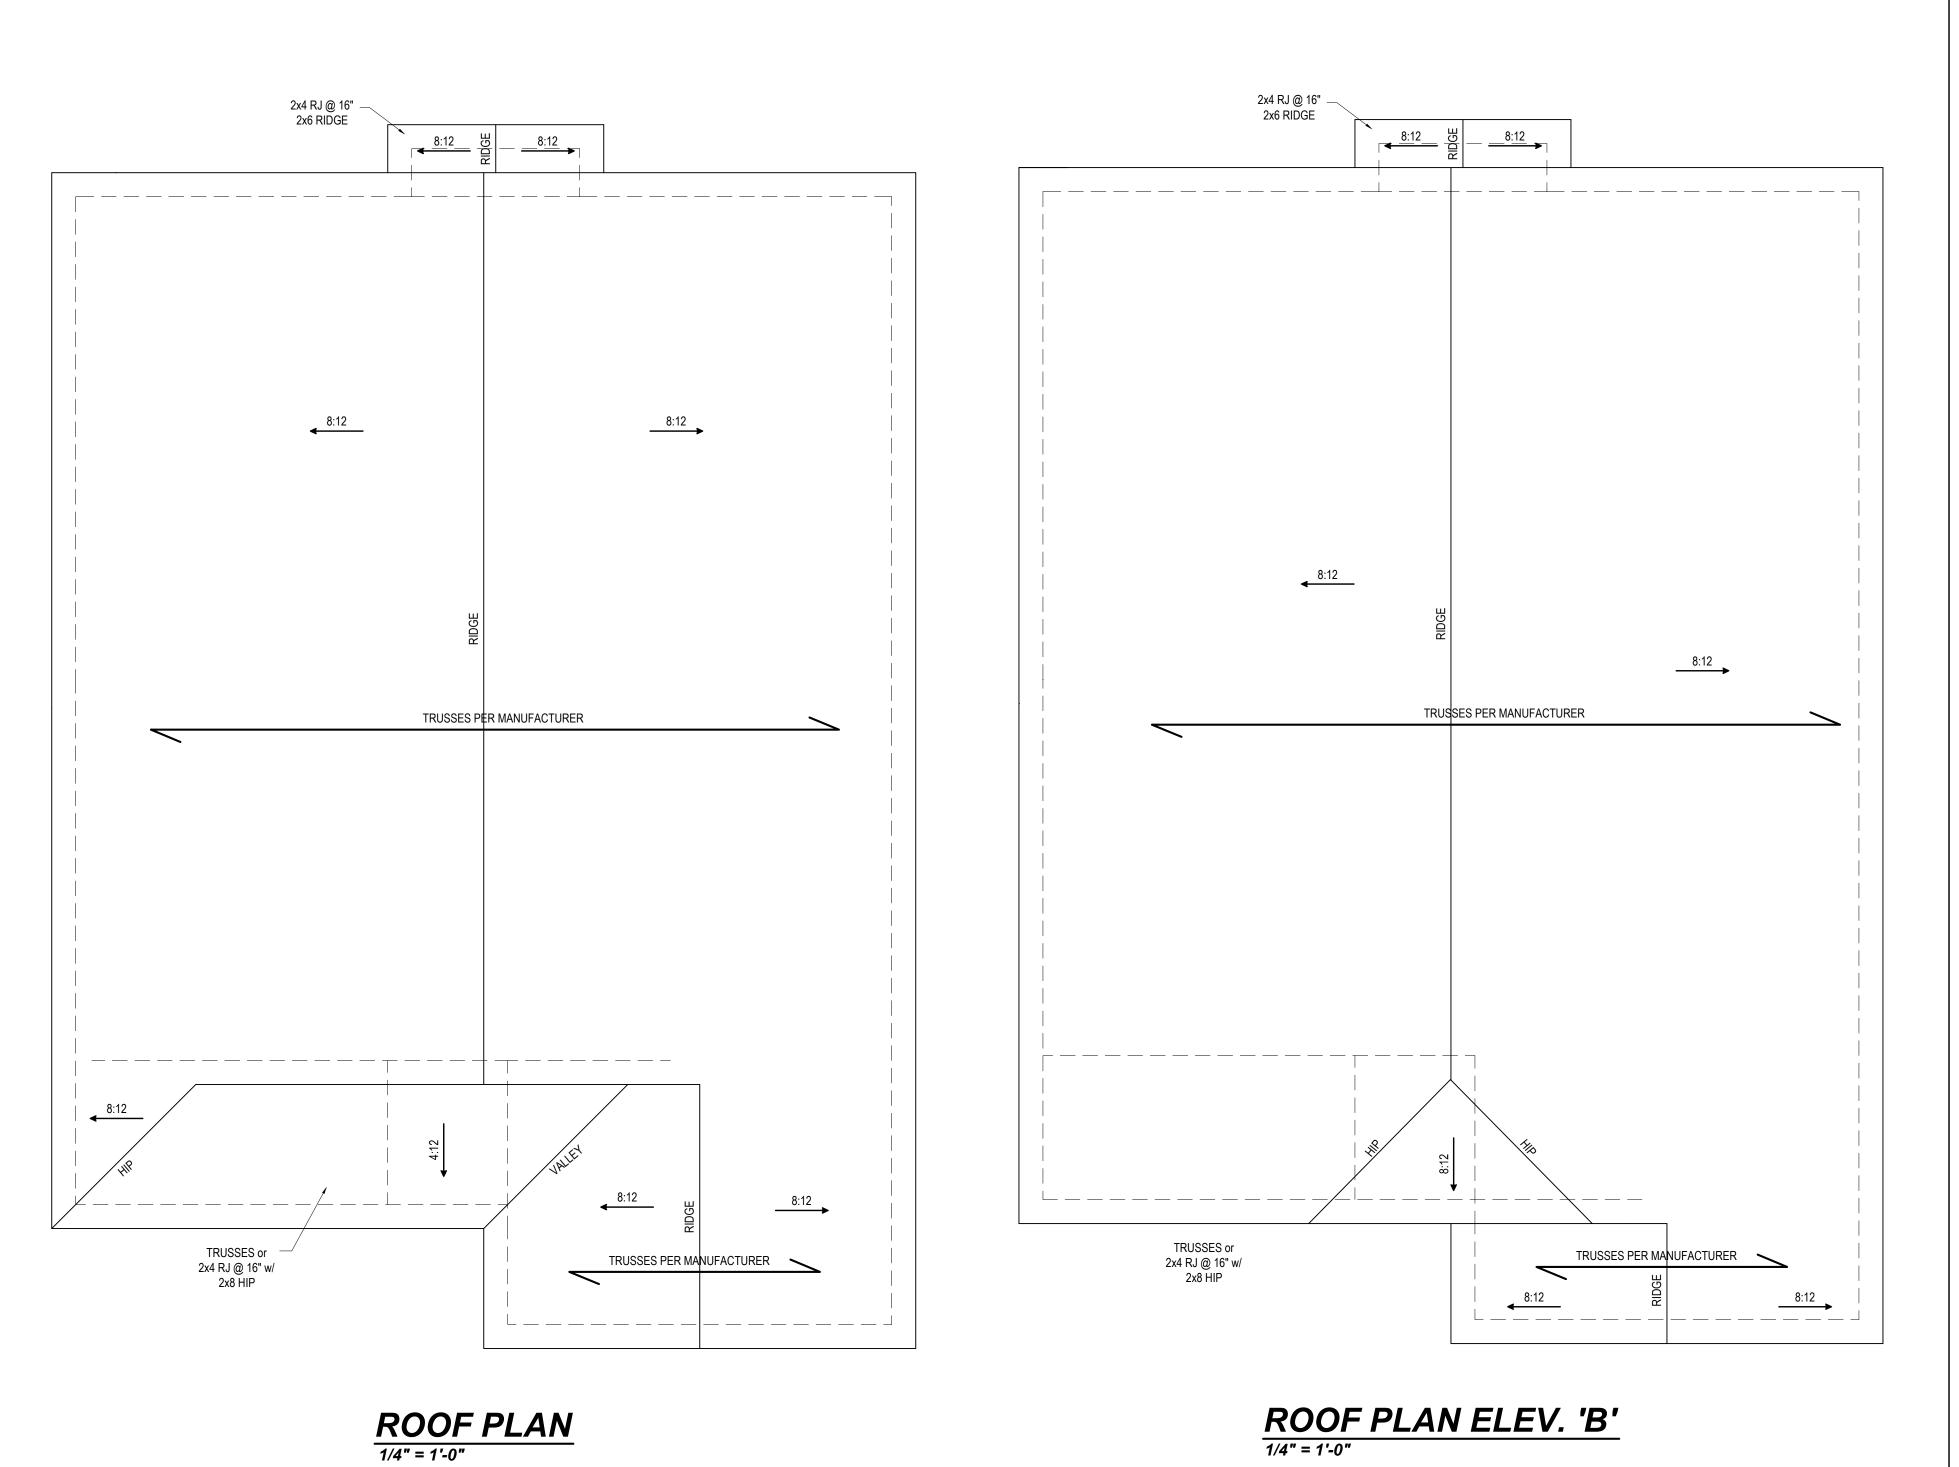

Project #: 19-047 <u>Date:</u> 1-27-21 Drawn/Design By: Scale: 1/4" = 1'-0"

Remarks

9101 Ten-Ten Rd. Raleigh, NC 27603 Office: (919) 302-0693

Website: www.KandAHomeDesigns.com

Email: Kent@KandAHomeDesigns.com

The Cedar (Master Right)

KMB Building, LLC 5609 Stewart Rd. Raleigh, NC 27603

ROOF LAYOUT

Sheet Number