
GENERAL NOTES

- 1. ALL WORK SHALL BE PERFORMED IN ACCORDANCE WITH ALL APPLICABLE NATIONAL, STATE, AND LOCAL CODES AND REGULATIONS.
- CONTRACTOR SHALL THOROUGHLY REVIEW ALL SHEETS IN PLAN SET AND VERIFY ALL DETAILS AND DIMENSIONS BEFORE BEGINNING CONSTRUCTION. ANY DISCREPANCIES SHALL BE REPORTED TO RENAISSANCE RESIDENTIAL DESIGN, INC. FOR JUSTIFICATION AND/OR CORRECTION BEFORE PROCEEDING WITH WORK. CONTRACTORS SHALL ASSUME RESPONSIBILITY FOR ERRORS THAT ARE NOT REPORTED PRIOR TO CONSTRUCTION.
- ALL DIMENSIONS SHOULD BE READ OR CALCULATED AND NEVER SCALED.
- CONTRACTOR SHALL ENSURE COMPATIBILITY OF THE BUILDING WITH ALL

LOT 5 WEST PARK 173 WEST PARK LANE SANFORD, NC 27332

PLANS DESIGNED TO THE 2018 NORTH CAROLINA STATE RESIDENTIAL BUILDING CODE.

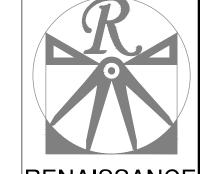

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DATE: JULY 22, 2020

REV.: SCALE: 1/4" = 1'-0"


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REVIEWED BY:


C - ELEVATIONS

A-3



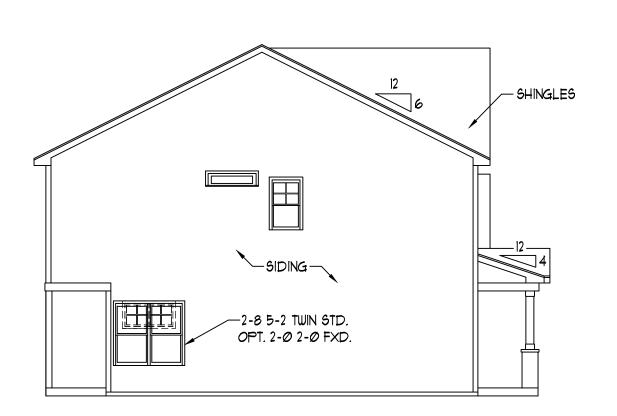

PLUMBING: DOUBLE J LEFT ELEVATION **HVAC: MAINSTREAM** SCALE: 1/8" = 1'-0" **ELECTRICAL: PIONEER**

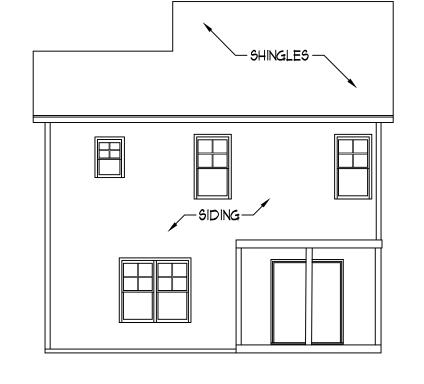

SCALE: 1/4" = 1'-0"

REAR ELEVATION SCALE: 1/8" = 1'-0" SHINGLES -


SHINGLES -


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RIGHT ELEVATION SCALE: 1/8" = 1'-0"

SCALE NOTE: 18x24 PRINTS ARE TO SCALE AS NOTED. 11x17 PRINTS ARE NOT TO SCALE

NORTH CAROLINA



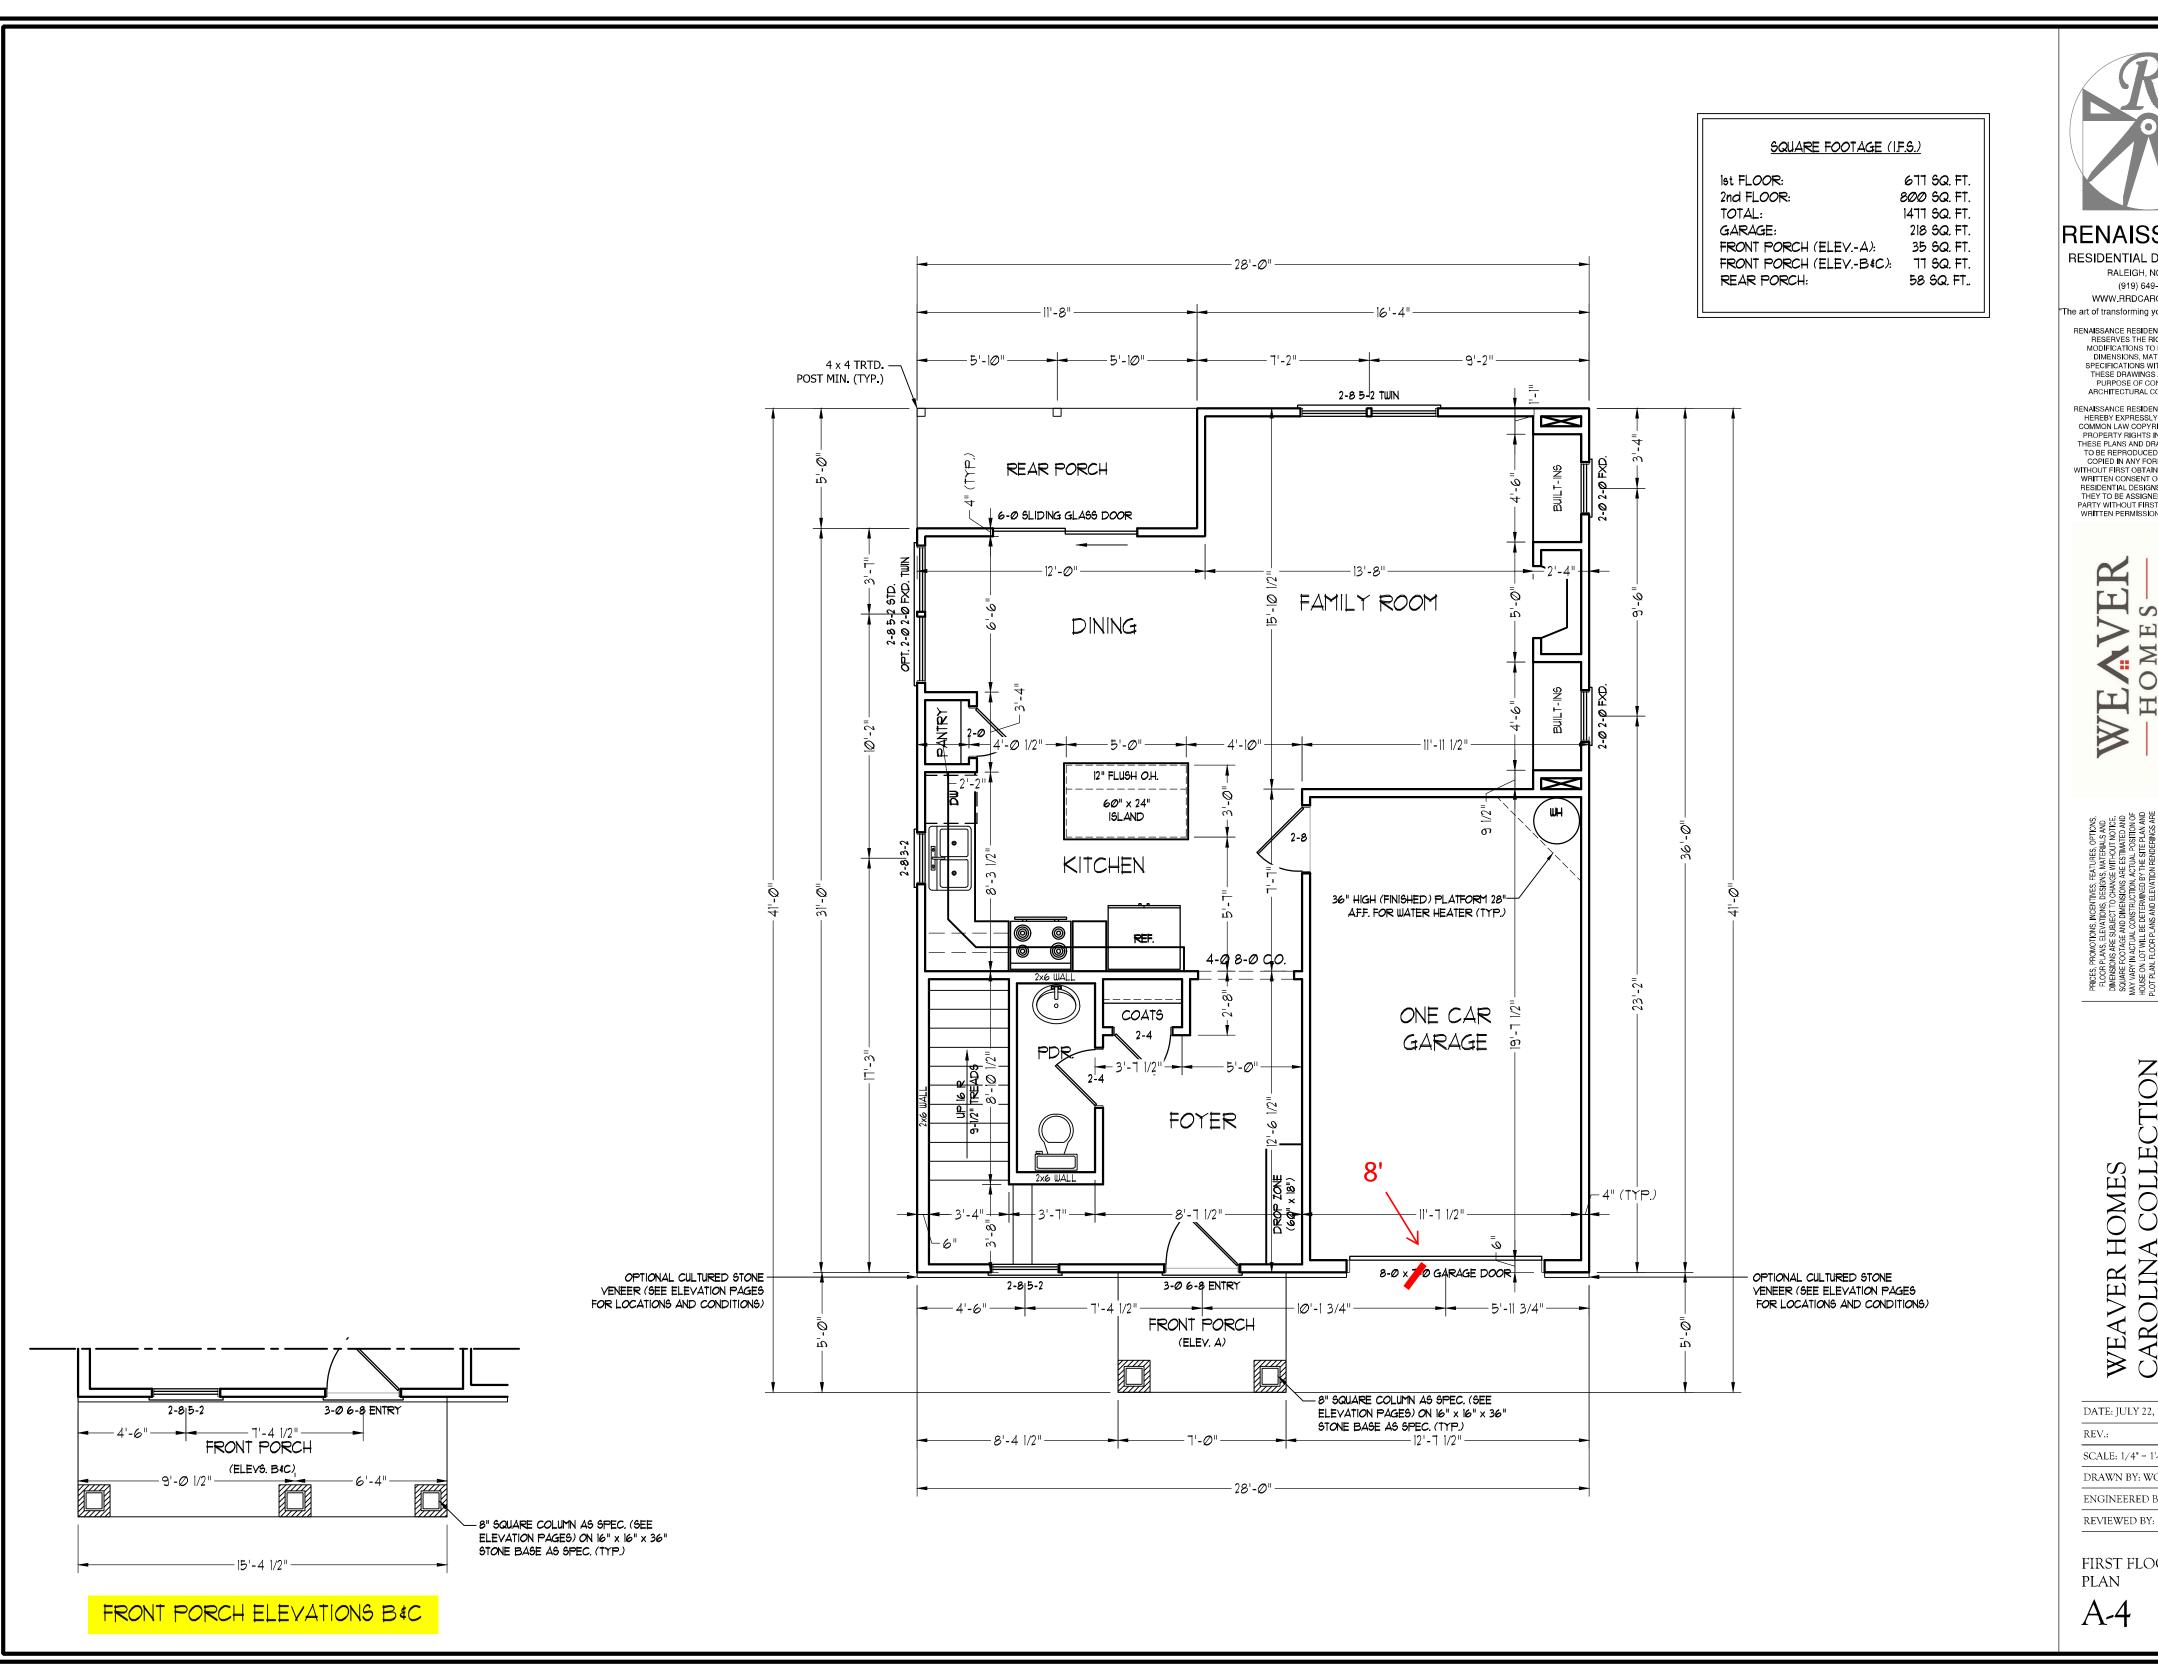
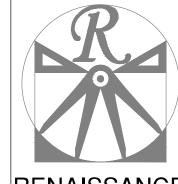
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DATE: JULY 22, 2020


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SCALE: 1/4" = 1'-0" DRAWN BY: WG

ENGINEERED BY:

FIRST FLOOR PLAN

A-4



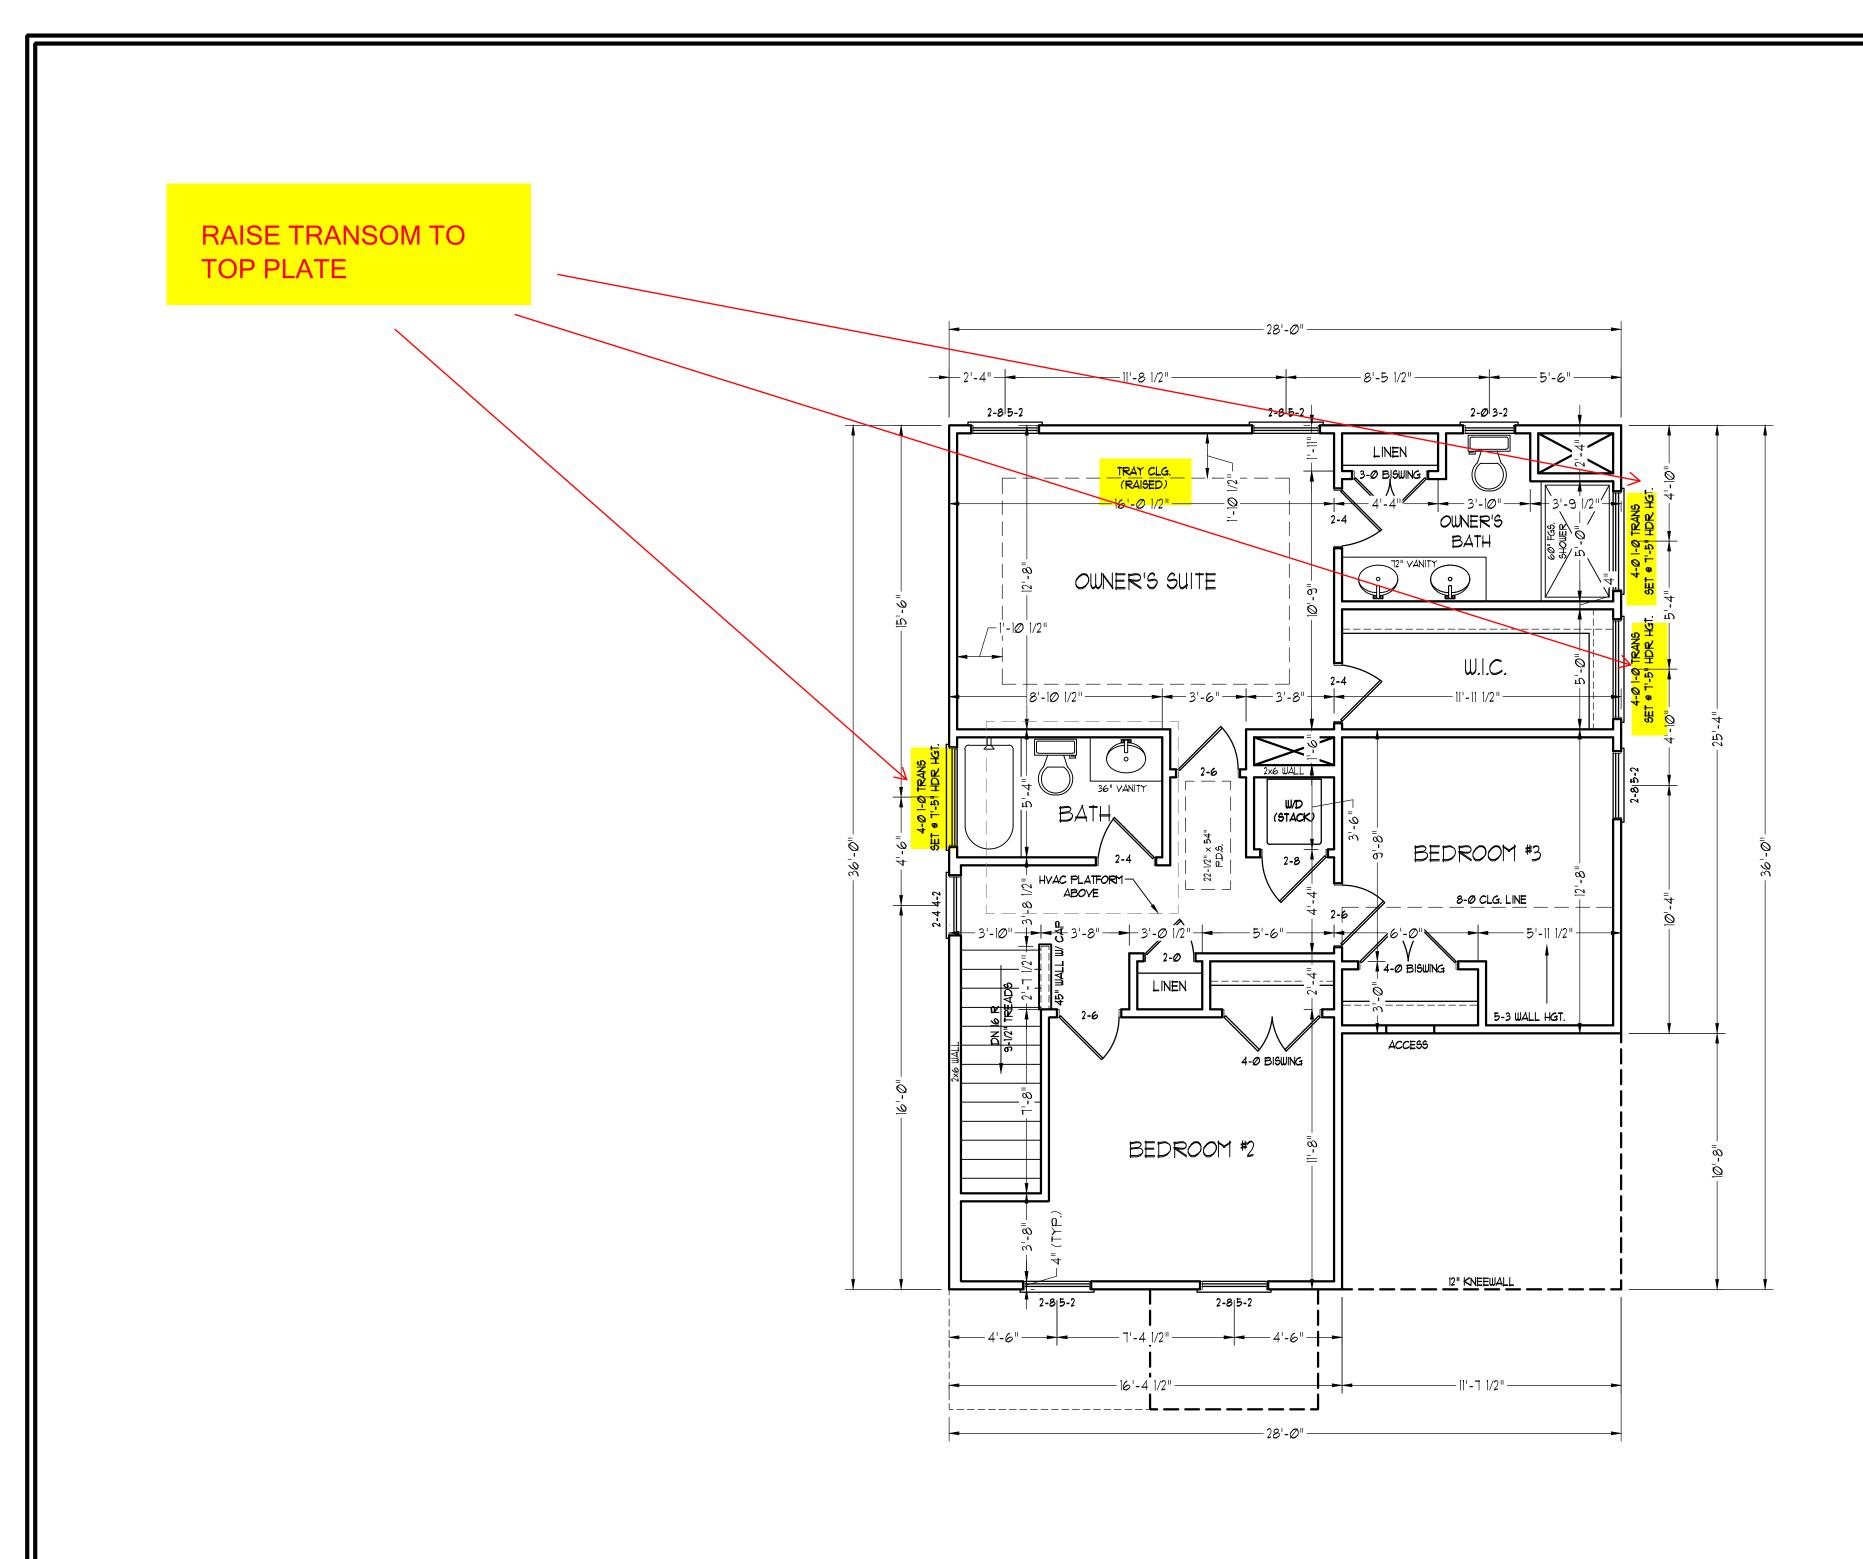

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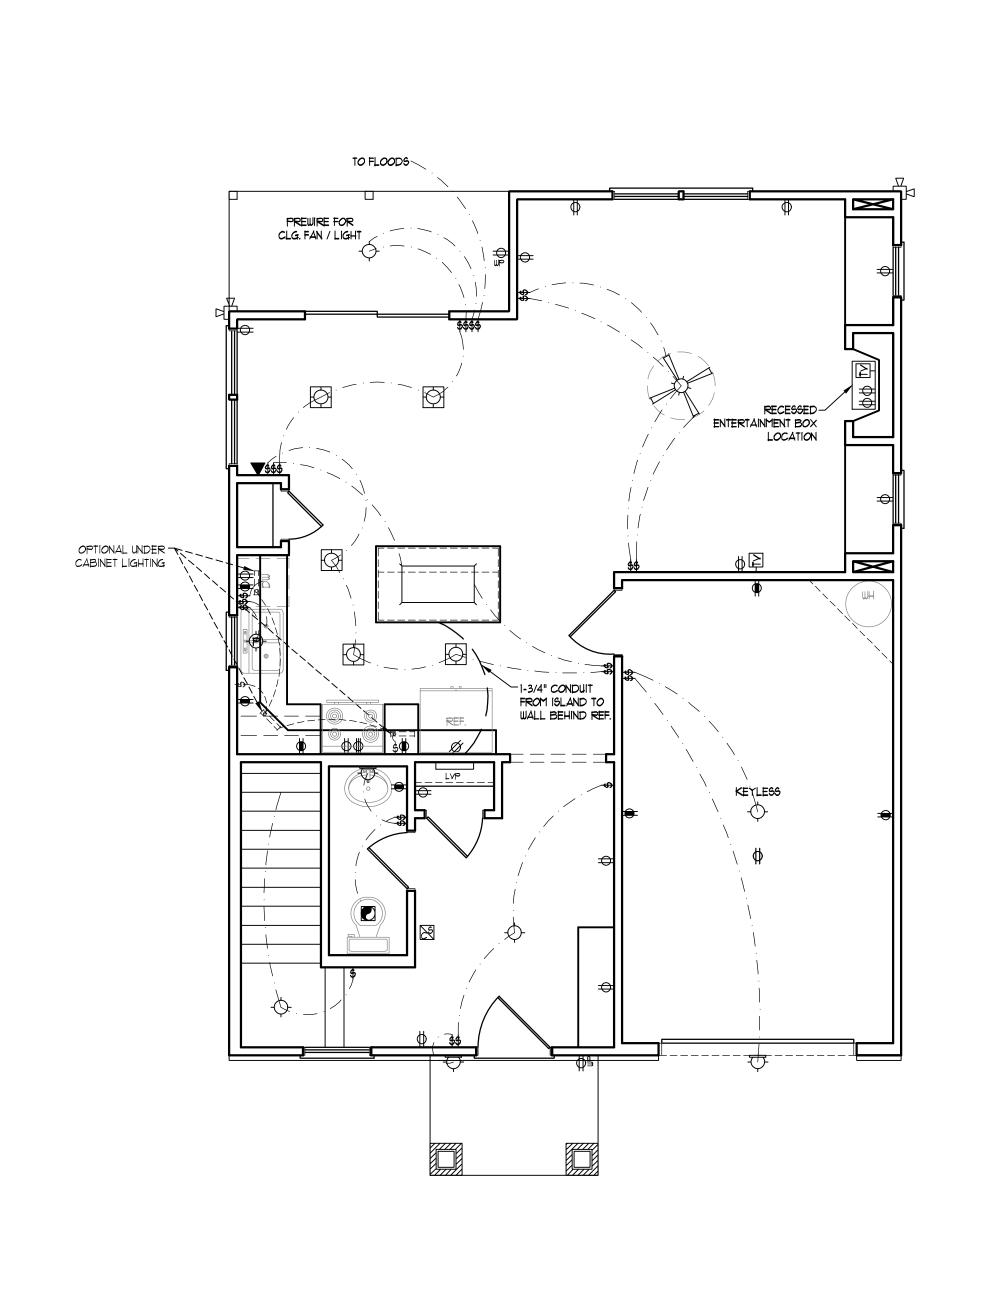
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REVIEWED BY:

SECOND FLOOR PLAN

A-5

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ELECTRICAL LAYOUT NOTES:

- 1.) BLOCK AND WIRE FOR ALL CELING FANS PER PLAN.
- 2.) VANITY LIGHTS TO BE SET @ 90" A.F.F. (TYP.)
- 3.) ADDITIONAL EXTERIOR OUTLETS REQUIRED BY CODE TO BE LOCATED BY ELECTRICIAN.
- 4.) PLACE SWITCHES 8" (MIN.) FROM ROUGH OPENINGS.

ELECTRICAL LEGEND

- ⇒ IIØ Y OUTLET
- € 110 Y GFI OUTLET
- → 110 V SWITCHED OUTLET
- BB IIØ Y BASEBOARD OUTLET
- 4-PLEX
- COUNTER OR FLOOR MOUNTED
- COUNTER OR FLOOR MOUNTED 110V GFI
- ₩EATHERPROOF
- **⇒** 220 ∨ OUTLET
- 10 Y DEDICATED CIRCUIT
- # 220 V DEDICATED CIRCUIT
- PH SPECIAL PURPOSE (240 V, ETC.)
- WALL MOUNT LIGHT
- -PENDANT LIGHT
- RECESSED CAN LIGHT
- MINI CAN LIGHT
- EYEBALL LIGHT

FLUORESCENT LIGHT

- UNDERCABINET LIGHT
- FLOOD LIGHT
- SWITCH \$D DIMMER SWITCH
- ▲ TELEPHONE
- △ DATA

TELEPHONE AND DATA

- TV- TV CONNECTION
- TV/ DATA
- CD- CONDUIT FOR COMPONENT WIRING
- SPEAKER
- 110 V SMOKE/CM DETECTOR
- SD 110 V SMOKE DETECTOR
- EXHAUST FAN



ALARM PANEL







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DATE: JULY 22, 2020


SCALE: 1/4" = 1'-0" DRAWN BY: WG

ENGINEERED BY: REVIEWED BY:

FIRST FLOOR ELECTRICAL PLAN

E-1

FRONT PORCH ELEVATIONS B&C

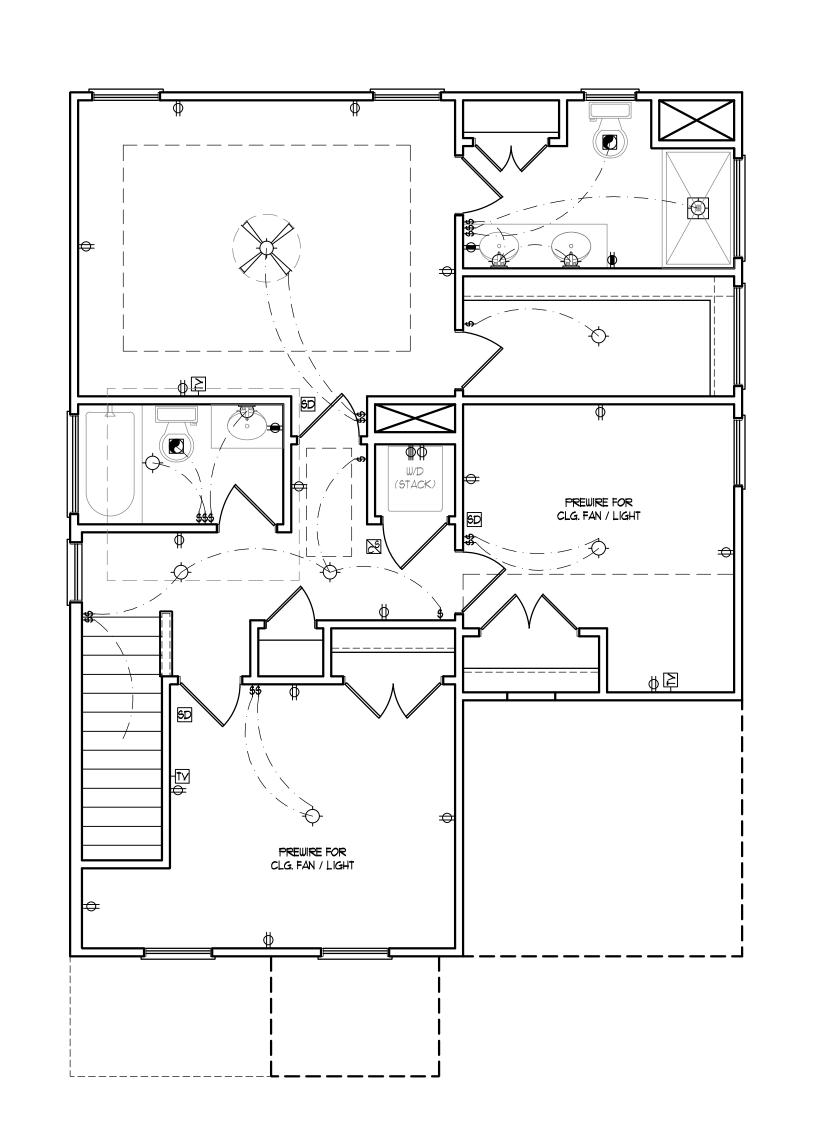

ELECTRICAL LAYOUT NOTES:

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- **⇒** 22Ø ∨ OUTLET
- 10 Y DEDICATED CIRCUIT
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- WALL MOUNT LIGHT
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- -P- PENDANT LIGHT
- RECESSED CAN LIGHT
- MINI CAN LIGHT
- EYEBALL LIGHT

FLUORESCENT LIGHT

UNDERCABINET LIGHT

FLOOD LIGHT

SWITCH

\$D DIMMER SWITCH

▲ TELEPHONE

△ DATA

- TELEPHONE AND DATA
- TV- TV CONNECTION
- TV/ DATA
- CD- CONDUIT FOR COMPONENT WIRING
- SP SPEAKER
- 110 V SMOKE/ CO DETECTOR
- SD 110 V SMOKE DETECTOR

EXHAUST FAN



ALARM PANEL







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DATE: JULY 22, 2020

REVIEWED BY:

SCALE: 1/4" = 1'-0" DRAWN BY: WG

ENGINEERED BY:

SECOND FLOOR ELCTRICAL

E-2

PLAN


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ULTIMATE DESIGN WIND SPEED NOTES FOR LESS THAN 30' MEAN ROOF HEIGHT: 1. STRUCTURAL DESIGN PER NORTH CAROLINA RESIDENTIAL CODE, 2018 EDITION. 2. FOR 120 MPH WIND ZONES INSTALL 1/2" ANCHOR BOLTS 6'-0" O.C. AND WITHIN 1'-0" FROM END OF EACH CORNER. ANCHOR BOLTS MUST EXTEND A MINIMUM OF 7" INTO CONCRETE OR 15" INTO MASONRY. LOCATE BOLT WITHIN MIDDLE THIRD OF PLATE WIDTH. 3. FOR 130 MPH WIND ZONES INSTALL 1/2" ANCHOR BOLTS 4'-0" O.C. AND WITHIN 1'-0" FROM END OF EACH CORNER, ANCHOR BOLTS MUST EXTEND A MINIMUM OF 7" INTO CONCRETE OR 15" INTO MASONRY. LOCATE BOLT WITHIN MIDDLE THIRD OF PLATE WIDTH. 4. MEAN ROOF HEIGHT IS LESS THAN 30 FEET. 5. EXTERIOR WALLS DESIGNED FOR 120 OR 130 MPH WINDS. 6. INSTALL 7/16" OSB SHEATHING ON ALL EXTERIOR WALLS OF ALL STORIES IN ACCORDANCE WITH SECTION R602.10.3 OF THE NCRC, 2018 EDITION. 7. ENERGY EFFICIENCY COMPLIANCE AND INSULATION VALUES OF THE BUILDING TO BE IN ACCORDANCE WITH CHAPTER 11 OF THE NCRC, 2018 EDITION. FINISHED GRADE— FINISHED GRADE—

GARAGE CURB DETAIL

1'-4"

TYPICAL SLAB DETAIL

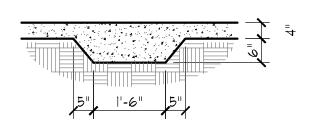

__2 x 4 OR 2 x 6 STUD

__2 x 4 OR 2 x 6 STUD

FRAMING

SIDING AS SPEC.

STARTER STRIP-

SIDING AS SPEC.

SHEATHING-

STARTER STRIP-

SHEATHING-

-2 x TRTD. BOTTOM PLATE(S) SECURED AND

-4" CONCRETE SLAB

W/ FIBER REINFORCING

6 MIL. VAPOR BARRIER

-2 x TRTD. BOTTOM PLATE(S) SECURED AND

-4" CONCRETE SLAB

-6 MIL. VAPOR BARRIER


W/ FIBER REINFORCING


SEE 120 MPH OR 130 MPH ULTIMATE WIND DESIGN NOTES FOR DETAILS

SEE 120 MPH OR 130 MPH ULTIMATE

WIND DESIGN NOTES FOR DETAILS

THICKENED SLAB DETAIL

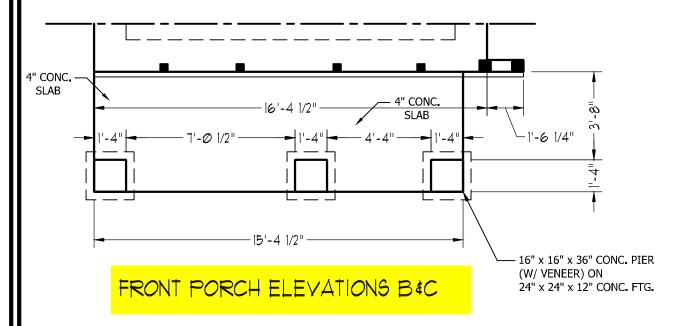

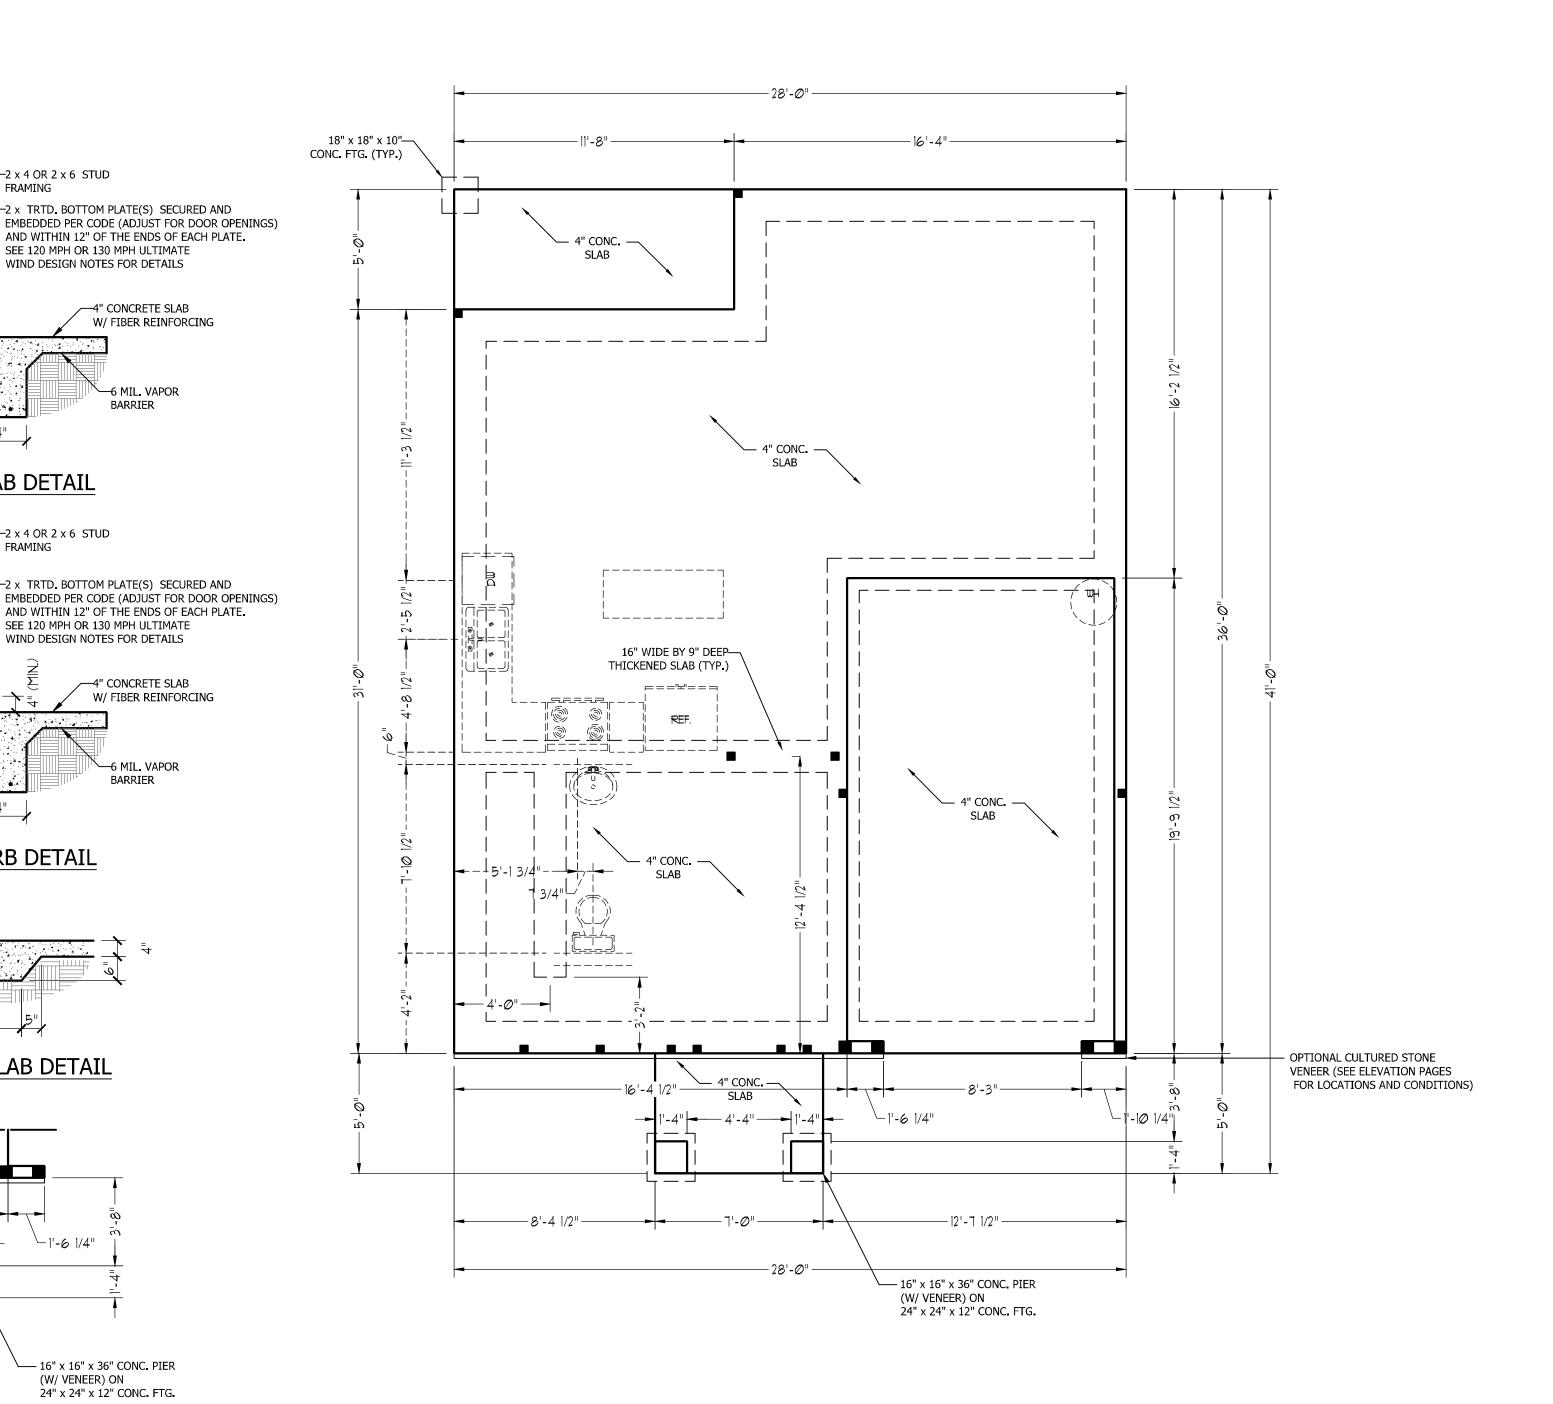



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ENGINEERED BY:

REVIEWED BY:


MONO SLAB **FOUNDATION** PLAN

S-1

MASONRY STEM WALL SPECIFICATIONS							
WALL HEIGHT	MASONRY WALL TYPE						
(FEET)	8" CMU	4" BRICK AND 4" CMU	4" BRICK AND 8" CMU	12" CMU			
2' OR LESS	UNGROUTED	GROUT SOLID	UNGROUTED	UNGROUTED			
3'	UNGROUTED	GROUT SOLID	UNGROUTED	UNGROUTED			
4'	GROUT SOLID	GROUT SOLID w/ #4 REBAR @ 48" O.C.	GROUT SOLID	GROUT SOLID w/ #4 REBAR @ 64" O.C			
5'	GROUT SOLID w/ #4 REBAR @ 36" O.C.	N/A	GROUT SOLID w/ #4 REBAR @ 36" O.C.	GROUT SOLID w/ #4 REBAR @ 64" O.C			
6'	GROUT SOLID w/ #4 REBAR @ 24" O.C.	N/A	GROUT SOLID w/ #4 REBAR @ 24" O.C.	GROUT SOLID w/ #4 REBAR @ 64" O.C			
7' OR MORE		ENGINEERED BASED	ON SITE CONDITIONS				

ULTIMATE DESIGN WIND SPEED NOTES FOR LESS THAN 30' MEAN ROOF HEIGHT:


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- 2. FOR 120 MPH WIND ZONES INSTALL 1/2" ANCHOR BOLTS 6'-0" O.C. AND WITHIN 1'-0" FROM END OF EACH CORNER. ANCHOR BOLTS MUST EXTEND A MINIMUM OF 7" INTO CONCRETE OR 15" INTO MASONRY. LOCATE BOLT WITHIN MIDDLE THIRD OF PLATE WIDTH.
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- 4. MEAN ROOF HEIGHT IS LESS THAN 30 FEET.
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- 6. INSTALL 7/16" OSB SHEATHING ON ALL EXTERIOR WALLS OF ALL STORIES IN ACCORDANCE WITH SECTION R602.10.3 OF THE NCRC, 2018 EDITION.
- 7. ENERGY EFFICIENCY COMPLIANCE AND INSULATION VALUES OF THE BUILDING TO BE IN ACCORDANCE WITH CHAPTER 11 OF THE NCRC, 2018 EDITION.

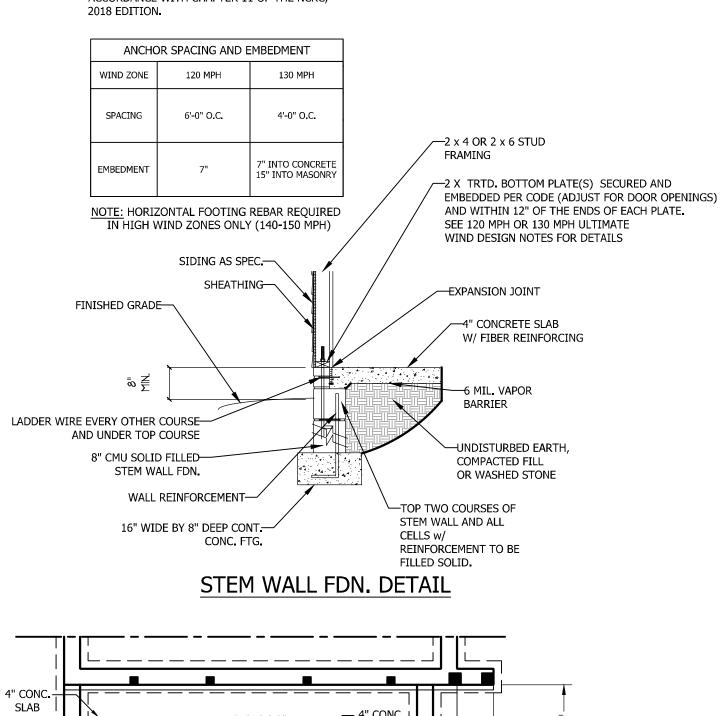

- 16" x 16" x 36" CONC. PIER (W/ VENEER) ON 24" x 24" x 12" CONC. FTG.

STRUCTURAL NOTES:

- 1. TABLE ABOVE APPLIES TO HOUSE FOUNDATION ONLY. TABLE DOES NOT APPLY TO GARAGE FOUNDATION NOT COMMON TO HOUSE.
- 2. TIE MULTIPLE WYTHES TOGETHER WITH LADDER WIRE @ 16" O.C. VERTICALLY.
- 3. WALL HGT. IS MEASURED FROM TOP OF FOOTING TO TOP OF WALL.
- 4. PREP SLAB PER R506.2.1 AND R505.2.2 BASE AND EXCEPTION OF THE 2018 NCRC
- MINIMUM 24" LAP SPLICE LENGTH.
 BACKFILL OF CLEAN #57/ #67 WASHED STONE IS PERMITTED.
- 7. BACKFILL OF WELL DRAINED SAND-GRAVEL MIXTURE SOILS (45 PSF/FT BELOW GRADE) CLASSIFIED AS GROUP 1 ACCORDING TO UNIFIED SOILS CLASSIFICATION SYSTEM IN ACCORDANCE WITH TABLE R405.1 OF THE 2018 NCRC ARE ALLOWABLE.
- 8. LOCATE REBAR IN CENTER OF FOUNDATION WALL.
- 9. WHERE REQUIRED, FILL BLOCK SOLID WITH TYPE "S" MORTAR OR 3000 PSI GROUT. USE OF "LOW LIFT GROUTING" METHOD REQUIRED WHEN FILLING WALLS WITH GROUT AT HEIGHTS OF 5' AND GREATER.

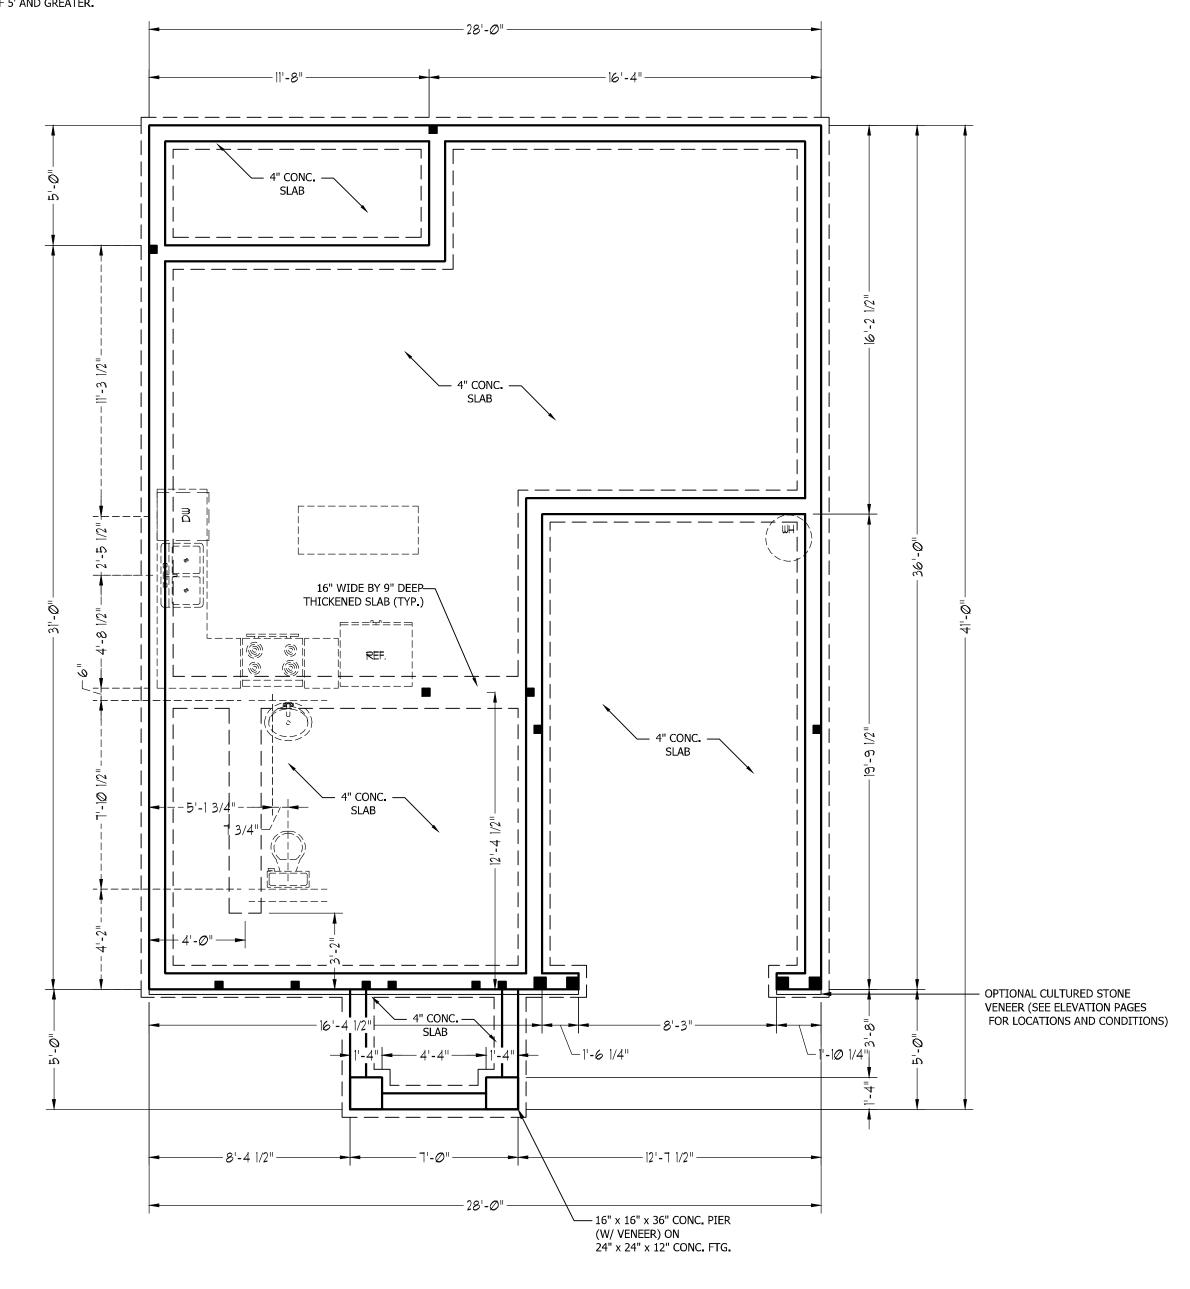



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DRAWN BY: WG

ENGINEERED BY:

REVIEWED BY:

STEMWALL SLAB FOUNDATION PLAN

S-1

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FRONT PORCH ELEVATIONS B&C

STRUCTURAL NOTES:

- 1. ALL FRAMING LUMBER TO BE SPF #2 (UNO). ALL TREATED LUMBER TO BE SYP #2
- 2. ALL LOAD BEARING HEADERS TO BE (2) 2 x 6 (UNO).
- 3. INSTALL AN EXTRA JOIST UNDER WALLS PARALLEL TO FLOOR JOISTS
- 4. WINDOW AND DOOR HEADERS TO BE SUPPORTED w/ (1) JACK STUD AND (1) KING STUD EA. END (UNO.). SEE TABLE R602.7.5 FOR ADDITIONAL KING STUD REQUIREMENTS.
- 5. SQUARES DENOTE POINT LOADS WHICH REQUIRE SOLID BLOCKING TO GIRDER OR FOUNDATION. ALL SQUARES TO BE (2) STUDS (UNO.)
- 6. ALL 4 X 4 POSTS SHALL BE ANCHORED TO SLABS W/ SIMPSON ABU44 POST BASES (OR EQUAL) AND 6 X 6 POSTS W/ ABU66 POST BASES (OR EQUAL) (UNO). ALL 4 X 4 AND 6 X 6 POSTS TO BE INSTALLED WITH 700 LB CAPACITY UPLIFT CONNECTORS AT TOP (UNO.)
- 7. FOR FIBERGLASS, ALUMINUM, OR COLUMN ENG. BY OTHERS, SECURE TO SLAB W/
 (2) METAL ANGLES USING 2" CONC. SCREWS. FASTEN ANGLES TO COLUMNS W/
 1/4" THROUGH BOLTS W/ NUTS AND WASHERS. LOCATE ANGLES ON OPPOSITE
 SIDES OF COLUMN. THROUGH BOLTS MUST BE INSTALLED PRIOR TO SETTING
 COLUMN.

BRACE WALL PANEL NOTES:


EXTERIOR WALLS: ALL EXTERIOR WALLS TO BE SHEALTHED WITH CS-WSP OR CS-SFB IN ACCORDANCE WITH SECTION R602.10.3 UNLESS NOTED OTHERWISE.


REQUIRED LENGTH OF BRACING: REQUIRED BRACE WALL LENGTH FOR EACH SIDE OF THE CIRCUMSCRIBED RECTANGLE ARE INTERPOLATED PER TABLE R602.10.3. METHODS CS-WSP AND CS-SFB CONTRIBUTE THIER ACTUAL LENGTH. METHOD GB CONTRIBUTES 0.5 ITS ACTUAL LENGTH. METHOD PF CONTRIBUTES 1.5 TIMES ITS ACTUAL LENGTH.

GYPSUM: ALL INTERIOR SIDES OF EXTERIOR WALLS AND BOTH SIDES OF INTERIOR WALLS TO HAVE 1/2" GYPSUM INSTALLED. WHEN NOT USING METHOD GB GYPSUM TO BE FASTENED PER TABLE R702.3.5. METHOD GB TO BE FASTENED PER TABLE R602.10.1.

HD: 800 LBS HOLD DOWN DEVICE FASTENED TO THE EDGE OF THE BRACE WALL PANEL NEAREST TO THE CORNER

METHODS: PER TABLE R602.10.1

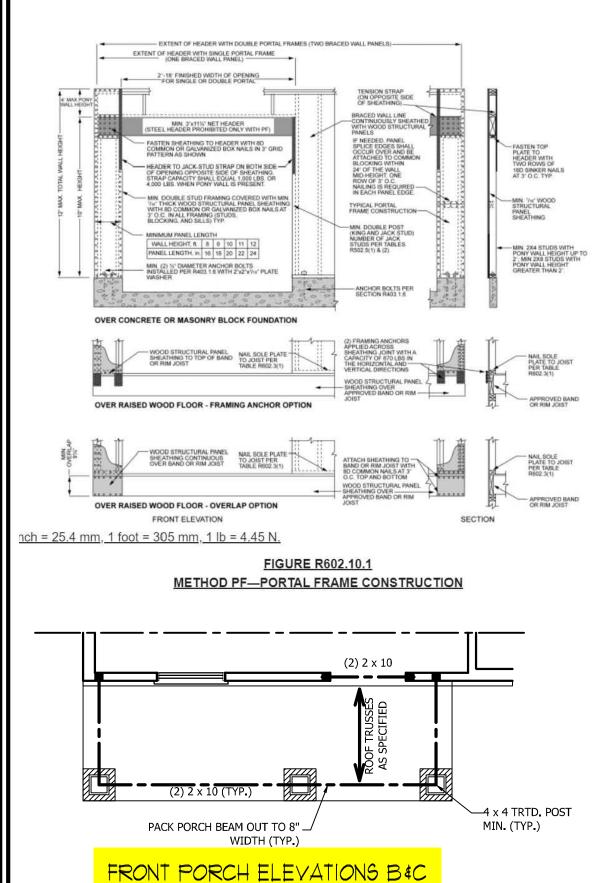

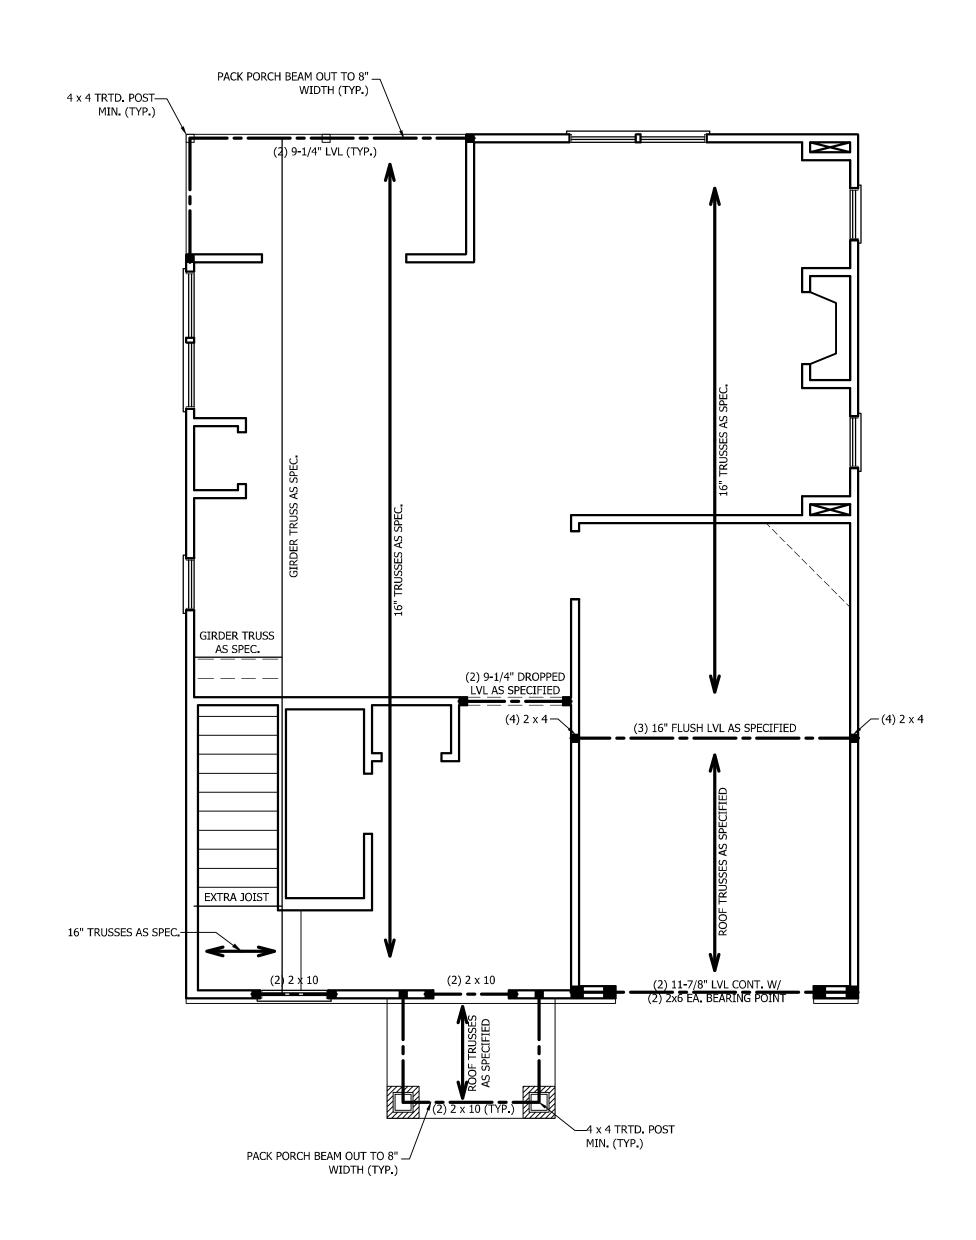



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WEAVER HOMES
CAROLINA COLLECTIO
POPLAR DRIVE RIGHT

DATE: JULY 22, 2020

REV.:

SCALE: 1/4" = 1'-0"

DRAWN BY: WG

ENGINEERED BY: REVIEWED BY:

SECOND FLOOR FRAMING PLAN

S-2


TABLE R602.7.5 MINIMUM NUMBER OF FULL HEIGHT STUDS AT EACH END OF HEADERS IN EXTERIOR WALLS

HEADER SPAN (FEET)	MAXIMUM STUD SPACING (INCHES) (PER TABLE R602.3(5)				
(1 = 1)	16	24			
UP TO 3'	1	1			
4'	2	1			
8'	3	2			
12'	5	3			
16'	6	4			

STRUCTURAL NOTES:

- 1. ALL FRAMING LUMBER TO BE SPF #2 (UNO). ALL TREATED LUMBER TO BE SYP #2 (UNO.)
- 2. ALL LOAD BEARING HEADERS TO BE (2) 2 x 6 (UNO).
- 3. WINDOW AND DOOR HEADERS TO BE SUPPORTED w/ (1) JACK STUD AND (1) KING STUD EA. END (UNO.). SEE TABLE R602.7.5 FOR ADDITIONAL KING STUD REQUIREMENTS.
- 4. SQUARES DENOTE POINT LOADS WHICH REQUIRE SOLID BLOCKING TO GIRDER OR FOUNDATION. ALL SQUARES TO BE (2) STUDS (UNO.)

DSP - DOUBLE STUD POCKET TSP - TRIPLE STUD POCKET

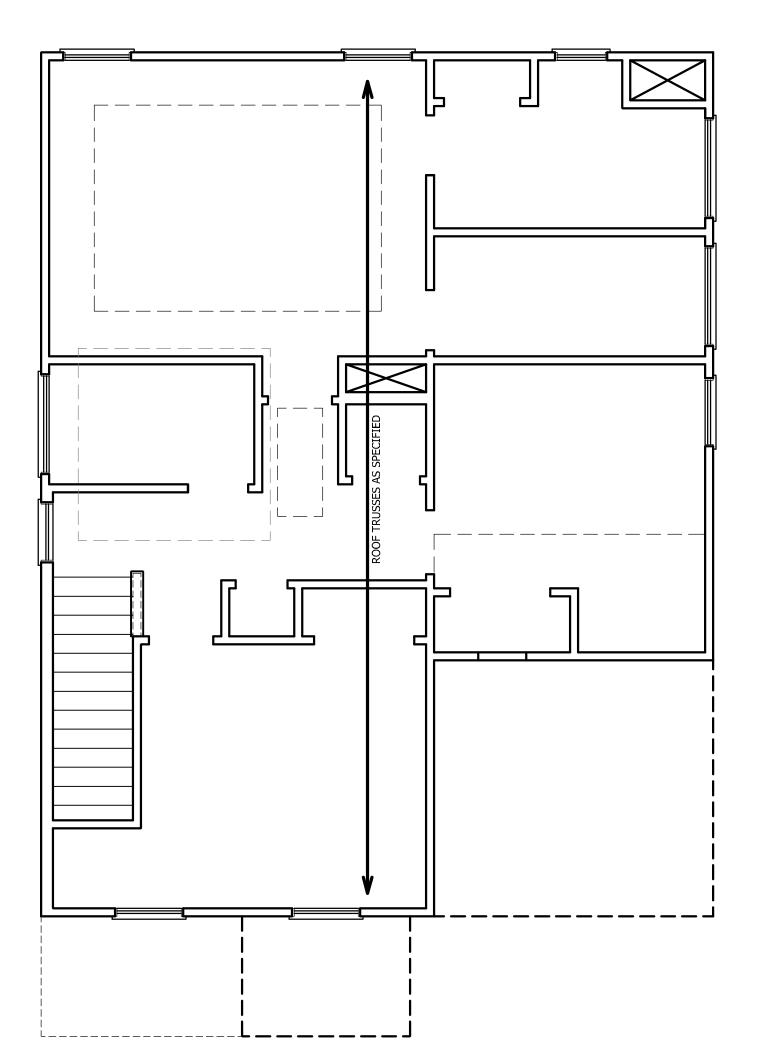



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RALEIGH, NC 27612

(919) 649-4128

WWW.RRDCAROLINA.COM

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DATE: JULY 22, 2020

REV.:

SCALE: 1/4" = 1'-0"

DRAWN BY: WG

ENGINEERED BY:
REVIEWED BY:

. ____

ATTIC FLOOR FRAMING PLAN

S-3

STRUCTURAL NOTES:


- 1. ALL FRAMING LUMBER TO BE #2 SPF (UNO).
- 2. HIP SPLICES ARE TO BE SPACED A MIN. OF 8'-0". FASTEN MEMBERS WITH THREE ROWS OF 12d NAILS @ 16" O.C. (TYP.)
- 3. STICK FRAME OVER-FRAMED ROOF SECTIONS W/ 2 x 8 RIDGES, 2 x 6 RAFTERS @ 16" O.C. AND FLAT 2 x 10 VALLEYS OR USE VALLEY TRUSSES.
- 4. FASTEN FLAT VALLEYS TO RAFTERS OR TRUSSES WITH SIMPSON H2.5A HURRICANE TIES @ 32" O.C. MAX. PASS HURRICANE TIES THROUGH NOTCH IN ROOF SHEATHING. EACH RAFTER IS TO BE FASTENED TO THE FLAT VALLEY WITH A MIN. OF (6) 12d TOE NAILS.
- 5. REFER TO SECTION R802.11 OF THE 2018 NCRC FOR REQUIRED UPLIFT RESISTANCE AT RAFTERS AND TRUSSES.


ATTIC VENT CALCULATION:

1218 SQ. FT. OF ATTIC DIVIDED BY 150 REQUIRES 8.1 SQ. FT. OF NET FREE VENTILATING AREA (MIN.).

ATTIC VENT CALCULATION:

1180 SQ. FT. OF ATTIC DIVIDED BY 150 REQUIRES 7.9 SQ. FT. OF NET FREE VENTILATING AREA (MIN.).

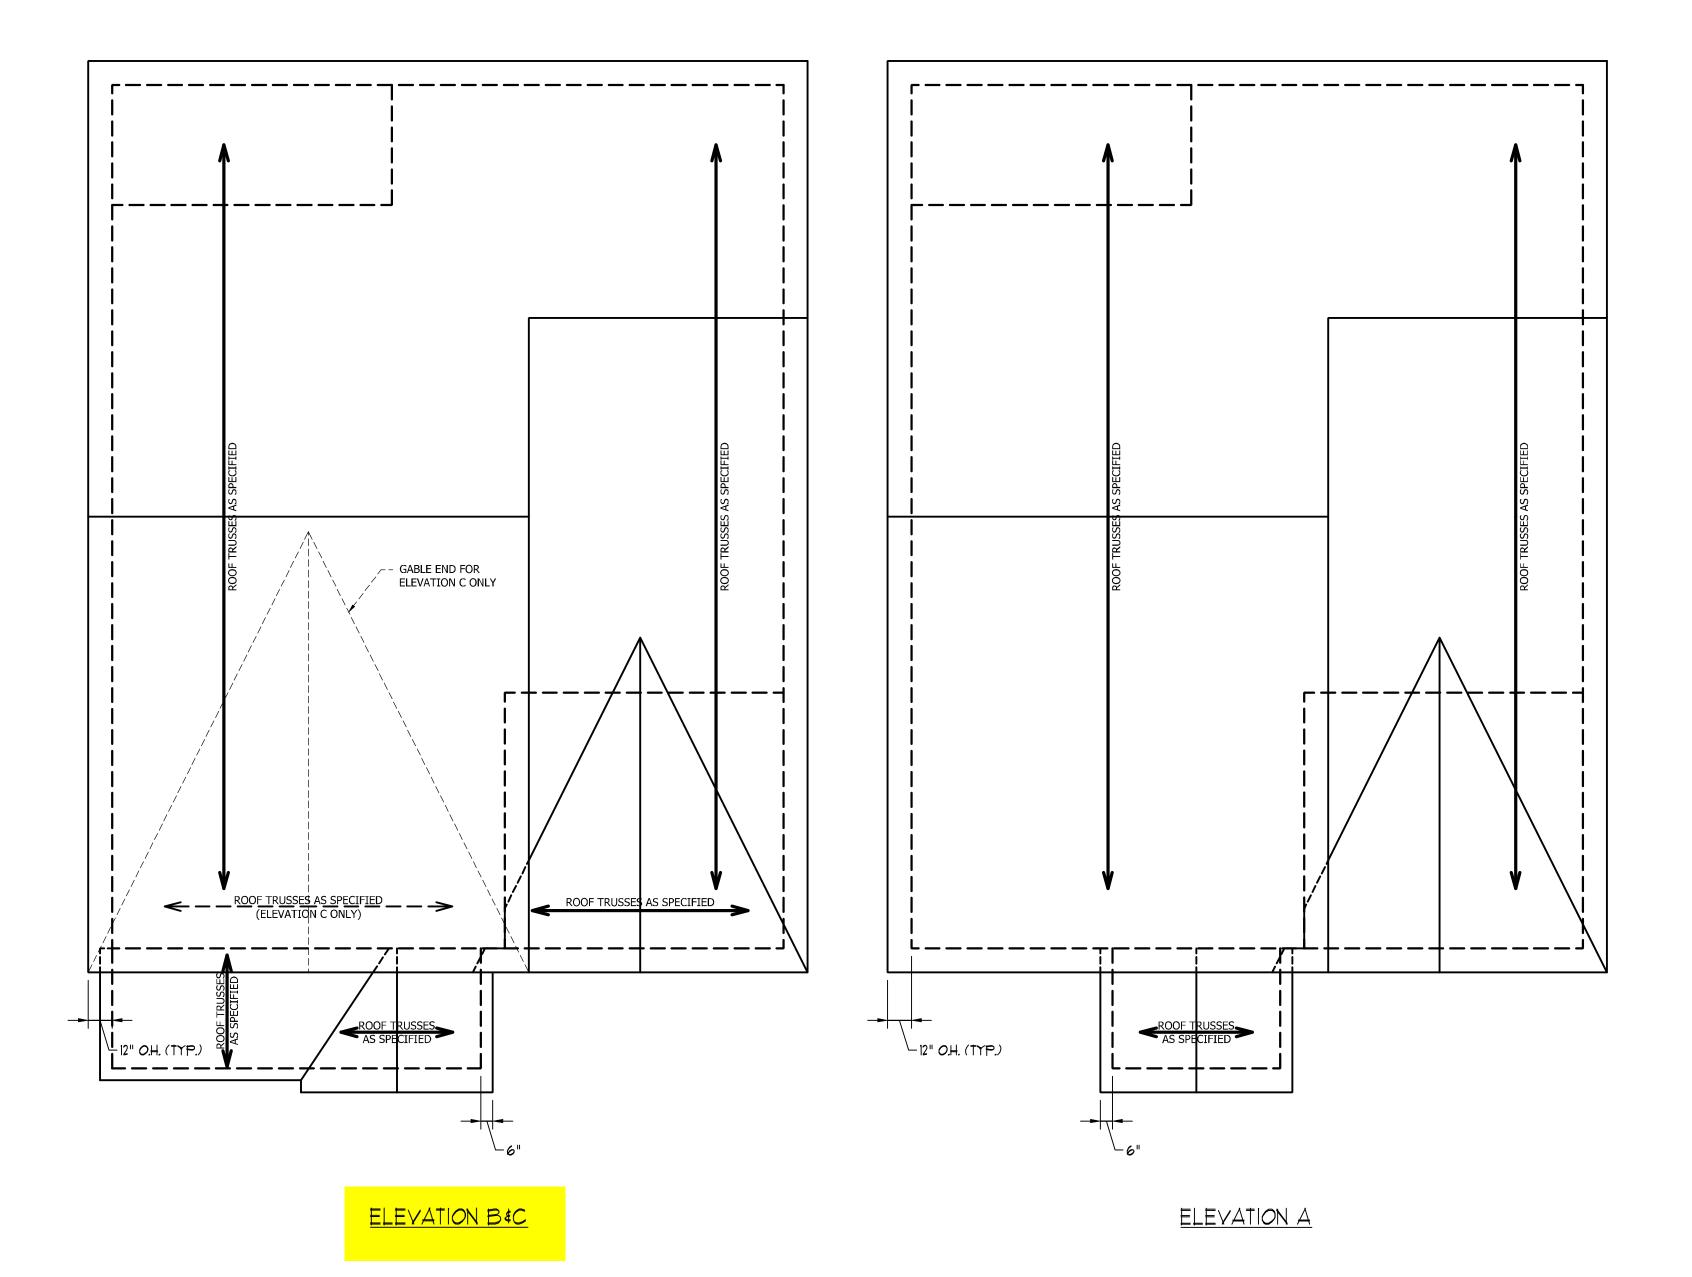

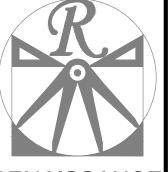

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POPLAR DRIVE RIGHT

DATE: JULY 22, 2020

REV.:

SCALE: 1/4" = 1'-0"


DRAWN BY: WG
ENGINEERED BY:

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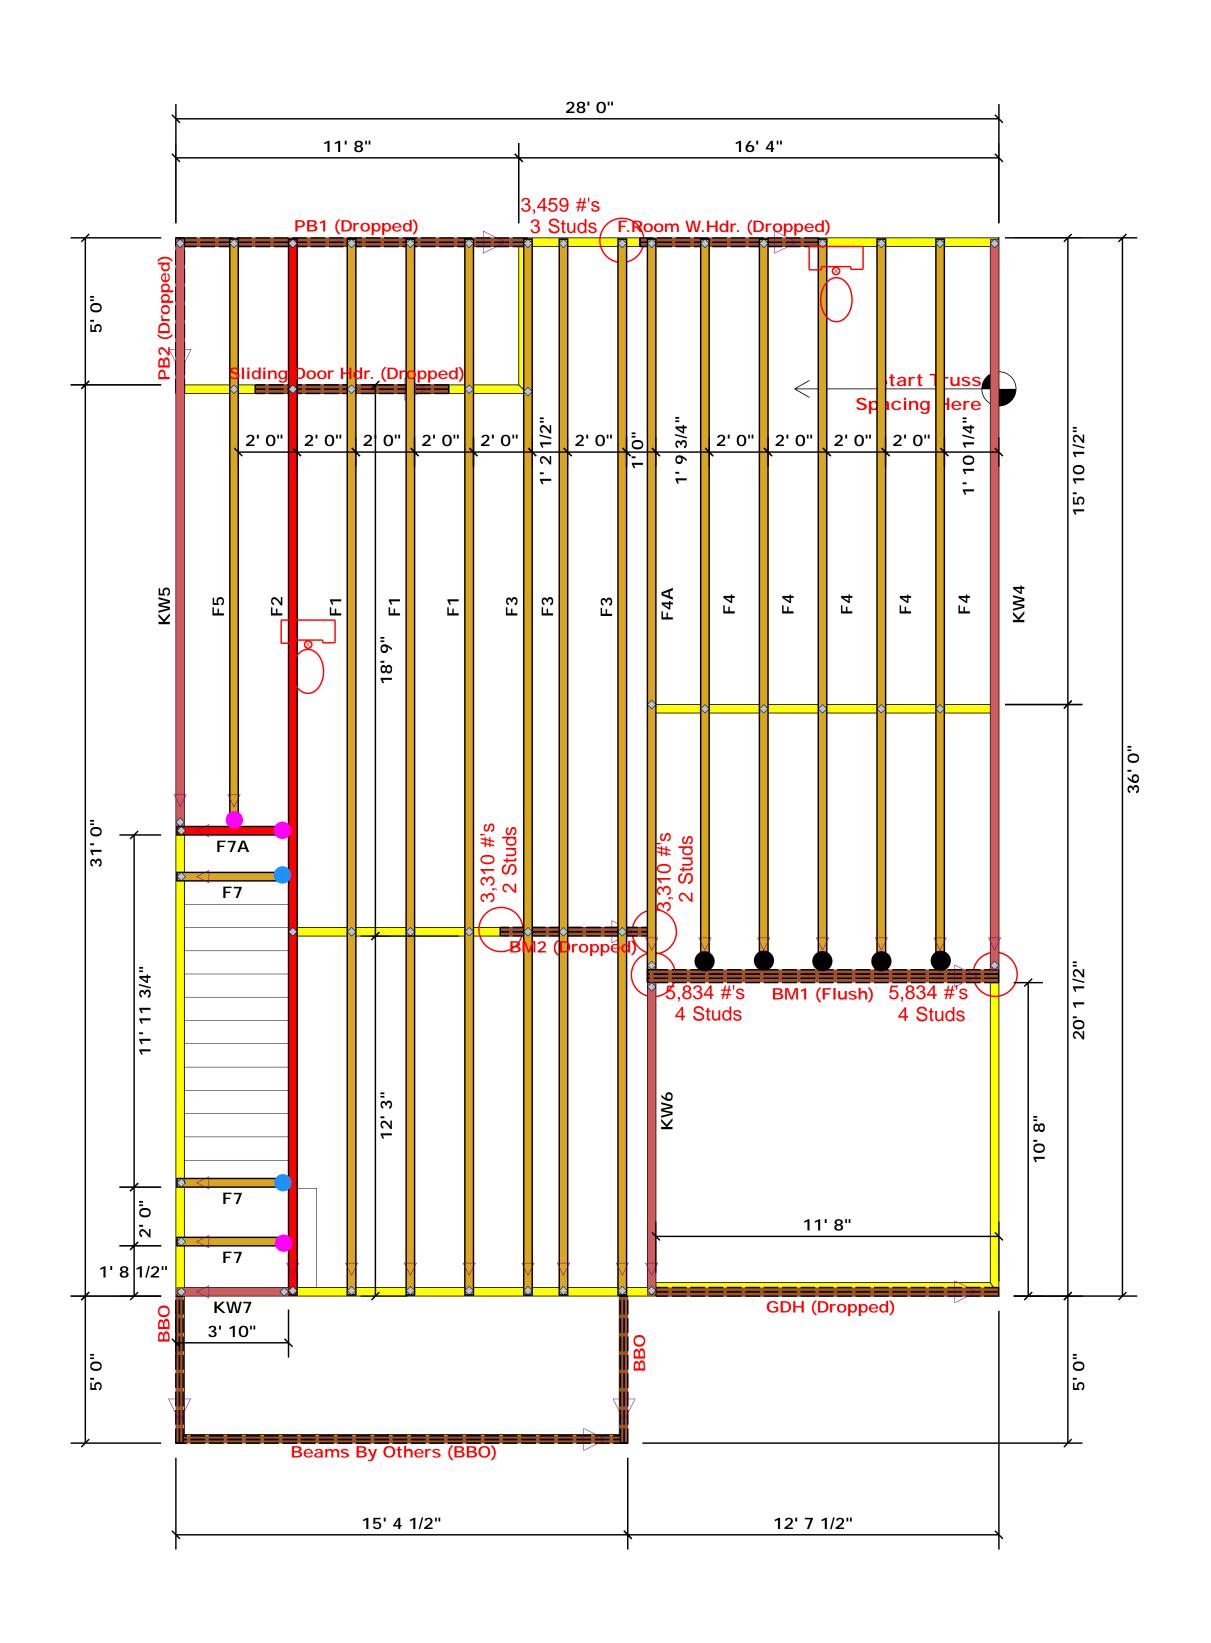
ROOF PLANS


S-4

C:\Users\Wade\Documents\Projects\Westan-Weaver\Poplar_GR_7-22-20.dwg, 7/24/2020 6:37:53 AM

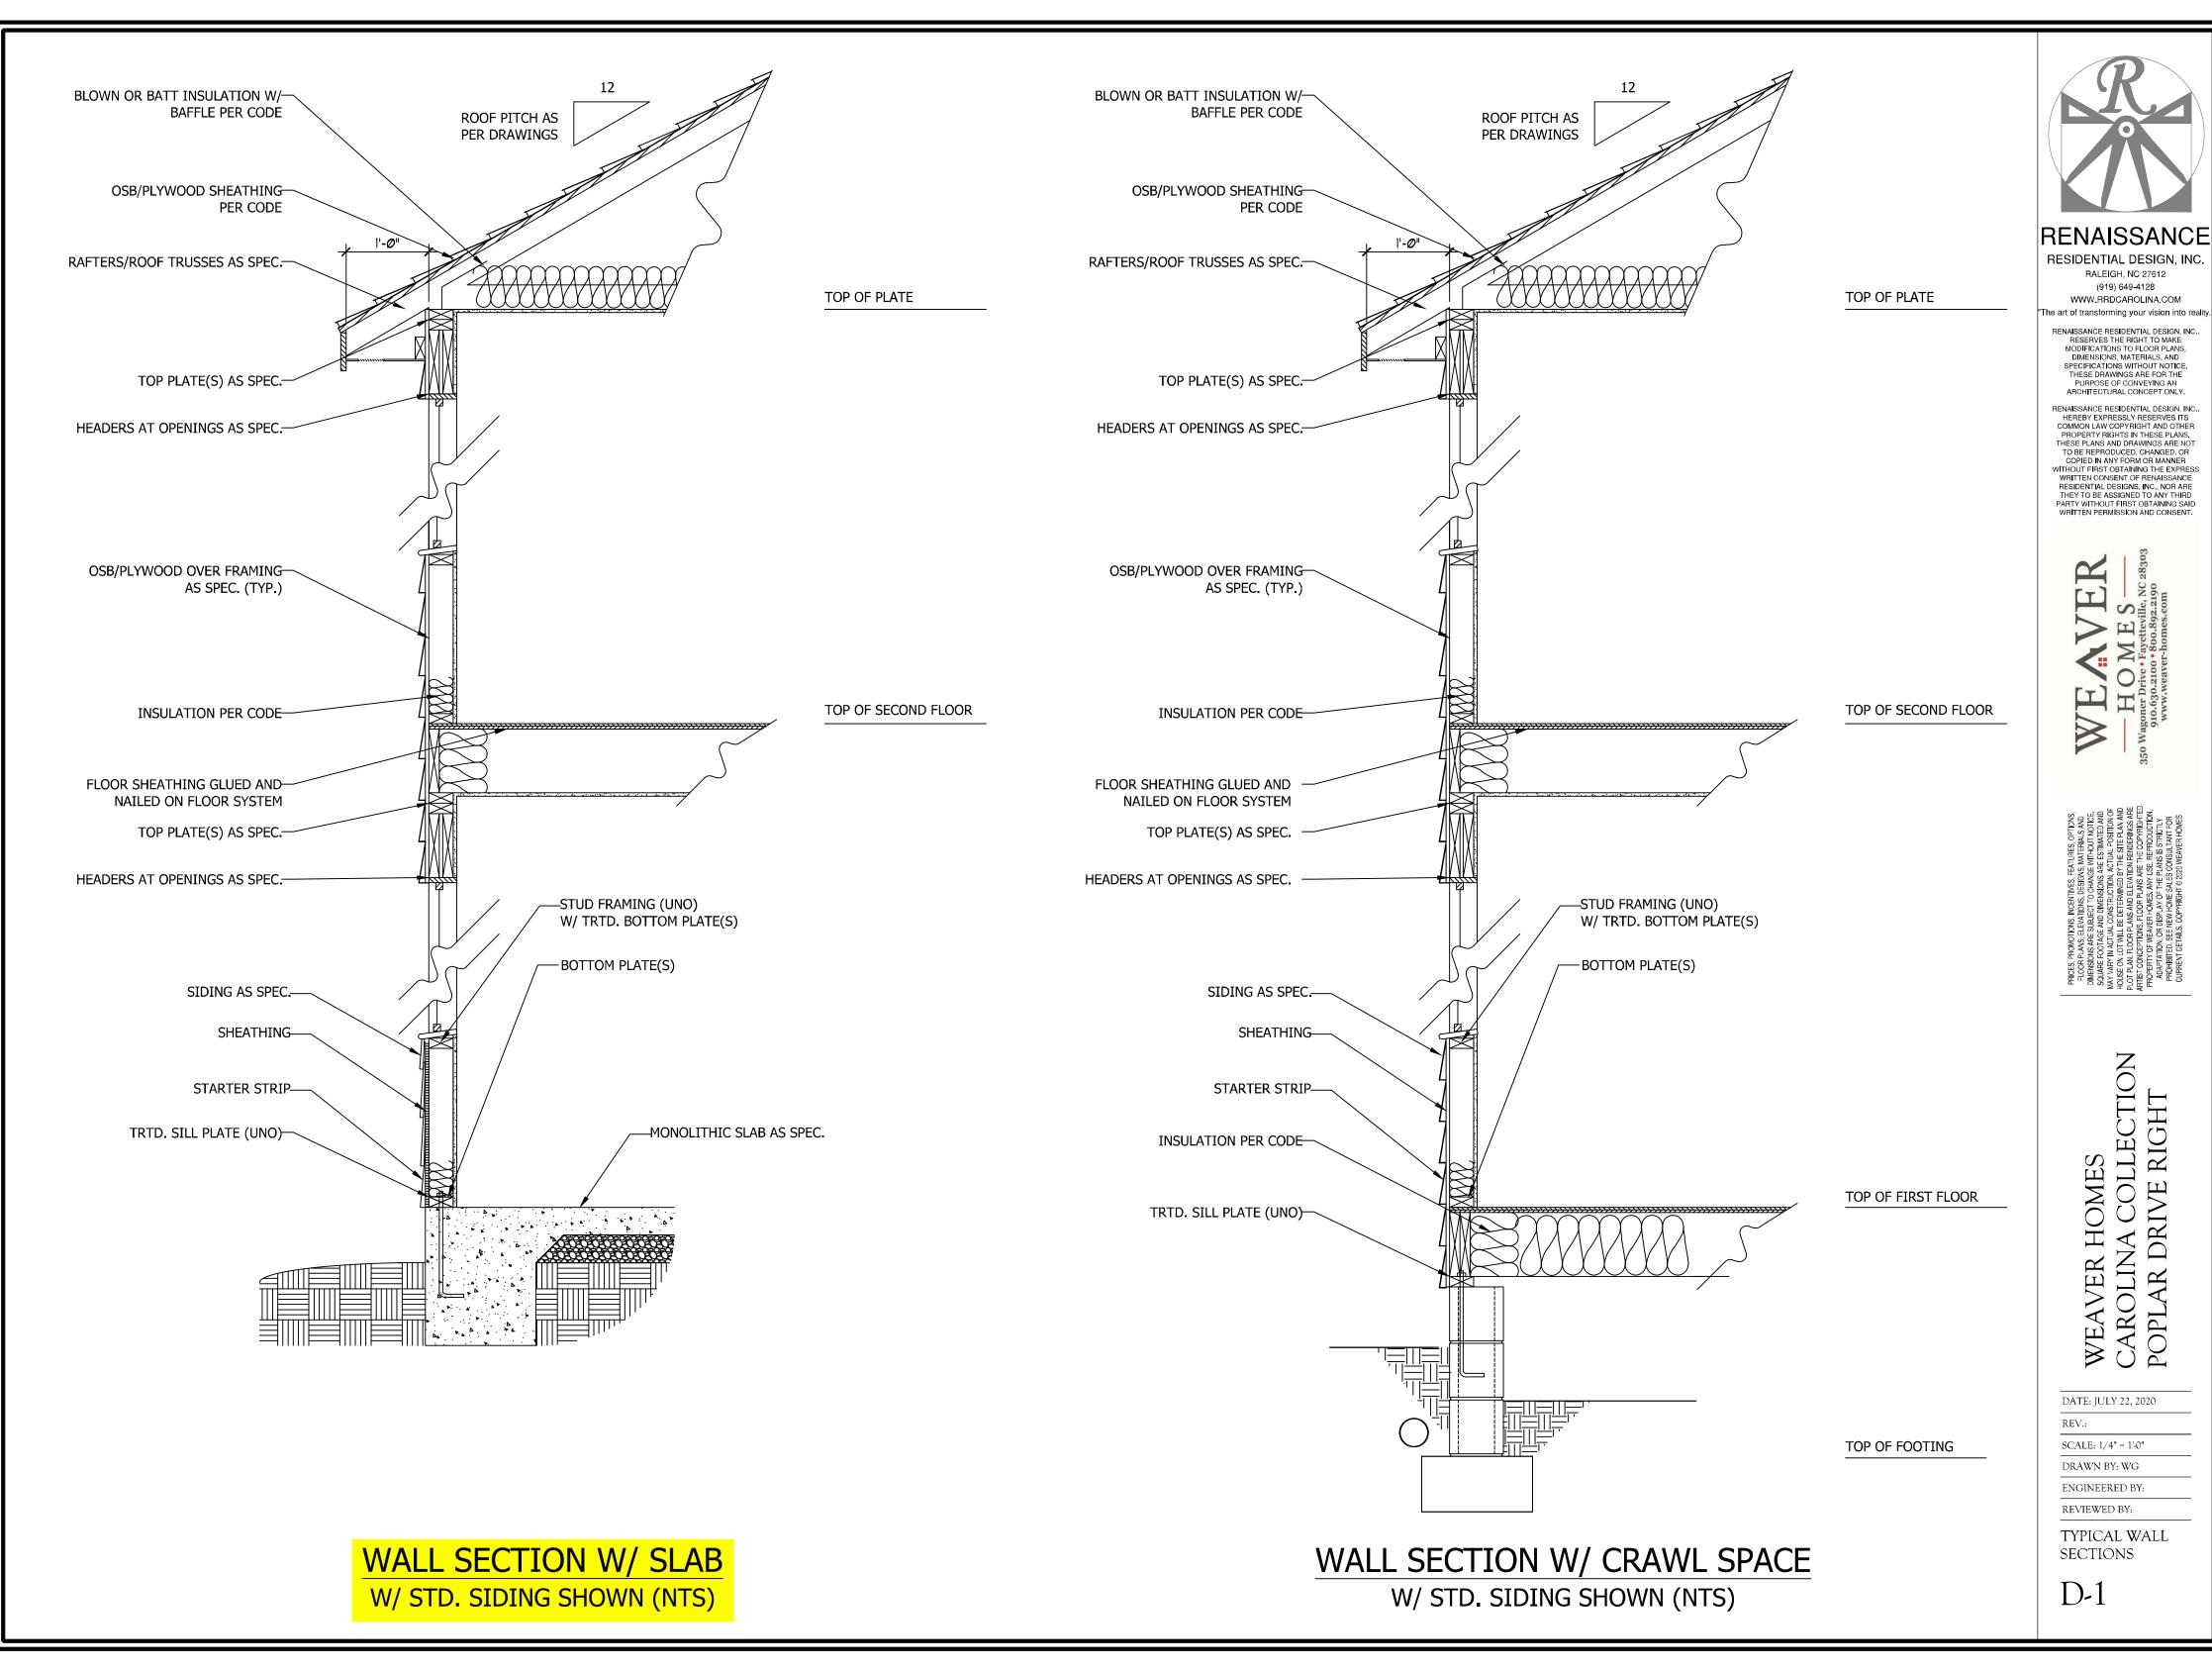

C:\Users\Wade\Documents\Projects\Westan-Weaver\Poplar_GR_7-22-20.dwg, 7/24/2020 6:37:53 AM



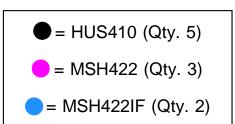

Truss Placement Plan SCALE: NTS

▲= Denotes Left End of Truss (Reference Engineered Truss Drawing)

		Products			
PlotID	Length	Product	Plies	Net Qty	Fab Type
PB1 (Dropped)	12' 0"	1-3/4"x 9-1/4" LVL Kerto-S	2	2	FF
F.Room W.Hdr. (Dropped)	7' 0"	1-3/4"x 9-1/4" LVL Kerto-S	2	2	FF
Sliding Door Hdr. (Dropped)	7' 0"	1-3/4"x 9-1/4" LVL Kerto-S	2	2	FF
BM2 (Dropped)	6' 0"	1-3/4"x 9-1/4" LVL Kerto-S	2	2	FF
PB2 (Dropped)	6' 0"	1-3/4"x 9-1/4" LVL Kerto-S	2	2	FF
GDH (Dropped)	12' 0"	1-3/4"x 11-7/8" LVL Kerto-S	2	2	FF
BM1 (Flush)	12' 0"	1-3/4"x 16" LVL Kerto-S	3	3	FF

than 3,000 lbs. Unless Noted Otherwise.

-- Denotes Reaction Greater than 3,000 lbs. Reaction / # of Studs

All Truss Reactions are Less


LO.	AD 6	CHART FO	RJ	ACK STUD	5		
(04555 ON) ABLES 8502 5(1) & (6))							
NU	NN(2.0	» заскатива а	(cyura	CO @ CA CNO OF			
		PEAGER/8	ERDE				
END REACTION (OT FU)	SEC DISTURS FOR CORN HEADER	SND PENCTION CAT ALL	MEQUE STUDS FOR COPAN - EMBER	END SURCESON (OT 10)	PEQD STUDS FOR (4) M.Y HEADER		
1700	1	2550	1	3400	1		
3400	2	5100	2	6600	2		
5100	3	7650	3	10200	3		
6800	4	10200	4	13600	4		
8500	5	12750	5	17000	5		
10200	6	15300	6				
11900	7						
13600	8						
15200							


					_
	BUILDER	Weaver Development	CITY / CO.	Sanford / Harnett	t
	JOB NAME	Lot 5 West Park	ADDRESS	173 West Park Lane	i t
	PLAN	Poplar Elev. C	MODEL	Floor	E
	SEAL DATE	Seal Date	DATE REV.	/ /	f t
	QUOTE #	Quote #	DRAWN BY	Christine Shivy	r
-	JOB#	J0921-5309	SALES REP.	Lenny Norris	

THIS IS A TRUSS PLACEMENT DIAGRAM ONLY.

соттесн **ROOF & FLOOR TRUSSES & BEAMS**

Reilly Road Industrial Park Fayetteville, N.C. 28309 Christine Shivy Phone: (910) 864-8787 Fax: (910) 864-4444 **Christine Shivy**

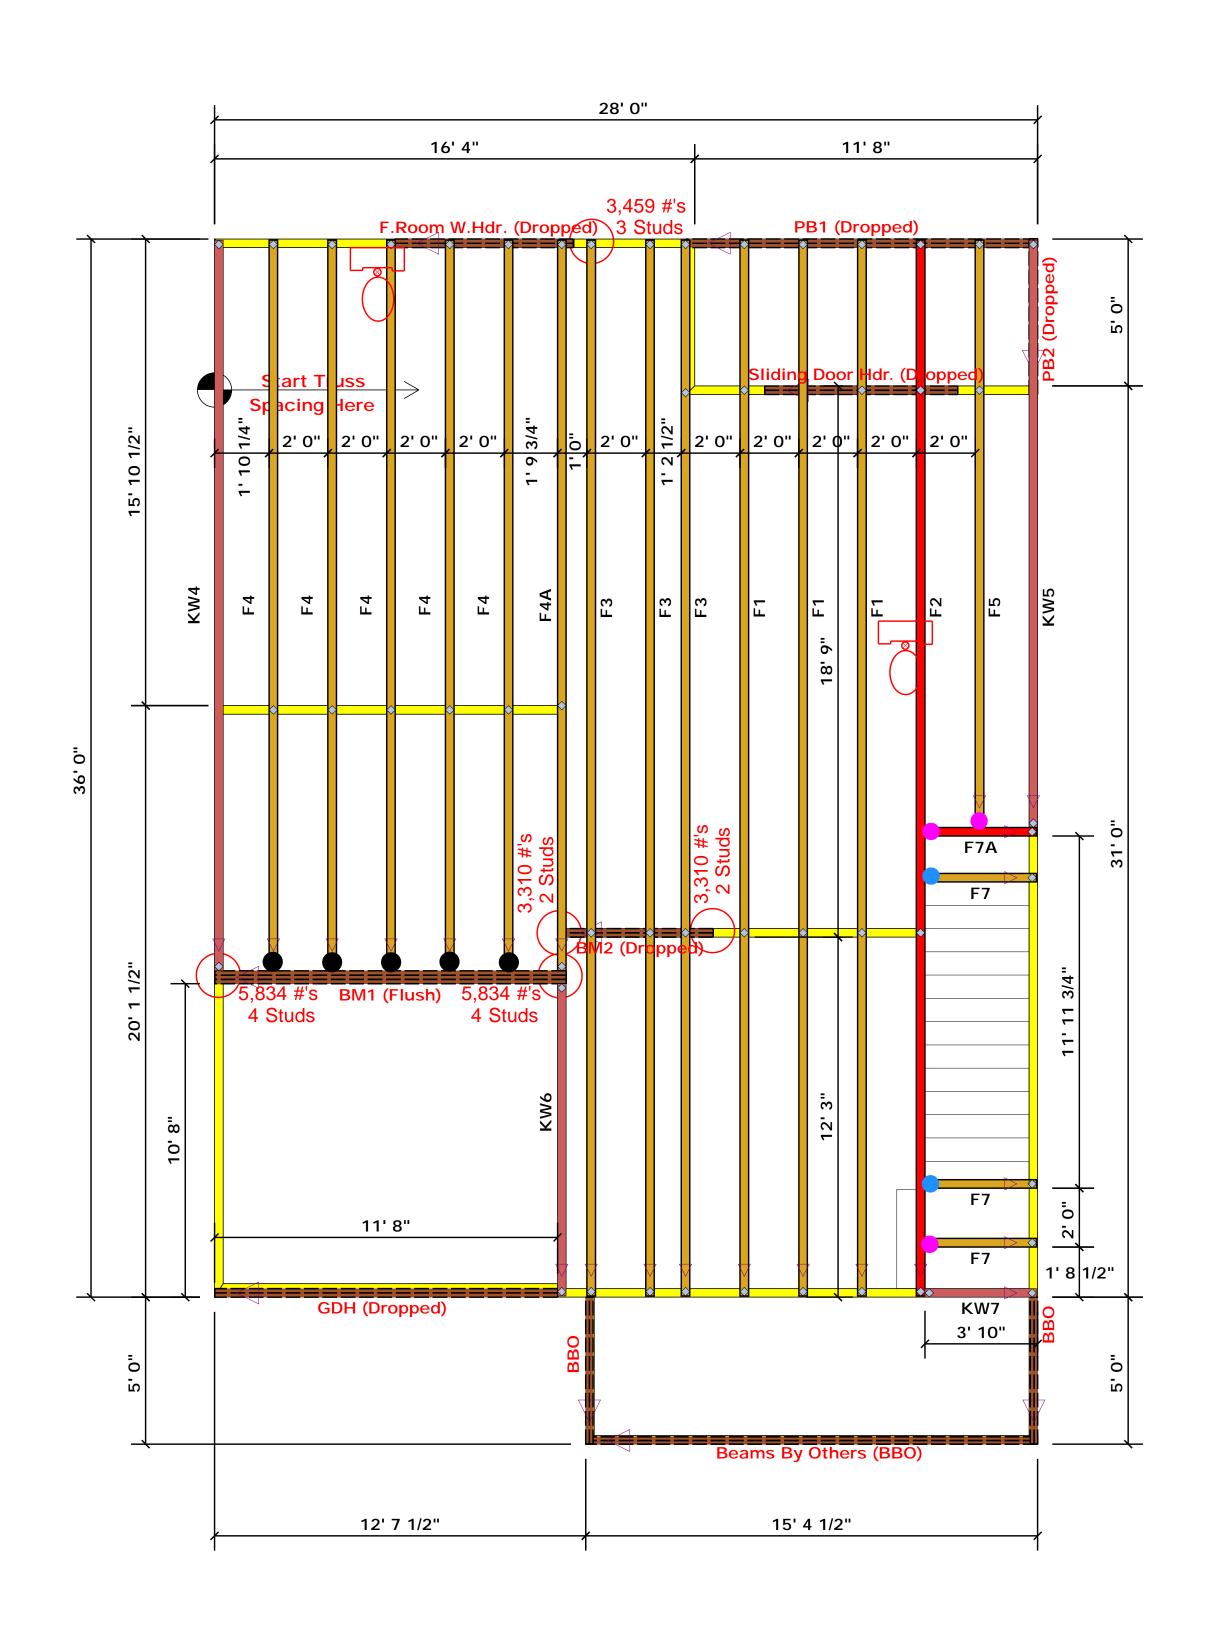

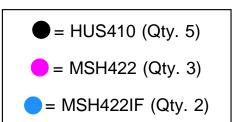

Truss Placement Plan SCALE: NTS

▲= Denotes Left End of Truss (Reference Engineered Truss Drawing)

		Products			
PlotID	Length	Product	Plies	Net Qty	Fab Type
PB1 (Dropped)	12' 0"	1-3/4"x 9-1/4" LVL Kerto-S	2	2	FF
F.Room W.Hdr. (Dropped)	7' 0"	1-3/4"x 9-1/4" LVL Kerto-S	2	2	FF
Sliding Door Hdr. (Dropped)	7' 0"	1-3/4"x 9-1/4" LVL Kerto-S	2	2	FF
BM2 (Dropped)	6' 0"	1-3/4"x 9-1/4" LVL Kerto-S	2	2	FF
PB2 (Dropped)	6' 0"	1-3/4"x 9-1/4" LVL Kerto-S	2	2	FF
GDH (Dropped)	12' 0"	1-3/4"x 11-7/8" LVL Kerto-S	2	2	FF
BM1 (Flush)	12' 0"	1-3/4"x 16" LVL Kerto-S	3	3	FF


than 3,000 lbs. Unless Noted Otherwise. -- Denotes Reaction Greater than 3,000 lbs.

All Truss Reactions are Less

Reaction / # of Studs

_	LO.	AD 6	CHAI	RT FO	RЈ	ACK	STUD	5
	(045Fb ON 1 ABLES R502 5(1) & (b))							
	No	NHER O		STUDG 8			A END OF	
				HEADER/6	1806			
	END REACTION (OT FU)	RECIDENTES FOR		SNE PEACTION (AF AL)	REQ15 STUDS FOR CIPAN FEMORE		END REACTION (OF FO)	REQ'D STUDS FUR (4) R/Y HEADER
	1700	1		2550	1		3400	1
	3400	2		5100	2		6600	2
	5100	3		7650	3		10200	3
	6800	4		10200	4		13600	4
	8500	5		12750	5		17000	5
	10200	á		15300	6			
	11900	7						
	13600	8						
	15200							

	BUILDER	Weaver Development	CITY / CO.	Sanford / Harnett	THIS IS A TRUSS PLACEMENT DIAGRAM ONLY. These trusses are designed as individual building components the building design at the specification of the building designer sheets for each truss design identified on the placement drawing the statement drawing the statem
	JOB NAME	Lot 5 West Park	ADDRESS	173 West Park Lane	is responsible for temporary and permanent bracing of the roof the overall structure. The design of the truss support structure walls, and columns is the responsibility of the building designe regarding bracing, consult BCSI-B1 and BCSI-B3 provided with
talen l	PLAN	Poplar Elev. C	MODEL	Floor	or online @ sbcindustry.com Bearing reactions less than or equal to 3000# are deemer prescriptive Code requirements. The contractor shall refe
	SEAL DATE	Seal Date	DATE REV.	/ /	(derived from the prescriptive Code requirements) to de foundation size and number of wood studs required to su than 3000# but not greater than 15000#. A registered desibe retained to design the support system for any reaction
	QUOTE #	Quote #	DRAWN BY	Christine Shivy	specified in the attached Tables. A registered design prof retained to design the support system for all reactions the
-	JOB#	J0921-5309	SALES REP.	Lenny Norris	SignatureChristine Shi

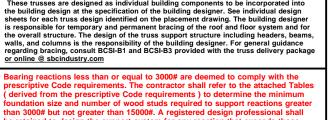

Christine Shivy

Christine Shivy

ROOF & FLOOR TRUSSES & BEAMS Reilly Road Industrial Park

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