
LOT 4 WEST PARK PLANS DESIGNED TO THE **GENERAL NOTES** 149 WEST PARK LANE 1. ALL WORK SHALL BE PERFORMED IN ACCORDANCE WITH ALL APPLICABLE 2018 NORTH CAROLINA STATE NATIONAL, STATE, AND LOCAL CODES AND REGULATIONS. 2. CONTRACTOR SHALL THOROUGHLY REVIEW ALL SHEETS IN PLAN SET AND SANFORD, NC 27332 RESIDENTIAL BUILDING CODE. VERIFY ALL DETAILS AND DIMENSIONS BEFORE BEGINNING CONSTRUCTION. ANY DISCREPANCIES SHALL BE REPORTED TO RENAISSANCE RESIDENTIAL RIDGE VENT (TYP.) DESIGN, INC. FOR JUSTIFICATION AND/OR CORRECTION BEFORE PROCEEDING WITH WORK, CONTRACTORS SHALL ASSUME RESPONSIBILITY FOR ERRORS THAT ARE NOT REPORTED PRIOR TO CONSTRUCTION. 3. ALL DIMENSIONS SHOULD BE READ OR CALCULATED AND NEVER SCALED. 4. CONTRACTOR SHALL ENSURE COMPATIBILITY OF THE BUILDING WITH ALL SITE REQUIREMENTS. 1 x 4 FRIEZE BOARD AS SPEC. (TYP. FRONT ELEVATION ONLY) -SIDING AS SPEC. (TYP.) -SHINGLES AS SPEC. (TYP.) SHINGLES AS SPEC. (TYP.) CORNER BOARD EXTERIOR LIGHT AS SPEC. (TYP.) AS SPEC. (TYP.) └-12" O.H. (TYP.) ⊕ ₹ 14" SHUTTERS AS SPEC. (TYP.) -12" TAPERED COL. ON 16" x 16" x 36" -1 x 4 TRIM AS SPEC. (TYP.) BASE AS SPEC. (TYP.) 高 五 五 GARAGE DOOR AS SPEC. WITH OPTIONAL HARDWARE OPTIONAL CULTURED STONE SKIRT (SHOWN) STEPS PER GRADE AS REQ. FRONT ELEVATION-C NOTICE TO CONTRACTOR struction must comply with current NC Building Codes SCALE: 1/4" = 1'-0" APPROVED RIDGE VENT (TYP.) Limited building only review Harnett 09/17/2021 NORTH CAROLINA SHINGLES -SIDING HVAC: N/A REAR ELEVATION ELECTRICAL:PIONEER SCALE: 1/8" = 1'-0" PLUMBING: DOUBLE J SHINGLES -SHINGLES - SHINGLES SHINGLES COVERED PORCH FEXAMINE OF STANK LEFT ELEVATION RIGHT ELEVATION SCALE NOTE: 18x24 PRINTS ARE SCALE: 1/8" = 1'-0" SCALE: 1/8" = 1'-0" TO SCALE AS NOTED. 11x17 PRINTS ARE NOT TO SCALE

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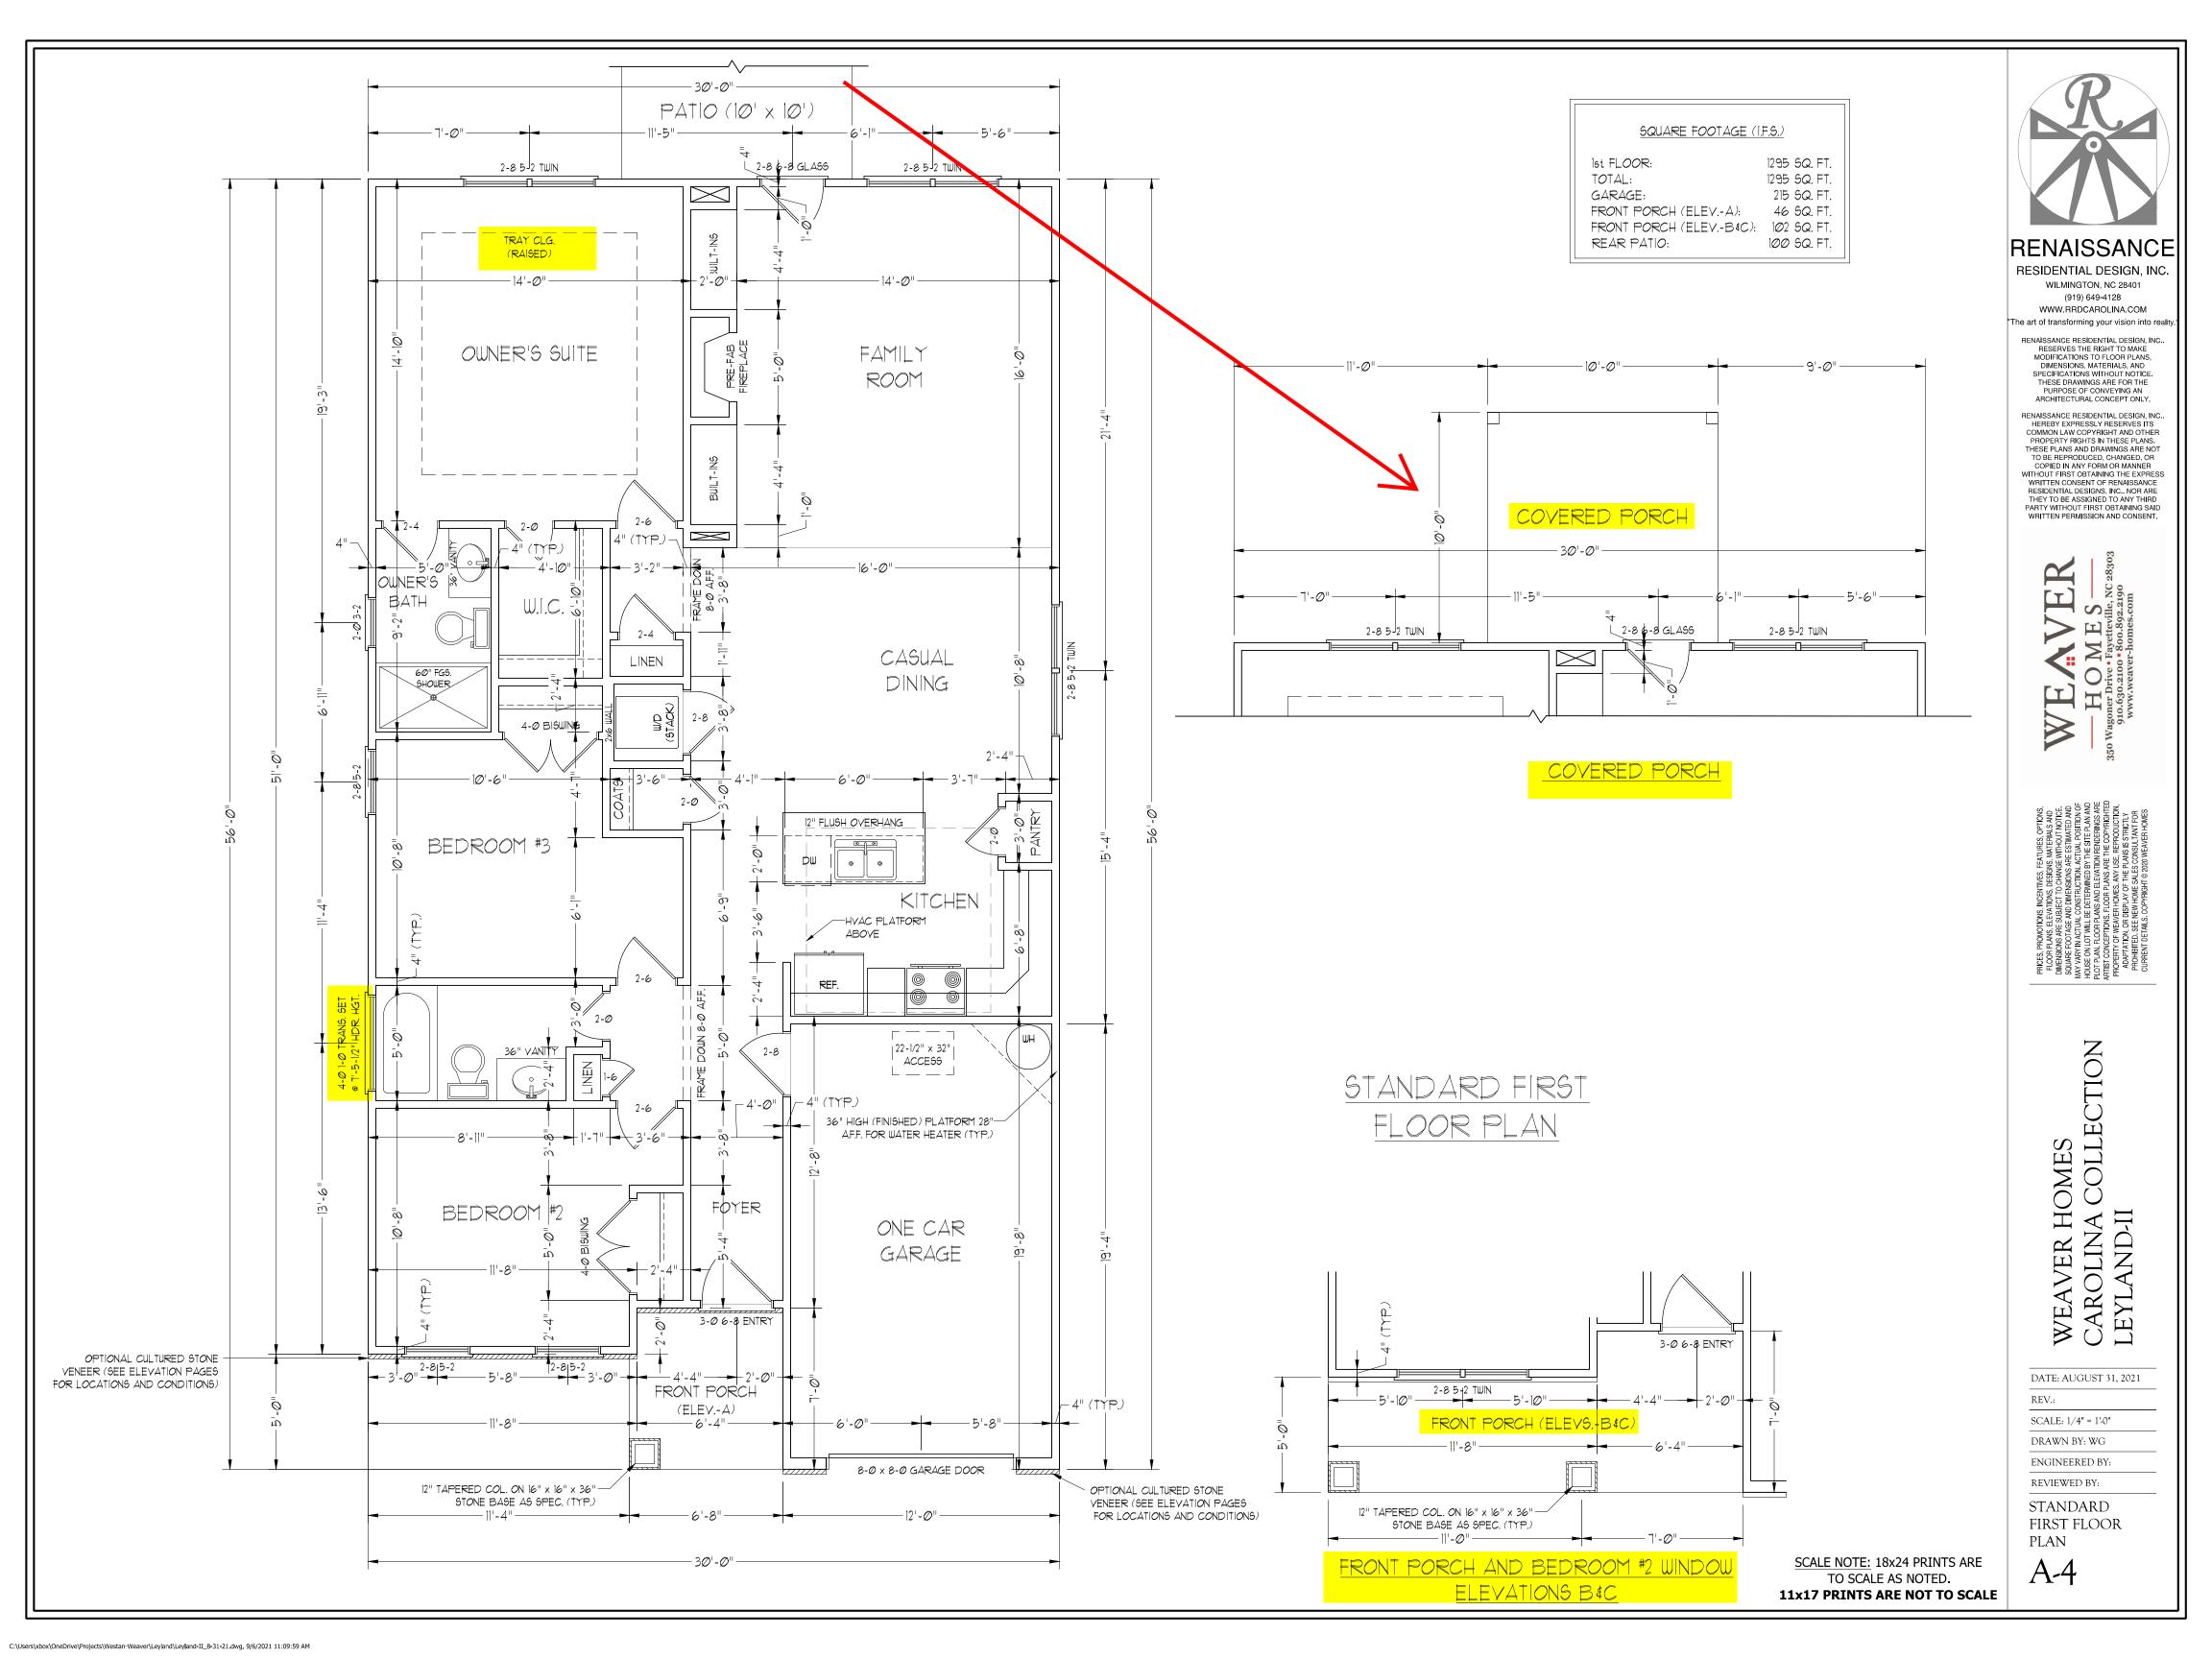
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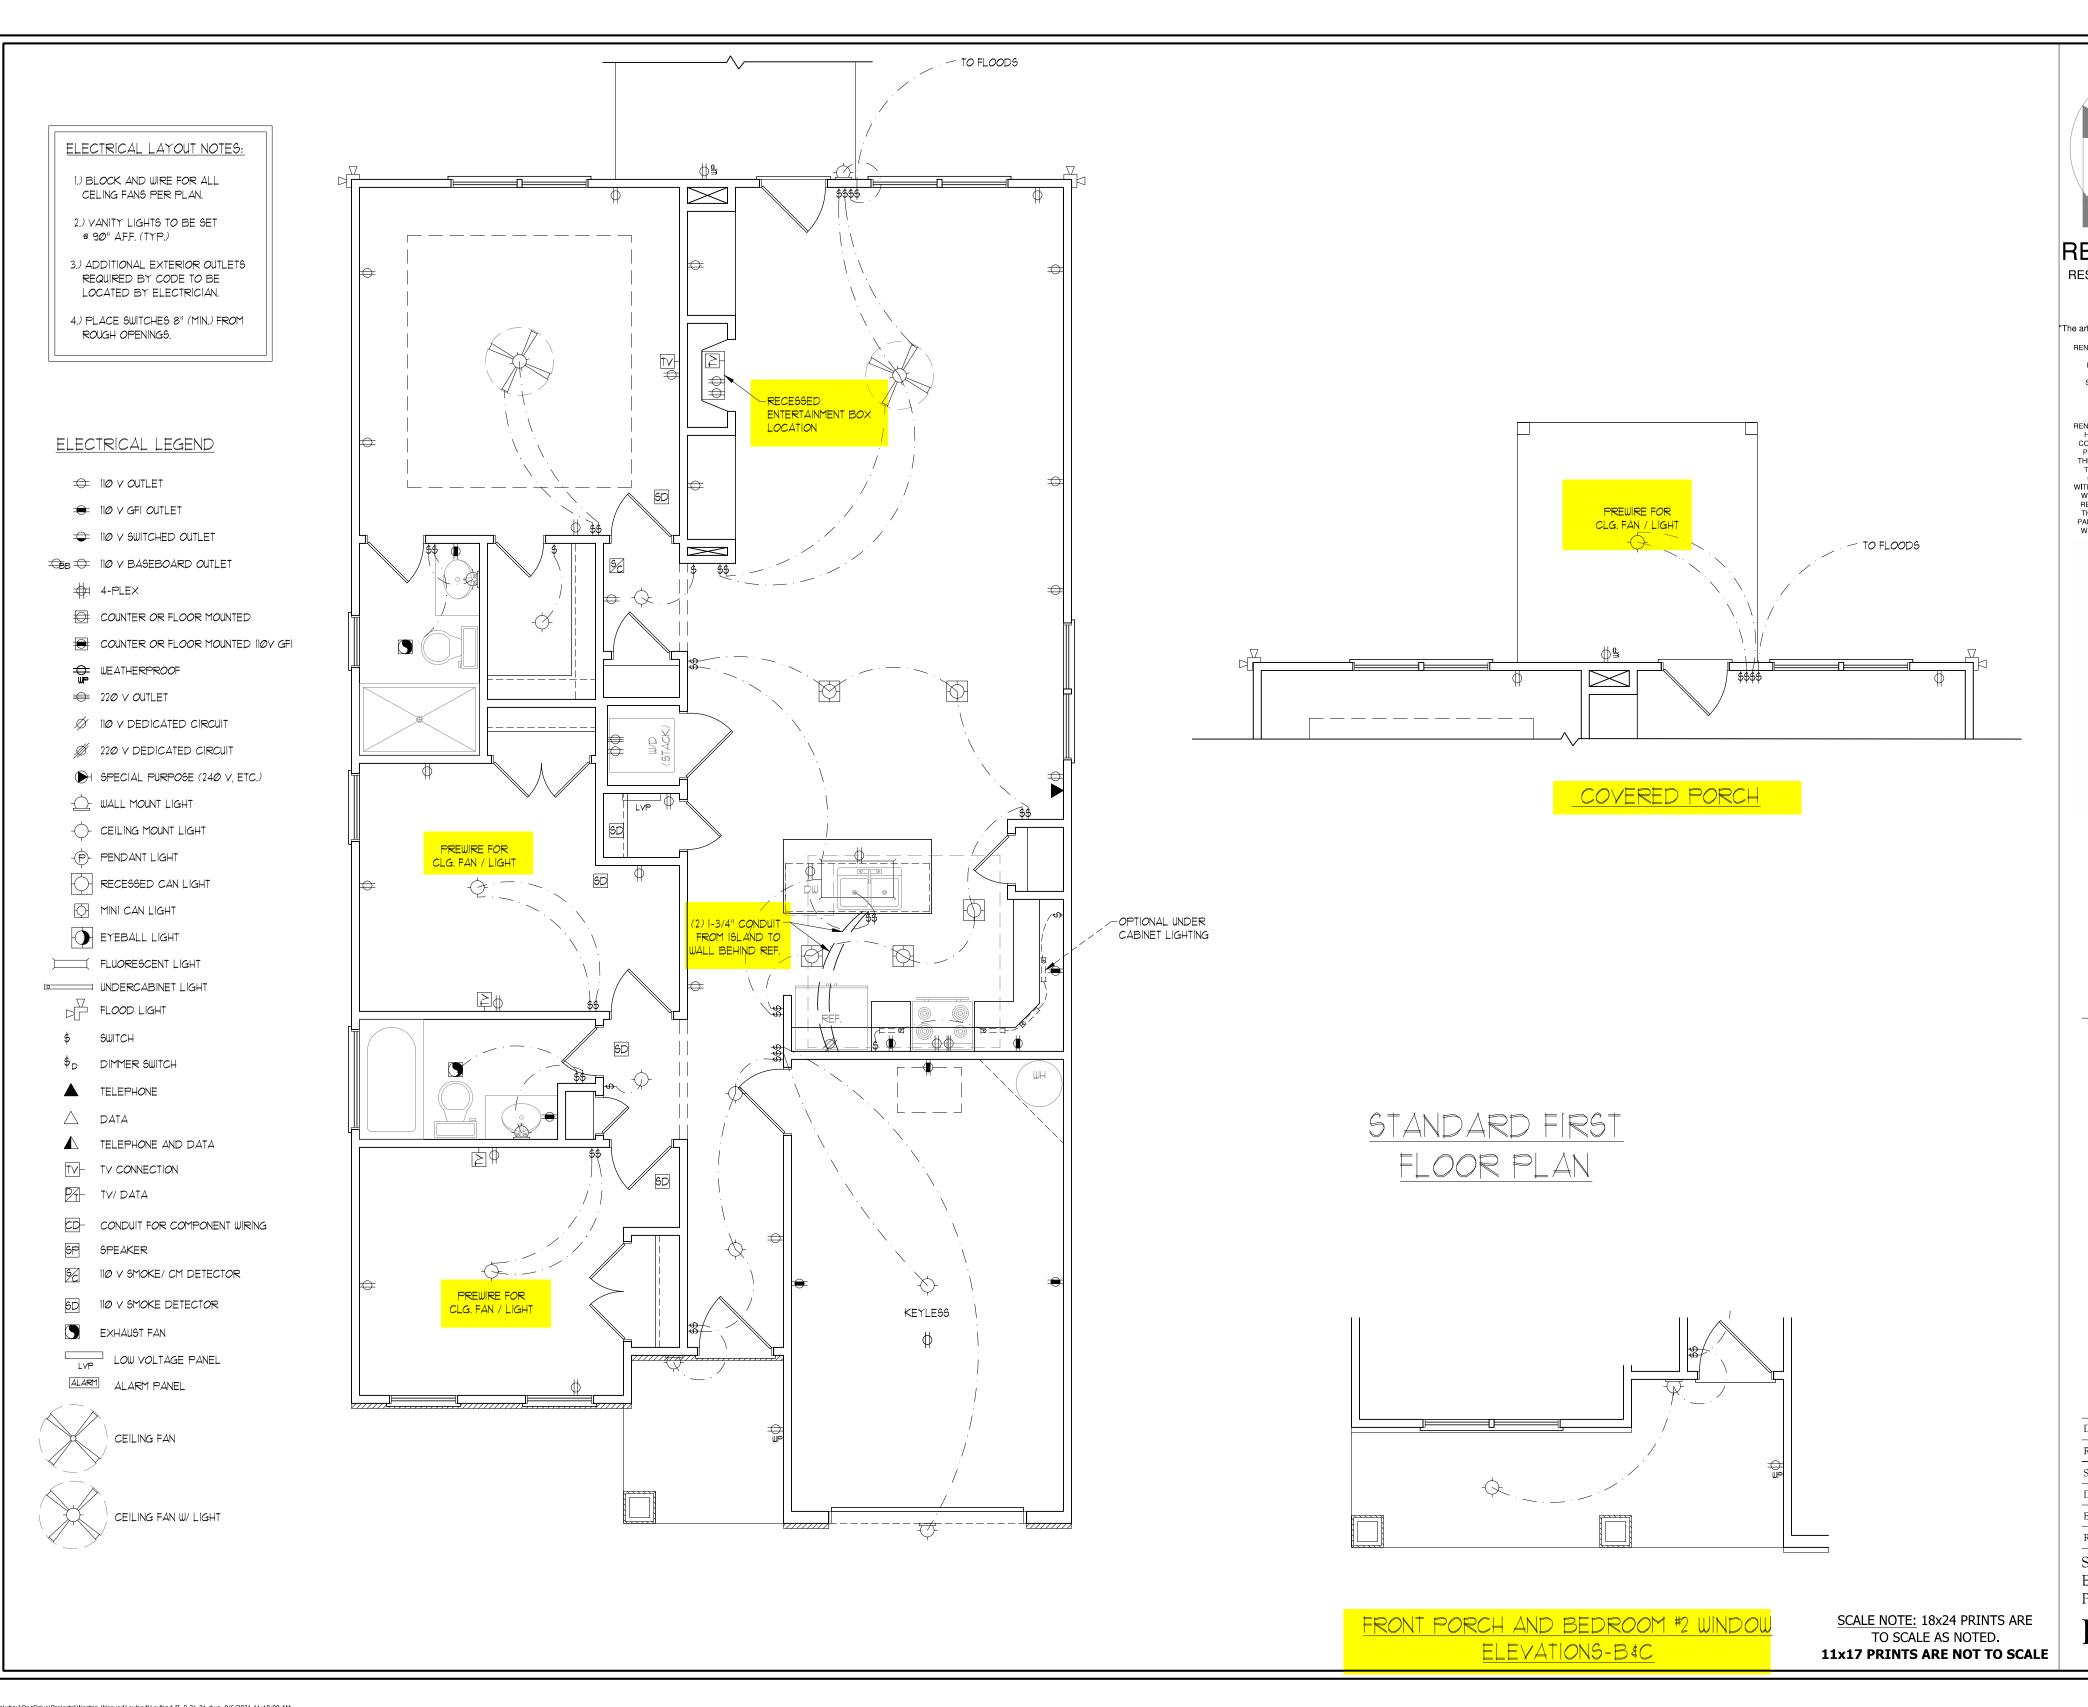
DRAWN BY: WG
ENGINEERED BY:

REVIEWED BY:

C - ELEVATIONS

A-3

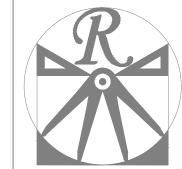





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DATE: AUGUST 31, 2021

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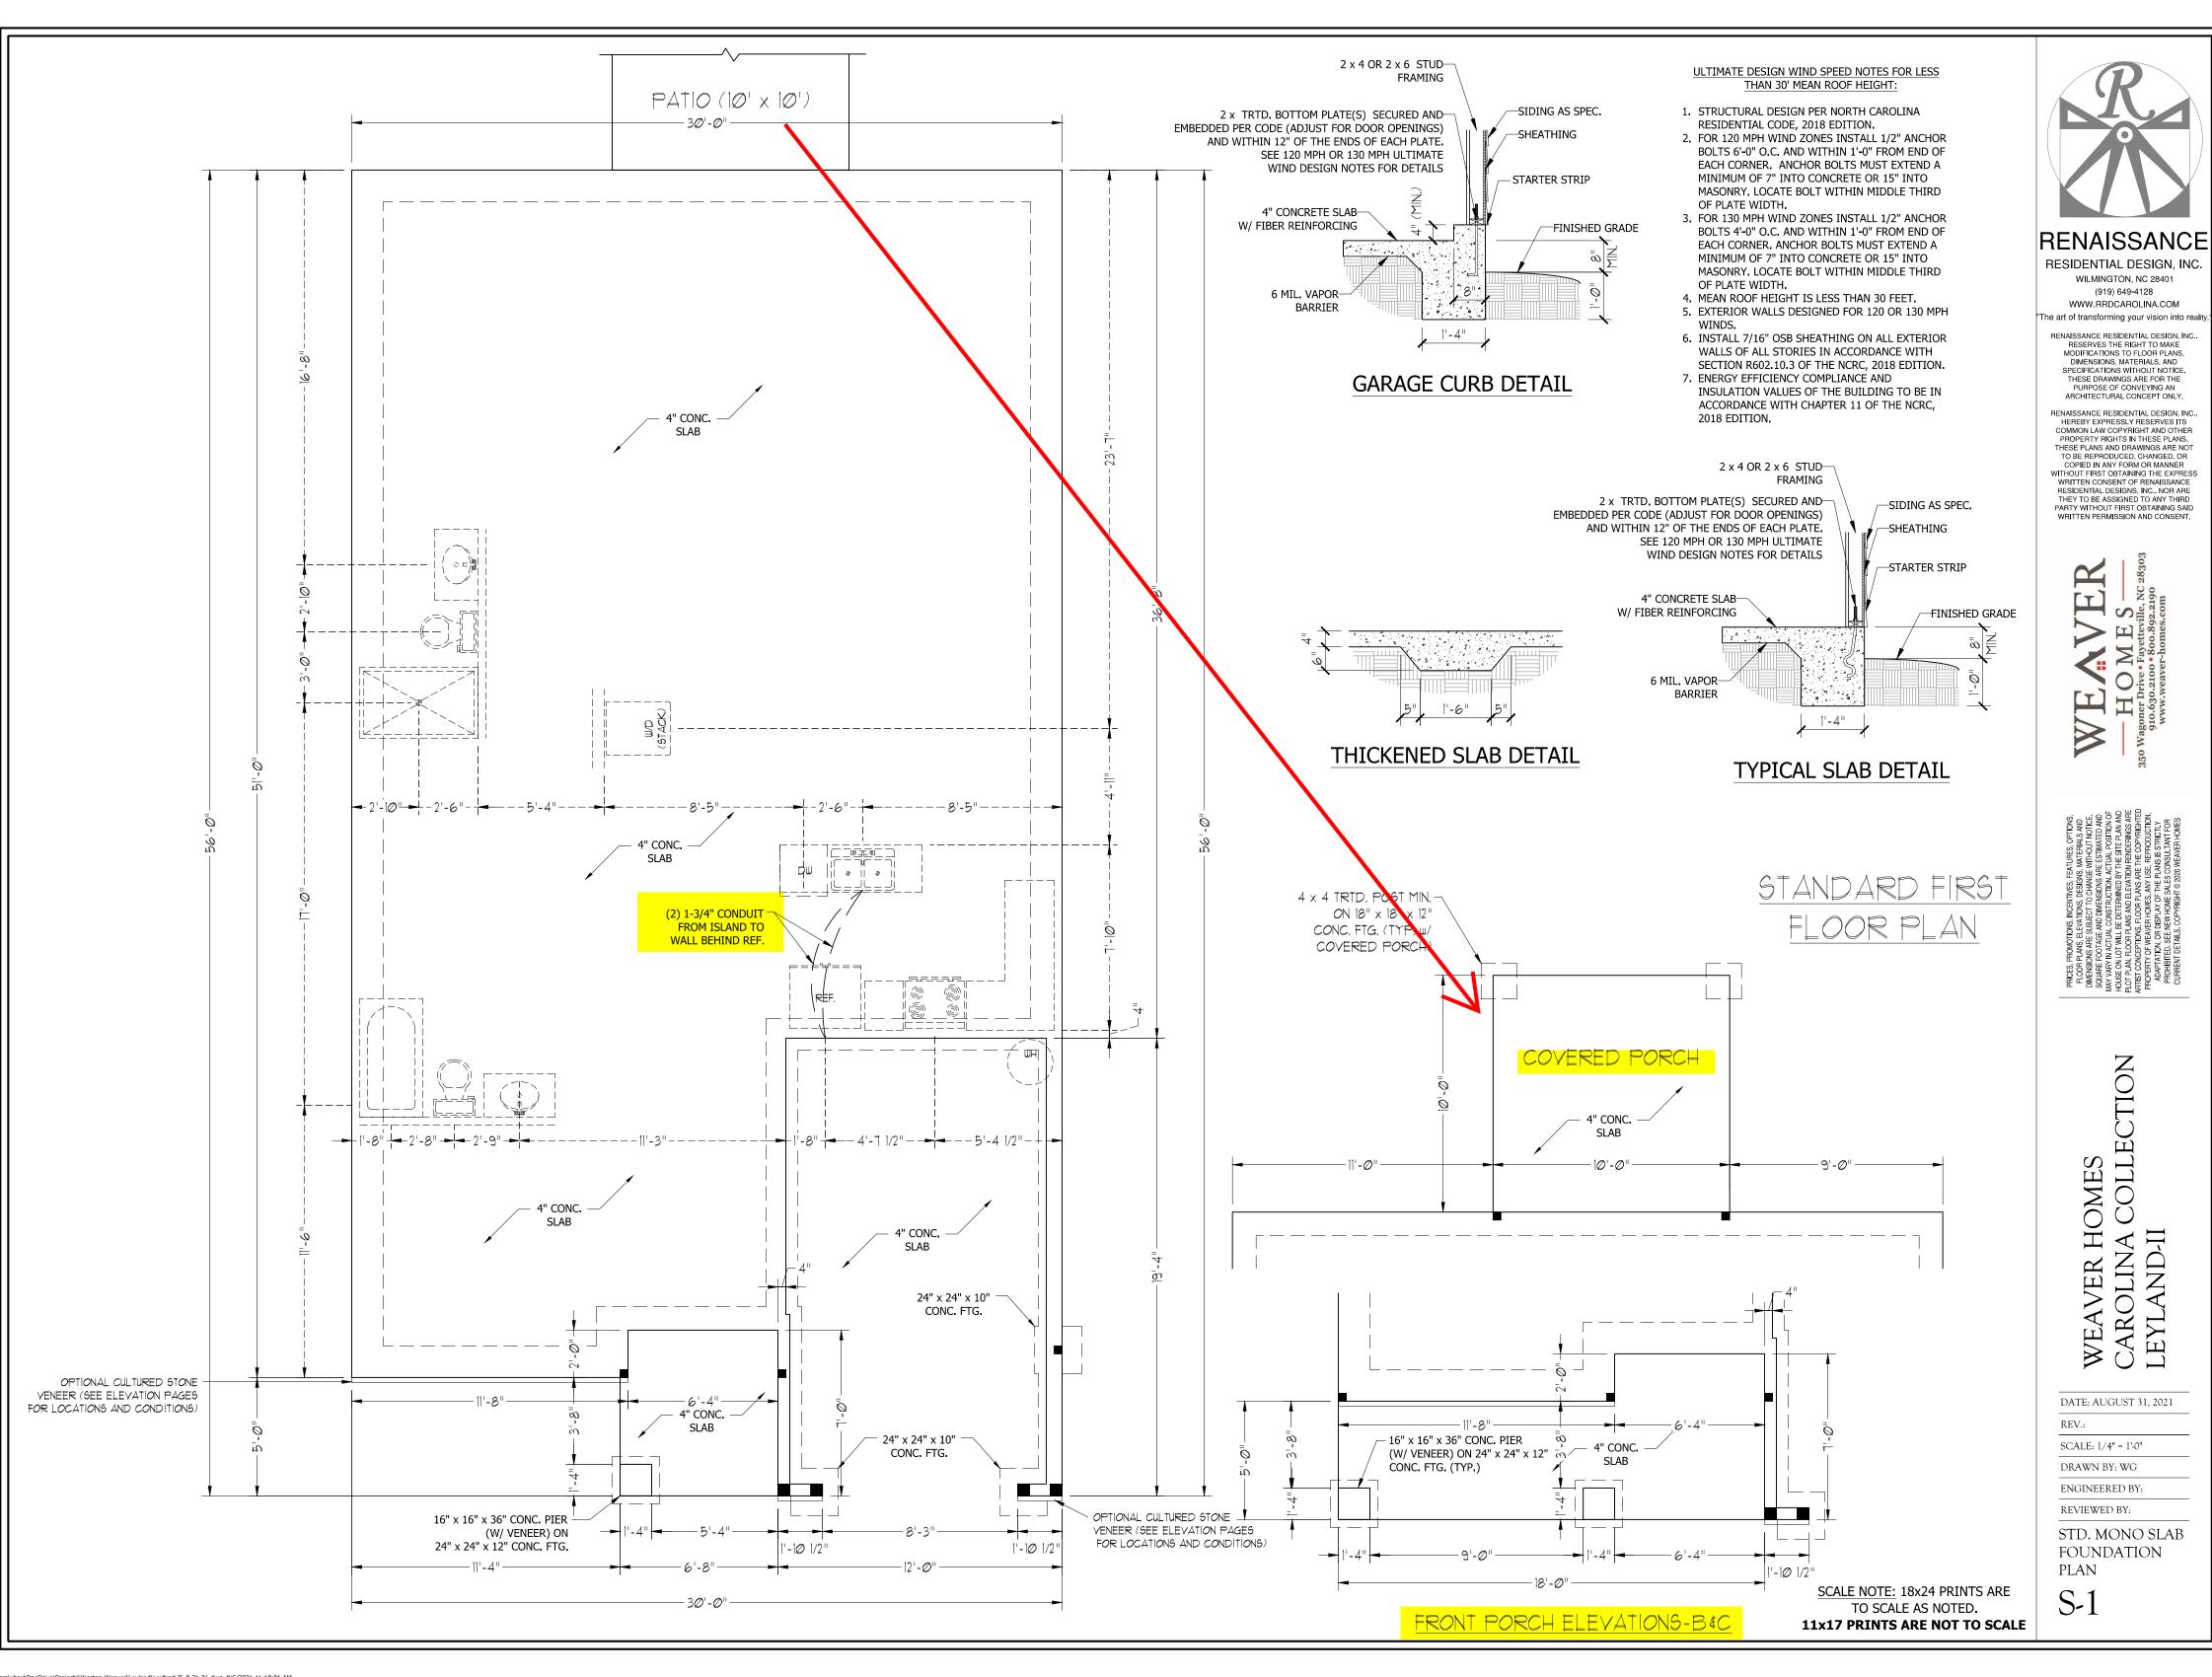
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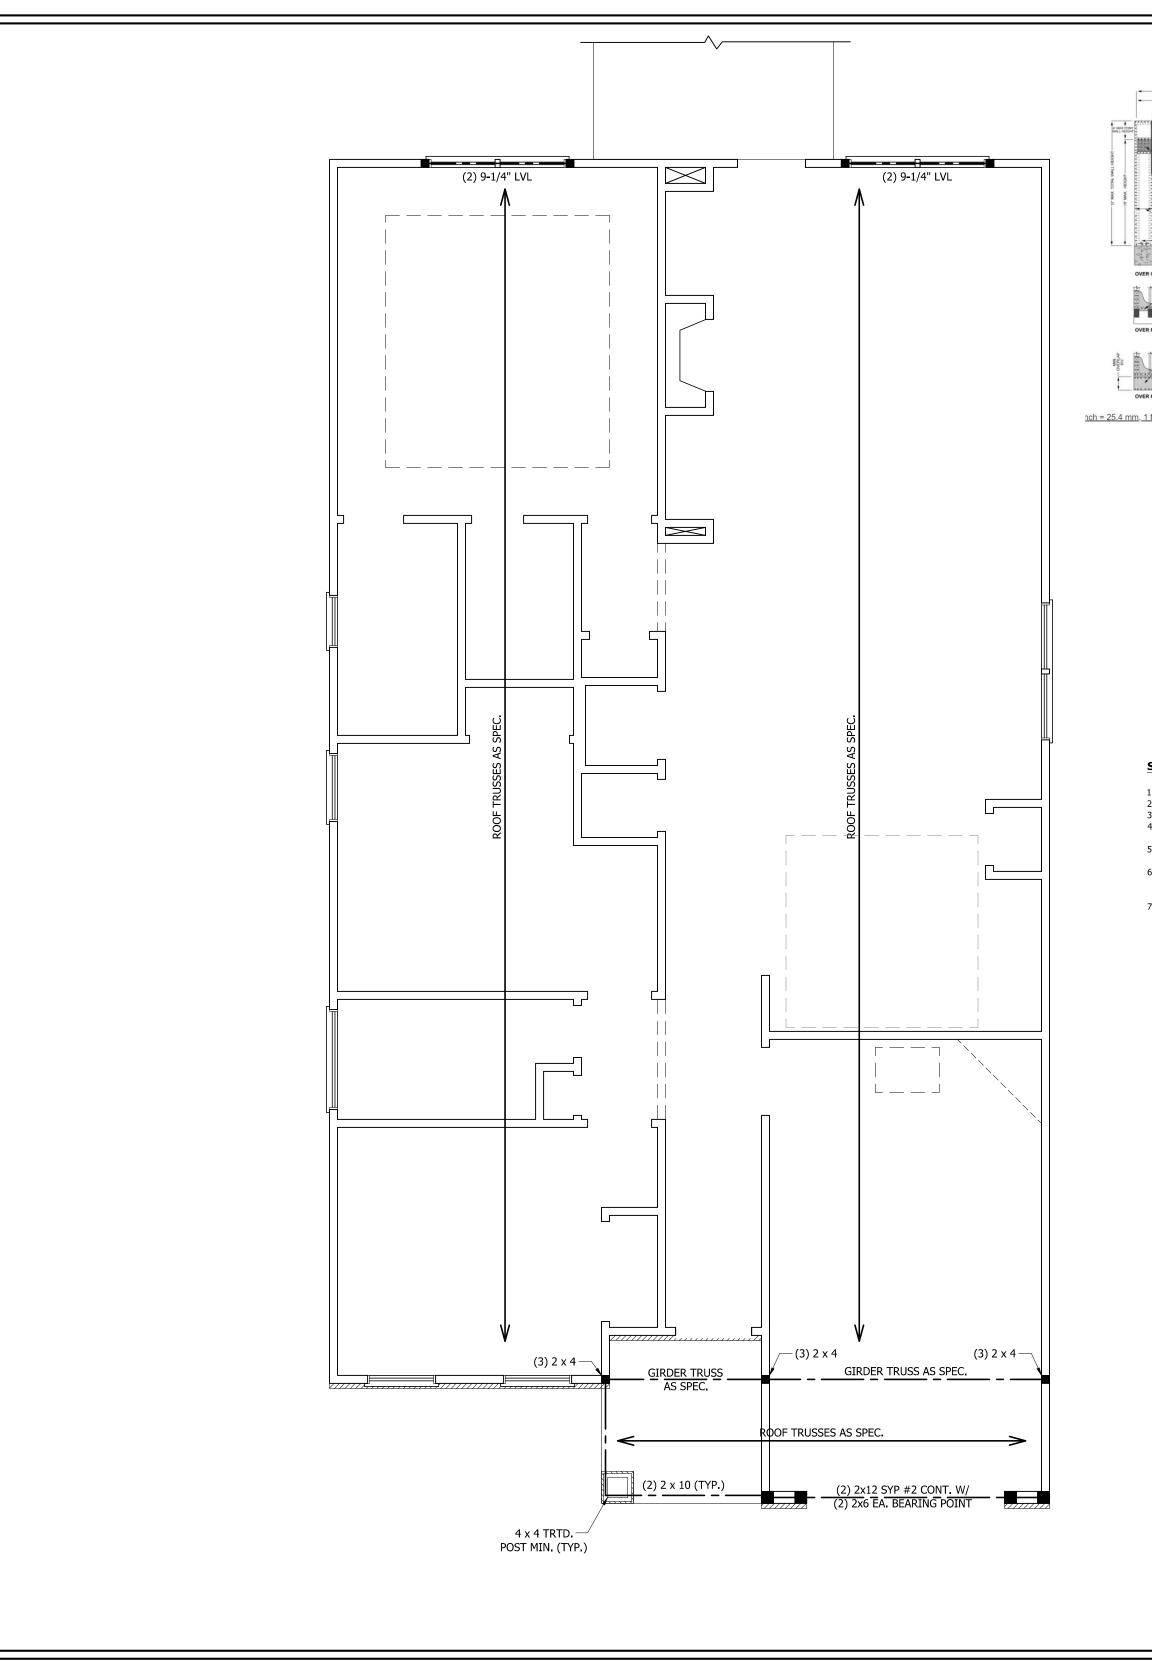
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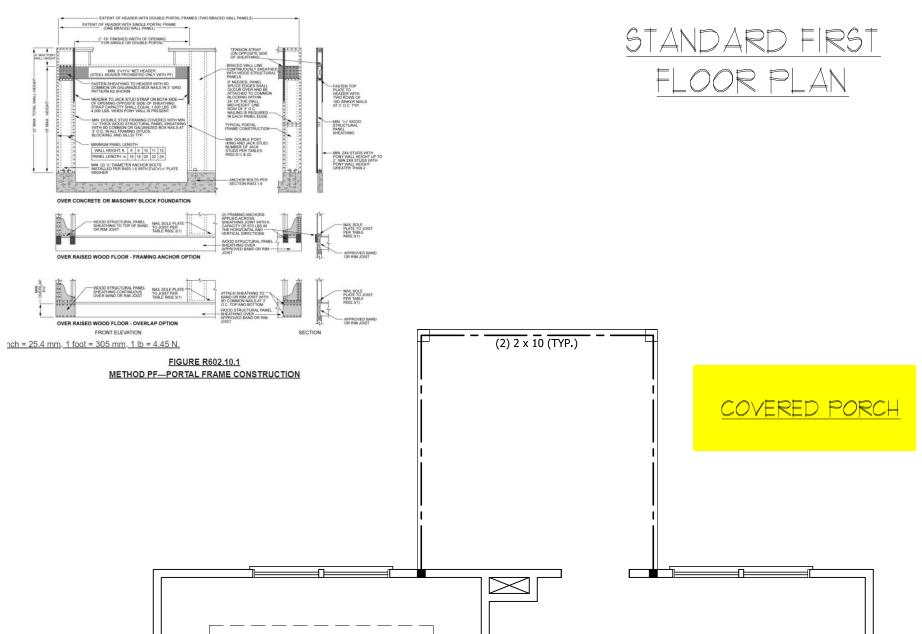
STANDARD FF ELECTRICAL PLAN

E-1

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STRUCTURAL NOTES:

- 1. ALL FRAMING LUMBER TO BE SPF #2 (UNO). ALL TREATED LUMBER TO BE SYP #2 (UNO.)
- ALL LOAD BEARING HEADERS TO BE (2) 2 x 6 (UNO).
 INSTALL AN EXTRA JOIST UNDER WALLS PARALLEL TO FLOOR JOISTS
- 4. WINDOW AND DOOR HEADERS TO BE SUPPORTED w/ (1) JACK STUD AND (1) KING STUD EA. END (UNO.).
- SEE TABLE R602.7.5 FOR ADDITIONAL KING STUD REQUIREMENTS.
- 5. SQUARES DENOTE POINT LOADS WHICH REQUIRE SOLID BLOCKING TO GIRDER OR FOUNDATION. ALL SQUARES TO BE (2) STUDS (UNO.)
- 6. ALL 4 X 4 POSTS SHALL BE ANCHORED TO SLABS W/ SIMPSON ABU44 POST BASES (OR EQUAL) AND 6 X 6 POSTS W/ ABU66 POST BASES (OR EQUAL) (UNO). ALL 4 X 4 AND 6 X 6 POSTS TO BE INSTALLED WITH 700 LB CAPACITY UPLIFT CONNECTORS AT TOP (UNO.) 7. FOR FIBERGLASS, ALUMINUM, OR COLUMN ENG. BY OTHERS, SECURE TO SLAB W/ (2) METAL ANGLES
- USING 2" CONC. SCREWS. FASTEN ANGLES TO COLUMNS W/ 1/4" THROUGH BOLTS W/ NUTS AND WASHERS. LOCATE ANGLES ON OPPOSITE SIDES OF COLUMN. THROUGH BOLTS MUST BE INSTALLED

BRACE WALL PANEL NOTES:


EXTERIOR WALLS: ALL EXTERIOR WALLS TO BE SHEALTHED WITH CS-WSP OR CS-SFB

REQUIRED LENGTH OF BRACING: REQUIRED BRACE WALL LENGTH FOR EACH SIDE OF THE CIRCUMSCRIBED RECTANGLE ARE INTERPOLATED PER TABLE R602.10.3. METHODS CS-WSP AND CS-SFB CONTRIBUTE THIER ACTUAL LENGTH. METHOD GB CONTRIBUTES 0.5 ITS ACTUAL LENGTH. METHOD PF CONTRIBUTES 1.5 TIMES ITS

GYPSUM: ALL INTERIOR SIDES OF EXTERIOR WALLS AND BOTH SIDES OF INTERIOR WALLS TO HAVE 1/2" GYPSUM INSTALLED. WHEN NOT USING METHOD GB GYPSUM TO BE FASTENED PER TABLE R702.3.5. METHOD GB TO BE FASTENED PER TABLE R602.10.1.

HD: 800 LBS HOLD DOWN DEVICE FASTENED TO THE EDGE OF THE BRACE WALL PANEL NEAREST TO THE CORNER

METHODS: PER TABLE R602.10.1

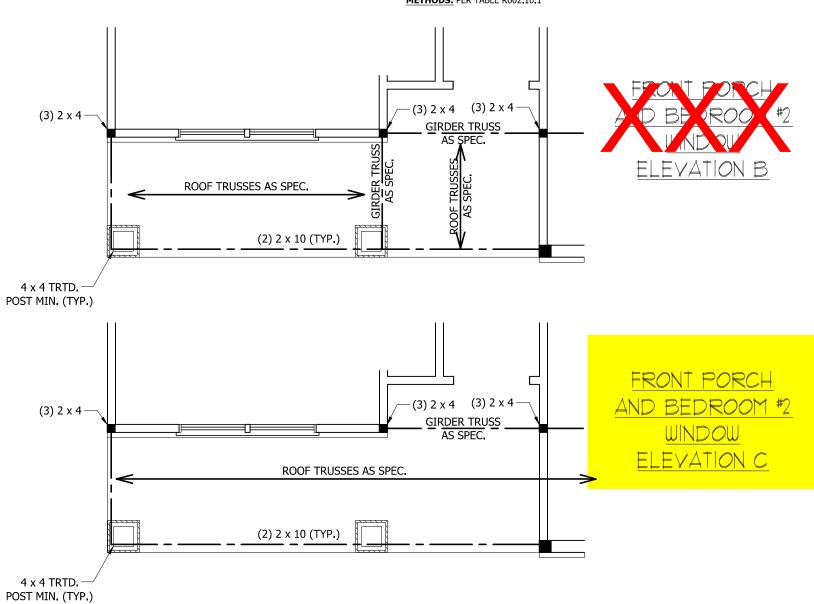

SCALE NOTE: 18x24 PRINTS ARE TO SCALE AS NOTED. 11x17 PRINTS ARE NOT TO SCALE



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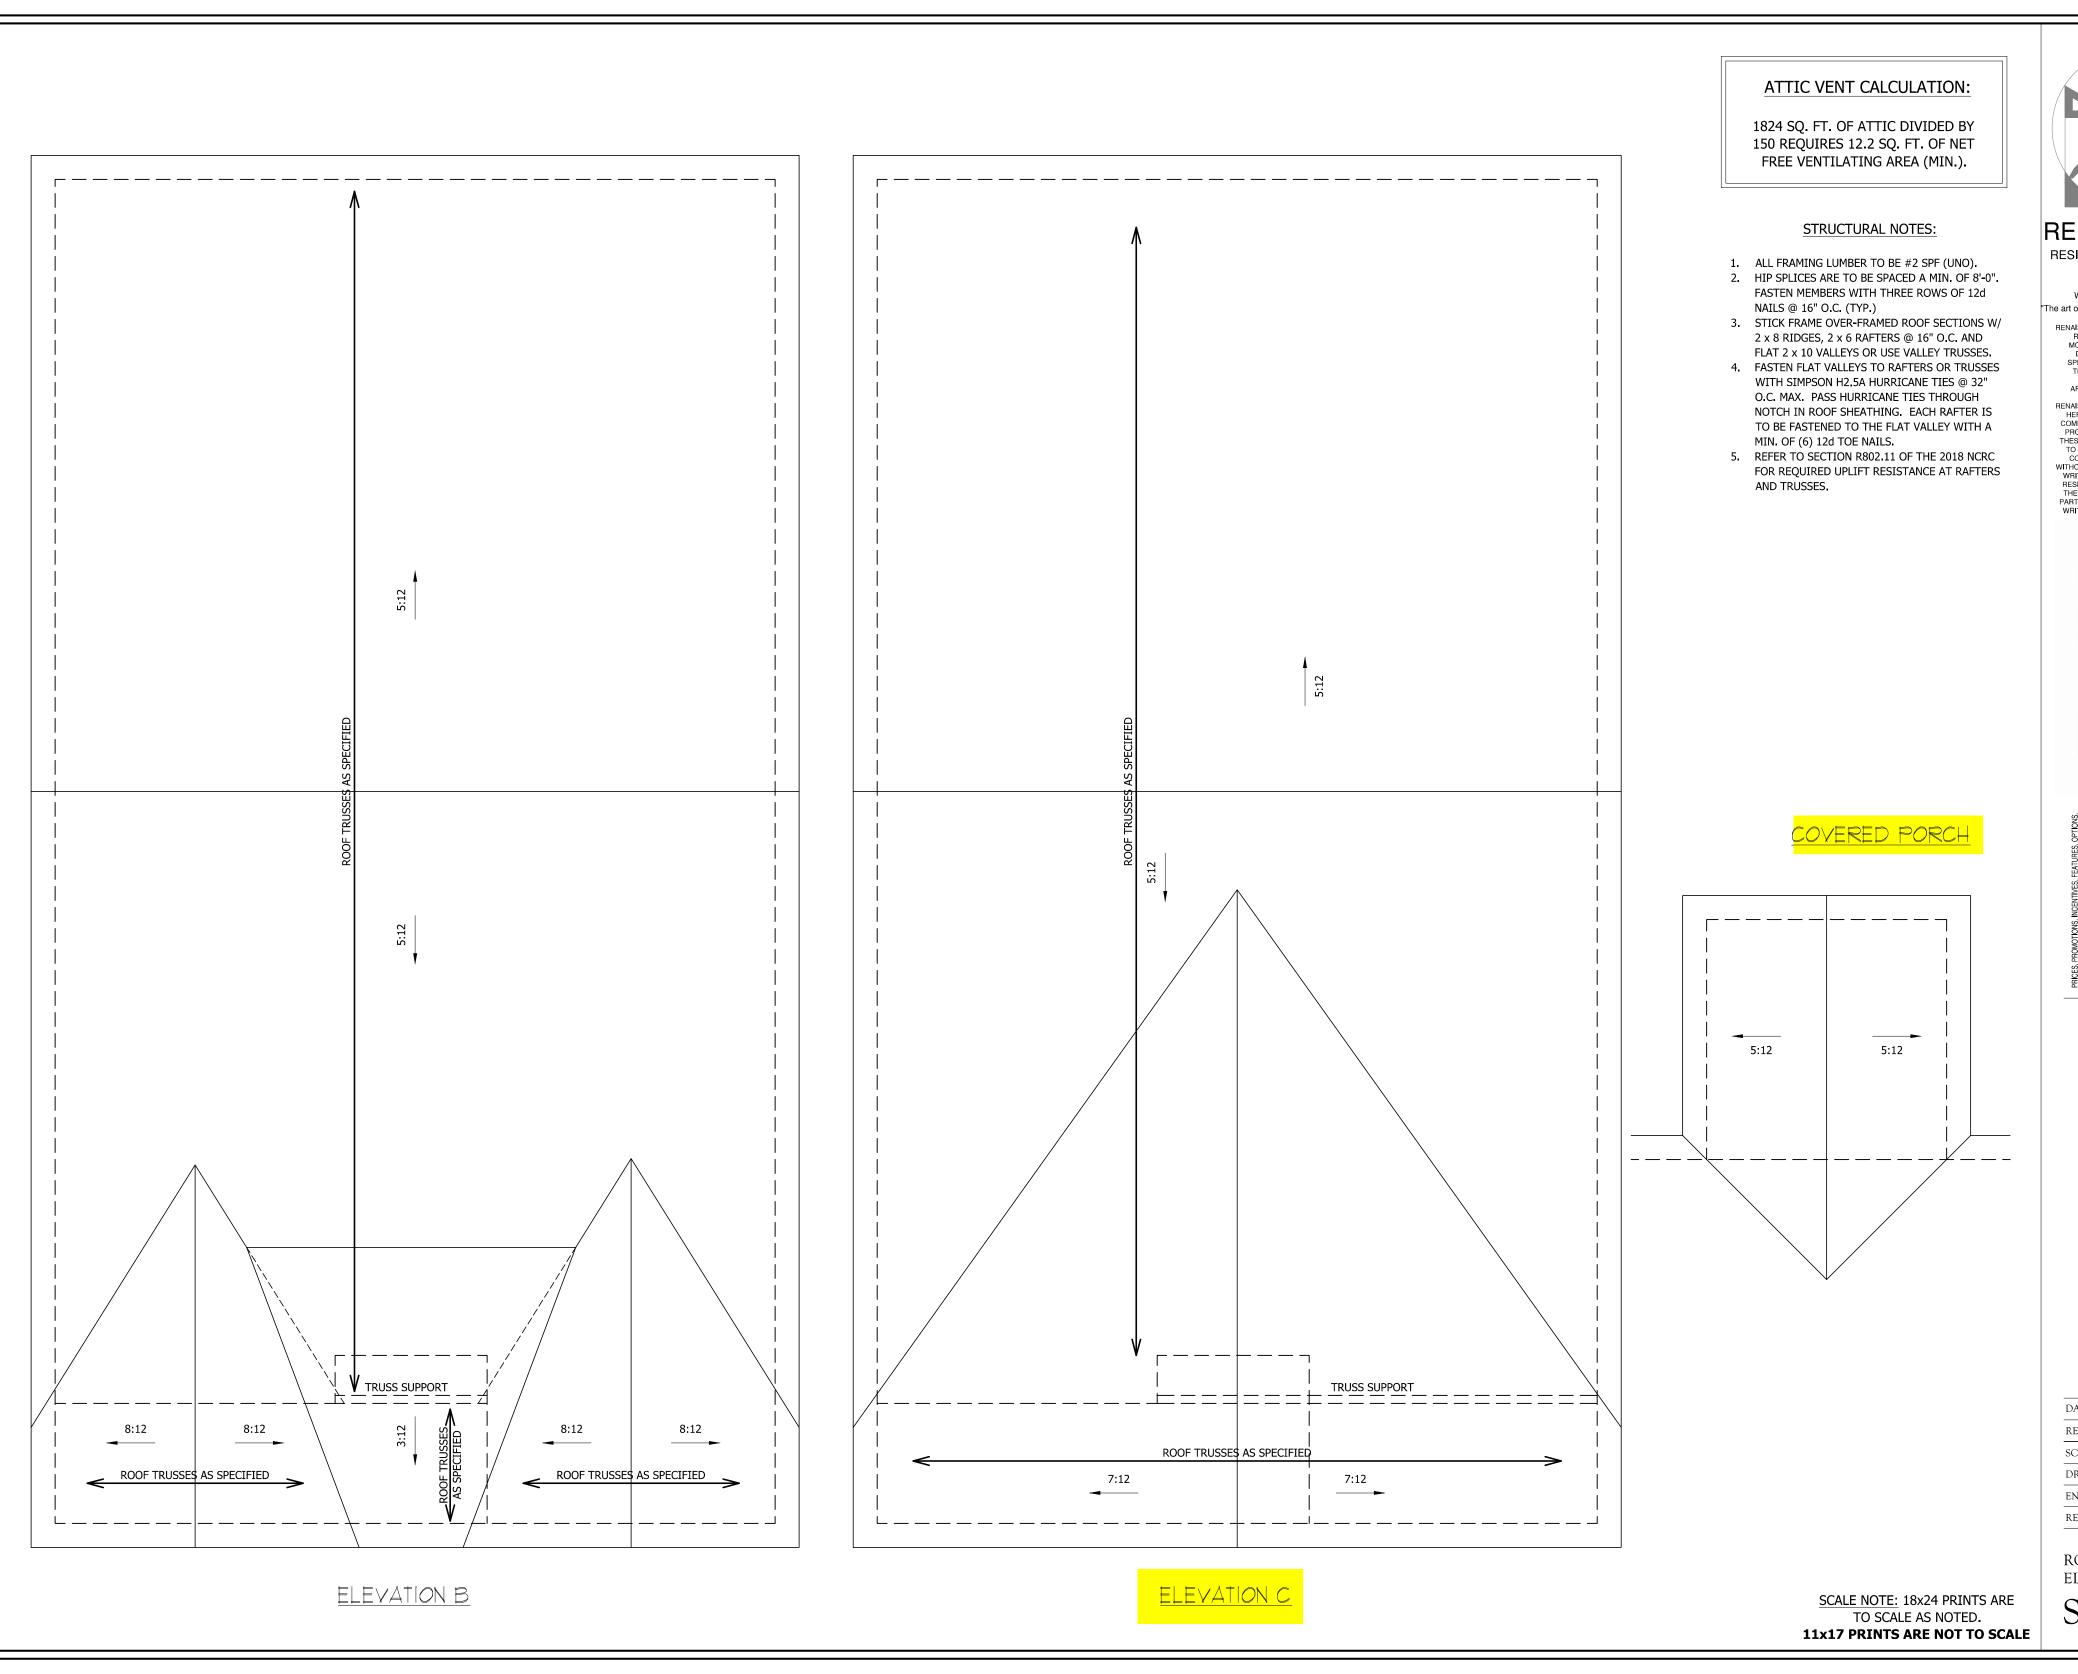
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STANDARD SF

FRAMING PLAN



0

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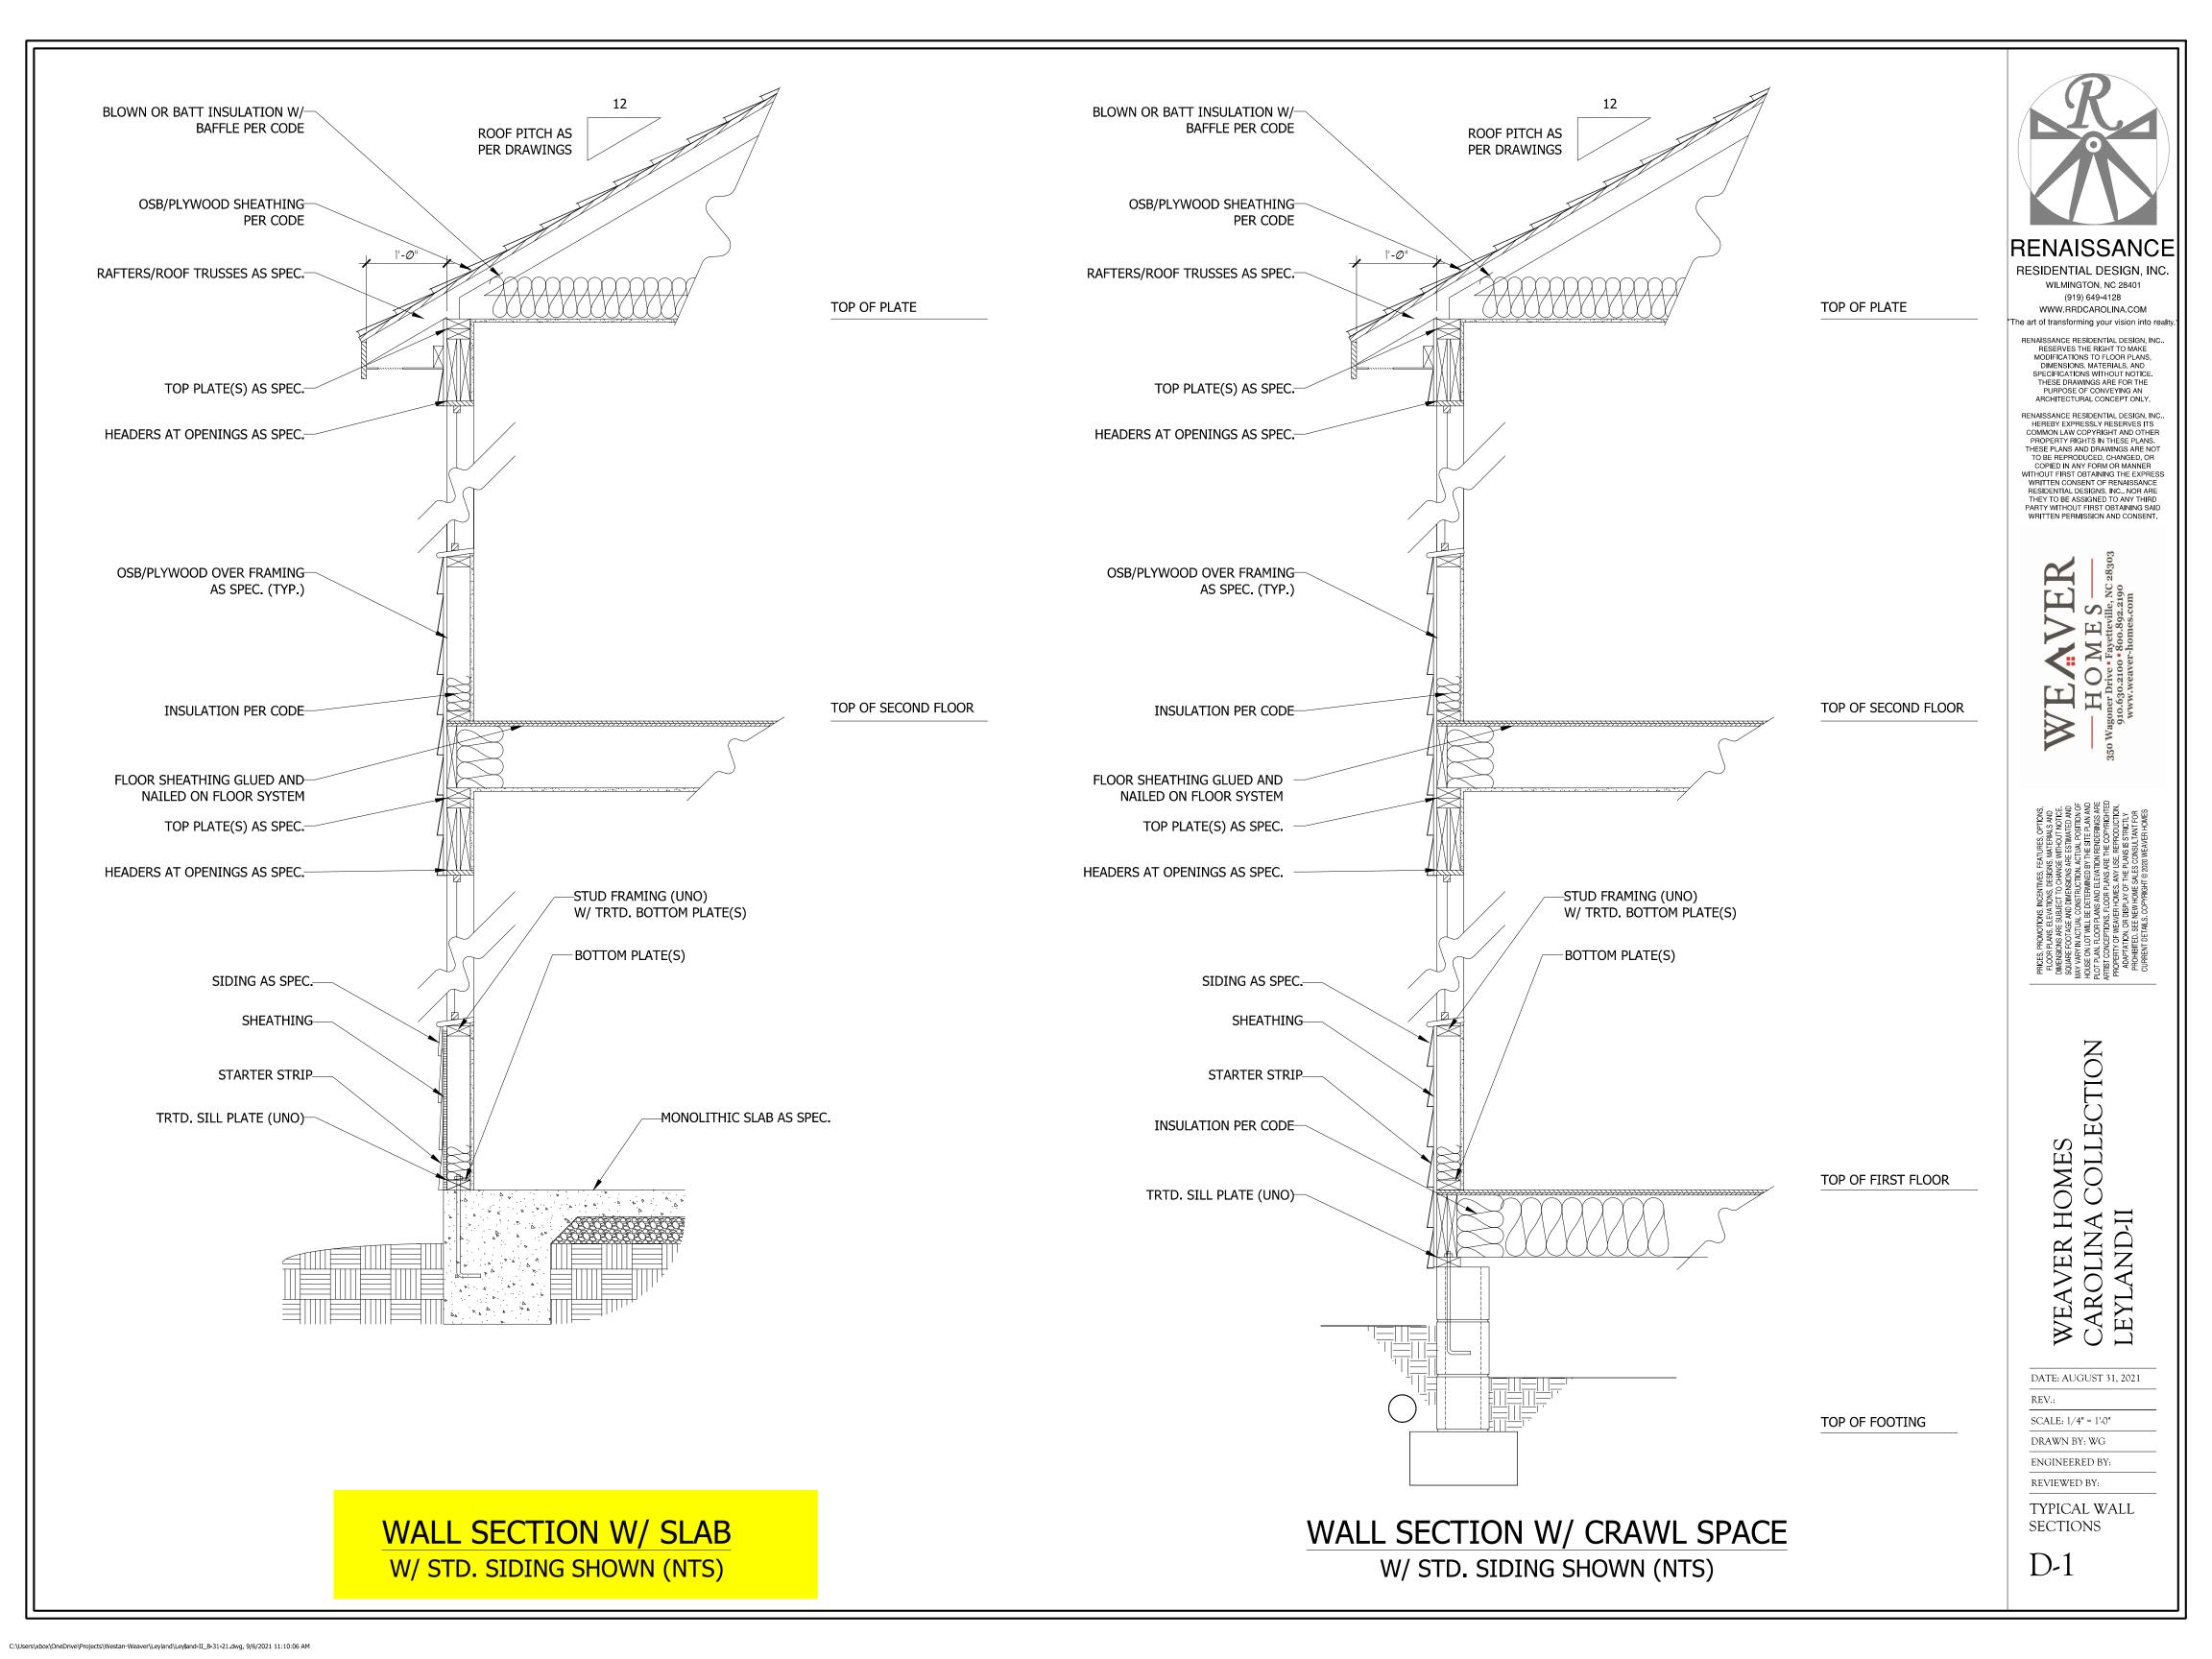
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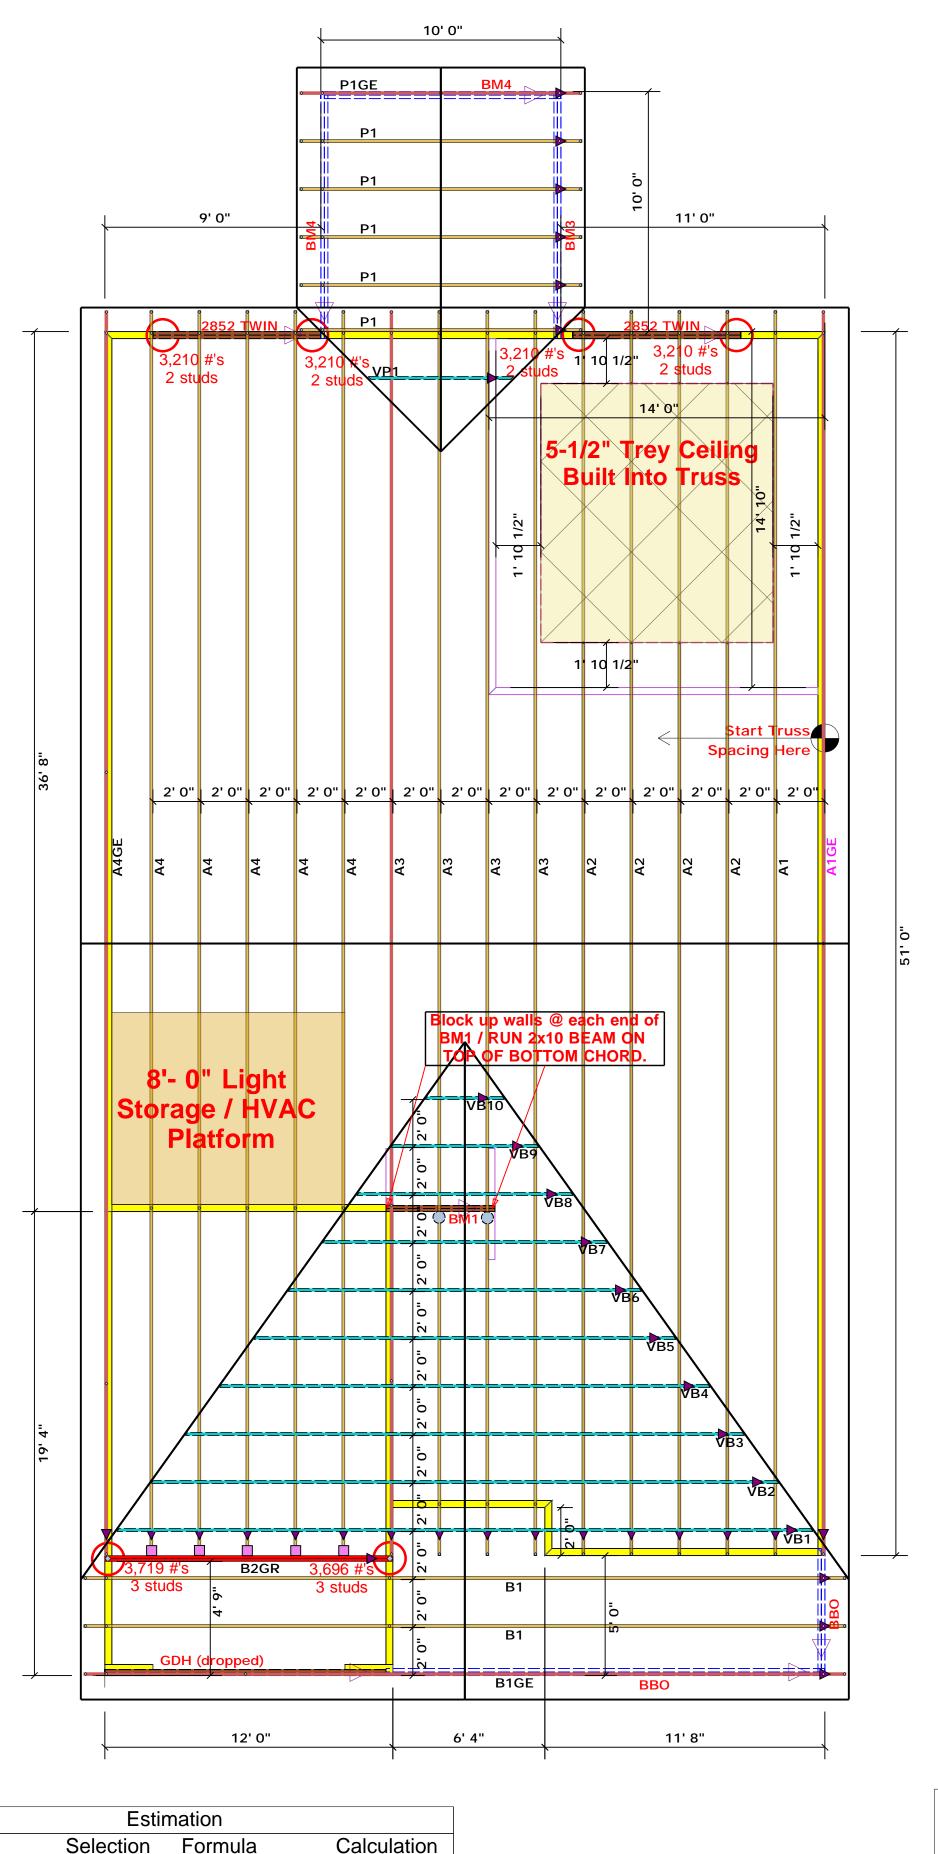
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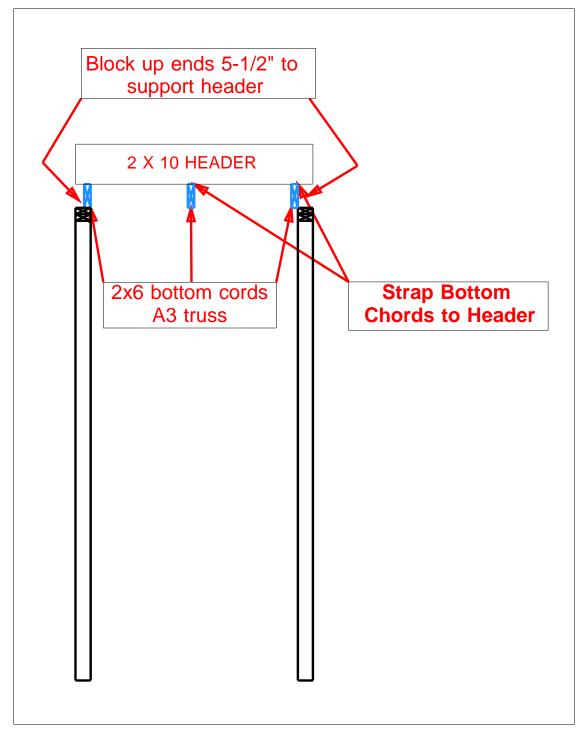
ROOF PLANS ELEVATIONS B&C

S-5.1

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Truss Placement Plan SCALE: 1/4" = 1'-0"

▲ = Denotes Left End of Truss (Reference Engineered Truss Drawing)

Estimation							
Name	Selection	Formula	Calculation				
Roof Area	1st Floor	Roof Area	2218.22				
Roof Decking	1st Floor	Roof Decking	76				
		DEAM LECEND					

QUOTE #

JOB #

15300 6

HUS28	USP	5		16d/3-1/2	16d/3-1/2"
MSH422	USP	2	Varies	10d/3"	10d/3"

Harnett

ROOF

/ /

DRAWN BY

SALES REP.

Lot 4 West Park

Lenny Norris

Lenny Norris

BEAM LEGEND PlotID Length Product Plies Net Qty Fab Type 2852 TWIN 7' 0" 1-3/4"x 9-1/4" LVL Kerto-S

All Truss Reactions are Less than 3,000 lbs. Unless Noted Otherwise.

-- Denotes Reaction Greater than 3,000 lbs. Reaction / # of Studs

2002 I WIIN	7 0	1-3/4 X 7	- 1/4 LVL Kerto-3	_	4	FF	
GDH (dropped	d) 12' 0	" 2x12 SPF	No.2	2	2	FF	
LOAD CHART FOR JA MASEN ON LABES 85025 MANGE OF JACK STUDG SCOURS	5(1) 4 (6())	BUILDER	Weaver Homes				CITY / CO.
HEADER/60RDER	i	JOB NAME	Lot 4 West Park				ADDRESS
HIND SEACTION (0.7 TO) (0.7 TO) (0.7 TO) (0.7 MIN HENDER (0.7	୍ଥି ଥିଲ	PLAN	LEYLAND " C "				MODEL
1700 1 2550 1 3400 2 5100 2 5100 3 7650 3	3400 ! 6600 2 10200 3	SEAL DATE	Seal Date				DATE REV.
6800 4 10200 4 8500 5 12750 5	13600 4 17000 5	OUOTE #					DRAWN BY

J0821-5269


Lenny Norris


Lenny Norris

THIS IS A TRUSS PLACEMENT DIAGRAM ONLY.



Reilly Road Industrial Park Fayetteville, N.C. 28309 Phone: (910) 864-8787 Fax: (910) 864-4444

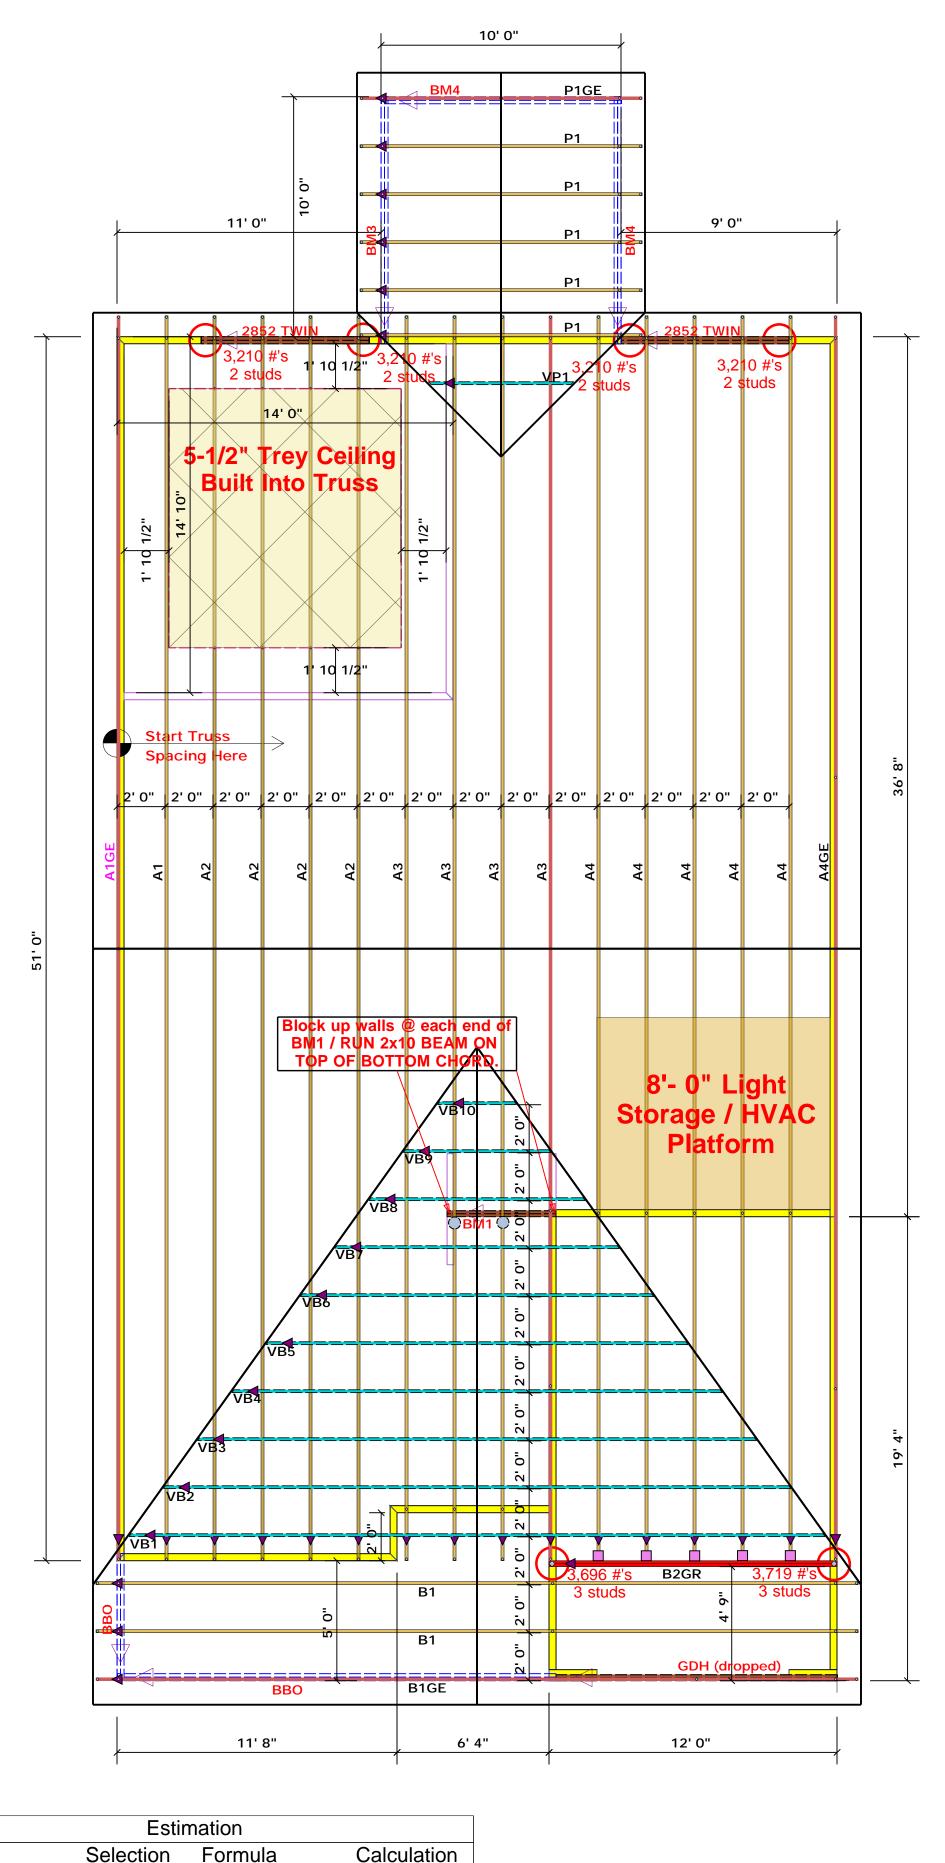

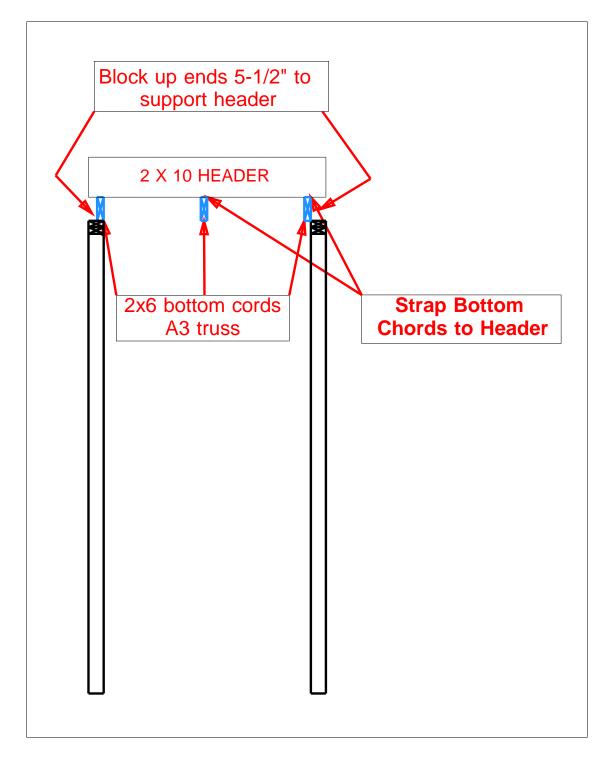

Truss Placement Plan SCALE: 1/4" = 1'-0"

▲ = Denotes Left End of Truss (Reference Engineered Truss Drawing)

Selection Calculation Name Roof Area 2218.22 Roof Area 1st Floor USP 16d/3-1/2 16d/3-1/2" HUS28 Roof Decking MSH422 USP 10d/3" Roof Decking 1st Floor 76 **BEAM LEGEND** PlotID Length Product Net Qty Fab Type Plies 7' 0" 2852 TWIN 1-3/4"x 9-1/4" LVL Kerto-S FF

Seal Date

J0821-5269

GDH (dropped)

LOAD CHART FOR JACK STUDS (BASEN ON LABLES R502.5(1) λ (b)) NUMBER OF DIACK STUDG REQUIREDS & CA END OF FEADER/600063

2550 1 5100 2

7650 3

10200 4 12750 5

15300 6

3400

6600 2

10200 3

13600 4 17000 5

SEAL DATE

QUOTE #

JOB #

All Truss Reactions are Less than 3,000 lbs. Unless Noted Otherwise.

-- Denotes Reaction Greater than 3,000 lbs. Reaction / # of Studs

Lenny Norris

Lenny Norris

12' 0'	' 2x12 SPF	No.2	2	2	FF			
STUDS	BUILDER	Weaver Homes				CITY / CO.	Harnett	THIS IS A TRUSS PLACEMENT DIAGRAM ONLY. These trusses are designed as individual building components to be incorporated into the building design at the specification of the building designer. See individual design sheets for each truss design identified on the placement drawing. The building designer
NO CO NO CO NO FOR	JOB NAME					ADDRESS	Lot 4 West Park	is responsible for temporary and permanent bracing of the roof and floor system and for the overall structure. The design of the truss support structure including headers, beams, walls, and columns is the responsibility of the building designer. For general guidance regarding bracing, consult BCSI-B1 and BCSI-B3 provided with the truss delivery package
3400 2	PLAN					MODEL	ROOF	Bearing reactions less than or equal to 3000# are deemed to comply with the prescriptive Code requirements. The contractor shall refer to the attached Tables (derived from the prescriptive Code requirements) to determine the minimum.

Lenny Norris

Lenny Norris

DATE REV.

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SALES REP.

10d/3"

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соттесн

ROOF & FLOOR

TRUSSES & BEAMS