



PLUMBING W/ OPT. GOURMET KITCHEN

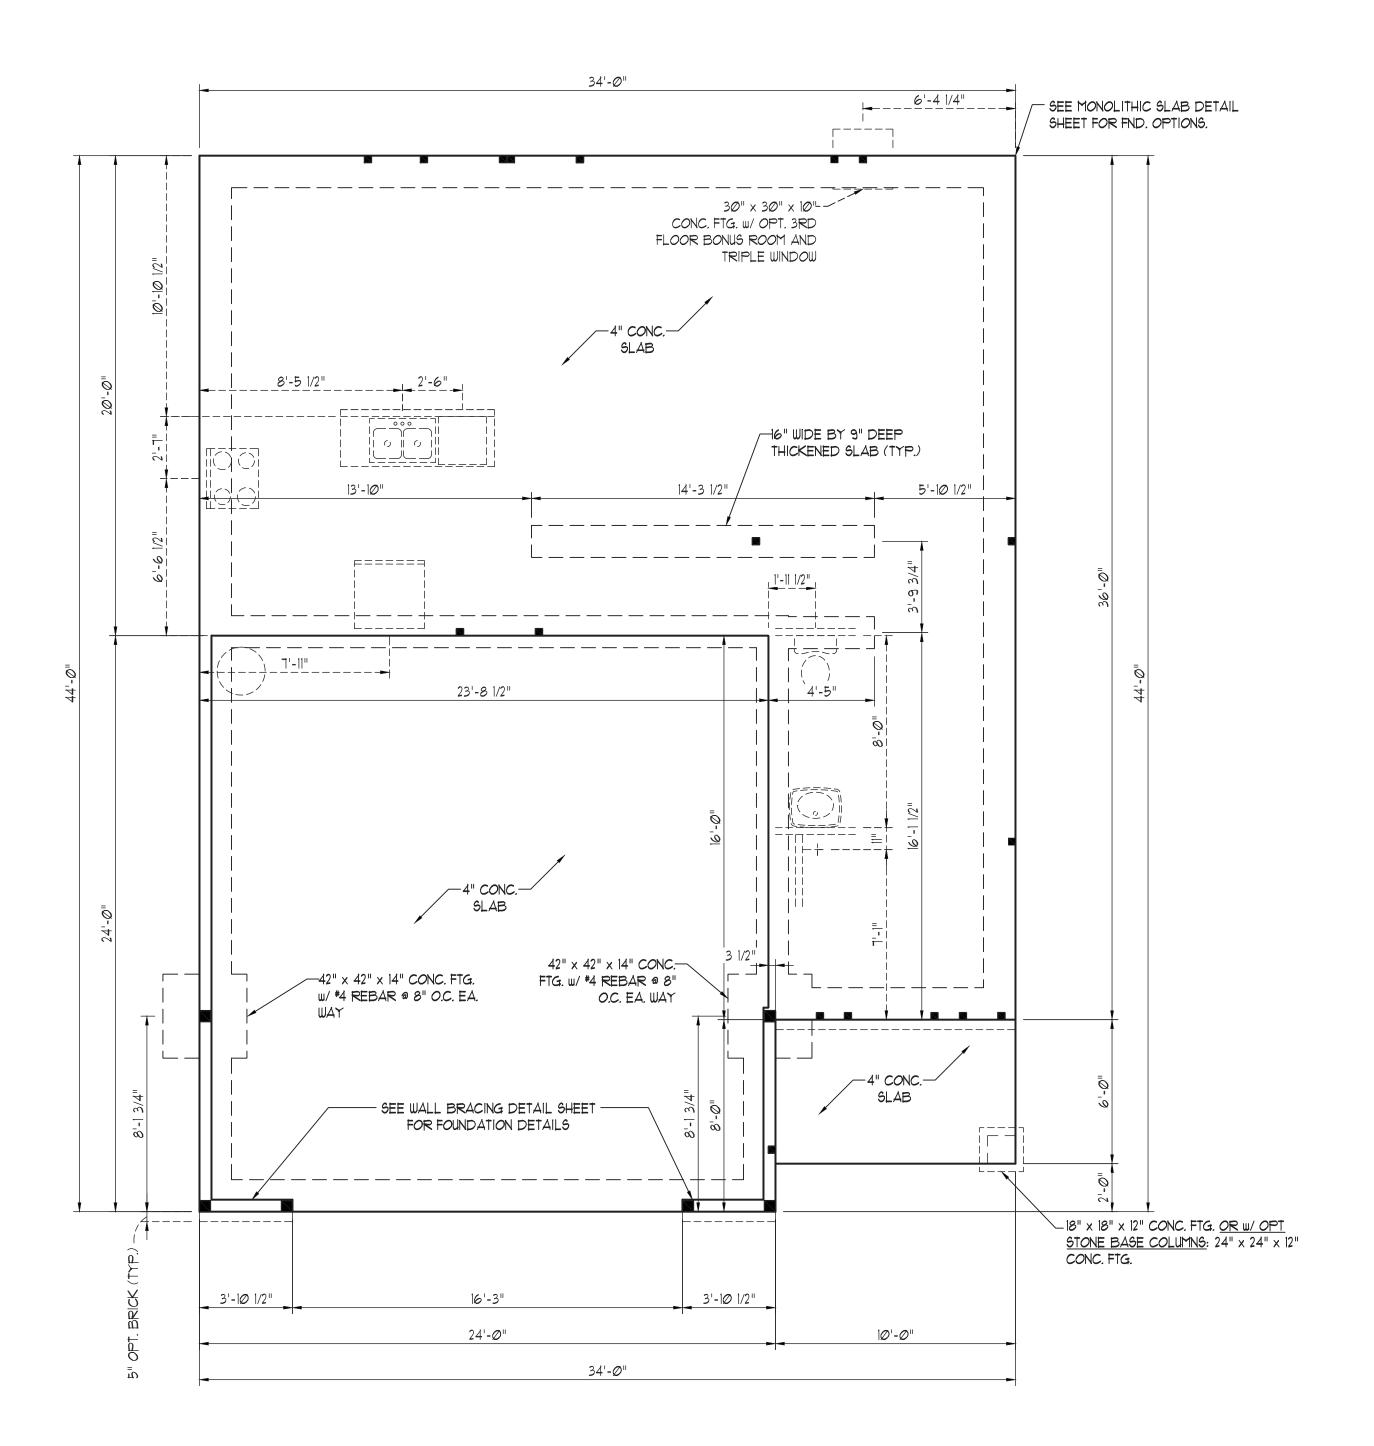

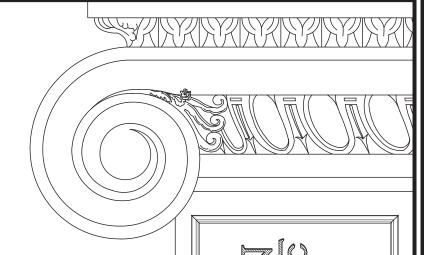

150 MPH ULTIMATE DESIGN WIND SPEED NOTES FOR LESS THAN 30' MEAN ROOF HEIGHT:

ENGINEER'S SEAL APPLIES ONLY TO

STRUCTURAL COMPONENTS. ENGINEER'S
SEAL DOES NOT CERTIFY DIMENSIONAL
ACCURACY OR ARCHITECTURAL LAYOUT
INCLUDING ROOF SYSTEM.

2. STRUCTURAL DESIGN PER NORTH
CAROLINA RESIDENTIAL CODE, 2018
EDITION WITH SPECIAL CONSIDERATION TO

CHAPTER 45 ("HIGH WIND ZONES" FOR 150 MPH WINDS).

3. BUILDER 16 TO PROVIDE FRAMING:
CONNECTIONS AS REQUIRED BY CHAPTER
45 ("HIGH WIND ZONES" FOR 150 MPH
WINDS) OF THE NORTH CAROLINA
RESIDENTIAL CODE, 2018 EDITION.

4. FOUNDATION ANCHORAGE TO COMPLY WITH SECTION 4504 OF THE NORTH CAROLINA RESIDENTIAL CODE, 2018 EDITION.

5. MEAN ROOF HEIGHT IS LESS THAN 30 FEET.

6. WALL CLADDING DESIGNED FOR +24.3 PSF

AND -32 PSF (+/- INDICATE POSITIVE / NEGATIVE PRESSURE (TYP).

1. ROOF CLADDING DESIGNED FOR +22.2 PSF AND -28 PSF FOR ROOF PITCHES 1/12 TO 12/12 AND +14 PSF AND -51 PSF FOR ROOF PITCHED 2.25/12 TO 1/12.

8. 1/16" OSB SHEATHING IS REQUIRED ON ALL EXTERIOR WALLS.
9. WALLS TO BE BRACED IN ACCORDANCE WITH SECTION R602.10 OF THE NORTH CAROLINA RESIDENTIAL CODE, 2018 EDITION AND AS NOTED ON PLANS.

EDITION AND AS NOTED ON PLANS.

10. ENERGY EFFICIENCY COMPLIANCE AND INSULATION VALUES OF THE BUILDING TO BE IN ACCORDANCE WITH CHAPTER II OF THE NCRC, 2018 EDITION.

120 MPH ULTIMATE DESIGN WIND SPEED NOTES FOR LESS THAN 30' MEAN ROOF HEIGHT:

I. ENGINEER'S SEAL APPLIES ONLY TO STRUCTURAL COMPONENTS, ENGINEER'S SEAL DOES NOT CERTIFY DIMENSIONAL ACCURACY OR ARCHITECTURAL LAYOUT

ACCURACY OR ARCHITECTURAL LAYOUT INCLUDING ROOF SYSTEM.

2. STRUCTURAL DESIGN PER NORTH CAROLINA RESIDENTIAL CODE, 2018 EDITION.

3. INSTALL 1/2" ANCHOR BOLTS 6'-0" O.C. AND WITHIN 1'-0" FROM END OF EACH CORNER.

ANCHOR BOLTS MUST EXTEND A MINIMUM OF T" INTO MASONRY OR CONCRETE. LOCATE BOLT WITHIN MIDDLE THIRD OF PLATE WIDTH.

4. MEAN ROOF HEIGHT IS LESS THAN 30 FEET.

4. MEAN ROOF HEIGHT IS LESS THAN 30 FEET.

5. EXTERIOR WALLS DESIGNED FOR 120 MPH WINDS.

6. WALL CLADDING DESIGNED FOR 155 PSF.

6. WALL CLADDING DESIGNED FOR +15.5 PSF AND -20 PSF (+/- INDICATE POSITIVE / NEGATIVE PRESSURE (TYP).
1. ROOF CLADDING DESIGNED FOR +14.2 PSF AND -18 PSF FOR ROOF PITCHES 17/2 TO 12/12 AND +10 PSF AND -36 PSF FOR ROOF

PITCHED 225/12 TO 1/12.

8. INSTALL 1/16" OSB SHEATHING ON ALL EXTERIOR WALLS OF ALL STORIES IN ACCORDANCE WITH SECTION R602.10.3 OF THE NCRC, 2018 EDITION. SEE THE WALL BRACING NOTES AND DETAILS SHEET FOR MORE INFORMATION

MORE INFORMATION.

9. ENERGY EFFICIENCY COMPLIANCE AND INSULATION VALUES OF THE BUILDING TO BE IN ACCORDANCE WITH CHAPTER II OF THE NCRC, 2018 EDITION.

10. REFER TO NOTES AND DETAIL SHEETS FOR ADDITIONAL STRUCTURAL INFORMATION.

SCALE: 1/4" = 1'.0"

DRAWN BY: TT

DATE: MAY 21, 2021

ENGINEERED BY: JAG

136 & C


N N

SHEET: 2 OF: 17

S-1b

MONO SLAB
FOUNDATION PLAN



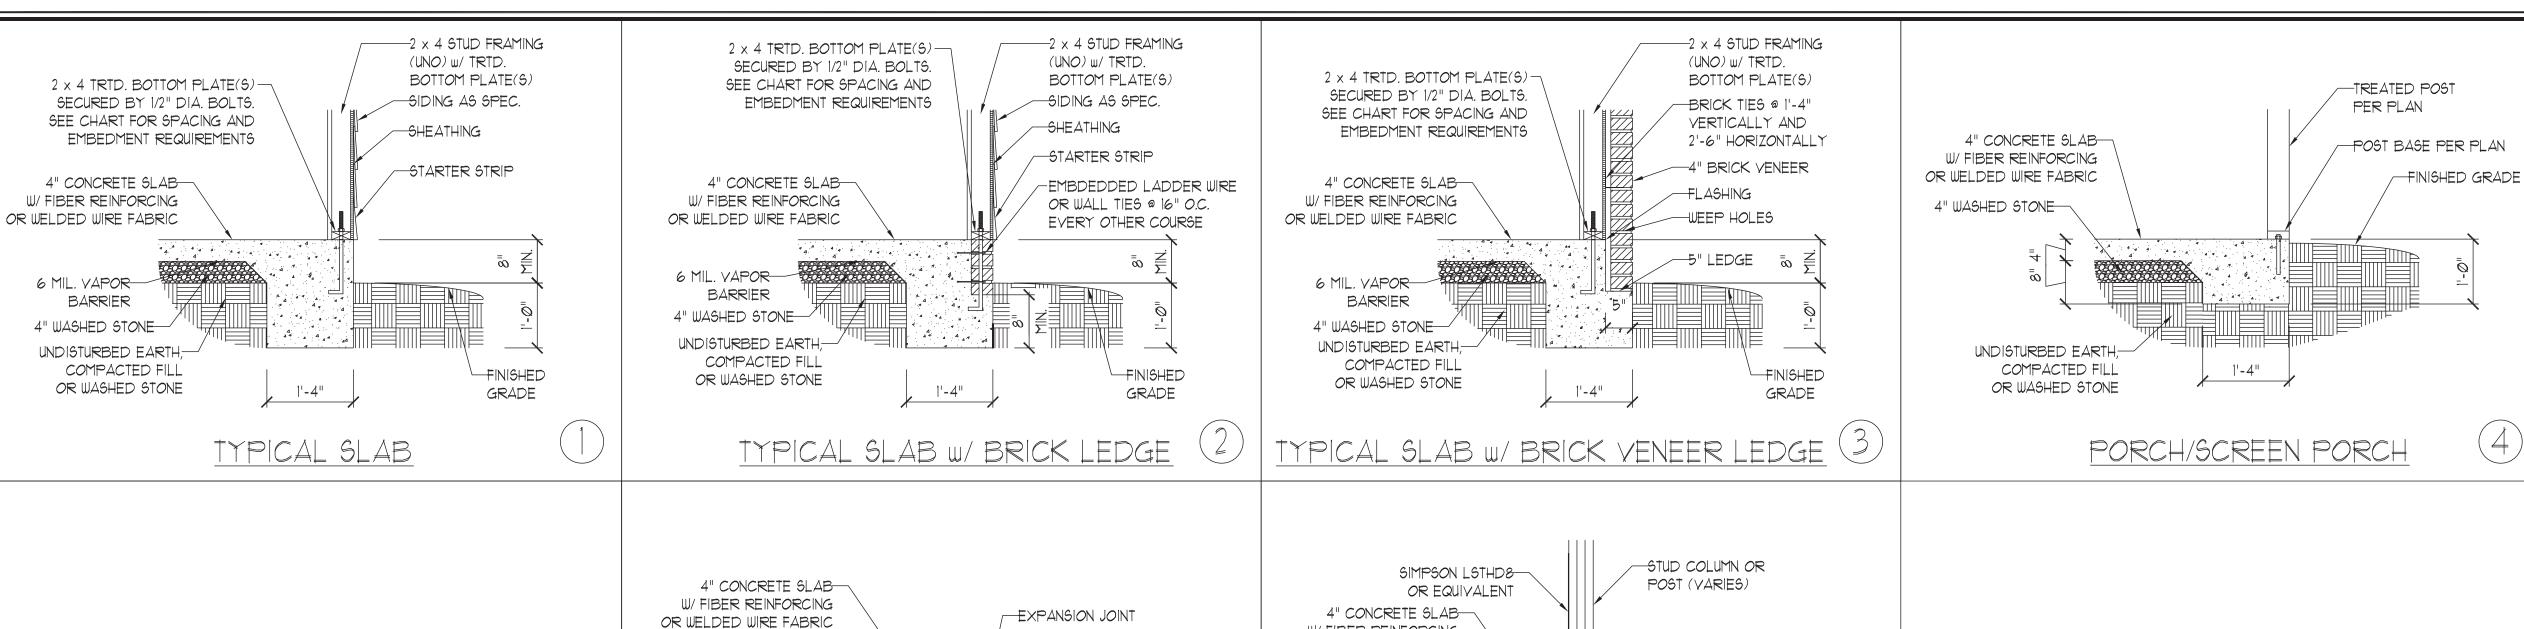

W/ FIBER REINFORCING OR WELDED WIRE FABRIC 4" WASHED STONE ENLARGED FOOTING -UNDISTURBED EARTH, PER PLAN COMPACTED FILL OR WASHED STONE TYPICAL COLUMN TO (6)SLAB CONNECTION

2 x 4 TRTD. BOTTOM PLATE(S)--EXTERIOR WALL: SECURED BY 1/2" DIA. BOLTS. 2 x 4 STUD FRAMING (UNO) SEE CHART FOR SPACING AND w/ TRTD. BOTTOM PLATE(S) EMBEDMENT REQUIREMENTS SIDING AS SPEC. SHEATHING 4" CONCRETE SLAB STARTER STRIP W/ FIBER REINFORCING OR WELDED WIRE FABRIC 6 MIL. VAPOR— BARRIER 4" WASHED STONE-UNDISTURBED EARTH COMPACTED FILL OR WASHED STONE 1'-4" FINISHED GRADE 8

GARAGE CURB

TYPICAL THICKENED SLAB

-UNDISTURBED EARTH,

COMPACTED FILL

OR WASHED STONE

4" CONCRETE SLAB-

W/ FIBER REINFORCING OR WELDED WIRE FABRIC

4" WASHED STONE

 -2×4 STUD FRAMING (UNO) W/ TRTD. BOTTOM PLATE(S) 2 x 4 TRTD. BOTTOM PLATE(S) -SECURED BY 1/2" DIA. BOLTS. BRICK TIES @ SEE CHART FOR SPACING AND 1'-4" YERTICALLY AND EMBEDMENT REQUIREMENTS 2'-6" HORIZONTALLY 4" BRICK VENEER FLASHING 4" CONCRETE SLAB -WEEP HOLES W/ FIBER REINFORCING ∕−5" LEDGE OR WELDED WIRE FABRIC 6 MIL. VAPOR-BARRIER 4" WASHED STONE UNDISTURBED EARTH,— COMPACTED FILL OR WASHED STONE -FINISHED GRADE 1'-4"

GARAGE CURB W/ BRICK LEDGE


1'-4"

SLAB FLOOR CHANGE

6 MIL. VAPOR-BARRIER 4" WASHED STONE

UNDISTURBED EARTH,-COMPACTED FILL

OR WASHED STONE

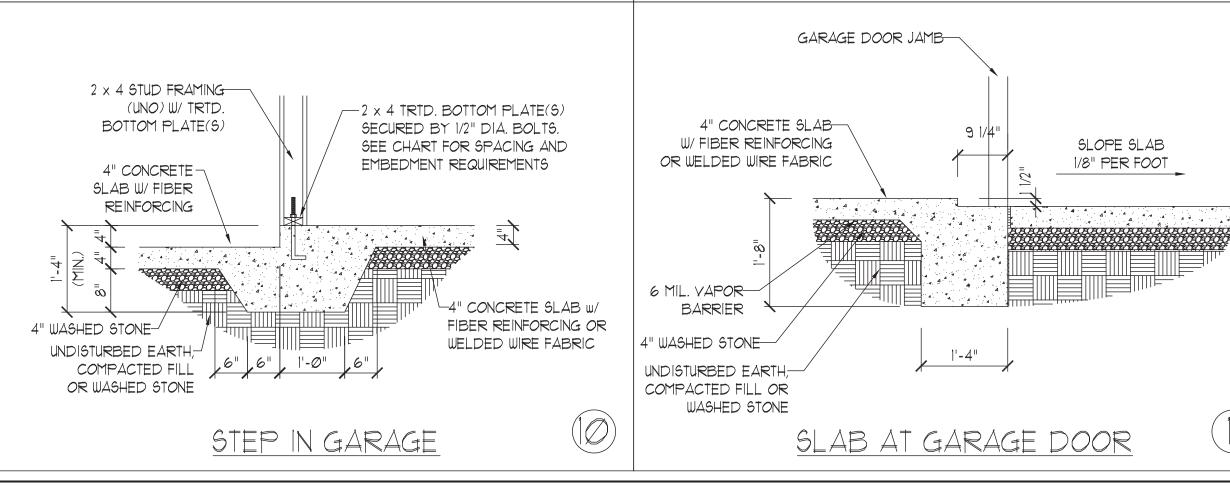

ANCHOR SPACING AND EMBEDMENT			
WIND ZONE	120 MPH	130 MPH	
SPACING	6'-0" O.C. INSTALL MIN. (2) ANCHORS PER PLATE SECTION AND (1) ANCHOR WITHIN 12" OF CORNERS	4'-0" O.C. INSTALL MIN. (2) ANCHORS PER PLATE SECTION AND (1) ANCHOR WITHIN 12" OF CORNERS	
EMBEDMENT	7"	15" INTO MASONRY 7" INTO CONCRETE	

NOTE: THREADED ROD WITH EPOXY, SIMPSON TITEN HD, OR APPROVED ANCHORS SPACED AS REQUIRED TO PROVIDE EQUIVALENT ANCHORAGE TO 1/2" DIAMETER ANCHOR BOLTS MAY BE USED IN LIEU OF 1/2" ANCHOR BOLTS.



This sealed page is to be used in conjunction with a full plan set engineered by J.S. Thompson Engineering, Inc. only. Use of this individual sealed page within architectural pages or shop drawings by others is a punishable offense under N.C. Statute § 89C-23

SLAB ETAIL MONOLITHIC FOUNDATION D

DATE: NOVEMBER 1, 2018 SCALE: NTS DRAWN BY: JST

ENGINEERED BY: JST

FOUNDATION

DETAILS