GENERAL NOTES:

- 1. IT IS THE CONTRACTORS RESPONSIBILITY TO VERIFY THAT ALL DIMENSIONS, ROOF PITCHES, AND SQUARE FOOTAGE ARE CORRECT PRIOR TO CONSTRUCTION. K&A HOME DESIGNS, INC. IS NOT RESPONSIBLE FOR ANY DIMENSIONING, ROOF PITCH, OR SQUARE FOOTAGE ERRORS ONCE CONSTRUCTION BEGINS.
- 2. ALL WALLS SHOWN ON THE FLOOR PLANS ARE DRAWN AT 4" UNLESS NOTED OTHERWISE.
- 3. ALL ANGLED WALL SHOWN ON THE PLANS ARE 45 DEGREES UNLESS NOTED OTHERWISE.
- 4. STUD WALL DESIGN SHALL CONFORM TO ALL NORTH CAROLINA STATE BUILDING CODE REQUIREMENTS.
- 5. DO NOT SCALE PLANS. DRAWING SCALE MAY BE DISTORTED DUE TO COPIER IMPERFECTIONS.
- 6. ALL CONSTRUCTION SHALL BE IN ACCORDANCE WITH NORTH CAROLINA STATE BUILDING CODE, 2018 EDITION.

SQUARE FOOTAGE

HEATED SQUARE FOOTAGE		UNHEATED SQUARE FOO			
FIRST FLOOR =	1645	GARAGE=	560		
SECOND FLOOR=	N/A	FRONT PORCH=	128		
THIRD FLOOR =	N/A	SCREEN PORCH=	144		
BASEMENT=	N/A	DECK=	120		
		STORAGE =	N/A		

TOTAL HEATED = 1645 TO TAL UNHEATED = 952

CRAWL SPACE VENTILATION CALCULATIONS

-VENT LOCATIONS MAY VARY FROM THOSE SHOWN ON THE PLAN BUT SHOULD BE PLACED TO PROVIDE ADEQUATE VENTILATION AT ALL POINTS TO PREVENT DEAD AIR POCKETS.

-100% VAPOR BARRIER MUST BE PROVIDED WITH 12" MIN. LAP JOINTS.

-THE TOTAL AREA OF VENTILATION OPENINGS MAY BE REDUCED TO 1/1500 AS LONG AS REQUIRED OPENINGS ARE PLACED SO AS TO PROVIDE CROSS-VENTILATION OF THE SPACE. THE INSTALLATION OF OPERABLE LOUVERS SHALL NOT BE PROHIBITED. (COMPLY WITH NC CODE MIN. WITH REGARD TO VENT PLACEMENT FROM CORNERS)

1645 SQ. FT. OF CRAWL SPACE/1500

1.09 SQ. FT. OF REQUIRED VENTILATION

PROVIDED BY: 3 VENTS AT 0.45 SQ. FT. NET FREE VENTILATION EACH= 1.35 SQ. FT. OF VENTILATION

**FOUNDATION DRAINAGE- WATER PROOFING PER SECTIONS 405 & 406.

ATTIC VENTILATION CALCULATIONS

- CALCULATIONS SHOWN BELOW ARE BASED ON VENTILATORS USED AT LEAST 3 FT. ABOVE THE CORNICE VENTS WITH THE BALANCE OF VENTIALTION PROVIDED BE EAVE VENTS.

- CATHEDRAL CEILINGS SHALL HAVE A MIN. 1" CLEARANCE BETWEEN THE BOTTOM OF THE ROOF DECK AND THE INSULATION.

2477 SQ. FT. OF ATTIC/300= EACH OF INLET AND OUTLET REQUIRED.

*WALL AND ROOF CLADDING DESIGN VALUES

- WALL CLADDING IS DESIGNED FOR A 24.1 SQ. FT. OR GREATER POSITIVE AND NEGATIVE PRESSURE.

- ROOF VALUES BOTH POSITVE AND NEGATIVE SHALL BE AS FOLLOWS:

45.5 LBS. PER SQ. FT. FOR ROOF PITCHES OF 0/12 TO 2.25/12

34.8 LBS. PER SQ. FT. FOR ROOF PITCHES OF 2.25/12 TO 7/12

21 LBS. PER SQ. FT. FOR ROOF PITCHES OF 7/12 TO 12/12

** MEAN ROOF HEIGHT 30' OR LESS




FRONT ELEVATION

1/4" = 1'-0"




REAR ELEVATION

1/8" = 1'-0"

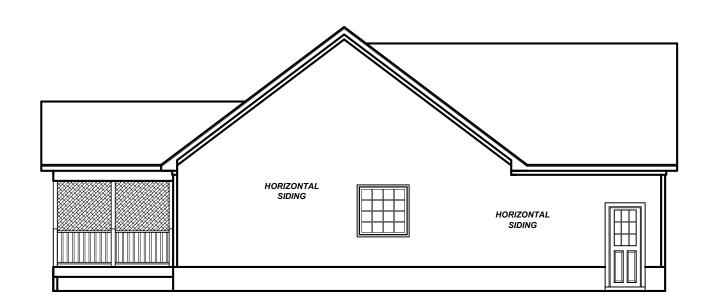

LEFT ELEVATION 1/8" = 1'-0"

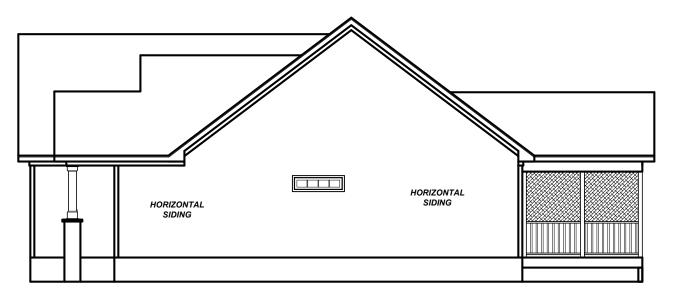

RIGHT ELEVATION

1/8" = 1'-0"


13KB-164 10-31-13 KBB Scale: REFER TO ELEV.

Remarks

IC 27603 9) 302-0693 661-2632 Ten-Ten Rd 9101 Ten-Ter Raleigh, NC 2 Office: (919) 3 Fax: (919) 66

David

ELEVATIONS

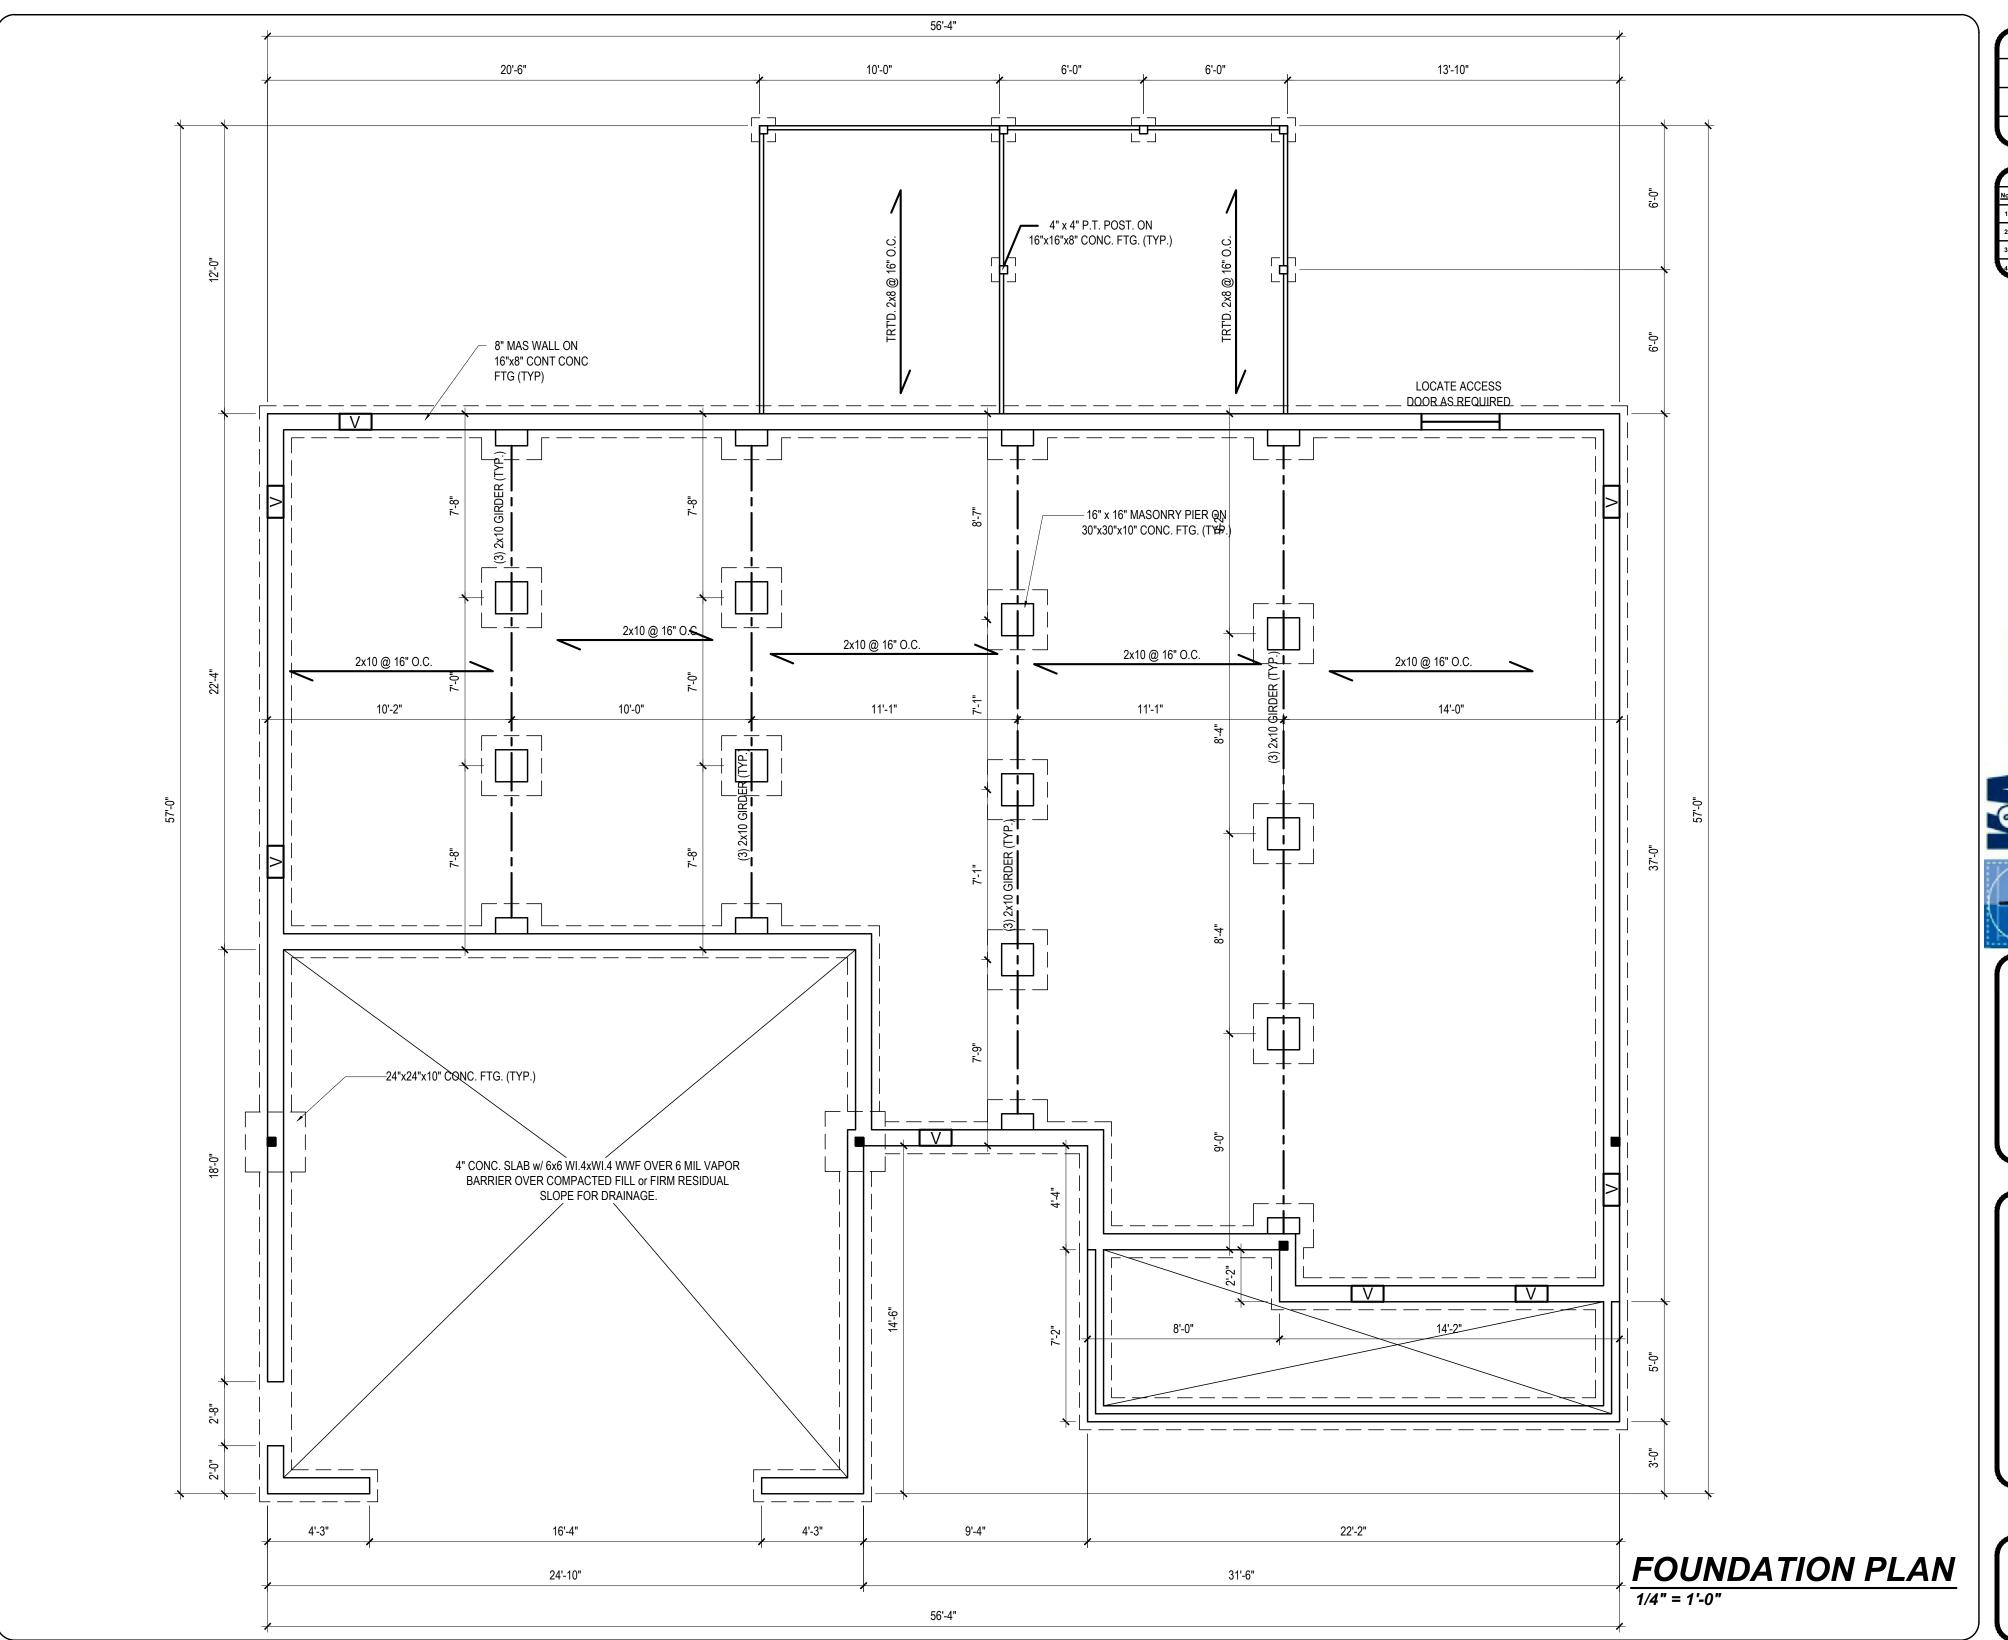

Date: 10-31-13 Drawn/Design By: Scale: 1/4" = 1'-0"

Remarks Date:

9101 Ten-Ten Rd. Raleigh, NC 27603 Office: (919) 302-0693 Fax: (919) 661-2632




The David II (Garage Left)

Co., LLCTwin Acres Rd. Building, LLC 2393 Twir Clayton, 00

FOUNDATION

Sheet Number

of 7

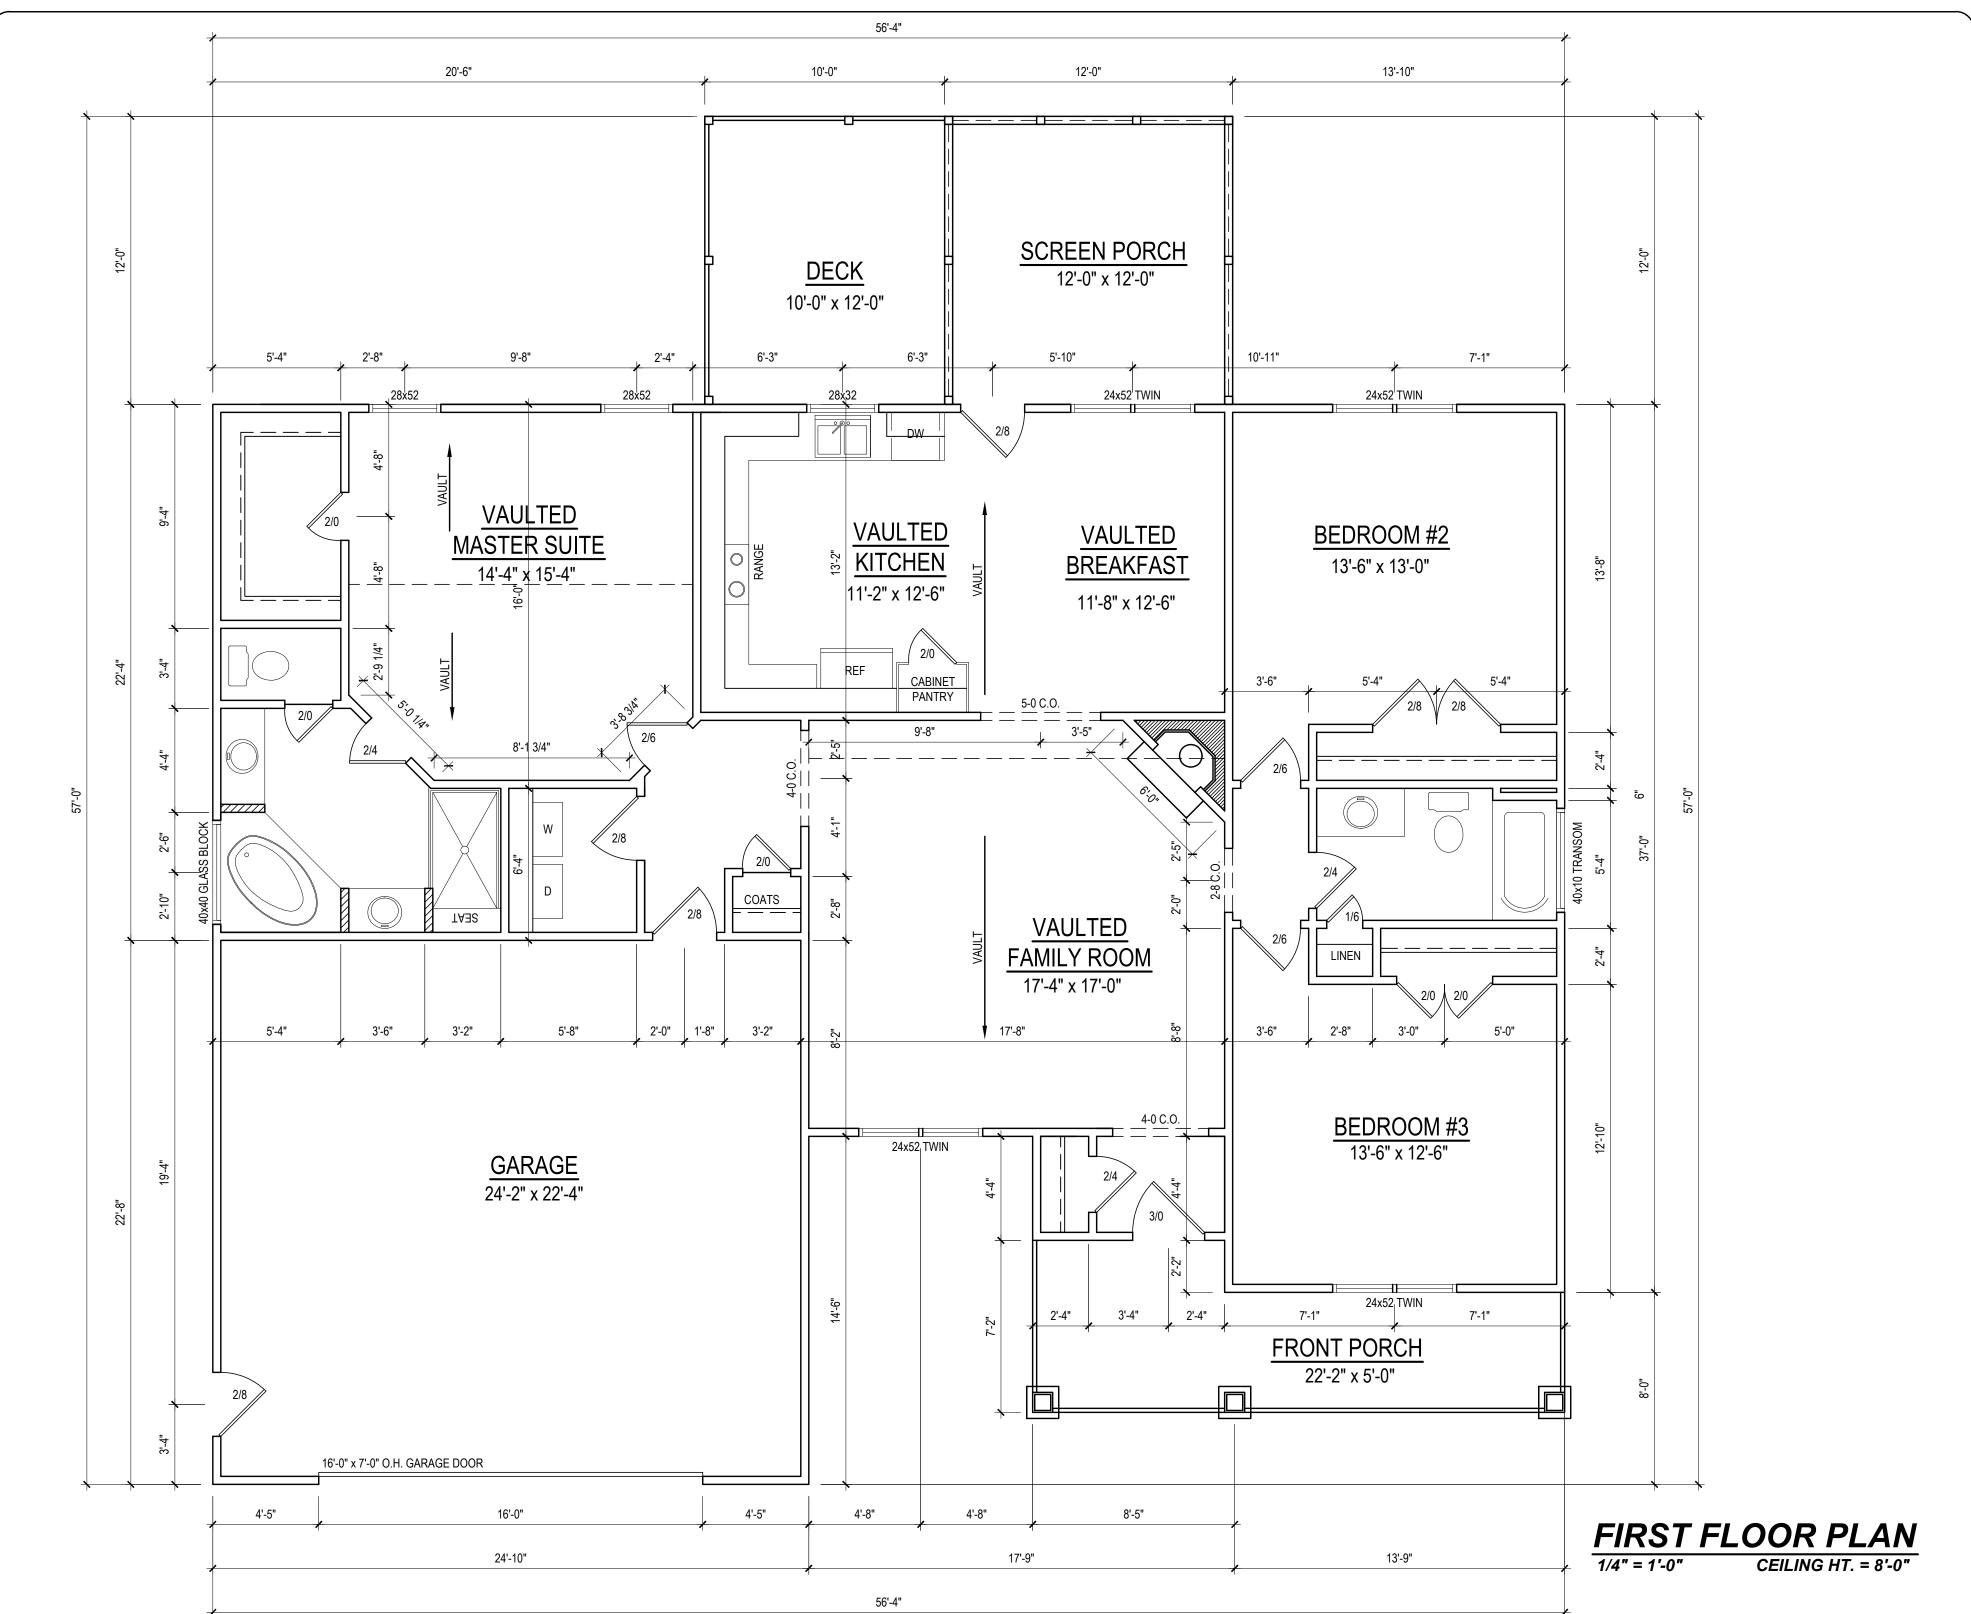

Project #: 13KB-164 Date: 10-31-13 Drawn/Design By: Scale: 1/4" = 1'-0"

> Remarks Date:


9101 Ten-Ten Rd. Raleigh, NC 27603 Office: (919) 302-0693 Fax: (919) 661-2632

Website: www.KandAHomeDesigns.com

The David II (Garage Left)

00

FIRST FLOOR

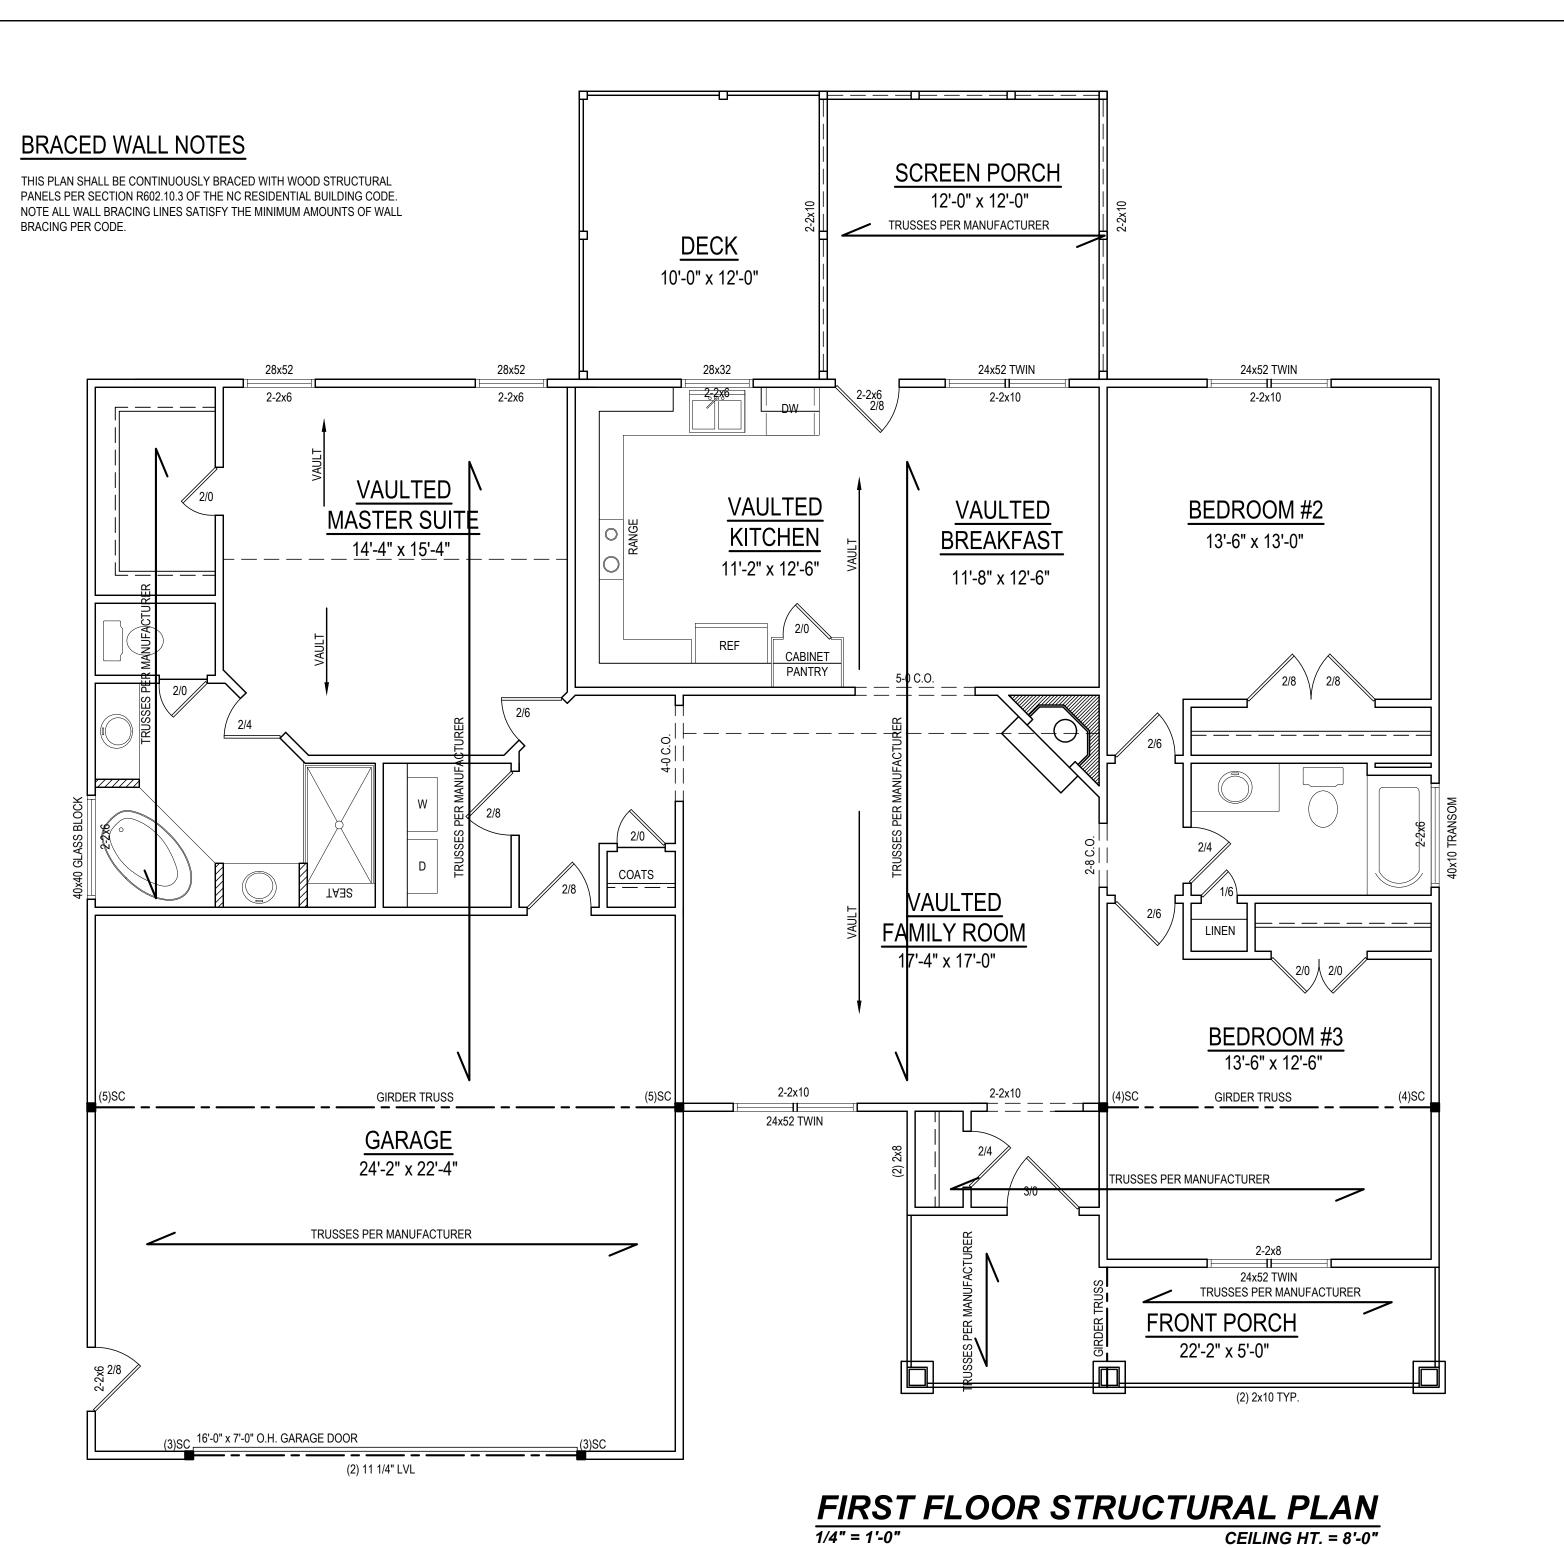

Project #:

Date:

Drawn/Design By:


KBB

Scale:

1/4" = 1'-0"

9101 Ten-Ten Rd. Raleigh, NC 27603 Office: (919) 302-0693 Fax: (919) 661-2632

DESIGNS
Where Dreams Become Reality

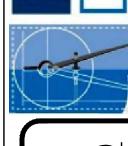

The David II (Garage Left)


Co., LLC
Twin Acres Rd.

FIRST FLOOR

FIRST FLOOR STRUCTURAL

Sheet Number

4

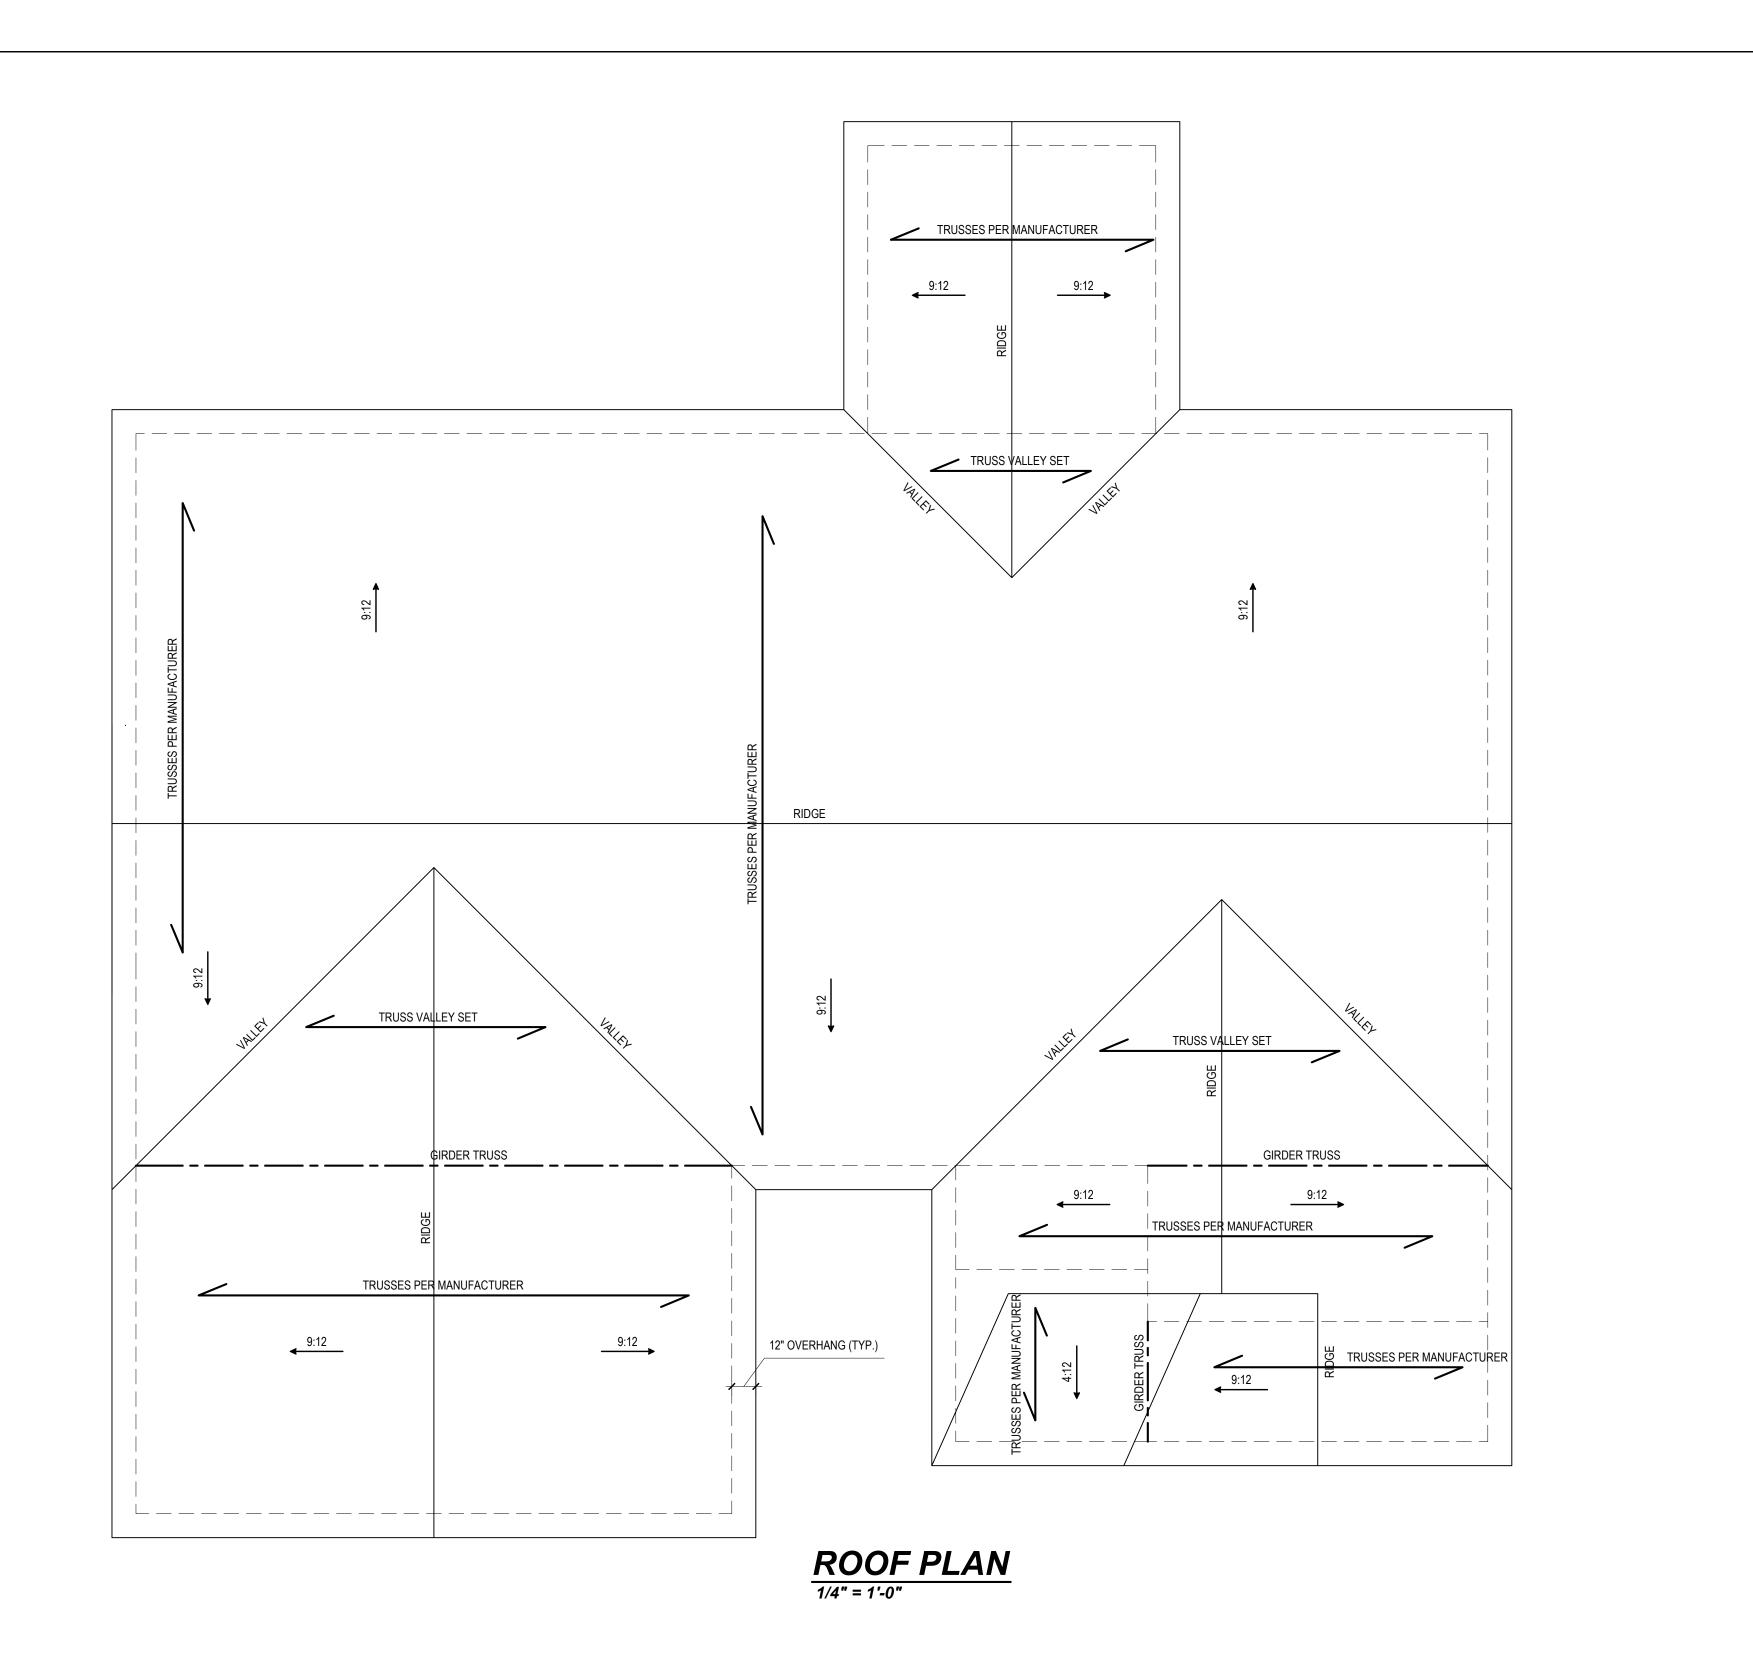

Project #: 13KB-164 <u>Date:</u> 10-31-13 Drawn/Design By:

Scale: 1/4" = 1'-0" Remarks Date:

9101 Ten-Ten Rd. Raleigh, NC 27603 Office: (919) 302-0693 Fax: (919) 661-2632

Website: www.KandAHomeDesigns.com

Email: Kent@KandAHomeDesigns.com

ROOF LAYOUT

00

The David II (Garage Left)

13KB-164

en-T

DETAILS

6

STRUCTURAL NOTES 1) ALL CONSTRUCTION SHALL CONFORM TO THE LATEST REQUIREMENTS OF "NORTH CAROLINA STATE 2018 RESIDENTIAL BUILDING CODE", IN ADDITION TO ALL LOCAL CODES AND REGULATIONS.


	LIVE LOAD (PSF)	DEAD LOAD (PSF)	DEFLECTION (DL & LL)	
ALL FLOORS	40	10	L/360	
ATTIC (pull down access)	20	10	L/240	
ATTIC (no access)	10	5	L/240	
EXTERNAL BALCONY	60	10	L/360	
ROOF	20	10	L/180	
ROOF TRUSS	20	20	L/240	
WIND LOAD	[BASED ON 115MPH (3-second gusts)]			

- NINIMUM ALLOWABLE SOIL BEARING PRESSURE = 2000 PSF
- 4) CONCRETE SHALL HAVE A MINIMUM 28 DAY STRENGTH OF 3000 PSI AND A MAXIMUM SLUMP OF FIVE INCHES UNLESS NOTED OTHERWISE (UNO).
- 6) MAXIMUM DEPTH OF UNBALANCED FILL AGAINST FOUNDATION WALLS TO BE LESS THAN 4:0" WITHOUT USING SUFFICIENT WALL BRACING. REFER TO SECTION R404 OF 2018 NC BUILDING CODE FOR BACKFILL LIMITATIONS BASED ON WALL HEIGHT, WALL THICKNESS, SOIL TYPE, AND UNBALANCED BACKFILL HEIGHT
- 6) ALL FRAMING LUMBER SHALL BE SYP #2 (Fb = 800 PSI) UNO. ALL FRAMING LUMBER EXPOSED TO THE ELEMENTS SHALL BE TREATED MATERIAL.
- 7) ALL LOAD BEARING HEADERS SHALL BE (2)2x10 (UNO). ALL WINDOW AND DOOR HEADERS SHALL BE SUPPORTED BY (1) JACK STUD AND (1) KING STUD AT EACH END UNLESS NOTED. ALL OTHER BEAMS SHALL BE SUPPORTED BY 2 STUDS OR THE AMOUNT OF STUDS REQUIRED FOR FULL BEARING AT EACH END UNLESS NOTED. POINT LOADS (STIFF KNEES, ETC.) SHALL CONSIST OF 2 STUDS UNLESS NOTED. ALL SUPPORTS OF 2 STUDS OR MORE SHALL BE TRANSFERRED THROUGH
- 8) ALL EXTERIOR WALLS TO BE SHEATHED WITH MIN. 7/16" WOOD STRUCTURAL PANELS FASTNED WITH 8D NAILS 6" O.C. AT EDGES AND 12" O.C. AT INT. SUPPORTS. BLOCKING SHALL BE INSTALLED IF LESS THAN 50 PERCENT OF THE WALL LENGTH IS SHEATHED. WHERE BLOCKING IS REQ'D, ALL PANELS SHALL BE FASTENED AT 3" O.C AT EDGES AND 6" O.C. AT
- P) ALL STRUCTURAL STEEL SHALL ASTM A-36. STEEL BEAMS SHALL BE SUPPORTED AT EACH END WITH A MINIMUM BEARING LENGTH OF 3-1/2" INCHES AND FULL FLANGE WIDTH. PROVIDE SOLID BEARING FROM BEAM SUPPORT TO FOUNDATION. BEAMS SHALL BE ATTACHED TO EACH SUPPORT WITH TWO LAG SCREWS (1/2 DIAMETER AND 4" LONG). LATERAL SUPPORT IS CONSIDERED ADEQUATE PROVIDING THE JOISTS ARE TOE NAILED TO THE SOLE PLATES, AND THE SOLE PLATES ARE NAILED OR BOLTED TO THE BEAM FLANGES @ 48" O.C.
- (0) ANCHOR BOLT PLACEMENT PER SECTION R403.1.6. 1/2" DIAMETER ANCHOR BOLTS SPACED AT 6'-0" O/C AND PLACED 12" FROM THE END OF EACH PLATE SECTION
- 1) FOUNDATION DRAINAGE-DAMP PROOFING OR WATERPROOFING PER SECTION 405 AND 406 OF 2018 NC BUILDING CODE
- 2) WALL AND ROOF CLADDING VALUES:
- WALL CLADDING SHALL BE DESIGNED FOR A 24.1 SQ.FT. OR GREATER POSITIVE AND NEGATIVE PRESSURE ROOF VALUES BOTH POSITIVE AND NEGATIVE SHALL BE AS FOLLOWS:
- 45.5 LBS/SQFT FOR ROOF PITCHES OF 0/12 TO 2.25/12
- 34.8 LBS/SQFT FOR ROOF PITCHES OF 2.25/12 TO 7/12 21.0 LBS/SQFT FOR ROOF PITCHES OF 7/12 TO 12/12
- ** MEAN ROOF HEIGHT 30' OR LESS
- 3) FOR ROOF SLOPES FROM 2:12 THROUGH 4:12, BUILDER TO INSTALL 2 LAYERS OF 15# FELT PAPER
- 14) IT IS THE CONTRACTOR'S RESPONSIBLITY TO VERIFY ALL DIMENSIONS AND SQ. FTG. ARE CORRECT PRIOR TO CONSTRUCTION. DESIGNER IS NOT RESPONSIBLE FOR DIMENSIONING OR SQ. FTG. ERRORS ONCE CONSTRUCTION BEGINS


ALLOWABLE SPANS FOR LINTELS

SUPPORTING MASONRY	VENEER
(1,3) Size of Angles	(2,4) Maximum Span
3-1/2" x 3-1/2" x 1/4"	6'-0"
5" x 3-1/2" x 5/16"	10'-0"


- 1. Long leg of the angle shall be placed in a vertical position.
- Spans over 4' shall be shored up until cured. 3. Steel members indicated are adequate typical examples: other steel
- requirements may be used.

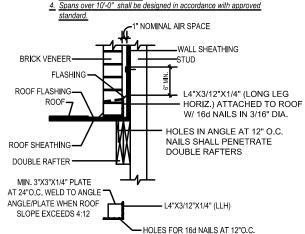


MASONRY VENEER DETAIL (FIG. 703.3(A)

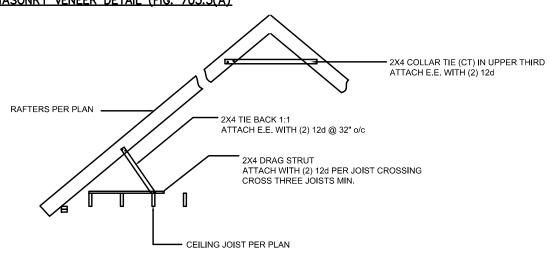

RAFTER TIE BACK DETAIL

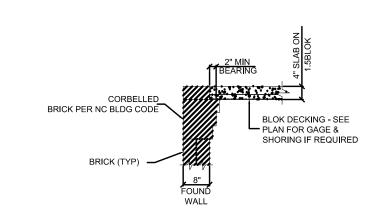


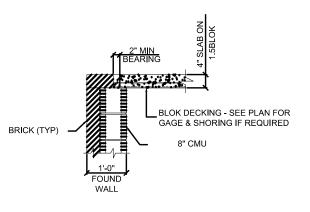


DUCRETE SLAB DU METAL DECKING DETAI

TABLE N1102.1 INSULATION AND FENESTRATION REQUIREMENTS BY COMPONENT


REQUIREMENTS BY COMI CITEMY							
	MAXIMUM			MINIMUM INSULATION R-VALUE			
CLIMATE ZONE	GLAZING U-FACTOR	CEILINGS	WALLS	FLOORS	BASEMENT WALLS	SLAB PERIMETER	CRAWL SPACE WALLS
3	.35	R-38 or R-30	R-15	R-19	R-5/13	R-0	R-5/13
4	.35	R-38 or R-30	R-15	R-19	R-10/15	R-10	R-10/15

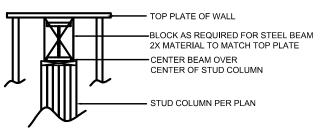


GARAGE BEAM STUD COLUMN DETAIL

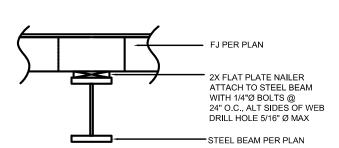


GARAGE BEAM LATERAL BRACING DETAIL

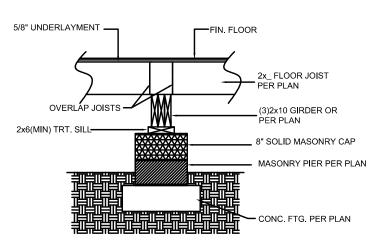


DROPPED GIRDER DETAIL

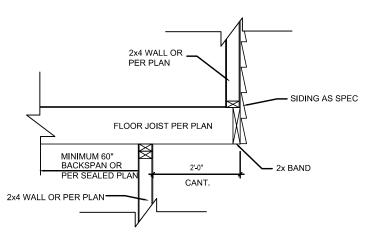

CANTILEVER FLOOR JOIST DETAIL

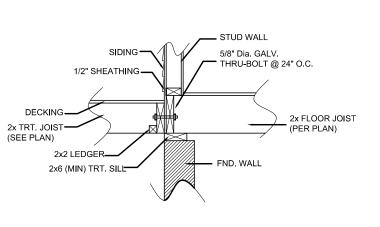

1. MAXIMUM HEIGHT OF DECK SUPPORT POSTS AS FOLLOWS: * THIS TABLE IS BASED ON NO. 2 TREATED SOUTHERN PINE POSTS. ** FROM TOP OF FOOTING TO BOTTOM OF GIRDER *** DECKS WITH POST HEIGHTS OVER 20'-0" SHALL BE DESIGNED AND SEALED BY A PROFESSIONAL ENGINEER OR REGISTERED ARCHITECT. 2. DECKS SHALL BE BRACED TO PROVIDE LATERAL STABILITY BY ONE OF THE METHODS:

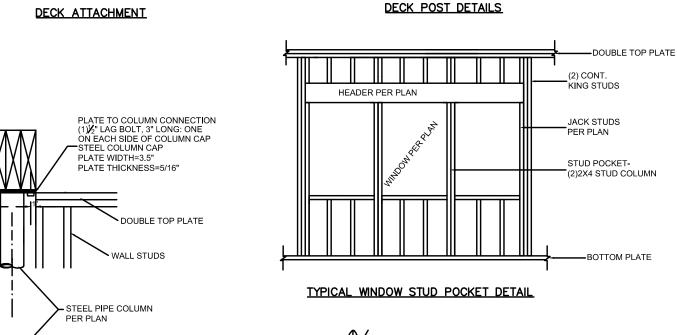


THE BRACE.

POST SIZE

4 X 4

6 X 6

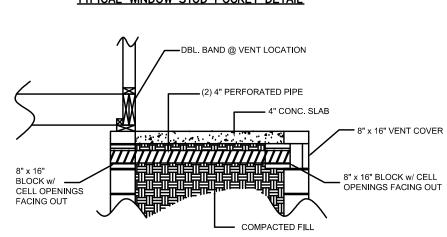

FOUNDATION VENT DETAIL AT COMPACTED FILL

OST SIZE *

4 X 4

6 X 6

A.WHEN THE DECK FLOOR HEIGHT IS LESS THAN 4' AND THE DECK

IS ATTACHED TO THE STRUCTURE IN ACCORDANCE WITH SECTION

B. 4X4 WOOD KNEE BRACES MAY BE PROVIDED ON EACH COLUMN IN

BOTH DIRECTIONS. THE KNEE BRACES SHALL ATTACH TO EACH

POST AT A POINT NOT LESS THAN $\frac{1}{3}$ OF THE POST LENGTH FROM

THE TOP OF THE POST, AND THE BRACES SHALL BE ANGLED BETWEEN 45° AND 60° FROM THE HORIZONTAL. KNEE BRACES

SHALL BE NAILED TO THE POST AND THE GIRDER OR BOLTED

THE POSTS IN ACCORDANCE WITH THE FOLLOWING:

AREA

120 SF

WITH ONE 5/8" HOT DIPPED GALVANIZED BOLT AT EACH END OF

C. FOR FREESTANDING DECKS WITHOUT KNEE BRACES OR DIAGONAL BRACING, LATERAL STABILITY MAY BE PROVIDED BY EMBEDDING

HEIGHT

4'-0"

6'-0"

TO THE STRUCTURE AT THE EXTERIOR COLUMN LINE FOR ATTACHED DECKS.

D 2x6 DIAGONAL VERTICAL ROSS-BRACING MAY BE PROVIDED IN TWO

PERPIINDICULAR DIRECTIONS FOR FREESTANDING DECKS OR PARALLEL

DEPTH

2'-6"

1'-0"

AM104, LATERAL BRACING IS NOT REQUIRED.

8'-0"


20'-0" OVER 20'-0"

STEEL COLUMN AT WALL

COLUMN BASE

PLATE WIDTH=3.5"

PLATE THICKNESS=5/16"

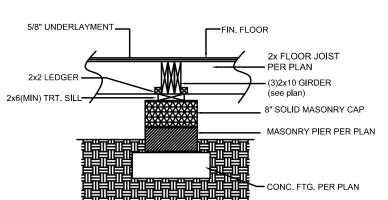


WALL STUDS

PLATE TO COLUMN CONNECTION


(i.e. REDHEAD) ON EACH SIDE OF


- (1) 1/2"x6" COMPRESSION FIT ANCHOR

FLUSH GIRDER DETAIL

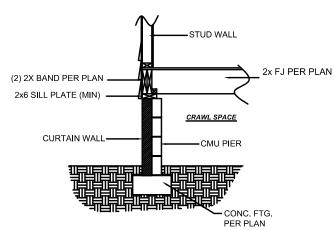


CURTAIN WALL DETAIL

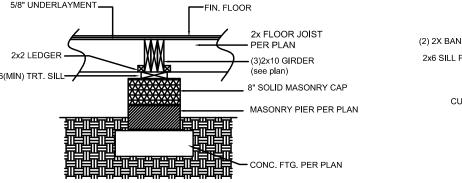

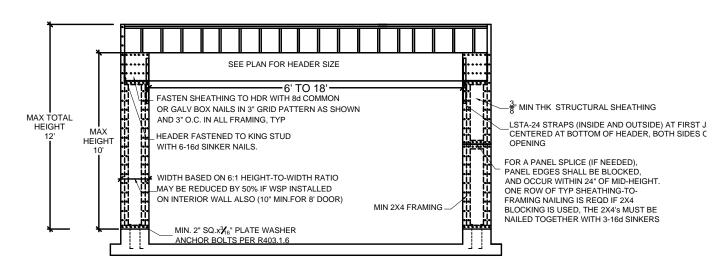

METHOD CS-PF PORTAL FRAME

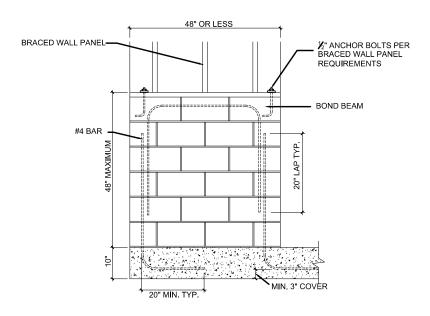

BRACED WALL LINE STEMWALL DETAIL



13KB-164 Date: 10-31-13 Drawn/Design By: KBB Scale: NTS

Date:

REVISIONS

9101 Ten-Ten Rd. Raleigh, NC 27603 Office: (919) 302-0693 Fax: (919) 661-2632

Website: www.KandAHomeDesigns.com


Email: Kent@KandAHomeDesigns.com

Remarks


The David (Garage


Co., LLC 2393 Twin Acres Rd


DETAILS

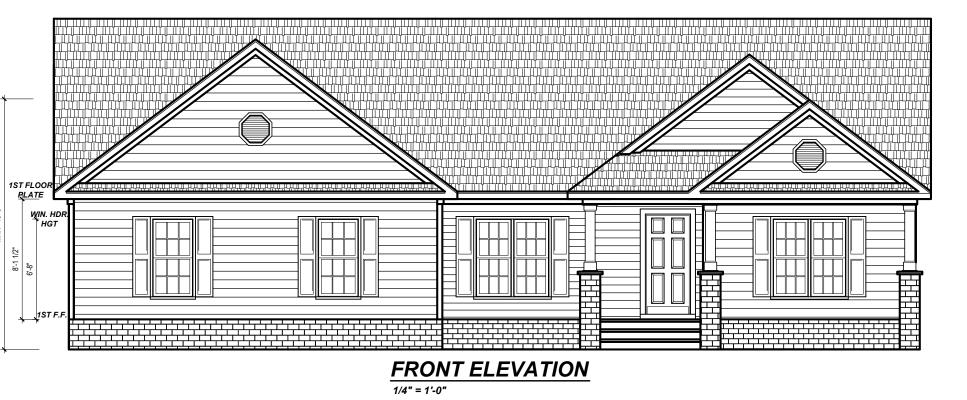



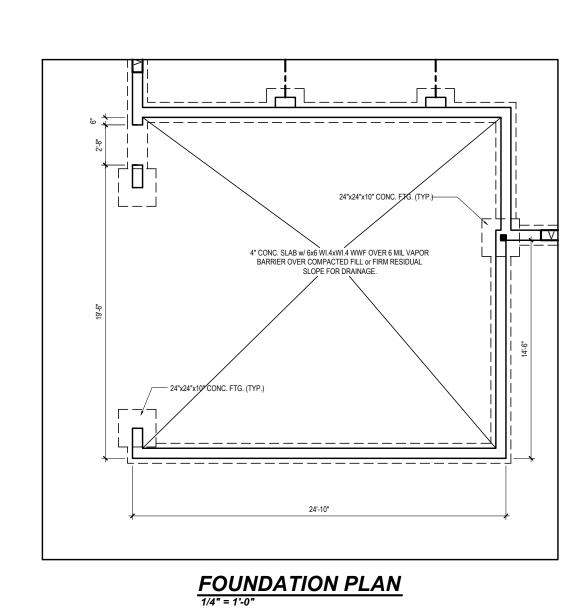

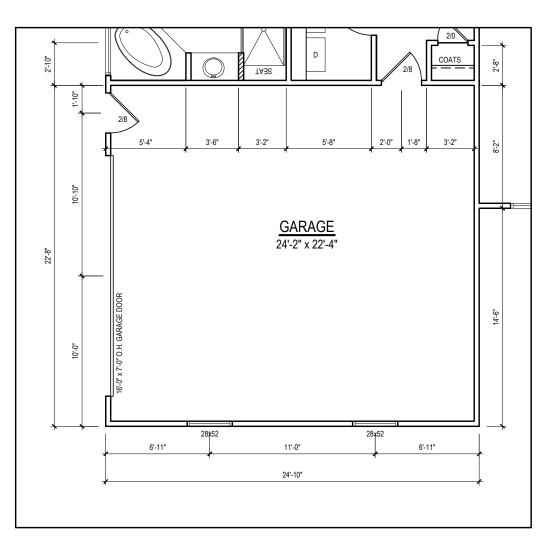

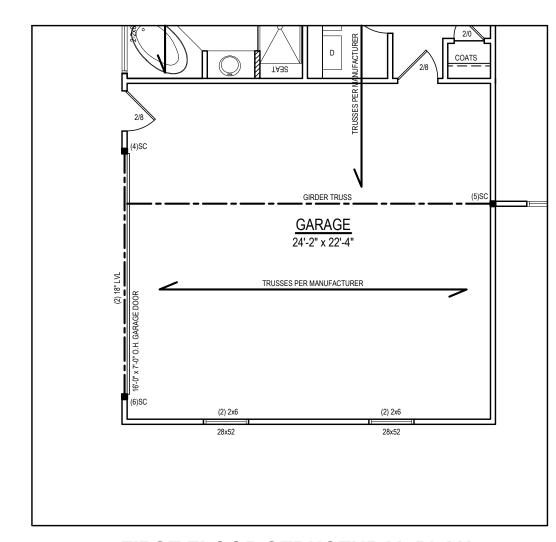

FIRST FLOOR PLAN

1/4" = 1'-0" CEILING HT. = 8'-0"

FIRST FLOOR STRUCTURAL PLAN

1/4" = 1'-0"

CEILING HT. = 8'-0"

The David II (Garage Left)

Project #: 13KB-164

Date: 10-31-13

Drawn/Design By:

Scale: 1/4" = 1'-0"

Remarks

9101 Ten-Ten Rd. Raleigh, NC 27603 Office: (919) 302-0693 Fax: (919) 661-2632

Website: www.KandAHomeDesigns.com

Email: Kent@KandAHomeDesigns.com

SIDE LOAD OPTION