



LEFT ELEVATION

SCALE: 1'= 1/4"

I ASSUME NO RESPONSIBILITY FOR ANY DISTANCES AFTER START OF CONSTRUCTION, CONTRACTOR/BUILDER SHALL CONSULT WITH HOME OWNER ON ALL INTERIOR AND EXTERIOR MOLDINGS, TRIMS, COLORS, FINISHES, CABINET LAYOUTS, AND MANUFACTORS BEFORE CONSTRUCTION BEGINS.
ALL BEAMS AND FRAMING MEMBERS ARE SIZED BY OTHERS.

1.1 This plan has been drawn to comply with the 2018 NC Building Code

- 1.2 Minimum Design Loads for Building and Other Structures ASCE 7-9B
- 2 Roof Dead Load 115 PSF 3 Roof Live Load 20 PSF
- 4 Typical Floor Dead Load 10 PSF
- 5 Floor Live Loads
- 5.1 Rooms other than sleeping rooms 40 PSF
- 5.2 Sleeping Rooms 30 PSF
- 5.3 Stairs 40 PSF
- 5.4 Decks 40 PSF 5.5 Exterior Balconies 60 PSF
- 6 Wind Loads
- 6.1 Ultimate Design Wind Speeds 15 MPH
- 6.2 Wind Importance Factor, IW 1.00
- 6.3 Exposure B
- 6.4 Walls (Component and Cladding) 25 PSF
- 6.5 Roofs (Component and Cladding)
 6.5.1 Roof Slopes 2.25/12 to 7/12 34.8 PSF
 6.5.2 Roof Slopes 7/12 to 12/12 21 PSF

It is the sole responsibility of the Contractor and/or Builder to conform to all standards, provisions, requirements, methods of construction and uses of materials provided in buildings and/or structures as required by NC Uniform Building Code, Local Agencies and in accordance with good engineering practices. Verify all dimensions prior to construction.





REAR ELEVATION

GCALE: 1'= 1/4"

PAGE #:

Diane Rives Designs 6205 Mockingbird Lane 899-110-0353

SCALE: 1'= 1/4" DRAWN BY:

TOM HOUSE FLAN FO

TYPICAL WALL: BRICK & 4" BLOCK W/ 16" X 10" FOOTING 8" BLOCK W/16" X 10" FOOTING (3)- 2 X 10'5 GIRDER 2 X 10'5 16" OC JOIST (2)- 2 X 10'5 DBL JOIST

FOUNDATION NOTES: ALL FOOTINGS SHALL BEAR ON ORIGINAL UNDISTURBED SOIL. THE 28 DAY COMPRESSIVE STRENGTH OF ALL FOOTINGS IS 3000 PSI

PROVIDE WATER PROOFING AND PERIMETER DRAINS AS REQUIRED.


FOUNDATION CONCRETE MIX TO HAVE 1-1/2" MAX AGGREGATE SIZE, CONCRETE FILL MIX TO HAVE 1/2" MAX AGGREGATE SIZE,

FOOTING WIDTHS ARE BASED ON A LOAD-BEARING SOIL CAPACITY OF 2000 PSI.

PROVIDE 6 MIL POLY VAPOR BARRIER TO COVER GROUND SURFACE IN CRAWL SPACE


ALL ANCHOR BOLTS TO BE 12" LONG, 1/2" DIA. A36 UNO ANCHOR BOLTS SHALL BE SPACE AT A MAX OF 6' OC AND NO MORE THAN 1' FROM EA CORNER.

Termite Soil Treatment: Treat entire slab area soil or crawl space surface before vapor barrier is installed and slab is poured with a state approved termiticide. Termiticide should be applied by a licensed and certified pest control professional by the state of North Carolina.

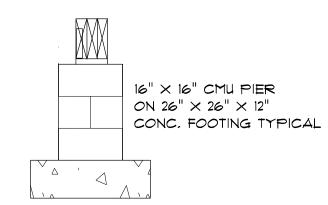


CONCRETE BLOCK PIER DETAIL

NOT TO SCALE

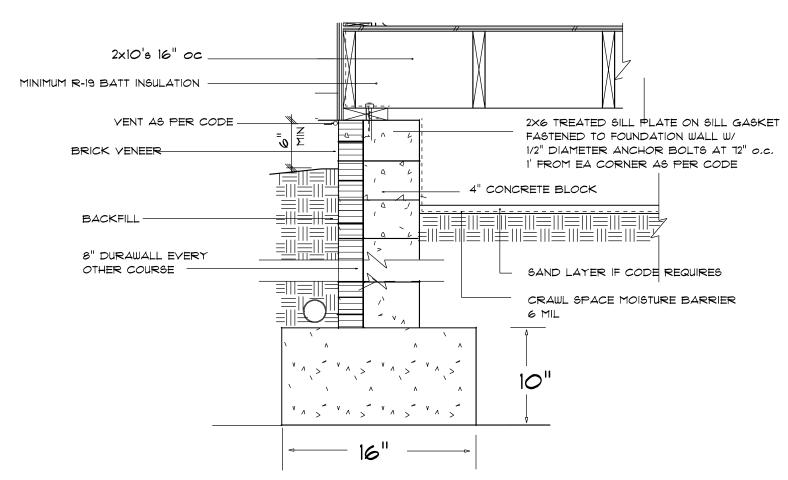

FOOTING & FOUNDATION DETAIL


not to scale

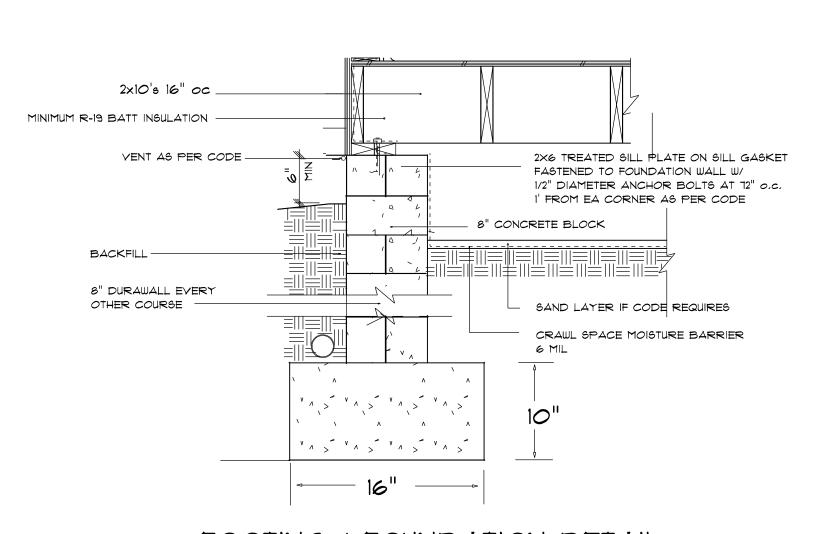



FOOTING & FOUNDATION DETAIL

not to scale



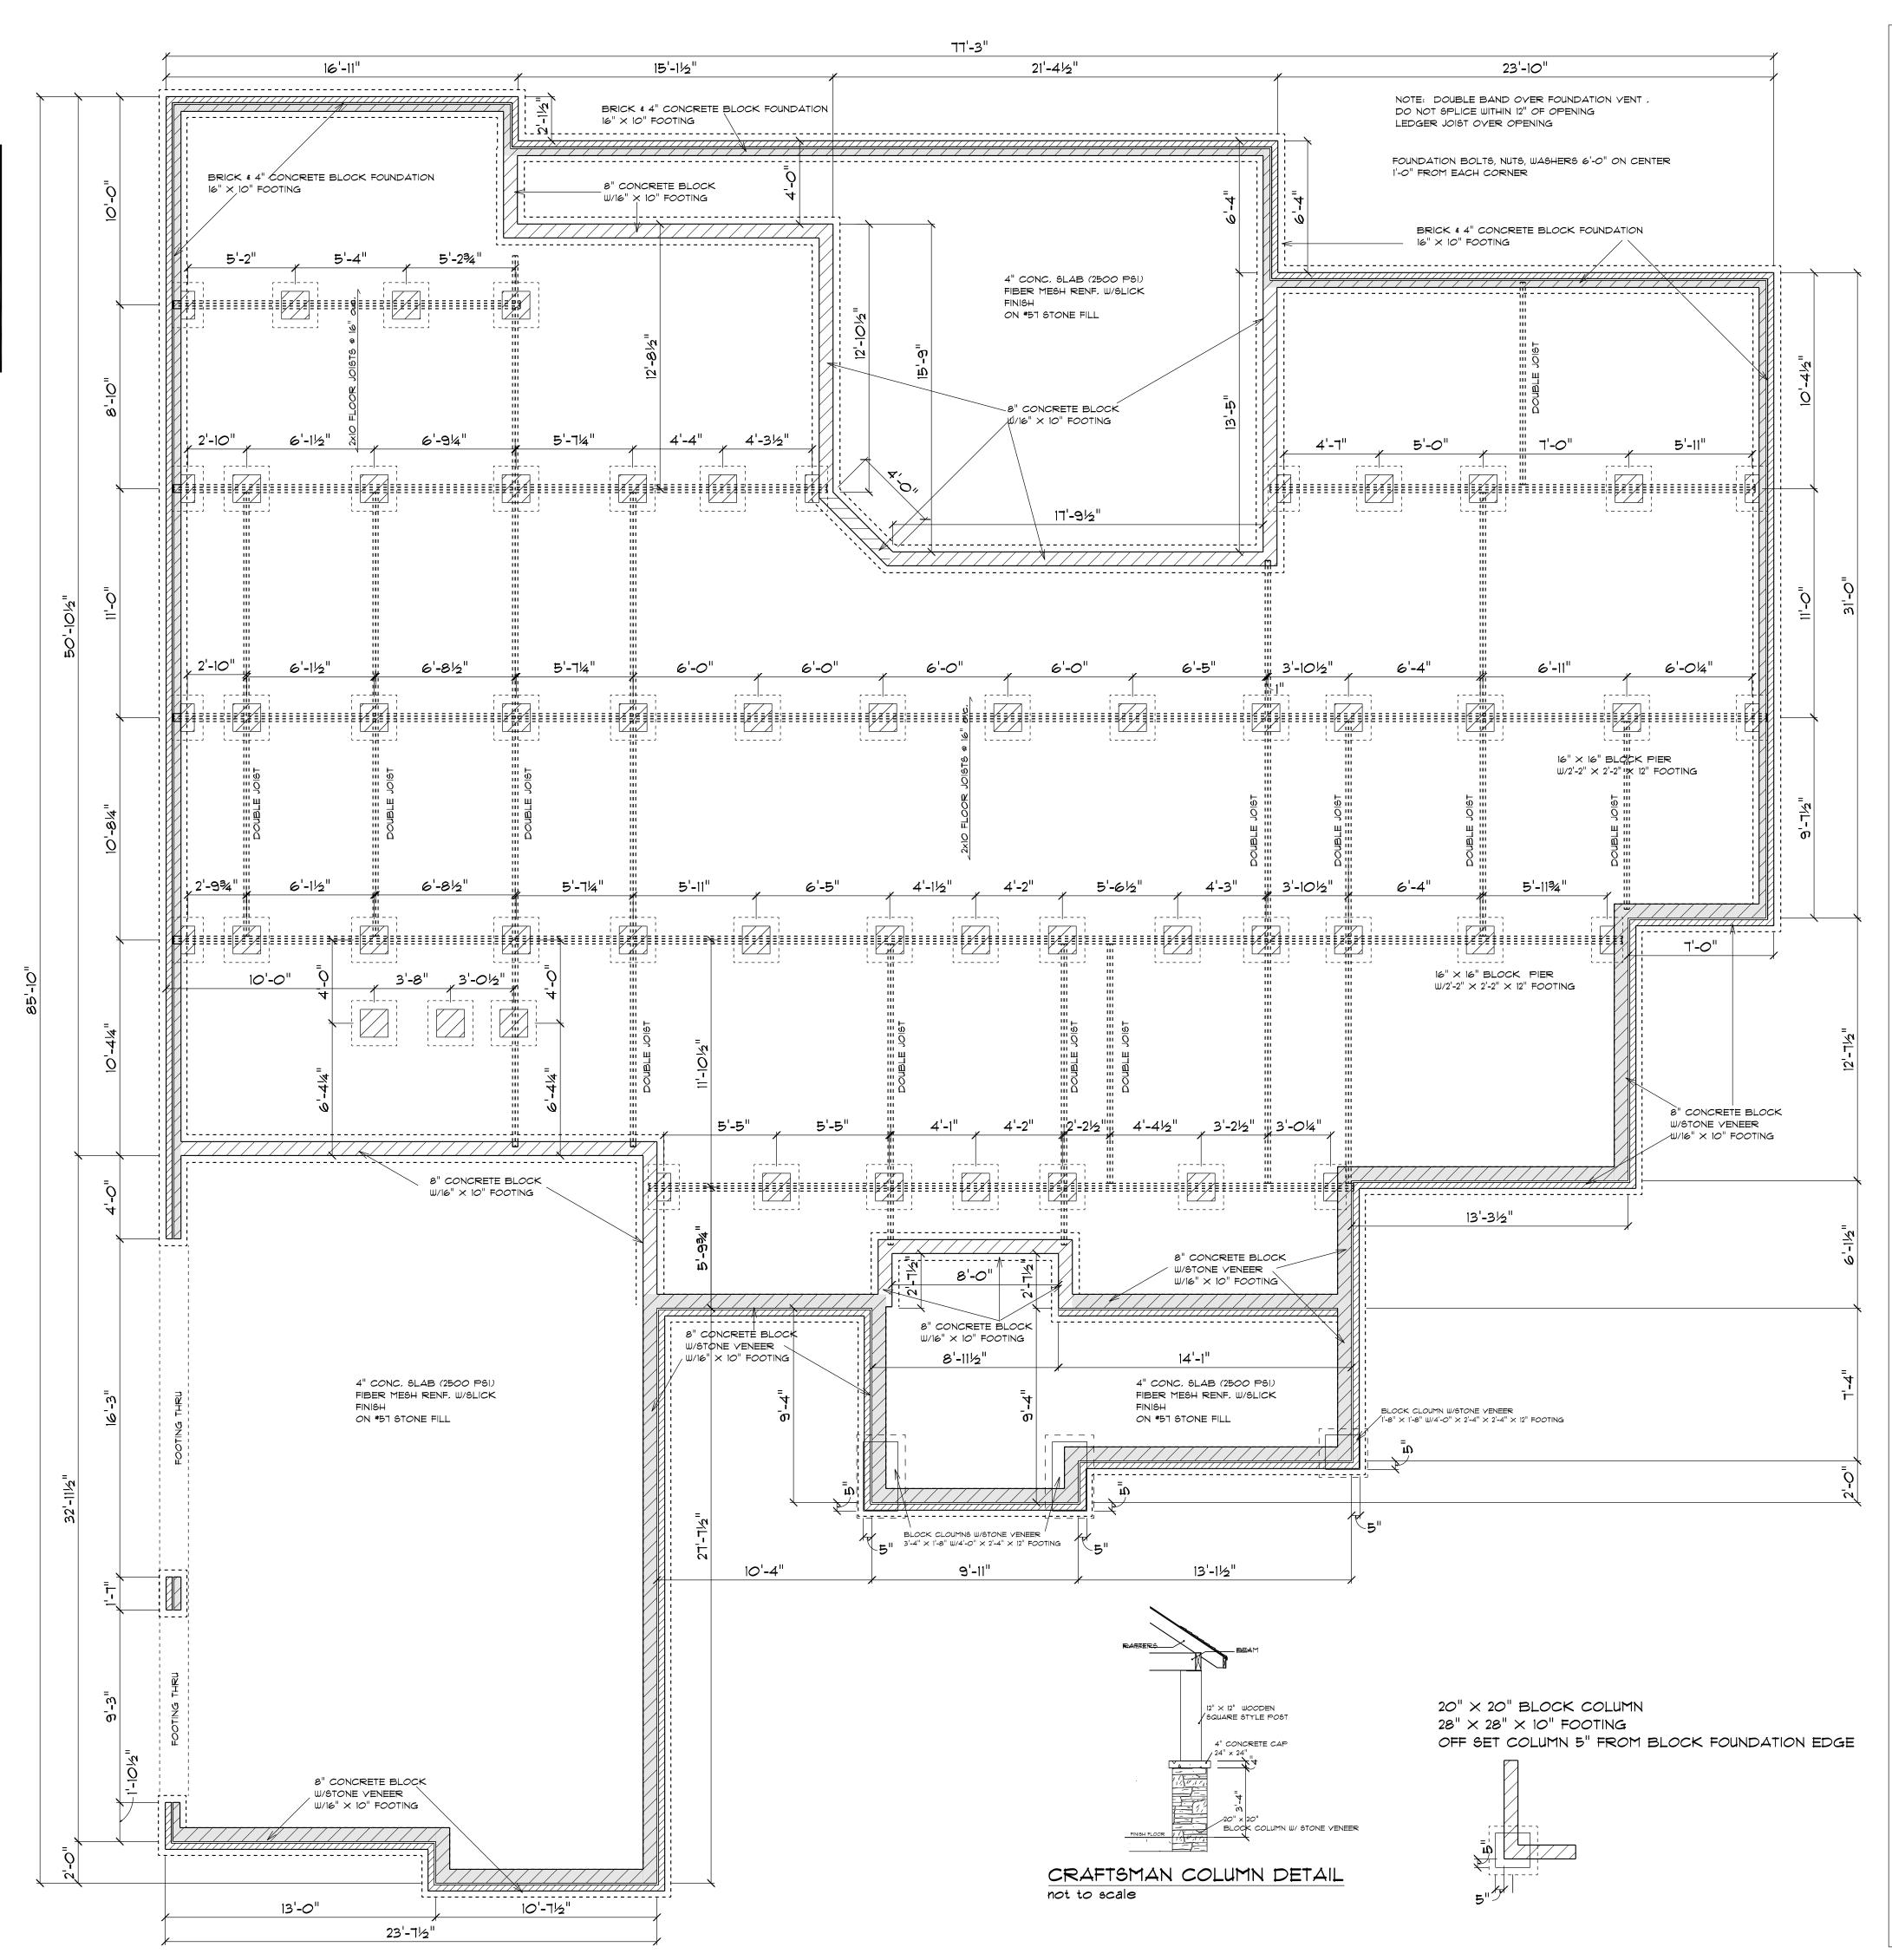

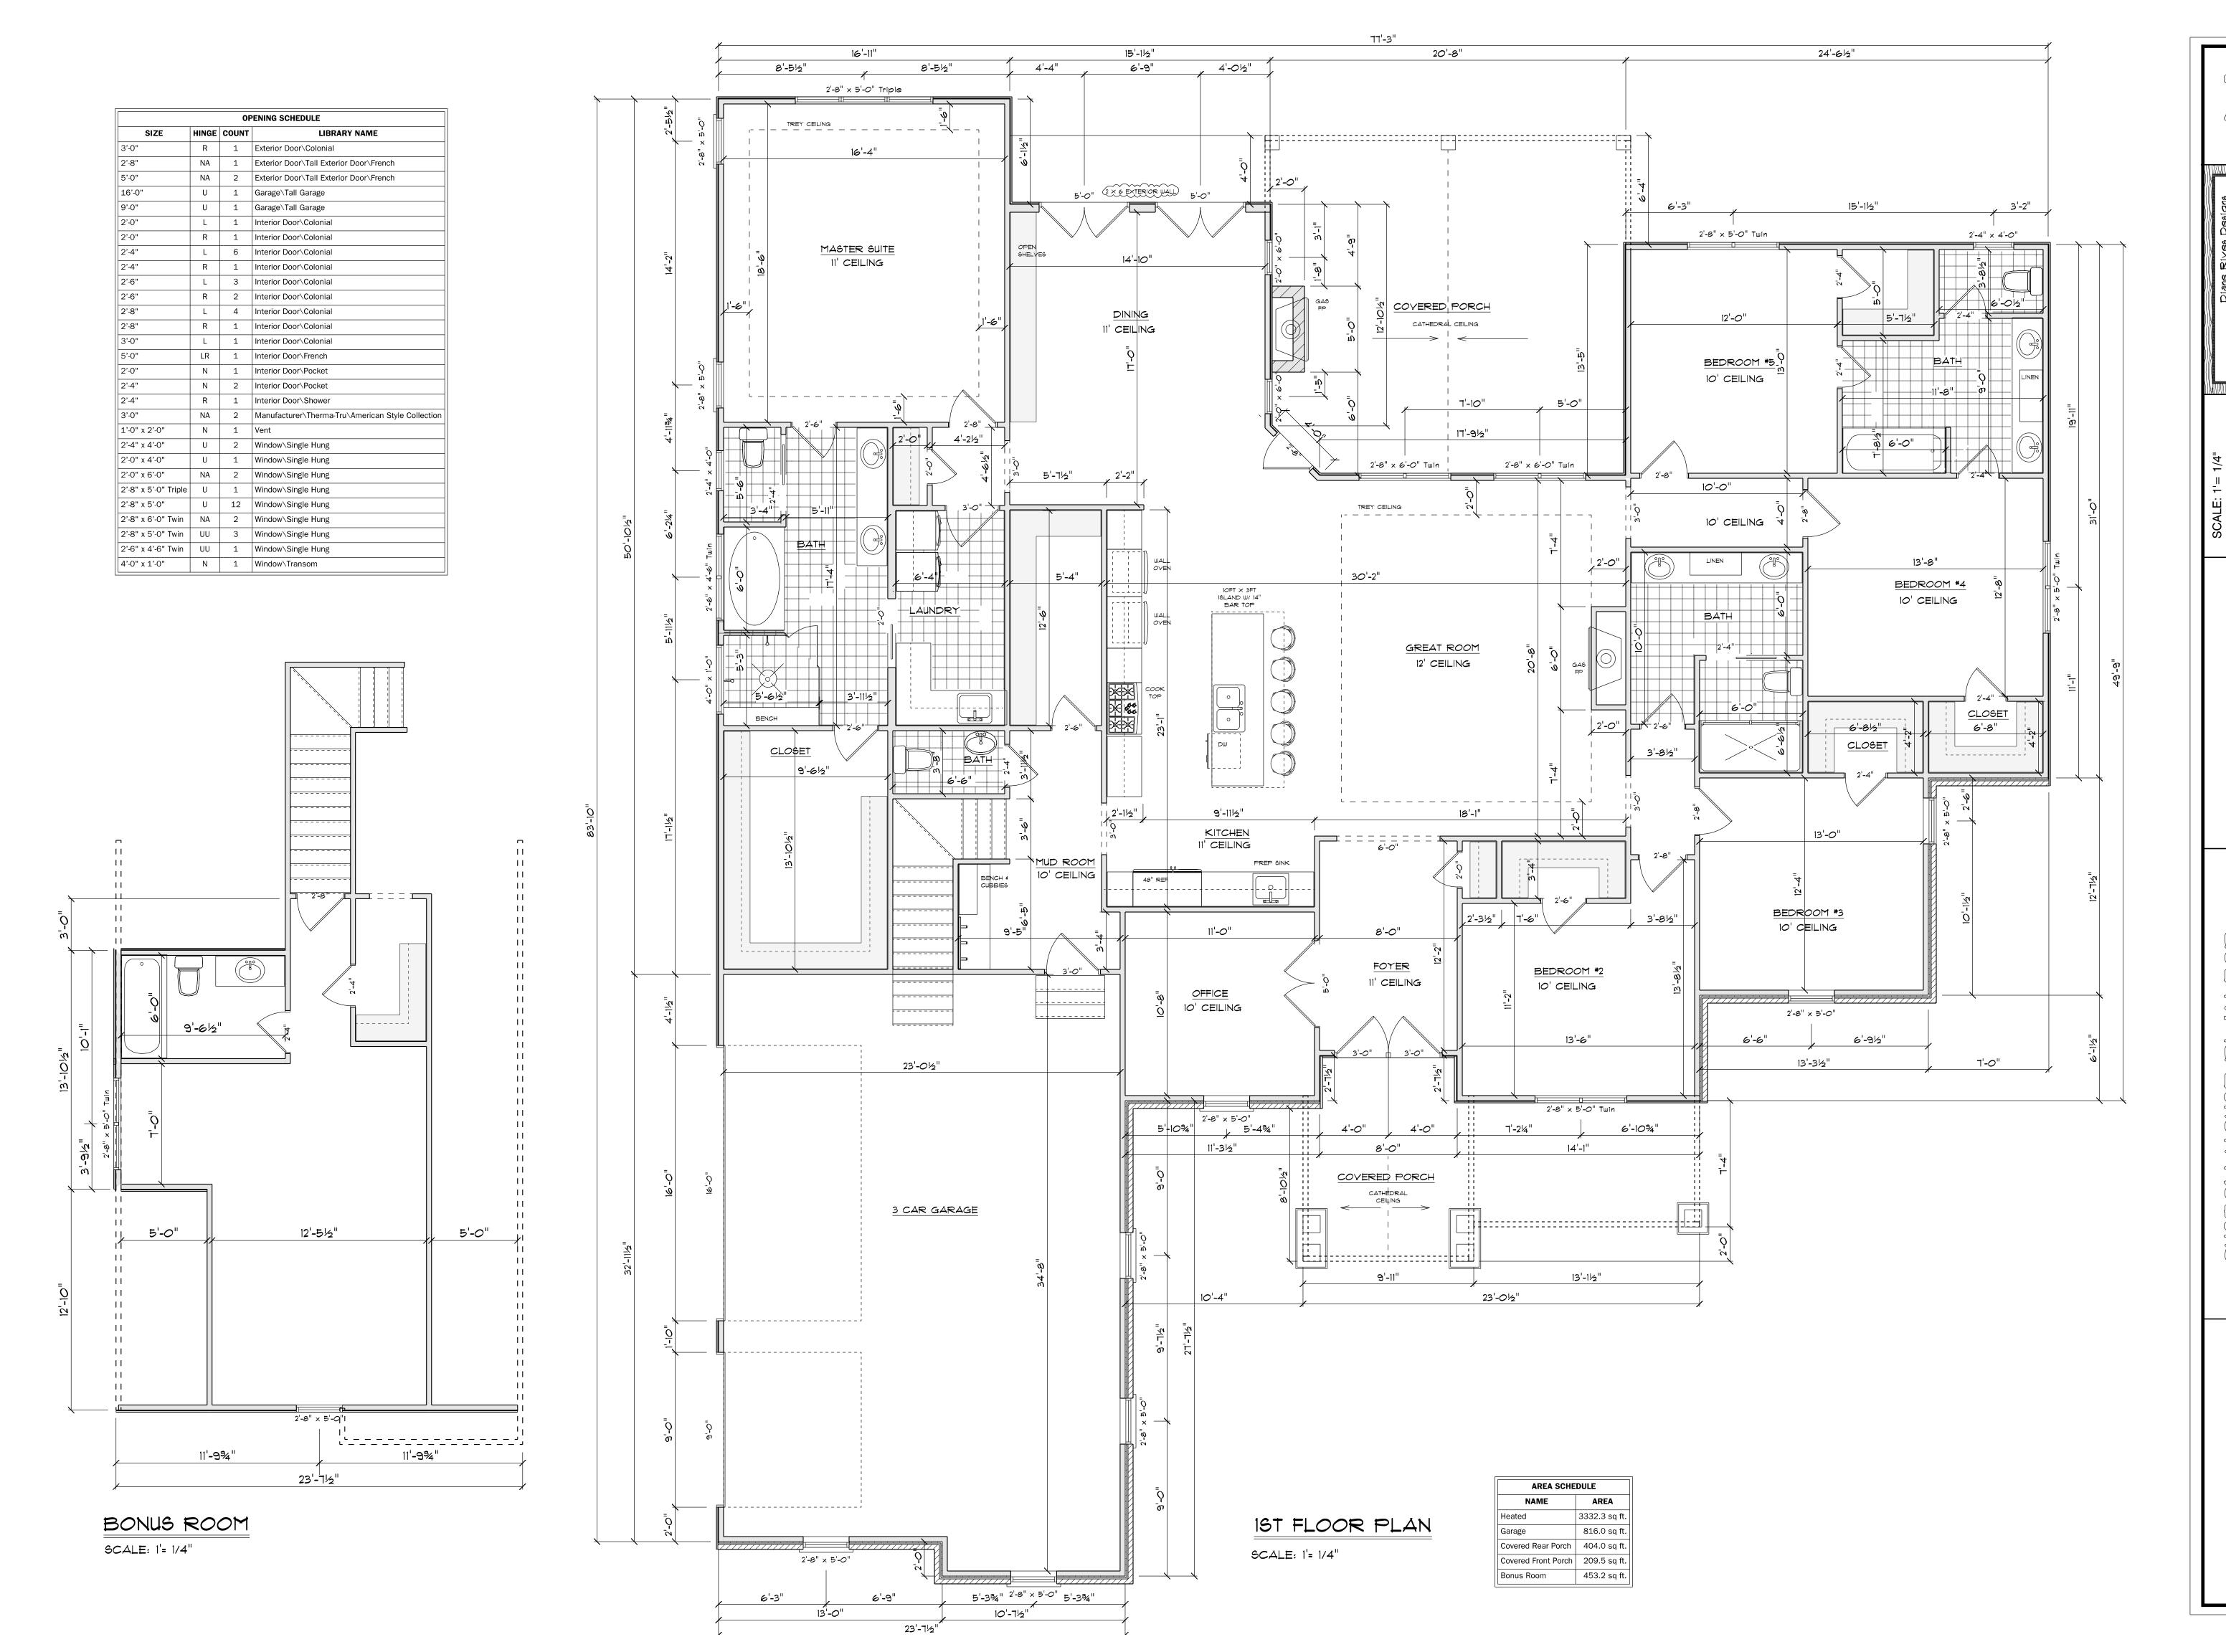

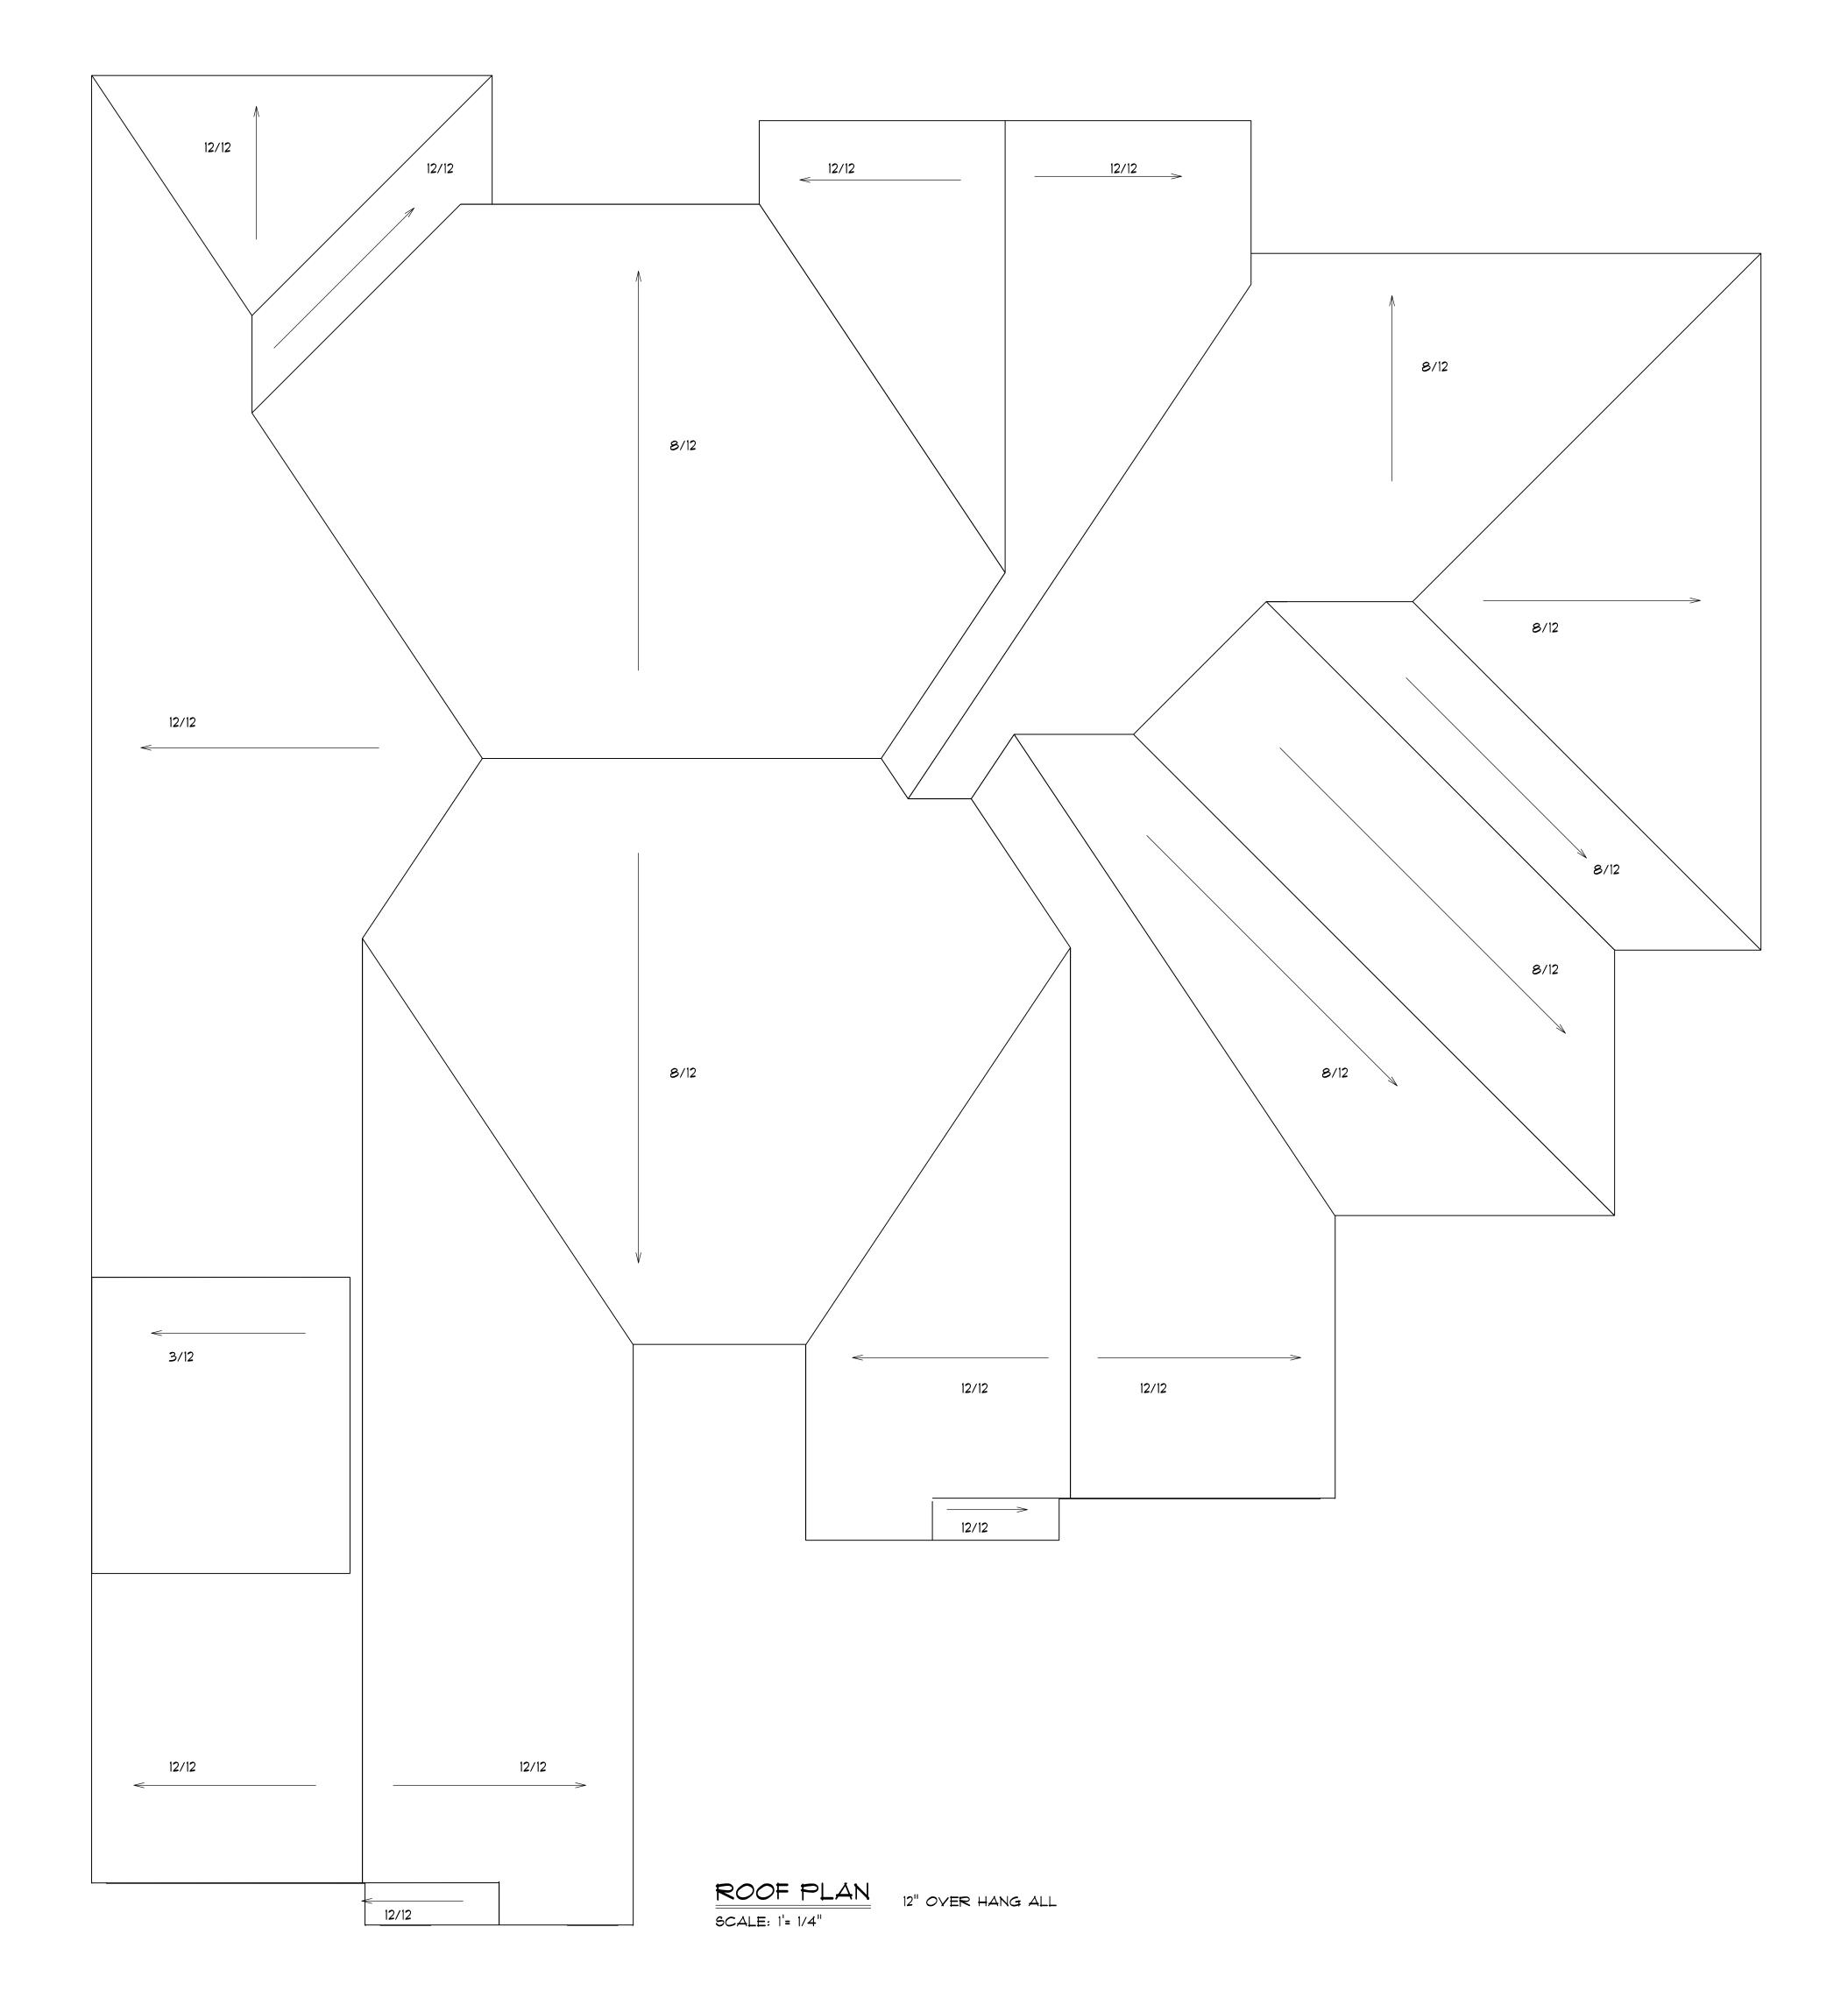

TYPICAL FRAME ROOF: SHINGLES ROOF 7/16" ROOFING PLYWOOD c/w 'H' CLIPS 2x10 RIDGEBOARD 2x8 RAFTERS @ 16" o.c. 2x4 COLLAR TIES @ 48" o.c. w/ 1x4 RIBBON TIE 2x8 CEILG JOISTS @ 16" o.c. w/ 2x4 RIBBON TIE R38 BLOWN INSULATION 5/8" CEILING BOARD TAPED & SANDED R40 BATT INSUL. 6 mil POLY V.B. 5/8" DRYWALL TAPED & SANDED


ROOF NOTES:

TRUSSES, BRACINGS, BRIDGING AND CONNECTORS ARE TO BE DESIGNED BY THE TRUSS MANUFACTURER.

IDENTIFY LUMBER BY OFFICIAL GRADE MARKINGS.


DO NOT CUT OR REMOVE CHORDS OR OTHER TRUSS MEMBERS, DO NOT NOTCH OR DRILL TRUSS MEMBERS,

WHERE PRE-ENGINEERED ROOF TRUSSES ARE USED, TRUSS
MANUFACTURER SHALL PROVIDE SHOP DRAWINGS, WHICH BEAR SEAL
OF A N. C. REGISTERED ENGINEER.

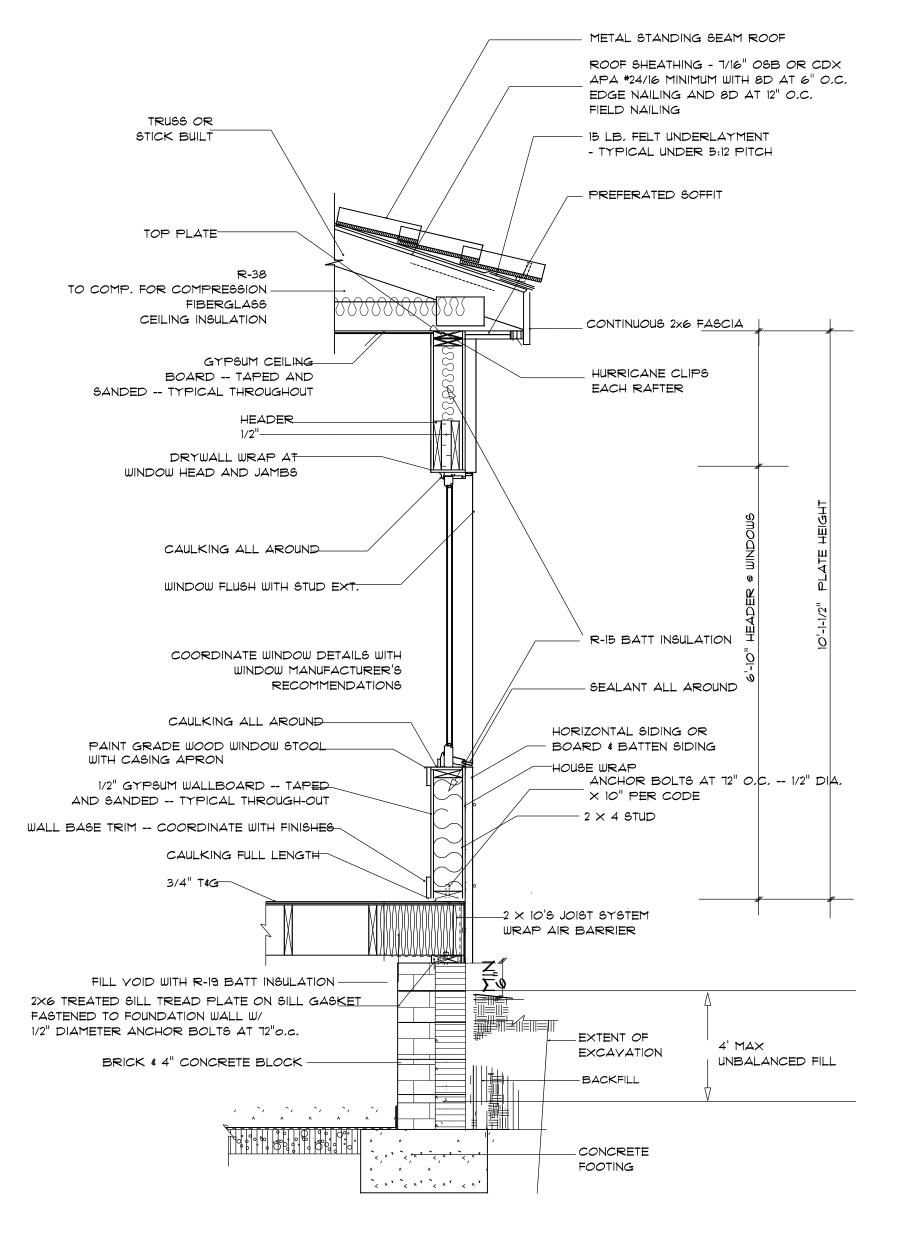


CRAWL SPACE FOUNDATION DETAIL not to scale




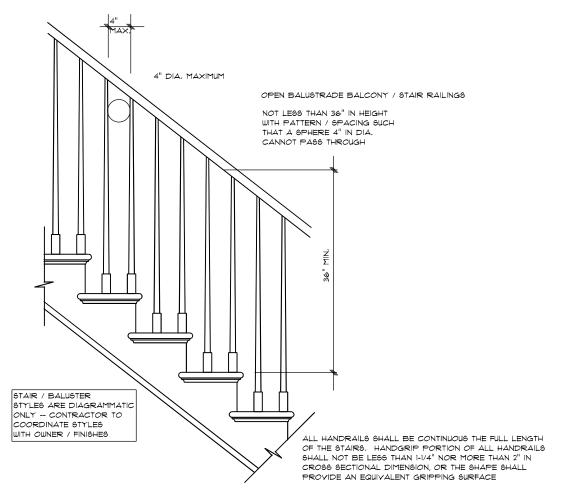

STAIR RAILING not to scale

SCALE: 1'= 1/4"

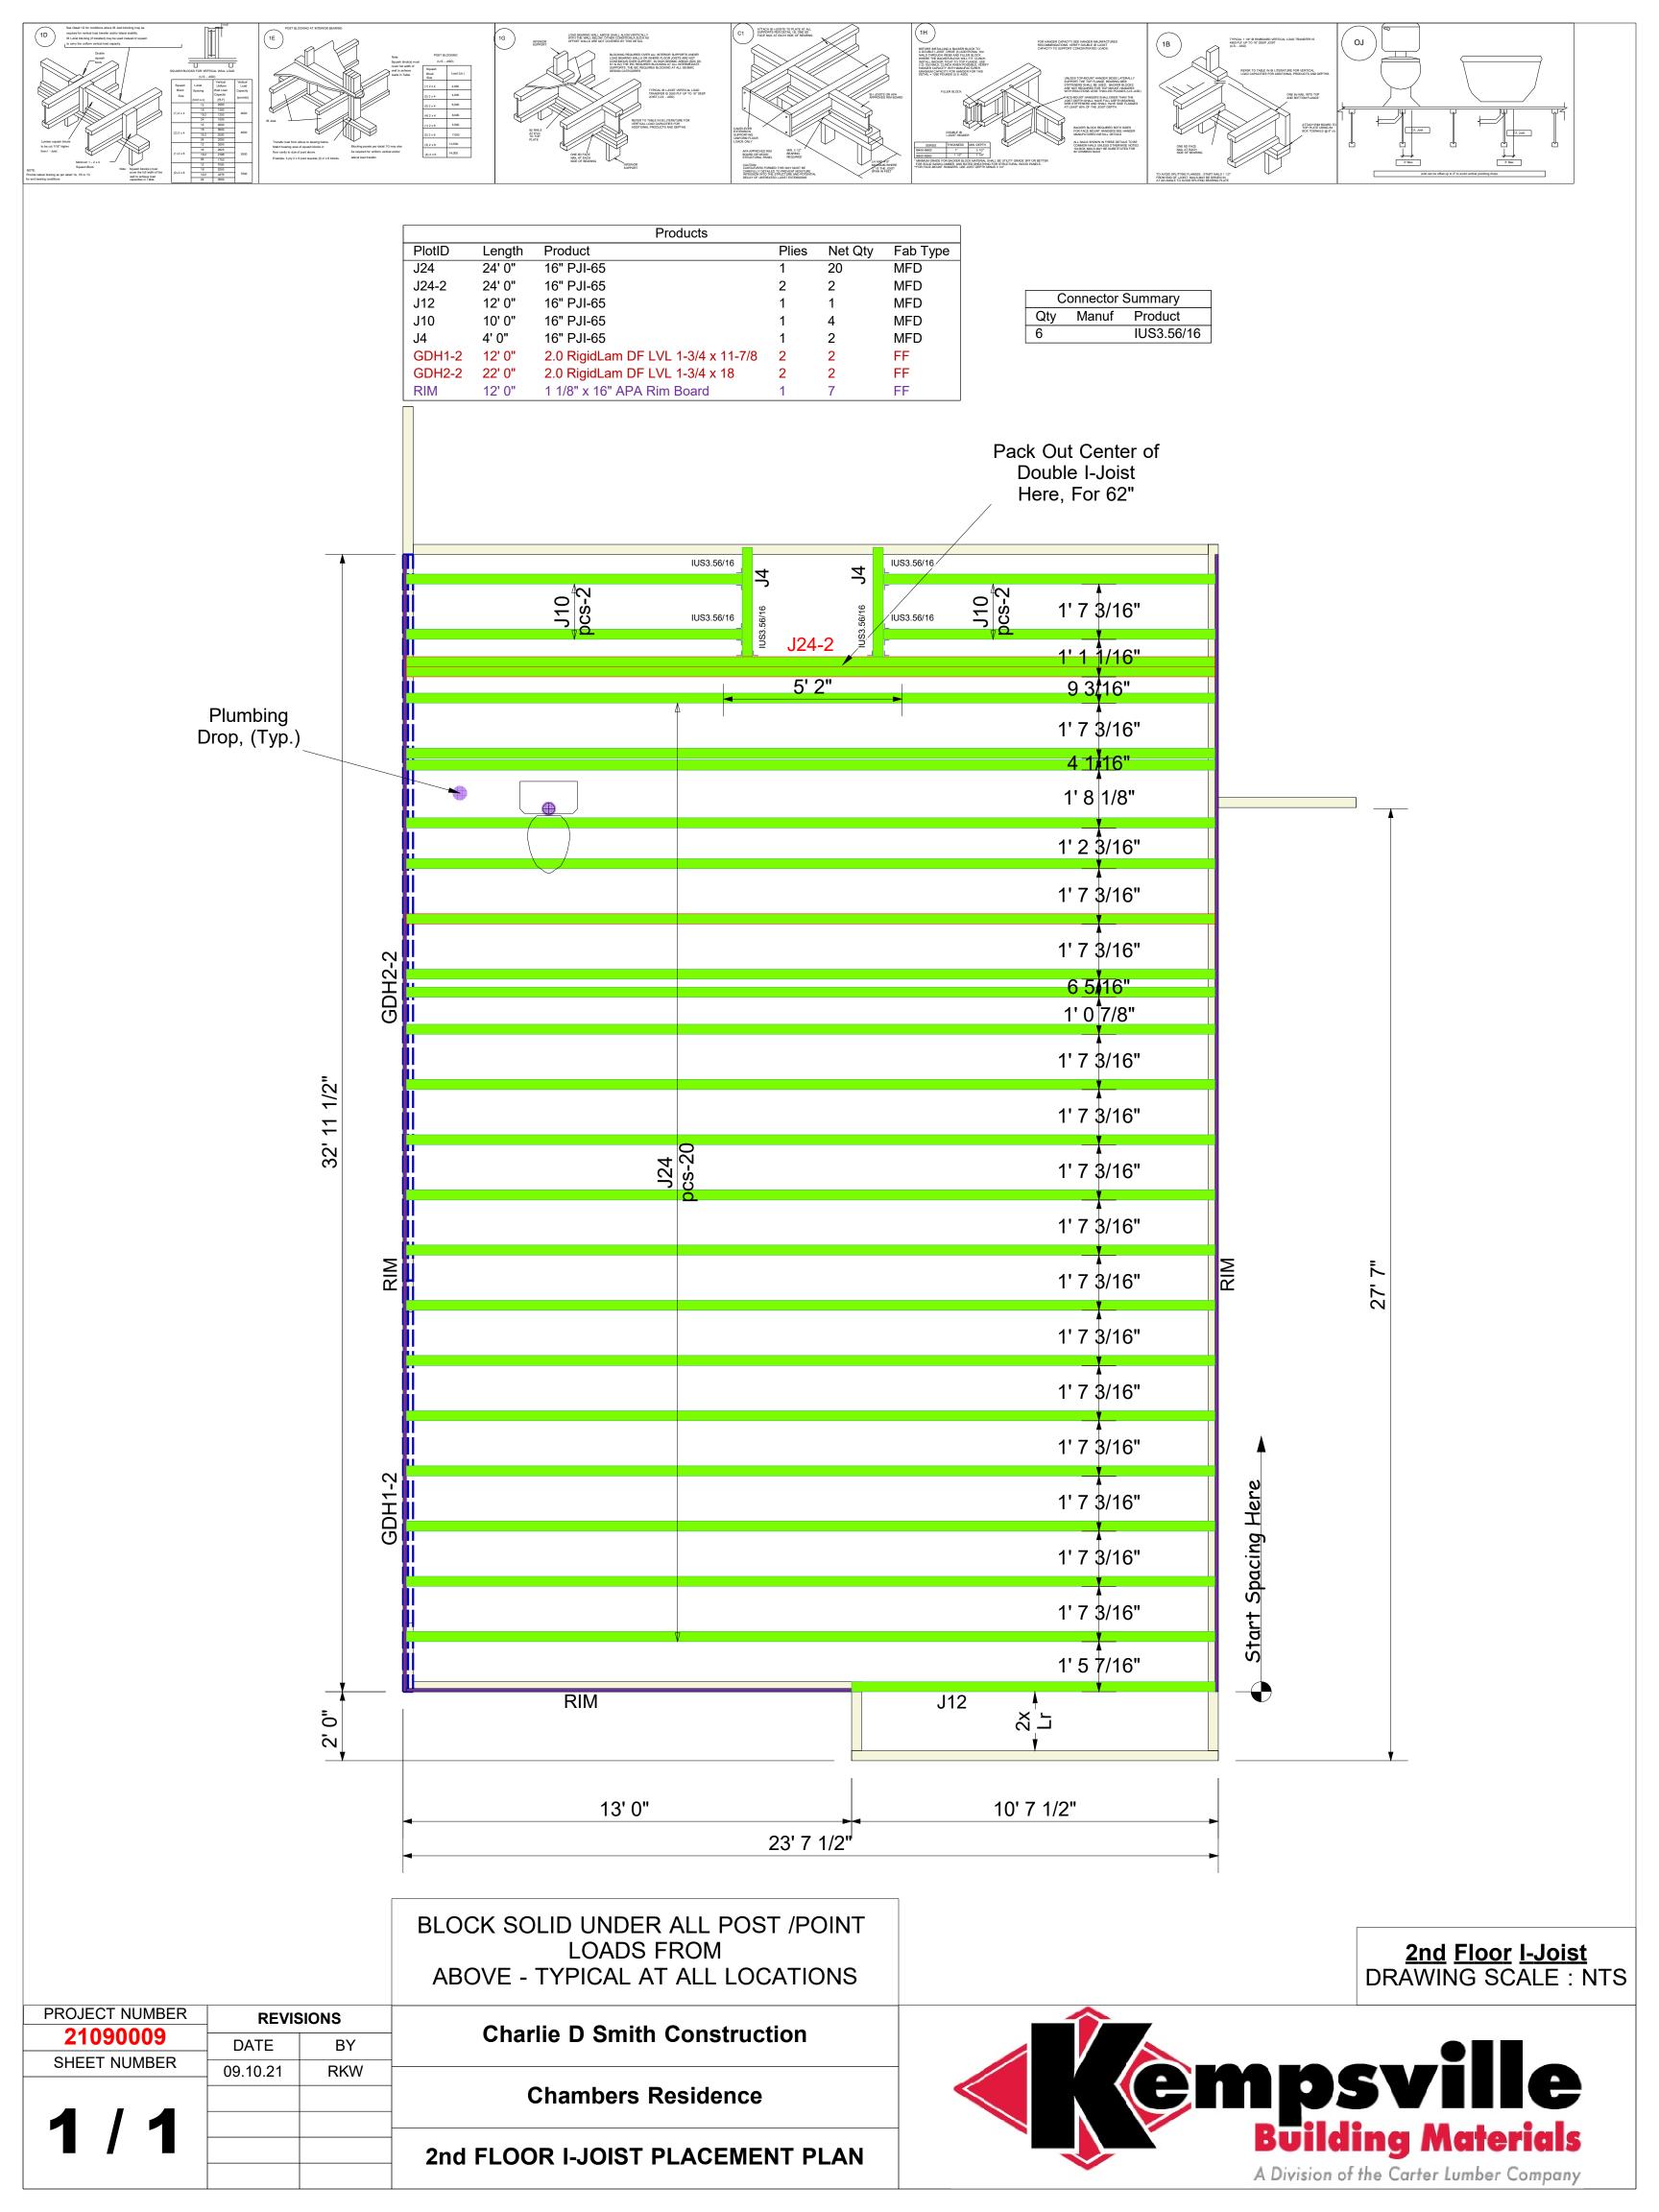

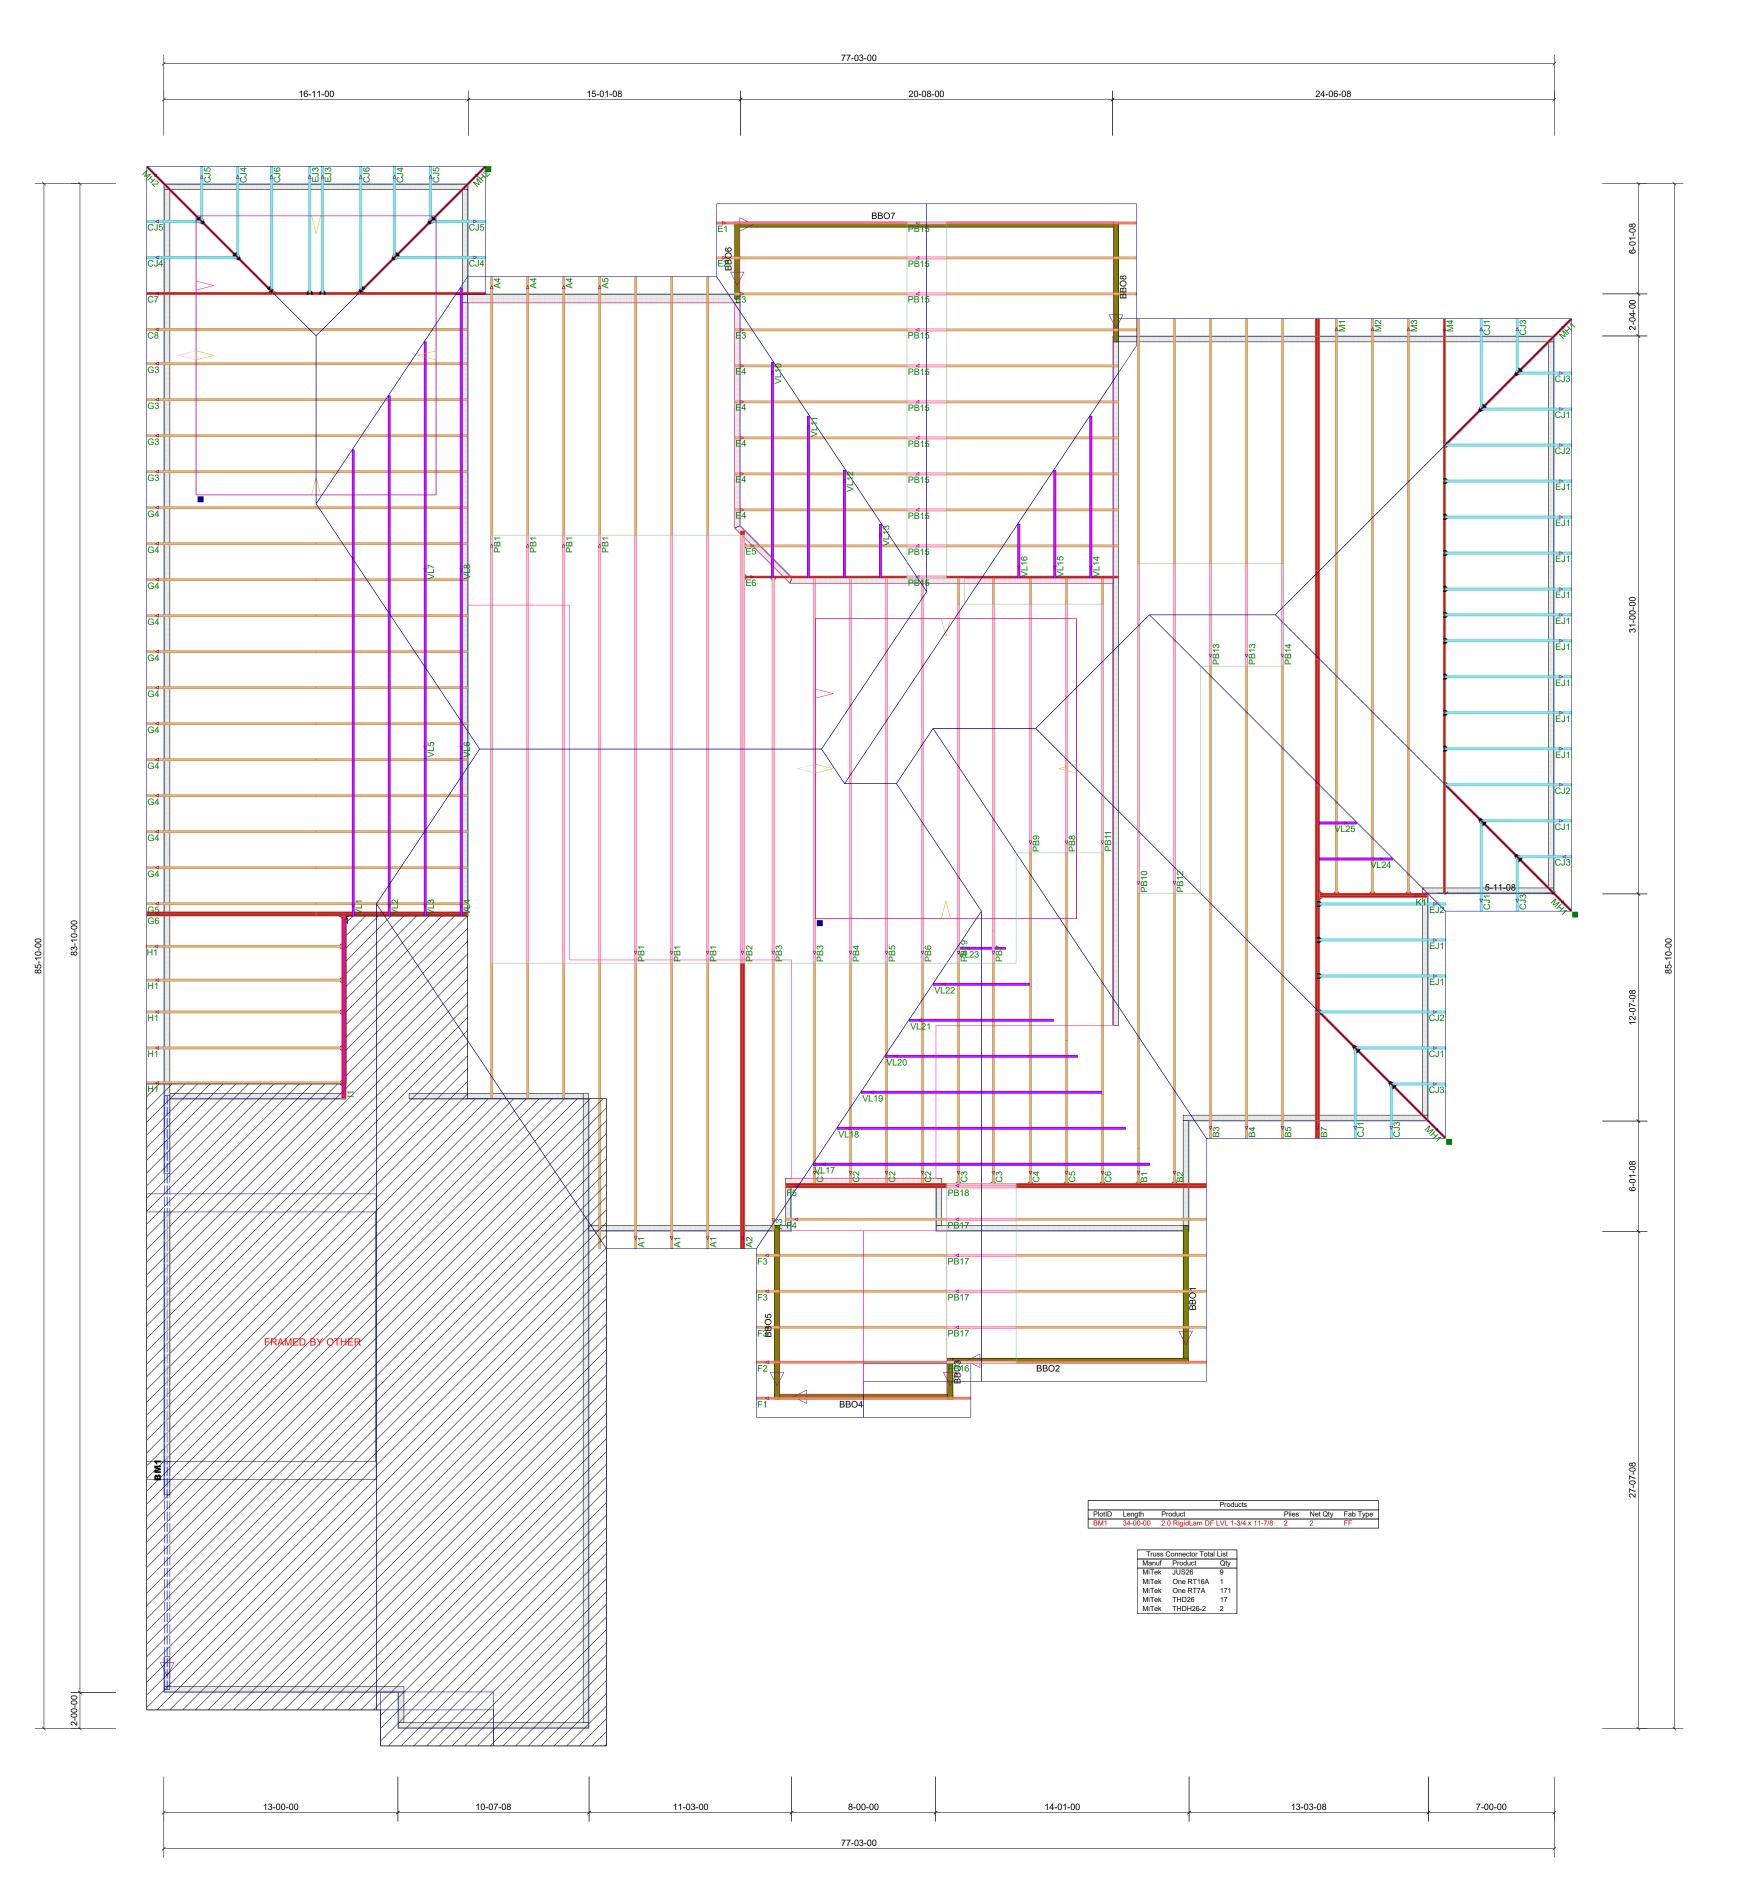



Charlie D Smith
Chambers Residence

	REVISIONS			
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9-23	3-21	VE)	

PROJECT NUMBER
21090009
SHEET NUMBER

ROOF TRUSS FRAMING
DRAWING SCALE: NTS