# PLANS DESIGNED TO THE 2018 NORTH CAROLINA STATE RESIDENTIAL BUILDING CODE.

West Park Lot 1 63 West Park Lane Sanford, NC 27332

- GENERAL NOTES

  1. ALL WORK SHALL BE PERFORMED IN ACCORDANCE WITH ALL APPLICABLE NATIONAL, STATE, AND LOCAL CODES AND REGULATIONS.

  2. CONTRACTOR SHALL THOROUGHLY REVIEW ALL SHEETS IN PLAN SET AND
- VERIFY ALL DETAILS AND DIMENSIONS BEFORE BEGINNING CONSTRUCTION.
  ANY DISCREPANCIES SHALL BE REPORTED TO RENAISSANCE RESIDENTIAL DESIGN. INC. FOR JUSTIFICATION AND/OR CORRECTION REFORE PROCEEDING WITH WORK. CONTRACTORS SHALL ASSUME RESPONSIBILITY FOR ERRORS THAT ARE NOT REPORTED PRIOR TO CONSTRUCTION.
- ALL DIMENSIONS SHOULD BE READ OR CALCULATED AND NEVER SCALED.
   CONTRACTOR SHALL ENSURE COMPATIBILITY OF THE BUILDING WITH ALL SITE REQUIREMENTS.



FRONT ELEVATION-B SCALE: 1/4" = 1'-0"



REAR ELEVATION RIGHT ELEVATION LEFT ELEVATION SCALE: 1/8" = 1'-0" SCALE: 1/8" = 1'-0' SCALE: 1/8" = 1'-0'

**HVAC: MAINSTREAM** ELECTRICAL: PIONEER PLUMBING: DOUBLE J

SCALE NOTE: 18x24 PRINTS ARE TO SCALE AS NOTED.

11x17 PRINTS ARE NOT TO SCALE RENAISSANCE

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WEAVER HOMES CAROLINA COLLECTION BRADFORD DRIVE LEFT


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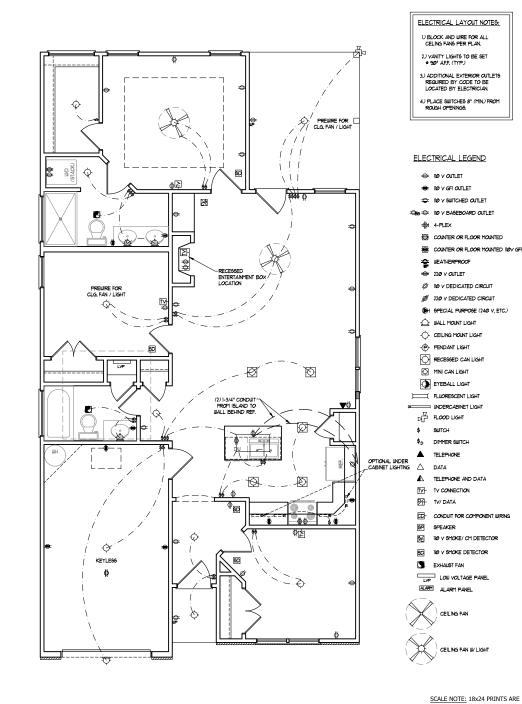
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B - ELEVATIONS

A-2





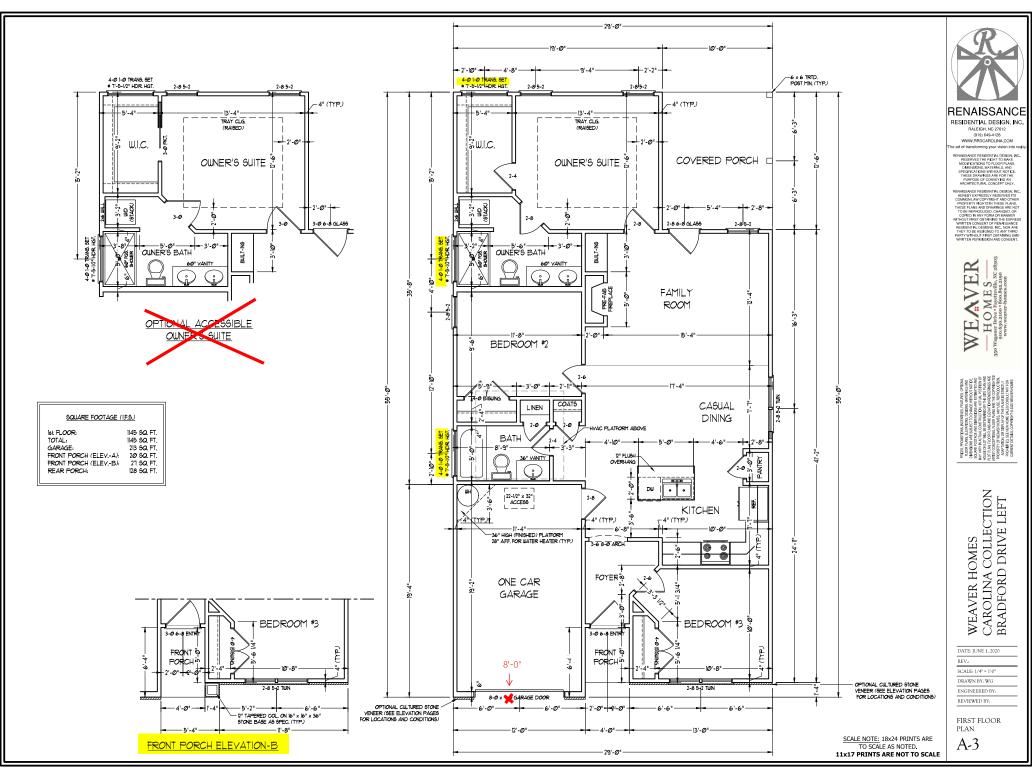

SCALE NOTE: 18x24 PRINTS ARE TO SCALE AS NOTED. 11x17 PRINTS ARE NOT TO SCALE



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DATE: JUNE 1, 2020

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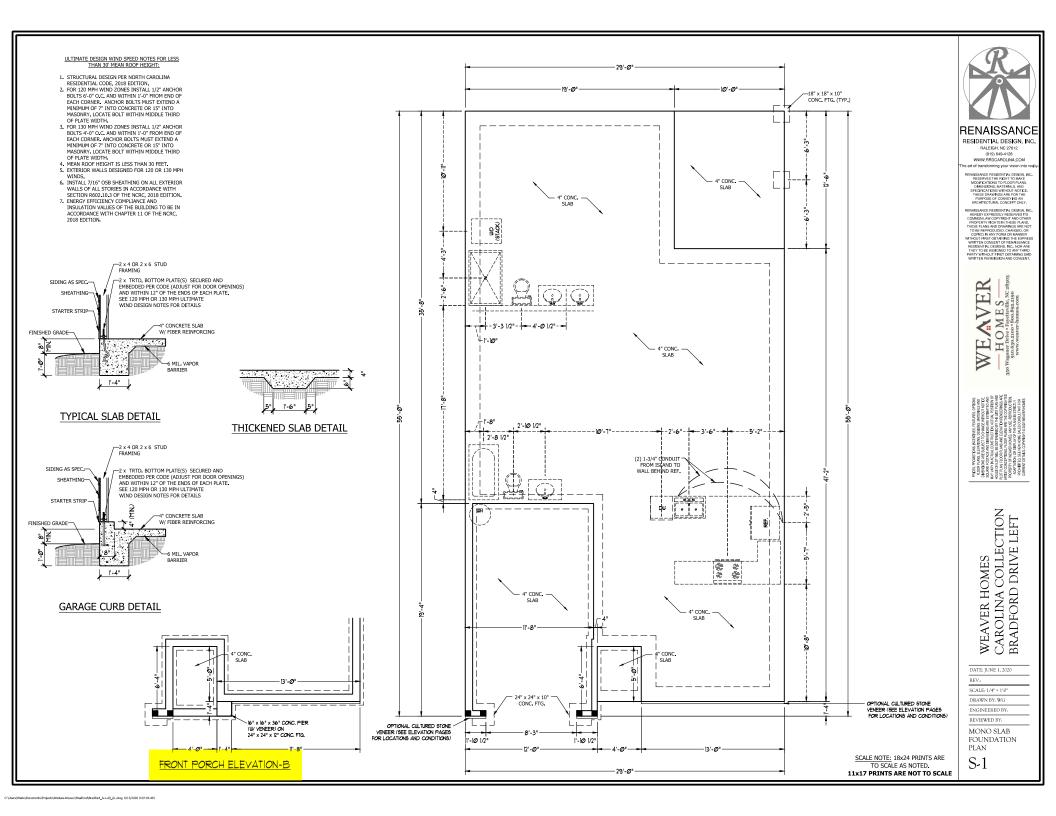
FIRST FLOOR ELECTRICAL PLAN


E-1

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FRONT PORCH ELEVATION-B





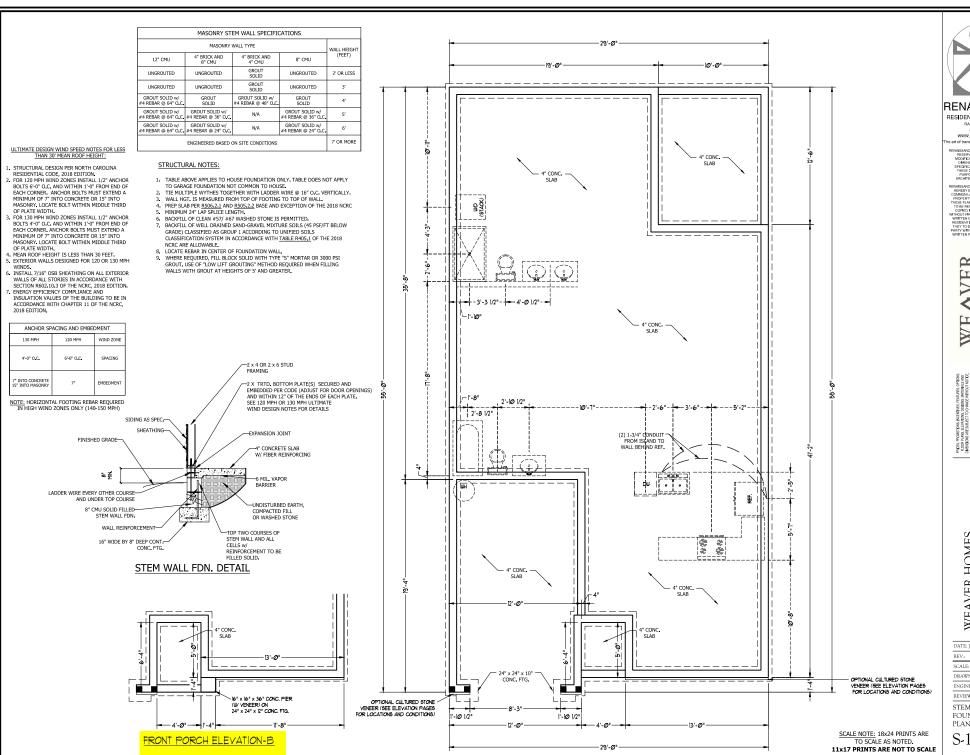

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REV.: SCALE: 1/4" = 1'-0" DRAWN BY: WG ENGINEERED BY: REVIEWED BY: STEMWALL SLAB FOUNDATION

PLAN

#### **BRACE WALL PANEL NOTES:**

**EXTERIOR WALLS:** ALL EXTERIOR WALLS TO BE SHEALTHED WITH CS-WSP OR CS-SSB IN ACCORDANCE WITH SECTION R602.10.3 UNLESS NOTED OTHERWISE.

REQUIRED LENGTH OF BRACEING: REQUIRED BRACE WALL LENGTH FOR EACH SIGN OF THE CIRCUMCRIBED RECTANGLE ARE INTERPOLATED PER TABLE R602.10.3. METHODS CS-WSP AND CS-SPB CONTIBURET HIRE ACTUAL LENGTH, METHOD OS CONTIBURETS 0.5 ITS ACTUAL LENGTH, METHOD PF CONTRIBURET SITS ACTUAL LENGTH, HETHOD PF CONTRIBUTES 1.5 TIMES ITS ACTUAL LENGTH, HETHOD PF CONTRIBUTES 1.5 TIMES ITS

GYPSUM: ALL INTERIOR SIDES OF EXTERIOR WALLS AND BOTH SIDES OF INTERIOR WALLS TO HAVE 1/2" GYPSUM INSTALLED, WHEN NOT USING METHOD GB GYPSUM TO BE FASTENED PER TABLE R02.3.5. METHOD GB TO BE FASTENED PER TABLE R02.10.1.

HD: 800 LBS HOLD DOWN DEVICE FASTENED TO THE EDGE OF THE BRACE WALL PANEL NEAREST TO THE CORNER

METHODS: PER TABLE R602.10.1

#### STRUCTURAL NOTES:

- ALL FRAMING LUMBER TO BE SPF #2 (UNO). ALL TREATED LUMBER TO BE SYP #2 (UNO.)
- ALL LOAD BEARING HEADERS TO BE (2) 2 x 6 (UNO).
- INSTALL AN EXTRA JOIST UNDER WALLS PARALLEL TO FLOOR JOISTS
   WINDOW AND DOOR HEADERS TO BE SUPPORTED W/ (1) JACK STUD AND (1) KING
- WINDOW AND DOOR HEADERS TO BE SUPPORTED W/ (1) JACK STUD AND (1) KIN STUD EA. END (UNO.). SEE TABLE R602.7.5 FOR ADDITIONAL KING STUD REQUIREMENTS.
- SQUARES DENOTE POINT LOADS WHICH REQUIRE SOLID BLOCKING TO GIRDER OR FOUNDATION. ALL SQUARES TO BE (2) STUDS (UND.)
   ALL 4 X 4 POSTS SHALL BE ANKHORED TO SLABS W/ SIMPSON ABU44 POST BASES
- ALL 4 X 4 POSTS SHALL BE ANCHORED TO SLABS W/SIMPSON ABU44 POST BASES (OR EQUIA) AND 6 X 6 POSTS W/ ABU46 POST BASES (OR EQUIA) (UNIO). ALL 4 X 4 AND 6 X 6 POSTS TO BE INSTALLED WITH 700 LB CAPACITY UPLIFT CONNECTORS AT TOP (UNIO.)
   FOR FIGERGLASS, ALUMINUM, OR COLUMN ENG, BY OTHERS, SECURE TO SLAB W/
- FOR FIBERGLASS, ALUMINUM, OR COLUMN ENG, BY OTHERS, SECURE TO SLAB W,
   METAL ANGLES USING 2" CONC. SCREWS. FASTEN ANGLES TO COLUMNS W/
   1/4" THROUGH BOLTS W/ NUTS AND WASHERS. LOCATE ANGLES ON OPPOSITE SIDES OF COLUMN. THROUGH BOLTS MUST BE INSTALLED PRIOR TO SETTING COLUMN.



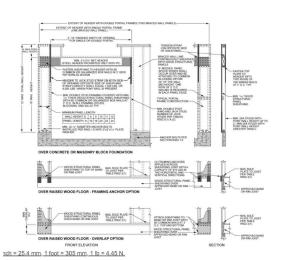


FIGURE R602.10.1
METHOD PF—PORTAL FRAME CONSTRUCTION



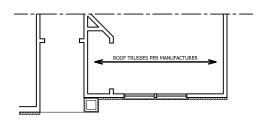

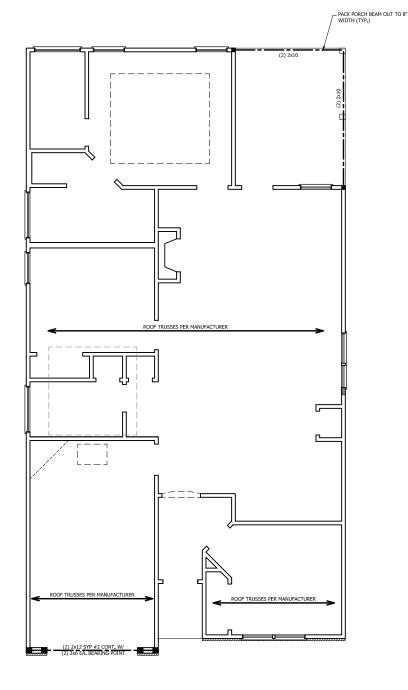

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WEAVER HOMES CAROLINA COLLECTION BRADFORD DRIVE LEFT

DATE: JUNE 1, 2020

SCALE: 1/4" = 1'-0" DRAWN BY: WG

ENGINEERED BY: REVIEWED BY:

SECOND FLOOR FRAMING PLAN

S-2

SCALE NOTE: 18x24 PRINTS ARE

TO SCALE AS NOTED.

11x17 PRINTS ARE NOT TO SCALE

FRONT PORCH ELEVATION-B

## ATTIC VENT CALCULATION:


1750 SQ. FT. OF ATTIC DIVIDED BY 150 REQUIRES 11.7 SQ. FT. OF NET FREE VENTILATING AREA (MIN.).

### STRUCTURAL NOTES:

- 1. ALL FRAMING LUMBER TO BE #2 SPF (UNO). HIP SPLICES ARE TO BE SPACED A MIN. OF 8'-0".
   FASTEN MEMBERS WITH THREE ROWS OF 12d
- NAILS @ 16" O.C. (TYP.)

  3. STICK FRAME OVER-FRAMED ROOF SECTIONS W/ 2 x 8 RIDGES, 2 x 6 RAFTERS @ 16" O.C. AND FLAT 2 x 10 VALLEYS OR USE VALLEY TRUSSES.
- FASTEN FLAT VALLEYS TO RAFTERS OR TRUSSES WITH SIMPSON H2, 5A HURRICANE TIES @ 32" O.C. MAX. PASS HURRICANE TIES THROUGH NOTCH IN ROOF SHEATHING. EACH RAFTER IS TO BE FASTENED TO THE FLAT VALLEY WITH A
- 5. REFER TO SECTION R802.11 OF THE 2018 NCRC FOR REQUIRED UPLIFT RESISTANCE AT RAFTERS

MIN. OF (6) 12d TOE NAILS.

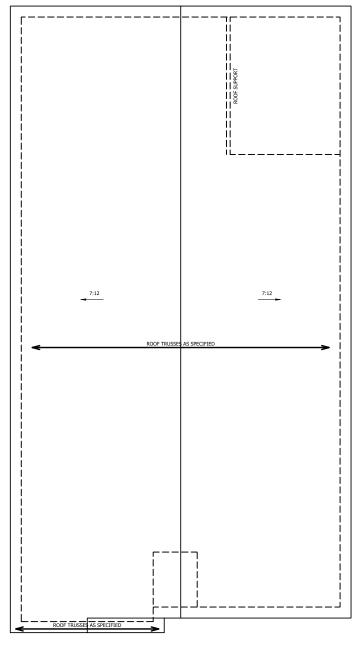



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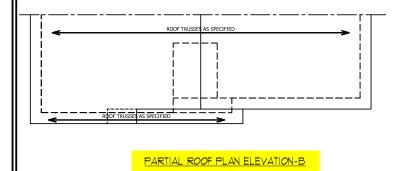
SCALE: 1/4" = 1'-0"

DRAWN BY: WG

ENGINEERED BY: REVIEWED BY:

ROOF PLAN

S-3



ELEVATION A

Weaver/Bradford/Bradford\_6-1-20\_GL dwg, 6/15/2020 9:07:06 AF

SCALE NOTE: 18x24 PRINTS ARE TO SCALE AS NOTED. 11x17 PRINTS ARE NOT TO SCALE

