

SHINGLES

SHINGL

PLUMBING: DOUBLE J HVAC: MAINSTREAM ELECTRICAL: PIONEER

SCALE NOTE: 18x24 PRINTS ARE
TO SCALE AS NOTED.
11x17 PRINTS ARE NOT TO SCALE

PORCH

RIGHT ELEVATION

SCALE: 1/8" = 1'-0"



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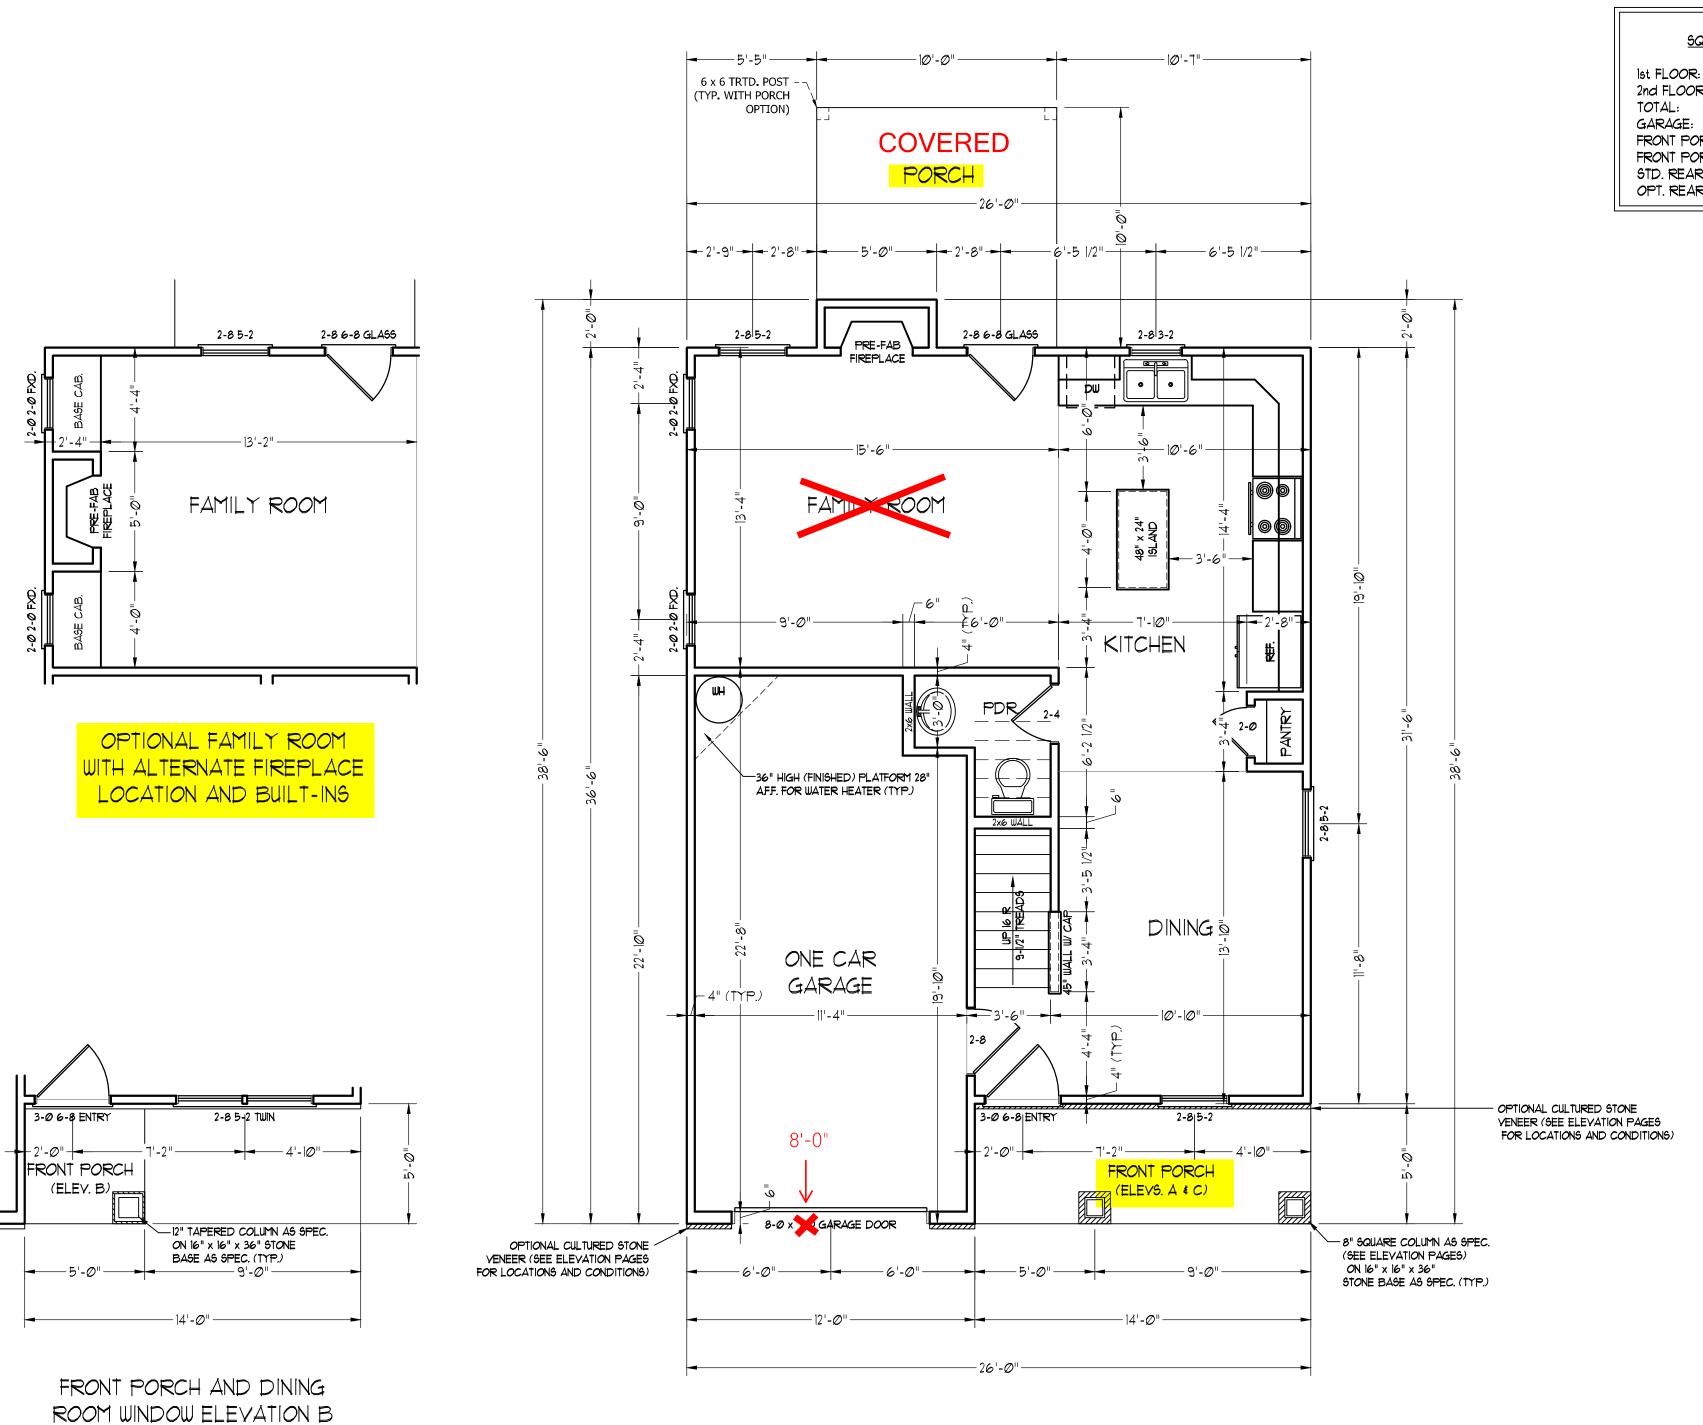
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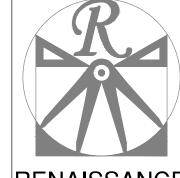
C - ELEVATIONS

A-3





| Ist FLOOR: 58| 6Q. FT. 2nd FLOOR: 141 6Q. FT. TOTAL: | 1328 6Q. FT. GARAGE: 246 6Q. FT. FRONT PORCH (ELEV.-A&C): 10 6Q. FT. FRONT PORCH (ELEV.-B): 25 6Q. FT. STD. REAR PATIO: | 100 6Q. FT. OPT. REAR PORCH: | 100 6Q. FT.



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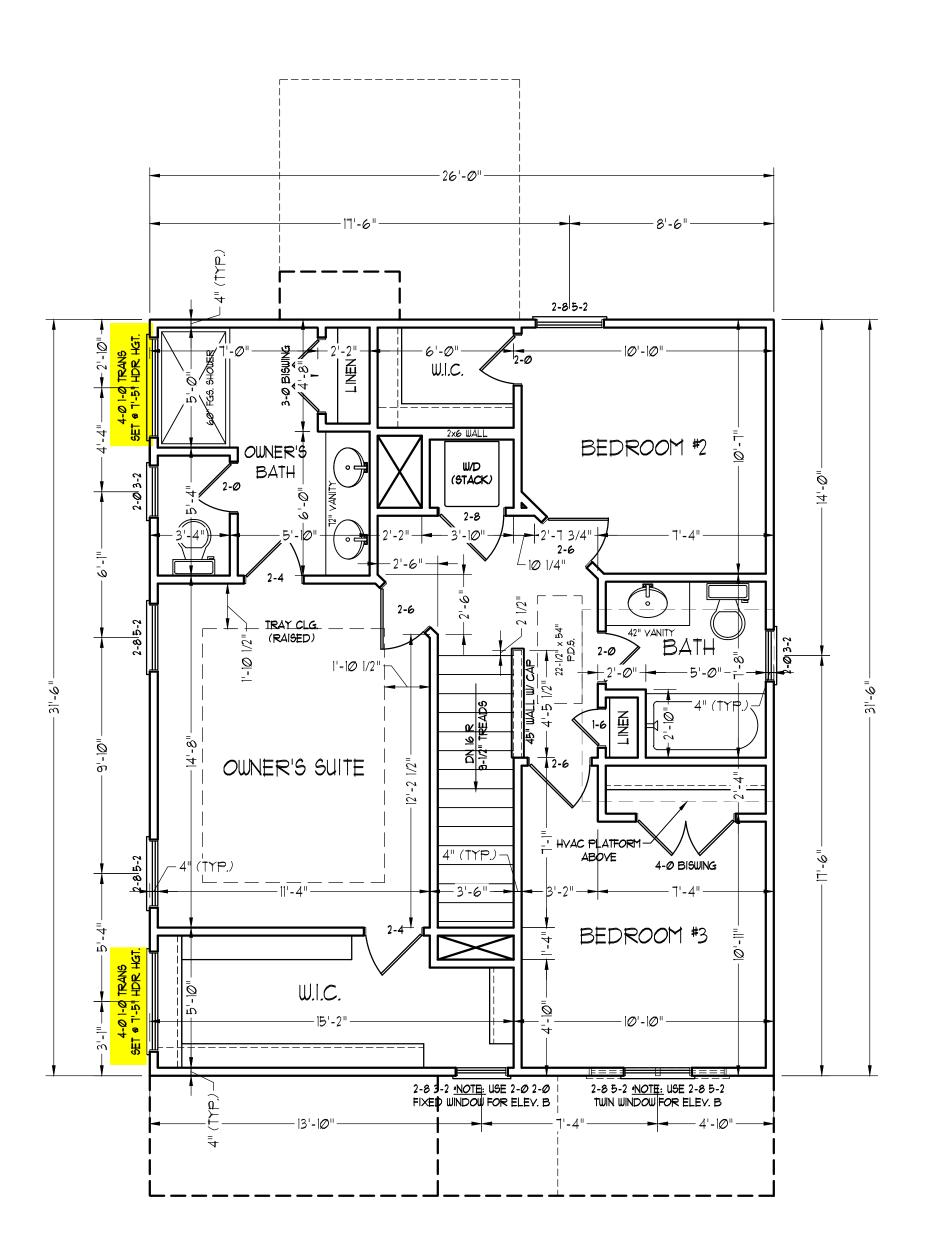
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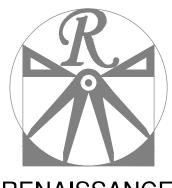
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FIRST FLOOR PLAN

A-4

SCALE NOTE: 18x24 PRINTS ARE
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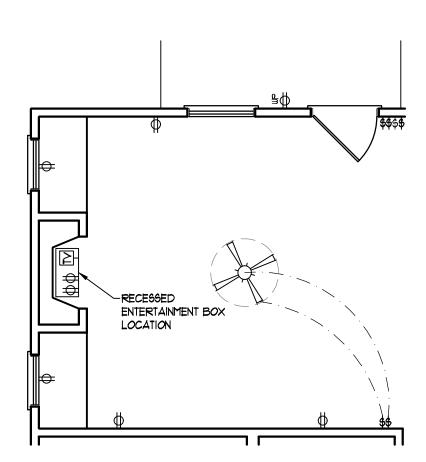
SECOND FLOOR PLAN

A-5


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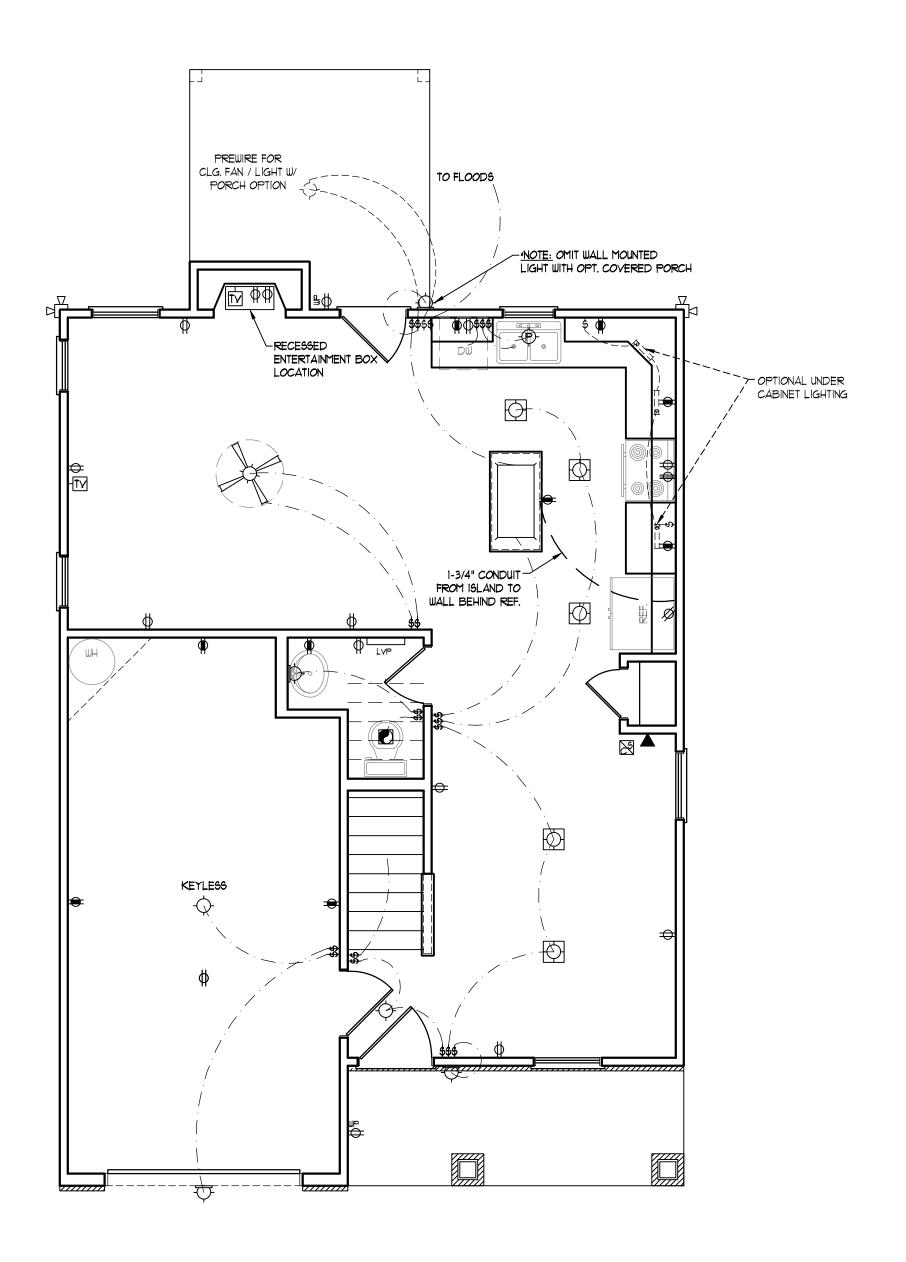
SCALE NOTE: 18x24 PRINTS ARE



OPTIONAL FAMILY ROOM WITH ALTERNATE FIREPLACE LOCATION AND BUILT-INS



FRONT PORCH AND DINING ROOM WINDOW ELEVATION B

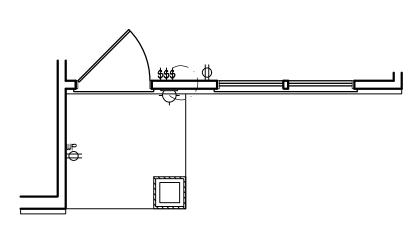

#### **ELECTRICAL LAYOUT NOTES:**

- 1.) BLOCK AND WIRE FOR ALL CELING FANS PER PLAN.
- 2.) VANITY LIGHTS TO BE SET @ 90" A.F.F. (TYP.)
- 3.) ADDITIONAL EXTERIOR OUTLETS REQUIRED BY CODE TO BE LOCATED BY ELECTRICIAN.
- 4.) PLACE SWITCHES 8" (MIN.) FROM ROUGH OPENINGS.

#### ELECTRICAL LEGEND

- ⇒ 110 Y OUTLET
- → 110 Y GFI OUTLET
- = 110 Y SWITCHED OUTLET
- BB = 110 Y BASEBOARD OUTLET
- 4-PLEX
- COUNTER OR FLOOR MOUNTED
- COUNTER OR FLOOR MOUNTED 110V GFI
- ₩EATHERPROOF
- **⇒** 22Ø ∨ OUTLET
- 10 V DEDICATED CIRCUIT
- # 220 V DEDICATED CIRCUIT
- PH SPECIAL PURPOSE (240 V, ETC.)
- WALL MOUNT LIGHT
- -P- PENDANT LIGHT
- RECESSED CAN LIGHT
- MINI CAN LIGHT
- EYEBALL LIGHT

FLUORESCENT LIGHT

undercabinet light

FLOOD LIGHT

SWITCH

DIMMER SWITCH

▲ TELEPHONE

△ DATA

TELEPHONE AND DATA

TV- TV CONNECTION

TV/ DATA

CD- CONDUIT FOR COMPONENT WIRING

SPEAKER

110 V SMOKE/ CM DETECTOR

SD 110 V SMOKE DETECTOR

EXHAUST FAN



ALARM PANEL





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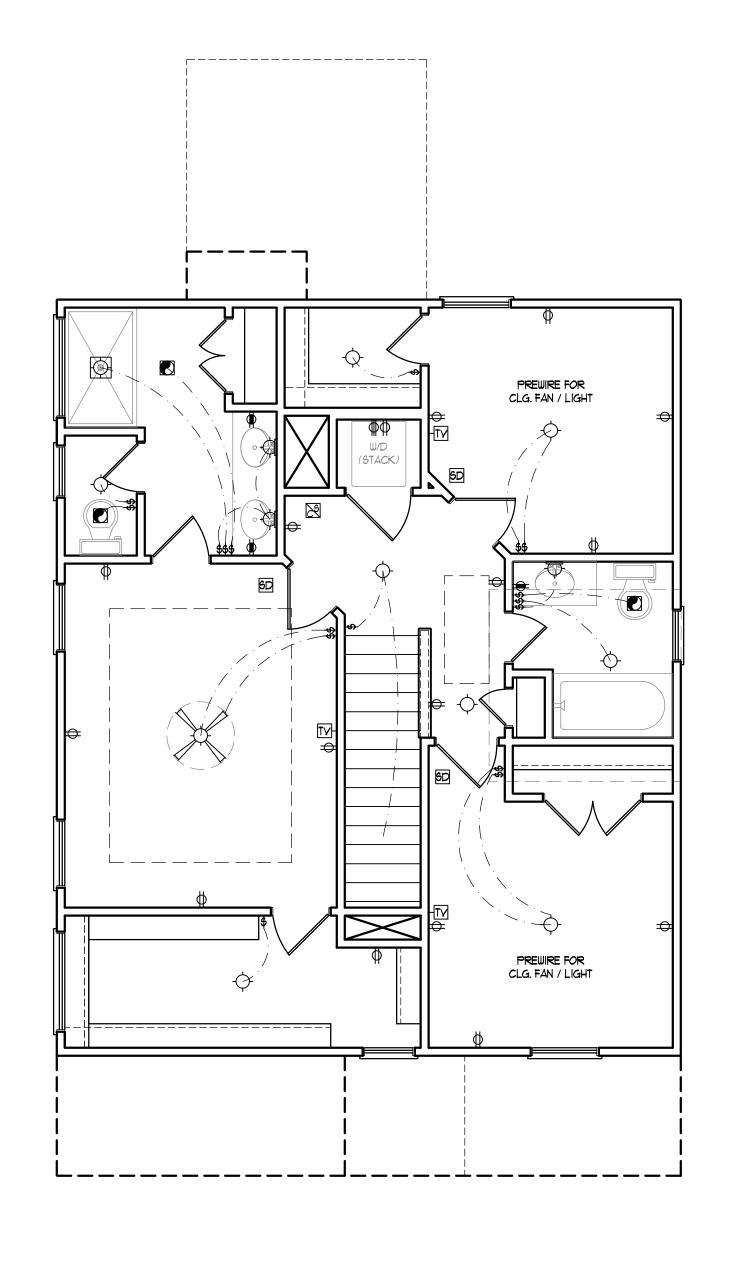
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ENGINEERED BY: REVIEWED BY:

FIRST FLOOR ELECTRICAL PLAN

E-1

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- FLUORESCENT LIGHT
- UNDERCABINET LIGHT
- FLOOD LIGHT
- SWITCH \$D DIMMER SWITCH
- ▲ TELEPHONE
- △ DATA
- TELEPHONE AND DATA
- TV- TV CONNECTION
- CD- CONDUIT FOR COMPONENT WIRING
- SP SPEAKER
- 110 Y SMOKE/ CO DETECTOR
- 6D 110 V SMOKE DETECTOR
- EXHAUST FAN



ALARM PANEL





SCALE NOTE: 18x24 PRINTS ARE TO SCALE AS NOTED. 11x17 PRINTS ARE NOT TO SCALE



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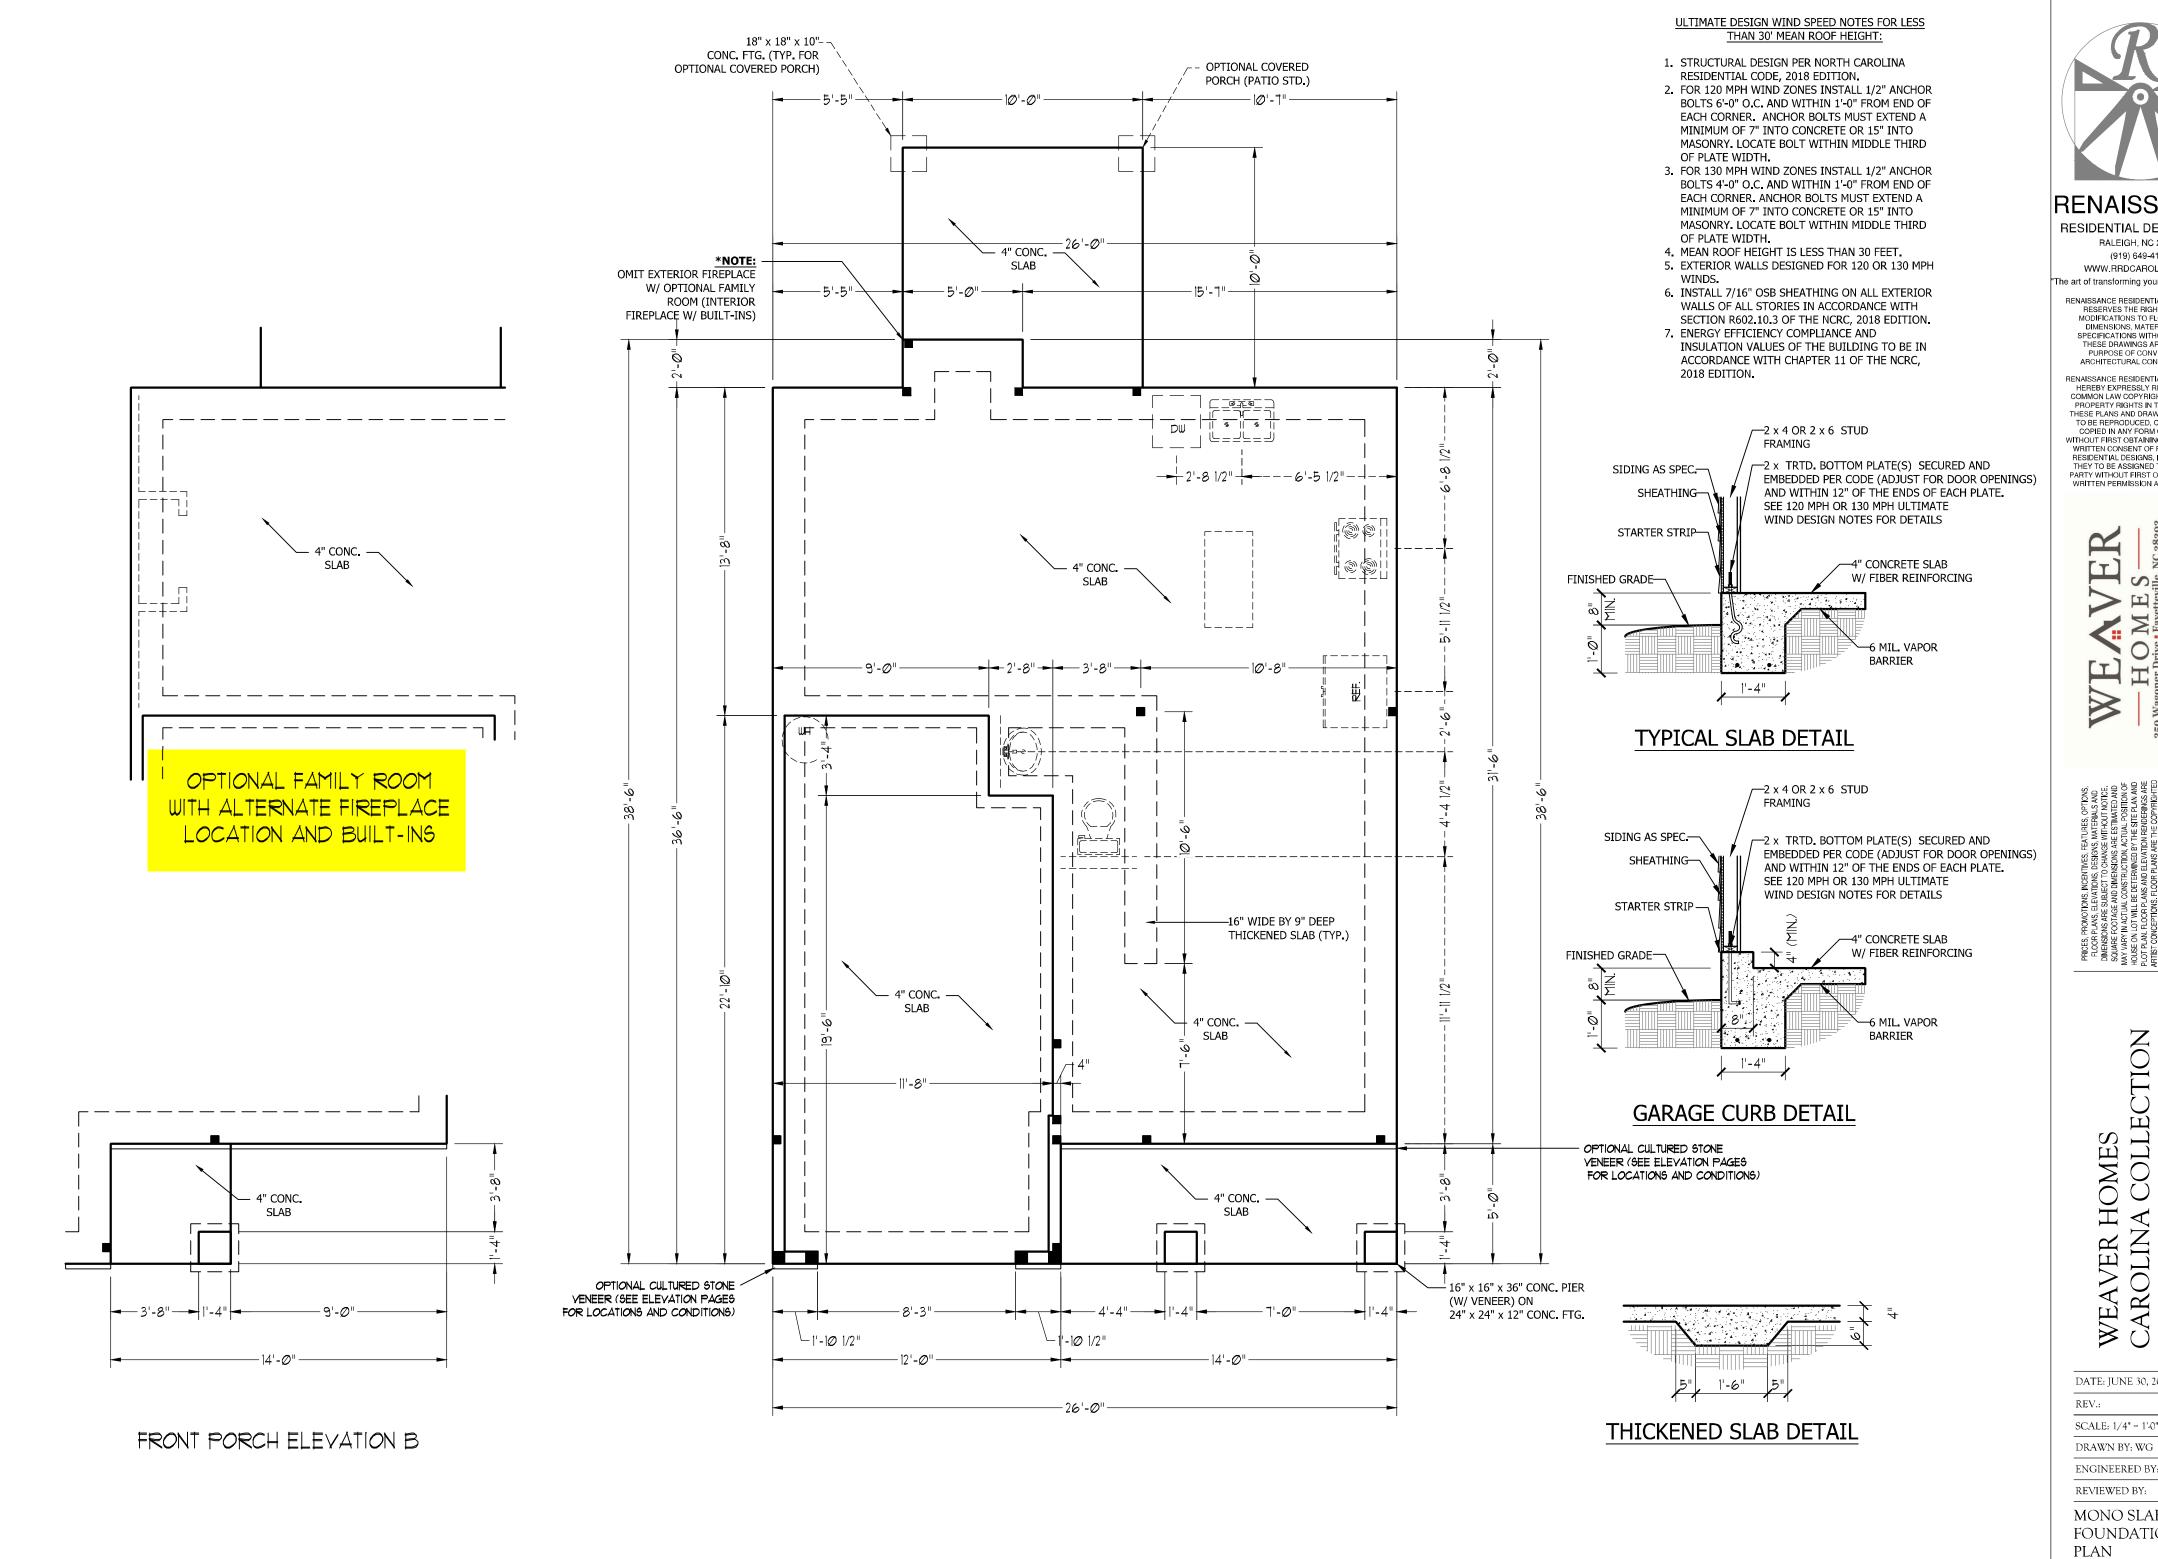
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SECOND FLOOR ELCTRICAL PLAN

E-2

 $C: \label{locuments} Projects \ Westan-Weaver \ Magnolia\_Magnolia\_GL\_6-30-20. dwg, 7/22/2020 6:47:59 \ AMS \ Magnolia\_GL\_6-30-20. dwg, 7/22/2020 6:47:59 \ Magnolia\_GL\_6-30-$ 



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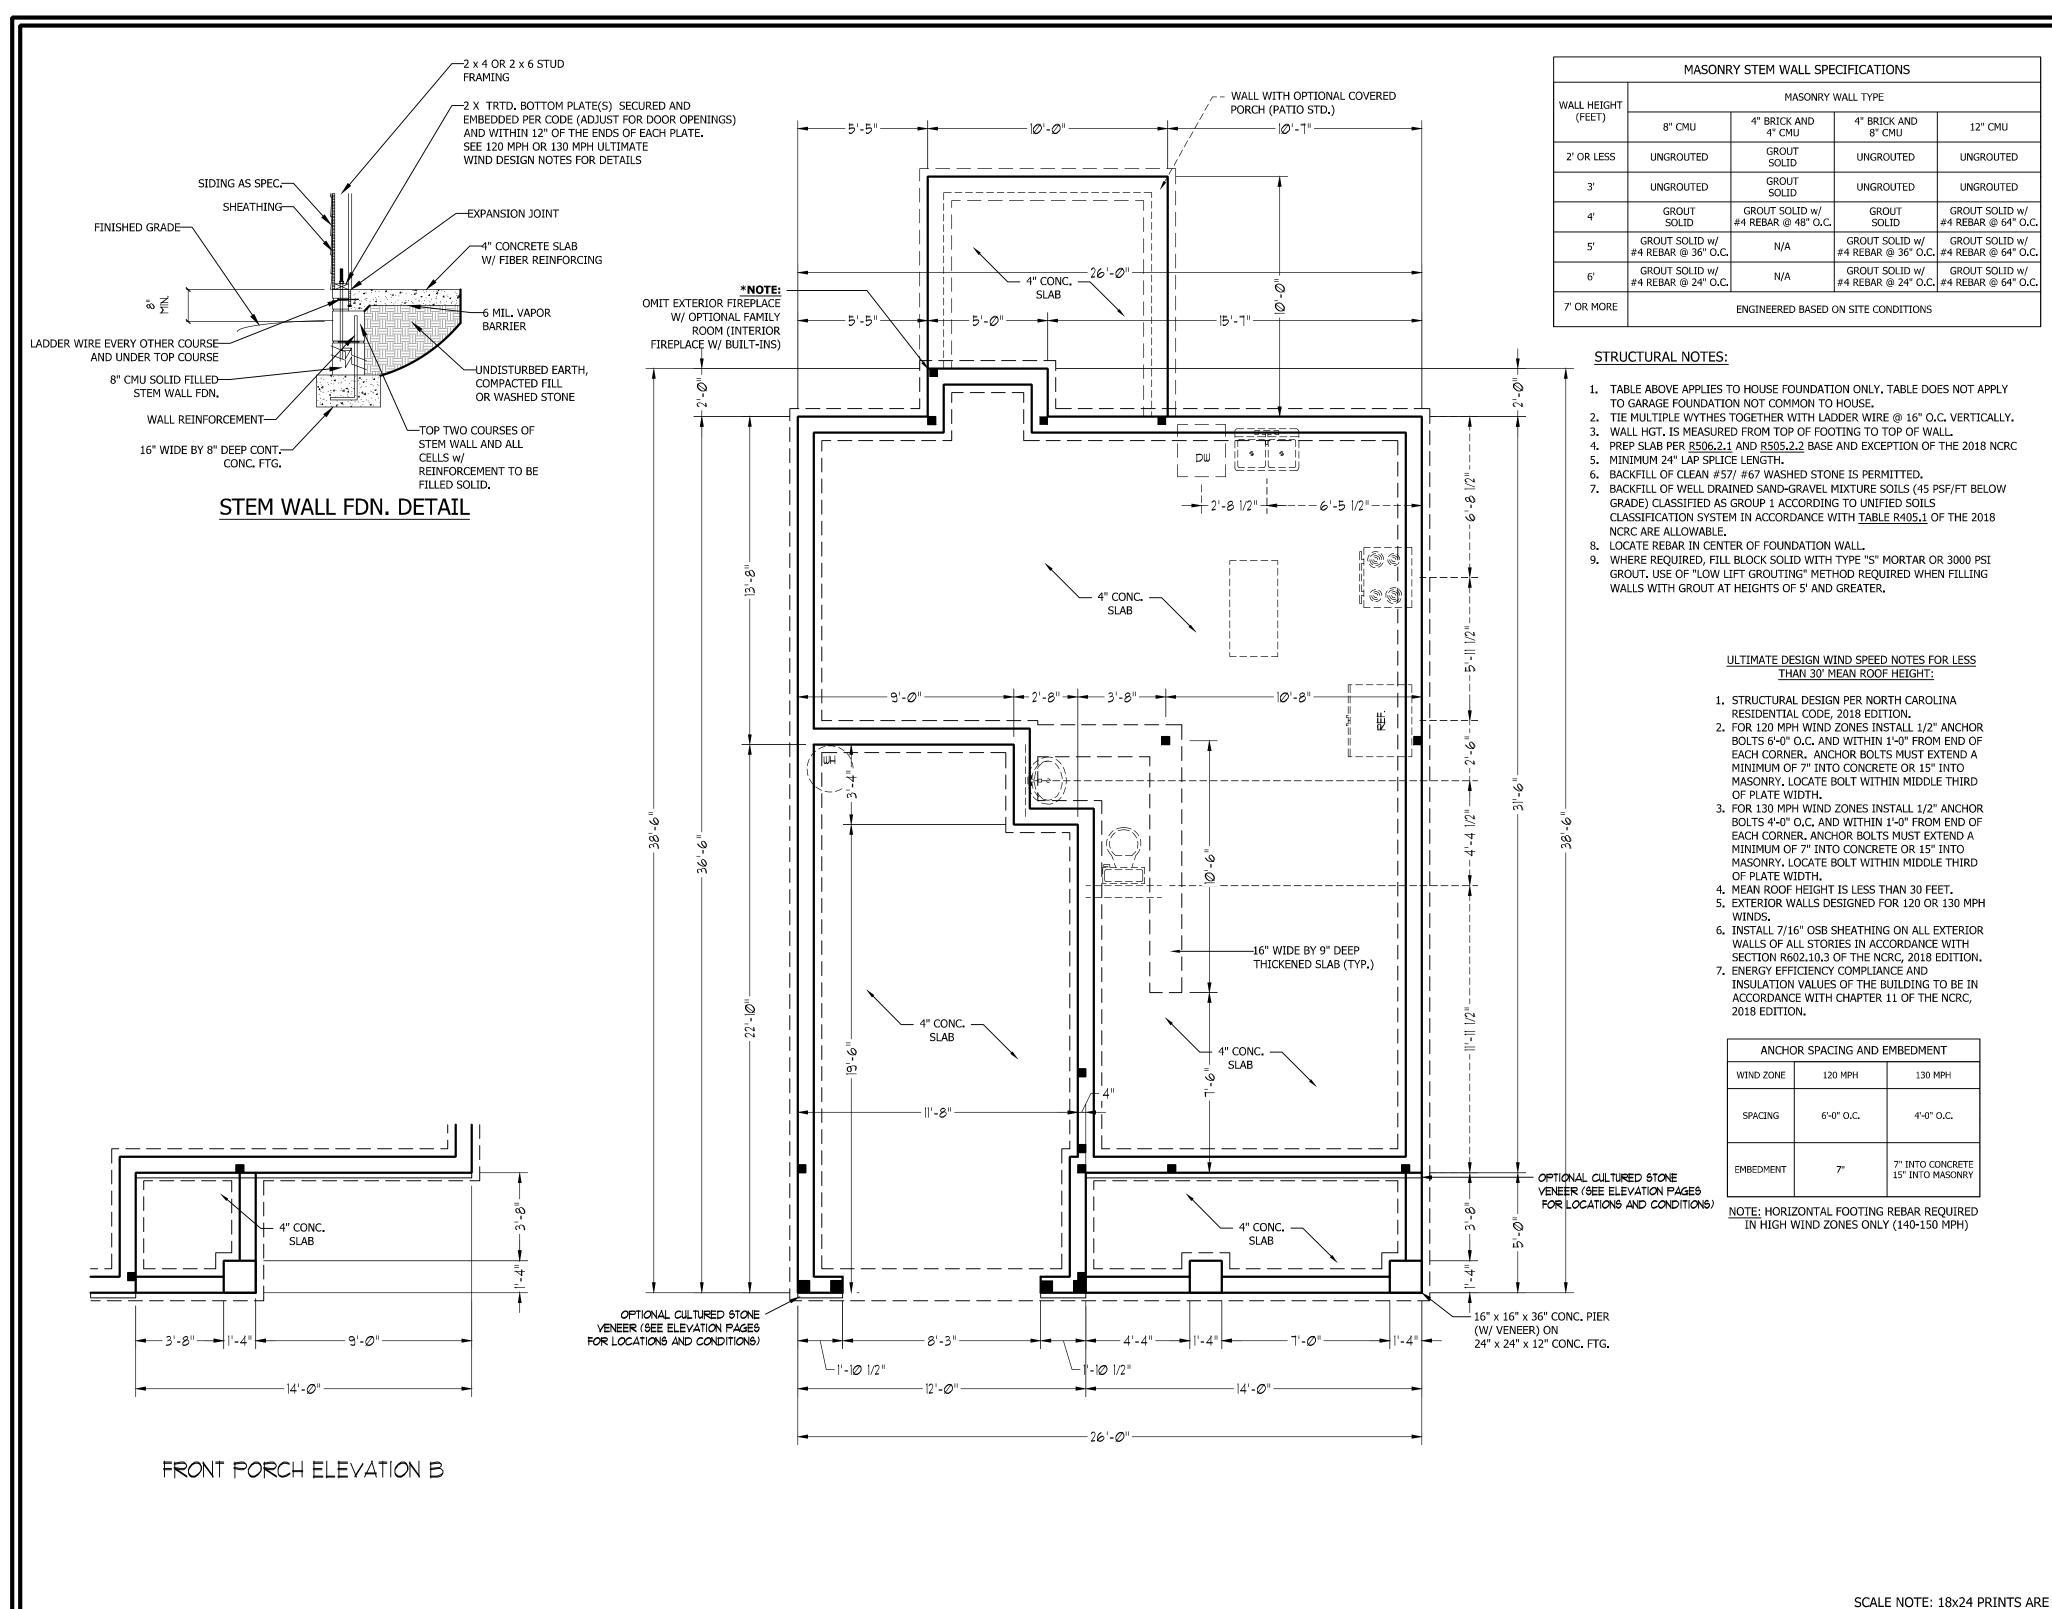
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MONO SLAB FOUNDATION PLAN

S-1

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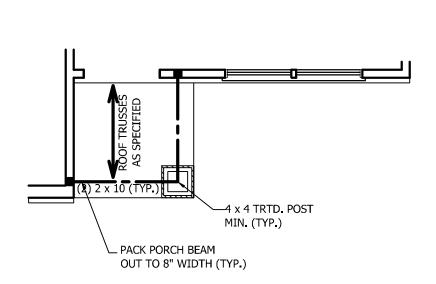
STEMWALL SLAB FOUNDATION PLAN

S-1

TO SCALE AS NOTED.

11x17 PRINTS ARE NOT TO SCALE

# OPTIONAL FAMILY ROOM WITH ALTERNATE FIREPLACE LOCATION AND BUILT-INS



FRONT PORCH AND DINING ROOM WINDOW ELEVATION B

#### **STRUCTURAL NOTES:**

PACK PORCH BEAM OUT TO 8" WIDTH (TYP. W/ COVERED

PORCH OPTION)

(3) 2 x 4-

EXTRA JOIST

/-(4) 2 x 4

(2) 2 x 10

16" TRUSSES AS SPEC.

(3) 16" FLUSH LVL AS SPECIFIED

ROOF TRUSSES AS SPEC.

(2) 11-7/8" LVL CONT. W/ (3) 2x6 EA. BEARING POINT

(4) 2 x 4 —

(2) 2x10

6 x 6 TRTD. POST -

OPTION)

(TYP. WITH PORCH

- 1. ALL FRAMING LUMBER TO BE SPF #2 (UNO). ALL TREATED LUMBER TO BE SYP #2
- 2. ALL LOAD BEARING HEADERS TO BE (2) 2 x 6 (UNO).
- 3. INSTALL AN EXTRA JOIST UNDER WALLS PARALLEL TO FLOOR JOISTS
- 4. WINDOW AND DOOR HEADERS TO BE SUPPORTED w/ (1) JACK STUD AND (1) KING STUD EA. END (UNO.). SEE TABLE R602.7.5 FOR ADDITIONAL KING STUD REQUIREMENTS.
- 5. SQUARES DENOTE POINT LOADS WHICH REQUIRE SOLID BLOCKING TO GIRDER OR FOUNDATION. ALL SQUARES TO BE (2) STUDS (UNO.)
- 6. ALL 4 X 4 POSTS SHALL BE ANCHORED TO SLABS W/ SIMPSON ABU44 POST BASES (OR EQUAL) AND 6 X 6 POSTS W/ ABU66 POST BASES (OR EQUAL) (UNO). ALL 4 X 4 AND 6 X 6 POSTS TO BE INSTALLED WITH 700 LB CAPACITY UPLIFT CONNECTORS
- 7. FOR FIBERGLASS, ALUMINUM, OR COLUMN ENG. BY OTHERS, SECURE TO SLAB W/ (2) METAL ANGLES USING 2" CONC. SCREWS. FASTEN ANGLES TO COLUMNS W/ 1/4" THROUGH BOLTS W/ NUTS AND WASHERS. LOCATE ANGLES ON OPPOSITE SIDES OF COLUMN. THROUGH BOLTS MUST BE INSTALLED PRIOR TO SETTING COLUMN.

#### **BRACE WALL PANEL NOTES:**


**EXTERIOR WALLS:** ALL EXTERIOR WALLS TO BE SHEALTHED WITH CS-WSP OR CS-SFB IN ACCORDANCE WITH SECTION R602.10.3 UNLESS NOTED OTHERWISE.


REQUIRED LENGTH OF BRACING: REQUIRED BRACE WALL LENGTH FOR EACH SIDE OF THE CIRCUMSCRIBED RECTANGLE ARE INTERPOLATED PER TABLE R602.10.3. METHODS CS-WSP AND CS-SFB CONTRIBUTE THIER ACTUAL LENGTH, METHOD GB CONTRIBUTES 0.5 ITS ACTUAL LENGTH. METHOD PF CONTRIBUTES 1.5 TIMES ITS ACTUAL LENGTH.

**GYPSUM:** ALL INTERIOR SIDES OF EXTERIOR WALLS AND BOTH SIDES OF INTERIOR WALLS TO HAVE 1/2" GYPSUM INSTALLED. WHEN NOT USING METHOD GB GYPSUM TO BE FASTENED PER TABLE R702.3.5. METHOD GB TO BE FASTENED PER TABLE R602.10.1.

**HD:** 800 LBS HOLD DOWN DEVICE FASTENED TO THE EDGE OF THE BRACE WALL PANEL NEAREST TO THE CORNER

METHODS: PER TABLE R602.10.1

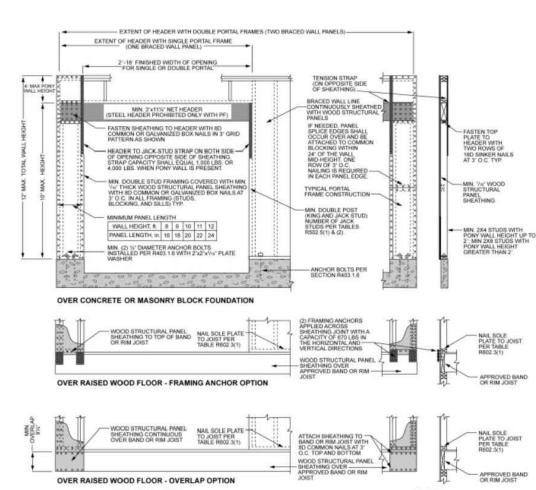

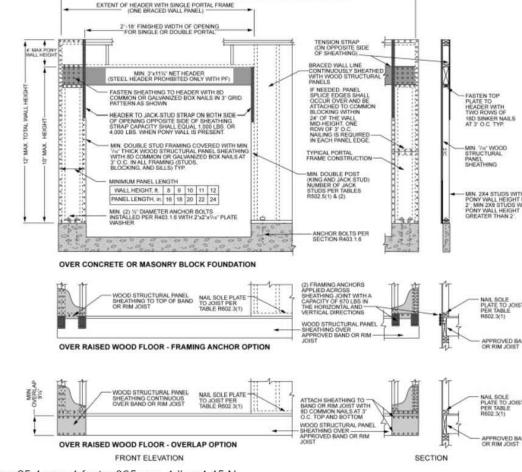

nch = 25.4 mm, 1 foot = 305 mm, 1 lb = 4.45 N.

/-(3) 2 x 4

-4 x 4 TRTD. POST

MIN. (TYP.)

(2) 16" FLUSH LVL AS SPECIFIED

(2) 2 x 10 (TYP.)

- PACK PORCH BEAM OUT TO 8"

WIDTH (TYP.)

FIGURE R602.10.1 METHOD PF—PORTAL FRAME CONSTRUCTION

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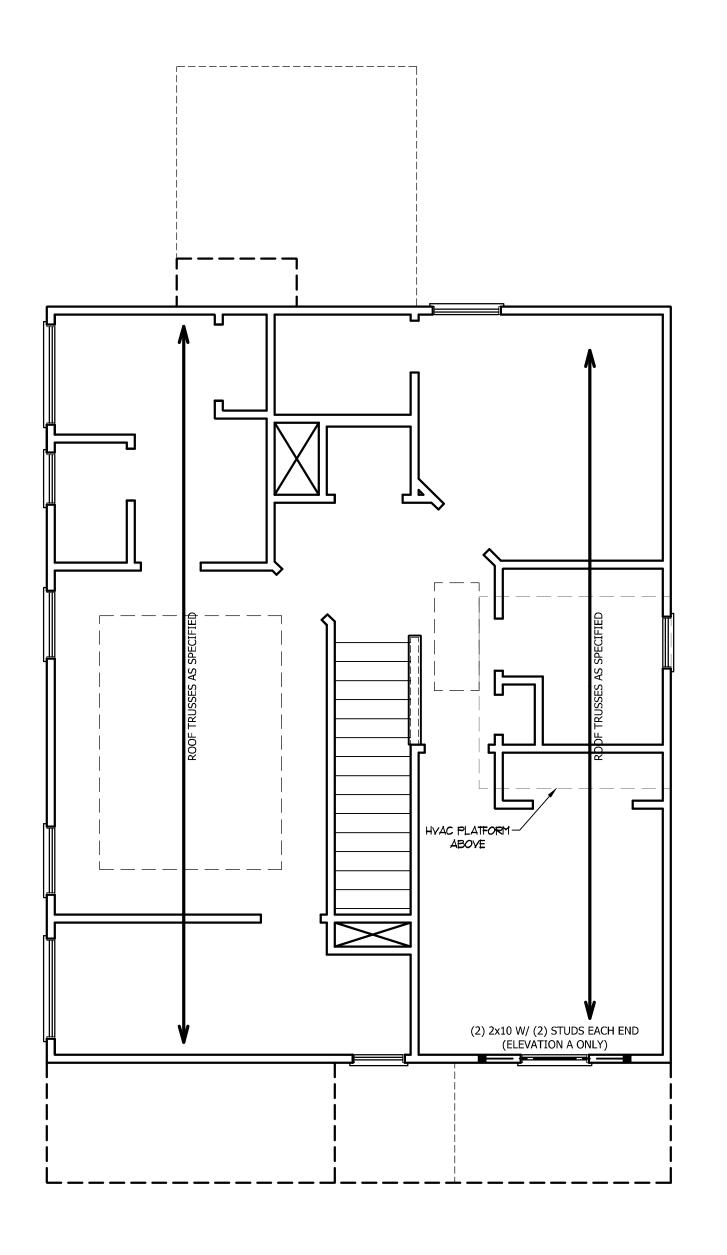
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SECOND FLOOR FRAMING PLAN

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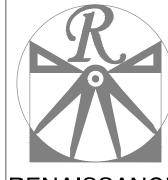
# TABLE R602.7.5 MINIMUM NUMBER OF FULL HEIGHT STUDS AT EACH END OF HEADERS IN EXTERIOR WALLS

HEADER SPAN (FEET)	MAXIMUM STUD SPACING (INCHES) (PER TABLE R602.3(5)			
( == . )	16	24		
UP TO 3'	1	1		
4'	2	1		
8'	3	2		
12'	5	3		
16'	6	4		

#### STRUCTURAL NOTES:

- 1. ALL FRAMING LUMBER TO BE SPF #2 (UNO). ALL TREATED LUMBER TO BE SYP #2 (UNO.)
- 2. ALL LOAD BEARING HEADERS TO BE (2) 2 x 6 (UNO).
- 3. WINDOW AND DOOR HEADERS TO BE SUPPORTED w/ (1) JACK STUD AND (1) KING STUD EA. END (UNO.). SEE TABLE R602.7.5 FOR ADDITIONAL KING STUD REQUIREMENTS.
- 4. SQUARES DENOTE POINT LOADS WHICH REQUIRE SOLID BLOCKING TO GIRDER OR FOUNDATION. ALL SQUARES TO BE (2) STUDS (UNO.)

DSP - DOUBLE STUD POCKET TSP - TRIPLE STUD POCKET



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FINED, SEE HINH HOME SALES CONDULITANT FOR

WEAVER HOMES CAROLINA COLLECTION MAGNOLIA DRIVE LEFT

DATE: JUNE 30, 2020

REV.:

SCALE: 1/4" = 1'-0"

DRAWN BY: WG

ENGINEERED BY:

REVIEWED BY:

ATTIC FLOOR FRAMING PLAN

SCALE NOTE: 18x24 PRINTS ARE
TO SCALE AS NOTED.

11x17 PRINTS ARE NOT TO SCALE


S-3

#### ATTIC VENT CALCULATION:


1040 SQ. FT. OF ATTIC DIVIDED BY 150 REQUIRES 6.9 SQ. FT. OF NET FREE VENTILATING AREA (MIN.).

#### **STRUCTURAL NOTES:**

- 1. ALL FRAMING LUMBER TO BE #2 SPF (UNO).
- 2. HIP SPLICES ARE TO BE SPACED A MIN. OF 8'-0". FASTEN MEMBERS WITH THREE ROWS OF 12d NAILS @ 16" O.C. (TYP.)
- 3. STICK FRAME OVER-FRAMED ROOF SECTIONS W/ 2 x 8 RIDGES, 2 x 6 RAFTERS @ 16" O.C. AND FLAT 2 x 10 VALLEYS OR USE VALLEY TRUSSES.
- 4. FASTEN FLAT VALLEYS TO RAFTERS OR TRUSSES WITH SIMPSON H2.5A HURRICANE TIES @ 32"
  O.C. MAX. PASS HURRICANE TIES THROUGH NOTCH IN ROOF SHEATHING. EACH RAFTER IS TO BE FASTENED TO THE FLAT VALLEY WITH A MIN. OF (6) 12d TOE NAILS.
- 5. REFER TO SECTION R802.11 OF THE 2018 NCRC FOR REQUIRED UPLIFT RESISTANCE AT RAFTERS AND TRUSSES.

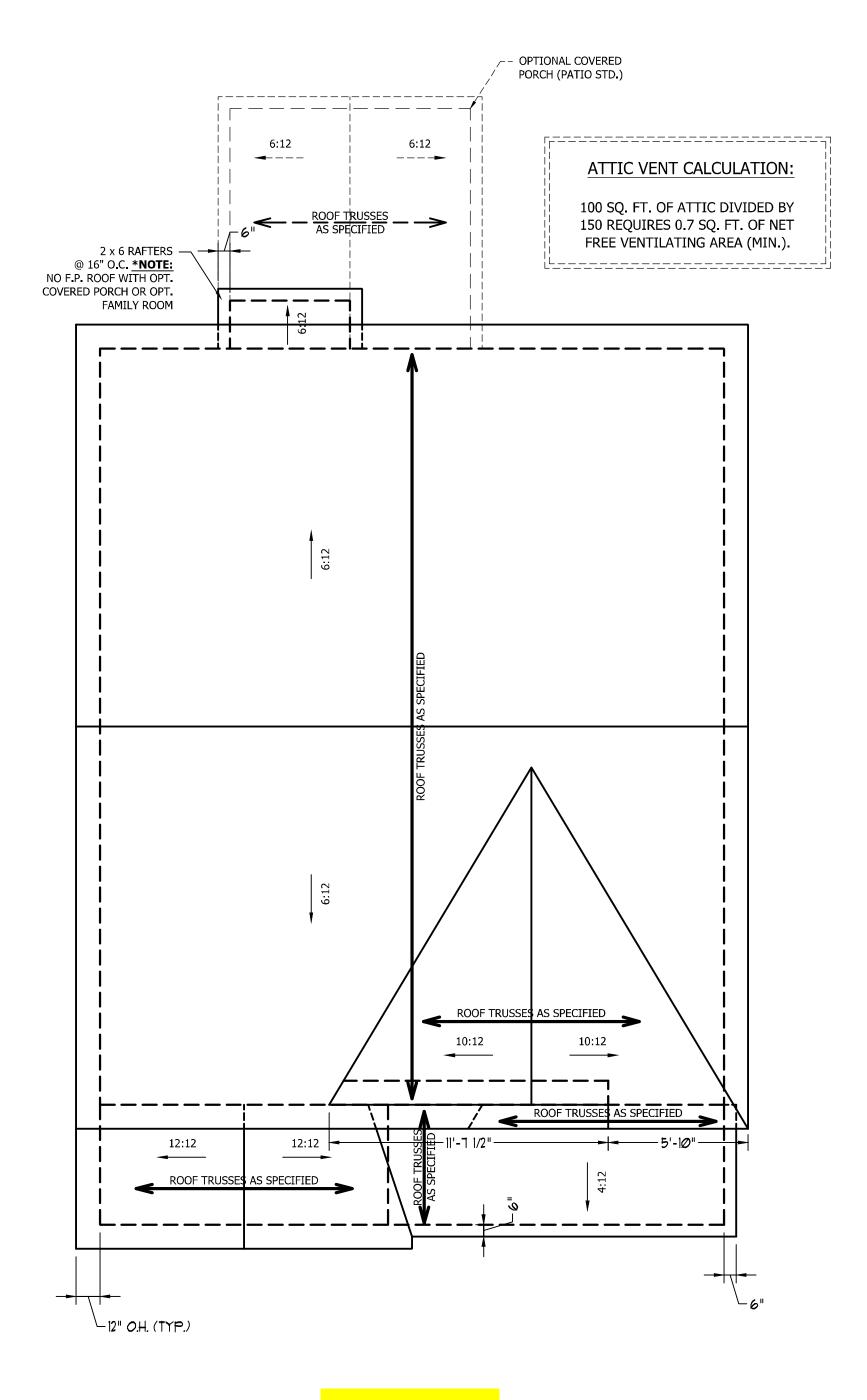

ELEVATION C

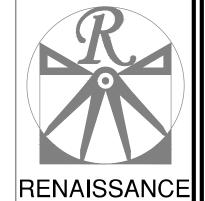

RESIDENTIAL DESIGN, INC. RALEIGH, NC 27612 (919) 649-4128

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ON LOT WILL BE DETERMINED BY THE SITE PLAN AND

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RIY OF WEAVER HOMES, ANY USE REPRODUCTION,

PTATION, OR DISPLAYOF THE PLANS IS STRICTLY

WEAVER HOMES CAROLINA COLLECTION MAGNOLIA DRIVE LEFT

DATE: JUNE 30, 2020

REV.:


SCALE: 1/4" = 1'-0"

DRAWN BY: WG


ENGINEERED BY:
REVIEWED BY:

ROOF PLAN ELEVATION - C

S-4

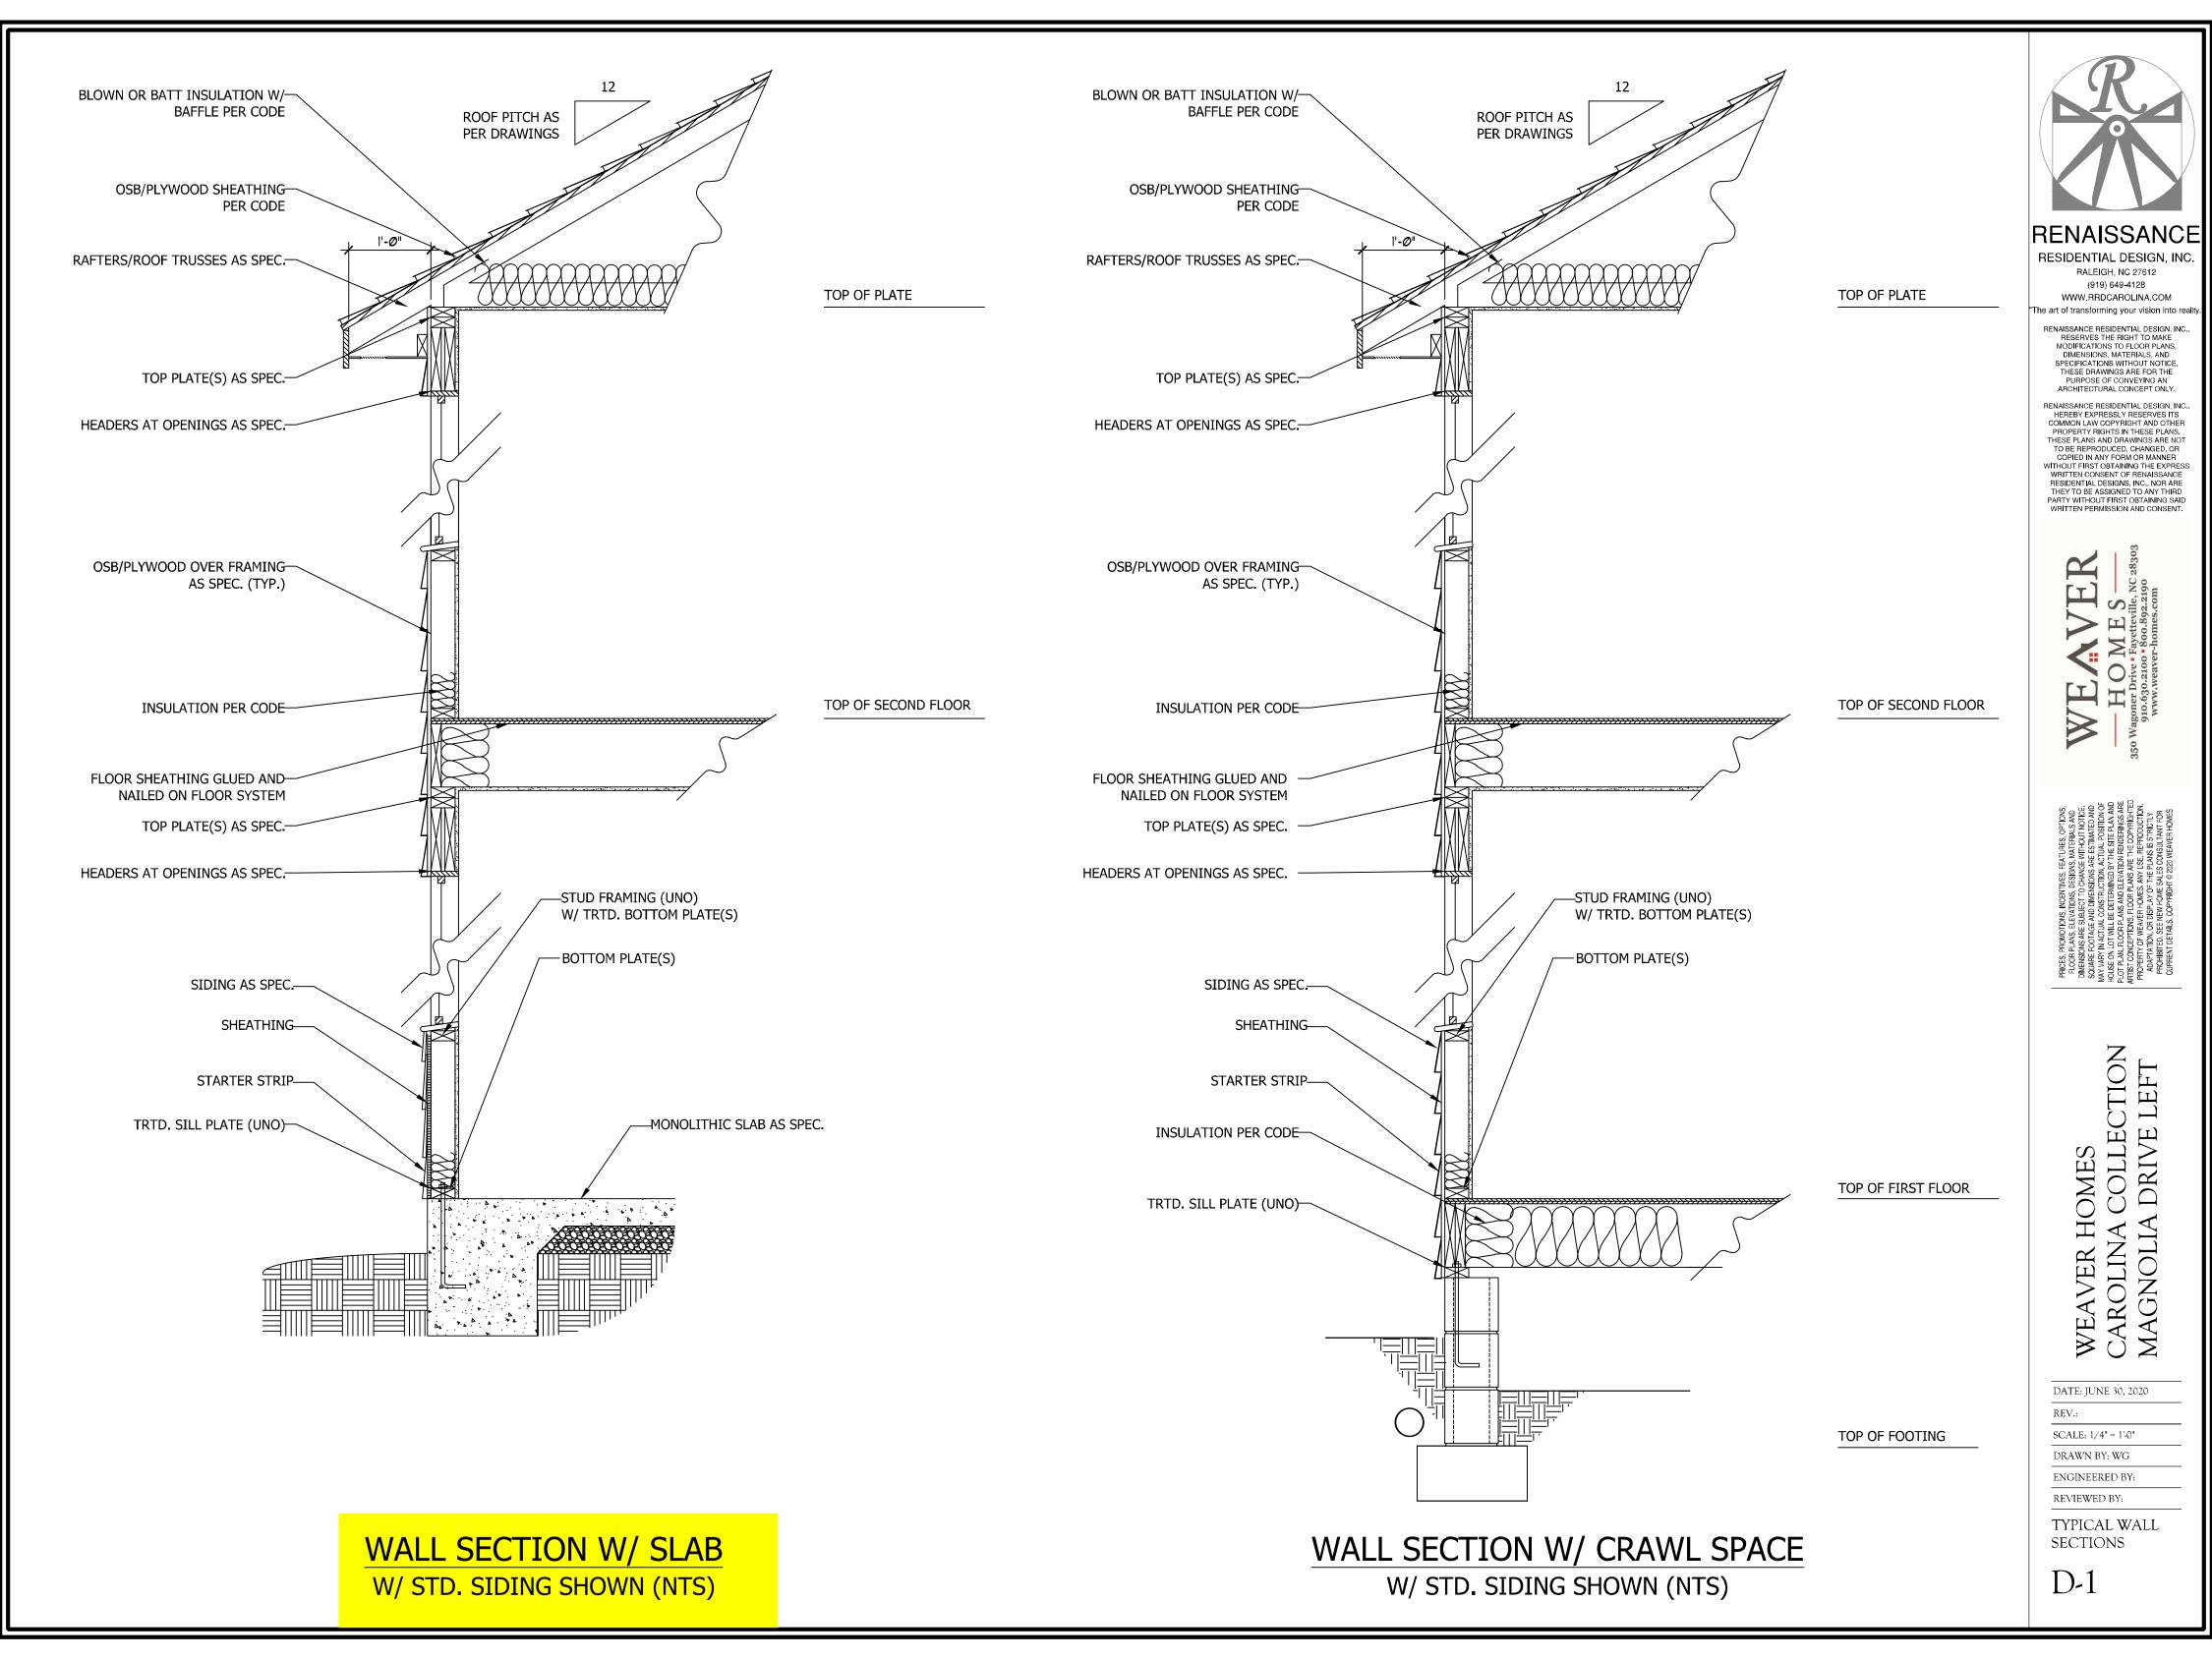

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= HUS410 (Qty. 16) **=** MSH422 (Qty. 2) ●= MSH422IF (Qty. 1)
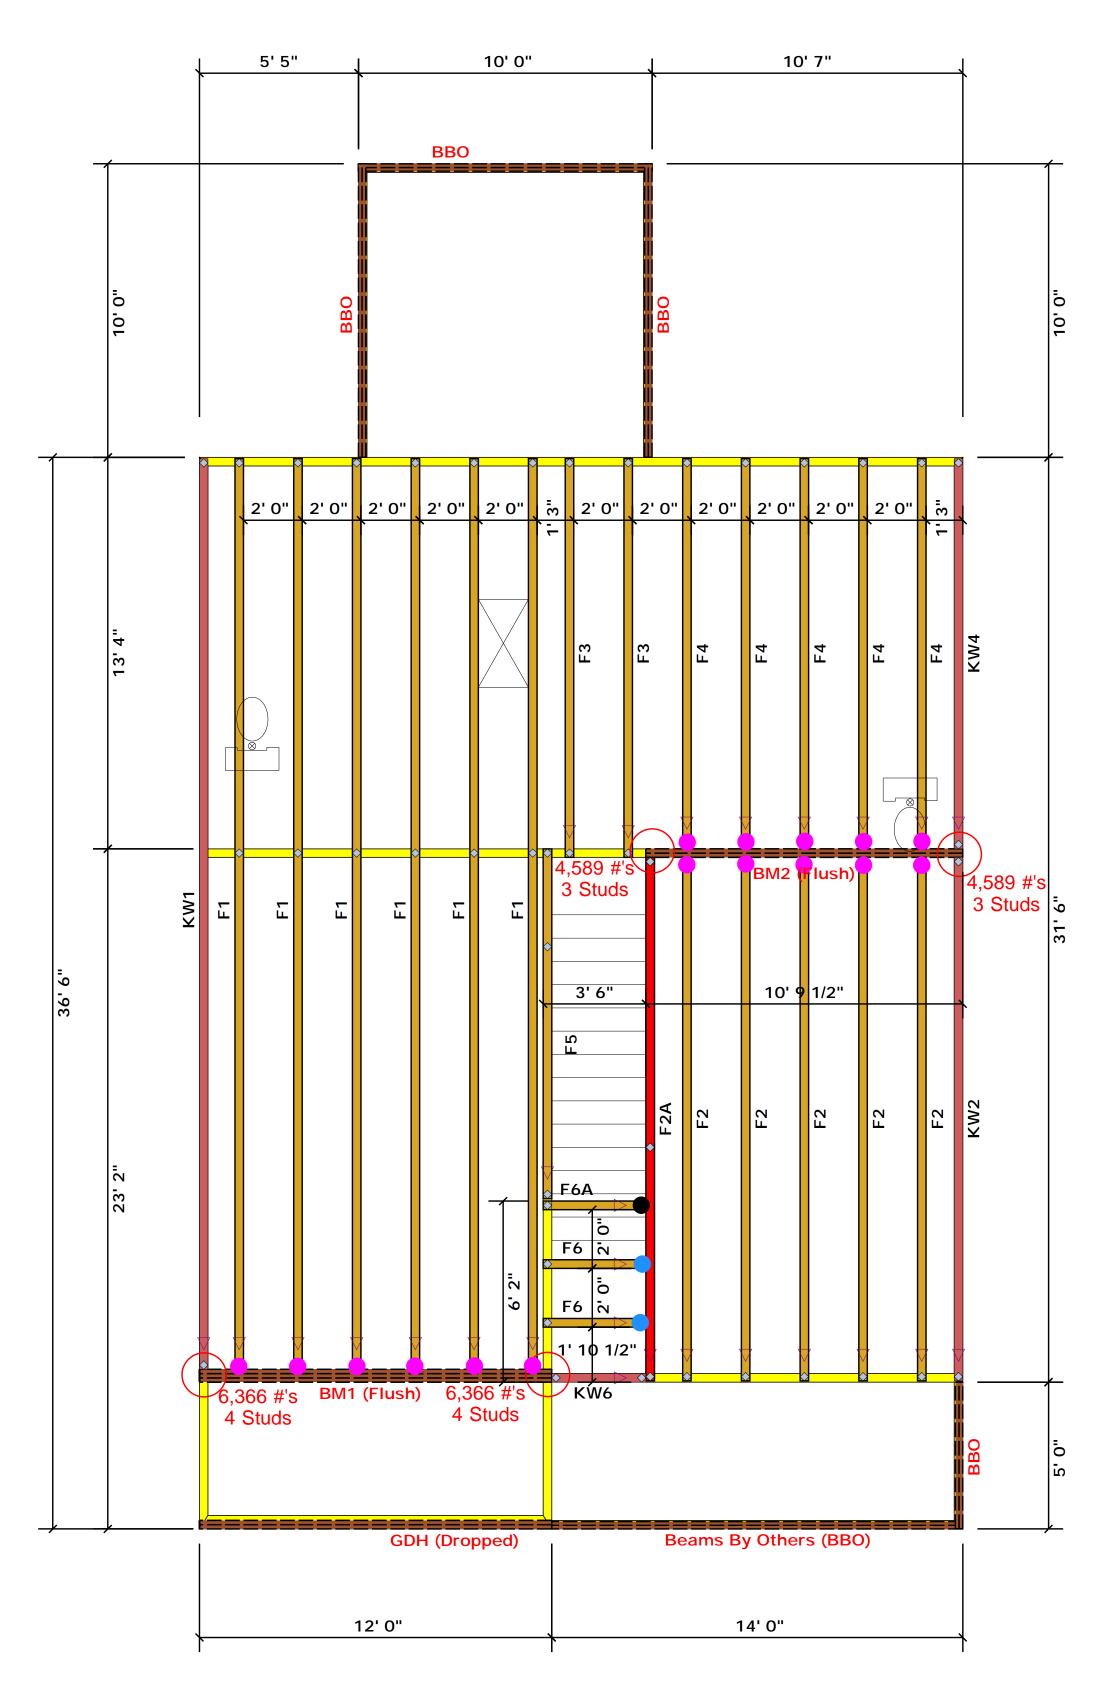
### **Truss Placement Plan SCALE: NTS**

▲ = Denotes Left End of Truss (Reference Engineered Truss Drawing)

**Products** PlotID Product Plies Net Qty Length GDH (Dropped) 12' 0" 1-3/4"x 11-7/8" LVL Kerto-S BM1 (Flush) 1-3/4"x 16" LVL Kerto-S 12' 0" 3 BM2 (Flush) 11' 0" 1-3/4"x 16" LVL Kerto-S 2

All Truss Reactions are Less than 3,000 lbs. Unless Noted Otherwise.

-- Denotes Reaction Greater than 3,000 lbs. Reaction / # of Studs

LOAD CHART FOR JACK STUDS  (BASE ON TABLE SERVICE) A 601  MARIE OF JACK STUDG SCOUNTED & CALON SE		BUILDER	Weaver Development	CITY / CO.	Dunn / Harnett	THIS IS A TRUSS PLA These trusses are designe the building design at the s sheets for each truss design	
	FEADER/6170ER	z   5 %	JOB NAME	Lot 16 West Park	ADDRESS	Lot 16 West Park	is responsible for tempora the overall structure. The c walls, and columns is the regarding bracing, consult
	CROSS STORY	END &	PLAN	Magnolia Elev. C	MODEL	Floor	or online @ sbcindustry.co  Bearing reactions less the prescriptive Code require
	1700 1 2550 1 3400 2 5100 2 5100 3 7650 3	3400 ! 6600 2 10200 3	SEAL DATE	Seal Date	DATE REV.	/ /	( derived from the presc foundation size and num than 3000# but not great be retained to design the
	6800 4 10200 4 8500 5 12750 5 10200 6 15300 6	13600 4 17000 5	QUOTE #	Quote #	DRAWN BY	Christine Shivy	specified in the attached retained to design the si
	11900 7 13600 8 15300 9		JOB#	J0720-3441	SALES REP.	Lenny Norris	Signature

PLACEMENT DIAGRAM ONLY. signed as individual building componer the specification of the building design


Christine Shivy

**Christine Shivy** 

**ROOF & FLOOR TRUSSES & BEAMS** Reilly Road Industrial Park

соттесн

Fayetteville, N.C. 28309 Phone: (910) 864-8787 Fax: (910) 864-4444

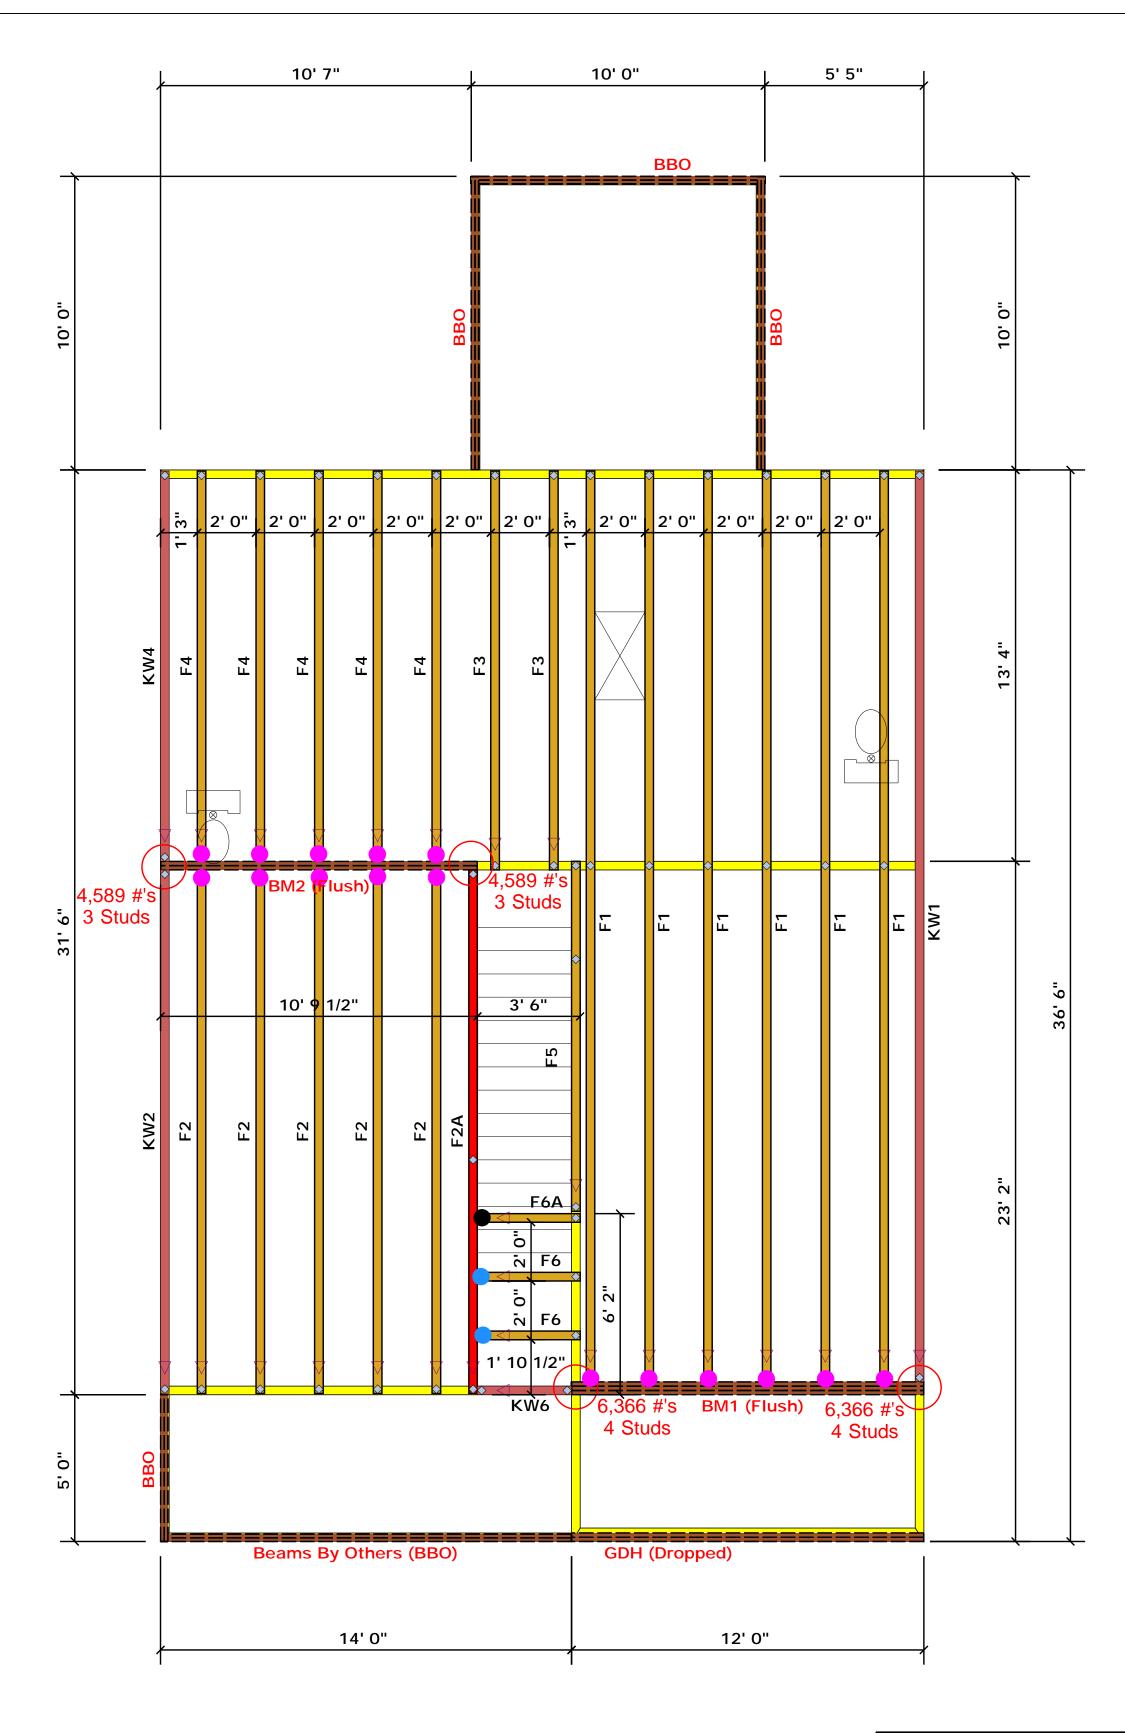

= HUS410 (Qty. 16) **=** MSH422 (Qty. 2) ●= MSH422IF (Qty. 1)

## **Truss Placement Plan SCALE: NTS**

▲ = Denotes Left End of Truss (Reference Engineered Truss Drawing)

**Products** PlotID Product Plies Net Qty Length GDH (Dropped) 12' 0" 1-3/4"x 11-7/8" LVL Kerto-S BM1 (Flush) 1-3/4"x 16" LVL Kerto-S 12' 0" 3 BM2 (Flush) 11' 0" 1-3/4"x 16" LVL Kerto-S 2

All Truss Reactions are Less than 3,000 lbs. Unless Noted Otherwise.

-- Denotes Reaction Greater than 3,000 lbs. Reaction / # of Studs

(DASEN )	RT FOR JACK STUDS ON FAILER (S0250) 4 (60) ON FAILER (S0250) 4 (60) ON FAILER (S0250) 4 (60)	BUILDER	Weaver Development	CITY / CO.	Dunn / Harnett	THIS IS A TRUSS PLACEMENT DIAGRAM ONLY. These trusses are designed as individual building components the building design at the specification of the building designer. sheets for each truss design identified on the placement drawin is responsible for temporary and permanent bracing of the roof the overall structure. The design of the truss support structure is walls, and columns is the responsibility of the building designer regarding bracing, consult BCSI-B1 and BCSI-B3 provided with the structure is the structure in the structure is the structure.
z 3 f.	PEADENGEROER  2	JOB NAME	Lot 16 West Park	ADDRESS	Lot 16 West Park	
OT 50 OT 50 SEC 0 SI UDA MANAH KIMIO	90 0 0 0 0 0 0 0 0 0 0 0 0 0 0 0 0 0 0	PLAN	Magnolia Elev. C	MODEL	Floor	or online @ sbcindustry.com  Bearing reactions less than or equal to 3000# are deemed prescriptive Code requirements. The contractor shall refer
1700 1 3400 2 5100 3	2550 1 3400 1 5100 2 6600 2 7650 3 10200 3	SEAL DATE	Seal Date	DATE REV.	/ /	( derived from the prescriptive Code requirements ) to foundation size and number of wood studs required to than 3000# but not greater than 15000#. A registered debe retained to design the support system for any reacti
6800 4 8500 5 10200 6	10200 4 13600 4 12750 5 17000 5 15300 6	QUOTE #	Quote #	DRAWN BY	Christine Shivy	specified in the attached Tables. A registered design proferetained to design the support system for all reactions the Christine Sh
11900 7 13600 8 15300 9		JOB #	J0720-3441	SALES REP.	Lenny Norris	Christine Shi


Christine Shivy

**Christine Shivy** 

**TRUSSES & BEAMS** Reilly Road Industrial Park Fayetteville, N.C. 28309 Phone: (910) 864-8787 Fax: (910) 864-4444

соттесн

**ROOF & FLOOR** 

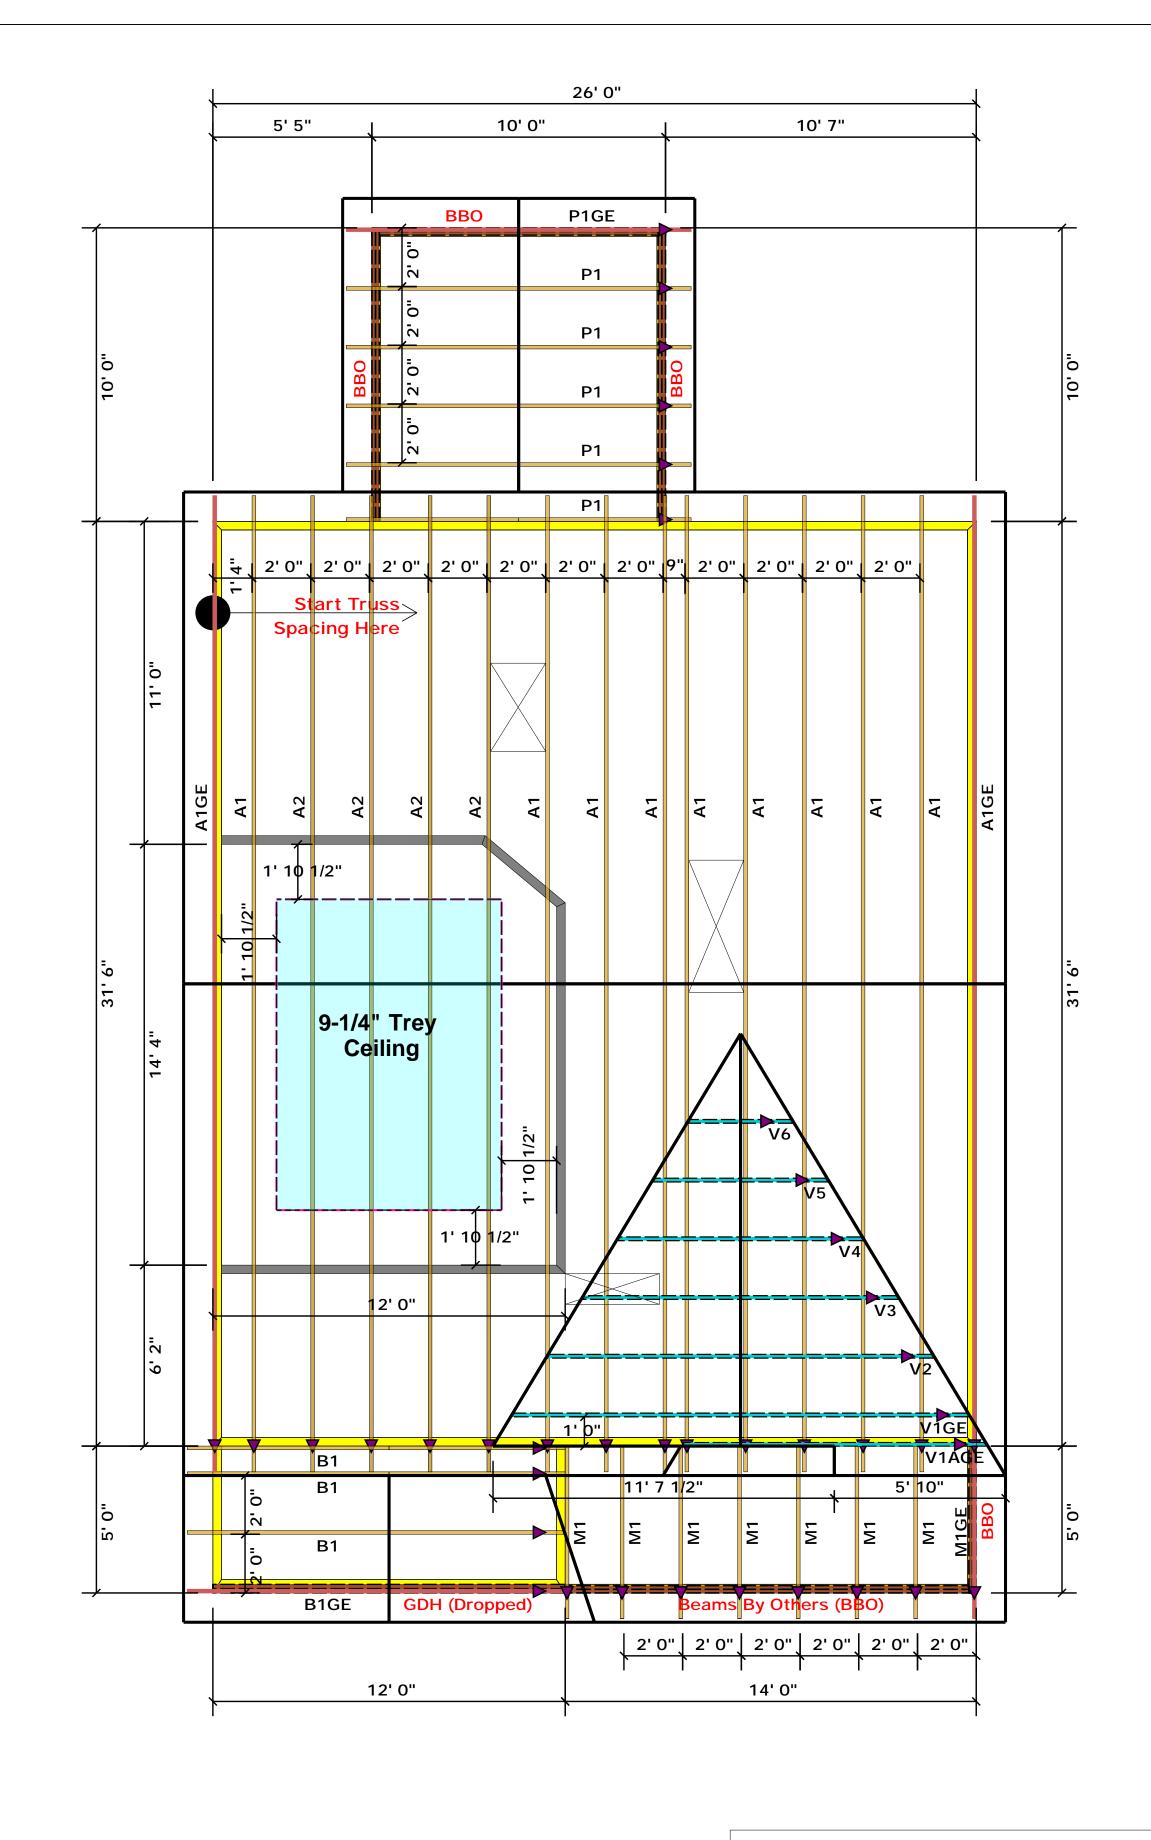

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) .

-- Denotes Reaction Greater than 3,000 lbs.

Reaction / # of Studs

▲= Denotes Left End of Truss (Reference Engineered Truss Drawing)

LOAD CHART FOR JACK STUDS

(BASED ON LABOR (500.51) A 60)

STANCE OF JACK STUDO ALS INSIDE ( A CND OF FEADER/6000E)

2550 1 5100 2

7650 3

10200 4

12750 5

15300 6

3400

6600 2

10200 3

13600 4

17000 5

1700 1 3400 2

5100 3

Truss Placement Plan SCALE: NTS

		<u> </u>			
	BUILDER	Weaver Development	CITY / CO.	Dunn / Harnett	THIS IS These tru the buildi sheets fo
i de	JOB NAME	Lot 16 West Park	ADDRESS	Lot 16 West Park	is respon the overa walls, and regarding
(1) PA	PLAN	Magnolia Elev. C	MODEL	Roof	or online  Bearing i prescript
	SEAL DATE	Seal Date	DATE REV.	/ /	( derived foundation than 3000 be retain
	QUOTE #	Quote #	DRAWN BY	Christine Shivy	specified retained
_	JOB#	J0720-3440	SALES REP.	Lenny Norris	Signa

THIS IS A TRUSS PLACEMENT DIAGRAM ONLY.

These trusses are designed as individual building components to be incorporated into the building design at the specification of the building designer. See individual design sheets for each truss design identified on the placement drawing. The building designer is responsible for temporary and permanent bracing of the roof and floor system and for the overall structure. The design of the truss support structure including headers, beams, walls, and columns is the responsibility of the building designer. For general guidance regarding bracing, consult BCSI-B1 and BCSI-B3 provided with the truss delivery package or online @ sbcindustry.com


Bearing reactions less than or equal to 3000# are deemed to comply with the prescriptive Code requirements. The contractor shall refer to the attached Tables ( derived from the prescriptive Code requirements ) to determine the minimum foundation size and number of wood studs required to support reactions greater than 3000# but not greater than 15000#. A registered design professional shall be retained to design the support system for any reaction that exceeds those specified in the attached Tables. A registered design professional shall be retained to design the support system for all reactions that exceed 15000#.

Christine Shivy

Christine Shivy



Phone: (910) 864-8787 Fax: (910) 864-4444

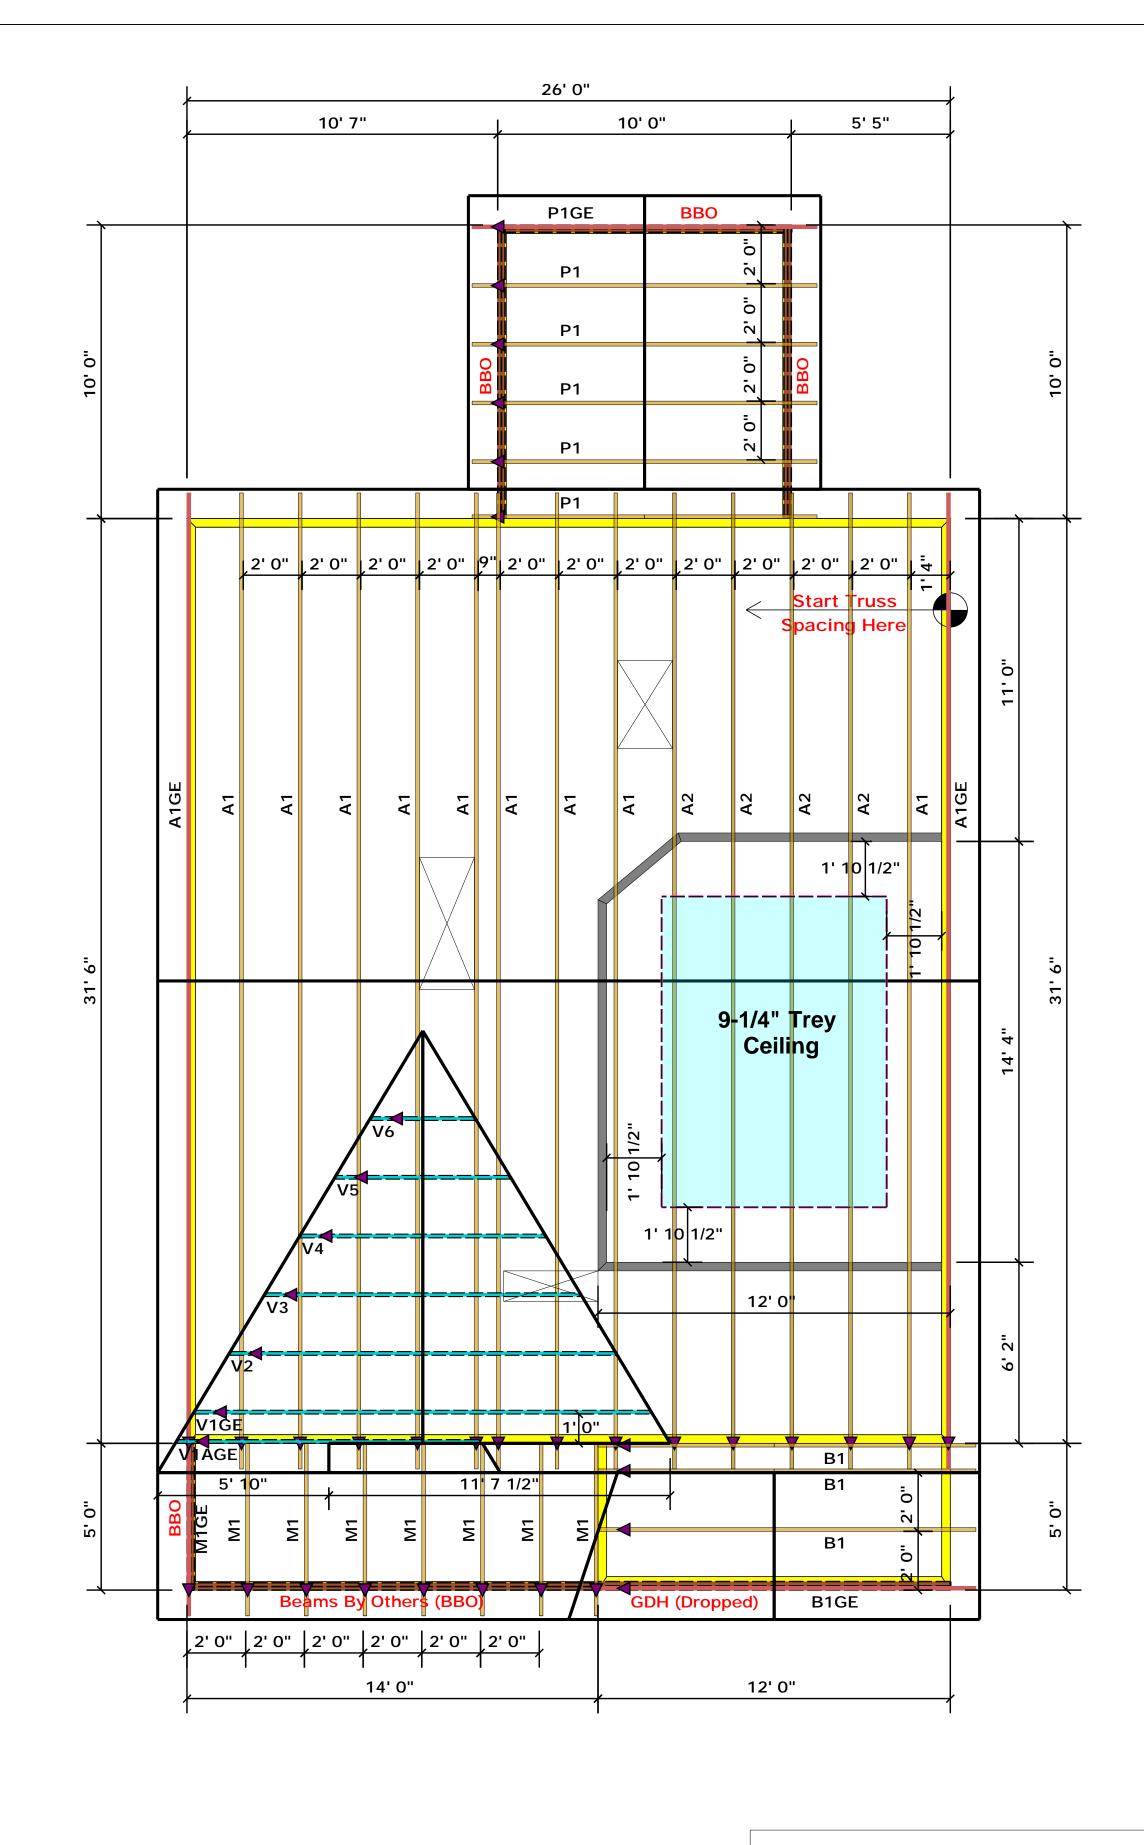

All Truss Reactions are Less than 3,000 lbs. Unless Noted Otherwise.

) -

-- Denotes Reaction Greater than 3,000 lbs.
Reaction / # of Studs

▲= Denotes Left End of Truss (Reference Engineered Truss Drawing)

J0720-3440

LOAD CHART FOR JACK STUDS

(BASED ON LABOR (500.51) A 60)

STANCE OF JACK STUDO ALS INSIDE ( A CND OF FEADER/6000E)

2550 1 5100 2

7650 3

10200 4 12750 5

15300 6

3400

6600 2

10200 3

13600 4

17000 5

JOB#

1700 1 3400 2

Truss Placement Plan SCALE: NTS

Lenny Norris

BUILDER	Weaver Development	CITY / CO.	Dunn / Harnett	THIS IS A TRUSS PLACE These trusses are designed a the building design at the spec sheets for each truss design is	
JOB NAME	Lot 16 West Park	ADDRESS	Lot 16 West Park	is responsible for temporary a the overall structure. The designalis, and columns is the responding bracing, consult BC	
PLAN	Magnolia Elev. C	MODEL	Roof	or online @ sbcindustry.com  Bearing reactions less than prescriptive Code requirements	
SEAL DATE	Seal Date	DATE REV.	/ /	( derived from the prescript foundation size and number than 3000# but not greater to be retained to design the su	
QUOTE #	Quote #	DRAWN BY	Christine Shivy	specified in the attached Ta retained to design the supp	

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Christine Shivy

Christine Shivy



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