JORDAN

JORDAN REVISION LIST - STRUCTURAL:

- 1.) CODE LIPDATE TO SCRC 2018 (1-20)
- 2.) CHANGE 2X6 EXTERIOR WALLS TO 2X4 EXTERIOR WALLS. (3-5-20)
- 3.) ADDED BASEMENT PLAN WHICH EXTENDS GARAGE FRONT 2'0". (5-1-20)

JORDAN REVISION LIST - ARCHITECTURAL:

1.) UPDATED PLANS: 7'40' HDR HGT. ADDED 2 HOSE BIBB LOC'NS, CHANGE MASTERS TO OWNERS, CHANGE

SOFFITS TO C.O., CHANGE MASTERS BATH TO OWNERS BATH I, CHANGED POWDER TO PDR I, AND CHANGED BATH TO BATH 2. (11.4-19)

2.) ADDED ROOF VENT CALCULATIONS FOR ELEV. A AND B. (12-2-19)

3.) UPDATED CUTSHEETS FOR THE GARAGE RIGHT. (12-13-19)

4.) CHANGED FIREPLACE FROM STANDARD TO OPTIONAL. (5-1-20)

5.) REMOVE GLASS INSERTS FROM GARAGE WINDOWS AND REMOVE METAL ACCESSORIES.(5-1-20)

6.) UPDATED CUTSHEETS TO MEET H&H STANDARDS. (5-1-20)

7.) ADDED OPTIONAL GLASS INSERTS TO TOP WINDOWS ONLY TO GARAGE DOORS. (5-1-20)

8.) CHANGED THE CORNERBOARDS FROM 6" TO 4". (5-1-20)

9.) REMOVED OPTIONAL KITCHEN CAN AND REPLACED WITH FLUORSCENT LIGHT IN THE KITCHEN. (5-1-20)

10.) CHANGE LOCATION OF THE HOSE BIBBS. (5-1-20) 11.) ADDED OPTIONAL GAS LINE NOTE AT PATIO, (5-1-20)

12.) CHANGED REFRIGERATOR, WASHER, AND DRYER TO OPTIONAL COMPONENTS. (5-1-20)

13.) CHANGE COFFERED CEILING IN DINING TO OPTIONAL WITH DETAIL. (5-1-20)

14.) ADDED WEATHERING STRIPPING AT 2-0 X 4-0 SOLID DOOR. (5-1-20)

15.) ADDED NOTE TO REMOVE (1)-3-0 5-0 WINDOW FOR BEDROOM #5 OPTION. (5-1-20)

16.) REMOVED GRIDS FROM SIDE AND REAR WINDOWS. (5-1-20)

17.) CHANGED 3-0 5-0 WINDOW IN LOFT TO STANDARD, (5-1-20)

18.) UPDATED STONE HATCH ON ELEVATIONS. (5-1-20) 19.) REMOVED ALL TV OUTLETS, PHONE OUTLETS, AND ELECTRICAL OUTLETS EXCEPT FLOOR OUTLETS. (5-1-20)

20.) ADDED CO2 DETECTORS PER LOCATE CODE. (5-1-20)

21.) CHANGED CEILING FANS TO OPTIONAL AND CHANGE THE LIGHTS TO PRE-WIRE. (5-1-20)

22.) ADDED CRICKETS TO FRONT ELEVATIONS. (5-1-20)

23.) UPDATED THE ELEVATION COACH LIGHTS TO MATCH THE ELECTRICAL PLANS. (5-1-20)

24.) CREATED ADDITIONAL SHEETS FOR FIRST FLOOR AND SECOND FLOOR OPTIONS (A4.1, A5.1, A6.1, A7.1, E-3, AND E-4) AND REMOVED

OPTIONS FROM BASE SHEETS, (5-1-20)

25.) ADDED DIMENSION FOR WATER TABLE TO FINISH FLOOR ON ELEVATION. (5-1-20)

26.) ADDED INSULATION DETAIL TO FIRST AND SECOND FLOOR SHEETS. (5-1-20)

27.) ADDED OPTIONAL (3) RECESS LIGHTING AND SWITCHES IN FAMILY ROOM. (5-1-20)

28.) ADDED SHEET 7.0 FOR FLOOR PLAN EXTERIOR SURFACES LAYOUTS. (5-1-20)

28.) CREATED OWNER'S BATH 2 AND OWNER'S BATH 3. (5-1-20)

28.) ADDED SHOWER DETAIL FOR OPTIONAL OWNER'S BATH 3. (5-1-20)

29.) UPDATED CUTSHEETS. (5-1-20)

30.) CHANGED OWNER'S BATH #3 WINDOW FROM 2-0 2-0 WINDOW TO 2-0 4-0 TEMP. (5-1-20)

31.) ADDED PATIO W/ EXTENDED PATIO OPTION. (5-1-20)

32.) ADDED OPTIONAL BASEMENT PLAN. (5-1-20)

33.) ADDED CHANGES TO OPTIONS WHEN BASEMENT OPTION SELECTED. (5-1-20)

34.) REVISED SHUTTERS ON ELEVATIONS B TO BE B&B (5-1-20)

35.) REMOVED HARDWARE FROM SHUTTERS ON ELEVATION C (5-1-20)

36.) REMOVED LIGHT OVER KITCHEN SINK (7-8-20)

37.) REMOVED NOTE "KEYLESS" FROM GARAGE CHANGED TO STANDARD CEILING MOUNTED LIGHT (7-8-20)

38.) CHANGED STANDARD LIGHT IN KITCHEN FROM 2-BULB FLUORESCENT TO 3 BULB CEILING MOUNT (7-8-20)

39.) CHANGED SWING OF SERVICE DOOR IN GARAGE TO OUT SWING (SEE SHEET A6.1) (7-8-20)

40.) REMOVED LIGHT IN SECONDARY BATH OVER TUB/SHOWER COMBO (7-8-20)


41.) REMOVED "RECESSED ENTERTAINMENT BOX" OVER FIREPLACE (7-8-20)

COVER SHEET







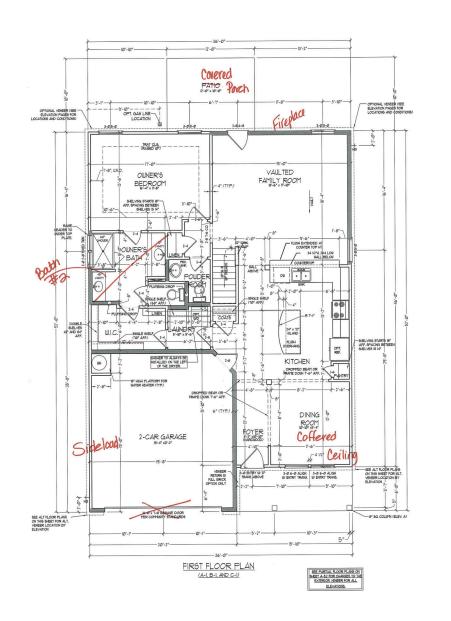

SQUASE FOOTASE

IN IR DOOR

IN IS DOOR

AND FOOTASE

IN IS DOOR

I

SGMARE FOOTAGE (W P.B.L. BRICK)

IN FLOOR

JOHN SON 1994 SO FT.

JOHN SON 1994 SON

MOTE, ALL EXTERIOR WALLS AND ATTIC WALLS ARE TO BE 2 x 4 o 16" OC. (WHO). ALL INTERIOR LOAD BEARNS WALLS ARE TO BE 2 x 4 o 16" OC. (WHO) AND NON-LOAD BEARNS INTERIOR WALLS ARE TO BE 2 x 4 o 24" OC. (WHO).

2x6 WALL

• SHADED WALLS ARE TO BE 2 x 6 • 16*
OC. (LOAD BEARING) OR 2 x 6 • 24* OC.
(NON-LOAD BEARING) RESARDLESS OF EXTEROR BUL! CONDITION

J.S.THOMPSON ENGINEERING, INC 606 WADE AVE, SUITE 104 RALEIGH, NC 27605 PHONE: (919) 788-9919 EAX: (919) 788-9921 N.C. LICENSE NO. C1733




H&H HOMES, INC. JORDAN


DATE: MARCH 15, 2019
REV.: MAY 01, 2020
SCALE: 1/4"~1'-0"


DRAWN BY: ENGINEERED BY: REVIEWED BY:

FIRST FLOOR

PLAN
A-6

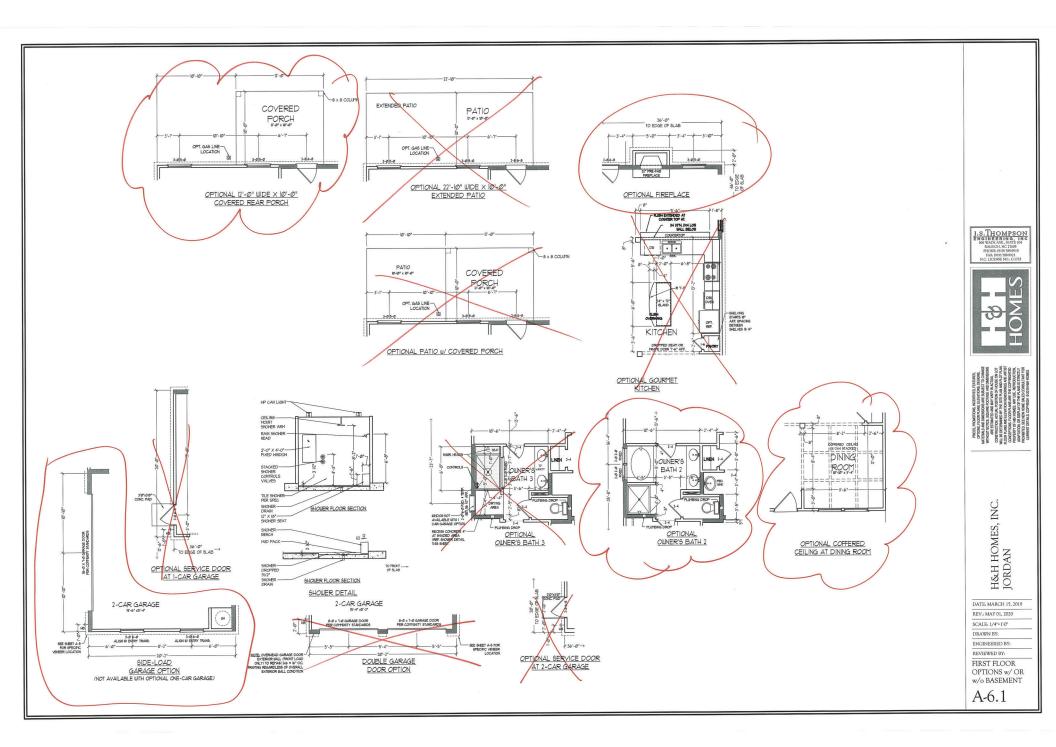

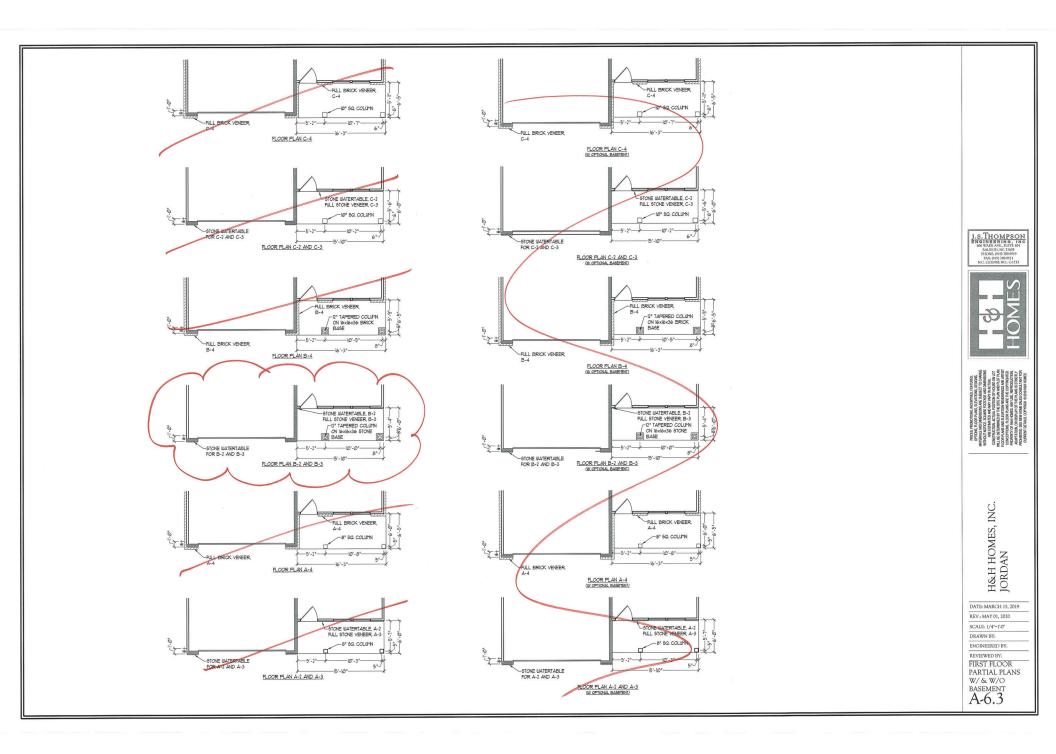

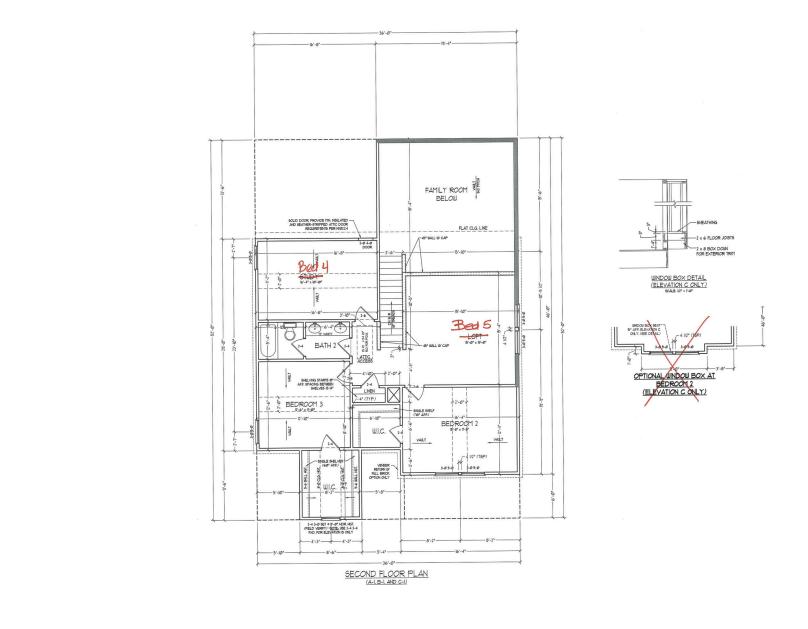

ACCE, ALL DOTRING ROULS AND ATTO BULLS ARE TO 3.4 4 8 W CO (MO.) ALL INTERCOLOD BEARING ARE TO BE? 3.4 4 % TO C. (MO.) ARD INVOLUDE DEAR MITEROR BULLS ARE TO BE 2.4 4 % 2.4 OC. (MO.) 206 BULLS ARE TO BE 3.4 6 W CO. C. (LOAD BEARING ARE 3.4 6 4 8 W CO. (MOH-LOAD BEARING ARE 3.4 6 4 8 W CO.) ENTRY CONTINUE OF 3.4 6 4 8 W CO.)

PROVIDE MINIMUM INSULATION
 IN CEILINGS AND WALLS
 PER SECTION N 1102.1

SEE PARTIAL FLOOR PLAYS ON SHEET A-62 FOR CHANGES TO THE EXTERIOR VENER FOR ALL ELEVATIONS. J.S.THOMPSON ENGINEERING, INC 606 WADE AVE, SUITE 104 RALECOR, NC. 17605 PHONE: 919 789-9919 FAX: 0191 789-9921 N.C. LICENSE NO.: C1733



THE WEST, PROMINES, THATES, TH

H&H HOMES, INC. JORDAN

DATE: MARCH 15, 2019

REV.: MAY 01, 2020


SCALE: 1/4*=1'-0*

DRAWN BY:

ENGINEERED BY: REVIEWED BY:

SECOND FLOOR

PLAN
A-7

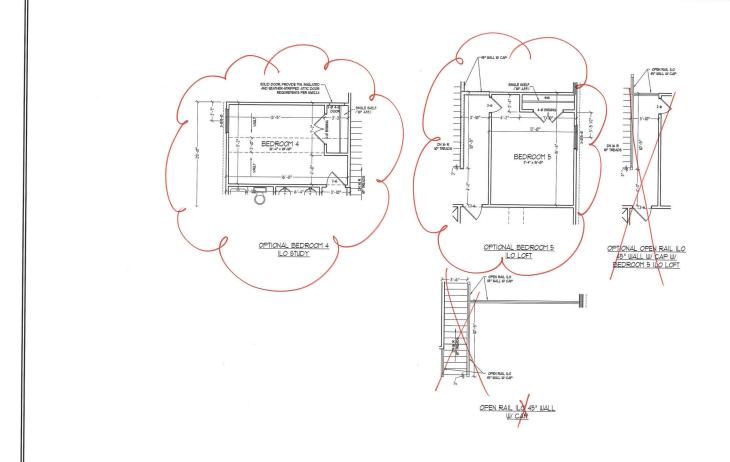

J.S.THOMPSON ENGINEERING, INC 606 WADE AVE, SUITE 104 RALEICH, NC 27605 PHONE: (919) 789-9919 FAX: (919) 789-9921 NC. LICENSE NO. CLIZIA



H&H HOMES, INC. JORDAN

DATE: MARCH 15, 2019

REV.: MAY 01, 2020


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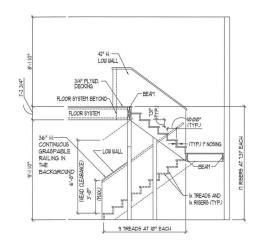
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ENGINEERED BY: REVIEWED BY:

SECOND FLOOR OPTIONS

A-7.1




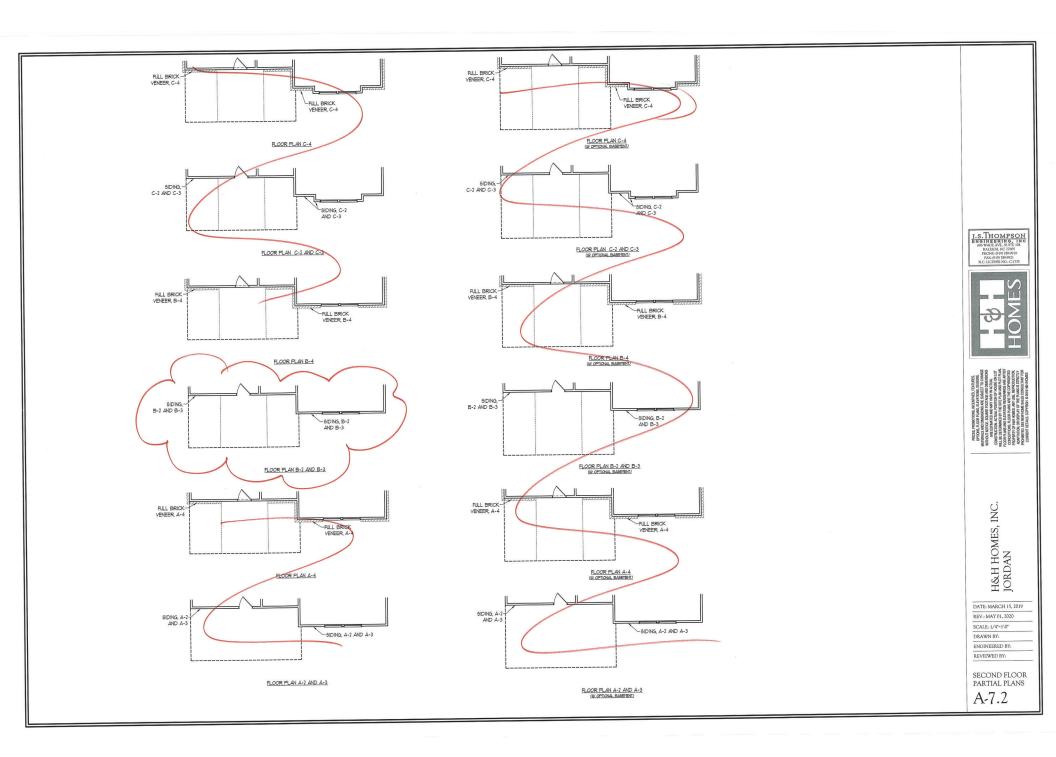


TYPICAL STAIR DETAIL (NTS)

CONTINUOUS GRASPABLE HANDRAIL MUST MEET TYPE ONE OR TYPE TUD ORTE

* * STAIR NOTES:

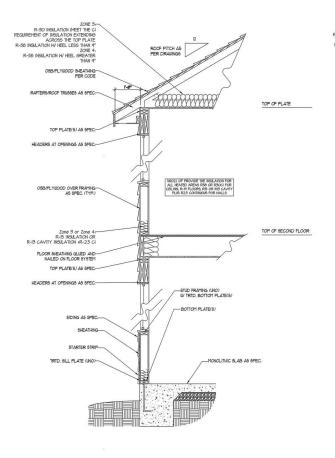

WALL SECTION W/ SLAB W/ STD. SIDING SHOWN (NTS)

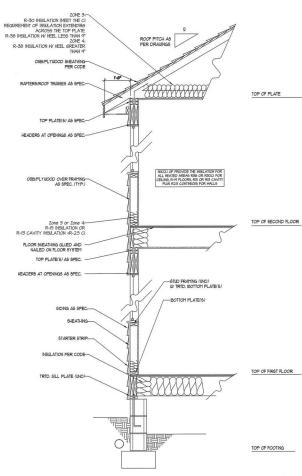

WALL SECTION W/ CRAWL SPACE W/ 6TD. SIDING SHOWN (NT6)

J.S.THOMPSON ENGINEERING, INC 606 WADE AVE, SUITE 104 RALEICH, NC 274055 PHONE, 0197 789-9919 FAX, 0197 789-99211 N.C. LICENSE NO. C-1733





H&H HOMES, INC. JORDAN


DATE: MARCH 15, 2019
REV.: MAY 01, 2020
SCALE: 1/4*=1'-0*

DRAWN BY: ENGINEERED BY:

WALL SECTIONS AND STAIR DETAIL

AD-1



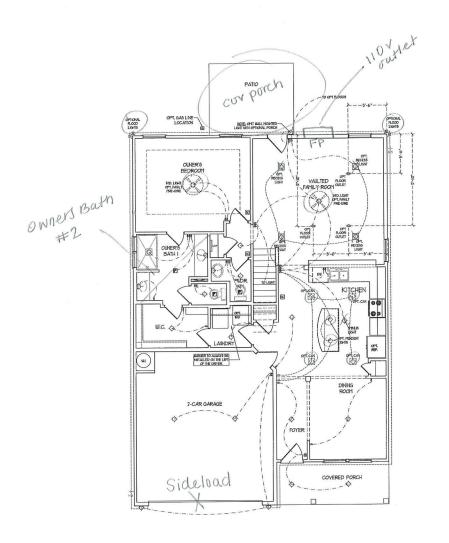

FIRST FLOOR PLAN (A-1, B-1, AND C-1)

ELECTRICAL LAYOUT NOTES: U BLOCK AND URE FOR ALL CELNG FANS PER FLAN 2) VANTY LIGHTS TO BE SET 5.) ADDITIONAL EXTERIOR CUILLES REQUIRED BY CODE TO BE LOCATED BY ELECTRICIAN A) PLACE BUTCHES S' (HIN) FROM ROUGH OPENINGS.

ELECTRICAL LEGEND

**	TO YOUTLET	
☆	WALL HOURT LIGHT	
	CELING HOURT LIGHT	
•	PENDANT LIGHT	
Ŕ	RECESSED CAN LIGHT	
Ø	MNI CAN LIGHT	
©	EYEBALL LIGHT	
=	RUDRESCENT LIGHT	
	1 LAMP, 4" FLUORESCENT LIGHT	
જ	PLOOD LIGHT	
ė	SUTCH	
Ł	3-DAY BUTCH	
ł	4-WAY BUTCH	
8	DITTER SUITCH	
α-	CONDUIT FOR COMPONENT URNS 6/FEAVER	
la*		
D-	DOORBELL CHINE	
80	NO Y SHOKE DETECTOR	
₩	CO DETECTOR	
DR.	EXHAUST FAN	
LYP	LOU VOLTAGE PAVEL	
X	CELING FAN	
(8)	CEILING FAN ID LIGHT	



J.S.THOMPSON ENGINEERING, INC 608 WAPE AVE. SUTTLE FOR PALESCEL NO. TWOS PHONE-6470 1880-019 FAX-6479 1880-019 NO. LEDNIS NO. CLIPS




H&H HOMES, INC. JORDAN


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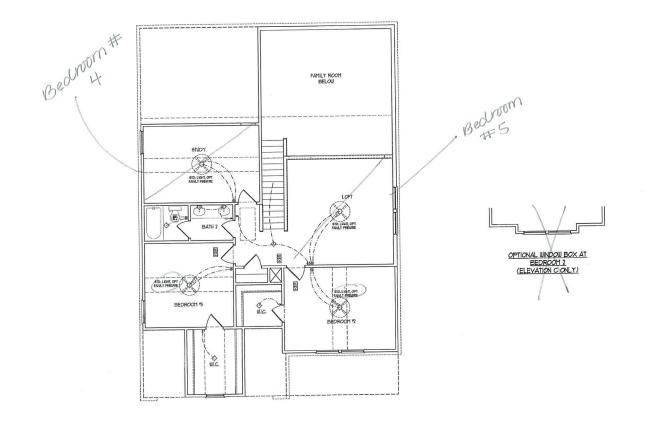
DRAWN BY: ENGINEERED BY: REVIEWED BY:

FIRST FLOOR ELECTRICAL PLAN

E-1



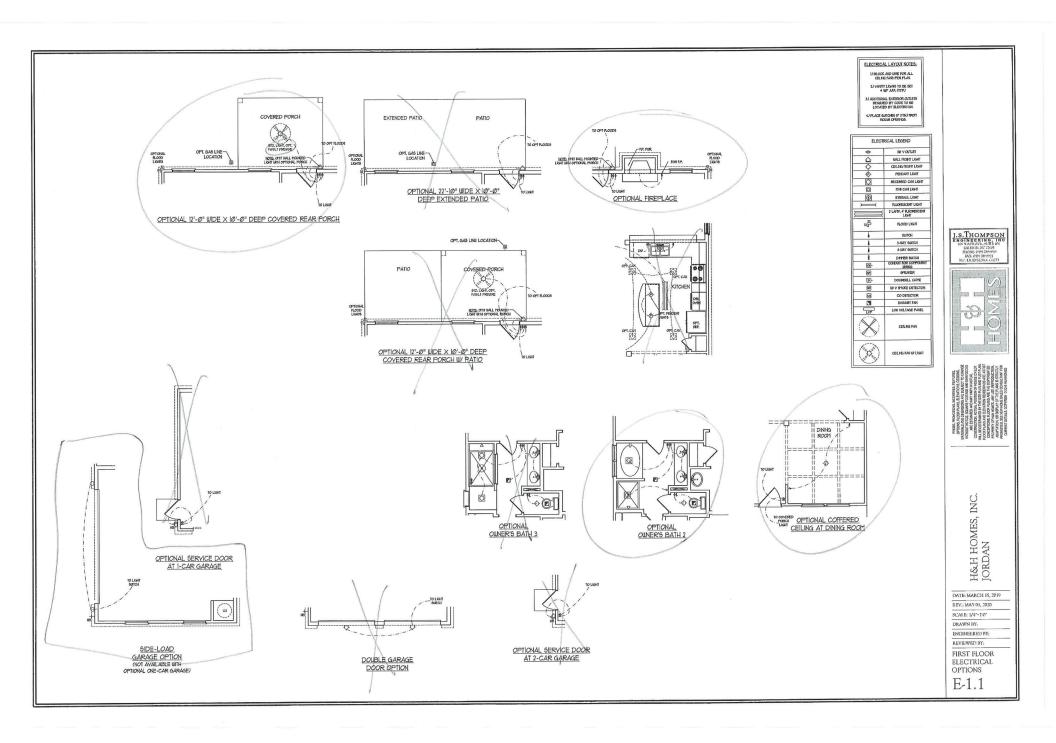

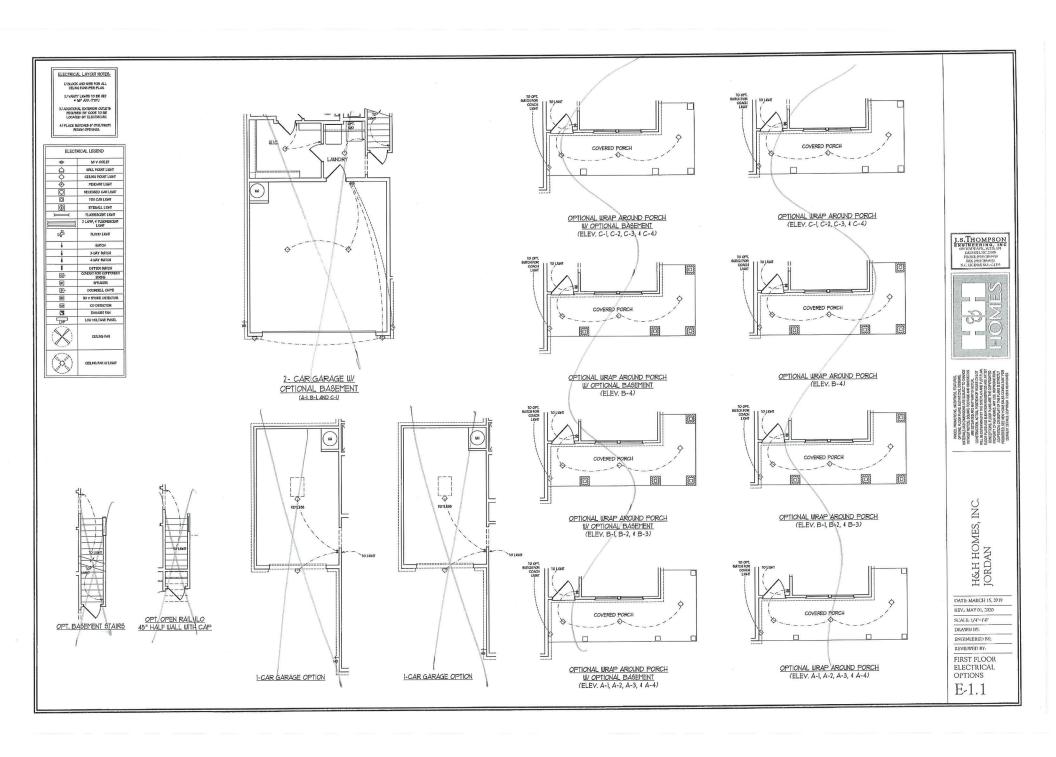

SECOND FLOOR PLAN (A-1, B-1, AND C-1)

ELECTRICAL LAYOUT NOTES: U BLOCK AND WIFE FOR ALL CELNG FAND FER PLAN 2) YANTY LISHTS TO BE SET # 90' AFF. (TYP)

3) ADDITIONAL EXTERIOR CUTLE REQUIRED BY CODE TO BE LOCATED BY ELECTRICIAN A) PLACE SUITCHES S" IT'NU FROM ROUSH OPENNSS.

ELECTRICAL LEGEND		
*	TO Y CUTLET	
☆	WALL HOURT LIGHT	
4	CEILING HOUNT LIGHT	
•	PENDANT LIGHT	
i i	RECESSED CAN LIGHT	
Ø	HINI CAN LIGHT	
(A)	EXEMPT FIRST	
>	FLUORESCIENT LIGHT	
	2 LAMP, 4" PLUORESCENT LIGHT	
路	FLOOD LIGHT	
į.	BUTCH	
à	3-NAY BUTCH	
ł	4-BAY BUTCH	
8	DIMER SUICH	
(a)-	CONDUIT FOR CONFORENT URBIS	
6	SPEAKER	
D-	DOORBHILL CHIME	
60	No v sycke petector	
60	CO DETECTOR	
CSI	EXMANDST FAN	
LMP	LOW YOUTAGE PAVEL	
8	CELNG FAN	
	CELLING FAN UP LIGHT	



H&H HOMES, INC. JORDAN


DATE: MARCH 15, 2019 REV.: MAY 01, 2020

SCALE: 1/4"=1'0" DRAWN BY: ENGINEERED BY:

REVIEWED BY:

SECOND FLOOR ELECTRICAL PLAN

E-2

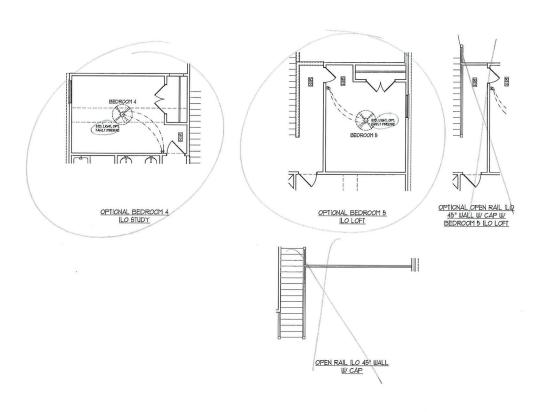

ELECTRICAL LAYOUT NOTES:

URLOCK AND USE FOR ALL
CEANS FASK FASK FASK
2) VARTY LIGHTS TO BE RET
2 SAF AFK THTP)

3) ADDITIONAL DETEROR OF, LETE
REGISTED BY CODE TO BE
LOCALIDE BY BLOCKED OF BLOCKED
4) FLACE SATIONED AND PROPER
AND COPENSA.

ELECT	RICAL LEGEND	
*	NO Y CUTLET	
☆	WALL MOUNT LIGHT	
0	CELING HOUNT LIGHT	
•	PENDANT LIGHT	
Ø	RECESSED CAN LIGHT	
E3	HNI CAN LIGHT	
(0)	EYEBALL LIGHT	
>===<	PLUCRESCENT LIGHT	
	2 LAMP, 4" PLUORESCENT LIGHT	
安	PLOOD LIGHT	
b	SUITCH	
ł	3-DAY SUITCH	
B	4-MAY GUTTCH	
8	DIMER SUITCH	
@-	CONDUIT FOR COMPONENT	
(6°)	6PEACER	
D -	DOORBELL CHINE	
80	NO V 64CKE DETECTOR	
₩	CO DETECTOR	
(3)	EXHAUST FAN	
LVP	LOU YOUTAGE PAYEL	
8	CELLING FAN	
	CEILING FAN UV LYSHT	

J.S.THOMPSON ENGINEERING, INC (WWADSAVE, STILE IN RALEIGH, NC 2700 PRANCE (PM 360401) FAX WHY 360401 NC HIGNES NO. C1733





H&H HOMES, INC. JORDAN

DATE MARCH 15, 2019

RBV: MAY 01, 2020

SCALE: LVF-1'0'

DRAWN BY:
ENGINEERED BY:
RBVIEWED BY:
SECOND FLOOR
ELECTRICAL
OPTIONS

E-2.1

DOUBLE GARAGE DOOR OPTION

BRACED WALL DESIGN NOTES:

- REACED WALL DEBMON NOTES.

 PRACED WALL DEBMON PER SECTION SECTION OF THE NCRC 2008 EDITION.

 SOURCE REPRESE TO CONTINUOUS SECTIONS. SECTION SECTION SECTION SECTION.

 SECTION SECTION

NOTE:

- PER SECTION REGILIAGE OF THE 10th NORC, THE AMOUNT OF BRACKINS REQUIRED ON THE MULK OUT BASEFORT MULLS BUCKEDS THE AMOUNT OF BRACKING ON THE MULL ABOVE MULTIFIED BY A PACITOR OF MIS. SEATH ALL DETERMINE MULLS BITH THE "OBS SEATHING ATTACKED WITH DETERMINE ATT O'CL, ALONG PAWEL, EDGES AND D' OLC, N THE FIELD.

STRUCTURAL NOTES:

- ALL FRAMING LIMBER TO BE 75 SF (MAD).

 ALL LOUD BEARMS READERS TO BE (3) 7 x 6 (MA).

 ALL LOUD BEARMS READERS TO BE (3) 7 x 6 (MA).

 BEARMS READERS TO BE (3) 7 x 6 (MA).

 BEARMS READERS TO BE (3) 8 (MA).

 BEARMS READERS TO BE (4) 8 (MA).

 BEARMS READERS TO BEARMS READERS TO BEARMS READERS TO BEARMS READERS TO BEARMS READERS READERS
- AS GRADE PERMITS. ALL LOAD BEARING INTERIOR WALLS TO BE 2×4 \circ 12° O.C. OR

- AS GRADE PERMISS.

 AS GRADE PERMISS. INTERIOR IMPLÉS TO BE 2 x 4 x 01° O.C. OR

 ALL LOUD BERNISS INTERIOR IMPLÉS TO BE 3 x 4 x 01° O.C. OR

 ALL LOUD BERNISS INTERIOR IMPLÉS TO BE SHEATHER BITH

 IN CASE SHATHER WITH LOWING ELECTE AND SOCIETY OF THE PERLIP

 IN CASE AND SOCIETY OF THE SHAPE AND SOCIETY OF THE PERLIP

 ANNELS TO DOLINEL FOR PLATES AND SOCIETY OF THE PERLIP

 (2) ROUS OF BIT MALS STACKERED AT 3° O.C. PARELS SHALL EXTEND

 (2) RESTOR CONSISTENCY NOTHS AND SALL OFFICER ANGENES

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 AND SOCIETY OF THE SHALL BE ANCIONED TO BE NOT ALL DESTRUCTION

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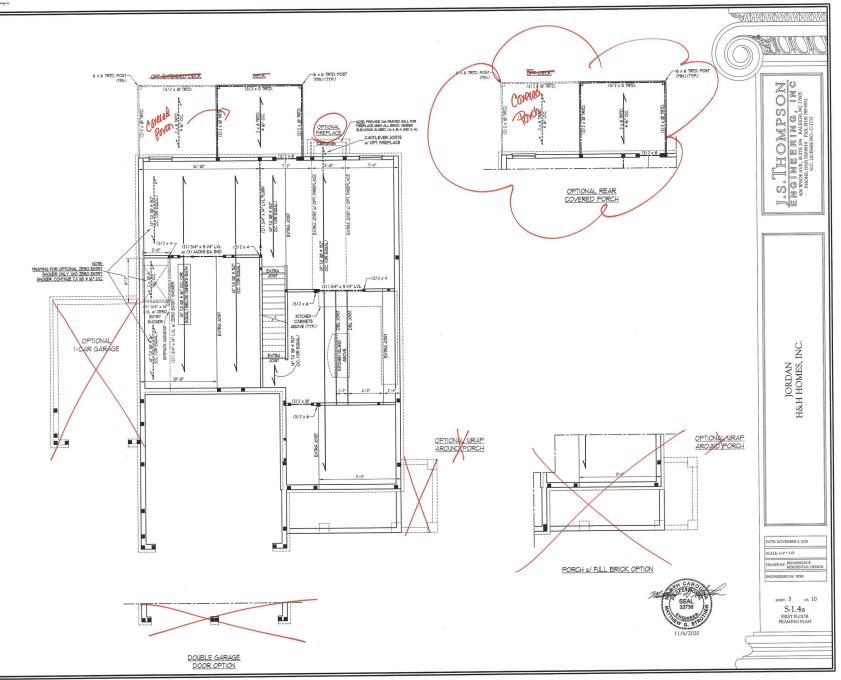
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 (CRE EX TORON).

	CHEDULE FOR AL STONE SUPPORT	
LENGTH (FT.)	SIZE OF LINTEL	
UP TO 4 FT.	L 3 1/2 x 3 1/2 x 1/4 L 5 x 3 1/2 x 5/16 LLV	
4-8		
8 AND GREATER	L 6 x 4 x 5/16 LLV	
BRICK SUPPORT NO	TES:	
ARCH DUISS, FC OPENINGS 2, 1(LLV) + LONG I, 1, LENGTH + CLE ⁴ 4. EHRED ALL AN 5DE NITO VAN 5TAGERER 6, FOR ALL BRICK 1/2 x 15TLD6 ur (4) 12 A 6' x 4' x 12 A 6' x 4' x 12 A 6' x 4' x 12 BRICK SUPPOR 1, PRECAST REM 1, TERCAST SHAM 1, T		



DOUBLE GARAGE DOOR OPTION

*NOTE: ALL EXTERIOR WALLS AND ATTIC WALLS ARE TO BE 2 x 6 @ 16" O.C. (UNO). 2 x 4 @ 16" O.C. EXTERIOR WALLS MAY BE CONSTRUCTED IN LIEU OF 2 x 6 WALLS (UNO). ALL INTERIOR LOAD BEARING WALLS ARE TO BE 2 x 4 @ 16" O.C. (UNO) AND NON-LOAD BEARING INTERIOR WALLS ARE TO BE 2 x 4 @ 24" O.C. (UNO).

	CHEDULE FOR AL STONE SUPPORT
LENGTH (FT.)	SIZE OF LINTEL
UP TO 4 FT.	L 3 1/2 x 3 1/2 x 1/4
4-8	L 5 x 3 l/2 x 5/l6 LLv
8 AND GREATER	L 6 x 4 x 5/16 LLV

- LINTEL SCHEDULE APPLIES TO ALL OPENINGS IN BRICK VENEER (UNO), SEE ARCH DUGS, FOR SIZE AND LOCATION OF

- ARCH DUSA FOR NIE AND LOCATION OF OPENINSS.
 (LLV) LOYA LES YERICAL INDIGHT + CERE YERICA

STRUCTURAL NOTES:

- STRUCTURAL NOTES.

 ALL RAPING LIPERS TO BE SITP 9 (NO.) ALL
 TREATED LIPERS TO BE SITP 9 (NO.)

 ALL DOUBLESS TO BE SITP 9 (NO.)

 FOR HOH BIND 2008 ALL DIFFEROR BILL SO TO BE

 BEATED BITH 100 ORD SITP 9 (NO.)

 FOR HOH BIND 2008 SECREME ALL DEFEROR BILL

 BEATED SITP 9 (NO.)

 FOR HOH BIND 2008 SECREME ALL DEFEROR BILL

 BEATED SITP 9 (NO.)

 FOR HOH BIND 2008 SECREME ALL DEFEROR BILL

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 ALL DEFEROR BIND SITP 9 (NO.)

 FOR HOH BIND 2008 SECREME BILL PLATES

 FOR HOM SITP 9 (NO.)

 FOR HOH BIND 2008 SECREME BILL PLATES

 FOR HOM SITP 9 (NO.)

 FOR HOM SITP 9 (NO.)

"TSP" INDICATES TRIPLE STUD POCKET BETWEEN WINDOW UNITS.

TABLE R6/02.75 MINIMUM NUMBER OF FULL HEIGHT STUDS


AT EACH END	OF HEADERS IN E	XTERIOR WALLS	
HEADER SPAN (FEET)	MAXIMUM STUD SPACING (INCHES) (PER TABLE R6/023/5)		
	16	24	
UP TO 31	1	1	
4'	2	1	
8"	3	2	
12"	5	3	
161	4	4	


BRACED WALL DESIGN NOTES:

- BRACED WALL DESIGN PER SECTION R6/02/0 OF THE NORC

NOTE:

- L PER SECTION R802/032 OF THE 208 NCRC, THE AYONT OF BRACNS ON THE SECOND FLOOR EXCEEDS THE AYONT REQUIRED FOR THE RRST FLOOR AND NO BRACED AND ATTS IS REQUIRED. SHEATH ALL DETRICK WALLS WITH YIM, OSB SHEATHING ATTACHED WITH BOT WALLS AT O'CL. ALCHIS PIAREL EDGES AND 0°C. OK. THE RELD.

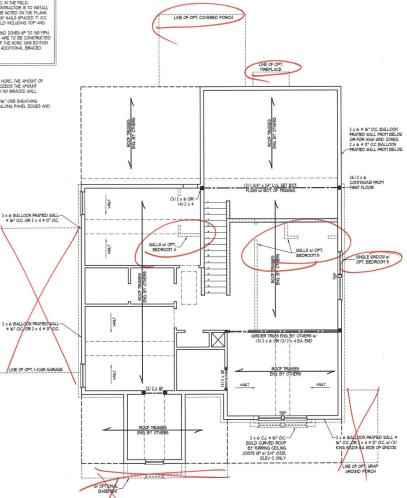

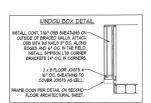

J.S. THOMPSON
ENGINEERING, INC
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JORDAN H&H HOMES, I

DATE MOMENTHER 5 2020 DRAWN BY: RENAISSANCE RESIDENTIAL DESIGN

> SHEET: 8 OF: 10 S-3 CEILING FRAMING PLAN

ENGINEERED BY: WFB




-2 x 6 RAFTERS e 16" O.C. ROOF TRUSSES EXTEND w/ OPT. — FIREPLACE TRU65 SUPPORT TRU66 SUPPORT GIRDER TRUSA ENG. BY OTHERS I-CAR GARAGE OPTION

ELEVATION A AND B

w/ OPTIONAL_/ BASEMENT

OPTIONAL WRAP AROUND PORCH

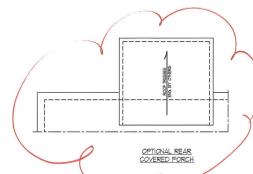

BRICK SUPPORT NOTE:

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STRUCTURAL NOTES:



SHEET: 9 OF 10 S-4a ROOF FRAMING PLAN





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SLAB AT GARAGE DOOR DETAIL

STEMWALL DETAILS




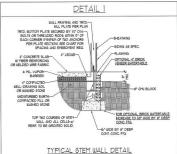

OPTIONAL STEM WALL DETAIL

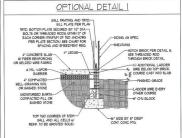
DETAIL 2 —FI ASHING 6 MIL VAPOR-BARRER % ¥ 4" COMPACTED-BELL-DRANING SOIL OR BASHED STONE -10" MIDE BY 8" DEEP

(W/ OPTIONAL WATERTABLE)

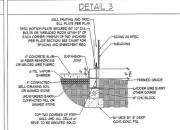

TYPICAL STEM WALL FND. W/ BRICK DETAIL

TYPICAL STEM WALL FND. DETAIL W/ CURB @ GARAGE

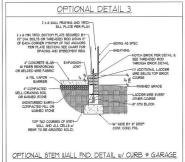

WALL FRAMING AND TRTD:— SILL PLATE PER PLAN	
IRID. BOTTOM PLATE SEQUED BY UP DIA- BOLTS OR THREADED ROD BITHIN D' OF EACH CORNER (THINRIA) OF TWO ANCHORS PER PLATE SECTION: SEE CHAIR FOR PLATE SECTION: SEE CHAIR FOR A" CONCRETE SLAD—EXPANSION— JOINT	PRICK TIES 9 1
BY FIBER REINFORCING R VELDED WIRE FABRIC 6 MIL VAPOR BARRER	
4" COMPACTED JELL-DRAINING SOIL OR BASHED STONE	LACOER URE EVERY
UNDISTURBED EARTH COMPACTED FILL OR ULISHED STONE	OTHER COURSE 12" CHU BLOOK
TOP TWO COURSES OF STEM- WALL AND ALL CELLS W' REINF, TO BE GROUTED SOUID.	-99" MIDE BY 8" DEEP CONT. CONC. FTG.
TYPICAL STEM WALL	FND. DETAIL W/ BRICK
AND CUR	B @ GARAGE

DETAIL 4

DETAIL 8 INSIDE EDGE OF MASONRY STEMWALL 1/2" ANCHOR ROD - SPACED PER TABLE BRICK MASONRY -000 000 000 OUTSIDE EDGE OF BRICK AND STICK FRAMED WALL ABOVE -NOTCH BRICK # THREADED ROD AND GROUT SOLID-THREADED ROD THROUGH BRICK MASONRY

MASONRY STEMWALL SPECIFICATIONS MASONRY WALL TYPE 4" BRICK AND 4" 4" BRICK AND 8" 12" CMU 8" CMJ 2 AND BELOW UNGROUTED GROUT SOLID UNGROUTED GROUT SOLID GROUT SOLID GROUT SOLID #/ 14 NOT APPLICABLE REBAR # 64" O.C. GROUT SOLID w/ *4
REBAR * 24" OC. REBAR * 64" OC. GROUT SOLID W *4 REBAR # 24" O.C. NOT APPLICABLE 6 1 AND GREATER ENGINEERED DESIGN BASED ON SITE CONDITIONS

STRUCTURAL NOTES:

- L WALL HEGHT PEASIRED PROVIDED FOR FOOTING TO TOP OF THE WALL.

 2. THE PLATTER BYTHES TOOLINGS WITH ADDRESS MER AT 16" OC. VERTICALLY.

 2. THE PLATTER BYTHES TOOLINGS WITH ADDRESS MER AT 16" OC. VERTICALLY.

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ΔN	ICHOR SPACING AN	D EMBEDMENT
WIND ZONE	120 MPH	13Ø MPH
SPACING	6'-0" O.C.	4'-0" O.C.
EMBEDMENT	171	IS" INTO MASONRY 1" INTO CONCRETE

WIND SPEED MPH ULTIMATE DESIGN FOUNDATION DETAILS

DATE: NOVEMBER 14, 2018 SCALE: NTS DRAWN BY: JST ENGINEERED BY: JES

D-1 FOUNDATION DETAILS



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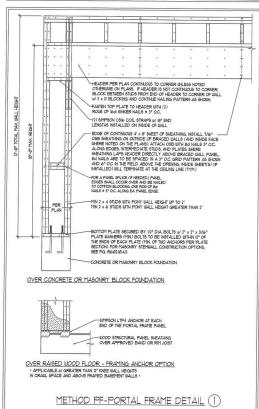
MPH - 130 120


GENERAL WALL BRACING NOTES:


- WALL BRACING DEBGNED IN ACCORDANCE WITH CHAPTER 6 OF THE 1008 NC RESIDENTIAL BUILDING CODE (INCRC) TABLES AND FRAKES REFERENCED ARE FROM THE 2008 NCRC. FOR ADDITIONAL INFORMATION AS NEEDED.
 SEE SING-ERF FOR REPORTED WALL LOCATIONS, DIPENSIONS, INCL. DOWN THE AND LOCATIONS, BRACED WALL LOCATIONS, BRACED WALL DOWN THE AND LOCATIONS, BRACED WALL DESCRIPTIONS OF TOTALS FOR EACH ULL LIVE AND ANY SECOLAL NOTES.
- OR REQUIREMENTS.


 ALL EXTERIOR MALLS ARE TO BE SHEATHED WITH CS-USP IN ACCORDANCE WITH SECTION R6/02.10/3 UNLESS NOTED OTHERWISE.

- A CASEMENT SHALD WAS TO BE SHARINEY WITH CHART IN ACCOUNTAGES WITH SECTION REQUEST WAS EXECUTED AS ALL DETERMS AND INTERIOR WALLS TO INVALED USEN'S INSIGH TESTED OF THE MATERIAL PROPRIET OF BE FASTERED FIRST ALLE REQUISITED. THE TABLE REQUISITED AND THE TABLE REQUISITED




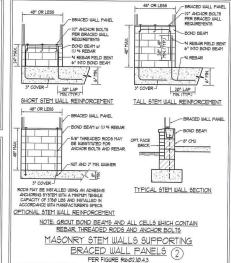


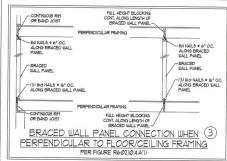


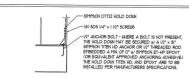



HOLD DOWN DETAIL FOR MASONRY FOUNDATION OR MONOLITHIC SLAB

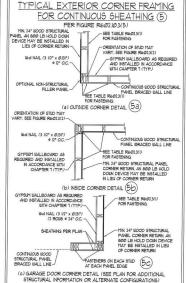

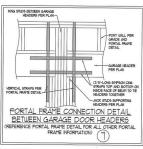

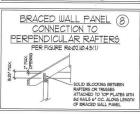

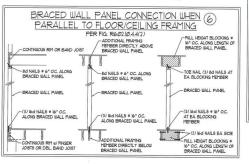

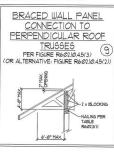

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SUITE 104 RALEIGH, NC.21
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LICENSE NO. C. C. (733) S. THC NGINE SO WAD AND FOR THONE, SUIT

> DESIGN WIND SPEED AND DETAILS MPH ULTIMATE I BRACING NOTES MPH - 130 N WALL E 20

DATE: NOVEMBER 14, 2018 CALE: 1/4" = 1:0"

ENGINEERED BY: JST

D-2 BRACED WALL NOTES AND DETAILS AND PF DETAIL

GENERAL NOTES

- ENGINEER'S SEAL APPLIES ONLY TO STRUCTURAL COMPONENTS INCLUDING ROOF RAFTERS, HIPS, VALLEYS, RIDGES, FLOORS, WALLS, BEAMS, HEADERS, COLUMNS, CANTILEVERS, OFFSET LOAD BEARING WALLS, PIERS, GIRDER SYSTEM AND FOOTING. ENSINEER'S SEAL DOES NOT CERTIFY DIMENSIONAL ACCURACY OF ARCHITECTURAL LAYOUT INCLUDING ROOF. ENGINEER'S SEAL DOES NOT APPLY TO 1-JOIST OR FLOOR/ROOF TRUSS
- 2. ALL CONSTRUCTION SHALL CONFORM TO THE LATEST REQUIREMENTS OF THE NORTH CAROLINA RESIDENTIAL CODE (NORC), 2019 EDITION, PLUS ALL LOCAL CODES AND REGULATIONS. THE STRUCTURAL BISINEER IS NOT REPROHIBITE FOR AND UILL NOT HAVE CONTROL OF CONSTRUCTION FOR THE HOLD OF THE CONTROL OF CONSTRUCTION FOR THE HOLD OF THE CONTROL OF CONSTRUCTION FOR THE CONTROL OF CONSTRUCTION FOR THE CONTROL OF CON
- 3. STRUCTURAL DESIGN BASED ON THE PROVISIONS OF THE NCRC, 2018 EDITION (R3014 R3011)

DESIGN CRITERIA	LIVE LOAD (PSF)	DEAD LOAD (PSF)	DEFLECTION (IN)
ATTIC WITH LIMITED STORAGE	20	10	L/240 (L/360 w/ BRITTLE FINISHES)
ATTIC WITHOUT STORAGE	10	10	L/360
DECKS	40	10	L/360
EXTERIOR BALCONIES	40	10	L/360
FIRE ESCAPES	40	10	L/360
HANDRAILS/GUARDRAILS	200 LB OR 50 (PLF)	10	L/360
PASSENGER VEHICLE GARAGE	50	10	L/360
ROOMS OTHER THAN SLEEPING ROOM	40	10	L/36Ø
SLEEPING ROOMS	30	10	L/360
STAIRS	40	10	1/360
UND LOAD	(BASED ON TABLE R3012)	(4) WIND ZONE AND EXPOSURE.	
GROUND SNOW LOAD: Pa	20 (PSF)		

- I-JOIST SYSTEMS DESIGNED WITH 12 PSF DEAD LOAD AND DEFLECTION (IN) OF L/480 - FLOOR TRUSS SYSTEMS DESIGNED WITH IS PSF DEAD LOAD
- 4. FOR IIS AND 120 MPH WIND ZONES, FOUNDATION ANCHORAGE IS TO COMPLY WITH SECTION R40316 OF THE NORC, 2019 EDITION. FOR 130 MPH, 140 MPH, AND 180 MPH WIND ZONES, FOUNDATION ANCHORAGE IS TO COMPLY WITH SECTION 4504 OF THE NORC, 2019 EDITION.
- 5. ENERGY EFFICIENCY COMPLIANCE AND INSULATION VALUES OF THE BUILDING TO BE IN ACCORDANCE WITH CHAPTER II OF THE NORC, 2016 EDITION.

FOOTING AND FOUNDATION NOTES

- I. FOUNDATION DESIGN BASED ON A MINIMUM ALLOWABLE BEARING CAPACITY OF 2000 PSF. CONTACT GEOTECHNICAL BYSINEER IF BEARING CAPACITY IS NOT ACHIEVED.
- 2. FOR ALL CONCRETE \$4.86 A NO PROFINS THE MERE SITHIN THE PERFORMENCE THE BULLING BYME OFF SHALL HAVE ALL VESSETATION, TOP SOL, AND POREIGN HATBOAL SEPONDED. THE HATBOAL SHALL BE FREE OF MESETATION AND PROBLEM HATBOAL THE PLAL SHALL BE CHAPPED OF SHALL BE SHALL BE SHALL BE FREE OFF SHALL BE FREE OFF SHALL BE FLACED. A DAME CLEME HAD ON GROWNED. AN THICK SHAPED CORRECT CORNING OF FLEEN GROUPDED SHAP OF GROWNED HALL BE FLACED. A DAME CORRECT HAD ONE OFF SHAPED SHAPE OFF SHAPED FROM THE SHAPED SHAPED SHAPED OFF SHAPED SHAPE
- PROPERLY DEMATER EXCAVATION PRIOR TO POURNS CONCRETE WEN BOTTON OF CONCRETE SLAB IS AT OR REQUIRING TRANSPER TABLE. F APPLICABLE, 34" I'P DEEP CORTROL, JONTS ARE TO DE SAIED WITHIN 4 TO 0 HOURS OF CONCRETE FINISHING AND WALL LOCATIONS HA BEEN MARKED, JOANST WERE RECESSARY.
- A CONCRETE SUALL CONFORM TO SECTION PARKS OF THE NORCE 2008 EDITION. CONCRETE PENEROPCING STEEL TO BE ASTMULADE OR ADDRESS. CONCERTE SHALL CORPORT IN SECTION MOST OF THE NOOK, DIE ENTINY, CONCERT EXPENDICION STEEL TO SE AMY LABS GALDE 6.0. IN CALABO, TOR POLICIO CONCERTE BUALD, CONCERTE CONCERTO RESPONSANO STEEL PELASSED FRONT THE MADE FACE OF THE MALL SHALL. NOT DE LESS THAN SAY. CONCERTE COVER FOR RESPONSANO STEEL PELASSED FRONT THE GITTISTE FACE OF THE BUALL SHALL. NOT DE LESS THAN SAY. CONCERTE COVER FOR RESPONSANO STEEL PELASSED FRONT THE CUITISTE FACE OF THE BUALL SHALL NOT DE LESS THAN 110° FOR THE SHAPE OF CHILLERS AND FOR LESS THAN 170° FOR SHAPE OF CHILD FACE.
- MASONRY UNITS TO CONFORM TO ACE 530/ASCE 5/TMS 402. MORTAR SHALL CONFORM TO ASTM C270.
- 6. THE UNSUPPORTED HEIGHT OF MASONRY PIERS SHALL NOT EXCEED FOUR TIMES THEIR LEAST DIMESION FOR UPFLIED HOLLOW CONCRETE MASONRY WITH AND TEN TIMES THEIR LEAST DIMESION FOR GOLD OR SOLD HELED PIERS, FERS MAY BE HELD SOLD WITH CONCRETE OR TYPE M OR 5 MORTAR PIERS AND WALLS SHALL BE CAPPED WITH 8" OF SOLD MASONRY.
- THE CENTER OF EACH OF THE PIERS SHALL BEAR IN THE MIDDLE THIRD OF IT'S RESPECTIVE FOOTING, EACH GIRDER SHALL BEAR IN THE MIDDLE THIRD OF THE PIERS.
- 8. ALL CONCRETE AND MASONRY FORDATION WALLS ARE TO BE CONSTRUCTED IN ACCORDANCE WITH THE PROVISIONS OF SECTION RIGHD OF THE MORE, 2008 EDITION OR IN ACCORDANCE WITH ACT 388, ACT 335, NOVEM TRIBLE A OR ACE 2500/ASCE STIMP 400. MASONRY FORDATION WALLS ARE TO BE REINFORCED PER TABLE RIGHDIN, RIGHDIN, RIGHDIN, OR RIGHDING OF THE MORE, 2008 EDITION. CONCRETE FORDATION WALLS ARE TO DE REINFORCED PER TABLE. R4041/(5) OF THE NCRC, 2016 EDITION. STEP CONCRETE FOUNDATION WALLS TO 2 x 6 FRAMED WALLS AT 16" OC. WHERE GRADE PERMITS (UNO)

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FRAMING NOTES

- [ALL FRAMING LIMBER SHALL BE 72 SPF MINIMM (Fb = 875 PS), Fv = 375 PS), Fv = 16000000 PS) (INLESS NOTED OTHERIUSE (IND), ALL TREATED LIMBER SHALL BE 72 SYP MINIMM (Fb = 975 PS), Fv = 175 PS), Fv = 16000000 PS) (INLESS NOTED OTHERIUSE (IND).
- 2 | AMNATED VENEER LIMPER (LVL.) SHALL HAVE THE FOLLOWING MINIMUM PROPERTIES. By : 260 00 PSL Ev. : 265 PSL Ev. : 1900000 PSL
- 3. STRUCTURAL STEEL SHALL CONFORM TO THE FOLLOWING ASTM SPECIFICATIONS
 - W AND WT SHAPES: CHANNELS AND ANGLES: ASTM A992 ASTM A36 PLATES AND BARS: ASTM A36
 - HOLLOW STRUCTURAL SECTIONS: ASTM A500 GRADE B ASTM A53, GRADE B. TYPE E OR S
- STEEL BEATS SHALL BE SUPPORTED AT EACH BND BITH A MINIMM BEARNIG LENGTH OF 3 1/2" AND FILL FLANGE WIDTH (IND.). PROVIDE SOLID BEARNIG PROFI BEAM SUPPORT TO FOUNDATION. BEATS SHALL BE ATTACHED AT THE BOTTOM PLANGE TO EACH SUPPORT AS FOLLOW GIVE.

(2) 1/2" DIA x 4" WEDGE ANCHORS C. MASONRY (FULLY GROUTED) (2) 1/2" DIA x 4" LONG SIMPSON TITEN HD ANCHORS

LATERAL SUPPORT IS CONSIDERED ADEQUATE PROVIDING THE JOISTS ARE TO'R NAILED TO THE 2x NAILER ON TOP OF THE STEEL BEAM, AND THE 2x NAILER IS SECURED TO THE TOP OF THE STEEL BEAM w/ (2) BOILS OF SELF TAPPING SCREUS # I/O* O.C. OR (2) ROUS OF I/O* DIAMETER BOLTS # 16" O.C. IF 1/2" BOLTS ARE USED TO FASTEN THE NAILER, THE STEEL BEAM SHALL BE FABRICATED W (2) ROUS OF 9/16" DIAMETER

- SQUARES DENOTE POINT LOADS WHICH REQUIRE SOLID BLOCKING TO GIRDER OR FOUNDATION, SHADED SQUARES DENOTE POINT LOADS FROM ABOVE WHICH REQUIRE SOLID BLOCKING TO SUPPORTING MEMBER BELOW.
- 6. ALL LOAD BEARING HEADERS TO CONFORM TO TABLE R602.7(1) AND R602.7(2) OF THE NORC, 2018 EDITION OR BE (2) 2 x 6 WITH (1) JACK AND (I) KING STUD EACH END (UNO), WHICHEVER IS GREATER ALL HEADERS TO BE SECURED TO EACH JACK STUD WITH (4) 8d NAILS. ALL BEAMS TO BE SUPPORTED WITH (2) STUDS AT EACH BEARING POINT (UNO), INSTALL KING STUDS PER SECTION R6/92/15 OF THE NORTH CAROLINA RESIDENTIAL CODE 2016 EDITION.
- 1. ALL BEAMS HEADERS OR GIRDER TRISSES PARALLEL TO HALL ARE TO BEAR BILLY ON (1) JACK OR (2) STIDS MINIMIM OR THE NUMBER OF AUCS OR STORD KITED. ALL BEIGHT MOREON FROM THE TO BE OF BEIGHT TO BEILL AND SUPPORTED BY 10'S STORD ON LESS ARE TO AUCS OR STORD KITED. ALL BEIGHT OF BEIGHT MORE TO BE OF BEIGHT AND STORD FROM THE STORD AND STORD AN
- FLITCH BEAMS SHALL BE BOLTED TOGETHER USING 1/2" DIAMETER BOLTS (ASTM AS/07) WITH WASHERS PLACED AT THREADED BND OF BOLT. BOLTS SHALL BE SPACED AT 24" CENTERS (MAXIMM), AND STAGGERED AT TOP AND BOTTOM OF BEAM (2" EDGE DISTANCE), WITH (2) BOLTS
- 9. ALL I-JOIST OR TRUSS LAYOUTS ARE TO BE IN COMPILIANCE WITH THE OVERALL DESIGN SPECIFIED ON THE PLANS. ALL DEVIATIONS ARE TO BE BROUGHT TO THE ATTENTION OF THE ENGINEER OF RECORD PRIOR TO INSTALLATION.
- Ø BRACED WALL PANELS SHALL BE CONSTRUCTED ACCORDING TO THE NORTH CAROLINA RESIDENTIAL CODE 2018 FORTION WALL BRACING. CRITERIA. THE AMOUNT, LENGTH, AND LOCATION OF BRACING SHALL COMPLY WITH ALL APPLICABLE TABLES IN SEC
- PROVIDE DOUBLE JOST WIDER ALL WALLS PARALLEL TO FLOOR JOSTS. PROVIDE SUPPORT WIDER ALL WALLS PARALLEL TO FLOOR TRUSSES OR I-JOSTS PER HAMPACTURERS SPECIFICATIONS. NSTALL BLOCKING BETWEEN JOSTS OR TRUSSES FOR POINT LOAD S
- 12. FOR ALL HEADERS SUPPORTING BRICK VENEER THAT ARE LESS THAN 8'-0" IN LENGTH, REST A 6" x 4" x 5/16" STEEL ANGLE WITH 6" MINIMUM EMBEDMENT AT SIDES FOR BRICK SUPPORT (UN.O.). FOR ALL HEADERS 8'-8" AND GREATER IN LENGTH, BOLT A 6" x 4" x 5/6" STEEL ANGLE TO HEADER WITH 1/2" LAG SCREWS AT 12" O.C. STAGGERED FOR BRICK SUPPORT, FOR ALL BRICK SUPPORT AT ROOF LINES, BOLT A 6" x 4" x 5/6" STEEL ANGLE TO (2) 2 x 1/2 BLOCKING INSTALLED by (4) 12d NAILS EA PLY BETWEEN WALL STUDS WITH (2) ROUS OF 1/2" LAG SCREWS AT 12" O.C. STAGGERED AND IN ACCORDANCE WITH SECTION R103,82J OF THE NCRC, 2018 EDITION.
- FOR STICK FRAMED ROOFS. CIRCLES DENOTE (3) 2 x 4 POSTS FOR ROOF NEMBER SUPPORT. HIP SPLICES ARE TO BE SPACED A HINNIM OF 8-0°. FASTEN YEMBERS WITH THREE ROUS OF BID MALLS AT 16° DC. FRAME DORFER MALLS ON TOP OF DOUBLE OR TRIPLE RAFTERS AS SHOWN (MOX.)
- 14. FOR TRUSSED ROOFS: FRAME DORMER WALLS ON TOP OF 2 x 4 LADDER FRAMING AT 24" O.C. BETWEEN ADJACENT ROOF TRUSSES. STICK FRAME OVER-FRAMED ROOF SECTIONS WITH 2 x 8 RIDGES, 2 x 6 RAFTERS AT 16" O.C. AND FLAT 2 x 10 VALLEYS (UNO.)
- 5. ALL 4 x 4 AND 6 x 6 POSTS TO BE INSTALLED WITH 100 LB CAPACITY UPLIFT CONNECTORS TOP AND BOTTOM (UND.) POSTS MAY BE SECURED BIANS ONE SHIPSON NO OR LITED UP IN IT CONNECTOR PASTIBLED TO THE BLAND AT THE BOTTOM AND THE BEAM AT THE TOP OF EACH POST, ONE OF SECURION OF SHIPSON COME COLL STRUMPING BITH (8) BIG HOS NALLS AT EACH BID MAY BE USED IN LIBIT OF EACH TRUST STRUMP PERSINED. FOR MAKENET OR CONCRETE FOLDISTION USE SHIPSON POST BASIS.



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DATE: NOVEMBER 14, 2018 SCALE: 1/4" = 1'0"

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50 STRUCTURAL NOTES