
THIS PLAN HAS BEEN DRAWN TO CONFORM TO THE 2018 NORTH CAROLINA RESIDENTIAL CODE


CONTRACTOR SHALL VERIFY ALL DIMENSIONS AND CONDITIONS PRIOR TO BEGGINING WORK. CONTRACTOR IS RESPONSIBLE FOR COMPLIANCE WITH ALL STATE AND LOCAL BUILDING CODES AND ORDINANCES. KADS CUSTOM HOME DESIGNS ASSUMES NO LIABILITY FOR SITE CONDITIONS, CONSTRUCTION METHODS OR ANY DEVIATION OF THESE PLANS.

ALL WINDOWS TO BE INSTALLED MUST MEET
A MAXIMUM OF .32 U VALUE OR BETTER, UNLESS
ENERGY CALCULATIONS ARE SUBMITTED WITH PLANS
PROVIDED BY BUILDER AT TIME OF PLAN REVIEW.

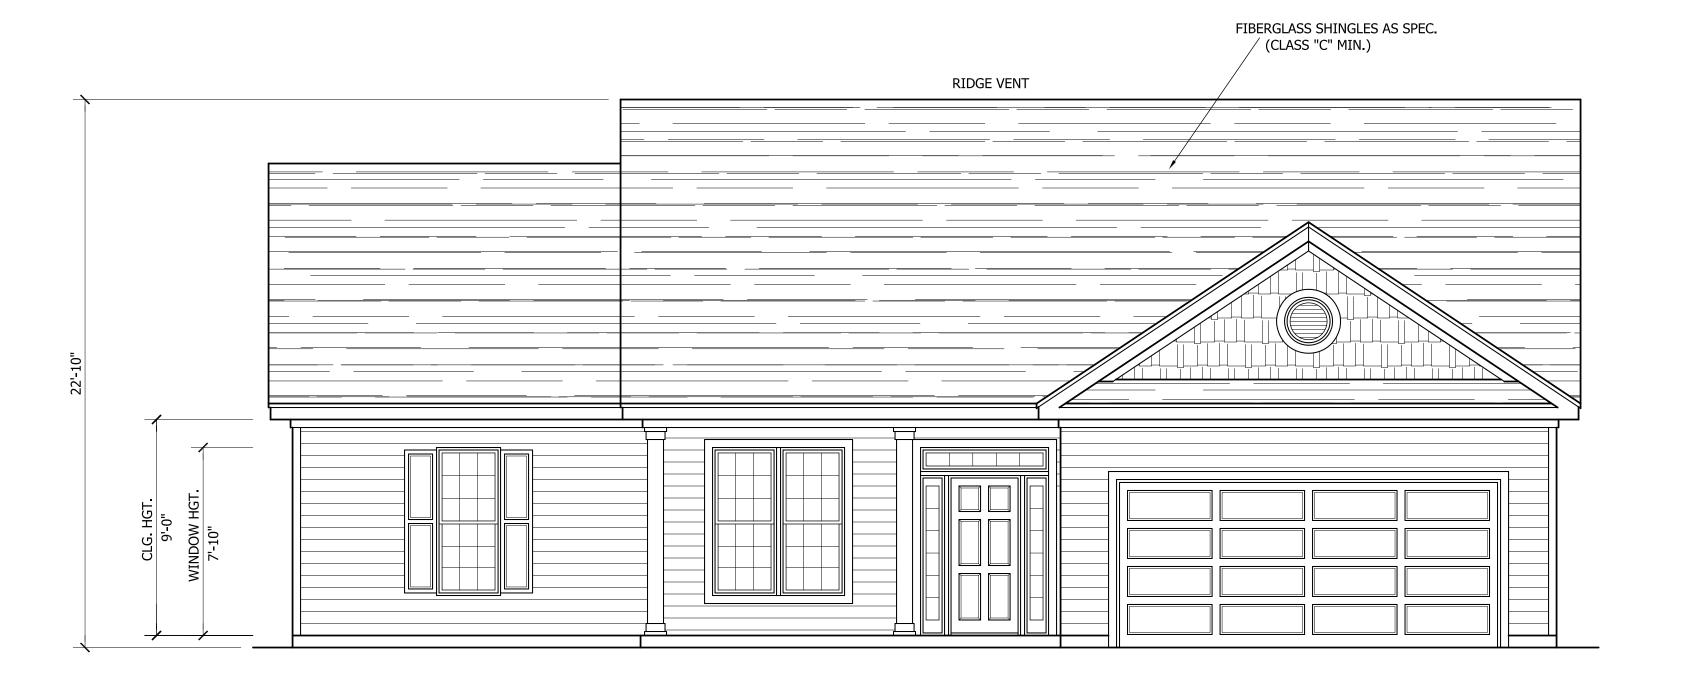


FRONT ELEVATION

SCALE: 1/4"=1'-0"

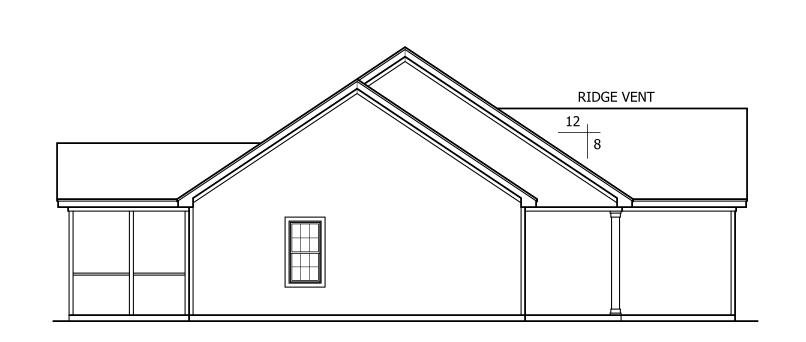




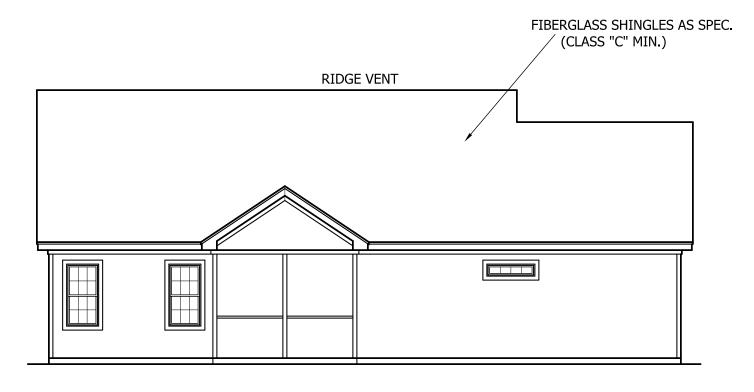

REAR ELEVATION


SCALE: 1/8"=1'-0"

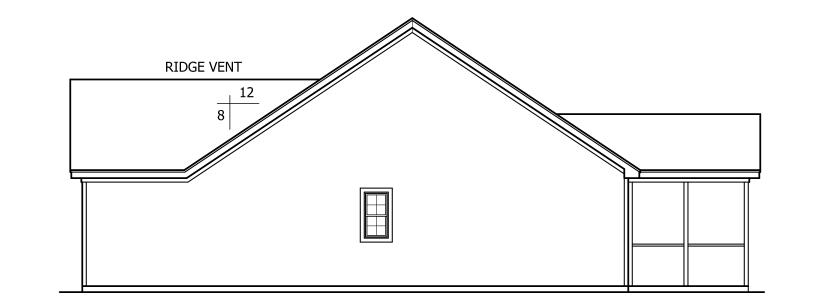

RIGHT ELEVATION

SCALE: 1/8"=1'-0"

TRIANGLE DEALS, LLC

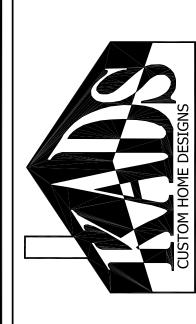

ANGIER, NC 919-369-7181

DRAWN BY:

<u>D.W.O.</u>


DATE: 6/8/21

PAGE NO

1

3

PLAN NO.

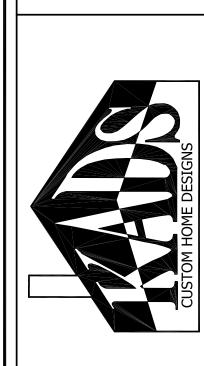

ANGIER, NC 919-369-7181

DRAWN BY:

<u>D.W.O.</u>


DATE: 6/8/21

= 139 = 413 = 120


PAGE NO

OF

PLAN NO. DK1423

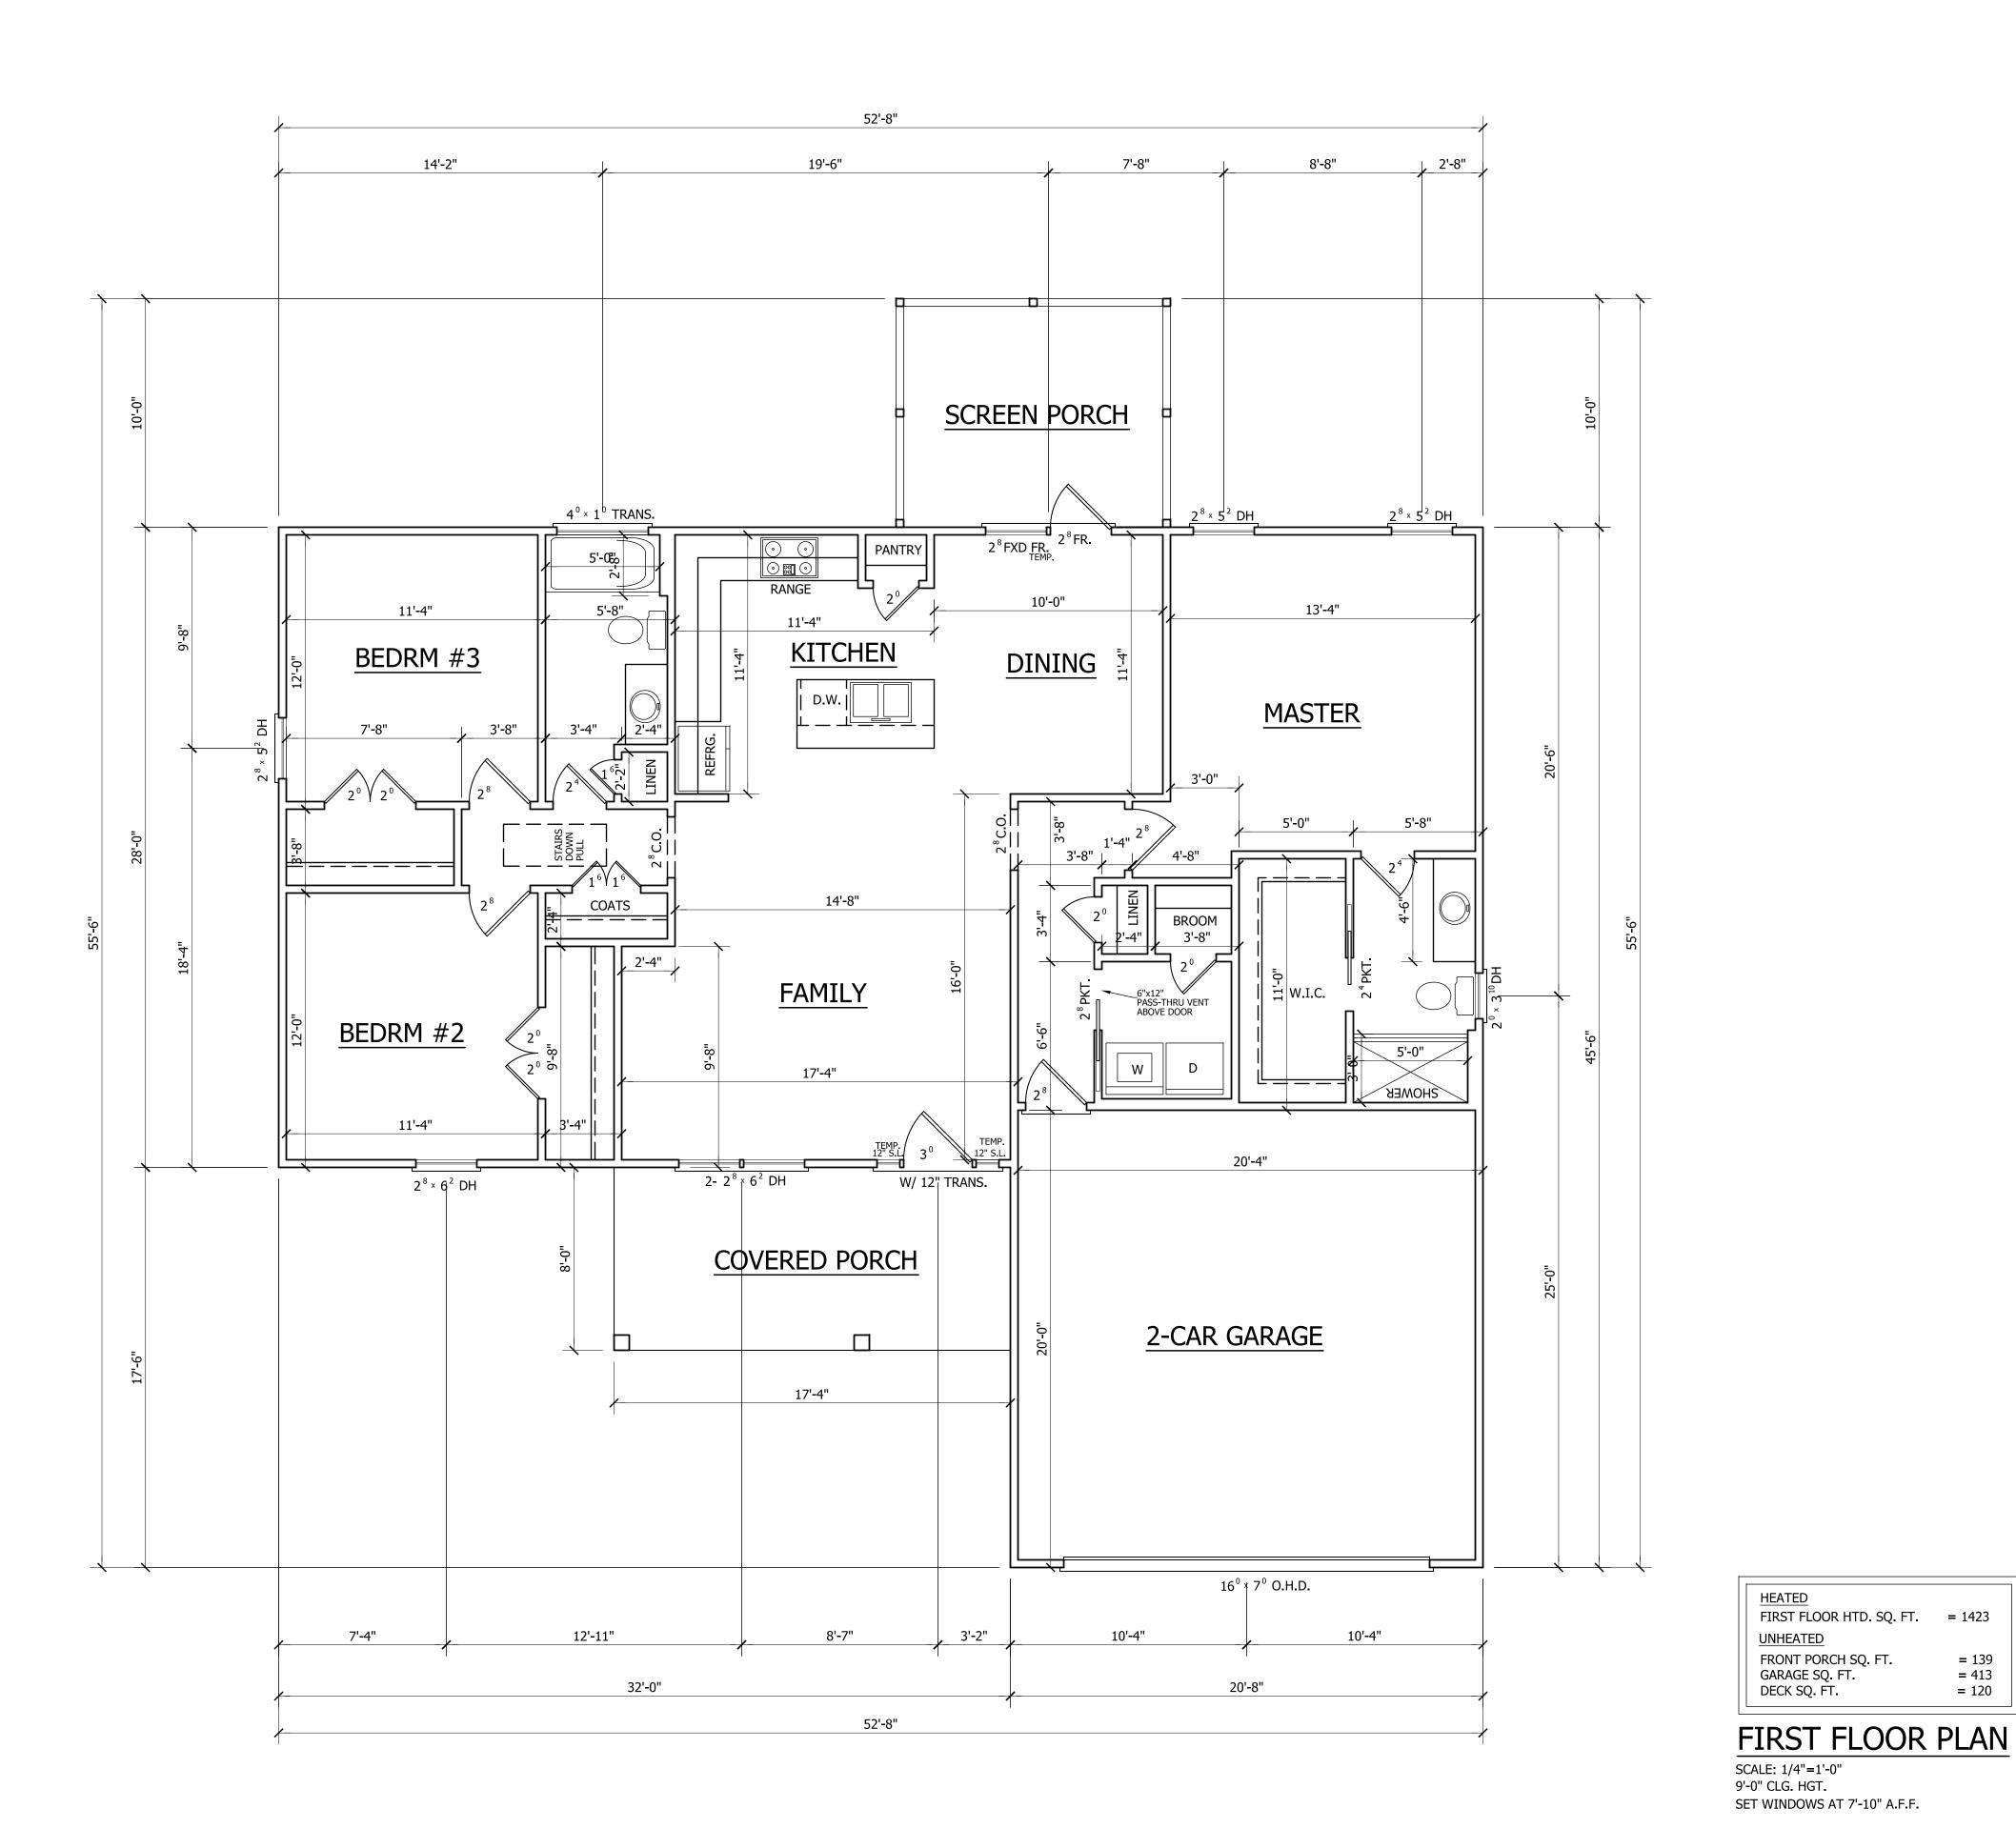



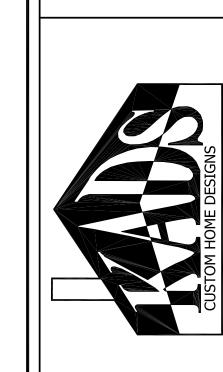

ANGIER, NC 919-369-7181

DRAWN BY:


D.W.O.


DATE: 6/8/21

PAGE NO

OF

PLAN NO. DK1423

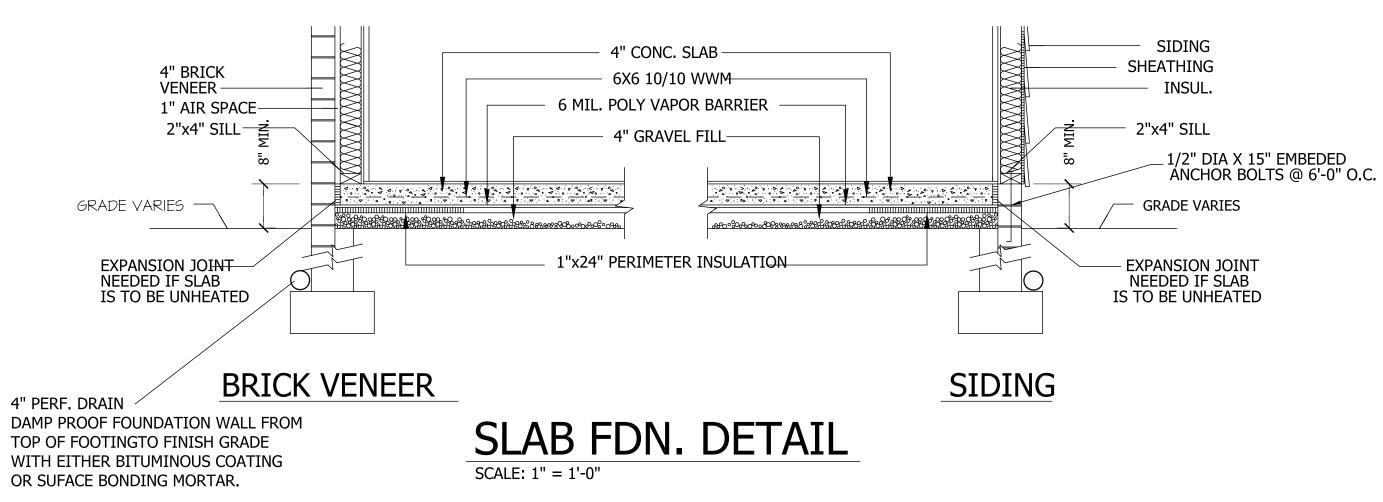

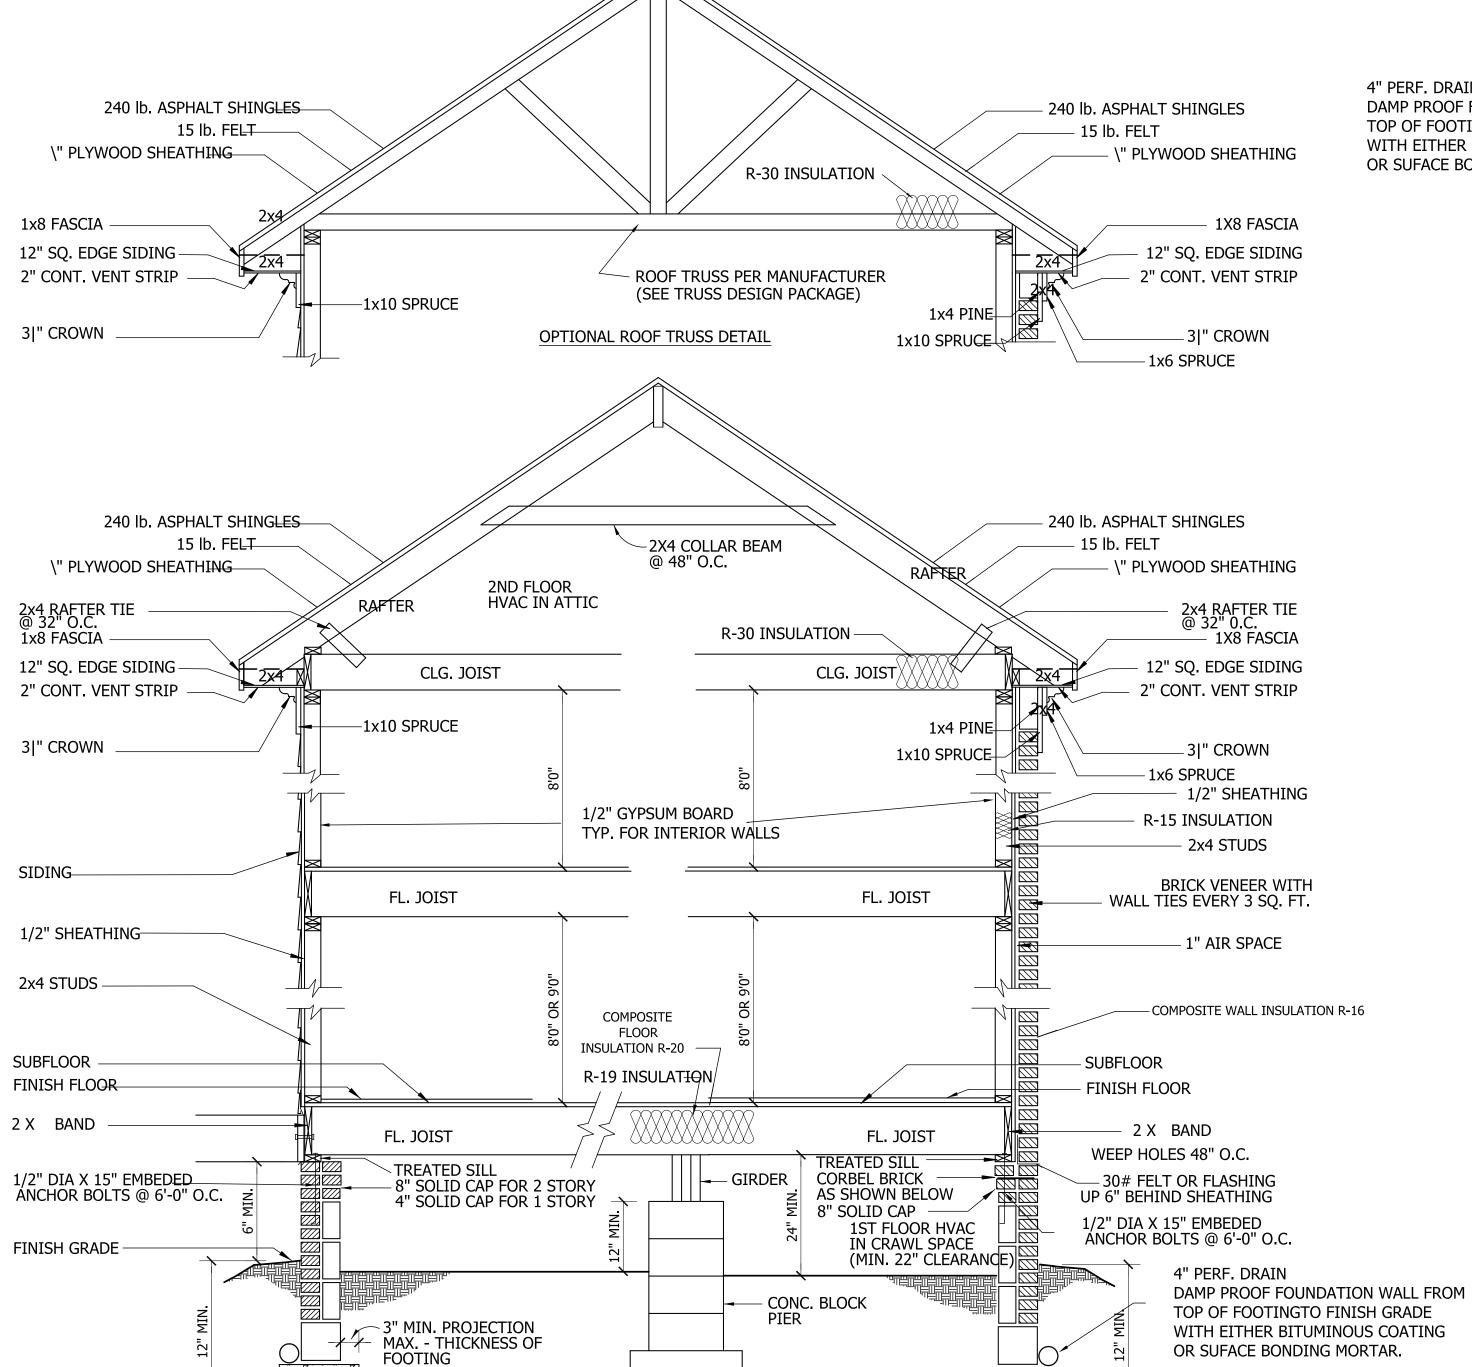


ROOF VENTILATING REQUIREMENTS = <u>12.82</u> SQ. FT. REQ'D **ROOF VENTILATING REQUIREMENTS** (POWER ROOF VENTILATOR REQUIRED)


= <u>6.41</u> SQ. FT. REQ'D

BUILDER TO PROVIDE APPROPRIATE VENTILATING AS REQUIRED.

CRAWL SPACE VENTILATION PROVIDE AT LEAST 1.0 SQ. FT. NET FREE VENTILATION AREA FOR EACH 150 SQ. FT. OF CRAWL SPACE. CRAWL SPACE AREA = 1423 SQ.FT. 1423/150 = 9.48 SQ. FT. REQ'D.REDUCE REQUIRED AREA TO 1.0 SQ. FT NET FREE VENTILATION AREA FOR EACH 1,500 SQ. FT. OF CRAWL SPACE WITH APPROVED VAPOR BARRIER. PROVIDE (1) VENT WITHIN 3'-0" OF EACH REFER TO MANUFACTURER SPECIFICATIONS FOR ACTUAL VENTS USED TO DETERMINE NUMBER OF VENTS REQUIRED.

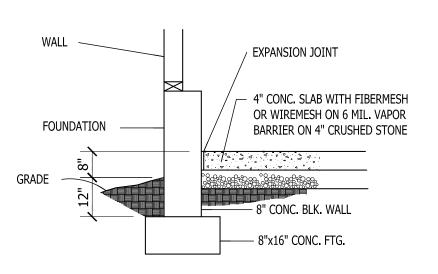

GARAGE SLAB SCALE: NTS

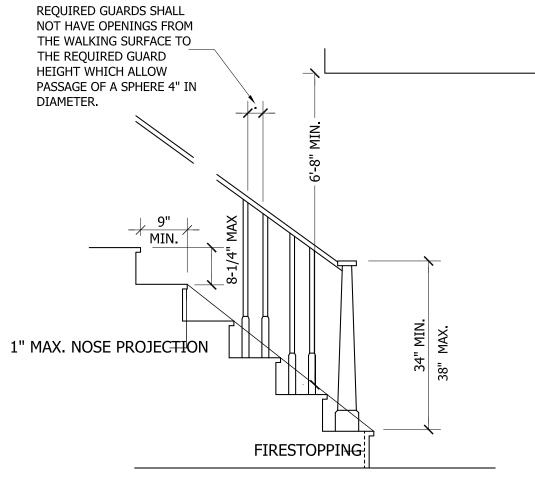

Stairways shall not be less than 36 inches in clear width at all points above the permitted handrail height and below the required headroom height. Handrails shall not project more than 4.5 inches on either side of the stairway and the minimum clear width of the stairway at and below the handrail height, including treads and landings, shall not be less than 31-1/2 inches where a handrail is installed on one side and 27 inches where handrails are provided on both sides

STAIR DETAIL

WALL SECTION

SCALE: \" = 1'-0"

BRICK SECTION

SIDING SECTION

GENERAL FOUNDATION NOTES:

- 1. THIS PLAN DESIGNED IN ACCORDANCE WITH NC RESIDENTIAL CODE, 2018 EDITION.
- 2. EXTERIOR WALL FOOTING TO BE MIN. 16" WIDE AND 3000 PSI. STRUCTURAL CONCRETE TO BE PREPARED AND PLACED IN ACCORDANCE WITH ACI 318, FOR FOUNDATION WALL HEIGHT, THICKNESS AND BACKFILL REQUIREMENTS, REFER TO STATE AND LOCAL BUILDING CODES. NOTE: ASSUMED SOIL BEARING CAPACITY = 2000 PSF. CONTRACTOR MUST VERIFY SITE CONDITIONS AND CONTACT SOIL ENGINEER IF MARGINAL
- OR UNSTABLE SOILS ARE ENCOUNTERED. 3. FOOTINGS TO BEAR ON UNDISTURBED EARTH A MINIMUM OF 12" BELOW
- ADJACENT FINISH GRADE OR AS OTHERWISE DIRECTED BY LOCAL INSPECTOR. 4. FOUNDATION DRAINAGE SHALL BE IN ACCORDANCE WITH SECTION R405 OF THE CODE "FOUNDATION DRAINAGE"
- 5. ANCHOR BOLTS SHALL BE $\frac{1}{2}$ " DIAMETER AND INSTALLED AT 12" ON CENTER AND 12" FROM EACH CORNER OR BOTTOM PLATE SPLICE LOCATIONS ..

STRUCTURAL EVALUATION BY: WILKINS ENGINEERING, P.C. Post Office Box 37446, Raleigh, NC FILE: KELSEY


* ENGINEER'S SEAL APPLIES ONLY TO STRUCTURAL COMPONENTS ON THIS DOCUMENT.

- SEAL DOES NOT INCLUDE CONSTRUCTION REVIEW, MEANS, METHODS, TECHNIQUES, SEQUENCES, PROCEDURES, OR SAFETY PRECAUTIONS.
- * ANY DEVIATIONS OR DISCREPANCIES ON PLANS ARE TO BE BROUGHT TO THE
- IMMEDIATE ATTENTION OF THE ENGINEER. FAILURE TO DO SO WILL VOID ENGINEER'S LIABILITY. THIS INCLUDES DIMENSIONS, NOTES, TITLE, DATES AND ANY INFORMATION ORIGINALLY SHOWN ON THE DRAWING BY THE ENGINEER.

32'-Ø"

52'-8"

ENGINEER'S SEAL AND SIGNATURE ABOVE.

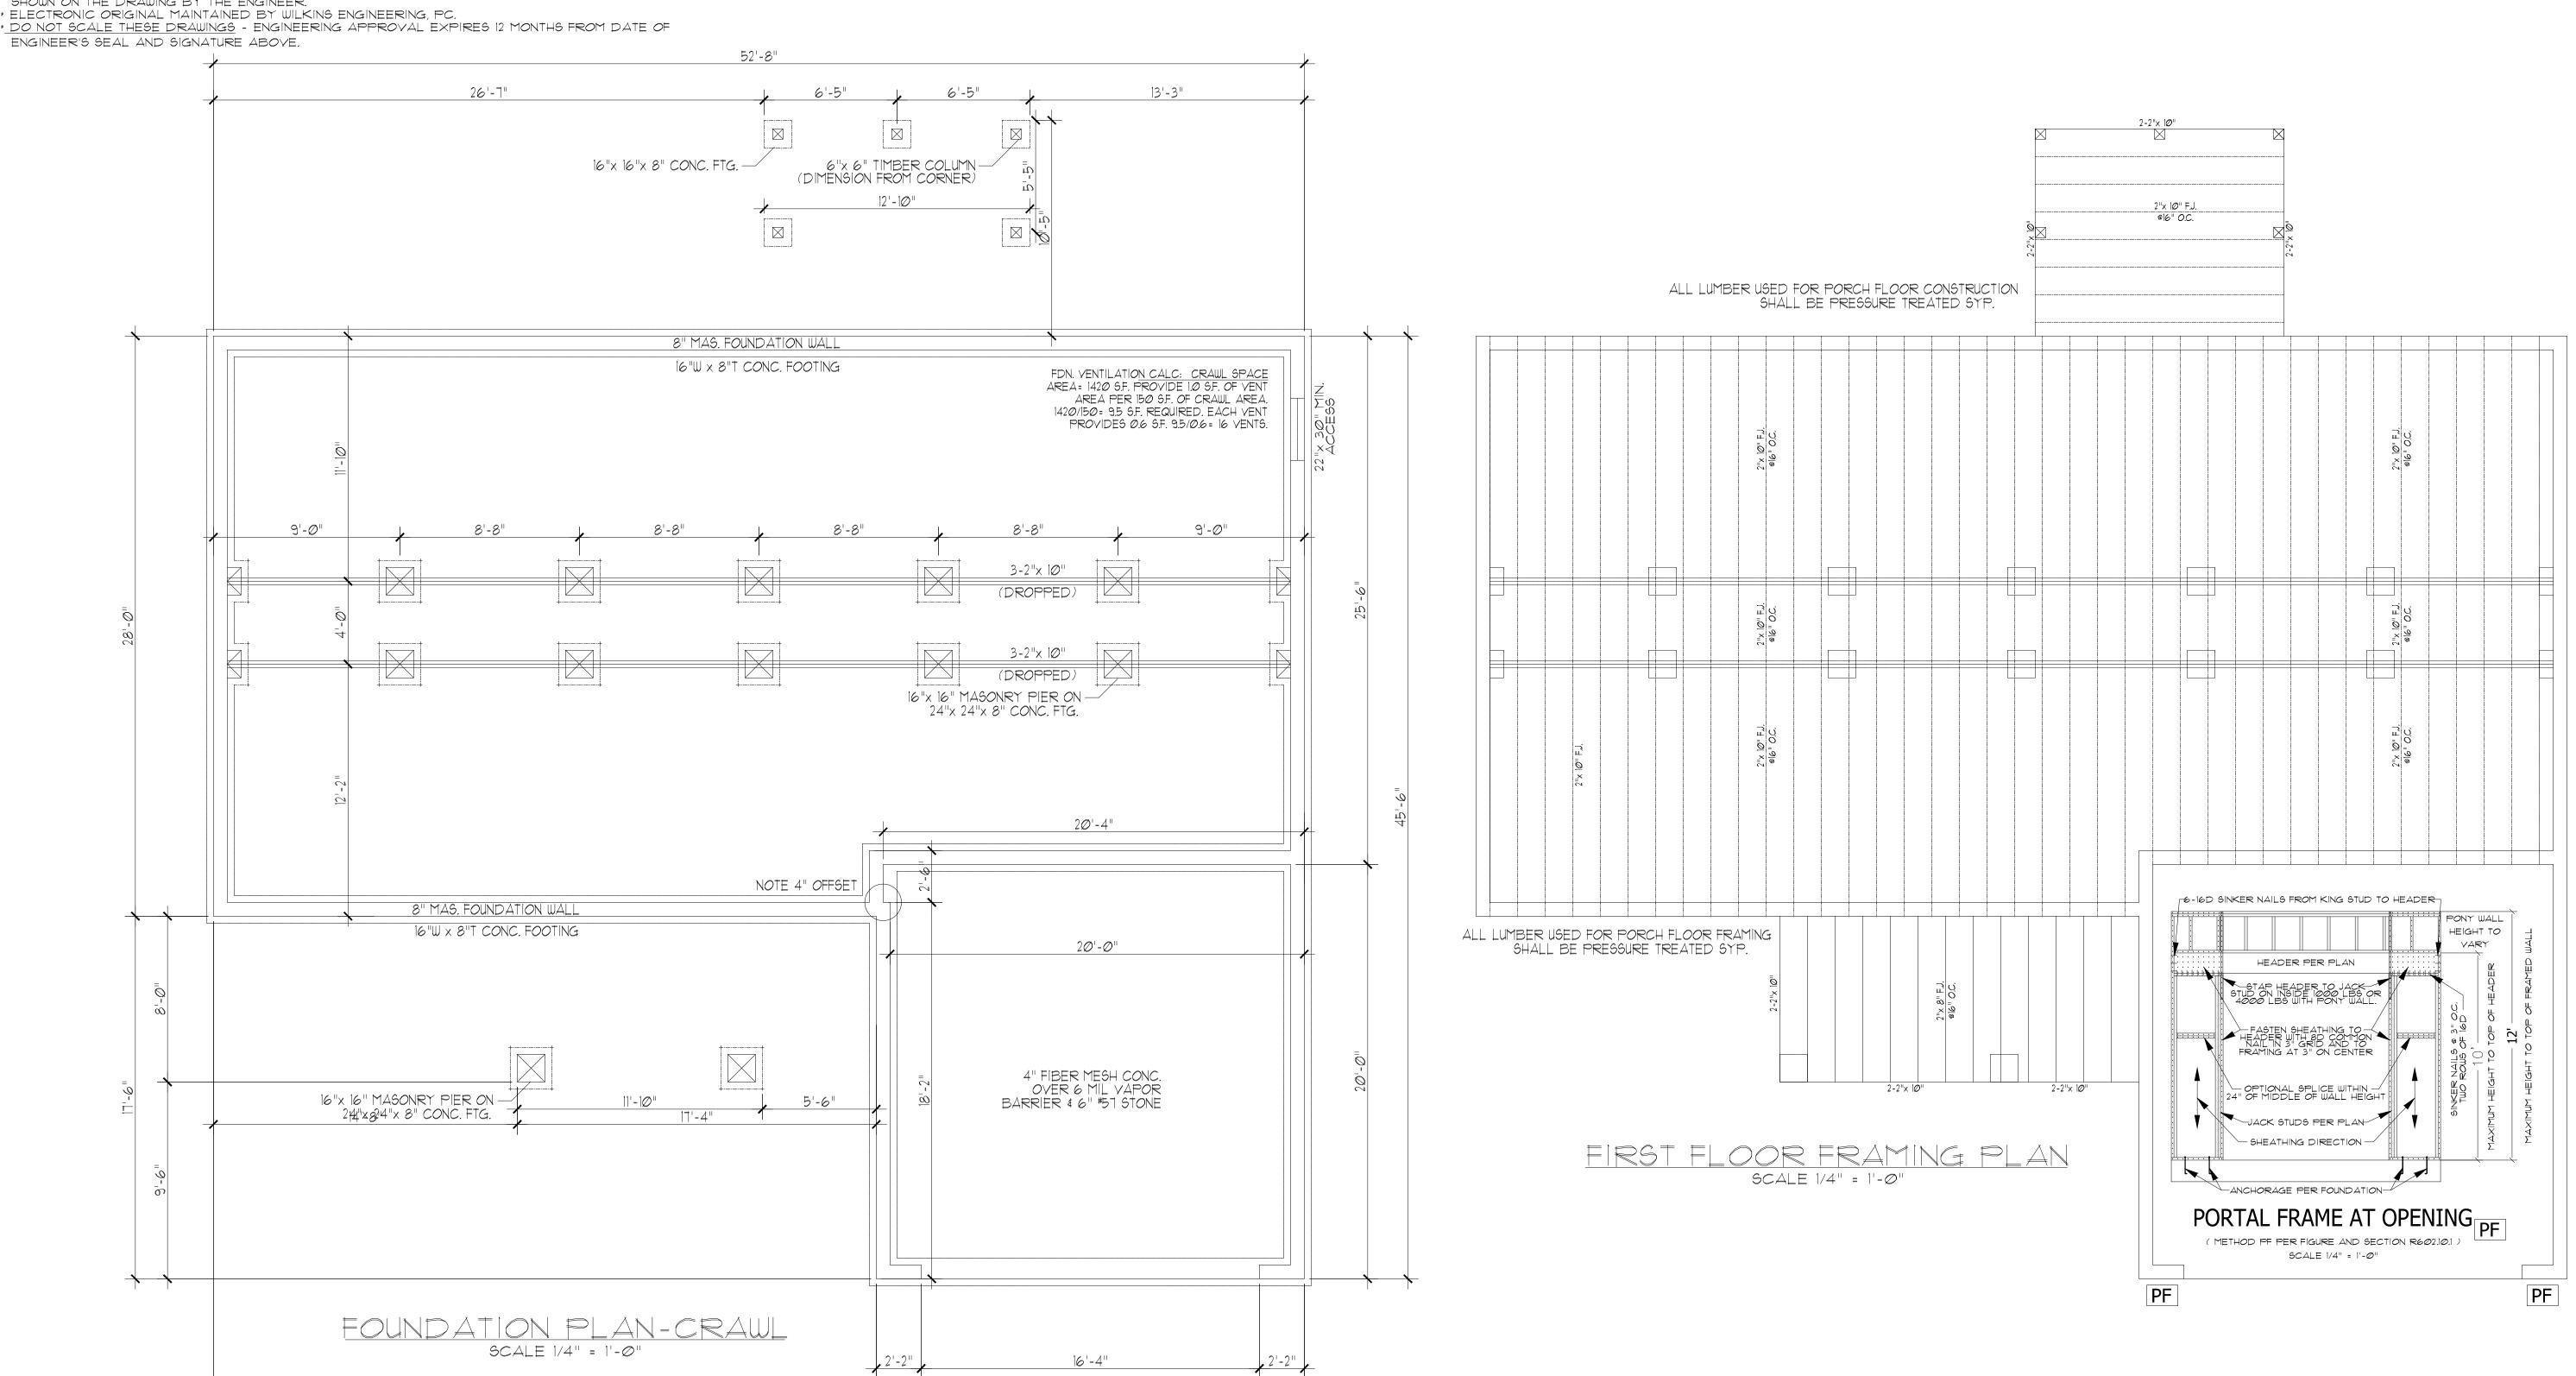

20'-8"

Sheet No.

GENERAL FOUNDATION NOTES:

- 1. THIS PLAN DESIGNED IN ACCORDANCE WITH NC RESIDENTIAL CODE, 2018 EDITION.
- 2. EXTERIOR WALL FOOTING TO BE MIN. 16" WIDE AND 3000 PSI.
 STRUCTURAL CONCRETE TO BE PREPARED AND PLACED IN ACCORDANCE
 WITH ACI 318. FOR FOUNDATION WALL HEIGHT, THICKNESS AND BACKFILL
 REQUIREMENTS, REFER TO STATE AND LOCAL BUILDING CODES.
 NOTE: ASSUMED SOIL BEARING CAPACITY = 2000 PSF. CONTRACTOR
 MUST VERIFY SITE CONDITIONS AND CONTACT SOIL ENGINEER IF MARGINAL
 OR UNSTABLE SOILS ARE ENCOUNTERED.
- 3. FOOTINGS TO BEAR ON UNDISTURBED EARTH A MINIMUM OF 12" BELOW ADJACENT FINISH GRADE OR AS OTHERWISE DIRECTED BY LOCAL INSPECTOR.
 4. FOUNDATION DRAINAGE SHALL BE IN ACCORDANCE WITH SECTION R405 OF
- THE CODE "FOUNDATION DRAINAGE".


 5. ANCHOR BOLTS SHALL BE $\frac{1}{2}$ " DIAMETER AND INSTALLED AT 12" ON CENTER AND 12" FROM EACH CORNER OR BOTTOM PLATE SPLICE LOCATIONS..

STRUCTURAL EVALUATION BY:
WILKINS ENGINEERING, P.C.
Post Office Box 37446, Raleigh, NC
FILE: KELSEY

FILE: KELSEY 6/18/2021

- * ENGINEER'S SEAL APPLIES ONLY TO STRUCTURAL COMPONENTS ON THIS DOCUMENT. SEAL DOES NOT INCLUDE CONSTRUCTION REVIEW, MEANS, METHODS, TECHNIQUES,
- SEQUENCES, PROCEDURES, OR SAFETY PRECAUTIONS.

 * ANY DEVIATIONS OR DISCREPANCIES ON PLANS ARE TO BE BROUGHT TO THE

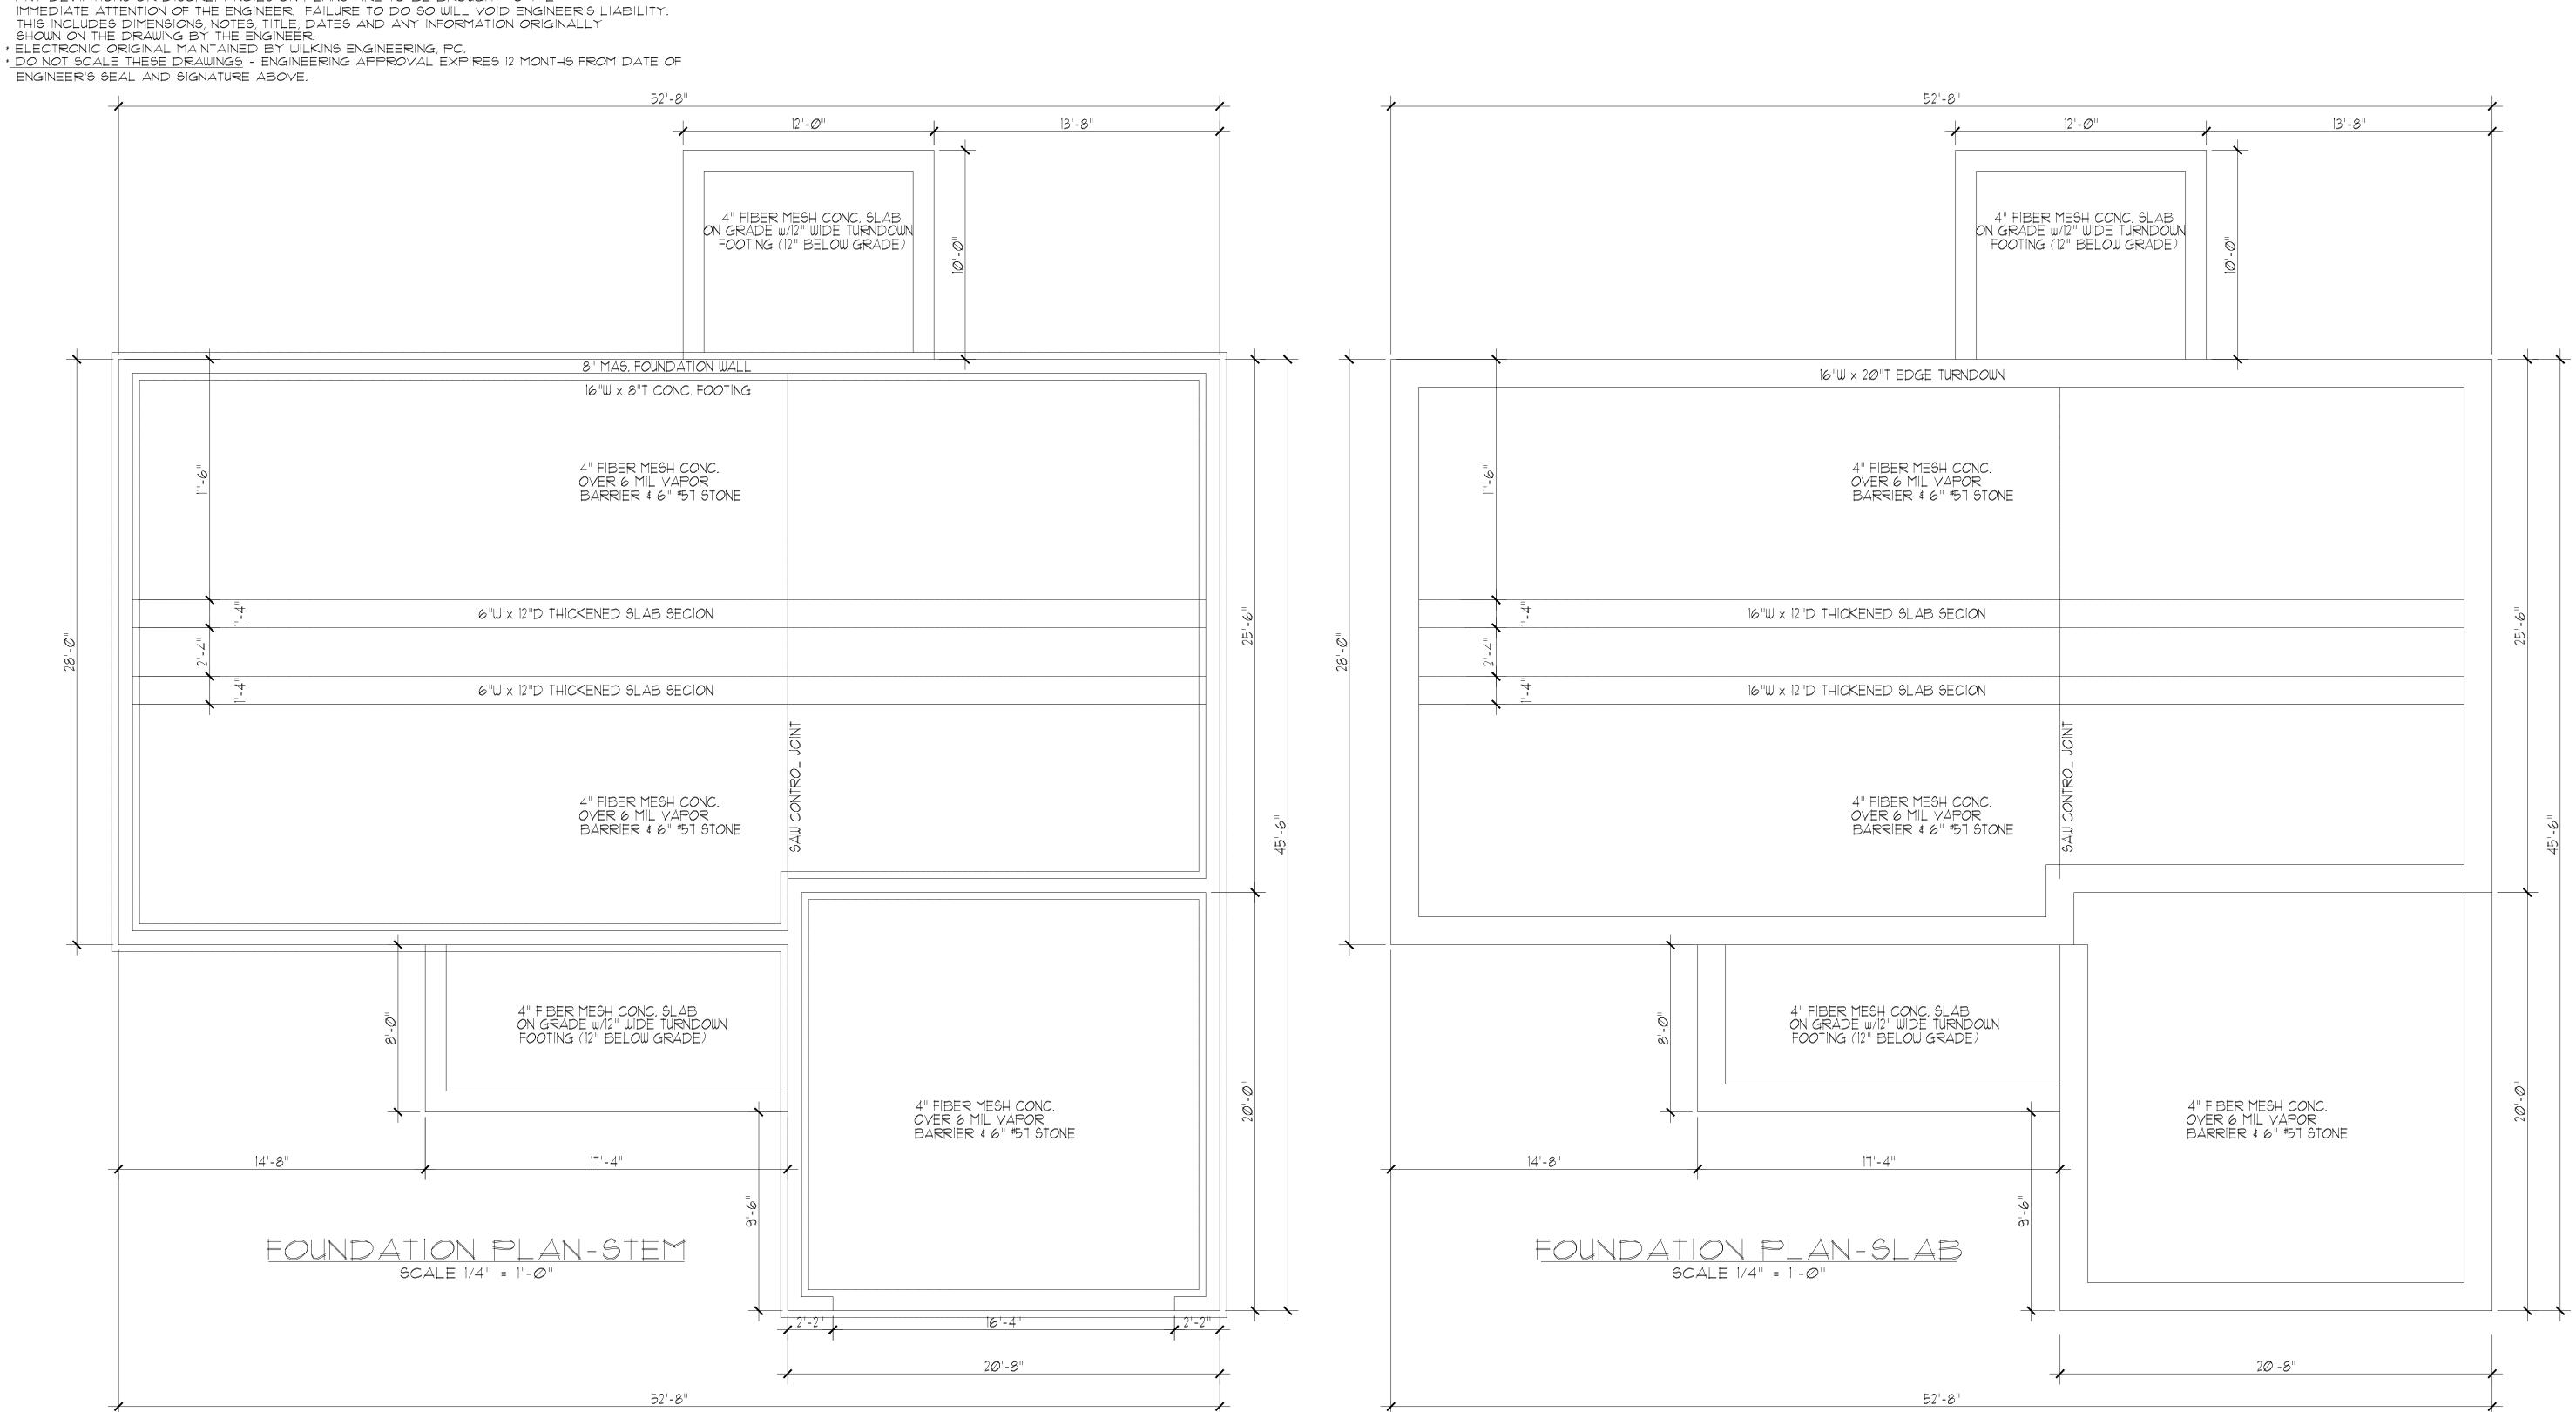

DO NOT SCALE THESE DRAWINGS

ALL DIMENSIONS AND SITE DIMENSIONS ARE TO BE
VERFIED BEFORE CONSTRUCTION BEGINS, SHOULD
ANY DISCREPANCIES OR OMISSIONS BE NOTED, THE
BUILDER AGREES TO NOTIFYTHE ENGINEER IMMEDIATELY.
THESE DRAWINGS APPLY TO STRUCTURAL ELEMENTS ONLY.
THE ENGINEER ASSUMES NO RESPONSIBILITY FOR CODE
COMPLIANCE OF NON-STRUCTURAL ITEMS.

ANS FINE FRICE COPYRIDO STATE OF THESE THE

Sheet No.

PRESSURE.

GENERAL NOTES:

- 1. THIS PLAN DESIGNED IN ACCORDANCE WITH NC RESIDENTIAL CODE, 2018 EDITION.
 2. GLAZING AREAS SHOWN ON THESE DESIGN DRAWINGS DO NOT EXCEED 15%
 OF THE GROSS AREA OF THE EXTERIOR WALLS. THIS STRUCTURE MEETS
- THE REQUIREMENTS OF NIIO1.2.1, RESIDENTIAL BUILDING, TYPE A-1.

 3. WALL CLADDING IS DESIGNED FOR A 24.1 #/SF OR GREATER POSITIVE/NEGATIVE
- ROOF CLADDING DESIGN VALUES (POSITIVE/NEGATIVE) SHALL BE AS

FOLLOWS:

45.5 */SF FOR ROOF PITCHES FROM Ø/12 TO 2.25/12

34.5 */SF FOR ROOF PITCHES FROM 2.25/12 TO 7/12

21 #/SF FOR ROOF PITCHES FROM 7/12 TO 12/12 MEAN ROOF HEIGHT FOR THIS STRUCTURE IS 22'.

4. ALL WALLS, FLOORS AND CEILINGS SHALL BE INSULATED IN ACCORDANCE WITH PART IV, ENERGY CONSERVATION, CHAPTER 11, ENERGY EFFICIENCY OF THE CODE FOR ZONE 4A (TABLE N1102...1.2).

5. DESIGN CRITERIA DEAD LIVE 10 PSF PRIMARY FLOOR SECONDARY FLOOR 10 PSF 40 PSF SLEEPING AREAS 10 PSF 30 PSF ATTIC 10 PSF 20 PSF ROOF 20 PSF 10 PSF

DEFLECTION LIMITS FLOOR - L/360 (LIVE LOAD ONLY) ROOF - L/240

- 6. ALL HEADERS IN LOAD BEARING WALLS SHALL BE 2-2"x 10" MEMBERS U.O.N. ALL LUMBER USED FOR JOISTS AND RAFTERS SHALL BE SPF #2 OR BETTER. LUMBER USE FOR STUDS SHALL BE SPF #3 OR BETTER.
- 7. LVL SHALL BE LAMINATED VENEER LUMBER OR PARALLEL STRAND LUMBER (PSL) WITH THE FOLLOWING PROPERTIES: Fb = 2800 PSI, Fv = 285 PSI, E = 2,000,000 PSI. INSTALL ALL LVL CONNECTIONS PER MANUFACTURER'S INSTRUCTIONS. MULTIPLE I 3/4 LVLs CAN BE USED TO ACHIEVE THE SPECIFIED SIZE AND IS CONSIDERED TO BE STRUCTURALLY EQUIVALENT.
- 8. THE FOLLOWING SHALL APPLY TO ALL BRACED WALL LINES:
 ALL EXTERIOR WALLS SHALL BE CONTINUOUSLY SHEATHED WITH 1/2" OSB OR CDX.
 WSP 1.A.W. R-602.10.3 AND SHALL BE COVERED WITH 1/2" GYPSUM BOARD ON THE
 INTERIOR. ALL WSP PANELS SHALL BE FASTENED WITH 8d NAILS, 12" O.C. (FIELD)
 AND 6" O.C. (EDGES). ALL EXTERIOR WALLS SHALL BE 2"x4"@16" ON CENTER (EXCEPT
 FOR BALLOON FRAMED SECTIONS AS NOTED) AND CONTINUOUSLY SHEATHED.

STRUCTURAL EVALUATION BY: WILKINS ENGINEERING, P.C. Post Office Box 37446, Raleigh,


FILE: KELSEY




6/12/2021

- * ENGINEER'S SEAL APPLIES ONLY TO STRUCTURAL COMPONENTS ON THIS DOCUMENT. SEAL DOES NOT INCLUDE CONSTRUCTION REVIEW, MEANS, METHODS, TECHNIQUES, SEQUENCES, PROCEDURES, OR SAFETY PRECAUTIONS.
- * ANY DEVIATIONS OR DISCREPANCIES ON PLANS ARE TO BE BROUGHT TO THE IMMEDIATE ATTENTION OF THE ENGINEER. FAILURE TO DO SO WILL VOID ENGINEER'S LIABILITY. * DO NOT SCALE THESE DRAWINGS. ENGINEERING APPROVAL EXPIRES IN 12 MONTHS.

# FULL HEIGHT STUDS EACH SIDE OF EXTERIOR WALL HEADERS/BEAMS			
HEADER SPAN (FEET)	STUDS @ 16" O.C.	STUDS @ 24" O.C.	
3'-0" OR LESS	1	1	
4'-0"	2	1	
8'-Ø"	3	2	
12'-Ø"	5	3	
16'-0"	6	4	

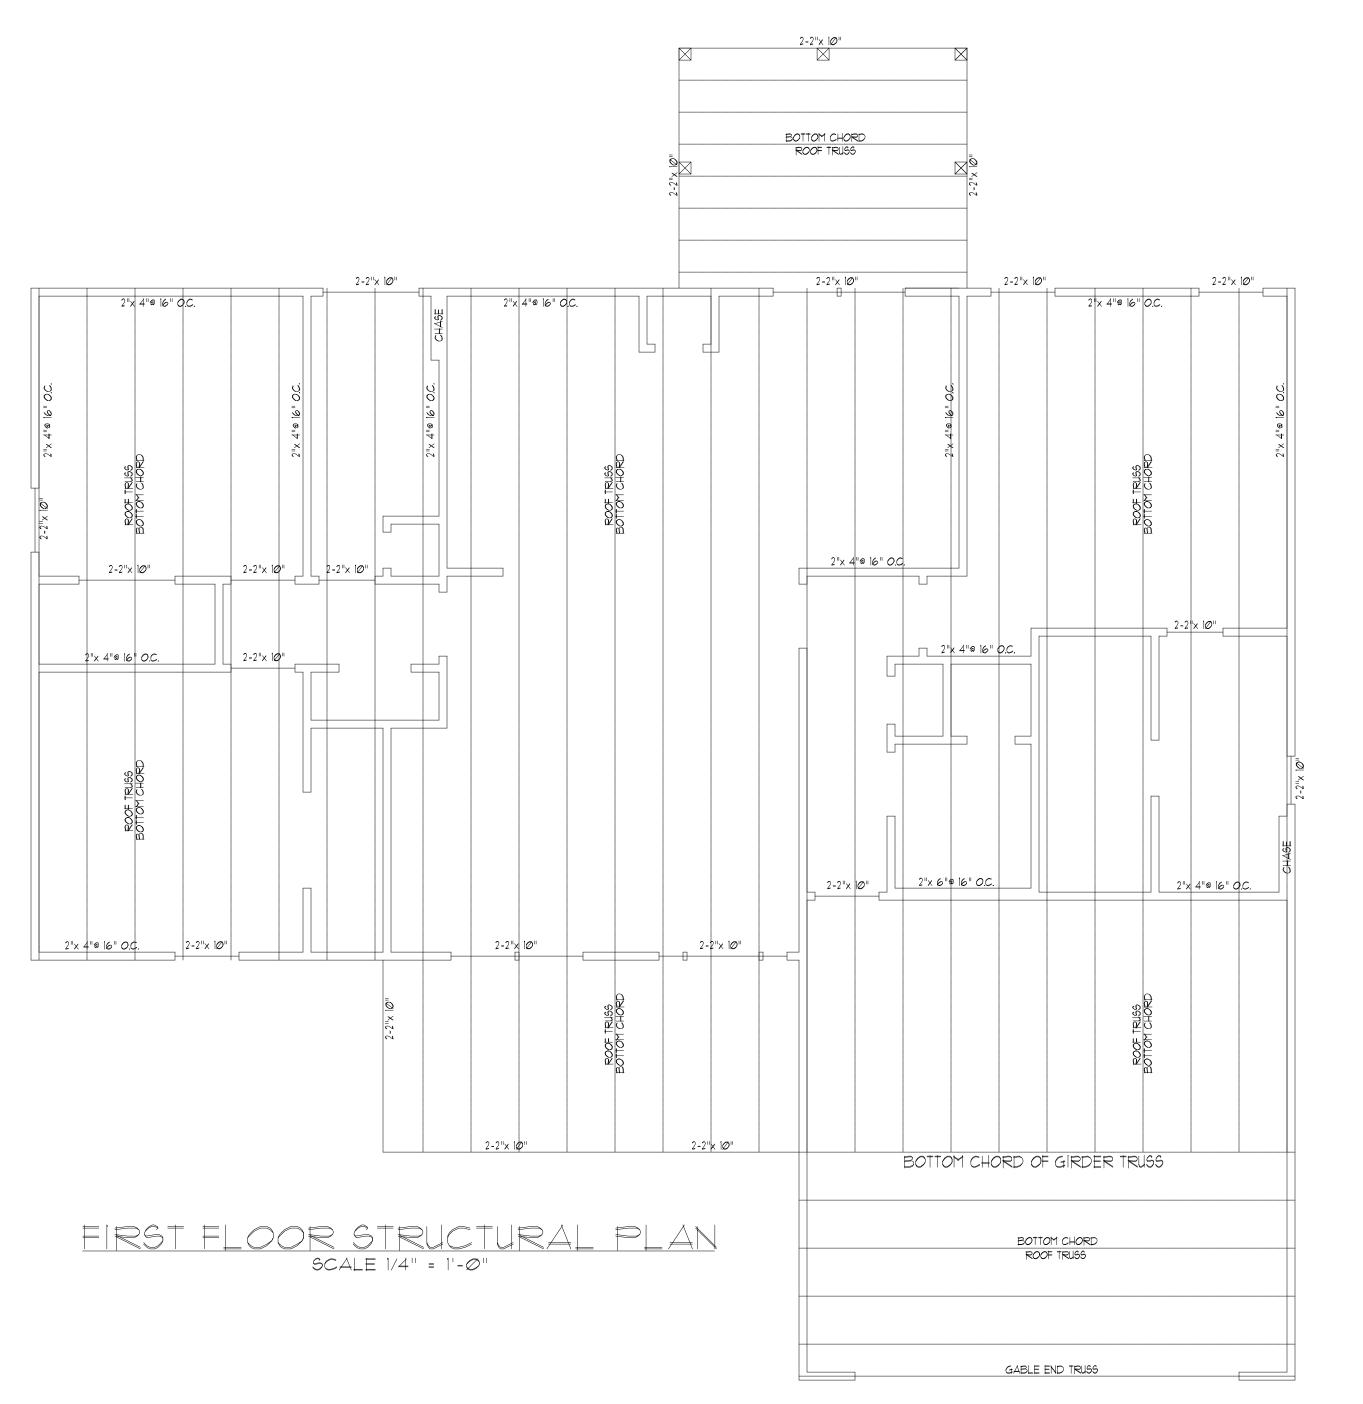

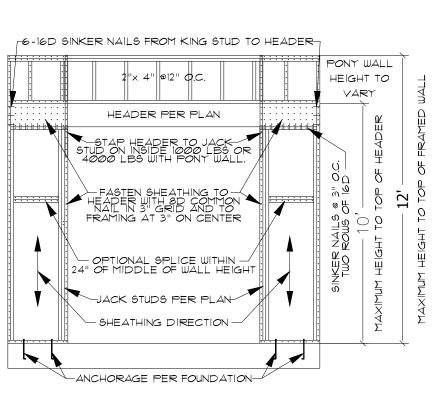

PORTAL FRAME AT OPENING

(METHOD PF PER FIGURE AND SECTION R602.10.1)

SCALE 1/4" = 1'-0"

DO NOT SCALE THESE DRAWINGS

ALL DIMENSIONS AND SITE DIMENSIONS ARE TO BE
VERIFIED BEFORE CONSTRUCTION BEGINS, SHOULD
ANY DISCREPANCIES OR OMISSIONS BE NOTED, THE
BUILDER AGREES TO NOTIFYTHE ENGINEER IMMEDIATEL
THESE DRAWINGS APPLY TO STRUCTURAL ELEMENTS OF
THE ENGINEER ASSUMES NO RESPONSIBILITY FOR CODI

COPYRIGHT 2020 WILKINS ENGINEERING, P.C. HESE DRAWINGS ARE PROTECTED UNDER FEDERAL COPYRIGHT LAWS. THE ORIGINAL PURCHASER OF HESE DRAWINGS IS LICENSED TO USE THE PLANS FOR THE CONSTRUCTION OF ONE AND ONLY ONE SINGLE AMILY HOME. REPRODUCTION, MODIFICATION, OR REUSE OF THESE DRAWINGS WITHOUT THE WRITTEN CONSENT OF THE ENGINEER IS EXPRESSLY

WILKINS ENGINE RING Post Office Box 37446 Raleigh, NC 27627

Sheet No.

GENERAL ROOF NOTES:


- 1. THIS PLAN DESIGNED IN ACCORDANCE WITH NC RESIDENTIAL CODE, 2018 EDITION.
- 2. ROOF CLADDING DESIGN VALUES (POSITIVE/NEGATIVE) ARE AS FOLLOWS:
 45.5 */SF FOR ROOF PITCHES FROM Ø/12 TO 2.25/12
 - 34.5 #/SF FOR ROOF PITCHES FROM 2.25/12 TO 7/12 21 #/SF FOR ROOF PITCHES FROM 7/12 TO 12/12
- 3. THE MEAN ROOF HEIGHT FOR THIS STRUCTURE IS 22 FEET.
- 4. ALL ROOFING ELEMENTS SHALL MEET THE REQUIREMENTS OF CHAPTER 8
- OF THE CODE.
- 5. ALL LUMBER SHALL BE #2 SPF, SYP OR BETTER.
- 6. THIS STRUCTURE DESIGNED FOR 115 MPH WIND ZONES.
- THE TRUSSES SHOWN ARE TO BE DESIGNED BY THE MANUFACTURER AND ANALYSIS PROVIDED TO THE ENGINEER FOR REVIEW PRIOR TO CONSTRUCTION.

STRUCTURAL EVALUATION BY:
WILKING ENGINEERING, P.C.
Post Office Box 37446, Raleigh, FILE: KELSEY



- * ENGINEER'S SEAL APPLIES ONLY TO STRUCTURAL COMPONENTS ON THIS DOCUMENT.
- SEAL DOES NOT INCLUDE CONSTRUCTION REVIEW, MEANS, METHODS, TECHNIQUES,
- SEQUENCES, PROCEDURES, OR SAFETY PRECAUTIONS.

 * ANY DEVIATIONS OR DISCREPANCIES ON PLANS ARE TO BE BROUGHT TO THE
- IMMEDIATE ATTENTION OF THE ENGINEER. FAILURE TO DO SO WILL VOID ENGINEER'S LIABILITY. THIS INCLUDES DIMENSIONS, NOTES, TITLE, DATES AND ANY INFORMATION ORIGINALLY
- SHOWN ON THE DRAWING BY THE ENGINEER.
- * ELECTRONIC ORIGINAL MAINTAINED BY WILKINS ENGINEERING, PC.
 * DO NOT SCALE THESE DRAWINGS ENGINEERING APPROVAL EXPIRES IN 12 MONTHS.

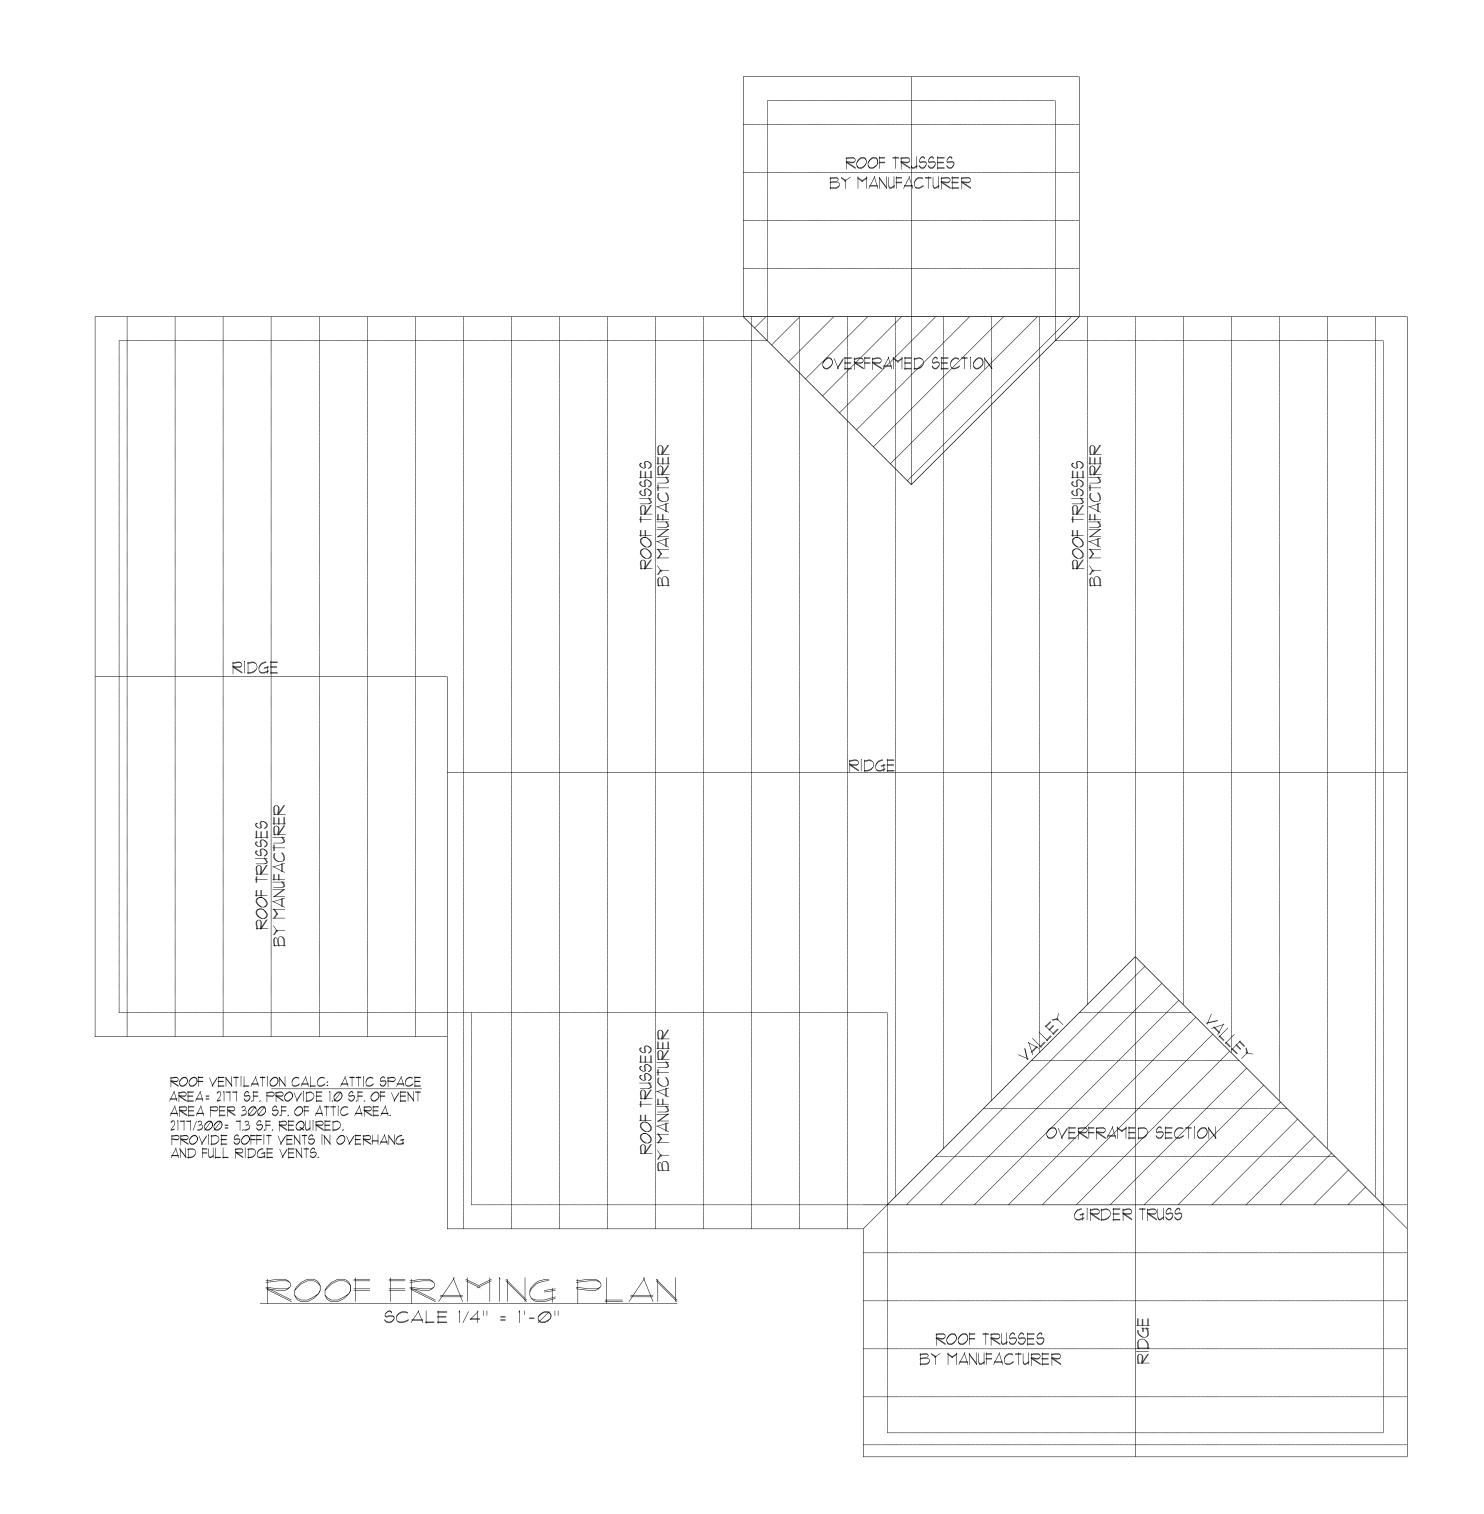

DO NOT SCALE THESE DRAWINGS

ALL DIMENSIONS AND SITE DIMENSIONS ARE TO BE
VERIFIED BEFORE CONSTRUCTION BEGINS, SHOULD
ANY DISCREPANCIES OR OMISSIONS BE NOTED, THE
BUILDER AGREES TO NOTIFYTHE ENGINEER IMMEDIATELY.
THESE DRAWINGS APPLY TO STRUCTURAL ELEMENTS ONLY.
THE ENGINEER ASSUMES NO RESPONSIBILITY FOR CODE
COMPLIANCE OF NON-STRUCTURAL ITEMS.

COPTRIGHT 2020 WILKINS ENGINEERING, P.C. THESE DRAWINGS ARE PROTECTED UNDER FEDERAL COPTRIGHT LAWS. THE ORIGINAL PURCHASER OF THESE DRAWINGS IS LICENSED TO USE THE PLANS FOTHE CONSTRUCTION OF ONE AND ONLY ONE SINGLE FAMILY HOME. REPRODUCTION, MODIFICATION, OR REUSE OF THESE DRAWINGS WITHOUT THE WRITTEN CONSENT OF THE ENGINEER IS EXPRESSLY

WILKINS ENGINE ENINE
Post Office Box 37446
Raleigh, NC 27627

Sheet No.



GENERAL NOTES:

- I. THIS PLAN DESIGNED IN ACCORDANCE WITH NC RESIDENTIAL CODE, 2018 EDITION. 2. GLAZING AREAS SHOWN ON THESE DESIGN DRAWINGS DO NOT EXCEED 15%
- THE REQUIREMENTS OF NIIØ1.2.1, RESIDENTIAL BUILDING, TYPE A-1. 3. WALL CLADDING IS DESIGNED FOR A 24.1 #/SF OR GREATER POSITIVE/NEGATIVE
- PRESSURE.
- ROOF CLADDING DESIGN VALUES (POSITIVE/NEGATIVE) SHALL BE AS

OF THE GROSS AREA OF THE EXTERIOR WALLS. THIS STRUCTURE MEETS


- 45.5 #/SF FOR ROOF PITCHES FROM 0/12 TO 2.25/12 34.5 #/SF FOR ROOF PITCHES FROM 2.25/12 TO 7/12
- 21 #/SF FOR ROOF PITCHES FROM 7/12 TO 12/12 MEAN ROOF HEIGHT FOR THIS STRUCTURE IS 22'
- 4. ALL WALLS, FLOORS AND CEILINGS SHALL BE INSULATED IN ACCORDANCE WITH PART IV, ENERGY CONSERVATION, CHAPTER II, ENERGY EFFICIENCY
- OF THE CODE FOR ZONE 4A (TABLE NII/02..1.2).
- 5. DESIGN CRITERIA DEAD LIVE 40 PSF 10 PSF PRIMARY FLOOR SECONDARY FLOOR 10 PSF 40 PSF 30 PSF SLEEPING AREAS 10 PSF 20 PSF ATTIC 10 PSF ROOF 20 PSF
- DEFLECTION LIMITS FLOOR - L/360 (LIVE LOAD ONLY) ROOF - L/240
- 6. ALL HEADERS IN LOAD BEARING WALLS SHALL BE 2-2"x 10" MEMBERS U.O.N. ALL LUMBER USED FOR JOISTS AND RAFTERS SHALL BE SPF #2 OR BETTER. LUMBER USE FOR STUDS SHALL BE SPF #3 OR BETTER.
- 7. LYL SHALL BE LAMINATED VENEER LUMBER OR PARALLEL STRAND LUMBER (PSL) WITH THE FOLLOWING PROPERTIES: Fb = 2800 PSI, Fv = 285 PSI, E = 2,000,000 PSI. INSTALL ALL LYL CONNECTIONS PER MANUFACTURER'S INSTRUCTIONS. MULTIPLE 1 3/4 LVLs CAN BE USED TO ACHIEVE THE SPECIFIED SIZE AND IS CONSIDERED TO BE STRUCTURALLY EQUIVALENT.
- 8. THE FOLLOWING SHALL APPLY TO ALL BRACED WALL LINES: ALL EXTERIOR WALLS SHALL BE CONTINUOUSLY SHEATHED WITH $\frac{1}{2}$ " OSB OR CDX. WSP I.A.W. R-602.10.3 AND SHALL BE COVERED WITH 1/2" GYPSUM BOARD ON THE INTERIOR. ALL WSP PANELS SHALL BE FASTENED WITH 8d NAILS, 12" O.C. (FIELD) AND 6" O.C. (EDGES). ALL EXTERIOR WALLS SHALL BE 2"x4"@16" ON CENTER (EXCEPT FOR BALLOON FRAMED SECTIONS AS NOTED) AND CONTINUOUSLY SHEATHED.


STRUCTURAL EVALUATION BY WILKINS ENGINEERING, P.C. Post Office Box 37446, Raleigh,

Ronald B. Wilkin FILE: KELSEY

- * ENGINEER'S SEAL APPLIES ONLY TO STRUCTURAL COMPONENTS ON THIS DOCUMENT. SEAL DOES NOT INCLUDE CONSTRUCTION REVIEW, MEANS, METHODS, TECHNIQUES, SEQUENCES, PROCEDURES, OR SAFETY PRECAUTIONS.
- * ANY DEVIATIONS OR DISCREPANCIES ON PLANS ARE TO BE BROUGHT TO THE IMMEDIATE ATTENTION OF THE ENGINEER. FAILURE TO DO SO WILL VOID ENGINEER'S LIABILITY.
- * DO NOT SCALE THESE DRAWINGS. ENGINEERING APPROVAL EXPIRES IN 12 MONTHS.

# EIII	ng Elacil	SIDE OF	
# FULL HEIGHT STUDS EACH SIDE OF EXTERIOR WALL HEADERS/BEAMS			
HEADER SPAN (FEET)	STUDS @ 16" O.C.	STUDS @ 24" O.C.	
3'-Ø" OR LESS	1	1	
4'-Ø"	2	1	
8'-Ø"	3	2	
12'-Ø"	5	3	
16'-0"	6	4	

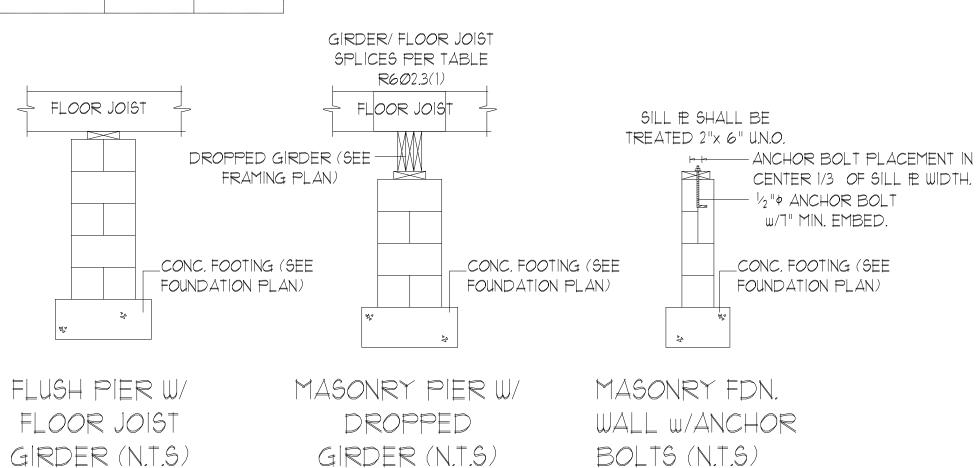

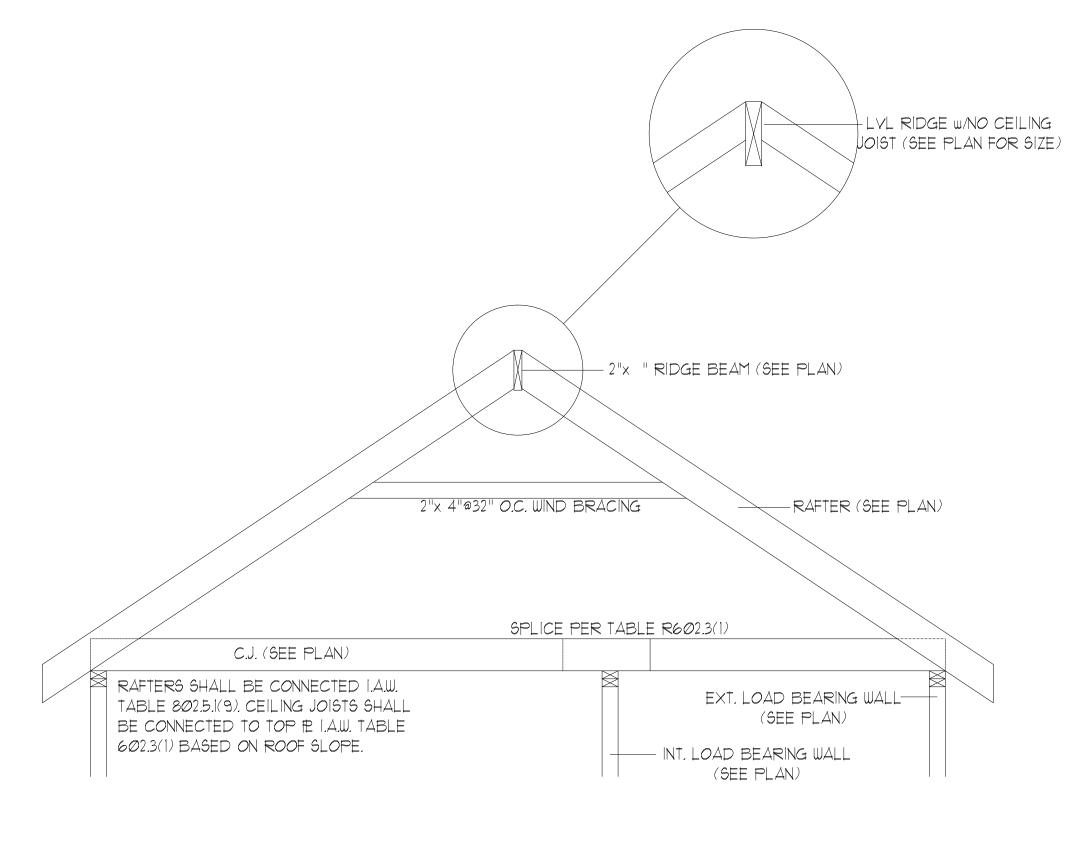

DO ALL VEN BULL BUTTERS THE STATE OF THE STA

|

Sheet No.

RIDGE BEAM/RAFTER DETAIL (N.T.S)

