Testing Company: Inspections Jurisdiction: I hereby certify that the above named company has been retained and is qualified to perform all of the necessary testing required to construct the retaining wall designed in these plans. If required, the above named inspections department will be notified of the results of these tests and/or in the event that testing services are suspended. Contractor: Print Name Signature

ENGINEER MUST BE
PRESENT DURING
CONSTRUCTION OF
RETAINING WALL TO
CERTIFY INSTALLATION
OF WALL

IT IS THE CONTRACTORS'
RESPONSIBILITY TO
PROVIDE STABLE CUTS
AND/OR TRENCH
PROTECTION PER OSHA
STANDARDS

TABLE OF CONTENTS:

RW1.0: RET. WALL PLAN VIEW


GS1: GENERAL NOTES AND SPECS GS2: GENERAL NOTES AND SPECS

RW2.0: RET. WALL ELEVATION

RW3.0-RW3.2: RET. WALL SECTION DETAILS

RW4.0: OPT. HANDRAIL DETAIL

RW5.0: GEOGRID PLACEMENT DETAILS

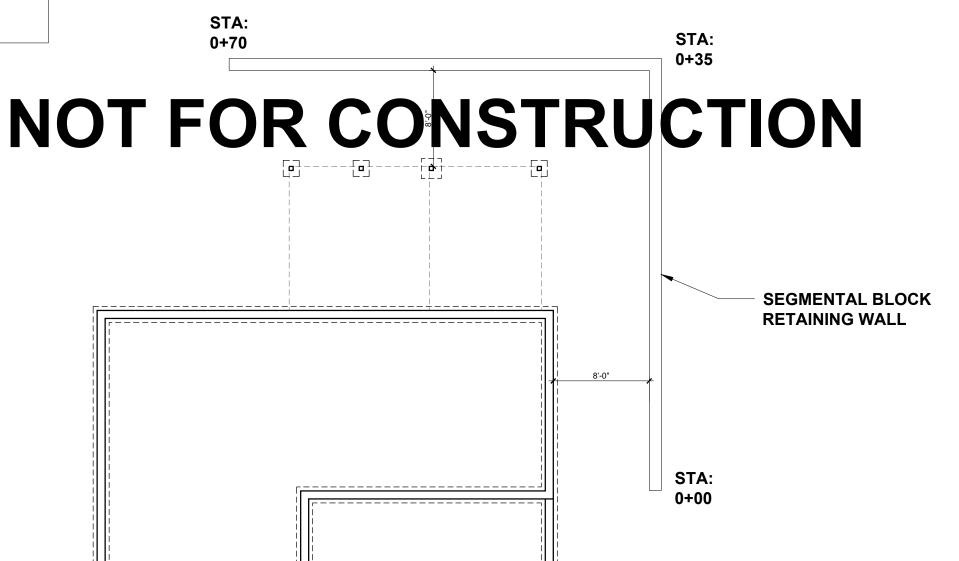



UTILITY LINES & TRANSFORMER ARE TO BE LOCATED BEFORE CONSTRUCTION STARTS ON OR NEAR RETAINING WALL. CALL 811 TO MARK OFF UTILITIES BEFORE YOU DIG.

RETAINING WALL: PLAN VIEW

SCALE: 1" = 8'-0"

ENGINEER OF RECORD

JDS CONSULTING, PLLC

DESIGN · ENGINEERING · SURVEYING · ENERGY

8600 'D' JERSEY COURT

RALEIGH, NC 27617

FIRM LIC. NO: P-0961

PROJECT REFERENCE: 21901981

P-0961




D GROVE LOT 21 /ARINA, NORTH CAROLINA


PROJECT NO: 2190XXXX

DATE: 11/02/2021 DRAWN BY: KMC

RETAINING WALL PLAN VIEW

RW1.0

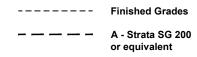

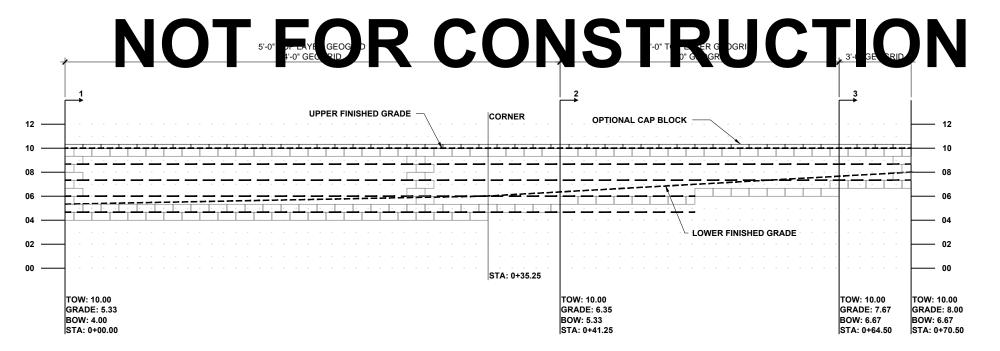

FINISHED GRADE LINES ARE TO BE DETERMINED BY CONTRACTOR. MAXIMUM UNBALANCED FILL TO BE 4'-0" AND A MINIMUM OF 1.5 BLOCK(S) TO BE BURIED BELOW GRADE AT ANY POINT.

RETAINING WALL: ELEVATION

SCALE: 1/8" = 1'-0"

P-0961



NORTH CAROLINA

GHLAND GROVE LOT

ECT NO.: **2190XXXX**

DATE: 11/02/2021

RAWN BY:

KMC

ETAINING WALL ELEVATION VIEW

211/2 (

IT IS THE CONTRACTORS' **RESPONSIBILITY TO PROVIDE STABLE CUTS** AND/OR TRENCH PROTECTION PER OSHA **STANDARDS**





WELL-GRADED GRANULAR WALL ROCK 0.25 in TO 1.5 in (5 mm TO 38 mm) LESS THAN 10% FINES, 12" MIN. OF BACKFILL



VIRGIN SOIL OR CONTROLLED FILL TO 95% COMPACTION



REINFORCED BACKFILL PER MFTR SPECS. COMPACTED TO MFTR SPECS.

SECTION: GEOGRID

WALL UNIT TYPE - 8"H x 18"W x 12"D

GF NULAR ALL ROUSE (5 in 10 38) (n) LE THEN 10% FIN. 10%

ADDITIONAL NOTES:

- 1. Setback distance is approximate and does not consider curves, radii or corners.
- 2. Geogrids placed in the slope above the wall are used in the internal compound stability calculations and in the contributory area calculation of the top wall geogrid.
- 3. Place the geogrid, in the reinforced base, per the elevation view.
- 4. All geogrid length dimensions are minimum lengths that the geogrid must extend past the front face of the block.
- 5. Base of wall shall be 6" deep and 2' wide typical, U.N.O., with the stone extending 6" beyond the face of the first course of block.
- 6. For site configurations with bottoms of the base on a level plane a minimum one percent gradient shall be maintained on the placement of the toe and heel pipe. Pipe outlets shall be provided on 50' centers, or 100' centers if pipe is crowned between the outlets.
- 7. Retaining wall shall be constructed in accordance with block manufacturer's specifications and recommendations.
- 8. Maintain 3' consolidation zone behind face of wall. No heavy equipment or machinery shall be allowed within the consolidation zone.

▼ GRADE ~ 6.00 ft 4" TOE DRAIN PIPE VENTED TO DAYLIGHT

Section 1: (0ft - 41ft) 4'-0" MAX ÙNBALANCED FILL

RETAINING WALL: SECTION DETAIL

SCALE: 3/8" = 1'-0"

DETERMINED BY CONTRACTOR, A





CAROLINA

2190XXXX

HIGHLAND GROVE LOT

11/02/2021

KB HOMES

KMC

RETAINING WALL SECTION DETAILS



WELL-GRADED GRANULAR WALL ROCK 0.25 in TO 1.5 in (5 mm TO 38 mm) LESS THAN 10% FINES, 12" MIN. OF BACKFILL




VIRGIN SOIL OR CONTROLLED FILL TO 95% COMPACTION



REINFORCED BACKFILL PER MFTR SPECS. COMPACTED TO MFTR SPECS.

---- SECTION: GEOGRID

WALL UNIT TYPE - 8"H x 18"W x 12"D

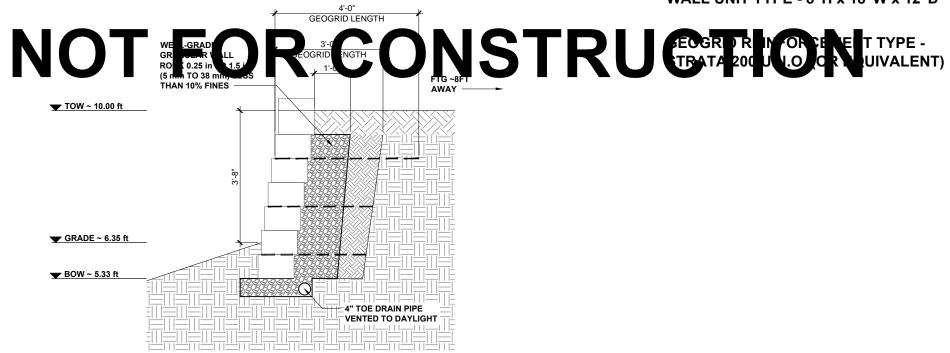

Section 2: (41ft - 65ft) 3'-8" MAX UNBALANCED FILL

RETAINING WALL: SECTION DETAIL

SCALE: 3/8" = 1'-0"

FINISHED GRADE LINES ARE TO BE DETERMINED BY CONTRACTOR. A MINIMUM OF 1.5 BLOCK(S) TO BE BURIEI BELOW GRADE AT ANY POINT. P-0961



NORTH CAROLINA

IGHLAND GROVE LOT

JECT NO.: **2190XXXX**

DATE: 11/02/2021

KMC

RETAINING WALL SECTION DETAILS

RW3.1



WELL-GRADED GRANULAR WALL ROCK 0.25 in TO 1.5 in (5 mm TO 38 mm) LESS THAN 10% FINES, 12" MIN. OF BACKFILL



VIRGIN SOIL OR CONTROLLED FILL TO 95% COMPACTION




REINFORCED BACKFILL PER MFTR SPECS. COMPACTED TO MFTR SPECS.

---- SECTION: GEOGRID

WALL UNIT TYPE - 8"H x 18"W x 12"D

NOT FOR CONSTRUCTOR DIVIDATE OF THE POPULATION O

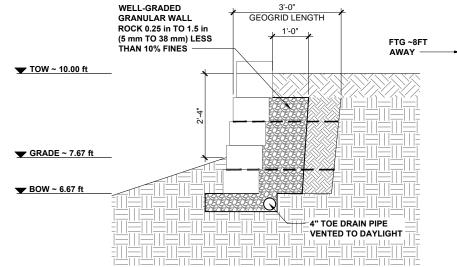

Section 3: (65ft - 70ft) 2'-4" MAX UNBALANCED FILL

RETAINING WALL: SECTION DETAIL

SCALE: 3/8" = 1'-0"

FINISHED GRADE LINES ARE TO BE DETERMINED BY CONTRACTOR. A MINIMUM OF 1.5 BLOCK(S) TO BE BURIE BELOW GRADE AT ANY POINT. P-0961



OVE LOT 21 VA, NORTH CAROLINA

IIGHLAND GROVE I

DECT NO.: 2190XXXX

DATE: 11/02/2021

KMC

RETAINING WALL SECTION DETAILS

RW3.2