- GENERAL NOTES

  1. ALL WORK SHALL BE PERFORMED IN ACCORDANCE WITH ALL APPLICABLE NATIONAL, STATE, AND LOCAL CODES AND REGULATIONS.
- CONTRACTOR SHALL THOROUGHLY REVIEW ALL SHEETS IN PLAN SET AND VERIFY ALL DETAILS AND DIMENSIONS BEFORE BEGINNING CONSTRUCTION. ANY DISCREPANCIES SHALL BE REPORTED TO RENAISSANCE RESIDENTIAL
- DESIGN, INC. FOR JUSTIFICATION AND/OR CORRECTION BEFORE
  PROCEEDING WITH WORK. CONTRACTORS SHALL ASSUME RESPONSIBILITY FOR ERRORS THAT ARE NOT REPORTED PRIOR TO CONSTRUCTION.
  ALL DIMENSIONS SHOULD BE READ OR CALCULATED AND NEVER SCALED.
- CONTRACTOR SHALL ENSURE COMPATIBILITY OF THE BUILDING WITH ALL

**LOT 71 THOMAS FARM** TBD OVERHILLS RD SPRING LAKE, NC

PLANS DESIGNED TO THE 2018 NORTH CAROLINA STATE RESIDENTIAL BUILDING CODE.



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WEAVER HOMES CAROLINA COLLECTION POPLAR DRIVE RIGHT

REV -SCALE: 1/4" = 1'-0"

DRAWN BY: WG ENGINEERED BY REVIEWED BY:

C - ELEVATIONS


A-3



# **HVAC:CAROLINA COMFORT HEATING & AIR**


**ELECTRICAL: TBD** 

PLUMBING: DOUBLE J PLUMBING

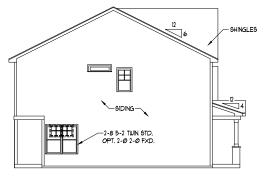


LEFT ELEVATION SCALE: 1/8" = 1'-0"

# FRONT ELEVATION-C SCALE: 1/4" = 1'-@"

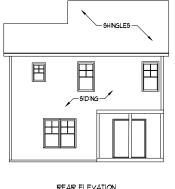



REAR ELEVATION SCALE: 1/8" = 1'-0'

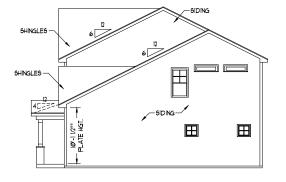

RIGHT ELEVATION SCALE: 1/8" = 1'-0'

SCALE NOTE: 18x24 PRINTS ARE TO SCALE AS NOTED. 11x17 PRINTS ARE NOT TO SCALE

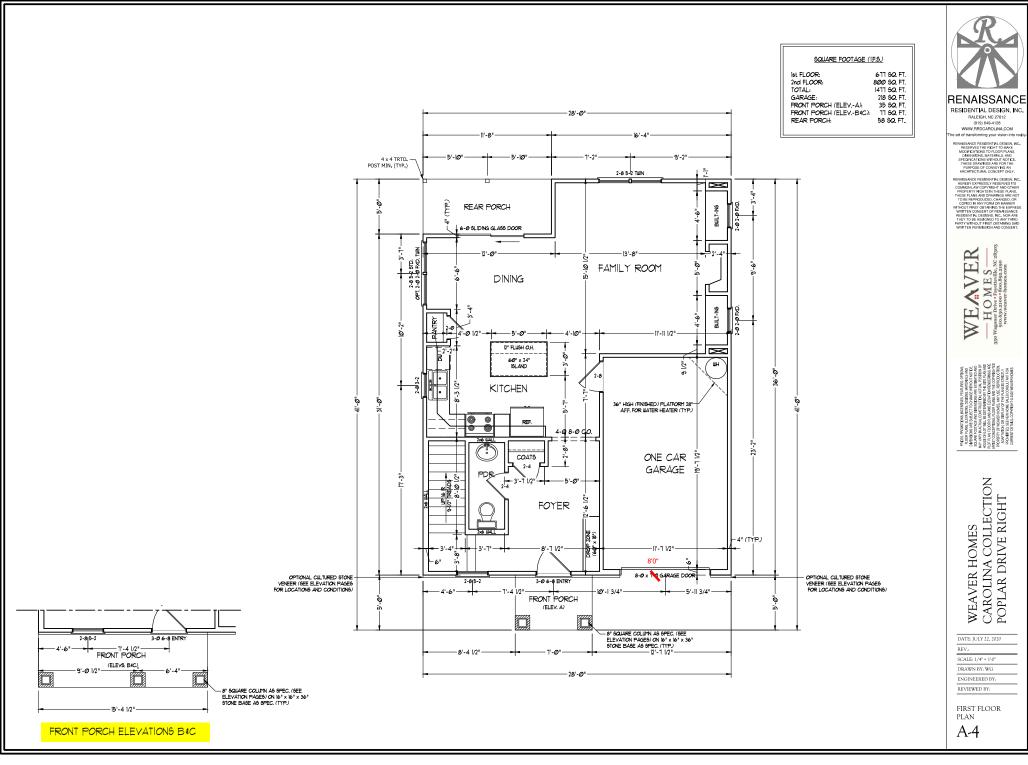

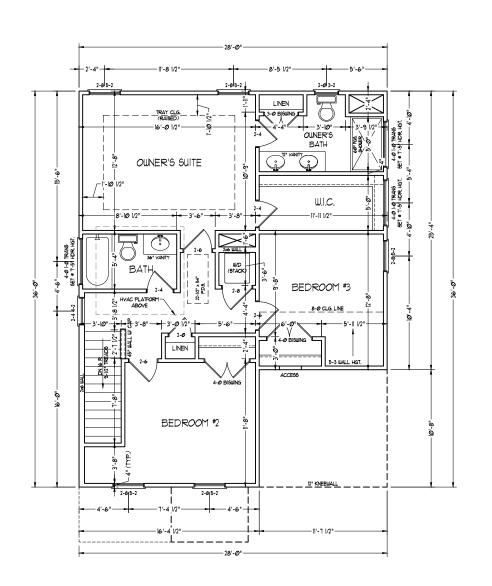



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WEAVER HOMES CAROLINA COLLECTION POPLAR DRIVE RIGHT

DATE: JULY 22, 2020

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SCALE: 1/4" = 1'-0" DRAWN BY: WG


ENGINEERED BY:

REVIEWED BY:

SECOND FLOOR PLAN

A-5



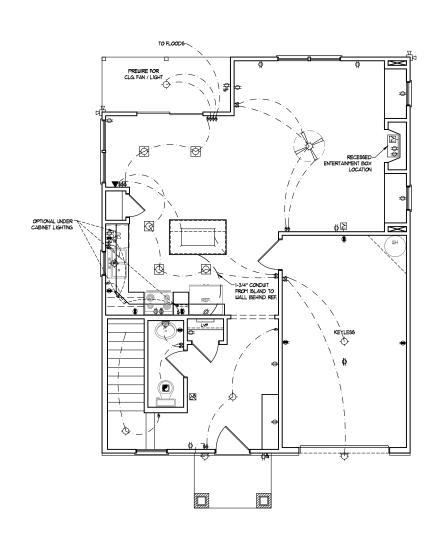



U BLOCK AND WIRE FOR ALL CELING FANS PER PLAN.

4-PLEX

RECESSED CAN LIGHT

MINI CAN LIGHT

EYEBALL LIGHT

UNDERCABINET LIGHT

\$ SWITCH

DIMMER SWITCH

▲ TELEPHONE

△ DATA

▲ TELEPHONE AND DATA

TY- TY CONNECTION

TV/ DATA

CONDUIT FOR COMPONENT WIRING

110 V SMOKE/ CM DETECTOR

5D 10 V SMOKE DETECTOR

LOW VOLTAGE PANEL





DATE: JULY 22, 2020 SCALE: 1/4" = 1'-0"

> DRAWN BY: WG ENGINEERED BY:

WEAVER HOMES CAROLINA COLLECTION POPLAR DRIVE RIGHT

REVIEWED BY: FIRST FLOOR ELECTRICAL

PLAN E-1



2) VANITY LIGHTS TO BE SET • 90" AFF. (TYP.)

3.) ADDITIONAL EXTERIOR OUTLETS REQUIRED BY CODE TO BE LOCATED BY ELECTRICIAN.

4.) PLACE SWITCHES 8" (MIN.) FROM ROUGH OPENINGS.

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# ELECTRICAL LEGEND

□ V OUTLET

₩ IØ V GFI OUTLET

□ ∨ SWITCHED OUTLET

BB == 10 V BASEBOARD OUTLET

GOUNTER OR FLOOR MOUNTED

COUNTER OR FLOOR MOUNTED HOV GF

# WEATHERPROOF

⇒ 22Ø ∨ OUTLET

Ø IØ V DEDICATED CIRCUIT

# 220 V DEDICATED CIRCUIT

● SPECIAL PURPOSE (240 V, ETC.)

ALL MOUNT LIGHT

CEILING MOUNT LIGHT

-PENDANT LIGHT

FLUORESCENT LIGHT

FLOOD LIGHT


24

EXHAUST FAN

ALARM PANEL



CEILING FAN W LIGHT

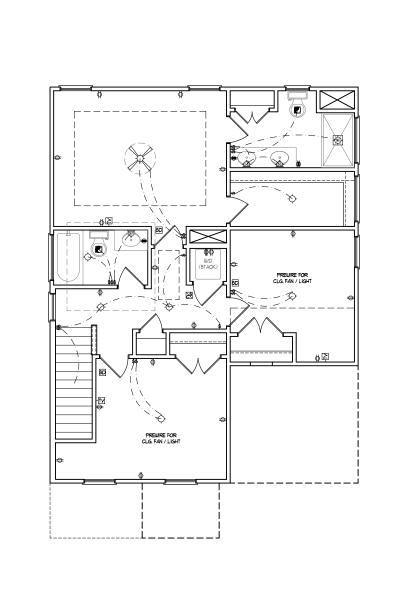

## ELECTRICAL LAYOUT NOTES:

- U BLOCK AND WIRE FOR ALL CELING FANS PER PLAN.
- 2.) VANITY LIGHTS TO BE SET 90" AFF. (TYP.)
- 3.) ADDITIONAL EXTERIOR OUTLETS REQUIRED BY CODE TO BE LOCATED BY ELECTRICIAN.
- 4.) PLACE SWITCHES 8" (MIN.) FROM ROUGH OPENINGS.

# ELECTRICAL LEGEND

- □ V OUTLET
- IØ V GFI OUTLET
- □ ∨ SWITCHED OUTLET
- BB == 110 V BASEBOARD OUTLET
- 4-PLEX
- GOUNTER OR FLOOR MOUNTED
- COUNTER OR FLOOR MOUNTED 110V GF1
- # WEATHERPROOF
- ⇒ 22Ø ∨ OUTLET
- Ø IØ V DEDICATED CIRCUIT
- # 220 V DEDICATED CIRCUIT
- ●H SPECIAL PURPOSE (240 V, ETC.)
- ALL MOUNT LIGHT
- CEILING MOUNT LIGHT
- -PENDANT LIGHT
- RECESSED CAN LIGHT
- MINI CAN LIGHT
- EYEBALL LIGHT
- FLUORESCENT LIGHT
- UNDERCABINET LIGHT
- ₽ FLOOD LIGHT
- \$ SWITCH
- DIMMER SWITCH
- ▲ TELEPHONE
- △ DATA
- ▲ TELEPHONE AND DATA
- TY- TY CONNECTION
- 24 TV/ DATA
- CO- CONDUIT FOR COMPONENT WIRING
- SPEAKER
- IIØ V SMOKE/ CO DETECTOR
- 5D 10 V SMOKE DETECTOR
- EXHAUST FAN







CEILING FAN W LIGHT



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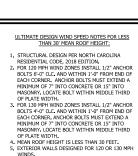
DATE: JULY 22, 2020

SCALE: 1/4" = 1'-0"


DRAWN BY: WG ENGINEERED BY:

REVIEWED BY: SECOND FLOOR ELCTRICAL PLAN


E-2




- WINDS.
  6. INSTALL 7/16" OSB SHEATHING ON ALL EXTERIOR WALLS OF ALL STORIES IN ACCORDANCE WITH SECTION R602.10.3 OF THE NCRC, 2018 EDITION.
- SECTION ROOZ-10.3 OF THE NURC, 2018 EDITION. ENERGY EFFICIENCY COMPLIANCE AND INSULATION VALUES OF THE BUILDING TO BE IN ACCORDANCE WITH CHAPTER 11 OF THE NURC,

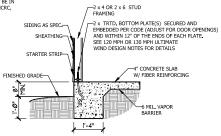


# TYPICAL SLAB DETAIL

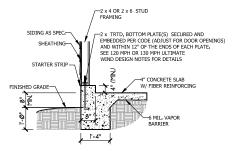


# GARAGE CURB DETAIL

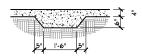

# THICKENED SLAB DETAIL

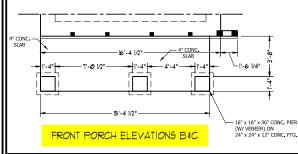

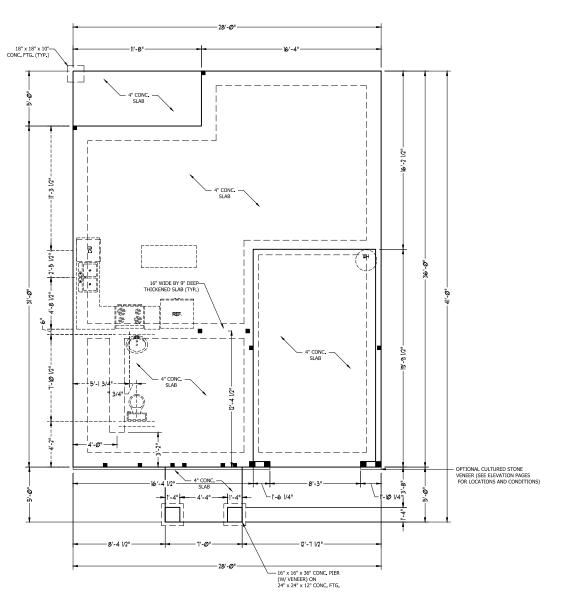



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WEAVER HOMES CAROLINA COLLECTION POPLAR DRIVE RIGHT

REV.:

SCALE: 1/4" = 1'-0"

DRAWN BY: WG ENGINEERED BY-

REVIEWED BY: MONO SLAB FOUNDATION

PLAN

MASONRY STEM WALL SPECIFICATIONS						
WALL HEIGHT (FEET)	MASONRY WALL TYPE					
	8" CMU	4" BRICK AND 4" CMU	4" BRICK AND 8" CMU	12" CMU		
2' OR LESS	UNGROUTED	GROUT SOLID	UNGROUTED	UNGROUTED		
3"	UNGROUTED	GROUT SOLID	UNGROUTED	UNGROUTED		
4"	GROUT SOLID	GROUT SOLID w/ #4 REBAR @ 48" O.C.	GROUT SOLID	GROUT SOLID w/ #4 REBAR @ 64" O.C.		
5'	GROUT SOLID w/ #4 REBAR @ 36" O.C.	N/A	GROUT SOLID w/ #4 REBAR @ 36" O.C.	GROUT SOLID w/ #4 REBAR @ 64" O.C.		
6'	GROUT SOLID w/ #4 REBAR @ 24" O.C.	N/A	GROUT SOLID w/ #4 REBAR @ 24" O.C.	GROUT SOLID w/ #4 REBAR @ 64" O.C.		
7' OR MORE	ENGINEERED BASED ON SITE CONDITIONS					

5. MINIMUM 24" LAP SPLICE LENGTH.

NCRC ARE ALLOWARLE

1. TABLE ABOVE APPLIES TO HOUSE FOUNDATION ONLY, TABLE DOES NOT APPLY TO GARAGE FOUNDATION NOT COMMON TO HOUSE.


2. TIE MULTIPLE WYTHES TOGETHER WITH LADDER WIRE @ 16" O.C. VERTICALLY. WALL HOT. IS MEASURED FROM TOP OF FOOTING TO TOP OF WALL.
 PREP SLAB PER R506.2.1 AND R505.2.2 BASE AND EXCEPTION OF THE 2018 NCRC


BACKFILL OF CLEAN #57/ #67 WASHED STONE IS PERMITTED.
 BACKFILL OF WELL DRAINED SAND-GRAVEL MIXTURE SOILS (45 PSF/FT BELOW)

- ULTIMATE DESIGN WIND SPEED NOTES FOR LESS THAN 30' MEAN ROOF HEIGHT: 1 STRUCTURAL DESIGN PER NORTH CAROLINA
- STRUCTURAL DESIGN PER NORTH CAROLINA RESIDENTIAL CODE, 2018 EDITION.
   FOR 120 MPH WIND ZONES INSTALL 1/2" ANCHOR BOLTS 6"0" OC. AND WITHIN 11" FROM END OF EACH CORNER. ANCHOR BOLTS MUST EXTEND A MINIMUM OF "INTO CONCRETE OR 15" INTO MASONRY. LOCATE BOLT WITHIN MIDDLE THIRD OF PIATE WITH OF PLATE WIDTH.
- OF PLATE WILDTH.

  3. FOR 130 MPH WIND ZONES INSTALL 1/2" ANCHOR
  BOLTS 4"-0" O.C. AND WITHIN 1"-0" FROM END OF
  EACH CORNER, ANCHOR BOLTS MUST EXTEND A
  MINIMUM OF 7" INTO CONCRETE OR 1.5" INTO MASONRY, LOCATE BOLT WITHIN MIDDLE THIRD OF PLATE WIDTH.

  4. MEAN ROOF HEIGHT IS LESS THAN 30 FEET.
- 5. EXTERIOR WALLS DESIGNED FOR 120 OR 130 MPH
- WINDS.
  6. INSTALL 7/16" OSB SHEATHING ON ALL EXTERIOR WALLS OF ALL STORIES IN ACCORDANCE WITH SECTION R602.10.3 OF THE NCRC, 2018 EDITION. 7. ENERGY EFFICIENCY COMPLIANCE AND INSULATION VALUES OF THE BUILDING TO BE IN
- ACCORDANCE WITH CHAPTER 11 OF THE NCRC, 2018 EDITION.

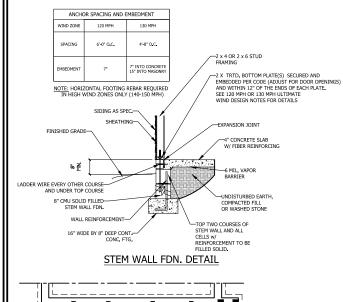

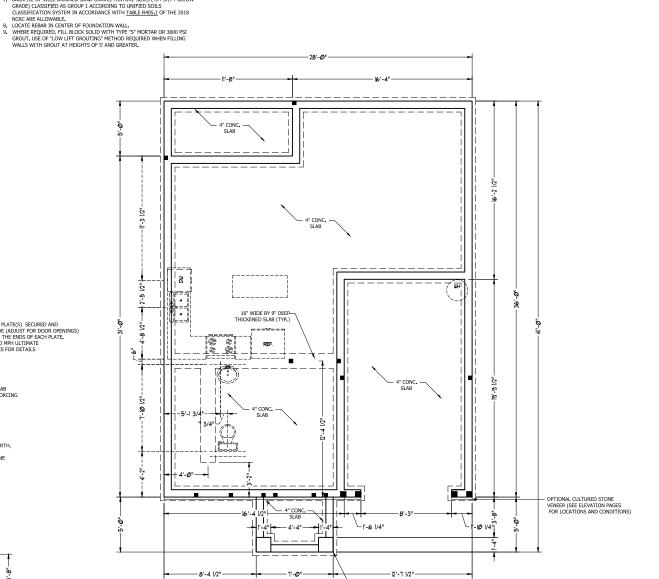

- 16" x 16" x 36" CONC. PIER (W/ VENEER) ON 24" x 24" x 12" CONC. FTG.



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REV -

SCALE: 1/4" = 1'-0"

DRAWN BY: WG

ENGINEERED BY-REVIEWED BY:

STEMWALL SLAB

FOUNDATION PLAN

S-1

-15'-4 1/2"

FRONT PORCH ELEVATIONS B&C

16" x 16" x 36" CONC. PIER (W/ VENEER) ON

24" x 24" x 12" CONC. FTG.

4" CONC. SLAB

- 1. ALL FRAMING LUMBER TO BE #2 SPF (UNO). ALL TREATED

- 1. ALL HAMING LUMBER I O GE #2 SPF (UNIV.), ALL INJUSTICE LUMBER TO BE #2 SPF (UNIV.)
  2. INSTALL AN EXTRA OR DOUBLE JOIST UNDER WALLS PARALLEL TO FLOOR JOISTS.
  3. SQUARES REPRESENT POINT LOADS WHICH REQUIRE SOLID
- 3. SQUARES REFRESENT POINT LOADS WHICH REQUIRE SOLI BLOCKING TO GIRDER OR FOUNDATION.
  4. SHADED PIERS TO BE FILLED SOLID.
  5. INSTALL LADDER WIRE @ 16" O.C. TO SECURE MULTIPLE WYTHE FOUNDATION WALLS TOGETHER.


# ULTIMATE DESIGN WIND SPEED NOTES FOR LESS THAN 30' MEAN ROOF HEIGHT:


- STRUCTURAL DESIGN PER NORTH CAROLINA RESIDENTIAL CODE, 2018 EDITION.
   FOR 120 MM VIMP ZONE SISTALL 1/2" ANCHOR BOLTS 6-0" O.C. AND WITHIN 1-0" FROM PNO OF EACH CORNER, ANCHOR BOLTS MUST EXTEND A MINIMUM OF 7" INTO CONCRETE OR 15" INTO MASONRY. LOCATE BOLT WITHIN MIDDLE THIRD MASONRY. LOCATE BOLT WITHIN MIDDLE THIRD
- MASONKY, LOCATE DOLT WITHIN THROTEL THRO OF PLATE WIDTH.

  3. FOR 130 MPH WIND ZONES INSTALL 1/2" ANCHOR BOLTS 4-0" O.C. AND WITHIN 1-0" FROM END OF EACH CORNER, ANCHOR BOLTS MUST EXTEND A MINIMUM OF 7" INTO CONCRETE OR 15" INTO MASONRY. LOCATE BOLT WITHIN MIDDLE THIRD
  OF PLATE WIDTH.
  4. MEAN ROOF HEIGHT IS LESS THAN 30 FEET.
- 5. EXTERIOR WALLS DESIGNED FOR 120 OR 130 MPH
- WINDS.
  6. INSTALL 7/16" OSB SHEATHING ON ALL EXTERIOR
- INSTALL 7/16" OSB SHEATHING ON ALL EXTERIOR WALLS OF ALL STORIES IN ACCOMPANCE WITH SECTION R602.10.3 OF THE NCRC, 2018 EDITION.
   ENERGY EFFCIENCY COMPLIANCE AND INSULATION VALUES OF THE BUILDING TO BE IN ACCORDANCE WITH CHAPTER 11 OF THE NCRC, 2018 EDITION.

# FOUNDATION VENTILATION CALCULATION

720 SQ, FT, OF CRAWL SPACE DIVIDED BY 1500 EQUALS 0.5 SQ, FT, OF NET FREE AREA REQUIRED. INSTALL 6 MIL POLY TO COVER ENTIRE CRAWL SPACE, LOCATE VENTS WITHIN 3"-0" OF EACH CORNER OF THE BUILDING TO PROVIDE CROSS-VENTILATION

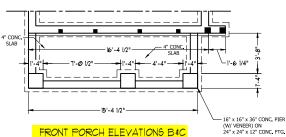

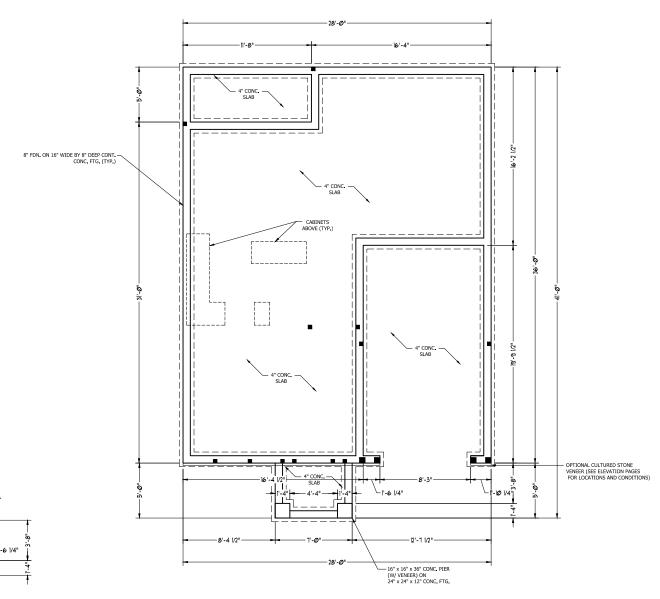



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PROFILE PLOY PLAN, F.
ARTHST CONCE.
PROPERTY Of ALAVETTED

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REV.:

SCALE: 1/4" = 1'-0" DRAWN BY: WG

ENGINEERED BY-REVIEWED BY:

CRAWL FOUNDATION PLAN

- 1. ALL FRAMING LUMBER TO BE SPF #2 (UNO). ALL TREATED LUMBER TO BE SYP #2

- (UNO.)
  2. ALL LOAD BEARING HEADERS TO BE (2) 2 x 6 (UNO).
  3. INSTALL AN EXTRA JOIST UNDER WALLS PARALLEL TO FLOOR JOISTS
  4. WINDOW AND DOOR HEADERS TO BE SUPPORTED w/ (1) JACK STUD AND (1) KING STUD EA. END (UNO.). SEE TABLE R602.7.5 FOR ADDITIONAL KING STUD REQUIREMENTS.
- REQUIREMENTS.

  SQUARES DENOTE POINT LOADS WHICH REQUIRE SOLID BLOCKING TO GIRDER OR FOUNDATION. ALL SQUARES TO BE (2), STUDS (UNC.).

  ALL 4.X & POSTS SHALL BE ANCHORED TO SLABE W/SIMPSON ABU44 POST BASES (OR EQUAL) (UNC). ALL 4.X & AND 6.X & POSTS TO BE INSTALLED WITH 70.0 IC APACTLY UPIET CONNECTORS.
- AT TOP (UNO.)

  7. FOR FIBERGLASS, ALUMINUM, OR COLUMN ENG. BY OTHERS, SECURE TO SLAB W/ (2) METAL ANGLES USING 2" CONC. SCREWS. FASTEN ANGLES TO COLUMNS W/ 1/4" THROUGH BOLTS W/ NUTS AND WASHERS. LOCATE ANGLES ON OPPOSITE SIDES OF COLUMN, THROUGH BOLTS MUST BE INSTALLED PRIOR TO SETTING

### BRACE WALL PANEL NOTES:


EXTERIOR WALLS: ALL EXTERIOR WALLS TO BE SHEALTHED WITH CS-WSP OR CS-SFB IN ACCORDANCE WITH SECTION R602.10.3 UNLESS NOTED OTHERWISE.


REQUIRED LENGTH OF BRACING: REQUIRED BRACE WALL LENGTH FOR EACH SIDE OF THE CIRCUMSCRIBED RECTANGLE ARE INTERPOLATED PER TABLE R602.10.3. METHODS CS-WSP AND CS-SFB CONTRIBUTE THIER ACTUAL LENGTH, METHOD GB CONTRIBUTES 0.5 ITS ACTUAL LENGTH, METHOD PF CONTRIBUTES 1.5 TIMES ITS ACTUAL LENGTH.

GYPSUM: ALL INTERIOR SIDES OF EXTERIOR WALLS AND BOTH SIDES OF INTERIOR WALLS TO HAVE 1/2" GYPSUM INSTALLED. WHEN NOT USING METHOD GB GYPSUM TO BE FASTENED PER TABLE R702.3.5. METHOD GB TO BE FASTENED PER TABLE R602.10.1.

HD: 800 LBS HOLD DOWN DEVICE FASTENED TO THE EDGE OF THE BRACE WALL PANEL NEAREST TO THE CORNER

METHODS: PER TABLE R602.10.1

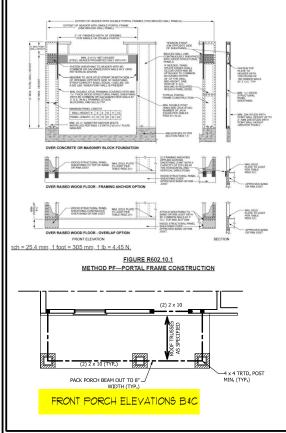

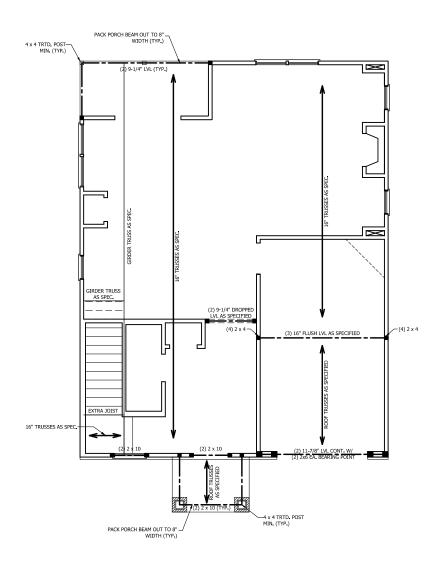



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REV -

SCALE: 1/4" = 1'-0"

DRAWN BY: WG ENGINEERED BY-

REVIEWED BY:

SECOND FLOOR


FRAMING PLAN

TABLE R602.7.5 MINIMUM NUMBER OF FULL HEIGHT STUDS AT EACH END OF HEADERS IN EXTERIOR WALLS

HEADER SPAN (FEET)	MAXIMUM STUD SPACING (INCHES) (PER TABLE R602.3(5)		
()	16	24	
UP TO 3'	1	1	
4'	2	1	
8'	3	2	
12'	5	3	
16'	6	4	

- 1. ALL FRAMING LUMBER TO BE SPF #2 (UNO). ALL TREATED LUMBER TO BE SYP
- 2. ALL LOAD BEARING HEADERS TO BE (2) 2 x 6 (UNO).
- 3. WINDOW AND DOOR HEADERS TO BE SUPPORTED w/ (1) JACK STUD AND (1) KING STUD EA. END (UNO.). SEE TABLE R602.7.5 FOR ADDITIONAL KING STUD REQUIREMENTS.
- 4. SQUARES DENOTE POINT LOADS WHICH REQUIRE SOLID BLOCKING TO GIRDER OR FOUNDATION. ALL SQUARES TO BE (2) STUDS (UNO.)

DSP - DOUBLE STUD POCKET TSP - TRIPLE STUD POCKET

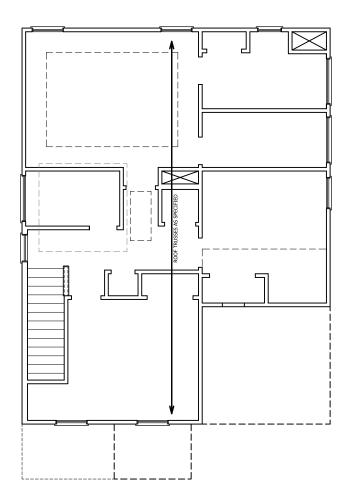



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DATE: JULY 22, 2020

SCALE: 1/4" = 1'-0"

DRAWN BY: WG

ENGINEERED BY:

REVIEWED BY:

ATTIC FLOOR FRAMING PLAN

- ALL FRAMING LUMBER TO BE #2 SPF (UNO).
   HIP SPLICES ARE TO BE SPACED A MIN. OF 8'-0".
  FASTEN MEMBERS WITH THREE ROWS OF 12d
  MALE #4" OF CTVD.)
- NAILS @ 16" O.C. (TYP.)

  3. STICK FRAME OVER-FRAMED ROOF SECTIONS W/
  2 x 8 RIDGES, 2 x 6 RAFTERS @ 16" O.C. AND
  FLAT 2 x 10 VALLEYS OR USE VALLEY TRUSSES.
- 4. FASTEN FLAT VALLEYS TO RAFTERS ON TRUSSES WITH SIMPSON H2.5A HURRICANE TIES 


  ⊕ 32\*\*
  O.C. MAX. PASS HURRICANE TIES THROUGH NOTCH IN ROOF SHEATHING. EACH RAFTER IS TO BE FASTENED TO THE FLAT VALLEY WITH A MIN. OF (6) 12d TOE NAILEY
- S. REFER TO SECTION R802.11 OF THE 2018 NCRC FOR REQUIRED UPLIFT RESISTANCE AT RAFTERS AND TRINSSES

# ATTIC VENT CALCULATION:

1218 SQ. FT. OF ATTIC DIVIDED BY 150 REQUIRES 8.1 SQ. FT. OF NET FREE VENTILATING AREA (MIN.).

# ATTIC VENT CALCULATION:

1180 SQ. FT. OF ATTIC DIVIDED BY 150 REQUIRES 7.9 SQ. FT. OF NET FREE VENTILATING AREA (MIN.).

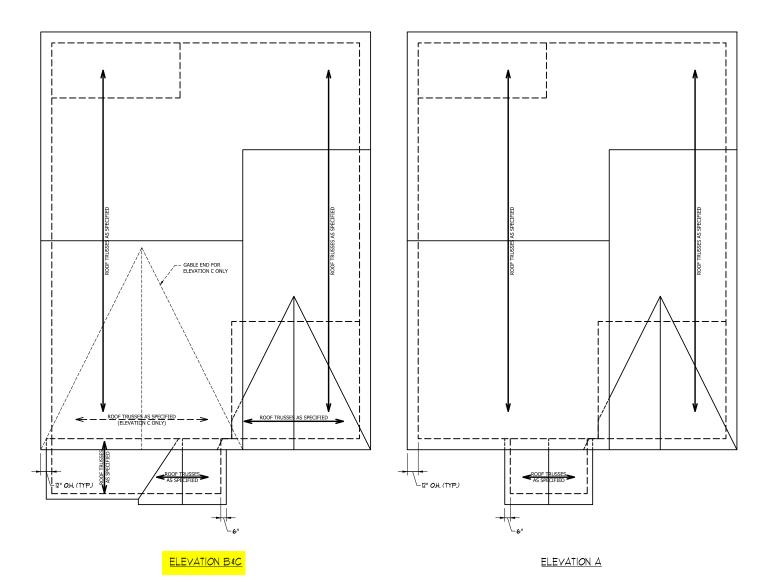



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DATE: JULY 22, 2020


REV.:

SCALE: 1/4" = 1'-0"

DRAWN BY: WG ENGINEERED BY:

REVIEWED BY:

ROOF PLANS

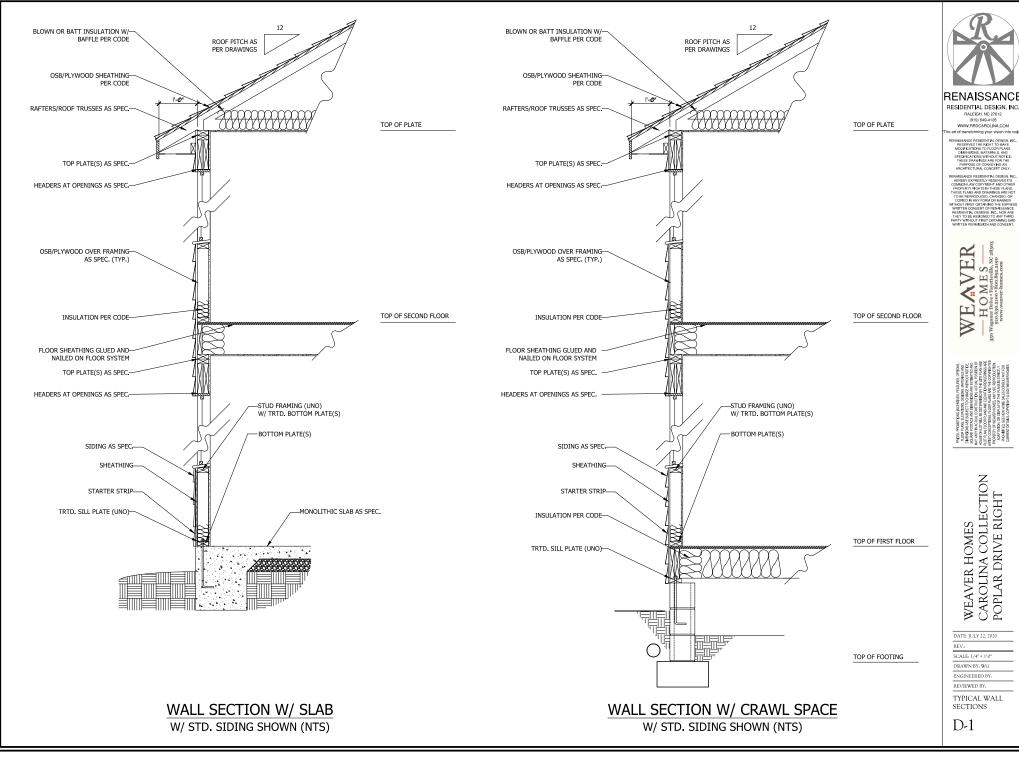



CAROLINA COLLECTION POPLAR DRIVE RIGHT

DATE: JULY 22, 2020

TYPICAL WALL