- GENERAL NOTES

 1. ALL WORK SHALL BE PERFORMED IN ACCORDANCE WITH ALL APPLICABLE NATIONAL, STATE, AND LOCAL CODES AND REGULATIONS.
- CONTRACTOR SHALL THOROUGHLY REVIEW ALL SHEETS IN PLAN SET AND VERIFY ALL DETAILS AND DIMENSIONS BEFORE BEGINNING CONSTRUCTION. ANY DISCREPANCIES SHALL BE REPORTED TO RENAISSANCE RESIDENTIAL DESIGN, INC. FOR JUSTIFICATION AND/OR CORRECTION BEFORE
 PROCEEDING WITH WORK. CONTRACTORS SHALL ASSUME RESPONSIBILITY
- FOR ERRORS THAT ARE NOT REPORTED PRIOR TO CONSTRUCTION.
 ALL DIMENSIONS SHOULD BE READ OR CALCULATED AND NEVER SCALED. CONTRACTOR SHALL ENSURE COMPATIBILITY OF THE BUILDING WITH ALL



LOT 71 THOMAS FARM TBD OVERHILLS RD SPRING LAKE, NC

PLANS DESIGNED TO THE 2018 NORTH CAROLINA STATE RESIDENTIAL BUILDING CODE.



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REV -SCALE: 1/4" = 1'-0" DRAWN BY: WG ENGINEERED BY

REVIEWED BY:

C - ELEVATIONS


A-3



HVAC:CAROLINA COMFORT HEATING & AIR


ELECTRICAL: TBD

PLUMBING: DOUBLE J PLUMBING

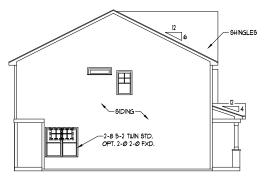


LEFT ELEVATION SCALE: 1/8" = 1'-0"

FRONT ELEVATION-C SCALE: 1/4" = 1'-@"

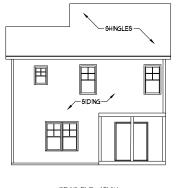



REAR ELEVATION SCALE: 1/8" = 1'-0'

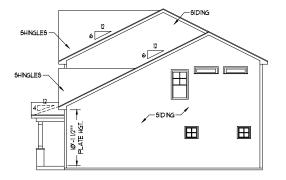

RIGHT ELEVATION SCALE: 1/8" = 1'-0'

SCALE NOTE: 18x24 PRINTS ARE TO SCALE AS NOTED. 11x17 PRINTS ARE NOT TO SCALE

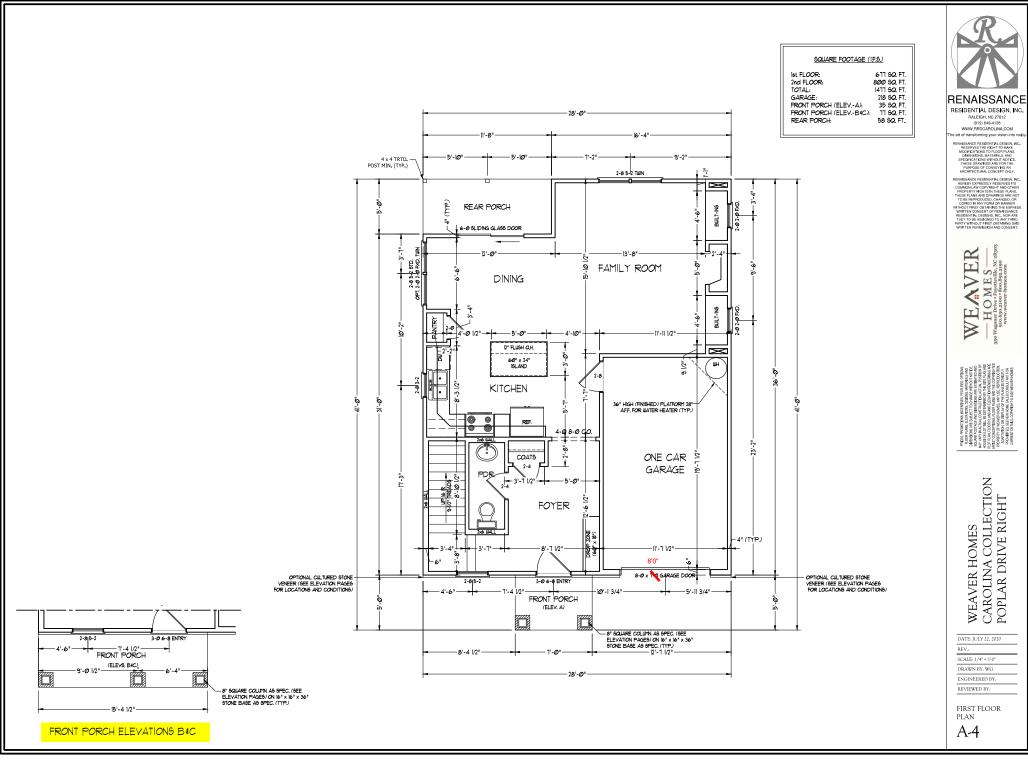

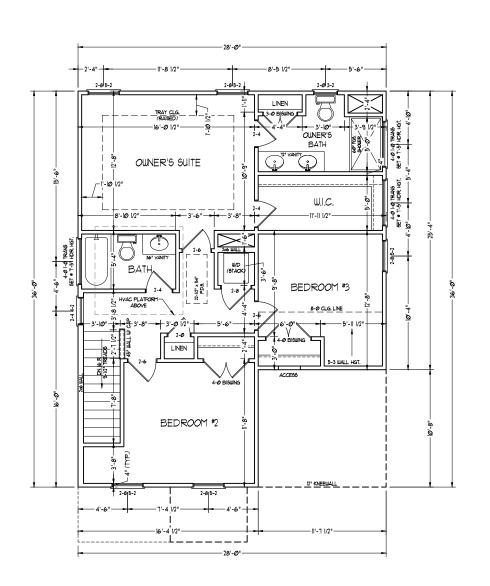



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DATE: JULY 22, 2020

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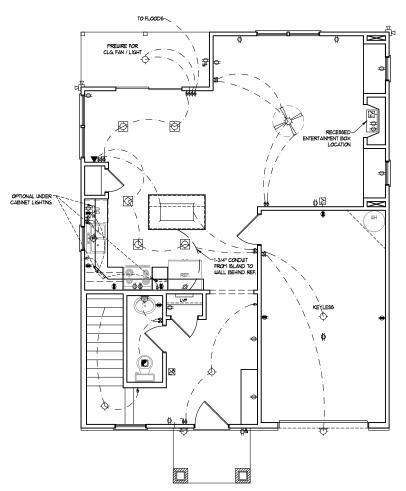
SCALE: 1/4" = 1'-0" DRAWN BY: WG

ENGINEERED BY: REVIEWED BY:

SECOND FLOOR PLAN

A-5





ELECTRICAL LAYOUT NOTES:

U BLOCK AND WIRE FOR ALL CELING FANS PER PLAN.

2) VANITY LIGHTS TO BE SET • 90" AFF. (TYP.)

3.) ADDITIONAL EXTERIOR OUTLETS REQUIRED BY CODE TO BE LOCATED BY ELECTRICIAN.

4.) PLACE SWITCHES 8" (MIN.) FROM ROUGH OPENINGS.

ELECTRICAL LEGEND

□ V OUTLET

₩ IØ V GFI OUTLET

□ V SWITCHED OUTLET

BB == 10 V BASEBOARD OUTLET

4-PLEX

GOUNTER OR FLOOR MOUNTED

COUNTER OR FLOOR MOUNTED HOV GF

WEATHERPROOF

⇒ 22Ø ∨ OUTLET

Ø IØ V DEDICATED CIRCUIT

220 V DEDICATED CIRCUIT

● SPECIAL PURPOSE (240 V, ETC.)

ALL MOUNT LIGHT

CEILING MOUNT LIGHT

-PENDANT LIGHT

RECESSED CAN LIGHT

MINI CAN LIGHT

EYEBALL LIGHT

FLUORESCENT LIGHT

UNDERCABINET LIGHT

FLOOD LIGHT

\$ SWITCH

DIMMER SWITCH

▲ TELEPHONE

△ DATA

▲ TELEPHONE AND DATA

TY- TY CONNECTION

24 TV/ DATA

CONDUIT FOR COMPONENT WIRING

110 V SMOKE/ CM DETECTOR

5D 10 V SMOKE DETECTOR

EXHAUST FAN

LOW VOLTAGE PANEL ALARM PANEL





CEILING FAN W LIGHT

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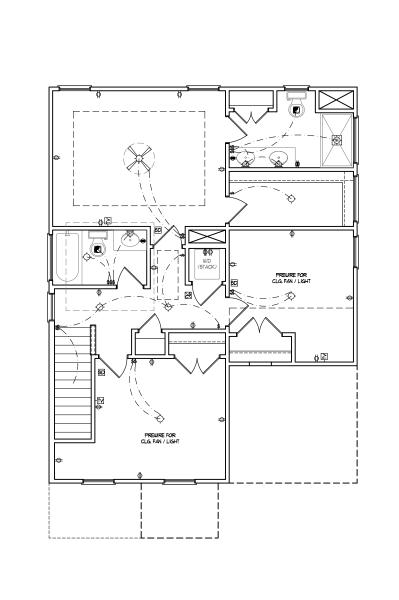
DATE: JULY 22, 2020

SCALE: 1/4" = 1'-0" DRAWN BY: WG ENGINEERED BY:

REVIEWED BY:

FIRST FLOOR ELECTRICAL PLAN

E-1



ELECTRICAL LAYOUT NOTES:

- U BLOCK AND WIRE FOR ALL CELING FANS PER PLAN.
- 2.) VANITY LIGHTS TO BE SET 90" AFF. (TYP.)
- 3.) ADDITIONAL EXTERIOR OUTLETS REQUIRED BY CODE TO BE LOCATED BY ELECTRICIAN.
- 4.) PLACE SWITCHES 8" (MIN.) FROM ROUGH OPENINGS.

ELECTRICAL LEGEND

- □ V OUTLET
- IØ V GFI OUTLET
- □ V SWITCHED OUTLET
- BB == 110 V BASEBOARD OUTLET
- 4-PLEX
- GOUNTER OR FLOOR MOUNTED
- COUNTER OR FLOOR MOUNTED 110V GF1
- # WEATHERPROOF
- ⇒ 22Ø ∨ OUTLET
- Ø IØ V DEDICATED CIRCUIT
- # 220 V DEDICATED CIRCUIT
- ●H SPECIAL PURPOSE (240 V, ETC.)
- ALL MOUNT LIGHT
- CEILING MOUNT LIGHT
- -PENDANT LIGHT
- RECESSED CAN LIGHT
- MINI CAN LIGHT
- EYEBALL LIGHT
- FLUORESCENT LIGHT
- UNDERCABINET LIGHT
- ₽ FLOOD LIGHT
- \$ SWITCH
- DIMMER SWITCH
- ▲ TELEPHONE
- △ DATA
- ▲ TELEPHONE AND DATA
- TY- TY CONNECTION
- 24 TV/ DATA
- CO- CONDUIT FOR COMPONENT WIRING
- SPEAKER
- IIØ V SMOKE/ CO DETECTOR
- 5D 10 V SMOKE DETECTOR
- EXHAUST FAN







CEILING FAN W LIGHT



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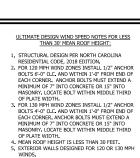
DATE: JULY 22, 2020

SCALE: 1/4" = 1'-0"

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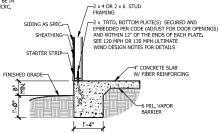
REVIEWED BY: SECOND FLOOR ELCTRICAL PLAN

E-2




5. EXTERIOR WALLS DESIGNED FOR 120 OR 130 OWN WINDS. 6. INSTALL 7/16" OSB SHEATHING ON ALL EXTERIOR WALLS OF ALL STORIES IN ACCORDANCE WITH SECTION R602.10.3 OF THE NCRC, 2018 EDITION.


SECTION ROOZ-10.3 OF THE NURC, 2018 EDITION. ENERGY EFFICIENCY COMPLIANCE AND INSULATION VALUES OF THE BUILDING TO BE IN ACCORDANCE WITH CHAPTER 11 OF THE NURC,




TYPICAL SLAB DETAIL

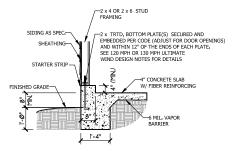


GARAGE CURB DETAIL

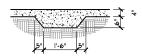

THICKENED SLAB DETAIL

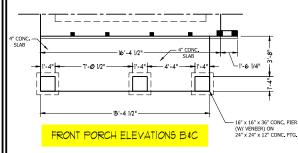

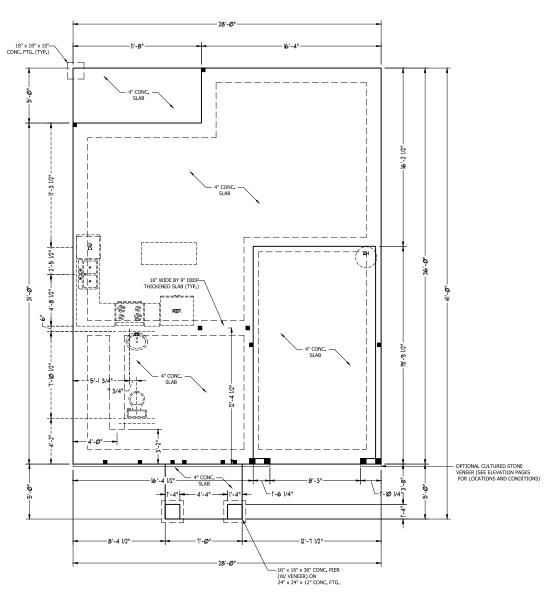



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MONO SLAB FOUNDATION PLAN

MASONRY STEM WALL SPECIFICATIONS							
WALL HEIGHT (FEET)	MASONRY WALL TYPE						
	8" CMU	4" BRICK AND 4" CMU	4" BRICK AND 8" CMU	12" CMU			
2' OR LESS	UNGROUTED	GROUT SOLID	UNGROUTED	UNGROUTED			
3"	UNGROUTED	GROUT SOLID	UNGROUTED	UNGROUTED			
4"	GROUT SOLID	GROUT SOLID w/ #4 REBAR @ 48" O.C.	GROUT SOLID	GROUT SOLID w/ #4 REBAR @ 64" O.C.			
5'	GROUT SOLID w/ #4 REBAR @ 36" O.C.	N/A	GROUT SOLID w/ #4 REBAR @ 36" O.C.	GROUT SOLID w/ #4 REBAR @ 64" O.C.			
6'	GROUT SOLID w/ #4 REBAR @ 24" O.C.	N/A	GROUT SOLID w/ #4 REBAR @ 24" O.C.	GROUT SOLID w/ #4 REBAR @ 64" O.C.			
7' OR MORE	ENGINEERED BASED ON SITE CONDITIONS						

5. MINIMUM 24" LAP SPLICE LENGTH.

NCRC ARE ALLOWARLE

1. TABLE ABOVE APPLIES TO HOUSE FOUNDATION ONLY, TABLE DOES NOT APPLY TO GARAGE FOUNDATION NOT COMMON TO HOUSE.


2. TIE MULTIPLE WYTHES TOGETHER WITH LADDER WIRE @ 16" O.C. VERTICALLY. WALL HOT. IS MEASURED FROM TOP OF FOOTING TO TOP OF WALL.
 PREP SLAB PER R506.2.1 AND R505.2.2 BASE AND EXCEPTION OF THE 2018 NCRC


 BACKFILL OF CLEAN #57/ #67 WASHED STONE IS PERMITTED.
 BACKFILL OF WELL DRAINED SAND-GRAVEL MIXTURE SOILS (45 PSF/FT BELOW) GRADE) CLASSIFIED AS GROUP 1 ACCORDING TO UNIFIED SOILS
CLASSIFICATION SYSTEM IN ACCORDANCE WITH TABLE R405.1 OF THE 2018

- ULTIMATE DESIGN WIND SPEED NOTES FOR LESS THAN 30' MEAN ROOF HEIGHT: 1 STRUCTURAL DESIGN PER NORTH CAROLINA
- STRUCTURAL DESIGN PER NORTH CAROLINA RESIDENTIAL CODE, 2018 EDITION.
 FOR 120 MPH WIND ZONES INSTALL 1/2" ANCHOR BOLTS 6"0" OC. AND WITHIN 11" FROM END OF EACH CORNER. ANCHOR BOLTS MUST EXTEND A MINIMUM OF "INTO CONCRETE OR 15" INTO MASONRY. LOCATE BOLT WITHIN MIDDLE THIRD OF PIATE WITTH OF PLATE WIDTH.
- OF PLATE WILDTH.

 3. FOR 130 MPH WIND ZONES INSTALL 1/2" ANCHOR
 BOLTS 4"-0" O.C. AND WITHIN 1"-0" FROM END OF
 EACH CORNER. ANCHOR BOLTS MUST EXTEND A
 MINIMUM OF 7" INTO CONCRETE OR 1.5" INTO MASONRY, LOCATE BOLT WITHIN MIDDLE THIRD OF PLATE WIDTH.

 4. MEAN ROOF HEIGHT IS LESS THAN 30 FEET.
- 5. EXTERIOR WALLS DESIGNED FOR 120 OR 130 MPH
- WINDS.
 6. INSTALL 7/16" OSB SHEATHING ON ALL EXTERIOR
- WALLS OF ALL STORIES IN ACCORDANCE WITH SECTION R602.10.3 OF THE NCRC, 2018 EDITION. 7. ENERGY EFFICIENCY COMPLIANCE AND INSULATION VALUES OF THE BUILDING TO BE IN ACCORDANCE WITH CHAPTER 11 OF THE NCRC, 2018 EDITION.

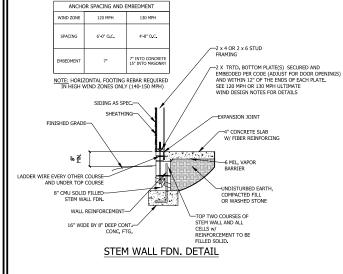

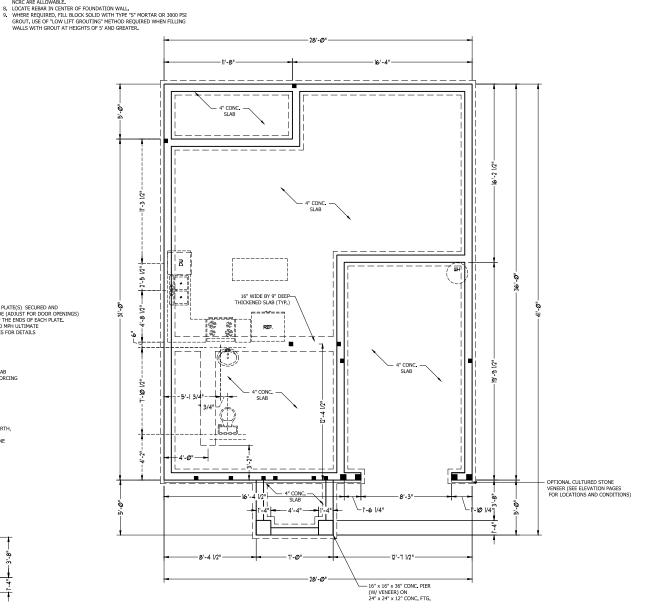



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REV -

SCALE: 1/4" = 1'-0"

DRAWN BY: WG ENGINEERED BY-

REVIEWED BY:

STEMWALL SLAB FOUNDATION

PLAN S-1

-15'-4 1/2"

FRONT PORCH ELEVATIONS B&C

16" x 16" x 36" CONC, PIER (W/ VENEER) ON

24" x 24" x 12" CONC. FTG.

4" CONC. SLAB

- 1. ALL FRAMING LUMBER TO BE #2 SPF (UNO). ALL TREATED

- 1. ALL HAMING LUMBER I O GE #2 SPF (UNIV.), ALL INJUSTICE LUMBER TO BE #2 SPF (UNIV.)
 2. INSTALL AN EXTRA OR DOUBLE JOIST UNDER WALLS PARALLEL TO FLOOR JOISTS.
 3. SQUARES REPRESENT POINT LOADS WHICH REQUIRE SOLID
- 3. SQUARES REFRESENT POINT LOADS WHICH REQUIRE SOLI BLOCKING TO GIRDER OR FOUNDATION.
 4. SHADED PIERS TO BE FILLED SOLID.
 5. INSTALL LADDER WIRE @ 16" O.C. TO SECURE MULTIPLE WYTHE FOUNDATION WALLS TOGETHER.


ULTIMATE DESIGN WIND SPEED NOTES FOR LESS THAN 30' MEAN ROOF HEIGHT:


- STRUCTURAL DESIGN PER NORTH CAROLINA RESIDENTIAL CODE, 2018 EDITION.
 FOR 120 MM VIMD ZONES INSTALL 1/2" ANCHOR BOLTS 6-0" O.C. AND WITHIN 1-0" FROM PNO OF EACH CORNER, ANCHOR BOLTS MUST EXTEND A MINIMUM OF 7" INTO CONCRETE OR 15" INTO MASONRY. LOCATE BOLT WITHIN MIDDLE THIRD MASONRY. LOCATE BOLT WITHIN MIDDLE THIRD
- MASONKY, LOCATE DOLT WITHIN THROTEL THRO OF PLATE WIDTH.

 3. FOR 130 MPH WIND ZONES INSTALL 1/2" ANCHOR BOLTS 4-0" O.C. AND WITHIN 1-0" FROM END OF EACH CORNER, ANCHOR BOLTS MUST EXTEND A MINIMUM OF 7" INTO CONCRETE OR 15" INTO MASONRY. LOCATE BOLT WITHIN MIDDLE THIRD
 OF PLATE WIDTH.
 4. MEAN ROOF HEIGHT IS LESS THAN 30 FEET.
- 5. EXTERIOR WALLS DESIGNED FOR 120 OR 130 MPH
- WINDS.
 6. INSTALL 7/16" OSB SHEATHING ON ALL EXTERIOR
- INSTALL 7/16" OSB SHEATHING ON ALL EXTERIOR WALLS OF ALL STORIES IN ACCOMPANCE WITH SECTION R602.10.3 OF THE NCRC, 2018 EDITION.
 ENERGY EFFCIENCY COMPLIANCE AND INSULATION VALUES OF THE BUILDING TO BE IN ACCORDANCE WITH CHAPTER 11 OF THE NCRC, 2018 EDITION.

FOUNDATION VENTILATION CALCULATION

720 SQ, FT, OF CRAWL SPACE DIVIDED BY 1500 EQUALS 0.5 SQ, FT, OF NET FREE AREA REQUIRED. INSTALL 6 MIL POLY TO COVER ENTIRE CRAWL SPACE, LOCATE VENTS WITHIN 3"-0" OF EACH CORNER OF THE BUILDING TO PROVIDE CROSS-VENTILATION

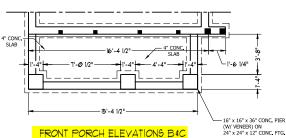

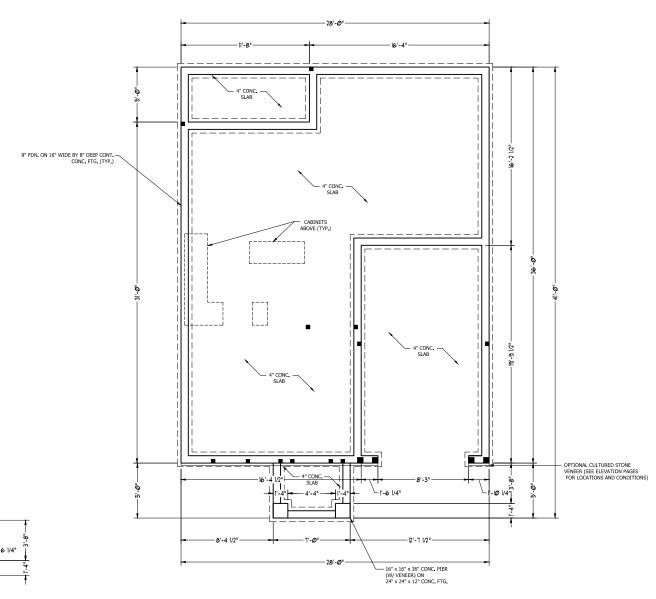



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SOLNEE P.
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ARTIST CONCE.
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SCALE: 1/4" = 1'-0" DRAWN BY: WG

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CRAWL FOUNDATION PLAN

- 1. ALL FRAMING LUMBER TO BE SPF #2 (UNO). ALL TREATED LUMBER TO BE SYP #2

- (UNO.)
 2. ALL LOAD BEARING HEADERS TO BE (2) 2 x 6 (UNO).
 3. INSTALL AN EXTRA JOIST UNDER WALLS PARALLEL TO FLOOR JOISTS
 4. WINDOW AND DOOR HEADERS TO BE SUPPORTED w/ (1) JACK STUD AND (1) KING STUD EA. END (UNO.). SEE TABLE R602.7.5 FOR ADDITIONAL KING STUD REQUIREMENTS.
- REQUIREMENTS.

 SQUARES DENOTE POINT LOADS WHICH REQUIRE SOLID BLOCKING TO GIRDER OR FOUNDATION. ALL SQUARES TO BE (2), STUDS (UNC.).

 ALL 4.X & POSTS SHALL BE ANCHORED TO SLABE W/SIMPSON ABU44 POST BASES (OR EQUAL) (UNC). ALL 4.X & AND 6.X & POSTS TO BE INSTALLED WITH 70.0 IC APACTLY UPIET CONNECTORS. AT TOP (UNO.)

 7. FOR FIBERGLASS, ALUMINUM, OR COLUMN ENG. BY OTHERS, SECURE TO SLAB W/
- (2) METAL ANGLES USING 2" CONC. SCREWS. FASTEN ANGLES TO COLUMNS W/ 1/4" THROUGH BOLTS W/ NUTS AND WASHERS. LOCATE ANGLES ON OPPOSITE SIDES OF COLUMN, THROUGH BOLTS MUST BE INSTALLED PRIOR TO SETTING

BRACE WALL PANEL NOTES:


EXTERIOR WALLS: ALL EXTERIOR WALLS TO BE SHEALTHED WITH CS-WSP OR CS-SFB IN ACCORDANCE WITH SECTION R602.10.3 UNLESS NOTED OTHERWISE.


REQUIRED LENGTH OF BRACING: REQUIRED BRACE WALL LENGTH FOR EACH SIDE OF THE CIRCUMSCRIBED RECTANGLE ARE INTERPOLATED PER TABLE R602.10.3. METHODS CS-WSP AND CS-SFB CONTRIBUTE THIER ACTUAL LENGTH, METHOD GB CONTRIBUTES 0.5 ITS ACTUAL LENGTH, METHOD PF CONTRIBUTES 1.5 TIMES ITS ACTUAL LENGTH.

GYPSUM: ALL INTERIOR SIDES OF EXTERIOR WALLS AND BOTH SIDES OF INTERIOR WALLS TO HAVE 1/2" GYPSUM INSTALLED. WHEN NOT USING METHOD GB GYPSUM TO BE FASTENED PER TABLE R702.3.5. METHOD GB TO BE FASTENED PER TABLE R602.10.1.

HD: 800 LBS HOLD DOWN DEVICE FASTENED TO THE EDGE OF THE BRACE WALL PANEL NEAREST TO THE CORNER

METHODS: PER TABLE R602.10.1

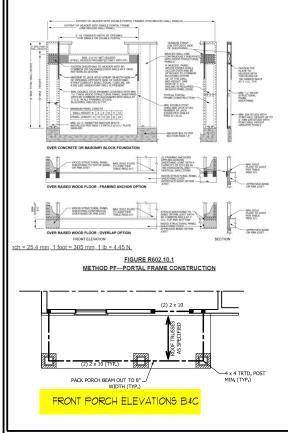

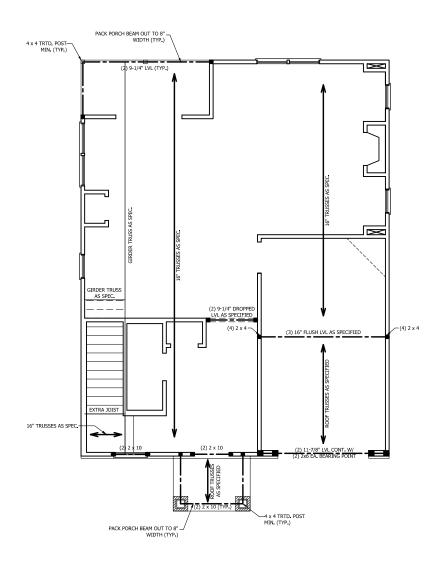



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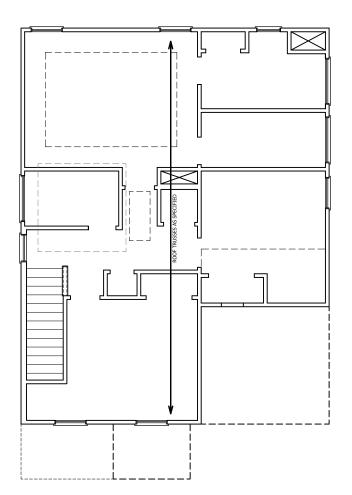
SECOND FLOOR FRAMING PLAN

TABLE R602.7.5 MINIMUM NUMBER OF FULL HEIGHT STUDS AT EACH END OF HEADERS IN EXTERIOR WALLS

HEADER SPAN (FEET)	MAXIMUM STUD SPACING (INCHES) (PER TABLE R602,3(5)				
(-==-)	16	24			
UP TO 3'	1	1			
4'	2	1			
8'	3	2			
12'	5	3			
16'	6	4			

- 1. ALL FRAMING LUMBER TO BE SPF #2 (UNO). ALL TREATED LUMBER TO BE SYP
- 2. ALL LOAD BEARING HEADERS TO BE (2) 2 x 6 (UNO).
- 3. WINDOW AND DOOR HEADERS TO BE SUPPORTED w/ (1) JACK STUD AND (1) KING STUD EA. END (UNO.). SEE TABLE R602.7.5 FOR ADDITIONAL KING STUD REQUIREMENTS.
- 4. SQUARES DENOTE POINT LOADS WHICH REQUIRE SOLID BLOCKING TO GIRDER OR FOUNDATION. ALL SQUARES TO BE (2) STUDS (UNO.)

DSP - DOUBLE STUD POCKET TSP - TRIPLE STUD POCKET





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ATTIC FLOOR FRAMING PLAN

- ALL FRAMING LUMBER TO BE #2 SPF (UNO).
 HIP SPLICES ARE TO BE SPACED A MIN. OF 8'-0".
 FASTEN MEMBERS WITH THREE ROWS OF 12d
- NAILS @ 16" O.C. (TYP.)

 3. STICK FRAME OVER-FRAMED ROOF SECTIONS W/
 2 x 8 RIDGES, 2 x 6 RAFTERS @ 16" O.C. AND
 FLAT 2 x 10 VALLEYS OR USE VALLEY TRUSSES.
- 4. FASTEN FLAT VALLEYS TO RAFTERS OR TRUSSES WITH SIMPSON H2.5A HURRICANE TIES


 ⊕ 32**
 O.C. MAX, PASS HURRICANE TIES TROUGH NOTCH IN ROOF SHEATHING. EACH RAFTER IS TO BE FASTENED TO THE FLAT VALLEY WITH A MIN. OF (6) 12d TOE NATION.
- 5. REFER TO SECTION R802.11 OF THE 2018 NCRC FOR REQUIRED UPLIFT RESISTANCE AT RAFTERS AND TRINSES

ATTIC VENT CALCULATION:

1218 SQ. FT. OF ATTIC DIVIDED BY 150 REQUIRES 8.1 SQ. FT. OF NET FREE VENTILATING AREA (MIN.).

ATTIC VENT CALCULATION:

1180 SQ. FT. OF ATTIC DIVIDED BY 150 REQUIRES 7.9 SQ. FT. OF NET FREE VENTILATING AREA (MIN.).

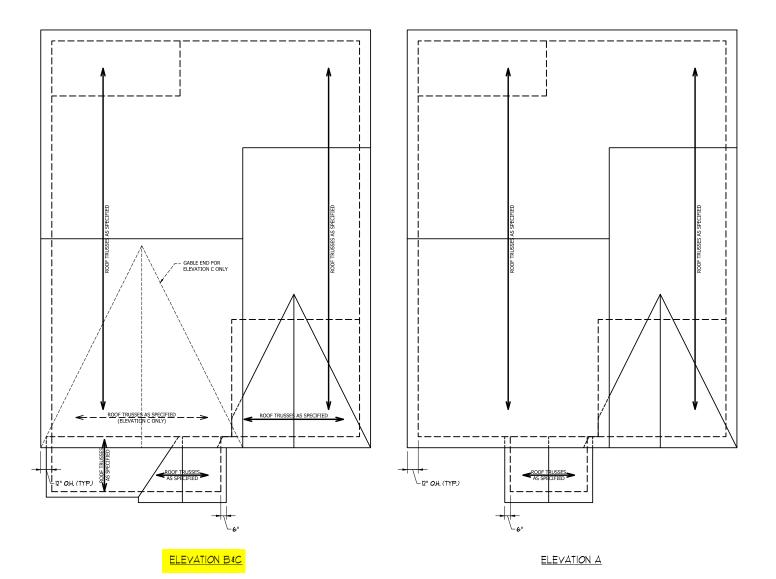



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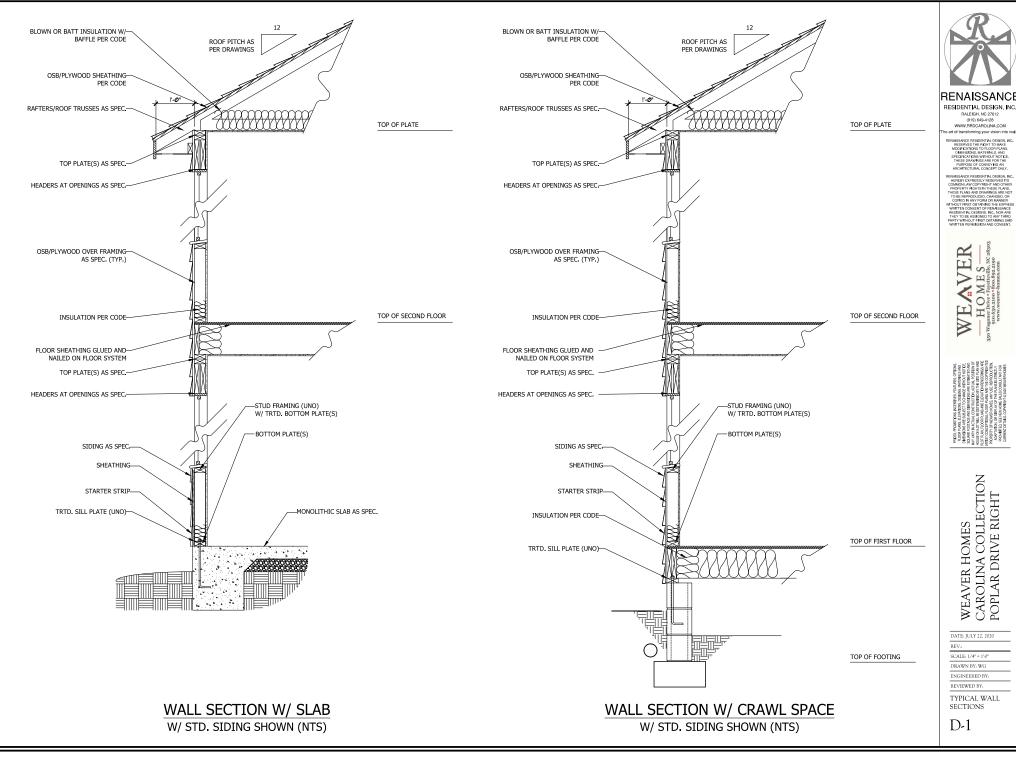
DATE: JULY 22, 2020 REV.:

SCALE: 1/4" = 1'-0"

DRAWN BY: WG ENGINEERED BY:

REVIEWED BY:

ROOF PLANS







CAROLINA COLLECTION POPLAR DRIVE RIGHT

DATE: JULY 22, 2020

TYPICAL WALL

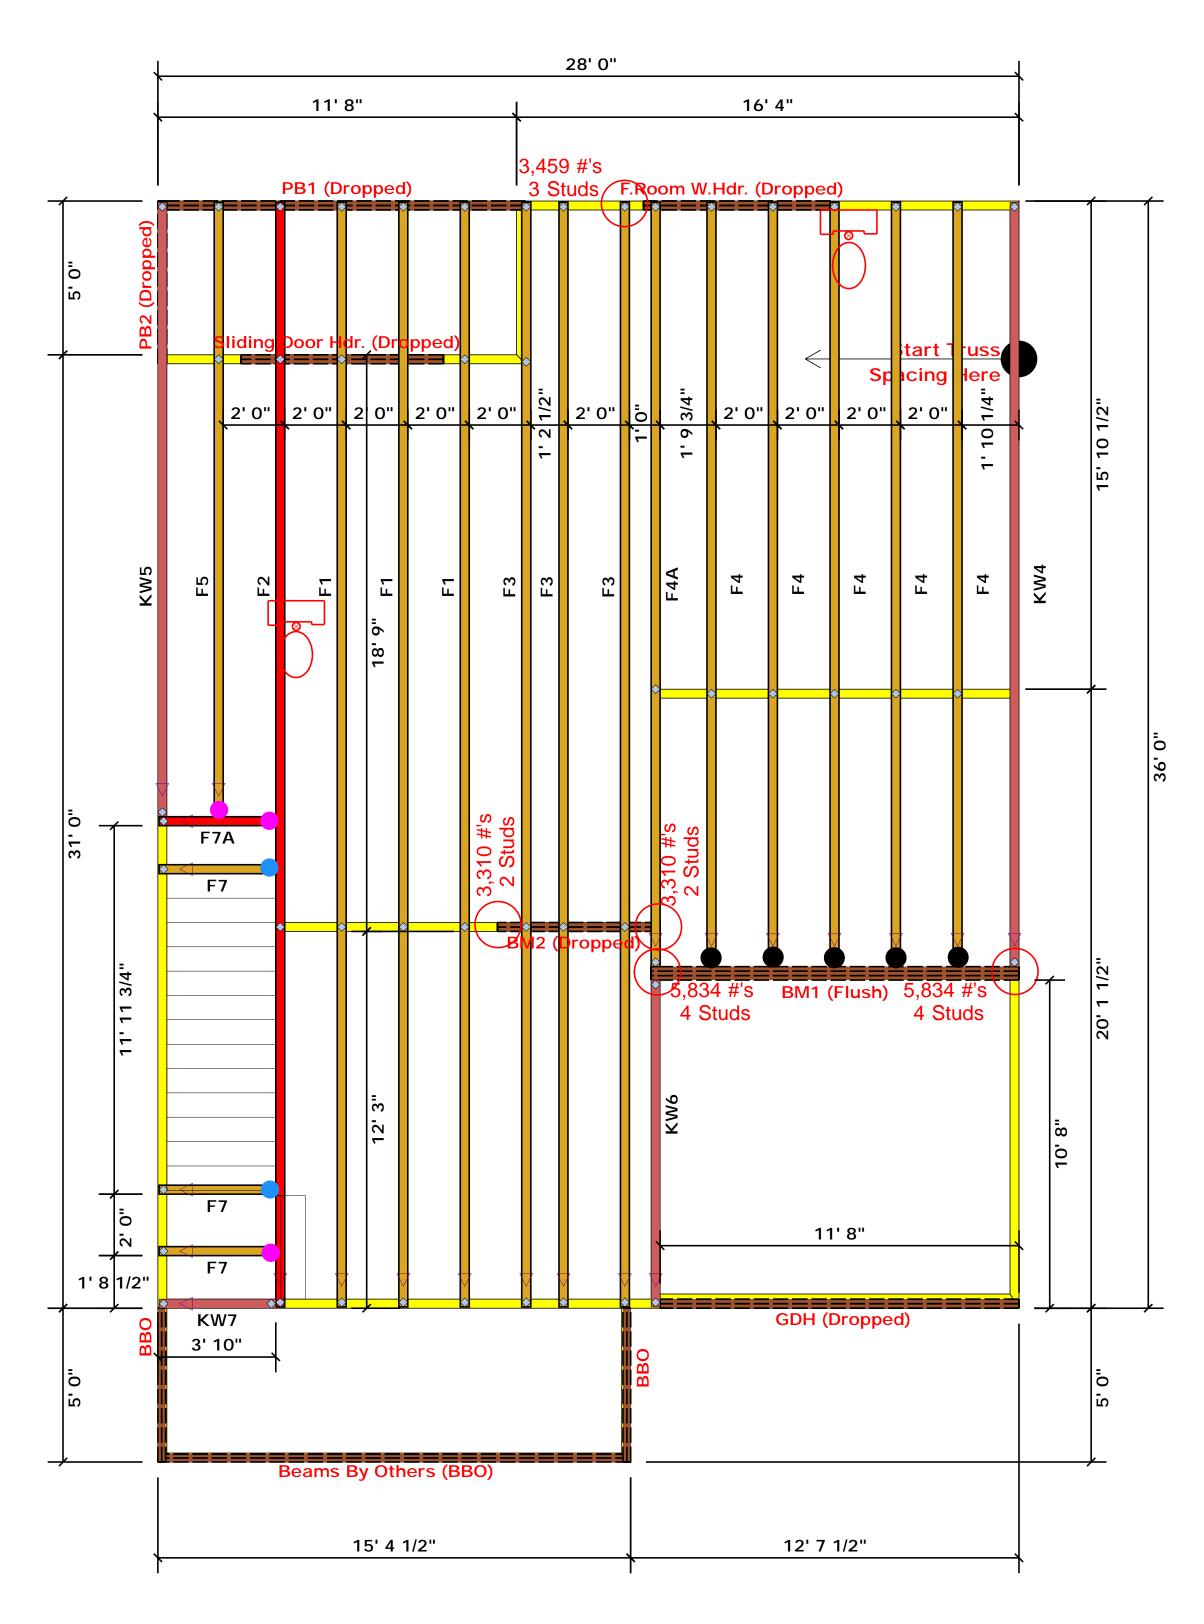

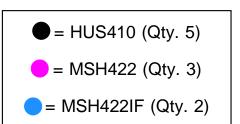

JOB#

Truss Placement Plan SCALE: NTS

▲= Denotes Left End of Truss (Reference Engineered Truss Drawing)

Products					
PlotID	Length	Product	Plies	Net Qty	
PB1 (Dropped)	12' 0"	1-3/4"x 9-1/4" LVL Kerto-S	2	2	
F.Room W.Hdr. (Dropped)	7' 0"	1-3/4"x 9-1/4" LVL Kerto-S	2	2	
Sliding Door Hdr. (Dropped)	7' 0"	1-3/4"x 9-1/4" LVL Kerto-S	2	2	
BM2 (Dropped)	6' 0"	1-3/4"x 9-1/4" LVL Kerto-S	2	2	
PB2 (Dropped)	6' 0"	1-3/4"x 9-1/4" LVL Kerto-S	2	2	
GDH (Dropped)	12' 0"	1-3/4"x 11-7/8" LVL Kerto-S	2	2	
BM1 (Flush)	12' 0"	1-3/4"x 16" LVL Kerto-S	3	3	

J0321-1856

-- Denotes Reaction Greater than 3,000 lbs. Reaction / # of Studs

Christine Shivy

All Truss Reactions are Less

than 3,000 lbs. Unless Noted Otherwise.

		_				
MANGEON FAILS (1995) May Mangeon Fails (1995) Mangeon Fails		BUILDER	Weaver Development	CITY / CO.	Spring Lake / Harnett	THIS IS A TRUSS PLACEMENT DIAGRAM ONLY. These trusses are designed as individual building components to be incorporated into the building design at the specification of the building designer. See individual design sheets for each truss design identified on the placement drawing. The building designer
		JOB NAME	Lot 71 Thomas Farm	ADDRESS	Overhills Rd.	is responsible for temporary and permanent bracing of the roof and floor system and for the overall structure. The design of the truss support structure including headers, beams, walls, and columns is the responsibility of the building designer. For general guidance regarding bracing, consult BCSI-B1 and BCSI-B3 provided with the truss delivery package
	= % = m & = m = m = m = m = m = m = m = m =	PLAN	Poplar Elev. C	MODEL	Floor	or online @ sbcindustry.com Bearing reactions less than or equal to 3000# are deemed to comply with the prescriptive Code requirements. The contractor shall refer to the attached Tables
5100 3 /650 3 10200 3	SEAL DATE	Seal Date	DATE REV.	/ /	(derived from the prescriptive Code requirements) to determine the minimum foundation size and number of wood studs required to support reactions greater than 3000# but not greater than 15000#. A registered design professional shall be retained to design the support system for any reaction that exceeds those	
	6800 4 10200 4 13600 4 8500 5 12750 5 17000 5 10200 6 15300 6	QUOTE #	Quote #	DRAWN BY	Christine Shivy	specified in the attached Tables. A registered design professional shall be retained to design the support system for all reactions that exceed 15000#. Christine Shivy
- 13	11900 7				· · · · · · · · · · · · · · · · · · ·	Signature


SALES REP.


Lenny Norris



Phone: (910) 864-8787

Fax: (910) 864-4444

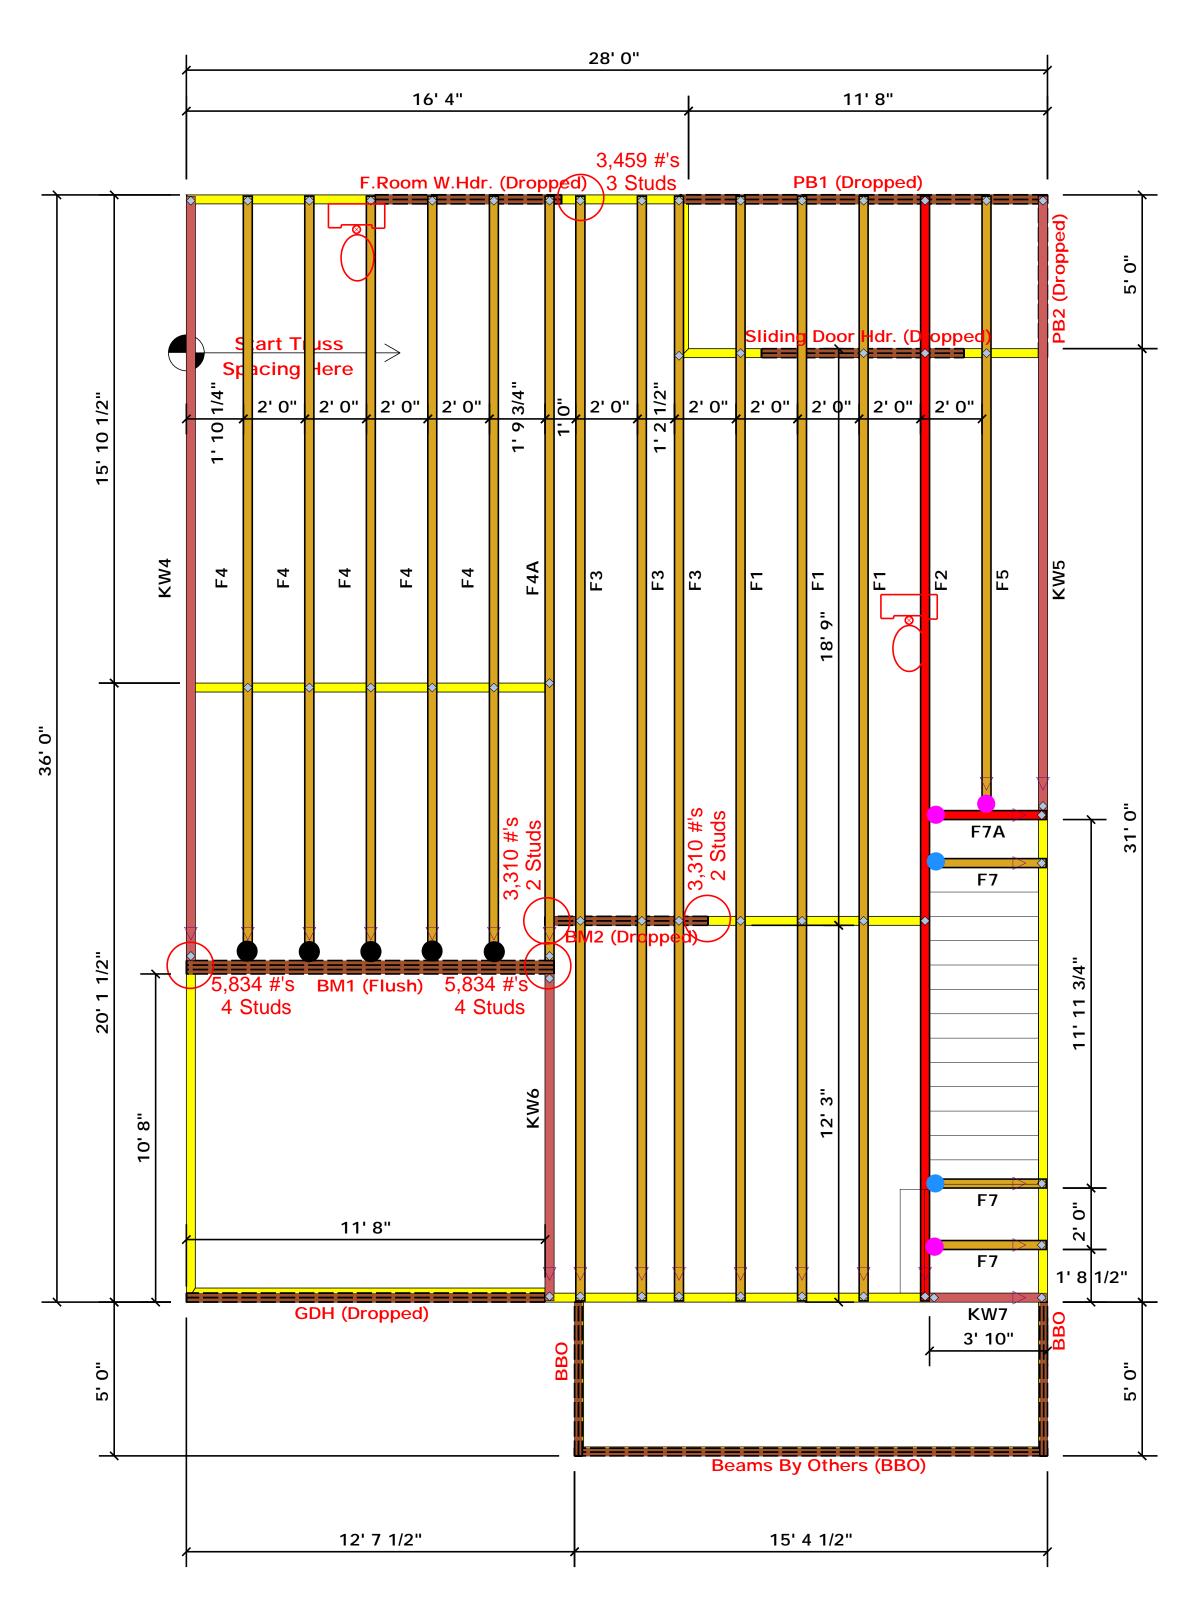

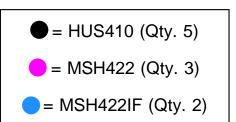

Truss Placement Plan SCALE: NTS

▲= Denotes Left End of Truss (Reference Engineered Truss Drawing)

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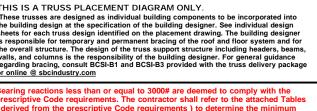
than 3,000 lbs. Unless Noted Otherwise. -- Denotes Reaction Greater than 3,000 lbs.

All Truss Reactions are Less

Reaction / # of Studs

	(045Eb	ON TABLES RS	JACK STUDS (0250) 1 (6)) UDS(0 @ (4 CM) 01	BUILDER	Weaver Developme
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	BUILDER	Weaver Development	CITY / CO.	Spring Lake / Harnett	THI The: the b
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	PLAN	Poplar Elev. C	MODEL	Floor	Bear pres
	SEAL DATE	Seal Date	DATE REV.	/ /	(der foun than be re
	QUOTE #	Quote #	DRAWN BY	Christine Shivy	spec retai
-	JOB#	J0321-1856	SALES REP.	Lenny Norris	*



Christine Shivy

Christine Shivy

ROOF & FLOOR
TRUSSES & BEAMS
Dailly Dand Industrial Dad

соттесн

Reilly Road Industrial Park Fayetteville, N.C. 28309 Phone: (910) 864-8787 Fax: (910) 864-4444

