

DOOR OPTION

SQUARE FOOTAGE

949 SQ. FT. ist FLOOR: 1351 SQ. FT. 2nd FLOOR: TOTAL: 2300 SQ. FT. FRONT PORCH: 137 SQ. FT. STD. REAR PATIO: GARAGE: 401 SQ. FT.

SQUARE FOOTAGE (OPTIONS) 999 3Q. FT FIRST FLOOR (BRICK): SECOND FLOOR (BRICK): 1405 SQ. FT. TOTAL (BRICK): 24Ø4 SQ. FT. GARAGE (BRICK): 418 SQ. FT. 53 SQ. FT. FRONT PORCH (WRAP OPTION): REAR PORCH (8-0 DEEP): 96 SQ. FT. REAR PORCH (12-0 DEEP): 144 SQ. FT. OPT. PATIO/ DECK: (8-Ø DEEP): 88 SQ. FT. 132 SQ. FT. OPT. PATIO/ DECK: (12-Ø DEEP): I-CAR GARAGE: 24Ø SQ. FT

*NOTE: ALL EXTERIOR WALLS AND ATTIC


WALLS ARE TO BE 2 x 6 @ 16" O.C. (UNO).

TO BE 2 x 4 @ 16" O.C. (UNO) AND

TO BE 2 x 4 @ 24" O.C. (UNO).

2 x 6 @ 16" O.C. (LOAD BEARING) OR

2x6 WALL

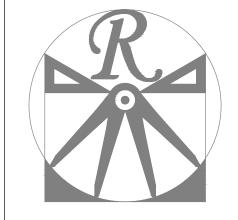

RENAISSANCE

RESIDENTIAL DESIGN, INC. RALEIGH, NC 27612 (919) 649-4128 WWW.RRDCAROLINA.COM

"The art of transforming your vision into reality." RENAISSANCE RESIDENTIAL DESIGN, INC. RESERVES THE RIGHT TO MAKE MODIFICATIONS TO FLOOR PLANS, DIMENSIONS, MATERIALS, AND SPECIFICATIONS WITHOUT NOTICE THESE DRAWINGS ARE FOR THE PURPOSE OF CONVEYING AN

ARCHITECTURAL CONCEPT ONLY.

RENAISSANCE RESIDENTIAL DESIGN, INC. HEREBY EXPRESSLY RESERVES ITS COMMON LAW COPYRIGHT AND OTHER PROPERTY RIGHTS IN THESE PLANS. THESE PLANS AND DRAWINGS ARE NOT TO BE REPRODUCED, CHANGED, OR COPIED IN ANY FORM OR MANNER WITHOUT FIRST OBTAINING THE EXPRESS WRITTEN CONSENT OF RENAISSANCE RESIDENTIAL DESIGN, INC. NOR ARE THEY TO BE ASSIGNED TO ANY THIRD PARTY WITHOUT FIRST OBTAINING SAID WRITTEN PERMISSION AND CONSENT.

j.s.Thompson ENGINEERING, INC 606 WADE AVE., SUITE 104 RALEIGH, NC 27605 PHONE: (919) 789-9919 FAX: (919) 789-9921

N.C. LICENSE NO.: C-1733



A&G RESIDENT CAMDEN

DATE: SEPTEMBER 28, 2020

REV.:

SCALE: 1/4"=1'-0" DRAWN BY: WG

ENGINEERED BY: WFB


REVIEWED BY: MGS


FIRST FLOOR PLAN

A-4

C:\Users\Wade\Documents\Projects\A&G\Camden\Camden_9-14-20.dwg, 10/2/2020 9:27:29 AM

OPTIONAL THIRD CAR GARAGE)

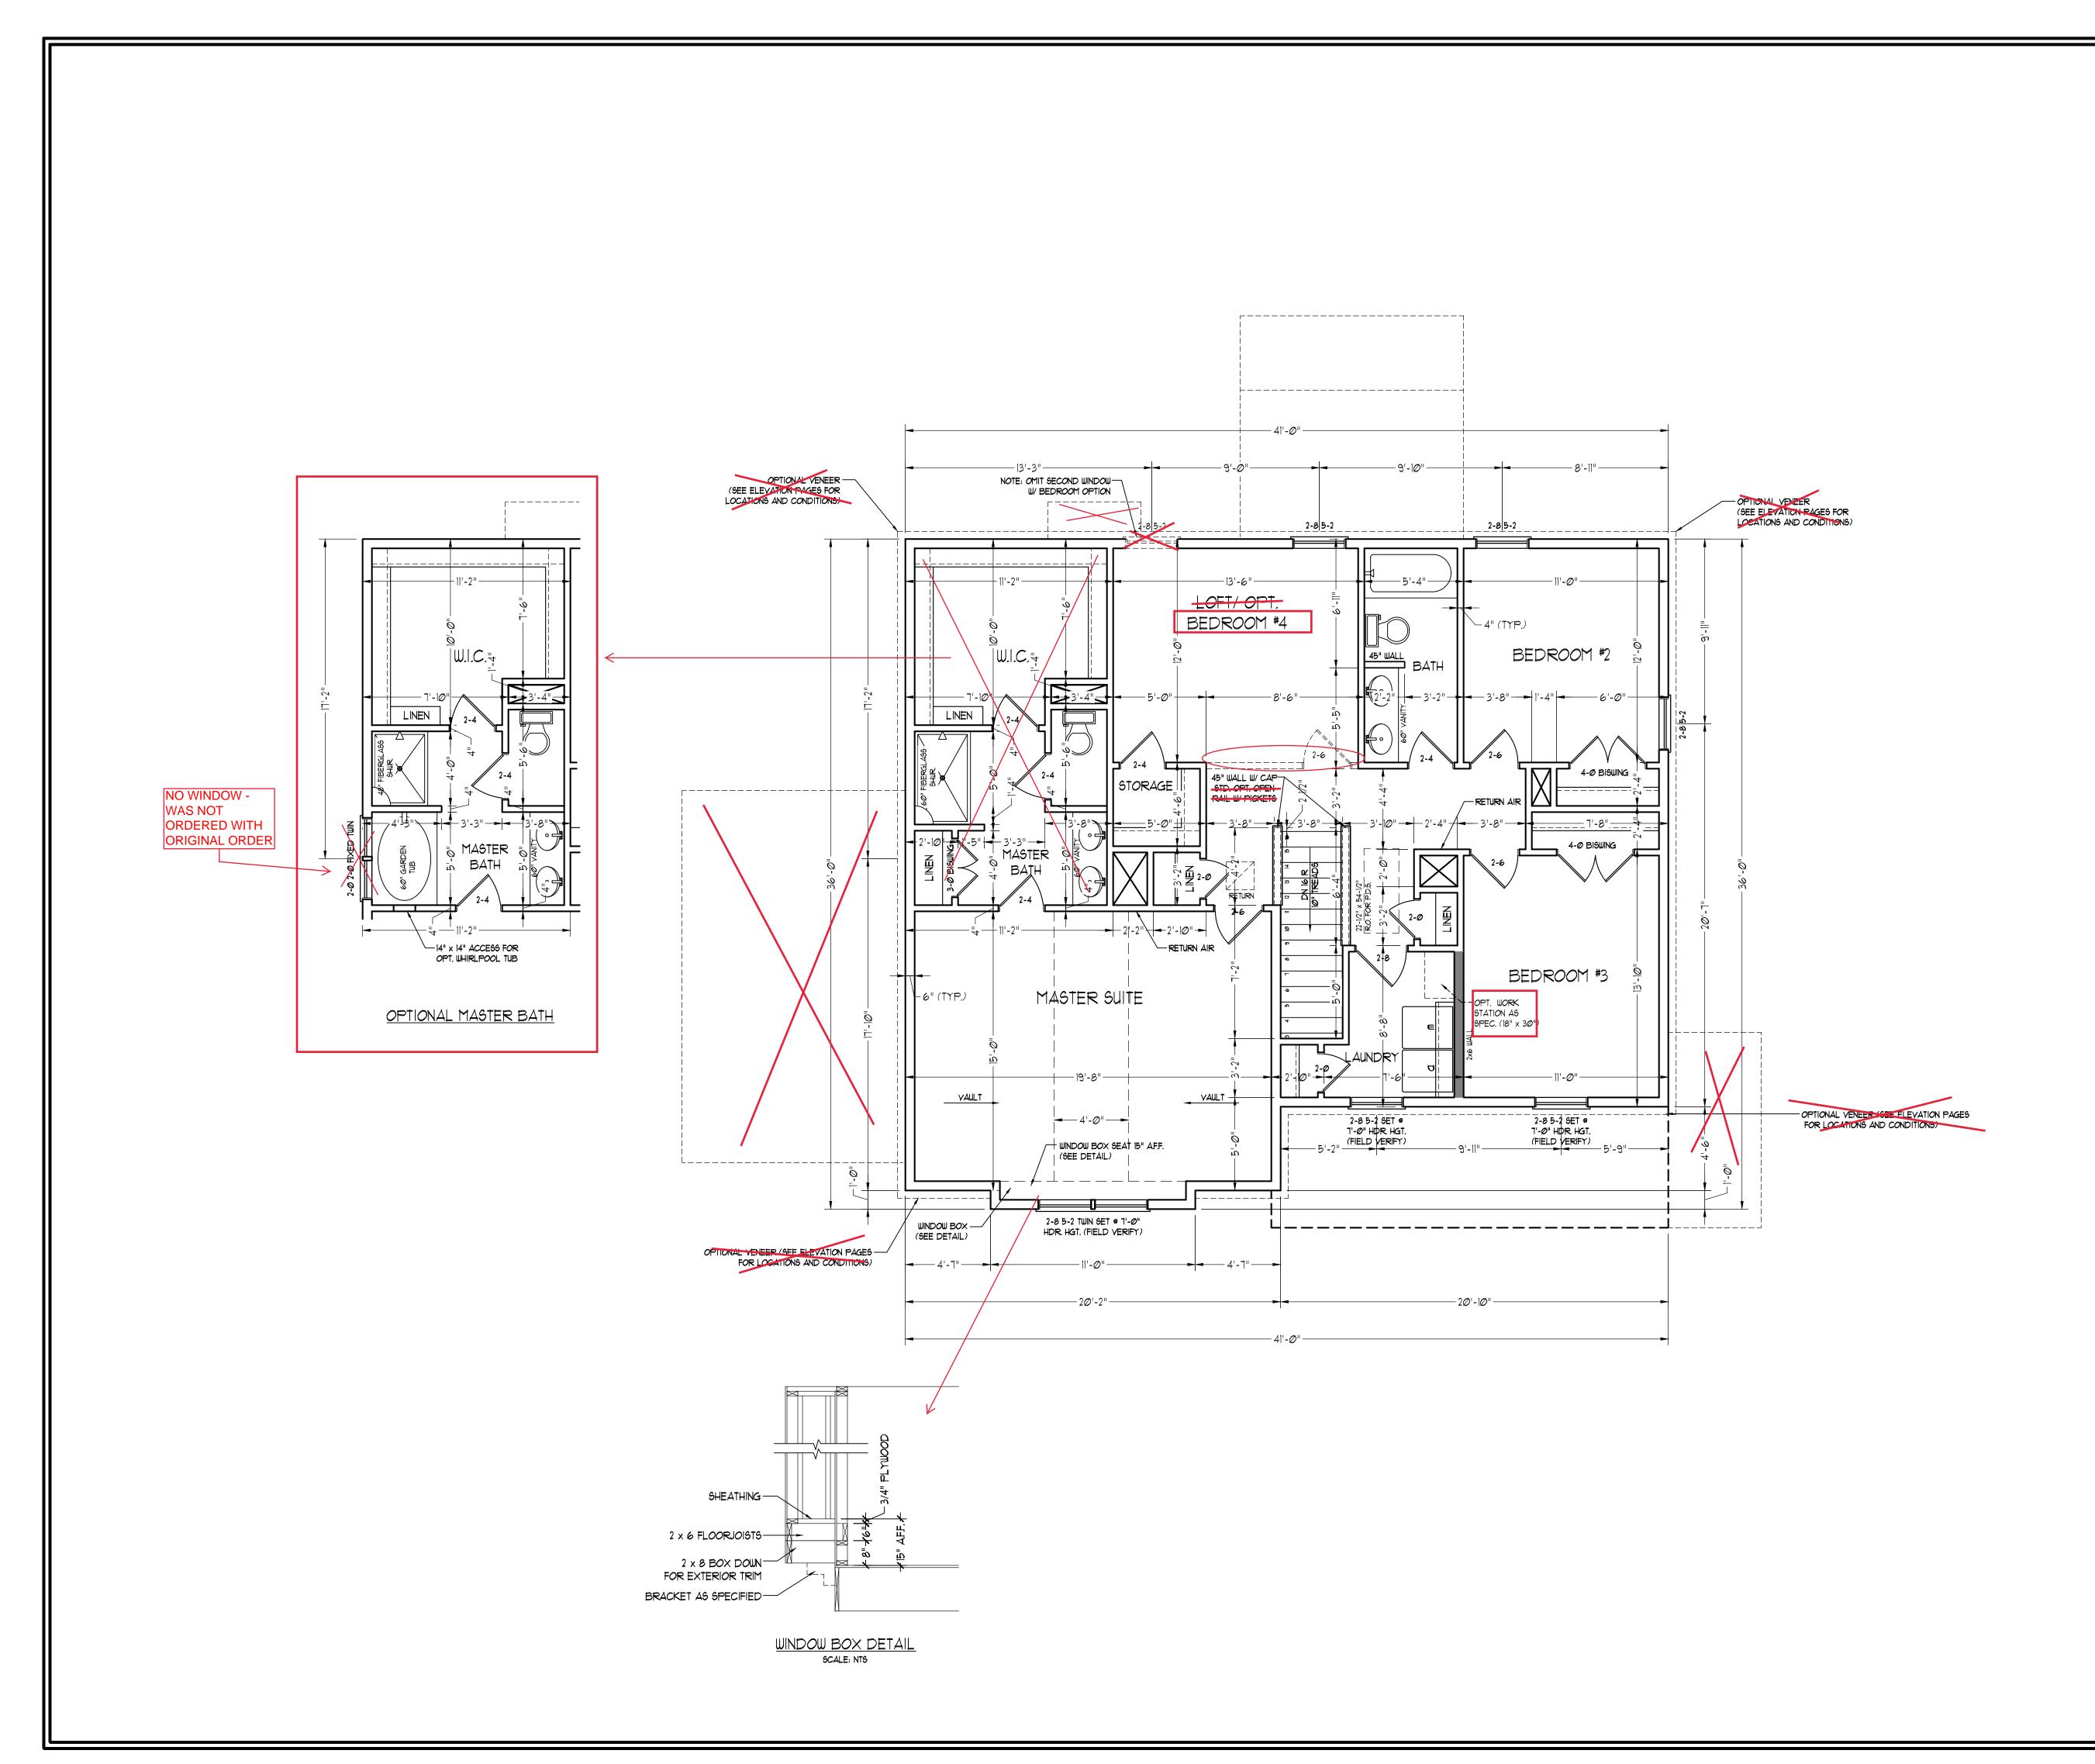

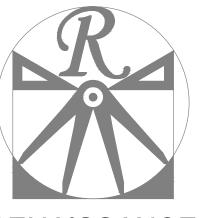

RENAISSANCE


RESIDENTIAL DESIGN, INC. RALEIGH, NC 27612 (919) 649-4128

WWW.RRDCAROLINA.COM
"The art of transforming your vision into reality."
RENAISSANCE RESIDENTIAL DESIGN, INC.

RENAISSANCE RESIDENTIAL DESIGN, INC.
RESERVES THE RIGHT TO MAKE
MODIFICATIONS TO FLOOR PLANS,
DIMENSIONS, MATERIALS, AND
SPECIFICATIONS WITHOUT NOTICE.
THESE DRAWINGS ARE FOR THE
PURPOSE OF CONVEYING AN
ARCHITECTURAL CONCEPT ONLY.

RENAISSANCE RESIDENTIAL DESIGN, INC.
HEREBY EXPRESSLY RESERVES ITS
COMMON LAW COPYRIGHT AND OTHER
PROPERTY RIGHTS IN THESE PLANS.
THESE PLANS AND DRAWINGS ARE NOT
TO BE REPRODUCED, CHANGED, OR
COPIED IN ANY FORM OR MANNER
WITHOUT FIRST OBTAINING THE EXPRESS
WRITTEN CONSENT OF RENAISSANCE
RESIDENTIAL DESIGN, INC. NOR ARE
THEY TO BE ASSIGNED TO ANY THIRD
PARTY WITHOUT FIRST OBTAINING SAID
WRITTEN PERMISSION AND CONSENT.

J.S.THOMPSON ENGINEERING, INC 606 WADE AVE., SUITE 104 RALEIGH, NC 27605 PHONE: (919) 789-9919 FAX: (919) 789-9921 N.C. LICENSE NO.: C-1733

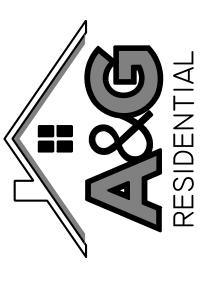

FLOOR PLANS, ELEVATIONS, DESIGNS, MATERIALS AND DIMENSIONS ARE SUBJECT TO CHANGE WITHOUT NOTICE. SUARE FOOTAGE AND DIMENSIONS ARE ESTIMATED AND MAY ARY IN ACTUAL CONSTRUCTION. ACTUAL POSITION OF HOUSE ON LOT WILL BE DETERMINED BY THE SITE PLAN AND PLOT AN. FLOOR PLANS AND ELEVATION RENDERINGS ARE ARTIST CONCEPTIONS. FLOOR PLANS ARE THE COPYRIGHTED PROPERTY OF A&G RESIDENTIAL. ANY USE, REPRODUCTION, ADAPTATION, OR DISPLAY OF THE PLANS IS STRICTLY PROHIBITED. SEE NEW HOME SALES CONSULTANT FOR CURRENT DETAILS. COPYRIGHT © 2020 A&G RESIDENTIAL

A&G RESIDENTIAL CAMDEN

DATE: SEPTEMBER 28, 2020

REV.:

SCALE: 1/4"=1'-0"


DRAWN BY: WG

ENGINEERED BY: WFB

REVIEWED BY: MGS

SECOND FLOOR PLAN

A-5

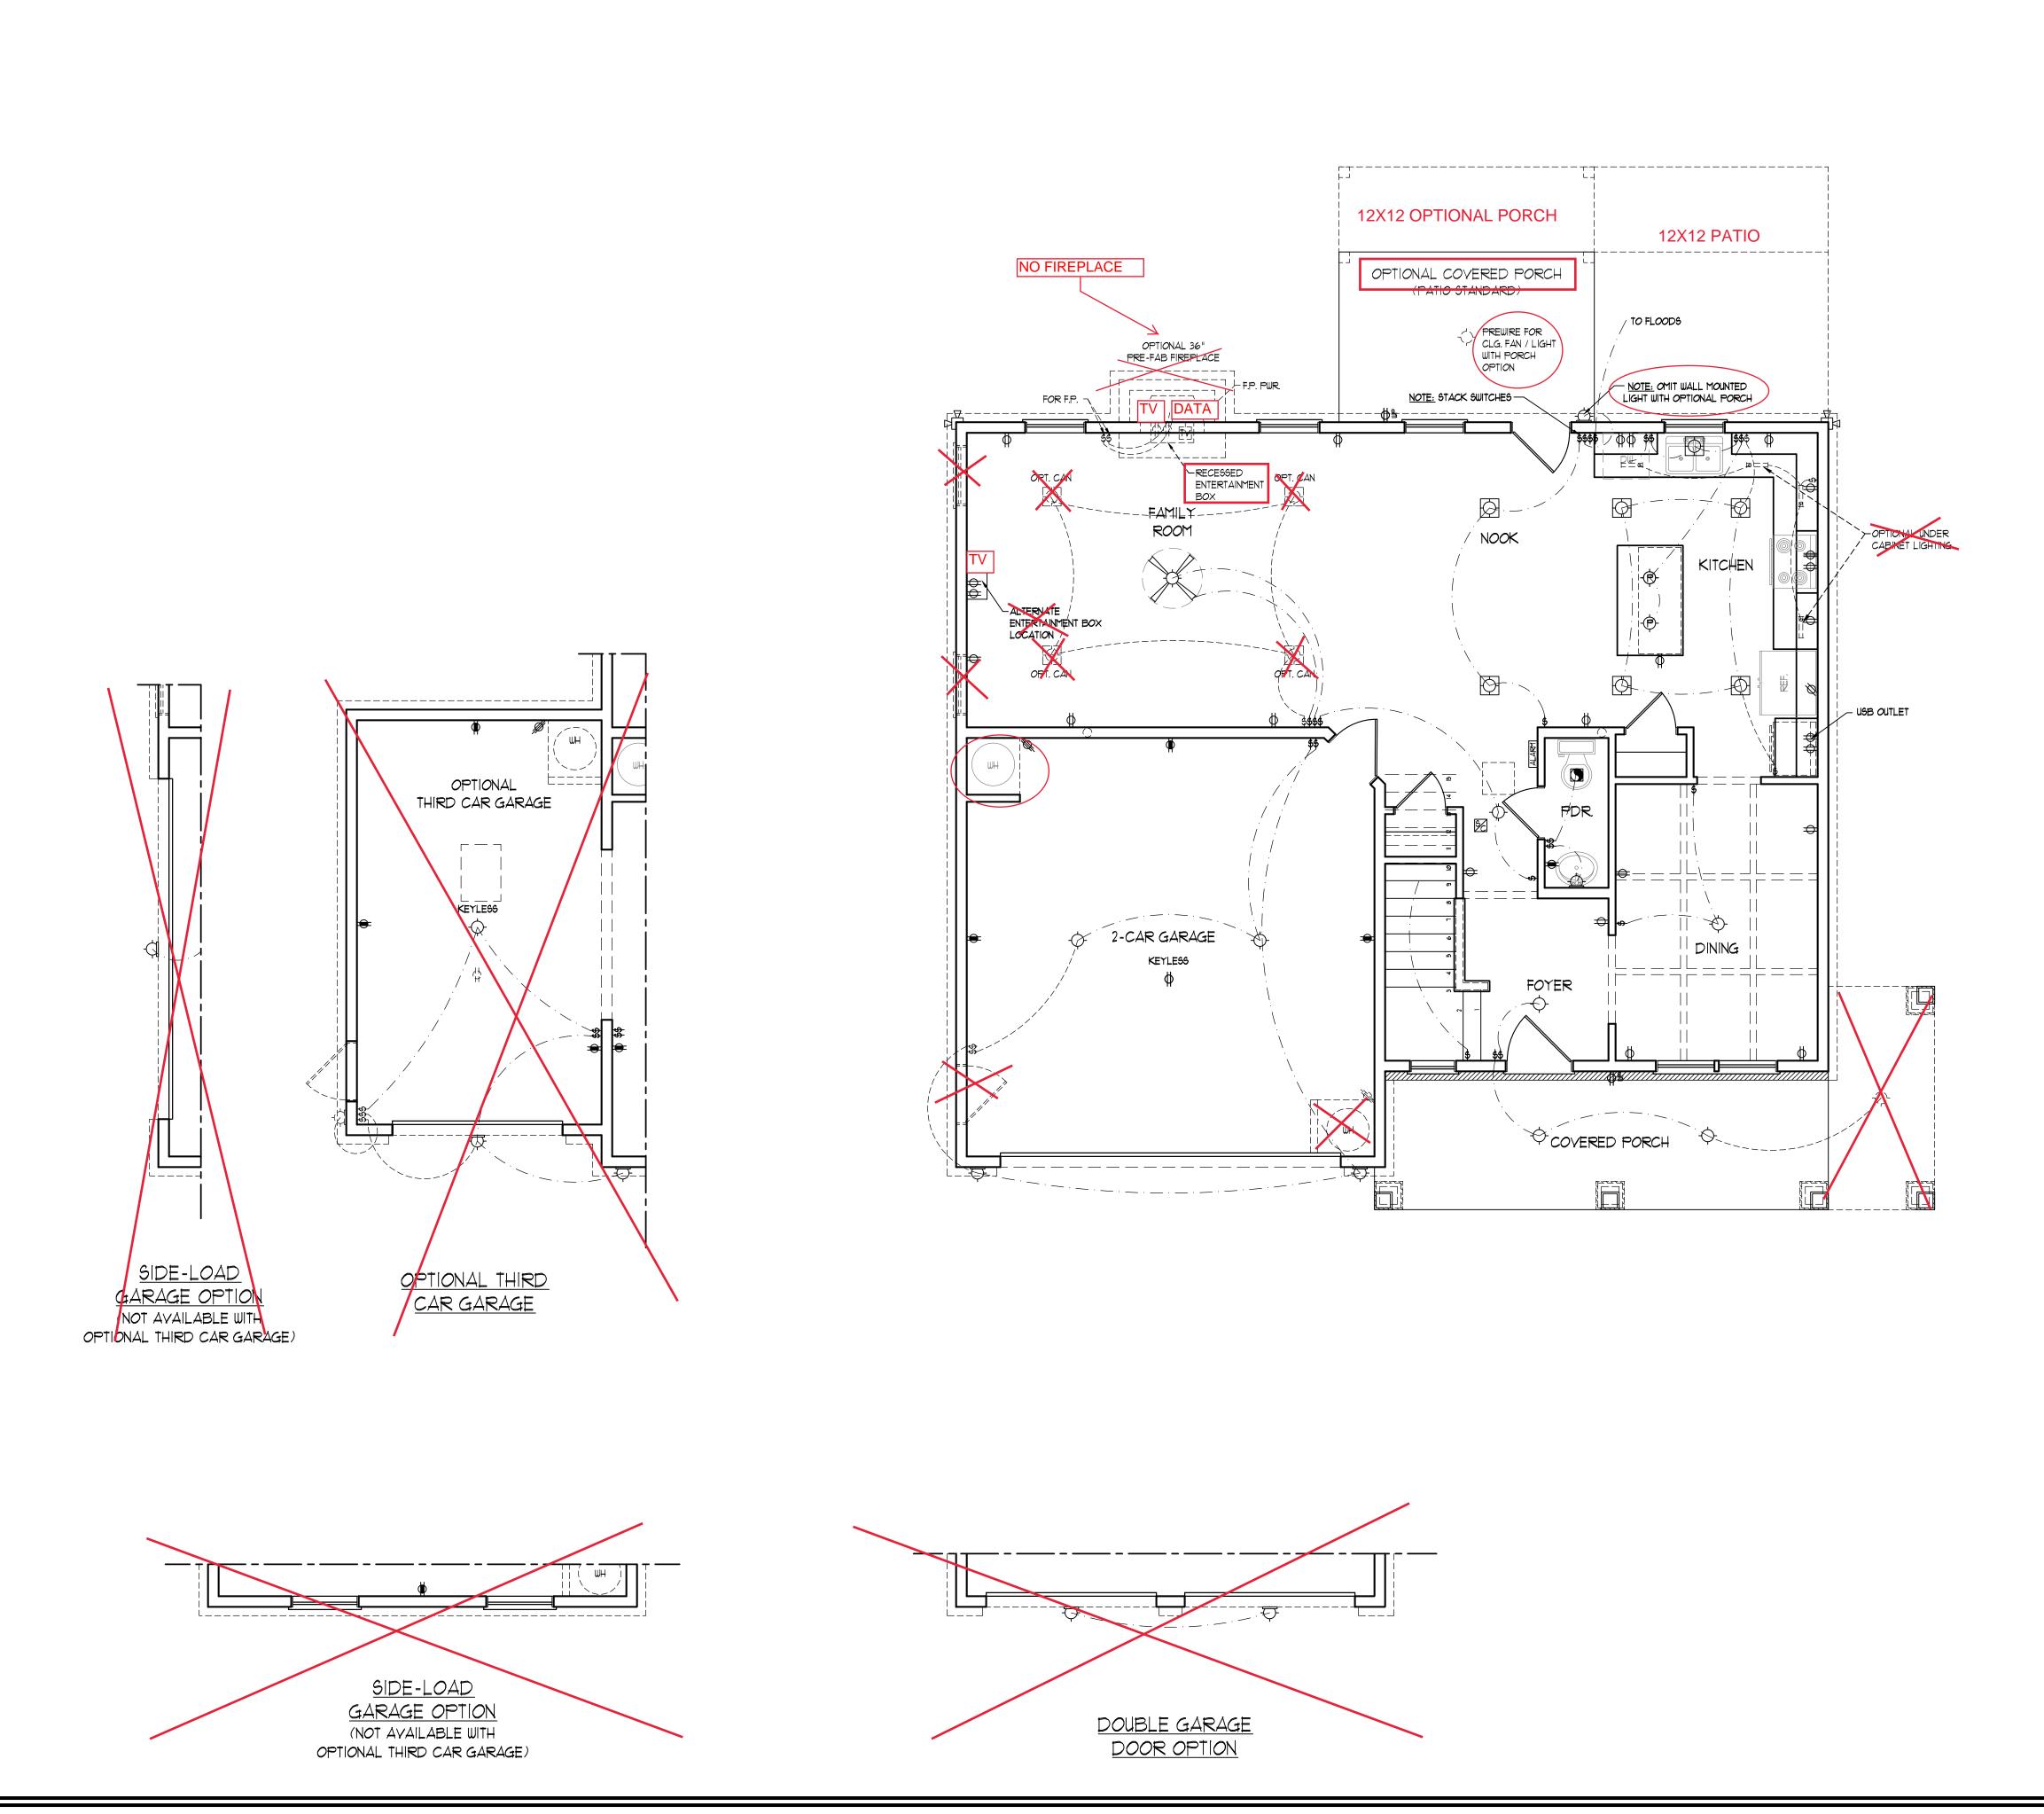



1.) BLOCK AND WIRE FOR ALL

CELING FANS PER PLAN.

2.) VANITY LIGHTS TO BE SET 90" A.F.F. (TYP.)

3.) ADDITIONAL EXTERIOR OUTLETS REQUIRED BY CODE TO BE LOCATED BY ELECTRICIAN.

4.) PLACE SWITCHES 8" (MIN.) FROM ROUGH OPENINGS.

ELECTRICAL LEGEND

 →
 I/Ø
 V
 OUTLET

 ⇒
 IIØ ∨ GFI OUTLET

⇒ 110 V SWITCHED OUTLET

BB 👄 110 V BASEBOARD OUTLET

4-PLEX

COUNTER OR FLOOR MOUNTED

COUNTER OR FLOOR MOUNTED 110V GF1

WEATHERPROOF **⇒** 22Ø ∨ OUTLET

Ø 110 V DEDICATED CIRCUIT

∅ 22∅ ∨ DEDICATED CIRCUIT

► SPECIAL PURPOSE (240 V, ETC.)

- WALL MOUNT LIGHT

-P- PENDANT LIGHT RECESSED CAN LIGHT

MINI CAN LIGHT

EYEBALL LIGHT

FLUORESCENT LIGHT

undercabinet light

FLOOD LIGHT

\$ SWITCH

\$D DIMMER SWITCH ▲ TELEPHONE

riangle data

TELEPHONE AND DATA

TV- TY CONNECTION TV/ DATA

CD- CONDUIT FOR COMPONENT WIRING


SPEAKER 110 V 9MOKE/ CM DETECTOR

SD 110 Y SMOKE DETECTOR

EXHAUST FAN

LOW YOLTAGE PANEL ALARM ALARM PANEL



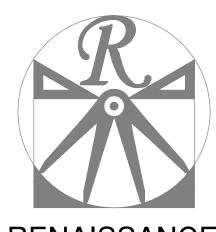

RENAISSANCE

RESIDENTIAL DESIGN, INC. RALEIGH, NC 27612 (919) 649-4128

WWW.RRDCAROLINA.COM


"The art of transforming your vision into reality." RENAISSANCE RESIDENTIAL DESIGN, INC. RESERVES THE RIGHT TO MAKE MODIFICATIONS TO FLOOR PLANS, DIMENSIONS, MATERIALS, AND SPECIFICATIONS WITHOUT NOTICE. THESE DRAWINGS ARE FOR THE PURPOSE OF CONVEYING AN

ARCHITECTURAL CONCEPT ONLY.

RENAISSANCE RESIDENTIAL DESIGN, INC. COMMON LAW COPYRIGHT AND OTHER PROPERTY RIGHTS IN THESE PLANS. THESE PLANS AND DRAWINGS ARE NOT TO BE REPRODUCED, CHANGED, OR COPIED IN ANY FORM OR MANNER WITHOUT FIRST OBTAINING THE EXPRESS WRITTEN CONSENT OF RENAISSANCE RESIDENTIAL DESIGN, INC. NOR ARE THEY TO BE ASSIGNED TO ANY THIRD PARTY WITHOUT FIRST OBTAINING SAID WRITTEN PERMISSION AND CONSENT.

J.S.THOMPSON ENGINEERING, INC 606 WADE AVE., SUITE 104 RALEIGH, NC 27605 PHONE: (919) 789-9919 FAX: (919) 789-9921

N.C. LICENSE NO.: C-1733

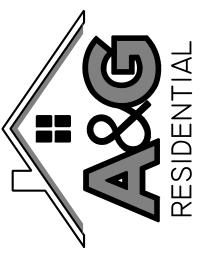

A&G RESIDENTIAL CAMDEN

DATE: SEPTEMBER 28, 2020

REV.:

SCALE: 1/4"=1'-0"


DRAWN BY: WG

ENGINEERED BY: WFB REVIEWED BY: MGS

FIRST FLOOR ELECTRICAL PLAN

E-1

 $C: \label{locuments} \label{locuments} Comden \label{locuments} A\&G \cite{Camden_9-14-20.dwg, 10/2/2020 9:27:32 AM} AM \cite{Camden_9-14-20.dwg, 10/2/2020 9:$

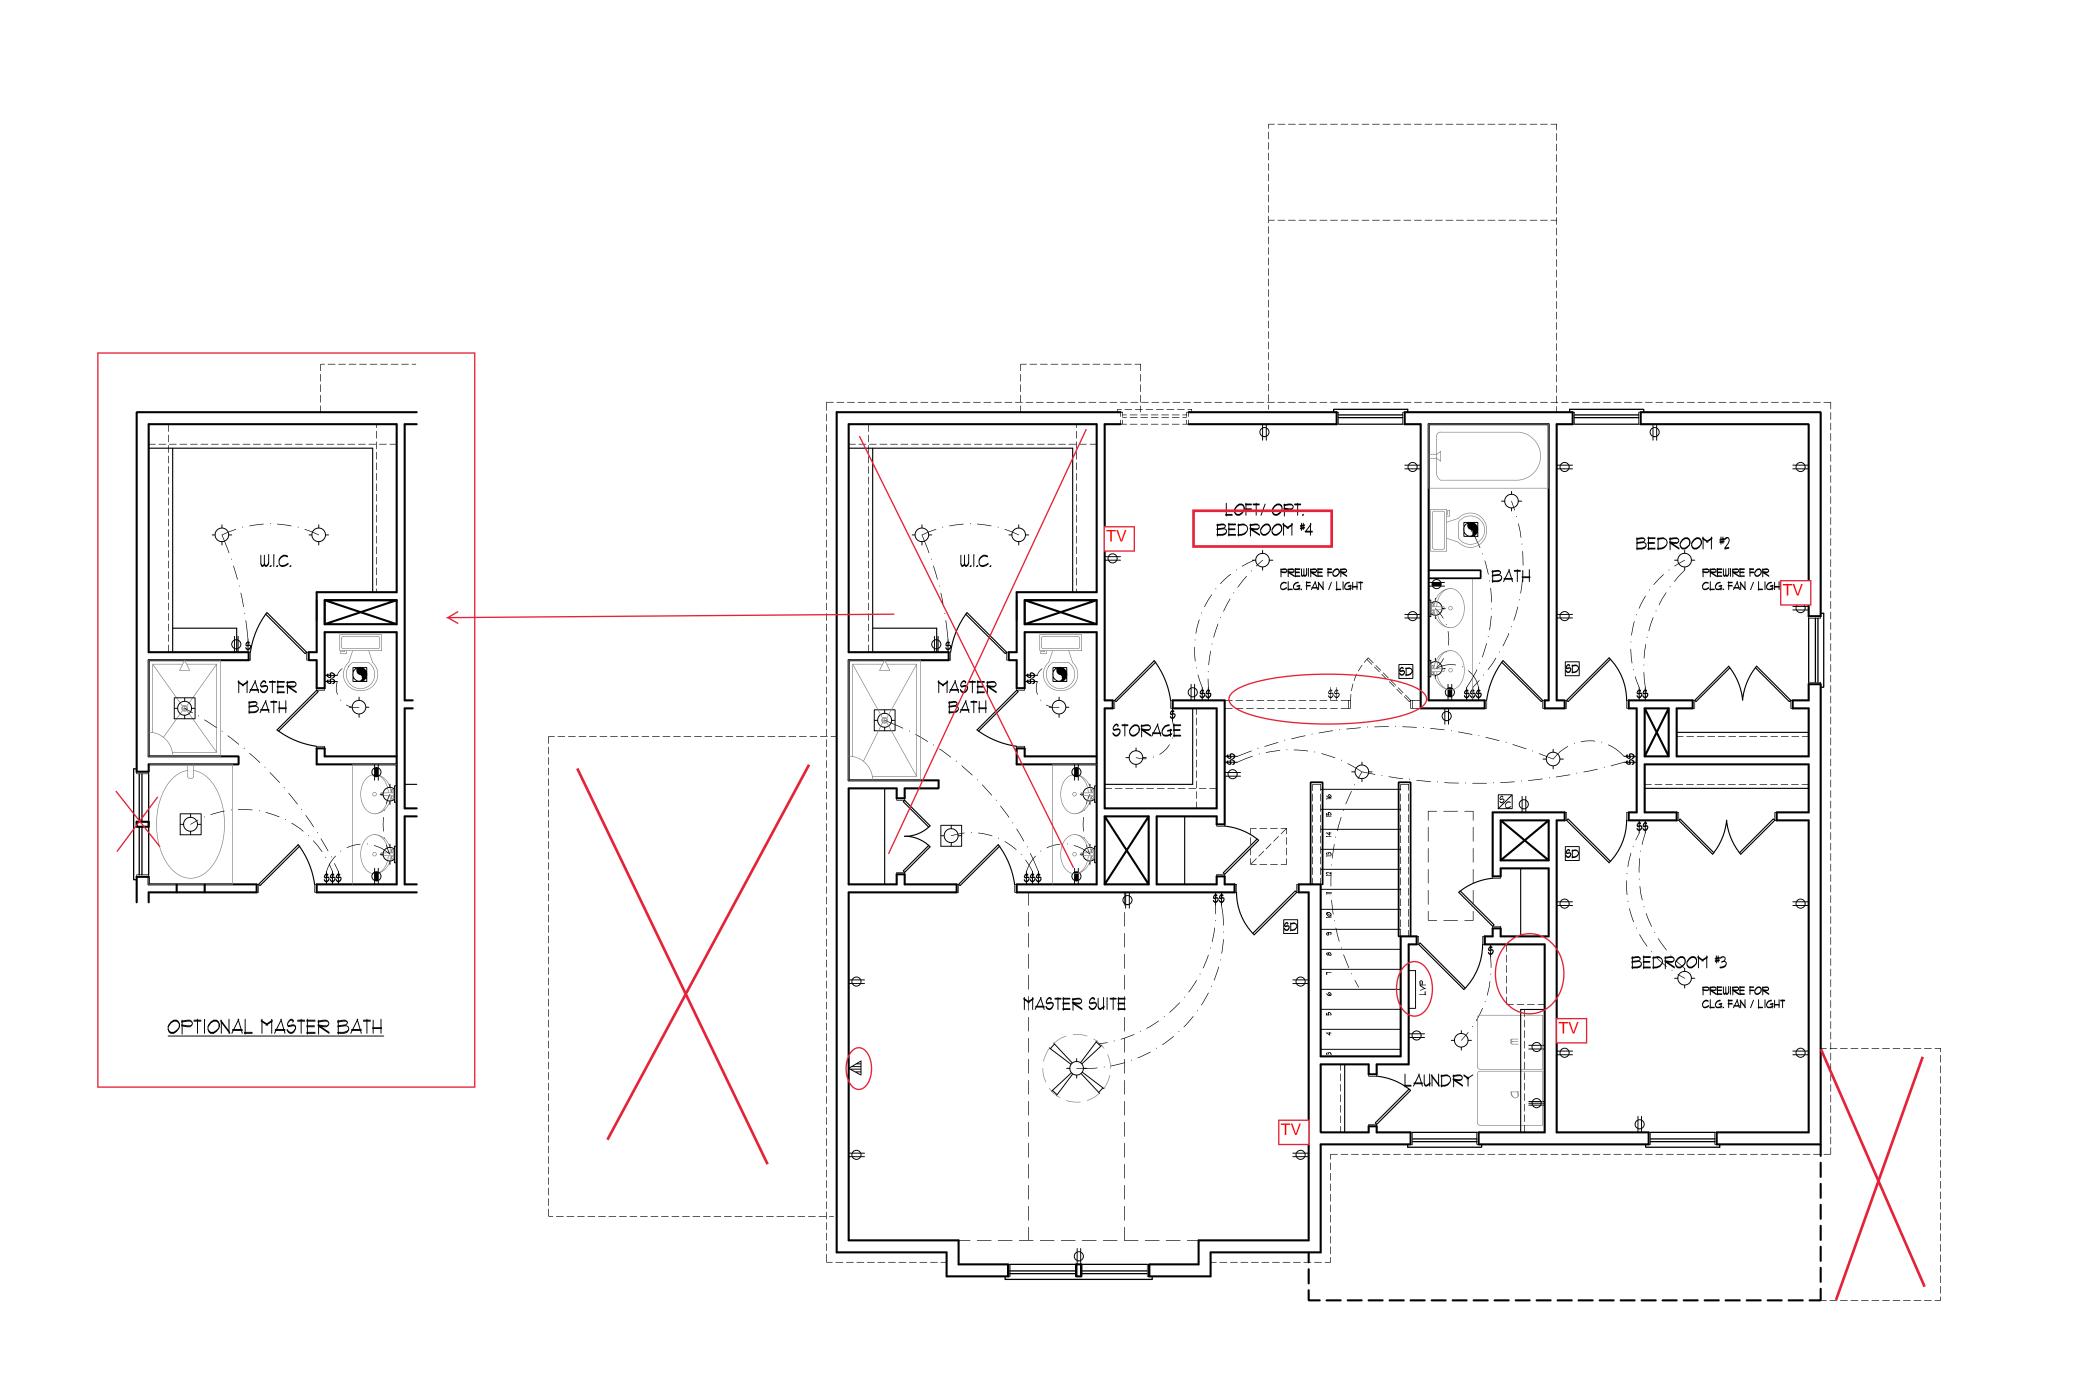

ELECTRICAL LAYOUT NOTES:

- BLOCK AND WIRE FOR ALL CELING FANS PER PLAN.
- 2.) VANITY LIGHTS TO BE SET
- 990" AFF. (TYP.)

 3.) ADDITIONAL EXTERIOR OUTLETS
 REQUIRED BY CODE TO BE
- LOCATED BY ELECTRICIAN.
- 4.) PLACE SWITCHES 8" (MIN.) FROM ROUGH OPENINGS.

ELECTRICAL LEGEND

- → IIØ ∨ OUTLET
- ⇒ IIØ V GFI OUTLET
- → 110 V SWITCHED OUTLET
- BB = 110 Y BASEBOARD OUTLET
- 4-PLEX
- COUNTER OR FLOOR MOUNTED

 COUNTER OR FLOOR MOUNTED 110V GF1
- ₩EATHERPROOF
- ₩P 220 ∨ OUTLET
- Ø 110 Y DEDICATED CIRCUIT
- Ø 22Ø V DEDICATED CIRCUIT
- WALL MOUNT LIGHT
- CEILING MOUNT LIGHT
- · -(P)- PENDANT LIGHT
- RECESSED CAN LIGHT
- MINI CAN LIGHT
- EYEBALL LIGHT
- FLUORESCENT LIGHT
 UNDERCABINET LIGHT
- FLOOD LIGHT
- \$ SWITCH
- \$D DIMMER SWITCH


 TELEPHONE
- △ DATA
- TELEPHONE AND DATA
- TV- TV CONNECTION
 TV/ DATA
- CD- CONDUIT FOR COMPONENT WIRING
- SP SPEAKER
- 110 V SMOKE/ CO DETECTOR
- 5D 110 V SMOKE DETECTOR
- EXHAUST FAN





CEILING FAN

CEILING FAN W/ LIGHT

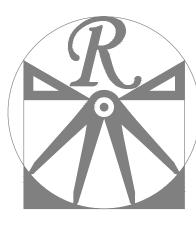

RENAISSANCE

RESIDENTIAL DESIGN, INC. RALEIGH, NC 27612 (919) 649-4128

WWW.RRDCAROLINA.COM

"The art of transforming your vision into reality."


RENAISSANCE RESIDENTIAL DESIGN, INC.
RESERVES THE RIGHT TO MAKE
MODIFICATIONS TO FLOOR PLANS,
DIMENSIONS, MATERIALS, AND

RENAISSANCE RESIDENTIAL DESIGN, INC. HEREBY EXPRESSLY RESERVES ITS COMMON LAW COPYRIGHT AND OTHER PROPERTY RIGHTS IN THESE PLANS. THESE PLANS AND DRAWINGS ARE NOT TO BE REPRODUCED, CHANGED, OR COPIED IN ANY FORM OR MANNER WITHOUT FIRST OBTAINING THE EXPRESS WRITTEN CONSENT OF RENAISSANCE RESIDENTIAL DESIGN, INC. NOR ARE THEY TO BE ASSIGNED TO ANY THIRD PARTY WITHOUT FIRST OBTAINING SAID WRITTEN PERMISSION AND CONSENT.

SPECIFICATIONS WITHOUT NOTICE.
THESE DRAWINGS ARE FOR THE
PURPOSE OF CONVEYING AN

ARCHITECTURAL CONCEPT ONLY.

J.S.THOMPSON ENGINEERING, INC 606 WADE AVE., SUITE 104 RALEIGH, NC 27605 PHONE: (919) 789-9919 FAX: (919) 789-9921 N.C. LICENSE NO.: C-1733

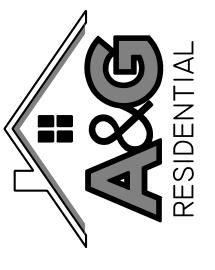

FLOOR PLANS, ELEVATIONS, DESIGNS, MATERIALS AND IMENSIONS ARE SUBJECT TO CHANGE WITHOUT NOTICE. JARE FOOTAGE AND DIMENSIONS ARE ESTIMATED AND M. Y. IN ACTUAL CONSTRUCTION. ACTUAL POSITION OF HOU! IN LOT WILL BE DETERMINED BY THE SITE PLAN AND PLOT IN. FLOOR PLANS AND ELEVATION RENDERINGS ARE ARTICONCEPTIONS. FLOOR PLANS ARE THE COPYRIGHTED CONCEPTIONS. FLOOR PLANS ARE THE COPYRIGHTED COPERTY OF A&G RESIDENTIAL. ANY USE, REPRODUCTION ADAPTATION, OR DISPLAY OF THE PLANS IS STRICTLY PROHIBITED. SEE NEW HOME SALES CONSULTANT FOR URRENT DETAILS. COPYRIGHT © 2020 A&G RESIDENTIAL

A&G RESIDENTIAL CAMDEN

DATE: SEPTEMBER 28, 2020

REV.:

SCALE: 1/4"=1'-0"

DRAWN BY: WG

ENGINEERED BY: WFB
REVIEWED BY: MGS

SECOND FLOOR ELECTRICAL PLAN

E-2

C:\Users\Wade\Documents\Projects\A&G\Camden\Camden_9-14-20.dwg, 10/2/2020 9:27:33 AM

30" x 30" x 10"─<

12" CONC. FTG.

30" x 30" x 10"-

12" CONC. FTG.

SIDE-LOAD


GARAGE OPTION

(NOT AVAILABLE WITH OPTIONAL THIRD CAR GARAGA

CONC. FTG. OR FOR BRICK 36" x 36" x

BRICK 36" x 36" x 5

CONC. FTG. OR FOR

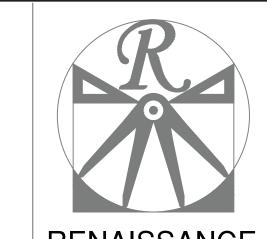

RALEIGH, NC 27612

(919) 649-4128

WWW.RRDCAROLINA.COM

RENAISSANCE RESIDENTIAL DESIGN, INC.

RESERVES THE RIGHT TO MAKE

MODIFICATIONS TO FLOOR PLANS, DIMENSIONS, MATERIALS, AND

SPECIFICATIONS WITHOUT NOTICE

THESE DRAWINGS ARE FOR THE PURPOSE OF CONVEYING AN

ARCHITECTURAL CONCEPT ONLY.

RENAISSANCE RESIDENTIAL DESIGN, INC.

HEREBY EXPRESSLY RESERVES ITS

COMMON LAW COPYRIGHT AND OTHER

PROPERTY RIGHTS IN THESE PLANS.

THESE PLANS AND DRAWINGS ARE NOT

TO BE REPRODUCED, CHANGED, OR

COPIED IN ANY FORM OR MANNER

WITHOUT FIRST OBTAINING THE EXPRESS

WRITTEN CONSENT OF RENAISSANCE RESIDENTIAL DESIGN, INC. NOR ARE THEY TO BE ASSIGNED TO ANY THIRD

PARTY WITHOUT FIRST OBTAINING SAID WRITTEN PERMISSION AND CONSENT.

'The art of transforming your vision into re ality."

RENAISSANCE RESIDENTIAL DESIGN, INC.

NOTES FOR LESS THAN <u>30' MEAN ROOF HEIGHT:</u>

- ENGINEER'S SEAL APPLIES ONLY TO DOES NOT CERTIFY DIMENSIONAL
- INCLUDING ROOF SYSTEM.
- WITHIN 1'-0" FROM END OF EACH CORNER. ANCHOR BOLTS MUST EXTEND A MINIMUM OF
- 5. EXTERIOR WALLS DESIGNED FOR 130 MPH
- PITCHED 2.25/12 TO 1/12. 8. INSTALL 1/16" OSB SHEATHING ON ALL EXTERIOR WALLS OF ALL STORIES IN ACCORDANCE WITH SECTION R602.10.3 OF
- BRACING NOTES AND DETAILS SHEET FOR MORE INFORMATION.
- 10. REFER TO NOTES AND DETAIL SHEETS FOR ADDITIONAL STRUCTURAL INFORMATION.

NOTES FOR LESS THAN

- ENGINEER'S SEAL APPLIES ONLY TO DOES NOT CERTIFY DIMENSIONAL ACCURACY OR ARCHITECTURAL LAYOUT
- . STRUCTURAL DESIGN PER NORTH CAROLINA RESIDENTIAL CODE, 2018 EDITION.
- AND -18 PSF FOR ROOF PITCHES 1/12 TO 12/12 AND +10 PSF AND -36 PSF FOR ROOF PITCHED 2.25/12 TO 7/12. 8. INSTALL 1/16" OSB SHEATHING ON ALL
- EXTERIOR WALLS OF ALL STORIES IN ACCORDANCE WITH SECTION R602.10.3 OF THE NCRC, 2018 EDITION. SEE THE WALL BRACING NOTES AND DETAILS SHEET FOR MORE INFORMATION.
- NCRC, 2018 EDITION. 10. REFER TO NOTES AND DETAIL SHEETS FOR

130 MPH ULTIMATE DESIGN WIND SPEED

- STRUCTURAL COMPONENTS. ENGINEER'S SEAL
- RESIDENTIAL CODE, 2018 EDITION. 3. INSTALL 1/2" ANCHOR BOLTS 4'-0" O.C. AND
- BOLT WITHIN MIDDLE THIRD OF PLATE WIDTH. 4. MEAN ROOF HEIGHT IS LESS THAN 30 FEET.
- 1. ROOF CLADDING DESIGNED FOR +16.7 PSF AND -21 PSF FOR ROOF PITCHES 1/12 TO 12/12 AND +10.5 PSF AND -43 PSF FOR ROOF
- THE NCRC, 2018 EDITION. SEE THE WALL
- 9. ENERGY EFFICIENCY COMPLIANCE AND

- ANCHOR BOLTS MUST EXTEND A MINIMUM OF 1" INTO MASONRY OR CONCRETE. LOCATE
- 5. EXTERIOR WALLS DESIGNED FOR 120 MPH
- 6. WALL CLADDING DESIGNED FOR +15.5 PSF AND -20 PSF (+/- INDICATE POSITIVE /
- 9. ENERGY EFFICIENCY COMPLIANCE AND INSULATION VALUES OF THE BUILDING TO BE IN ACCORDANCE WITH CHAPTER 11 OF THE
- ADDITIONAL STRUCTURAL INFORMATION.

- ACCURACY OR ARCHITECTURAL LAYOUT
- 2. STRUCTURAL DESIGN PER NORTH CAROLINA
- 1" INTO MASONRY OR CONCRETE. LOCATE
- 6. WALL CLADDING DESIGNED FOR +18.2 PSF
- AND -24 PSF (+/- INDICATE POSITIVE / NEGATIVE PRESSURE (TYP).
- INSULATION VALUES OF THE BUILDING TO BE IN ACCORDANCE WITH CHAPTER II OF THE NCRC, 2018 EDITION.

120 MPH ULTIMATE DESIGN WIND SPEED <u>30' MEAN ROOF HEIGHT:</u>

- STRUCTURAL COMPONENTS. ENGINEER'S SEAL INCLUDING ROOF SYSTEM.
- 3. INSTALL 1/2" ANCHOR BOLTS 6'-0" O.C. AND WITHIN 1'-0" FROM END OF EACH CORNER.
- BOLT WITHIN MIDDLE THIRD OF PLATE WIDTH. 4. MEAN ROOF HEIGHT IS LESS THAN 30 FEET.
- NEGATIVE PRESSURE (TYP). 1. ROOF CLADDING DESIGNED FOR +14.2 PSF

SEAL 33736

10/1/2020

J.S.THOMPSON ENGINEERING, INC 606 WADE AVE., SUITE 104 RALEIGH, NC 27605 PHONE: (919) 789-9919 FAX: (919) 789-9921

N.C. LICENSE NO.: C-1733



A&G RESIDENTIA CAMDEN

DATE: SEPTEMBER 28, 2020

SCALE: 1/4"=1'-0"


REV.:

DRAWN BY: WG

ENGINEERED BY: WFB REVIEWED BY: MGS

STEMWALL SLAB FOUNDATION PLAN

S-1

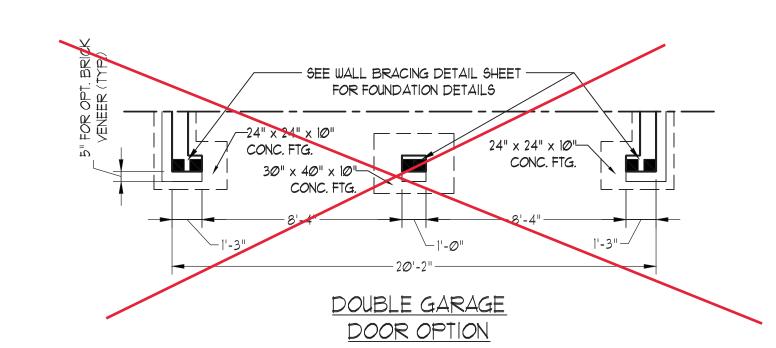

30" x 30" x 10" CONC. FTG

- SEE WALL BRACING DETAIL SHEET -

FOR FOUNDATION DETAILS

NO FIREPLACE

5" BRICK LEDGE FOR OPTIONAL VENEER— (SEE ELEVATION PAGES FOR LOCATIONS AND CONDITIONS)

FIREPLACE

_ 17'-3 1/2" __

- PLUMBING DROP

OPTIONAL COVERED PORCH

(PATIO STANDARD)

SLAB

PLUMBING DROP

ISLAND PLUG (TYP.)

OPT. PATIO 12-Ø

DEEP PATIO/ DECK

OPT. PATIO/

DECK

-----11'**-**1Ø''----

OPTIONAL OVENS --

6" WIDE BY 9" DEEP

· -------

THICKENED SLAB (TYP.)

SEE STEMWALL FDN. DETAIL

SLAB

PIER (INCLUDING VENEER) ON 24" x 24" x 10" CONC. FTG. (TYP.)

---5'-∅"---

5" BRICK LEDGE FOR

OPTIONAL VENEER (SEE ELEVATION PAGES

FOR LOCATIONS AND CONDITIONS)

SHEET FOR FND. OPTIONS.

SIDE-LOAD GARAGE OPTION

(NOT AVAILABLE WITH

OPTIONAL THIRD CAR GARAGE)

30" x 30" x 10"<u></u>

-4" CONC.

PEDESTRIAN

DOOR OPTION

SLAB

SEE WALL BRACING DETAIL SHEET

CONC. FTG.

OPTIONAL THIRD

CAR GARAGE

FOR FOUNDATION DETAILS

CONC. FTG.

GARAGE THOD PF

SIDE-LOAD

GARAGE OPTION

(NOT AVAILABLE WITH

OPTIONAL THIRD CAR GARAGE

JACKS ÉA. BEARING POINT.

GARAGE PORTAL FRAME. SEE-

OPTIONAL THIRD

CAR GARAGE

SIDE-LOAD

GARAGE OPTION

(NOT AVAILABLE WITH

OPTIONAL THIRD CAR GARAGE)

METHOD PF WALL BRACING DETAIL

-12'-0/ SIDE IB RECTANGLE B

CONTRIBUTES 21/9"

2'-2" CONTRIBUTES 3'-3"

 $+(3)2 \times 4 OR$ (3)2 x 6

BRACED WALL DESIGN

RECTANGLE A SIDE IB SIDE IA (FRONT LOAD)

METHOD: CS-WSP/PF/GB TOTAL REQUIRED LENGTH: 15.1' TOTAL PROVIDED LENGTH: 21.6' SIDE 2A SIDE 2B METHOD: CS-WSP

TOTAL REQUIRED LENGTH: 15.1' TOTAL PROVIDED LENGTH: 20.66' TOTAL PROVIDED LENGTH: 12' SIDE 3A (SIDE LOAD) TOTAL REQUIRED LENGTH: 17.55' TOTAL REQUIRED LENGTH: 3.19' TOTAL PROVIDED LENGTH: 17.9'

TOTAL REQUIRED LENGTH: 17.55' TOTAL REQUIRED LENGTH: 20.74'

RECTANGLE B METHOD: CS-WSP/PF TOTAL REQUIRED LENGTH: 4.56' TOTAL PROVIDED LENGTH: 6'

METHOD: CS-WSP TOTAL REQUIRED LENGTH: 4.56 SIDE 3B

METHOD: CS-WSP TOTAL PROVIDED LENGTH: 15.58' SIDE 4B/3A SHARED METHOD: CS-WSP/GB

BRACED WALL DESIGN NOTES:

- BRACED WALL DESIGN PER SECTION R602.10 OF THE
- NCRC 2018 EDITION. CS-WSP REFERS TO "CONTINUOUS SHEATHING - WOOD STRUCTURAL PANELS" CONTRACTOR IS TO INSTALL 1/16" OSB
- O.C. ALONG PANEL EDGES AND 12" O.C. IN THE FIELD. *GB REFERS TO "GYPSUM BOARD" CONTRACTOR IS TO INSTALL 1/2" (MIN.) GYPSUM WALL BOARD WHERE NOTED ON THE PLANS. FASTEN GB WITH 1 1/4" SCREWS OR 1 5/8" NAILS SPACED 1" O.C. ALONG PANEL EDGES AND IN THE FIELD INCLUDING TOP AND BOTTOM PLATES.
 - BRACED WALL DESIGN APPLIED IN WIND ZONES UP TO 130 MPH. FOR HIGH WIND ZONES, BRACE WALLS ARE TO BE CONSTRUCTED IN ACCORDANCE WITH CHAPTER 45 OF THE NCRC 2018 EDITION. SEE NOTES AND DETAIL SHEETS FOR ADDITIONAL BRACED

ON ALL EXTERIOR WALLS ATTACHED w/ 8d NAILS SPACED 6"

WALL INFORMATION.

NOTE: TJI 110 JOISTS MAY BE INSTALLED IN LIEU OF BCI 4500s-1.8 JOISTS AT THE DEPTH AND SPACING INDICATED ON THE PLAN

33736

10/1/2020

*NOTE: ALL EXTERIOR WALLS AND ATTIC WALLS ARE TO BE 2 x 6 @ 16" O.C. (UNO). 2 x 4 @ 16" O.C. EXTERIOR WALLS MAY BE CONSTRUCTED IN LIEU OF 2 x 6 WALLS (UNO). ALL INTERIOR LOAD BEARING WALLS ARE TO BE 2 x 4 @ 16" O.C. (UNO) AND NON-LOAD BEARING INTERIOR WALLS ARE TO BE || 2 × 4 @ 24" O.C. (UNO).

_			
	LINTEL SCHEDULE FOR BRICK/NATURAL STONE SUPPORT		
•	LENGTH (FT.)	SIZE OF LINTEL	
	UP TO 4 FT.	L 3 1/2 x 3 1/2 x 1/4	
	4-8	L 5 x 3 1/2 x 5/16 LLV	
	8 AND GREATER	L 6 x 4 x 5/16 LLV	
	UP TO 4 FT.	L 3 1/2 x 3 1/2 x 1/4 L 5 x 3 1/2 x 5/16 LL	_

BRICK SUPPORT NOTES:

- LINTEL SCHEDULE APPLIES TO ALL OPENINGS IN BRICK VENEER (UNO). SEE ARCH DWGS. FOR SIZE AND LOCATION OF OPENINGS.
- (LLV) = LONG LEG VERTICAL LENGTH = CLEAR OPENING
- EMBED ALL ANGLE IRONS MIN. 4" EACH SIDE INTO YENEER TO PROVIDE BEARING. FOR ALL HEADERS 8'-0" AND GREATER IN LENGTH, ATTACH STEEL ANGLE TO
- HEADER W/ 1/2" LAG SCREWS @ 12" O.C. STAGGERED. FOR ALL BRICK SUPPORT @ ROOF LINES, FASTEN (2) 2 x 10 BLOCKING BETWEEN STUDS w/ (4) 12d NAILS PER PLY. FASTEN
- 10 BLOCKING w/ (2) 1/2" LAG SCREWS @ 12" O.C. STAGGERED. SEE SECTION RT03.8.2.1 OF THE 2018 NCRC FOR ADDITIONAL BRICK SUPPORT INFORMATION. PRECAST REINFORCED CONCRETE LINTELS ENGINEERED BY OTHERS MAY BE

A 6" x 4" x 5/16" STEEL ANGLE TO (2) 2 x

STRUCTURAL NOTES:

ALL FRAMING LUMBER TO BE SPF #2 (UNO). ALL TREATED LUMBER TO BE SYP #2 (UNO.)

USED IN LIEU OF STEEL LINTELS.

- ALL LOAD BEARING HEADERS TO BE (2) 2×6 (UNO).
- INSTALL AN EXTRA JOIST UNDER WALLS PARALLEL TO FLOOR JOISTS
- WHERE NOTED ON THE PLANS. WINDOW AND DOOR HEADERS TO BE SUPPORTED w/(1) JACK STUD AND (1) KING STUD EA. END (UNO.). SEE TABLE R602.7.5 FOR ADDITIONAL KING STUD REQUIREMENTS.
- SQUARES DENOTE POINT LOADS WHICH REQUIRE SOLID BLOCKING TO GIRDER OR FOUNDATION. ALL SQUARES TO BE (2) STUDS (UNO.)
- 6. ALL 4 x 4 POSTS SHALL BE ANCHORED TO SLABS W/ SIMPSON ABU44 POST BASES (OR EQUAL) AND 6 x 6 POSTS w/ ABU66 POST BASES (OR EQUAL) (UNO). ALL 4 x 4 AND 6 x 6 POSTS TO BE INSTALLED WITH 100 LB CAPACITY UPLIFT CONNECTORS AT TOP (UNO.)
- FOR FIBERGLASS, ALUMINUM, OR COLUMN ENG. BY OTHERS, SECURE TO SLAB w/ (2) METAL ANGLES USING 2" CONC. SCREWS. FASTEN ANGLES TO COLUMNS w/ 1/4" THROUGH BOLTS w/ NUTS AND WASHERS. LOCATE ANGLES ON OPPOSITE SIDES OF COLUMN. THROUGH BOLTS MUST BE INSTALLED PRIOR TO SETTING COLUMN.
- REFER TO NOTES AND DETAIL SHEETS FOR ADDITIONAL STRUCTURAL INFORMATION.

RENAISSANCE RESIDENTIAL DESIGN, INC RALEIGH, NC 27612 (919) 649-4128 WWW.RRDCAROLINA.COM "The art of transforming your vision into re ality." RENAISSANCE RESIDENTIAL DESIGN, INC.

MODIFICATIONS TO FLOOR PLANS, DIMENSIONS, MATERIALS, AND SPECIFICATIONS WITHOUT NOTICE THESE DRAWINGS ARE FOR THE PURPOSE OF CONVEYING AN ARCHITECTURAL CONCEPT ONLY RENAISSANCE RESIDENTIAL DESIGN, INC. HEREBY EXPRESSLY RESERVES ITS COMMON LAW COPYRIGHT AND OTHER

PROPERTY RIGHTS IN THESE PLANS. THESE PLANS AND DRAWINGS ARE NOT TO BE REPRODUCED, CHANGED, OR COPIED IN ANY FORM OR MANNER WITHOUT FIRST OBTAINING THE EXPRESS WRITTEN CONSENT OF RENAISSANCE RESIDENTIAL DESIGN, INC. NOR ARE THEY TO BE ASSIGNED TO ANY THIRD PARTY WITHOUT FIRST OBTAINING SAID WRITTEN PERMISSION AND CONSENT.

J.S.THOMPSON ENGINEERING, INC 606 WADE AVE., SUITE 104 RALEIGH, NC 27605 PHONE: (919) 789-9919 FAX: (919) 789-9921 N.C. LICENSE NO.: C-1733



3 RESIDENTIAI 1DEN

DATE: SEPTEMBER 28, 2020

SCALE: 1/4"=1'-0"

REV.:

DRAWN BY: WG


REVIEWED BY: MGS


FRAMING PLAN

ENGINEERED BY: WFB

SECOND FLOOR

S-2

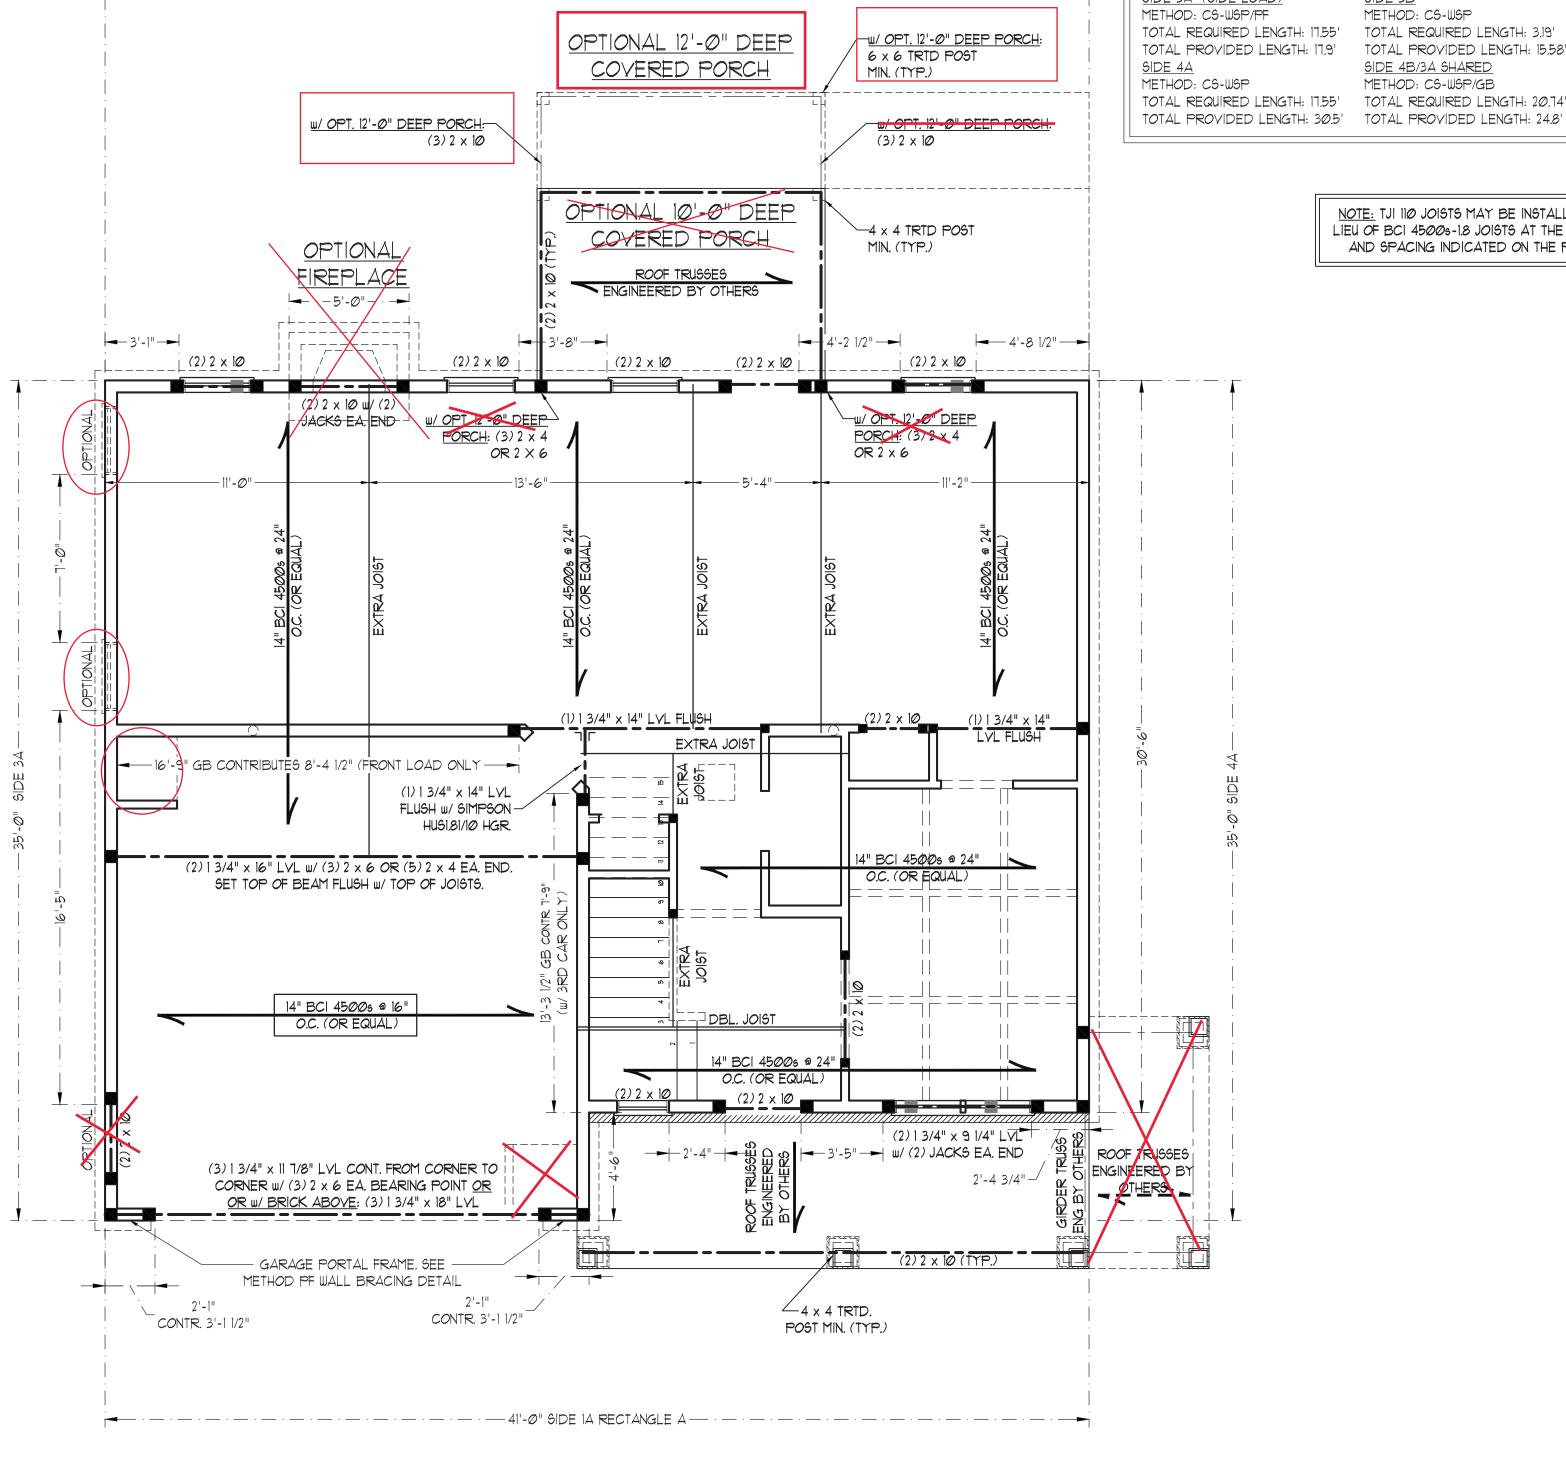

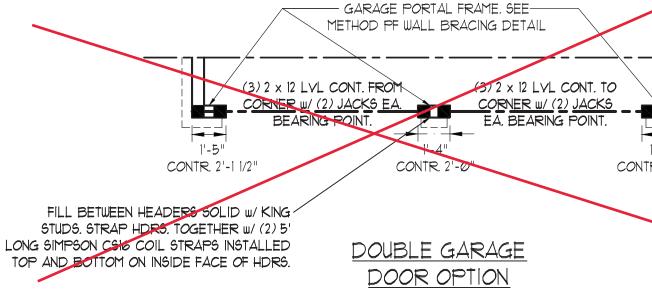


→ CONTR. 2'-1 1/2"

SEE WINDOW BOX DETAIL

ROOF AND CLG LOAD FROM

BUMPOUT ELEY C

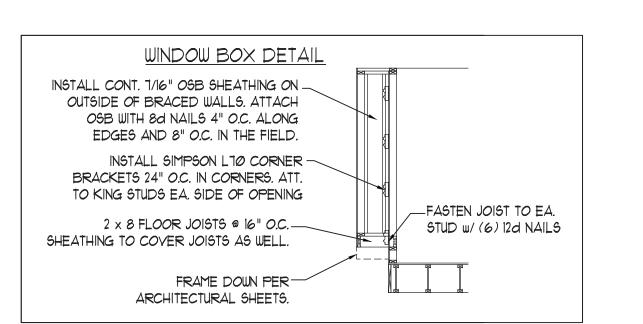

BRACED WALL DESIGN NOTES:

WALL INFORMATION.

- BRACED WALL DESIGN PER SECTION R602.10 OF THE
- NCRC 2018 EDITION. CS-WSP REFERS TO "CONTINUOUS SHEATHING - WOOD STRUCTURAL PANELS" CONTRACTOR IS TO INSTALL 1/16" OSB ON ALL EXTERIOR WALLS ATTACHED w/ 8d NAILS SPACED 6" O.C. ALONG PANEL EDGES AND 12" O.C. IN THE FIELD.
- *GB REFERS TO "GYPSUM BOARD" CONTRACTOR IS TO INSTALL 1/2" (MIN.) GYPSUM WALL BOARD WHERE NOTED ON THE PLANS. FASTEN GB WITH 1 1/4" SCREWS OR 1 5/8" NAILS SPACED 1" O.C. ALONG PANEL EDGES AND IN THE FIELD INCLUDING TOP AND BOTTOM PLATES.
- BRACED WALL DESIGN APPLIED IN WIND ZONES UP TO 130 MPH. FOR HIGH WIND ZONES, BRACE WALLS ARE TO BE CONSTRUCTED IN ACCORDANCE WITH CHAPTER 45 OF THE NCRC 2018 EDITION. SEE NOTES AND DETAIL SHEETS FOR ADDITIONAL BRACED

- 1. PER SECTION R602.10.3.2 OF THE 2018 NCRC, THE AMOUNT OF BRACING ON THE SECOND FLOOR EXCEEDS THE AMOUNT REQUIRED FOR THE FIRST FLOOR AND NO BRACED WALL ANALYSIS IS REQUIRED.
- 2. SHEATH ALL EXTERIOR WALLS WITH 1/16" OSB SHEATHING ATTACHED WITH 8d NAILS AT 6" O.C. ALONG PANEL EDGES AND 12" O.C. IN THE FIELD.

*NOTE: ALL EXTERIOR WALLS AND ATTIC WALLS ARE TO BE 2 x 6 @ 16" O.C. (UNO). 2 x 4 @ 16" O.C. EXTERIOR WALLS MAY BE CONSTRUCTED IN LIEU OF 2 x 6 WALLS (UNO). ALL INTERIOR LOAD BEARING WALLS ARE TO BE 2 x 4 @ 16" O.C. (UNO) AND NON-LOAD BEARING INTERIOR WALLS ARE TO BE 2 x 4 @ 24" O.C. (UNO).

LINTEL SCHEDULE FOR BRICK/NATURAL STONE SUPPOR		
LENGTH (FT.)	SIZE OF LINTEL	
UP TO 4 FT.	L 3 1/2 x 3 1/2 x 1/4	
4-8	L 5 x 3 1/2 x 5/16 LLV	
8 AND GREATER	L 6 x 4 x 5/16 LLV	
BRICK SUPPORT NOT	<u> </u>	

- LINTEL SCHEDULE APPLIES TO ALL OPENINGS IN BRICK VENEER (UNO). SEE ARCH DWGS. FOR SIZE AND LOCATION OF OPENINGS.
- (LLV) = LONG LEG VERTICAL LENGTH = CLEAR OPENING
- EMBED ALL ANGLE IRONS MIN. 4" EACH SIDE INTO VENEER TO PROVIDE BEARING.
- FOR ALL HEADERS 8'-0" AND GREATER IN LENGTH, ATTACH STEEL ANGLE TO HEADER W/ 1/2" LAG SCREWS @ 12" O.C. STAGGERED.
- FOR ALL BRICK SUPPORT @ ROOF LINES, FASTEN (2) 2 x 10 BLOCKING BETWEEN STUDS W/ (4) 12d NAILS PER PLY. FASTEN A 6" \times 4" \times 5/16" STEEL ANGLE TO (2) 2 \times 10 BLOCKING w/ (2) 1/2" LAG SCREWS @ 12" O.C. STAGGERED. SEE SECTION RT03.8.2.1 OF THE 2018 NCRC FOR ADDITIONAL BRICK SUPPORT INFORMATION. PRECAST REINFORCED CONCRETE LINTELS ENGINEERED BY OTHERS MAY BE

USED IN LIEU OF STEEL LINTELS.

TABLE R602.7.5 MINIMUM NUMBER OF FULL HEIGHT STUDS

AT EACH END OF HEADERS IN EXTERIOR WALLS			
HEADER SPAN (FEET)	/SES TARIE		
(16	24	
UP TO 3'	1	1	
4'	2	1	
8'	3	2	
12'	5	3	
16'	6	4	

33736

10/1/2020

STRUCTURAL NOTES:

- ALL FRAMING LUMBER TO BE #2 SPF
- 2. ALL LOAD BEARING HEADERS TO BE (2) 2×6 (UNO).
- B. WINDOW AND DOOR HEADERS TO BE SUPPORTED w/(1) JACK STUD AND (1) KING STUD EA. END (UNO.). SEE TABLE R602.7.5 FOR ADDITIONAL KING STUD REQUIREMENTS.
- SQUARES DENOTE POINT LOADS WHICH REQUIRE SOLID BLOCKING TO GIRDER OR FOUNDATION. SQUARES TO BE (2) STUDS (UNO.)
- REFER TO NOTES AND DETAIL SHEETS FOR ADDITIONAL STRUCTURAL INFORMATION.



RALEIGH, NC 27612 (919) 649-4128 WWW.RRDCAROLINA.COM

"The art of transforming your vision into re ality." RENAISSANCE RESIDENTIAL DESIGN, INC. MODIFICATIONS TO FLOOR PLANS, DIMENSIONS, MATERIALS, AND


SPECIFICATIONS WITHOUT NOTICE

THESE DRAWINGS ARE FOR THE

PURPOSE OF CONVEYING AN ARCHITECTURAL CONCEPT ONLY

RENAISSANCE RESIDENTIAL DESIGN, INC. HEREBY EXPRESSLY RESERVES ITS COMMON LAW COPYRIGHT AND OTHER PROPERTY RIGHTS IN THESE PLANS. THESE PLANS AND DRAWINGS ARE NOT TO BE REPRODUCED, CHANGED, OR COPIED IN ANY FORM OR MANNER WITHOUT FIRST OBTAINING THE EXPRESS WRITTEN CONSENT OF RENAISSANCE RESIDENTIAL DESIGN, INC. NOR ARE THEY TO BE ASSIGNED TO ANY THIRD PARTY WITHOUT FIRST OBTAINING SAID WRITTEN PERMISSION AND CONSENT.

J.S.THOMPSON ENGINEERING, INC 606 WADE AVE., SUITE 104 RALEIGH, NC 27605 PHONE: (919) 789-9919 FAX: (919) 789-9921 N.C. LICENSE NO.: C-1733

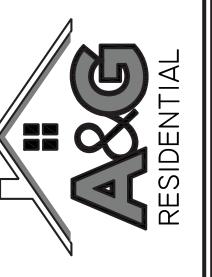

A&G RESIDENTIAL CAMDEN

DATE: SEPTEMBER 28, 2020 REV.:

SCALE: 1/4"=1'-0"

DRAWN BY: WG ENGINEERED BY: WFB

REVIEWED BY: MGS

ATTIC FLOOR FRAMING PLAN

S-3


ATTIC VENT CALCULATION:

286 SQ. FT. OF ATTIC DIVIDED BY 150 REQUIRES 1.9 SQ. FT. OF NET


FREE VENTILATING AREA (MIN.).

OPTIONAL THIRD

CAR GARAGE

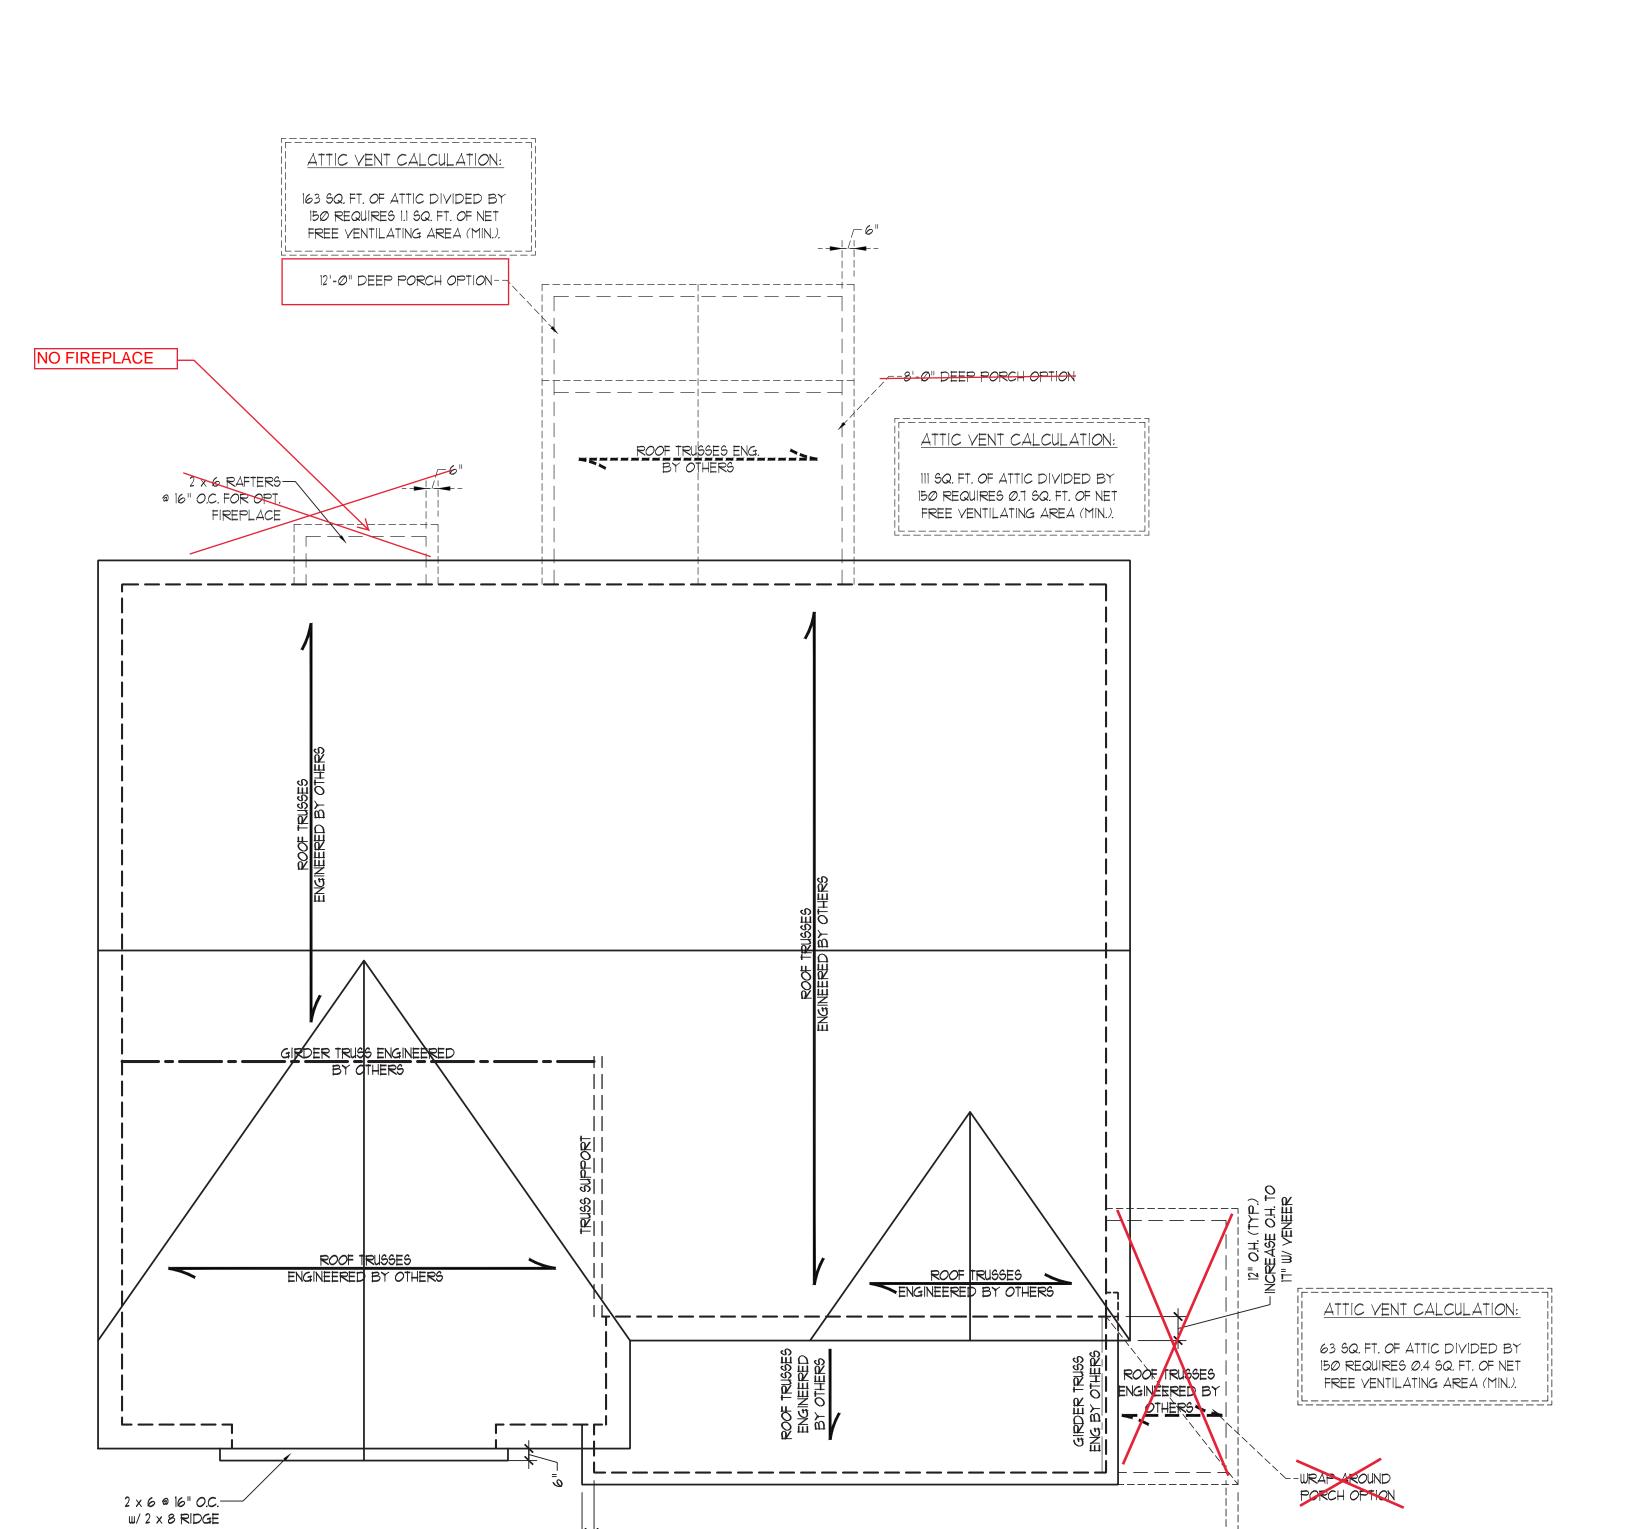

ELEVATION B

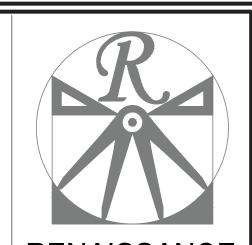

RENAISSANCE RESIDENTIAL DESIGN, INC.

RALEIGH, NC 27612

(919) 649-4128

WWW.RRDCAROLINA.COM

SPECIFICATIONS WITHOUT NOTICE

THESE DRAWINGS ARE FOR THE PURPOSE OF CONVEYING AN

ARCHITECTURAL CONCEPT ONLY.

THESE PLANS AND DRAWINGS ARE NOT

TO BE REPRODUCED, CHANGED, OR

COPIED IN ANY FORM OR MANNER

WITHOUT FIRST OBTAINING THE EXPRESS

WRITTEN CONSENT OF RENAISSANCE RESIDENTIAL DESIGN, INC. NOR ARE

THEY TO BE ASSIGNED TO ANY THIRD

J.S.THOMPSON

ENGINEERING, INC

606 Wade ave., suite 104 RALEIGH, NC 27605

PHONE: (919) 789-9919

FAX: (919) 789-9921

N.C. LICENSE NO.: C-1733

PARTY WITHOUT FIRST OBTAINING SAID WRITTEN PERMISSION AND CONSENT.

1630 SQ. FT. OF ATTIC DIVIDED BY

STRUCTURAL NOTES:

- SPF (UNO). CIRCLES DENOTE (3) 2 x 4 POSTS
- FRAME DORMER WALLS ON TOP OF DOUBLE OR TRIPLE RAFTERS.
- HIP SPLICES ARE TO BE SPACED A MIN. OF 8'-0". FASTEN
- MEMBERS WITH THREE ROWS OF 12d NAILS @ 16" O.C. (TYP.) STICK FRAME OVER-FRAMED
- FASTEN FLAT VALLEYS TO RAFTERS OR TRUSSES WITH TIES THROUGH NOTCH IN ROOF
- TOE NAILS. REFER TO SECTION R802.11 OF THE
- REFER TO NOTES AND DETAIL SHEETS FOR ADDITIONAL

BRICK SUPPORT NOTE:

- 1. FASTEN (2) 2 × 10 BLOCKING BETWEEN WALL STUDS w/ (4) 12d NAILS PER PLY. FASTEN A 6" × 4" × 5/16" STEEL ANGLE TO (2) 2 × 10 BLOCKING w/ (2) 1/2" LAG SCREWS @ 12" O.C. STAGGERED. SEE SECTION R703.8.2.1. OF THE 2018 NCRC FOR ADDITIONAL BRICK SUPPORT INFORMATION.
- O.C. PER SECTION R703.8.2.1 OF THE NORTH CAROLINA RESIDENTIAL CODE, 2018 EDITION.

ATTIC VENT CALCULATION:

'The art of transforming your vision into re ality." RENAISSANCE RESIDENTIAL DESIGN, INC. 150 REQUIRES 10.9 SQ. FT. OF NET RESERVES THE RIGHT TO MAKE MODIFICATIONS TO FLOOR PLANS, DIMENSIONS, MATERIALS, AND FREE VENTILATING AREA (MIN.).

RENAISSANCE RESIDENTIAL DESIGN, INC. HEREBY EXPRESSLY RESERVES ITS COMMON LAW COPYRIGHT AND OTHER PROPERTY RIGHTS IN THESE PLANS.

- ALL FRAMING LUMBER TO BE #2
- FOR ROOF SUPPORT.
- ROOF SECTIONS W/ 2 x 8 RIDGES,
- 2 x 6 RAFTERS @ 16" O.C. AND FLAT 2 x 10 VALLEYS OR USE VALLEY TRUSSES.
- SIMPSON H2.5A HURRICANE TIES @ 32" O.C. MAX. PASS HURRICANE SHEATHING. EACH RAFTER IS TO BE FASTENED TO THE FLAT VALLEY WITH A MIN. OF (6) 12d
- 2018 NCRC FOR REQUIRED UPLIFT RESISTANCE AT RAFTERS AND TRUSSES.
- STRUCTURAL INFORMATION.

- 2. WHERE ROOF SLOPES EXCEED 7:12, INSTALL 3" x 3" x 1/4" STEEL PLATE STOPS AT 24"

A&G RESIDENTIAL CAMDEN

DATE: SEPTEMBER 28, 2020 REV.:

SCALE: 1/4"=1'-0"

DRAWN BY: WG ENGINEERED BY: WFB

REVIEWED BY: MGS

ROOF PLAN ELEVATION - B

S-4

STEM WALI FOUNDATION DE

DATE: NOVEMBER 1, 2018

DRAWN BY: JST

SCALE: NTS

ENGINEERED BY: JST

FOUNDATION DETAILS

MASONRY STEMWALL SPECIFICATIONS MASONRY WALL TYPE WALL HEIGHT

4" BRICK AND 4" BRICK AND (FEET) 8" CMU 12" CMU 2 AND UNGROUTED GROUT SOLID UNGROUTED UNGROUTED BELOW GROUT SOLID UNGROUTED UNGROUTED UNGROUTED GROUT SOLID w/ #4 GROUT SOLID w/ #4 GROUT SOLID GROUT SOLID REBAR @ 48" O.C. REBAR @ 64" O.C. GROUT SOLID w/ #4 GROUT SOLID w/ #4 GROUT SOLID w/ #4 NOT APPLICABLE REBAR @ 36" O.C. REBAR @ 36" O.C. REBAR @ 64" O.C. GROUT SOLID w/ #4 GROUT SOLID w/ #4 GROUT SOLID w/ #4

REBAR @ 24" O.C. REBAR @ 24" O.C. REBAR @ 64" O.C. 7 AND ENGINEERED DESIGN BASED ON SITE CONDITIONS GREATER

STRUCTURAL NOTES:

NOT APPLICABLE

- 1) WALL HEIGHT MEASURED FROM TOP OF FOOTING TO TOP OF THE WALL.
- 2) TIE MULTIPLE WYTHES TOGETHER WITH LADDER WIRE AT 16" O.C. VERTICALLY.
- 3) CHART APPLICABLE FOR HOUSE FOUNDATION ONLY. CONSULT ENGINEER FOR DESIGN OF GARAGE FOUNDATION NOT COMMON TO HOUSE.
- 4) BACKFILL OF CLEAN #51 / #61 WASHED STONE IS ALLOWABLE.
- 5) BACKFILL OF WELL DRAINED OR SAND GRAYEL MIXTURE SOILS (45 PSF/FT BELOW GRADE) CLASSIFIED AS GROUP I ACCORDING TO UNIFIED SOILS CLASSIFICATION SYSTEM IN ACCORDANCE WITH TABLE R405.1 OF THE 2018 NORTH CAROLINA RESIDENTIAL CODE ARE ALLOWABLE.
- 6) PREP SLAB PER <u>R506.2.1</u> AND <u>R506.2.2</u> BASE AND <u>EXCEPTION</u> OF 2018 NORTH CAROLINA RESIDENTIAL CODE.
- 1) MINIMUM 24" LAP SPLICE LENGTH.
- 8) LOCATE REBAR IN CENTER OF FOUNDATION WALL.
- 9) WHERE REQUIRED, FILL BLOCK SOLID WITH TYPE "S" MORTAR OR 3000 PSI GROUT. USE OF "LOW LIFT GROUTING" METHOD REQUIRED WHEN FILLING WALLS WITH GROUT AT HEIGHTS OF 5' AND GREATER.

DETAIL 1	STEM WALL FDN. W/ BRICK AND CURB (2)
BRICK TIES @ I'-4" VERTICALLY AND 2'-6" HORIZONTALLY 4" BRICK VENEER FLASHING WEEP HOLES LADDER WIRE EVERYMOTHER COURSE 12" CMU BLOCK WALL REINFORCEMENT, SEE CHART FOR SPACING 20" WIDE BY 8" DEEP CONT. CONC. FTG.	2 x 4 STUD FRAMING (UNO) W TRTD. BOTTOM PLATE(S) SECURED BY 1/2" DIA. BOLTS. SEC CHART FOR SPACING AND EMBEDMENT REQUIREMENTS 4" CONCRETE SLAB W FIBER REINFORCING OR WELDED WIRE FABRIC 6 MIL. YAPOR BARRIER 4" WASHED STONE TOP TWO COURSES OF STEM WALL AND ALL CELLS W REINFORCEMENT TO BE FILLED SOLID. STEM WALL FDN. W/ OPTIONAL SHEATHING SHEATHING SHEATHING SIDING AS SPEC. FLASHING OPTIONAL 4" BRICK YENEER WATERTABLE WEEP HOLES WEEP HOLES FOR OPTIONAL BRICK WATERTABLE INCREASE TO 20" WIDE BY 8" DEEP CONT. CONC. FTG.

2 x 4 STUD FRAMING (UNO) W/ TRTD. BOTTOM PLATE(S)

2 x 4 TRTD. BOTTOM PLATE(S)-

SECURED BY 1/2" DIA. BOLTS.

SEE CHART FOR SPACING AND EMBEDMENT REQUIREMENTS

W/ FIBER REINFORCING

4" CONCRETE SLAB

6 MIL. VAPOR-BARRIER

UNDISTURBED EARTH,

COMPACTED FILL

OR WASHED STONE

TOP TWO COURSES OF STEM WALL AND-

ALL CELLS W/ REINFORCEMENT TO BE

FILLED SOLID.

OR WELDED WIRE FABRIC

4" WASHED STONE

BRICK TIES @

1'-4" VERTICALLY AND

LADDER WIRE

EVERY OTHER

— 12" CMU BLOCK

4

COURSE

-WALL REINFORCEMENT,

-20" WIDE BY 8" DEEP

CONT. CONC. FTG.

SEE CHART FOR SPACING

2'-6" HORIZONTALLY

-4" BRICK VENEER

WEEP HOLES

ANCHOR SPACING AND EMBEDMENT			NOTE:
WIND ZONE	120 MPH	130 MPH	THREADED
SPACING	6'-0" O.C. INSTALL MIN. (2) ANCHORS PER PLATE SECTION AND (1) ANCHOR WITHIN 12" OF CORNERS	4'-0" O.C. INSTALL MIN. (2) ANCHORS PER PLATE SECTION AND (1) ANCHOR WITHIN 12" OF CORNERS	SIMPSON T ANCHORS S TO PROVID ANCHORAG ANCHOR B
EMBEDMENT	7"	15" INTO MASONRY 7" INTO CONCRETE	LIEU OF 1/2

-SIDING AS SPEC.

-LADDER WIRE IN TOP TWO

-OPTIONAL BRICK VENEER

COURSES (W/ VENEER ONLY)

-FINISHED GRADE

LADDER WIRE

EVERY OTHER

-8" CMU BLOCK

COURSE

-WALL REINFORCEMENT, SEE

CHART FOR SPACING

-16" WIDE BY 8" DEEP

CONT. CONC. FTG.

STEM WALL FON. DETAIL

SHEATHING

2 x 4 STUD FRAMING (UNO) W/ TRTD. BOTTOM PLATE(S)

2 x 4 TRTD. BOTTOM PLATE(S)—

SECURED BY 1/2" DIA. BOLTS.

SEE CHART FOR SPACING AND

THICKENED SLAB-

4" CONCRETE SLAB

6 MIL. VAPOR-

UNDISTURBED EARTH,

COMPACTED FILL

OR WASHED STONE

TOP TWO COURSES OF STEM WALL AND-

ALL CELLS w/ REINFORCEMENT TO BE

2 x 4 STUD FRAMING (UNO)

W/ TRTD. BOTTOM PLATE(S)

2 x 4 TRTD. BOTTOM PLATE(S) -

SECURED BY 1/2" DIA. BOLTS.

EMBEDMENT REQUIREMENTS

SEE CHART FOR SPACING AND

4" CONCRETE SLAB

6 MIL. VAPOR-BARRIER

UNDISTURBED EARTH, COMPACTED FILL OR WASHED STONE

4" WASHED STONE

W/ FIBER REINFORCING
OR WELDED WIRE FABRIC

TOP TWO COURSES OF STEM WALL AND-ALL CELLS w/ REINFORCEMENT TO BE

FILLED SOLID.

STEM WALL FDN. W/ BRICK DETAIL

FILLED SOLID.

BARRIER

W/ FIBER REINFORCING

OR WELDED WIRE FABRIC

4" WASHED STONE

NOT REQUIRED

EMBEDMENT REQUIREMENTS

ED ROD WITH EPOXY, TITEN HD, OR APPROVED SPACED AS REQUIRED VIDE EQUIVALENT AGE TO 1/2" DIAMETER BOLTS MAY BE USED IN 12" ANCHOR BOLTS.

BRICK WATERTABLE DETAIL

This sealed page is to be used in conjunction with a full plan set engineered by J.S. Thompson Engineering, Inc. only. Use of this individual sealed page within architectural pages or shop drawings by others is a punishable offense under N.C. Statute § 89C-23

ES

DATE: MAY 18, 2020

SCALE: 1/4" = 1'-0" DRAWN BY: JST

ENGINEERED BY: JST

BRACED WALL

NOTES AND DETAILS AND PF DETAIL

GENERAL WALL BRACING NOTES

WALL BRACING DESIGNED IN ACCORDANCE WITH CHAPTER 6 OF THE 2018 NC RESIDENTIAL BUILDING CODE (NCRC). TABLES AND FIGURES REFERENCED ARE FROM THE 2018 NCRC. SEE THIS SHEET FOR GENERAL DETAILS. REFER TO THE 2018 NCRC FOR ADDITIONAL INFORMATION AS NEEDED

AND SHEAR FORCES IN ACCORDANCE WITH ACCEPTED ENGINEERED PRACTICE. SEE STRUCTURAL SHEETS FOR BRACED WALL LOCATIONS, DIMENSIONS, HOLD DOWN TYPE AND LOCATIONS, BRACED WALL LINE KEY WITH WALL DESIGN SUMMARY OF REQUIRED/PROVIDED TOTALS FOR EACH WALL LINE AND ANY SPECIAL NOTES

BRACED EXTERIOR WALLS SUPPORTING ROOF TRUSSES AND RAFTERS, INCLUDING STORIES BELOW THE TOP FLOOR, HAVE

BEEN DESIGNED PER R602.3.5 (3). WALL SHEATHING AND FASTENERS HAVE BEEN DESIGNED TO RESIST COMBINED UPLIFT


OR REQUIREMENTS. 5. ALL EXTERIOR WALLS ARE TO BE SHEATHED WITH CS-WSP IN ACCORDANCE WITH SECTION R602.10.3 UNLESS NOTED


6. ALL EXTERIOR AND INTERIOR WALLS TO HAVE 1/2" GYPSUM INSTALLED. WHEN NOT USING METHOD "GB", GYPSUM TO BE FASTENED PER TABLE R102.3.5. METHOD GB TO BE FASTENED PER TABLE R602.10.1


CS-WSP REFERS TO THE "CONTINUOUS SHEATHING - WOOD STRUCTURAL PANELS" WALL BRACING METHOD. 1/16" OSB SHEATHING IS TO BE INSTALLED ON ALL EXTERIOR WALLS ATTACHED W/6d COMMON NAILS OR 8d (2 1/2" LONG x Ø.113" DIAMETER) NAILS SPACED 6" O.C. ALONG PANEL EDGES AND 12" O.C. IN THE FIELD (U.N.O.,


GB REFERS TO THE "GYPSUM BOARD" WALL BRACING METHOD. 1/2" (MIN.) GYPSUM WALL BOARD IS TO BE INSTALLED ON BOTH SIDES OF THE BRACED WALL FASTENED WITH 1 1/4" SCREWS OR 1 5/8" NAILS SPACED 1" O.C. ALONG PANEL EDGES INCLUDING TOP AND BOTTOM PLATES AND INTERMEDIATE SUPPORTS (U.N.O.). VERIFY ALL FASTENER OPTIONS FOR 1/2" AND 5/8" GYPSUM PRIOR TO CONSTRUCTION. FOR INTERIOR FASTENER OPTIONS SEE TABLE R7/02.3.5. FOR EXTERIOR FASTENER OPTIONS SEE TABLE R602.3(1). EXTERIOR GB TO BE INSTALLED VERTICALLY.


REQUIRED BRACED WALL LENGTH FOR EACH SIDE OF THE CIRCUMSCRIBED RECTANGLE ARE INTERPOLATED PER TABLE R602. 10.3. METHOD CS-WSP CONTRIBUTES ITS ACTUAL LENGTH, METHOD GB CONTRIBUTES .5 ITS ACTUAL LENGTH, AND METHOD PF CONTRIBUTES 1.5 TIMES ITS ACTUAL LENGTH.

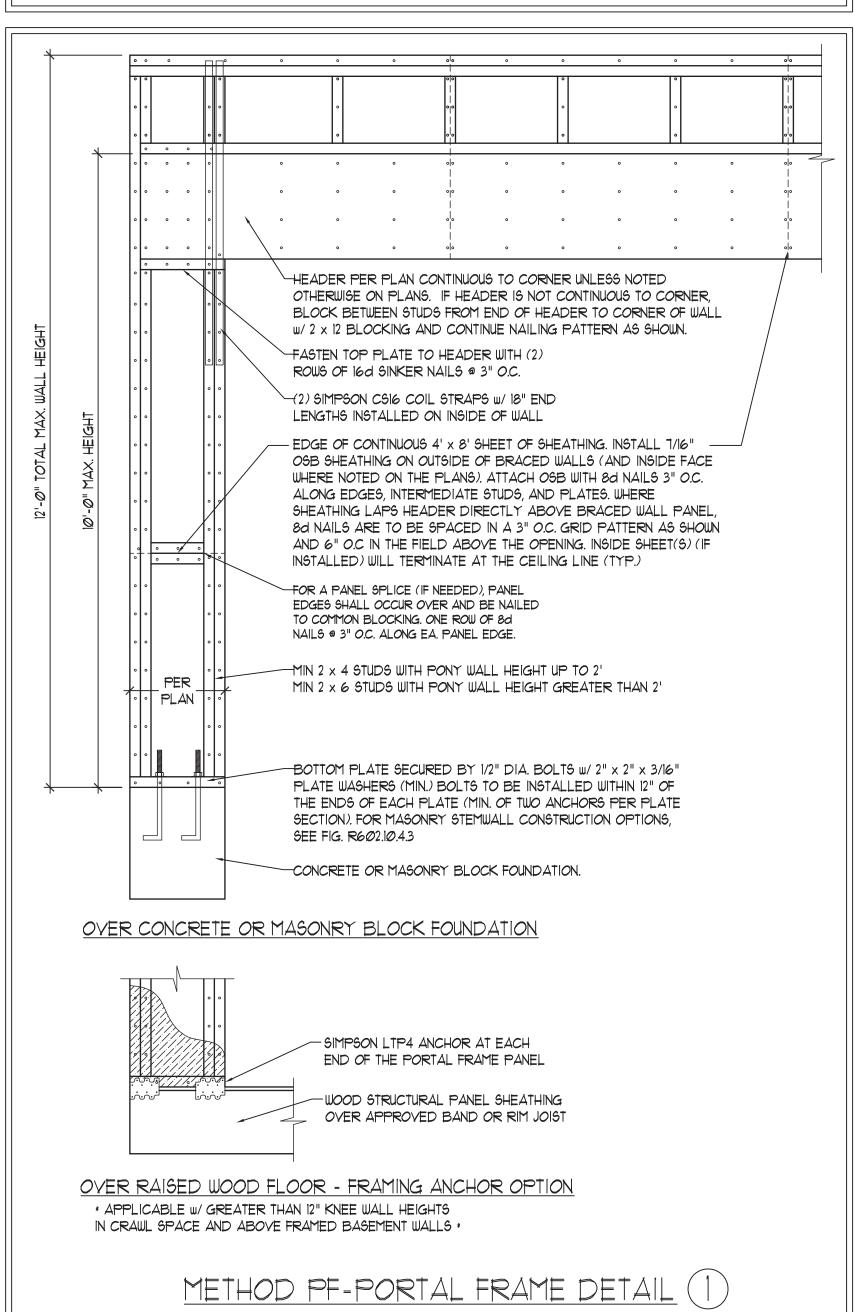

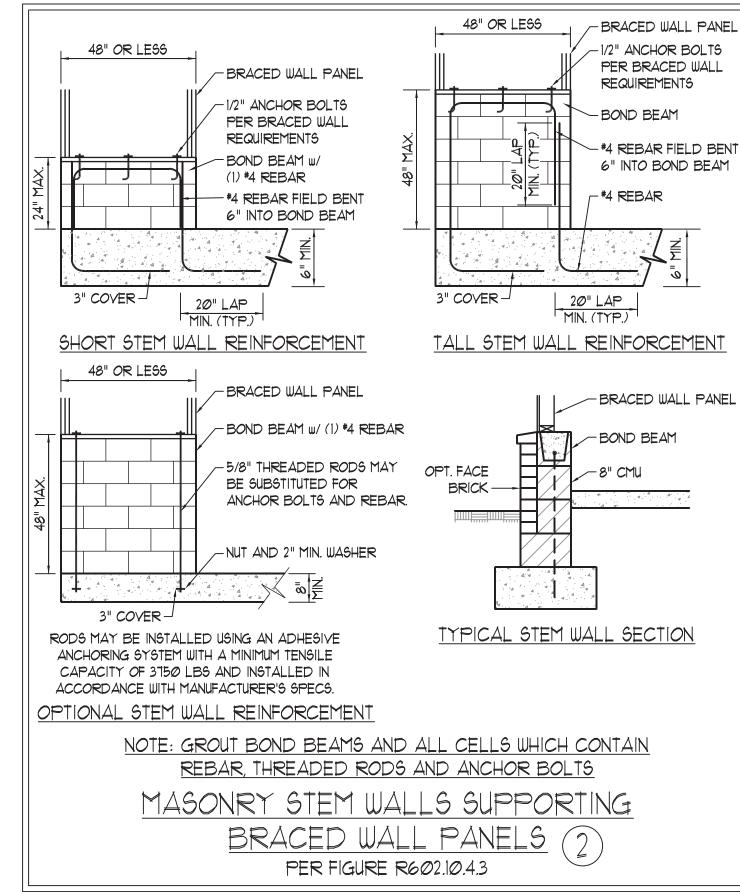


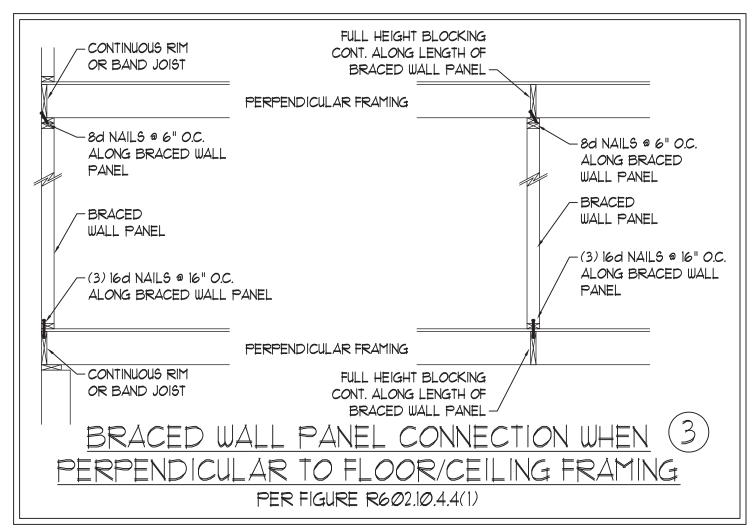


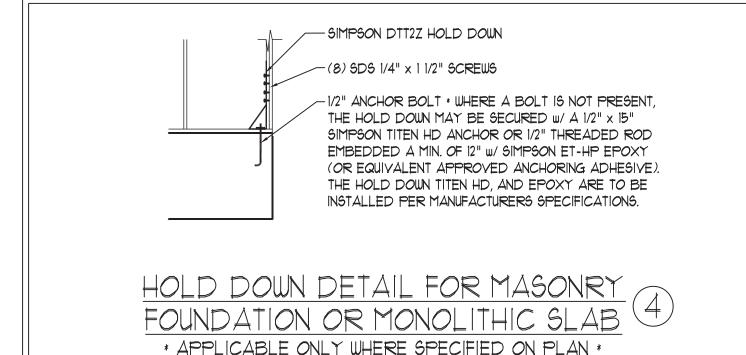

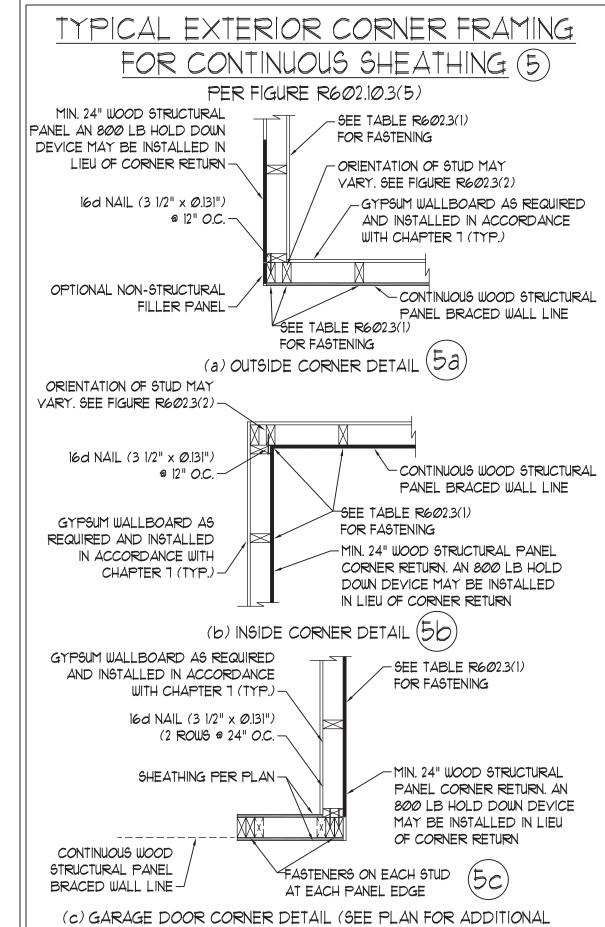

STRUCTURAL INFORMATION OR ALTERNATE CONFIGURATIONS)

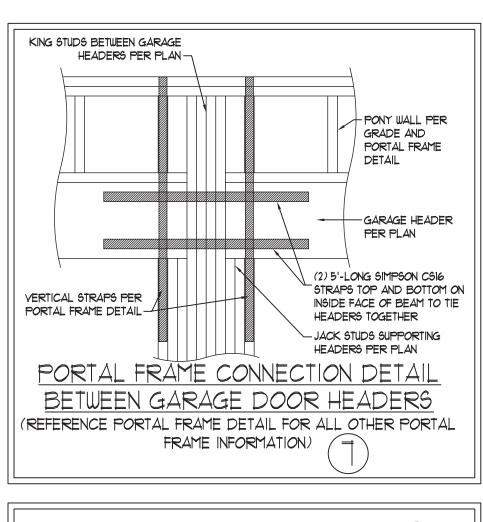

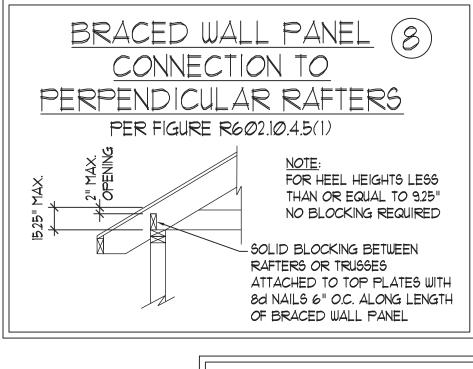

CONNECTION TO

PERPENDICULAR ROOF

TRUSSES

PER FIGURE R602.10.4.5(3)

(OR ALTERNATIVE: FIGURE R602.10.4.5(2))

6'-0" MAX.

2 x BLOCKING


NAILING PER


TABLE


33736

10/1/2020

R602.3(1)

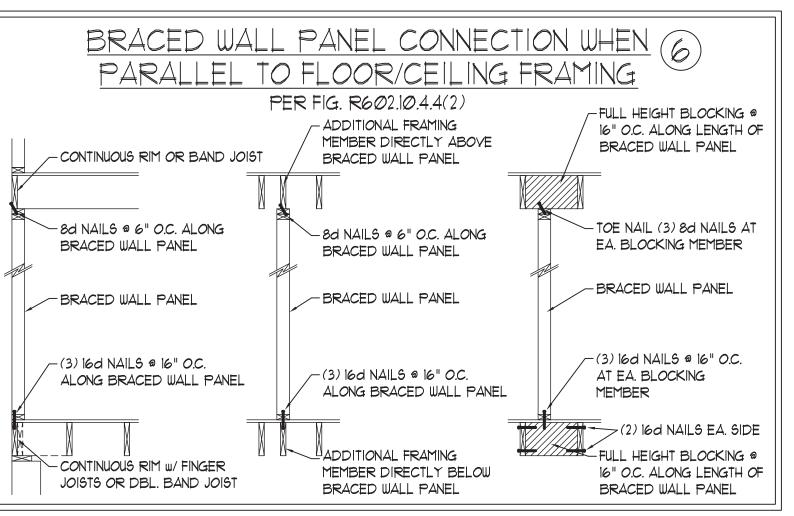

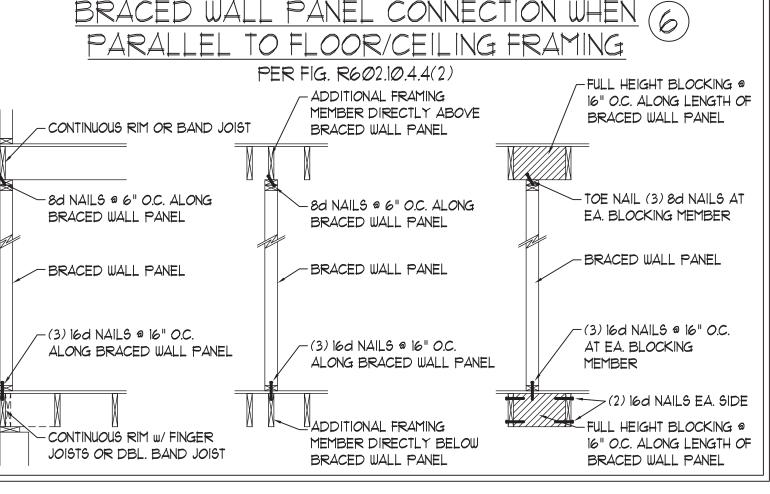

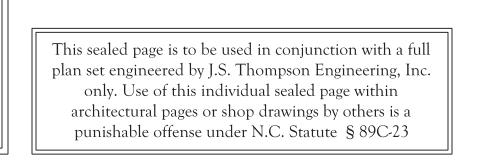

GENERAL NOTES

- 1. ENGINEER'S SEAL APPLIES ONLY TO STRUCTURAL COMPONENTS INCLUDING ROOF RAFTERS, HIPS, VALLEYS, RIDGES, FLOORS, WALLS, BEAMS, HEADERS, COLUMNS, CANTILEVERS, OFFSET LOAD BEARING WALLS, PIERS, GIRDER SYSTEM AND FOOTING. ENGINEER'S SEAL DOES NOT CERTIFY DIMENSIONAL ACCURACY OF ARCHITECTURAL LAYOUT INCLUDING ROOF. ENGINEER'S SEAL DOES NOT APPLY TO 1-JOIST OR FLOOR/ROOF TRUSS LAYOUT DESIGN AND ACCURACY.
- 2. ALL CONSTRUCTION SHALL CONFORM TO THE LATEST REQUIREMENTS OF THE NORTH CAROLINA RESIDENTIAL CODE (NCRC), 2018 EDITION, PLUS ALL LOCAL CODES AND REGULATIONS. THE STRUCTURAL ENGINEER IS NOT RESPONSIBLE FOR, AND WILL NOT HAVE CONTROL OF, CONSTRUCTION MEANS, METHODS, TECHNIQUES, SEQUENCES OR PROCEDURES, OR SAFETY PRECAUTIONS AND PROGRAMS IN CONNECTION WITH THE CONSTRUCTION WORK. NOR WILL THE ENGINEER BE RESPONSIBLE FOR THE CONTRACTORS FAILURE TO CARRY OUT THE CONSTRUCTION WORK IN ACCORDANCE WITH THE CONTRACT DOCUMENTS.
- 3. STRUCTURAL DESIGN BASED ON THE PROVISIONS OF THE NCRC, 2018 EDITION (R301,4 R301,7)

DESIGN CRITERIA:	LIVE LOAD (PSF)	DEAD LOAD (PSF)	DEFLECTION (IN)
ATTIC WITH LIMITED STORAGE	2Ø	10	L/240 (L/360 w/ BRITTLE FINISHES)
ATTIC WITHOUT STORAGE	10	10	L/360
DECK9	40	10	L/360
EXTERIOR BALCONIES	40	10	L/360
FIRE ESCAPES	40	10	L/360
HANDRAILS/GUARDRAILS	200 LB OR 50 (PLF)	10	L/360
PASSENGER VEHICLE GARAGE	50	10	L/360
ROOMS OTHER THAN SLEEPING ROOM	40	10	L/360
SLEEPING ROOMS	3Ø	10	L/360
STAIRS	40	10	L/360
WIND LOAD	(BASED ON TABLE R3Ø1.2(4) WIND ZONE AND EXPOSURE)		
GROUND SNOW LOAD: Pg	20 (PSF)		

- I-JOIST SYSTEMS DESIGNED WITH 12 PSF DEAD LOAD AND DEFLECTION (IN) OF L/480 - FLOOR TRUSS SYSTEMS DESIGNED WITH 15 PSF DEAD LOAD

- 4. FOR 115 AND 120 MPH WIND ZONES, FOUNDATION ANCHORAGE 15 TO COMPLY WITH SECTION R403.1.6 OF THE NCRC, 2018 EDITION. FOR 130 MPH, 140 MPH, AND 150 MPH WIND ZONES, FOUNDATION ANCHORAGE 15 TO COMPLY WITH SECTION 4504 OF THE NCRC, 2018 EDITION.
- 5. ENERGY EFFICIENCY COMPLIANCE AND INSULATION VALUES OF THE BUILDING TO BE IN ACCORDANCE WITH CHAPTER 11 OF THE NCRC, 2018 EDITION.

FOOTING AND FOUNDATION NOTES

- I. FOUNDATION DESIGN BASED ON A MINIMUM ALLOWABLE BEARING CAPACITY OF 2000 PSF. CONTACT GEOTECHNICAL ENGINEER IF BEARING CAPACITY IS NOT ACHIEVED.
- 2. FOR ALL CONCRETE SLABS AND FOOTINGS, THE AREA WITHIN THE PERIMETER OF THE BUILDING ENVELOPE SHALL HAVE ALL VEGETATION, TOP SOIL AND FOREIGN MATERIAL REMOVED. FILL MATERIAL SHALL BE FREE OF VEGETATION AND FOREIGN MATERIAL. THE FILL SHALL BE COMPACTED TO ASSURE UNIFORM SUPPORT OF THE SLAB, AND EXCEPT WHERE APPROVED, THE FILL DEPTHS SHALL NOT EXCEED 24" FOR CLEAN SAND OR GRAVEL. A 4" THICK BASED COURSE CONSISTING OF CLEAN GRADED SAND OR GRAVEL SHALL BE PLACED. A BASE COURSE IS NOT REQUIRED WHERE A CONCRETE SLAB IS INSTALLED ON WELL-DRAINED OR SAND-GRAVEL MIXTURE SOILS CLASSIFIED AS GROUP I, ACCORDING TO THE UNITED SOIL CLASSIFICATION SYSTEM IN ACCORDANCE WITH TABLE R405.1 OF THE NCRC, 2018 EDITION.
- 3. PROPERLY DEWATER EXCAVATION PRIOR TO POURING CONCRETE WHEN BOTTOM OF CONCRETE SLAB IS AT OR BELOW WATER TABLE. IF APPLICABLE, 3/4" 1" DEEP CONTROL JOINTS ARE TO BE SAWED WITHIN 4 TO 12 HOURS OF CONCRETE FINISHING AND WALL LOCATIONS HAVE BEEN MARKED. ADJUST WHERE NECESSARY.
- 4. CONCRETE SHALL CONFORM TO SECTION R402.2 OF THE NCRC, 2018 EDITION. CONCRETE REINFORCING STEEL TO BE ASTM A615 GRADE 60. WELDED WIRE FABRIC TO BE ASTM A185. MAINTAIN A MINIMUM CONCRETE COVER AROUND REINFORCING STEEL OF 3" IN FOOTINGS AND 1 1/2" IN SLABS. FOR POURED CONCRETE WALLS, CONCRETE COVER FOR REINFORCING STEEL MEASURED FROM THE INSIDE FACE OF THE WALL SHALL NOT BE LESS THAN 3/4". CONCRETE COVER FOR REINFORCING STEEL MEASURED FROM THE OUTSIDE FACE OF THE WALL SHALL NOT BE LESS THAN 1 1/2" FOR #5 BARS OR SMALLER, AND NOT LESS THAN 2" FOR #6 BARS OR LARGER.
- 5. MASONRY UNITS TO CONFORM TO ACE 530/ASCE 5/TMS 402. MORTAR SHALL COMFORM TO ASTM C270.
- 6. THE UNSUPPORTED HEIGHT OF MASONRY PIERS SHALL NOT EXCEED FOUR TIMES THEIR LEAST DIMENSION FOR UNFILLED HOLLOW CONCRETE MASONRY UNITS AND TEN TIMES THEIR LEAST DIMENSION FOR SOLID OR SOLID FILLED PIERS. PERS MAY BE FILLED SOLID WITH CONCRETE OR TYPE M OR S MORTAR. PIERS AND WALLS SHALL BE CAPPED WITH 8" OF SOLID MASONRY.
- 1. THE CENTER OF EACH OF THE PIERS SHALL BEAR IN THE MIDDLE THIRD OF ITS RESPECTIVE FOOTING. EACH GIRDER SHALL BEAR IN THE MIDDLE THIRD OF THE PIERS.
- 8. ALL CONCRETE AND MASONRY FOUNDATION WALLS ARE TO BE CONSTRUCTED IN ACCORDANCE WITH THE PROVISIONS OF SECTION R404 OF THE NCRC, 2018 EDITION OR IN ACCORDANCE WITH ACI 318, ACI 332, NCMA TR68-A OR ACE 530/ASCE 5/TMS 402. MASONRY FOUNDATION WALLS ARE TO BE REINFORCED PER TABLE R404.1.1(1), R404.1.1(2), R404.1.1(3), OR R404.1.1(4) OF THE NCRC, 2018 EDITION. CONCRETE FOUNDATION WALLS ARE TO BE REINFORCED PER TABLE R404.1.1(5) OF THE NCRC, 2018 EDITION. STEP CONCRETE FOUNDATION WALLS TO 2 x 6 FRAMED WALLS AT 16" O.C. WHERE GRADE PERMITS (UNO).

This sealed page is to be used in conjunction with a full plan set engineered by J.S. Thompson Engineering, Inc. only. Use of this individual sealed page within architectural pages or shop drawings by others is a punishable offense under N.C. Statute § 89C-23

FRAMING NOTES

- 1. ALL FRAMING LUMBER SHALL BE #2 SPF MINIMUM (Fb = 875 PSI, Fv = 375 PSI, E = 16000000 PSI) UNLESS NOTED OTHERWISE (UNO). ALL TREATED LUMBER SHALL BE #2 SYP MINIMUM (Fb = 975 PSI, Fv = 175 PSI, E = 16000000 PSI) UNLESS NOTED OTHERWISE (UNO).
- 2. LAMINATED VENEER LUMBER (LVL) SHALL HAVE THE FOLLOWING MINIMUM PROPERTIES: Fb = 2600 PSI, Fv = 285 PSI, E = 1900000 PSI.

 LAMINATED STRAND LUMBER (LSL) SHALL HAVE THE FOLLOWING MINIMUM PROPERTIES: Fb = 2325 PSI, Fv = 310 PSI, E = 1550000 PSI.

 PARALLEL STRAND LUMBER (PSL) UP TO 1" DEPTH SHALL HAVE THE FOLLOWING MINIMUM PROPERTIES: Fc = 2500 PSI, E = 18000000 PSI.

 PARALLEL STRAND LUMBER (PSL) MORE THAN 1" DEPTH SHALL HAVE THE FOLLOWING MINIMUM PROPERTIES: Fc = 2900 PSI, E = 20000000 PSI. INSTALL ALL CONNECTIONS PER MANUFACTURER'S SPECIFICATIONS.
- 3. STRUCTURAL STEEL SHALL CONFORM TO THE FOLLOWING ASTM SPECIFICATIONS

A. W AND WT 6HAPE6: ASTM A992

B. CHANNELS AND ANGLES: ASTM A36

C. PLATES AND BARS: ASTM A36

D. HOLLOW STRUCTURAL SECTIONS: ASTM A500 GRADE B

E. STEEL PIPE: ASTM A53, GRADE B, TYPE E OR S

4. STEEL BEAMS SHALL BE SUPPORTED AT EACH END WITH A MINIMUM BEARING LENGTH OF 3 1/2" AND FULL FLANGE WIDTH (UNO). PROVIDE SOLID BEARING FROM BEAM SUPPORT TO FOUNDATION. BEAMS SHALL BE ATTACHED AT THE BOTTOM FLANGE TO EACH SUPPORT AS FOLLOWS (UNO):

A. WOOD FRAMING:

B. CONCRETE

C. MASONRY (FULLY GROUTED)

(2) 1/2" DIA. x 4" WEDGE ANCHORS

(2) 1/2" DIA. x 4" LONG SIMPSON TITEN HD ANCHORS

LATERAL SUPPORT IS CONSIDERED ADEQUATE PROVIDING THE JOISTS ARE TOE NAILED TO THE 2x NAILER ON TOP OF THE STEEL BEAM, AND THE 2x NAILER IS SECURED TO THE TOP OF THE STEEL BEAM w/ (2) ROWS OF SELF TAPPING SCREWS @ 16" O.C. OR (2) ROWS OF 1/2" DIAMETER BOLTS @ 16" O.C. IF 1/2" BOLTS ARE USED TO FASTEN THE NAILER, THE STEEL BEAM SHALL BE FABRICATED w/ (2) ROWS OF 9/16" DIAMETER HOLES @ 16" O.C.

- 5. SQUARES DENOTE POINT LOADS WHICH REQUIRE SOLID BLOCKING TO GIRDER OR FOUNDATION. SHADED SQUARES DENOTE POINT LOADS FROM ABOVE WHICH REQUIRE SOLID BLOCKING TO SUPPORTING MEMBER BELOW.
- 6. ALL LOAD BEARING HEADERS TO CONFORM TO TABLE R602.7(1) AND R602.7(2) OF THE NCRC, 2018 EDITION OR BE (2) 2 x 6 WITH (1) JACK AND (1) KING STUD EACH END (UNO), WHICHEVER IS GREATER ALL HEADERS TO BE SECURED TO EACH JACK STUD WITH (4) 8d NAILS. ALL BEAMS TO BE SUPPORTED WITH (2) STUDS AT EACH BEARING POINT (UNO). INSTALL KING STUDS PER SECTION R602.7.5 OF THE NORTH CAROLINA RESIDENTIAL CODE, 2018 EDITION.
- 1. ALL BEAMS, HEADERS, OR GIRDER TRUSSES PARALLEL TO WALL ARE TO BEAR FULLY ON (1) JACK OR (2) STUDS MINIMUM OR THE NUMBER OF JACKS OR STUDS NOTED. ALL BEAMS OR GIRDER TRUSSES PERPENDICULAR TO WALL AND SUPPORTED BY (3) STUDS OR LESS ARE TO HAVE I I/2" MINIMUM BEARING (UNO). ALL BEAMS OR GIRDER TRUSSES PERPENDICULAR TO WALL AND SUPPORTED BY MORE THAN (3) STUDS OR OTHER NOTED COLUMN ARE TO BEAR FULLY ON SUPPORT COLUMN FOR ENTIRE WALL DEPTH (UNO). BEAM ENDS THAT BUTT INTO ONE ANOTHER ARE TO EACH BEAR EQUAL LENGTHS (UNO).
- 8. FLITCH BEAMS SHALL BE BOLTED TOGETHER USING 1/2" DIAMETER BOLTS (ASTM A3ØT) WITH WASHERS PLACED AT THREADED END OF BOLT.
 BOLTS SHALL BE SPACED AT 24" CENTERS (MAXIMUM), AND STAGGERED AT TOP AND BOTTOM OF BEAM (2" EDGE DISTANCE), WITH (2) BOLTS
 LOCATED AT 6" FROM EACH END (UNO).
- 9. ALL 1-JOIST OR TRUSS LAYOUTS ARE TO BE IN COMPLIANCE WITH THE OVERALL DESIGN SPECIFIED ON THE PLANS. ALL DEVIATIONS ARE TO BE BROUGHT TO THE ATTENTION OF THE ENGINEER OF RECORD PRIOR TO INSTALLATION.
- IØ. BRACED WALL PANELS SHALL BE CONSTRUCTED ACCORDING TO THE NORTH CAROLINA RESIDENTIAL CODE 2018 EDITION WALL BRACING CRITERIA. THE AMOUNT, LENGTH, AND LOCATION OF BRACING SHALL COMPLY WITH ALL APPLICABLE TABLES IN SECTION R602.10.
- 11. PROVIDE DOUBLE JOIST UNDER ALL WALLS PARALLEL TO FLOOR JOISTS. PROVIDE SUPPORT UNDER ALL WALLS PARALLEL TO FLOOR TRUSSES OR 1-JOISTS PER MANUFACTURER'S SPECIFICATIONS. INSTALL BLOCKING BETWEEN JOISTS OR TRUSSES FOR POINT LOAD SUPPORT FOR ALL POINT LOADS ALONG OFFSET LOAD LINES.
- 12. FOR ALL HEADERS SUPPORTING BRICK VENEER THAT ARE LESS THAN 8'-0" IN LENGTH, REST A 6" x 4" x 5/16" STEEL ANGLE WITH 6" MINIMUM EMBEDMENT AT SIDES FOR BRICK SUPPORT (UN.O). FOR ALL HEADERS 8'-0" AND GREATER IN LENGTH, BOLT A 6" x 4" x 5/16" STEEL ANGLE TO HEADER WITH 1/2" LAG SCREWS AT 12" O.C. STAGGERED FOR BRICK SUPPORT. FOR ALL BRICK SUPPORT AT ROOF LINES, BOLT A 6" x 4" x 5/16" STEEL ANGLE TO (2) 2 x 10 BLOCKING INSTALLED w/ (4) 12d NAILS EA. PLY BETWEEN WALL STUDS WITH (2) ROWS OF 1/2" LAG SCREWS AT 12" O.C. STAGGERED AND IN ACCORDANCE WITH SECTION RT03.8.2.1 OF THE NCRC, 2018 EDITION.
- 13. FOR STICK FRAMED ROOFS: CIRCLES DENOTE (3) 2 x 4 POSTS FOR ROOF MEMBER SUPPORT. HIP SPLICES ARE TO BE SPACED A MINIMUM OF 8'-Ø". FASTEN MEMBERS WITH THREE ROWS OF 12d NAILS AT 16" O.C. FRAME DORMER WALLS ON TOP OF DOUBLE OR TRIPLE RAFTERS AS SHOWN (UNO).
- 14. FOR TRUSSED ROOFS: FRAME DORMER WALLS ON TOP OF 2 x 4 LADDER FRAMING AT 24" O.C. BETWEEN ADJACENT ROOF TRUSSES. STICK FRAME OVER-FRAMED ROOF SECTIONS WITH 2 x 8 RIDGES, 2 x 6 RAFTERS AT 16" O.C. AND FLAT 2 x 10 VALLEYS (UNO).
- 15. ALL 4 x 4 AND 6 x 6 POSTS TO BE INSTALLED WITH 700 LB CAPACITY UPLIFT CONNECTORS TOP AND BOTTOM (UNO.) POSTS MAY BE SECURED USING ONE SIMPSON H6 OR LTS12 UPLIFT CONNECTOR FASTENED TO THE BAND AT THE BOTTOM AND THE BEAM AT THE TOP OF EACH POST. ONE 16" SECTION OF SIMPSON CS16 COIL STRAPPING WITH (8) 8d HDG NAILS AT EACH END MAY BE USED IN LIEU OF EACH TWIST STRAP IF DESIRED. FOR MASONRY OR CONCRETE FOUNDATION USE SIMPSON POST BASE.



S TONDE AVE, SUITE 104 RALEIGH, N

STANDARD STRUCTURAL NOTES

DATE: OCTOBER 29, 2018

SCALE: 1/4" = 1'-0"

DRAWN BY: JES

ENGINEERED BY: JST

EET:

STRUCTURAL NOTES

SEAL 33736

SEAL 30786

SOURCE POTAGE

10/1/2020